ROCKBURN BRANCH PARK

OUTFALL D ENVIRONMENTAL SITE DESIGN RETROFIT CAPITAL PROJECT # D1160

GENERAL NOTES

- ALL CONSTRUCTION SHALL BE IN ACCORDANCE WITH THE LATEST STANDARDS AND SPECIFICATIONS OF HOWARD COUNTY PLUS MSHA STANDARDS AND SPECIFICATIONS IF APPLICABLE.
- THE CONTRACTOR SHALL NOTIFY THE DEPARTMENT OF PUBLIC WORKS/BUREAU OF ENGINEERING/CONSTRUCTION INSPECTION DIVISION AT (410) 313-1880 AT LEAST FIVE (5) WORKING DAYS PRIOR TO THE START OF WORK.
- THE CONTRACTOR SHALL NOTIFY "MISS UTILITY" AT 1-800-257-7777 AT LEAST 48 HOURS PRIOR TO ANY EXCAVATION WORK BEING DONE.
- TRAFFIC CONTROL DEVICES, MARKINGS AND SIGNING SHALL BE IN ACCORDANCE WITH THE LATEST EDITION OF THE MANUAL OF UNIFORM TRAFFIC CONTROL DEVICES (MUTCD). ALL STREET AND REGULATORY SIGNS SHALL BE IN PLACE PRIOR TO THE PLACEMENT OF ANY ASPHALT.
- ALL PLAN DIMENSIONS ARE TO FACE OF CURB UNLESS OTHERWISE NOTED.
- THE EXISTING TOPOGRAPHY IS TAKEN FROM AERIAL SURVEY WITH 1 FOOT CONTOUR INTERVALS PREPARED BY AERO-METRIC DATED 2/26/2012.
- THE COORDINATES SHOWN HEREON ARE BASED UPON THE HOWARD COUNTY GEODETIC CONTROL, WHICH IS BASED UPON THE MARYLAND STATE PLANE COORDINATE SYSTEM. HOWARD COUNTY MONUMENT Nos. 37BM2 AND 37BC WERE USED FOR THIS PROJECT.
- WATER IS PUBLIC.
- SEWER IS PUBLIC.
- THIS PROJECT RETROFITS EXISTING CONDITIONS WITH A BIORETENTION FACILITY. THIS FACILITY WILL BE OWNED AND MAINTAINED BY THE DEPARTMENT OF RECREATION AND
- EXISTING UTILITIES ARE BASED ON AVAILABLE RECORDS.
- THERE IS NO FLOODPLAIN ON THIS SITE.
- THERE ARE NO WETLANDS ON THIS SITE.
- THERE ARE NO FOREST CONSERVATION EASEMENTS WITHIN THE PROJECT LIMITS.
- NO TRAFFIC STUDY IS REQUIRED FOR THIS PROJECT
- NO GRADING, REMOVAL OF VEGETATIVE COVER OR TREES, PAVING AND NEW STRUCTURES SHALL BE PERMITTED WITHIN THE REQUIRED WETLANDS, STREAMS, THEIR BUFFERS, FOREST CONSERVATION EASEMENTS AND 100-YEAR FLOODPLAIN, EXCEPT THOSE DISTURBANCES DEEMED NECESSARY BY DPZ.
- THE SUBJECT PROPERTY IS ZONED R-20 PER THE 10/6/2013 COMPREHENSIVE ZONING PLAN.
- THERE ARE NO BURIAL GROUNDS OR CEMETERY SITES LOCATED ON THE PROJECT SITE.
- THIS RENOVATION PROJECT FOR SITE IMPROVEMENTS TO THE ROCKBURN BRANCH PARK UNDER CAPITAL PROJECT No. D1160 IS CONSIDERED EXEMPT IN ACCORDANCE WITH APPENDIX 'O' OF THE FOREST CONSERVATION MANUAL BECAUSE THE ACTIVITY DOES NOT RESULT IN THE CUTTING, CLEARING OR GRADING OF MORE THAN 20,000 SQUARE FEET OF FOREST. THE TOTAL LOD WITHIN EXISTING FOREST IS 3,700 SF. TREE REMOVAL SHALL BE RESTRICTED TO THOSE REQUIRED TO BE COMPLETE THE WORK AS APPROVED BY DEPARTMENT OF RECREATION AND PARKS.
- OBSTRUCTIONS SHOWN ON THIS DRAWING ARE FOR THE CONVENIENCE OF THE CONTRACTOR ONLY, AND BIOHABITATS, INC. DOES NOT WARRANT OR GUARANTEE THE CORRECTNESS OR COMPLETENESS OF THE INFORMATION GIVEN. SHOULD THE CONTRACTOR DISCOVER ANY DISCREPANCIES BETWEEN THE PLANS AND THE FIELD CONDITIONS, THE ENGINEER SHALL BE NOTIFIED IMMEDIATELY TO RESOLVE THE SITUATION. SHOULD THE CONTRACTOR MAKE FIELD CORRECTIONS OR ADJUSTMENTS WITHOUT NOTIFYING THE ENGINEER, THE CONTRACTOR ASSUMES ALL RESPONSIBILITY FOR THOSE CHANGES.
- THE CONTRACTOR SHALL TAKE ALL NECESSARY PRECAUTIONS TO PROTECT THE EXISTING UTILITIES AND MAINTAIN UNINTERRUPTED SERVICE. ANY DAMAGE INCURRED DUE TO THE CONTRACTOR'S OPERATION SHALL BE REPAIRED IMMEDIATELY AT THE CONTRACTOR'S EXPENSE.

- BIOHABITATS SHALL CERTIFY IN WRITTEN LETTER THAT THE HAVE BEEN COMPLETED IN ACCORDANCE TO THESE PLANS.

 DPZ has determined the disturbance within the regulated 751 perennial streambank buffer is essential and land DI and necessary for construction of the SWM system in accordance with Section 10.110(c) of the Subdivision and land DI No grading will occur within the Streambank the contractor will need toplace the filter I the contractor will need toplace the filter I DEPARTMENT OF PUBLIC WORKS, HOWARD CO, MD

CHIEF STORMWATER MANAGEMENT DIVISION DATE

DEPARTMENT OF RECREATION AND PARKS, HOWARD CO, MD 5/1/2015 HOTING DIRECTOR OF RECREATION AND PARKS

SHEET LIST TABLE **Sheet Title Sheet Number** TITLE SHEET 16 GEOMETRY 17 GEOMETRY PROPOSED CONDITIONS 18 PROPOSED CONDITIONS 20 PROFILE DETAILS 22 **ERIOSION & SEDIMENT CONTROL PLAN EROSION & SEDIMENT CONTROL PLAN** 23 **GENERAL NOTES** 24 25 **GENERAL NOTES** 26 EROSION AND SEDIMENT CONTROL DETAILS **EROSION AND SEDIMENT CONTROL DETAILS** 27 28 EROSION AND SEDIMENT CONTROL DETAILS 29 PLANTING PLAN 30 PLANTING PLAN 31 PLANTING DETAILS MATERIAL SPECIFICATIONS


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VICINITY MAP



EREBY CERTIFY, BY MY SEAL, THAT TO THE BEST OF MY VLEDGE AND BELIEF THE FACILITIES SHOWN ON THIS PLAN ERE CONSTRUCTED AS SHOWN ON THIS "AS-BUILT" PLAN MEET THE APPROVED PLAN AND SPECIFICATIONS. Y LONGCRIER, PE# 45474 AS BUILT DATE: NOV. 30TH, 2015

> DEPARTMENT OF PUBLIC WORKS, HOWARD CO, MD DIRECTOR, DEPARTMENT OF PUBLIC WORKS

THAT I AM A DULY LICENSED PROFFESIONAL ENGINEER UNDER THE LAWS OF THE STATE OF MARYLAND.

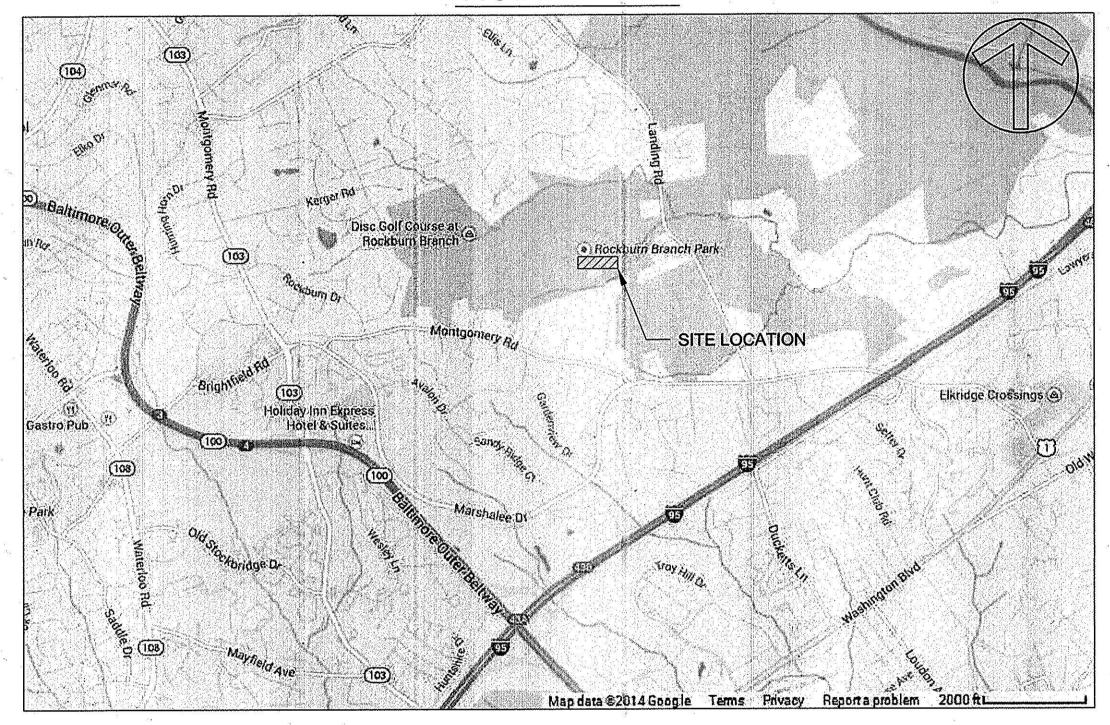LICENSE #: 45474

EXPIRATION DATE: 6/12/2016

"I CERTIFY THAT THIS PLAN FOR SEDIMENT AND EROSION CONTROL REPRESENTS A PRACTICAL AND WORKABLE PLAN BASED ON MY PERSONAL KNOWLEDGE OF THE SITE CONDITIONS AND THAT IT WAS PREPARED IN ACCORDANCE WITH THE REQUIREMENTS OF THE HOWARD COUNTY SOIL CONSERVATION DISTRICT

5/5/15

DATE

ENGINEERS CERTIFICATE

4 my Longuerise

DEVELOPERS CERTIFICATE

"I/WE CERTIFY THAT ALL DEVELOPMENT AND CONSTRUCTION WILL BE DONE ACCORDING TO THIS PLAN FOR SEDIMENT AND EROSION CONTROL, AND THAT ALL RESPONSIBLE PERSONNEL INVOLVED IN THE CONSTRUCTION PROJECT WILL HAVE A CERTIFICATE OF ATTENDANCE AT A DEPARTMENT OF THE ENVIRONMENT APPROVED TRAINING PROGRAM FOR THE CONTROL OF SEDIMENT AND EROSION BEFORE THE BEGINNING OF THE PROJECT. I ALSO


4/27/15 DATE

4/15/15

CLIENT

HOWARD COUNTY STORMWATER MANAGEMENT DIVISION 6751 COLUMBIA GATEWAY DRIVE SUITE 514 COLUMBIA, MD 21046

WATER QUALITY RETROFIT FOR

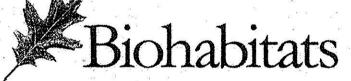

The Stables Building 2081 Clipper Park Road Baltimore, MD 21211 / ph: 410.554.0156 fx: 410.554.0168 / www.biohabitats.com

Restore the Earth & Inspire Ecological Stewardship

REVISED SITE DEVELOPMENT PLAN ROCKBURN **BRANCH PARK**

OUTFALL D RETROFIT

AS-BUILT


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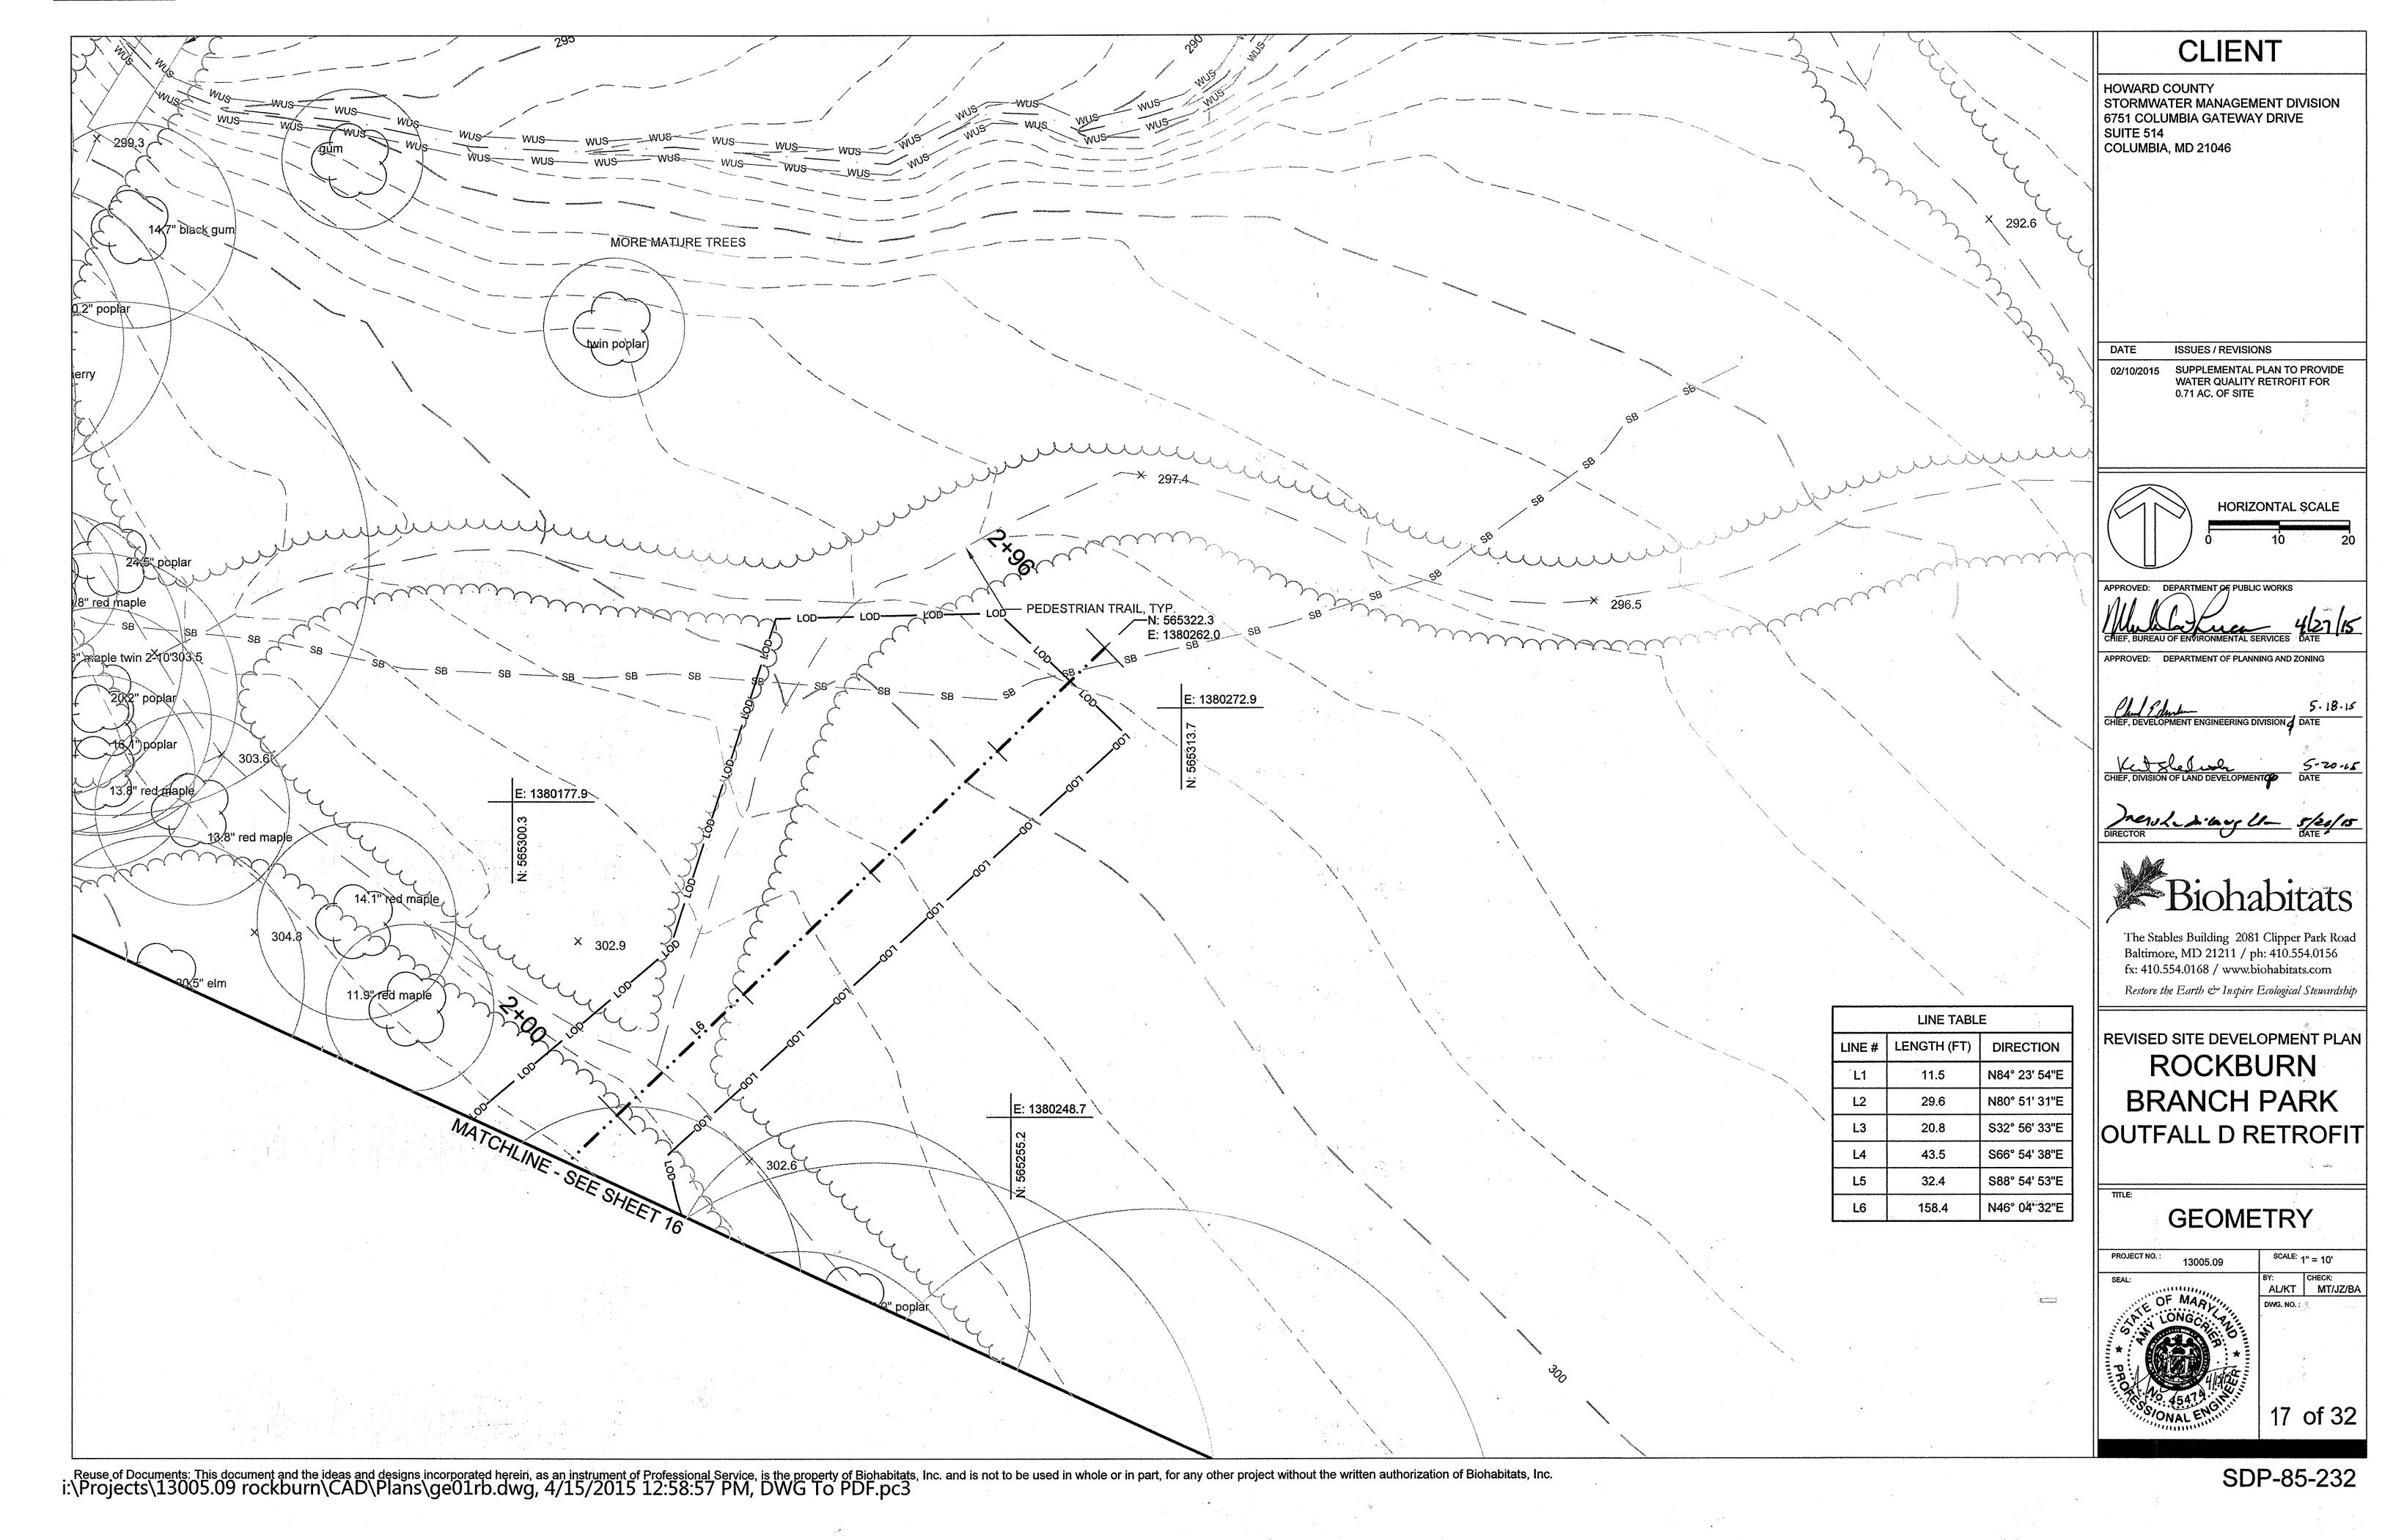
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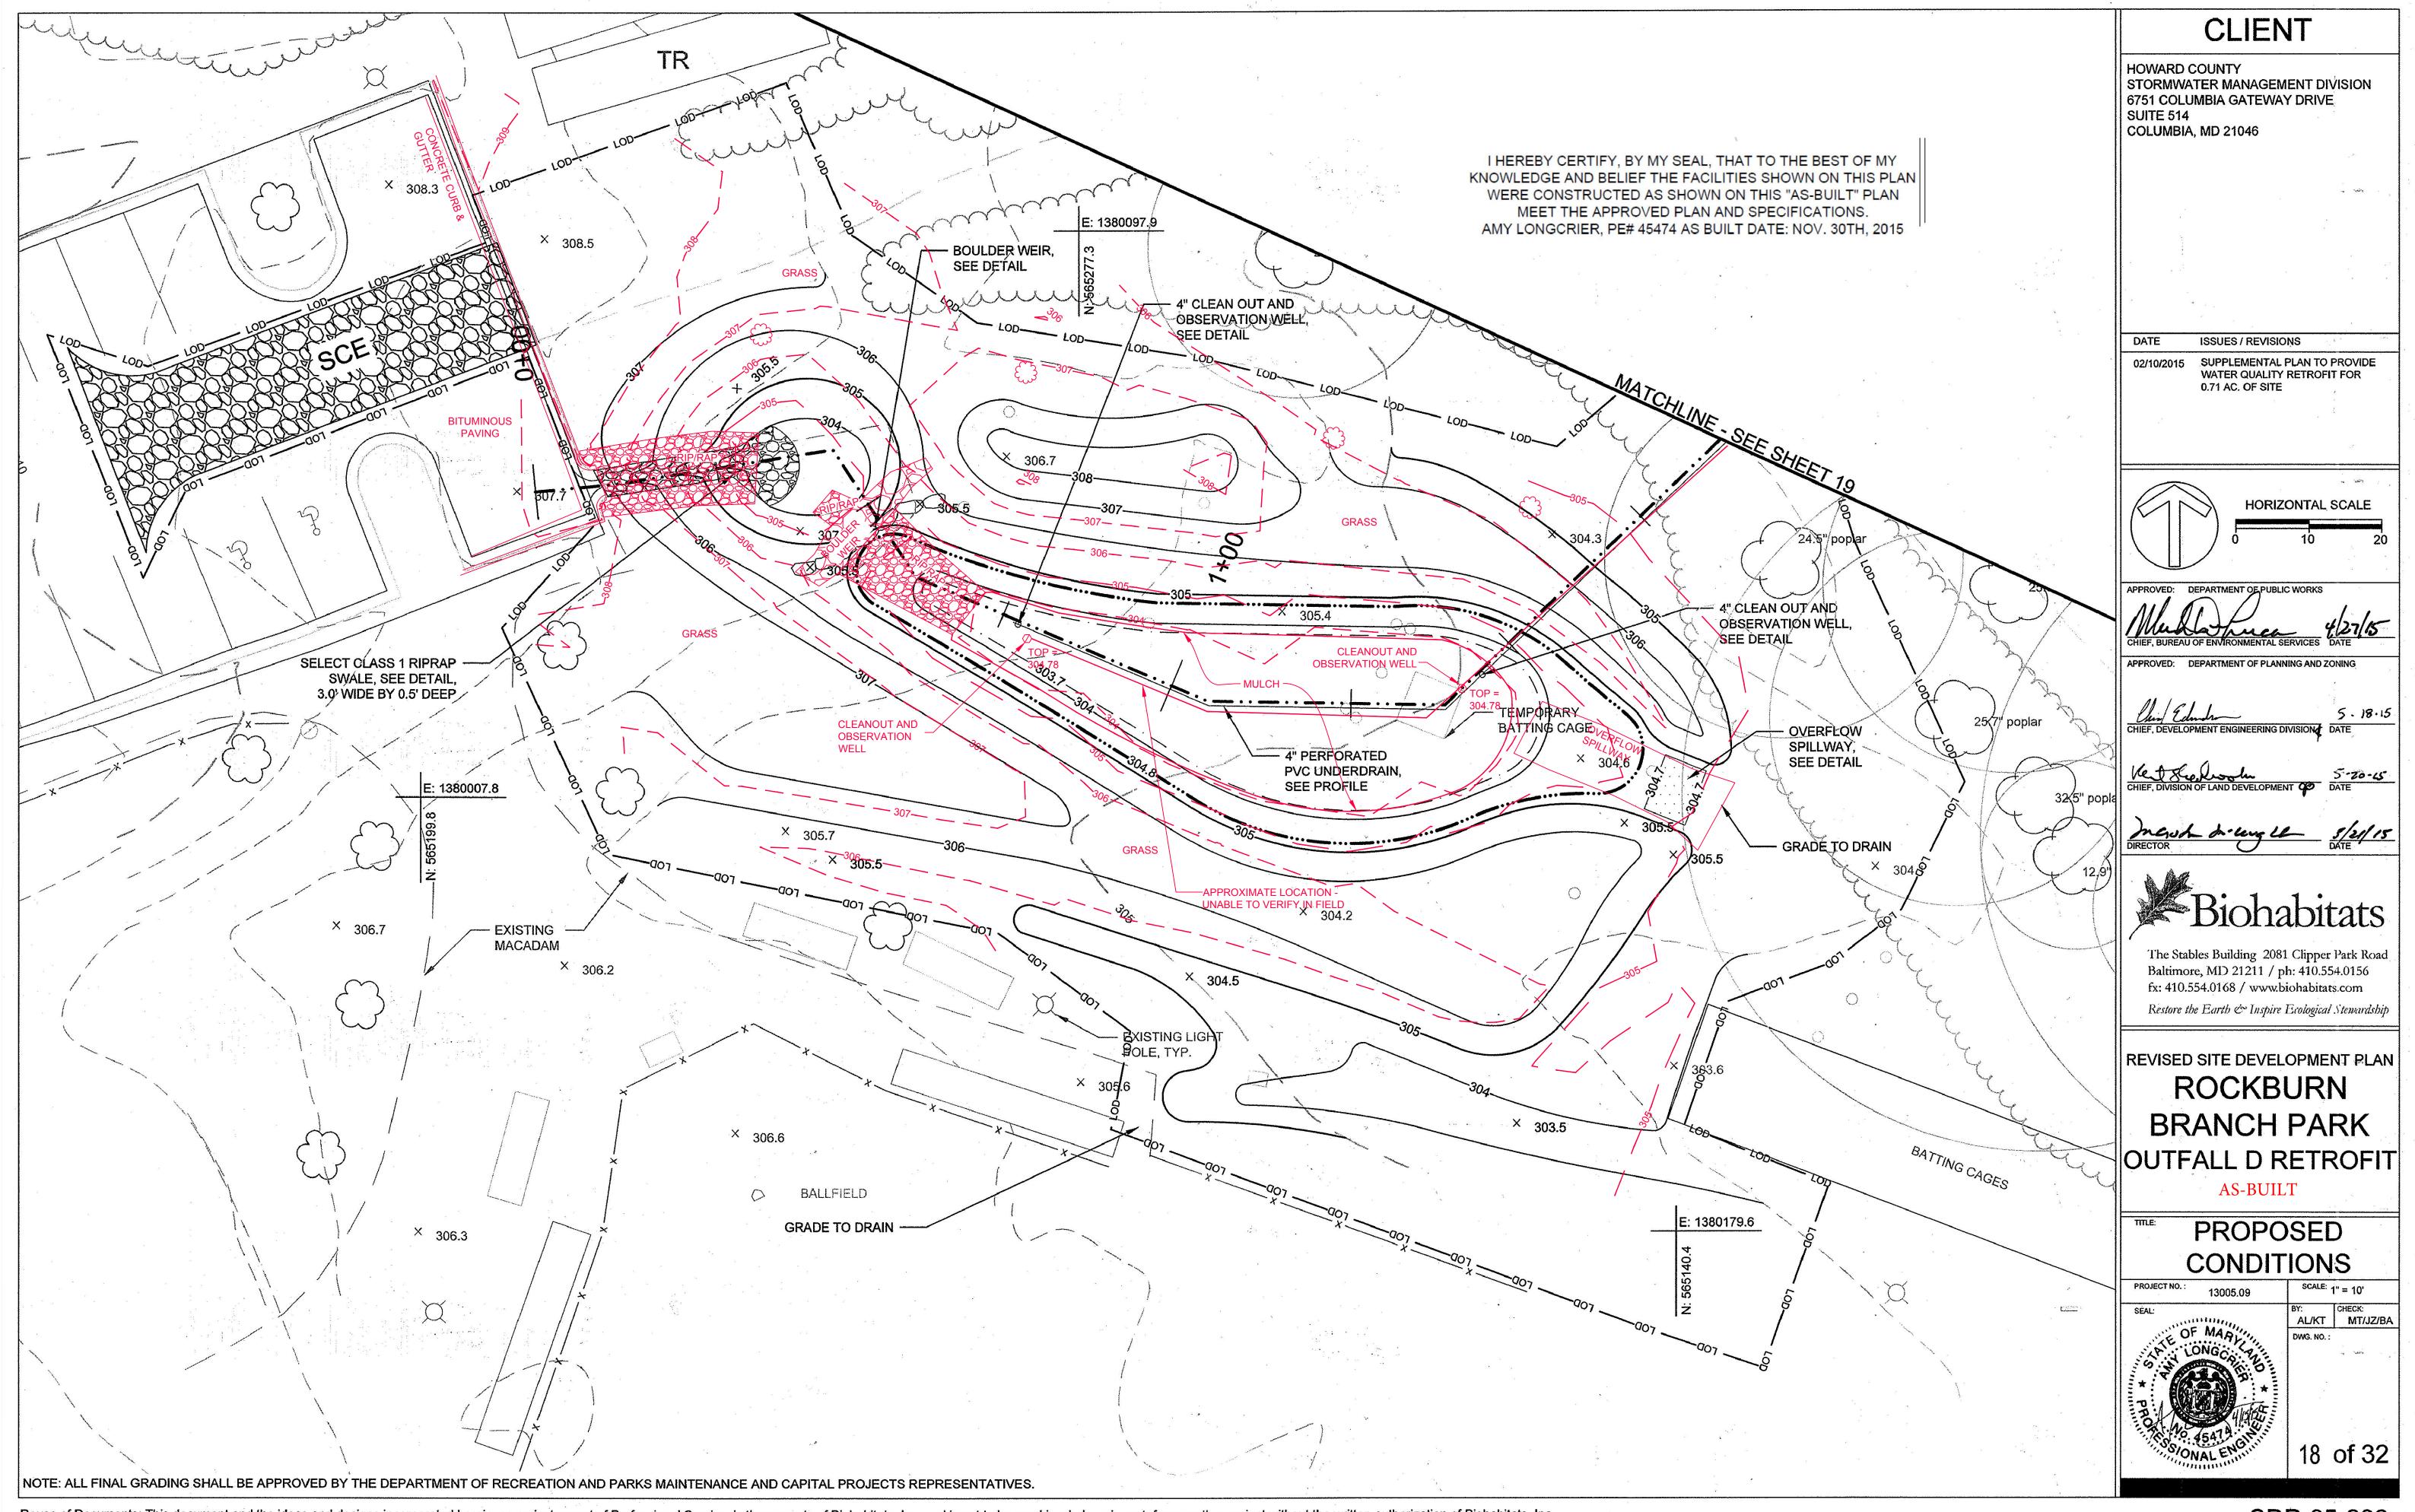
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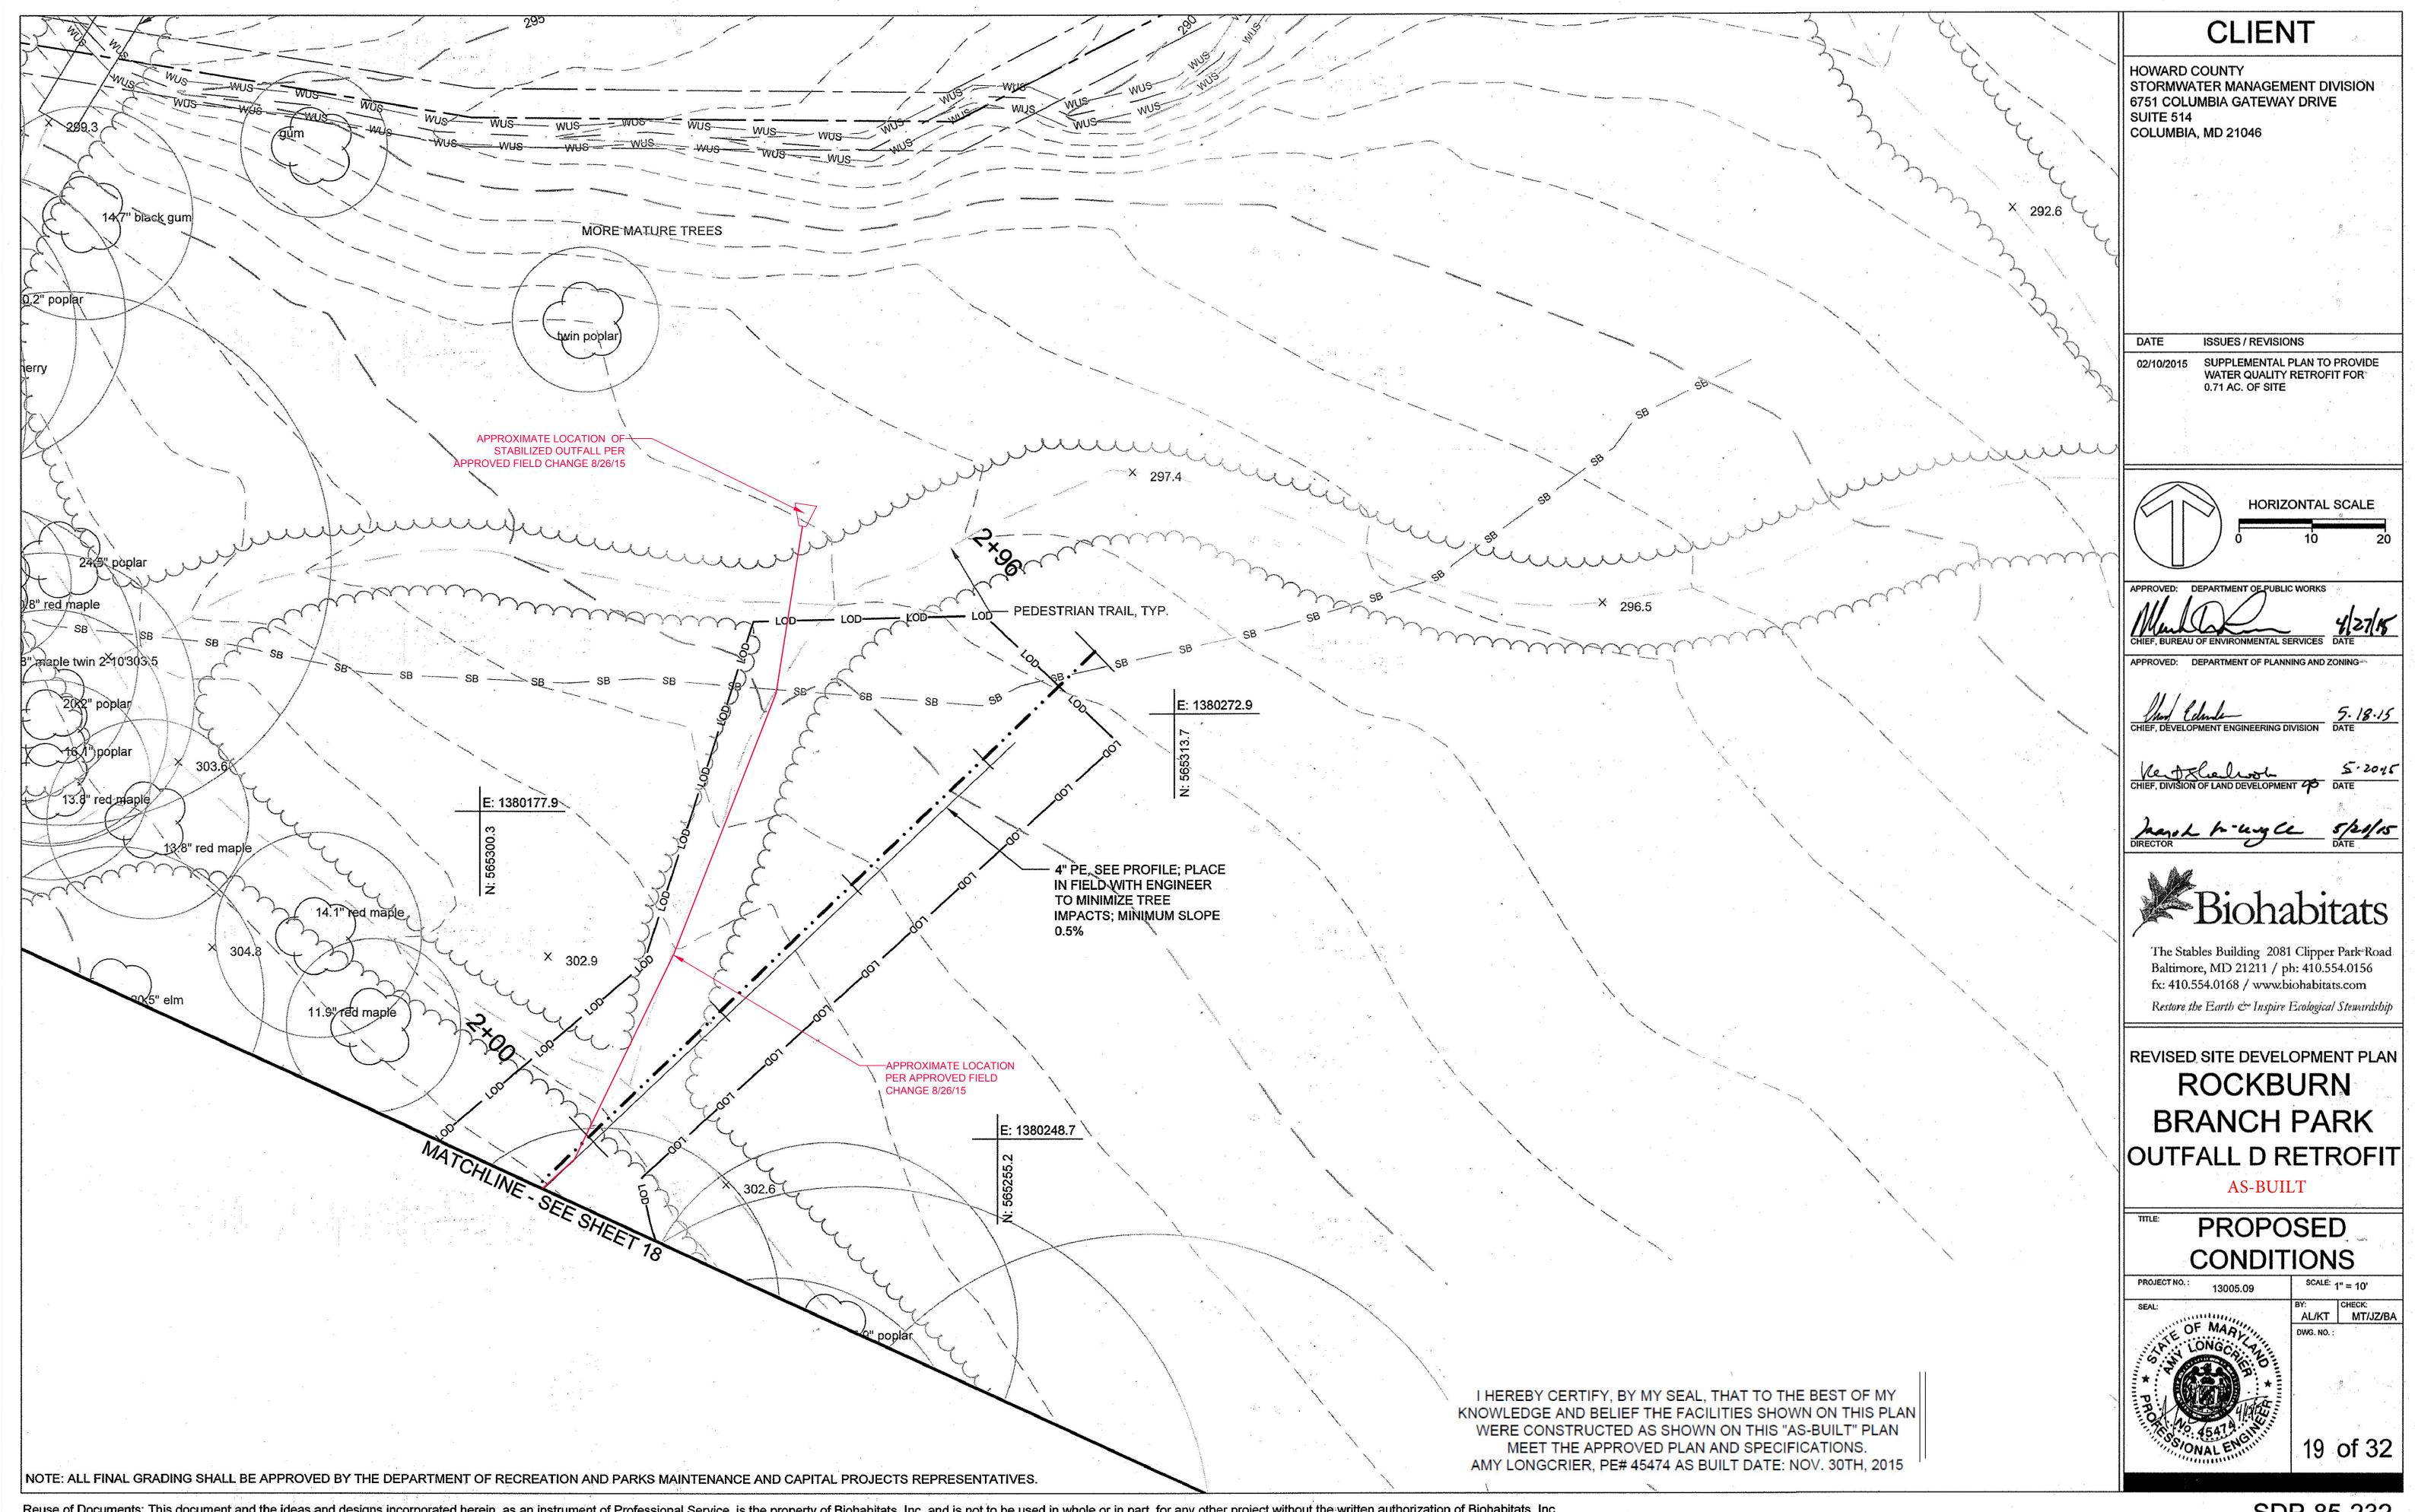
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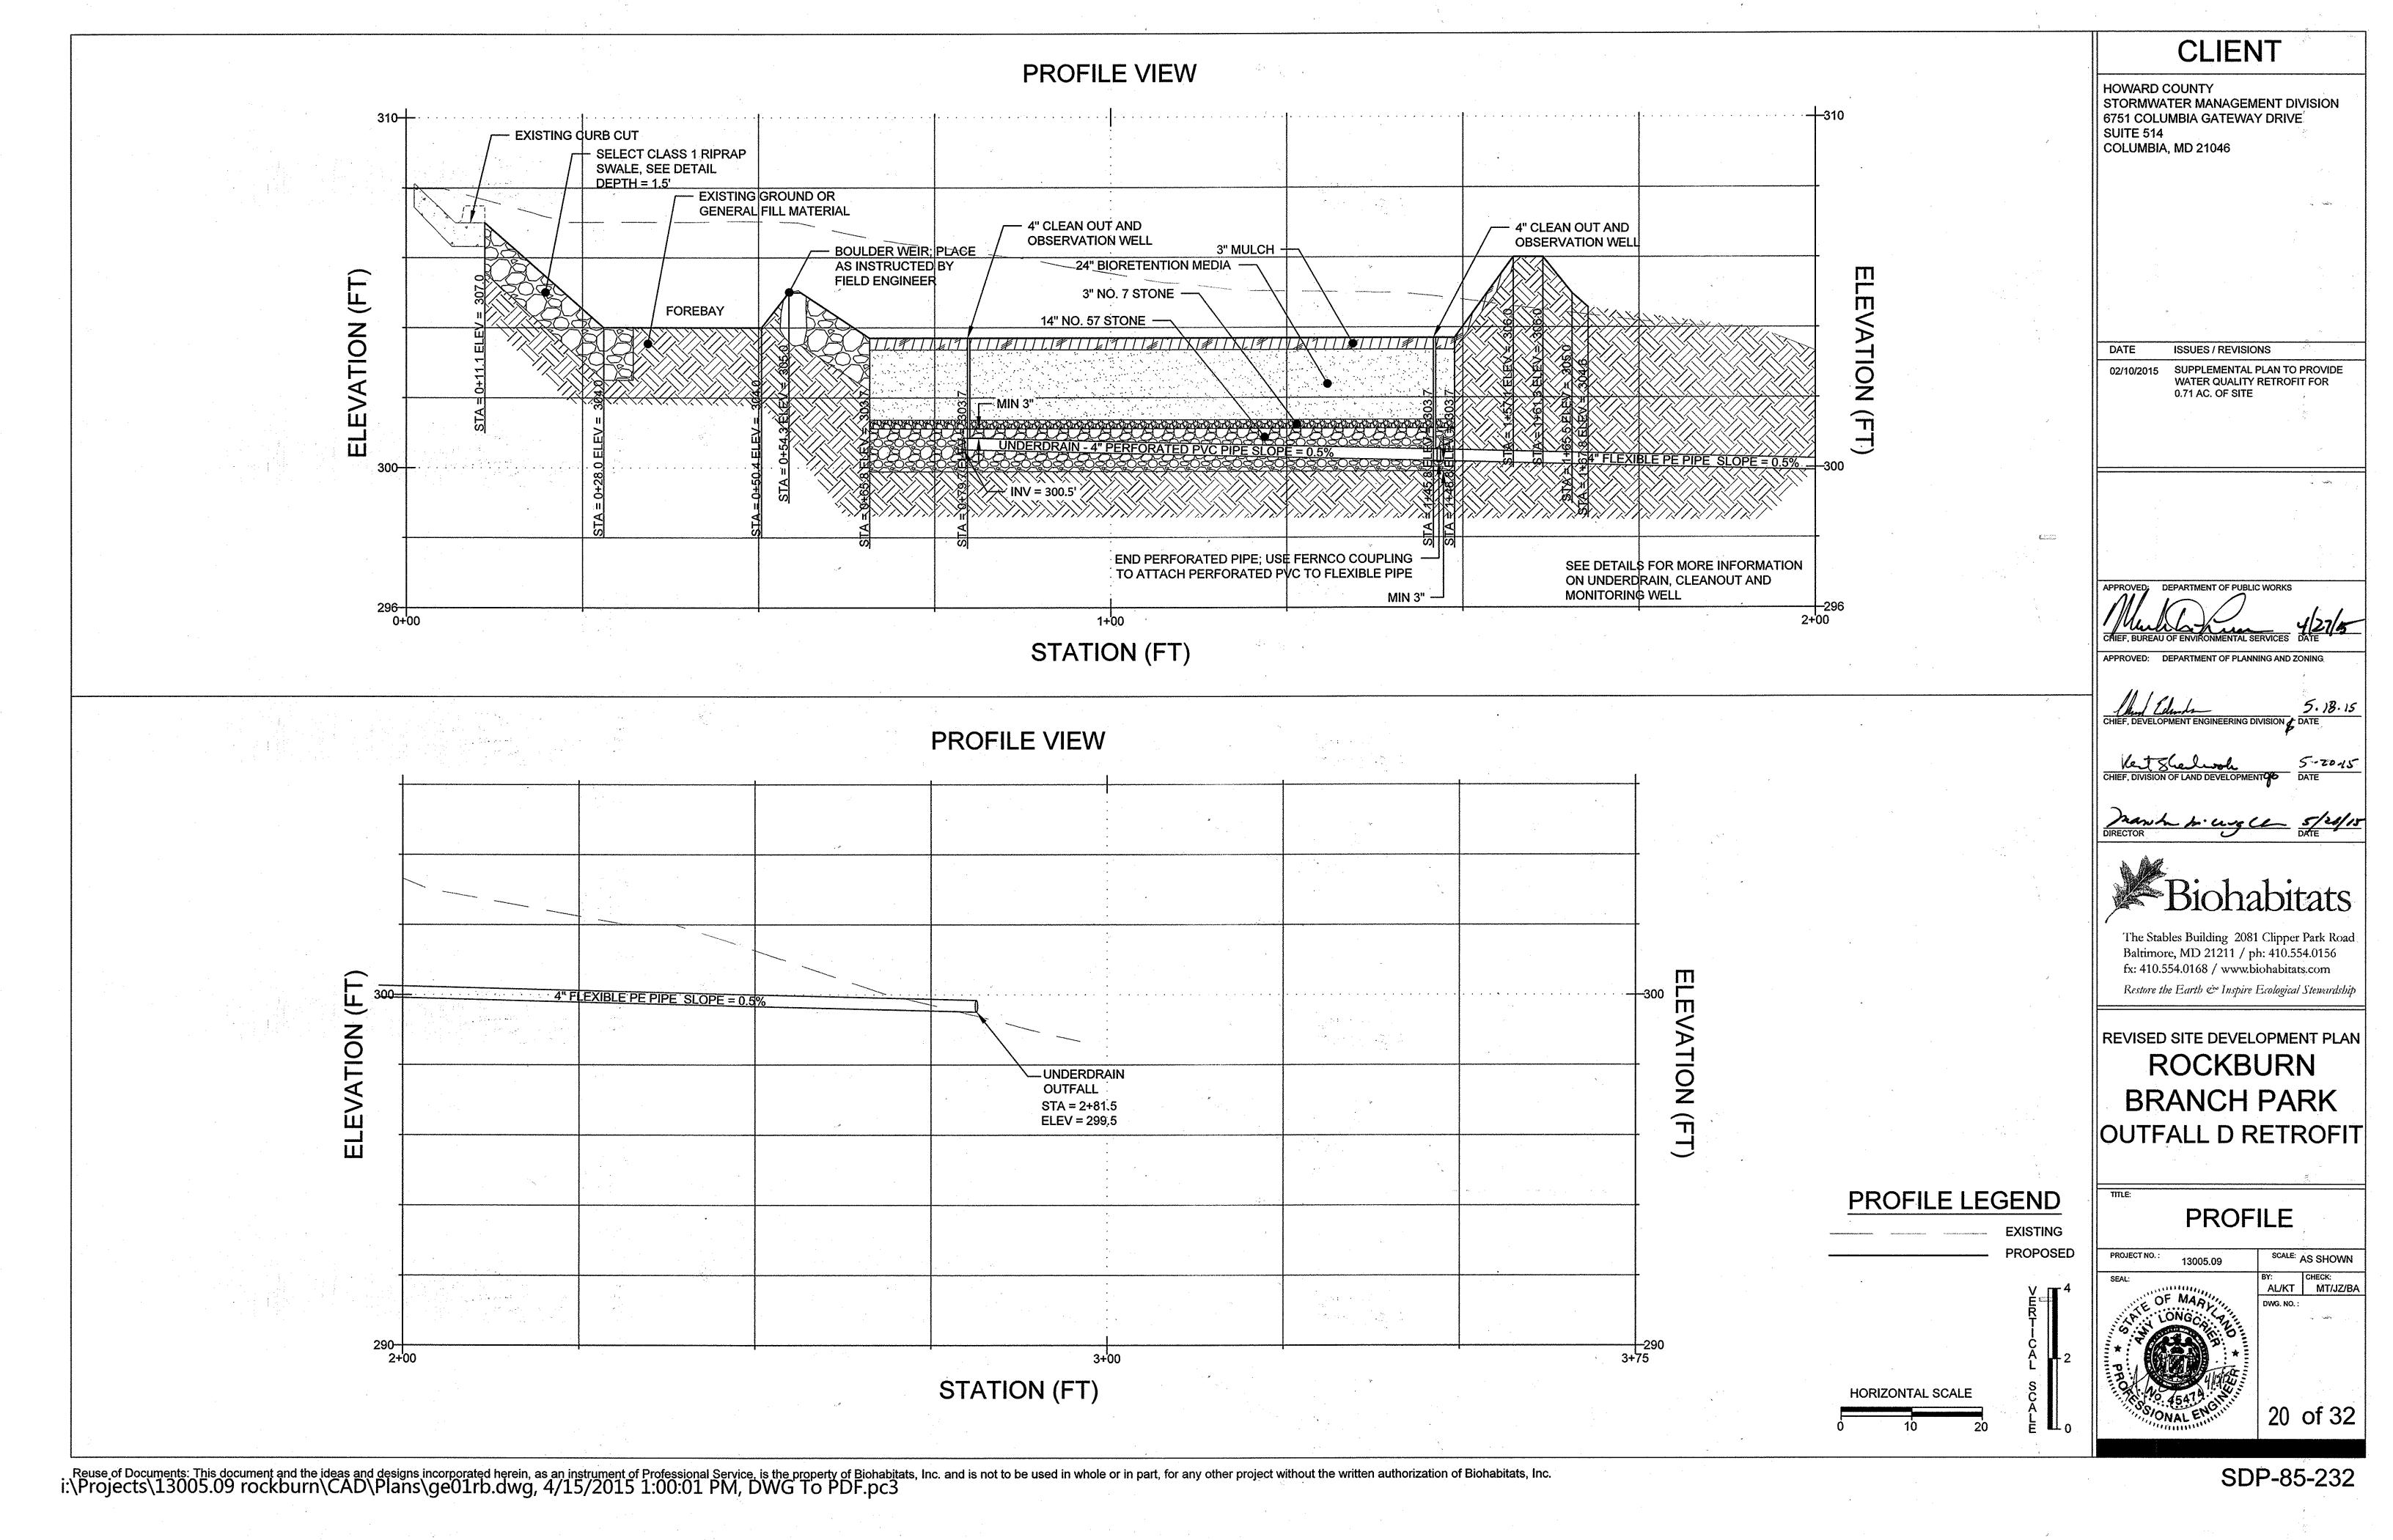
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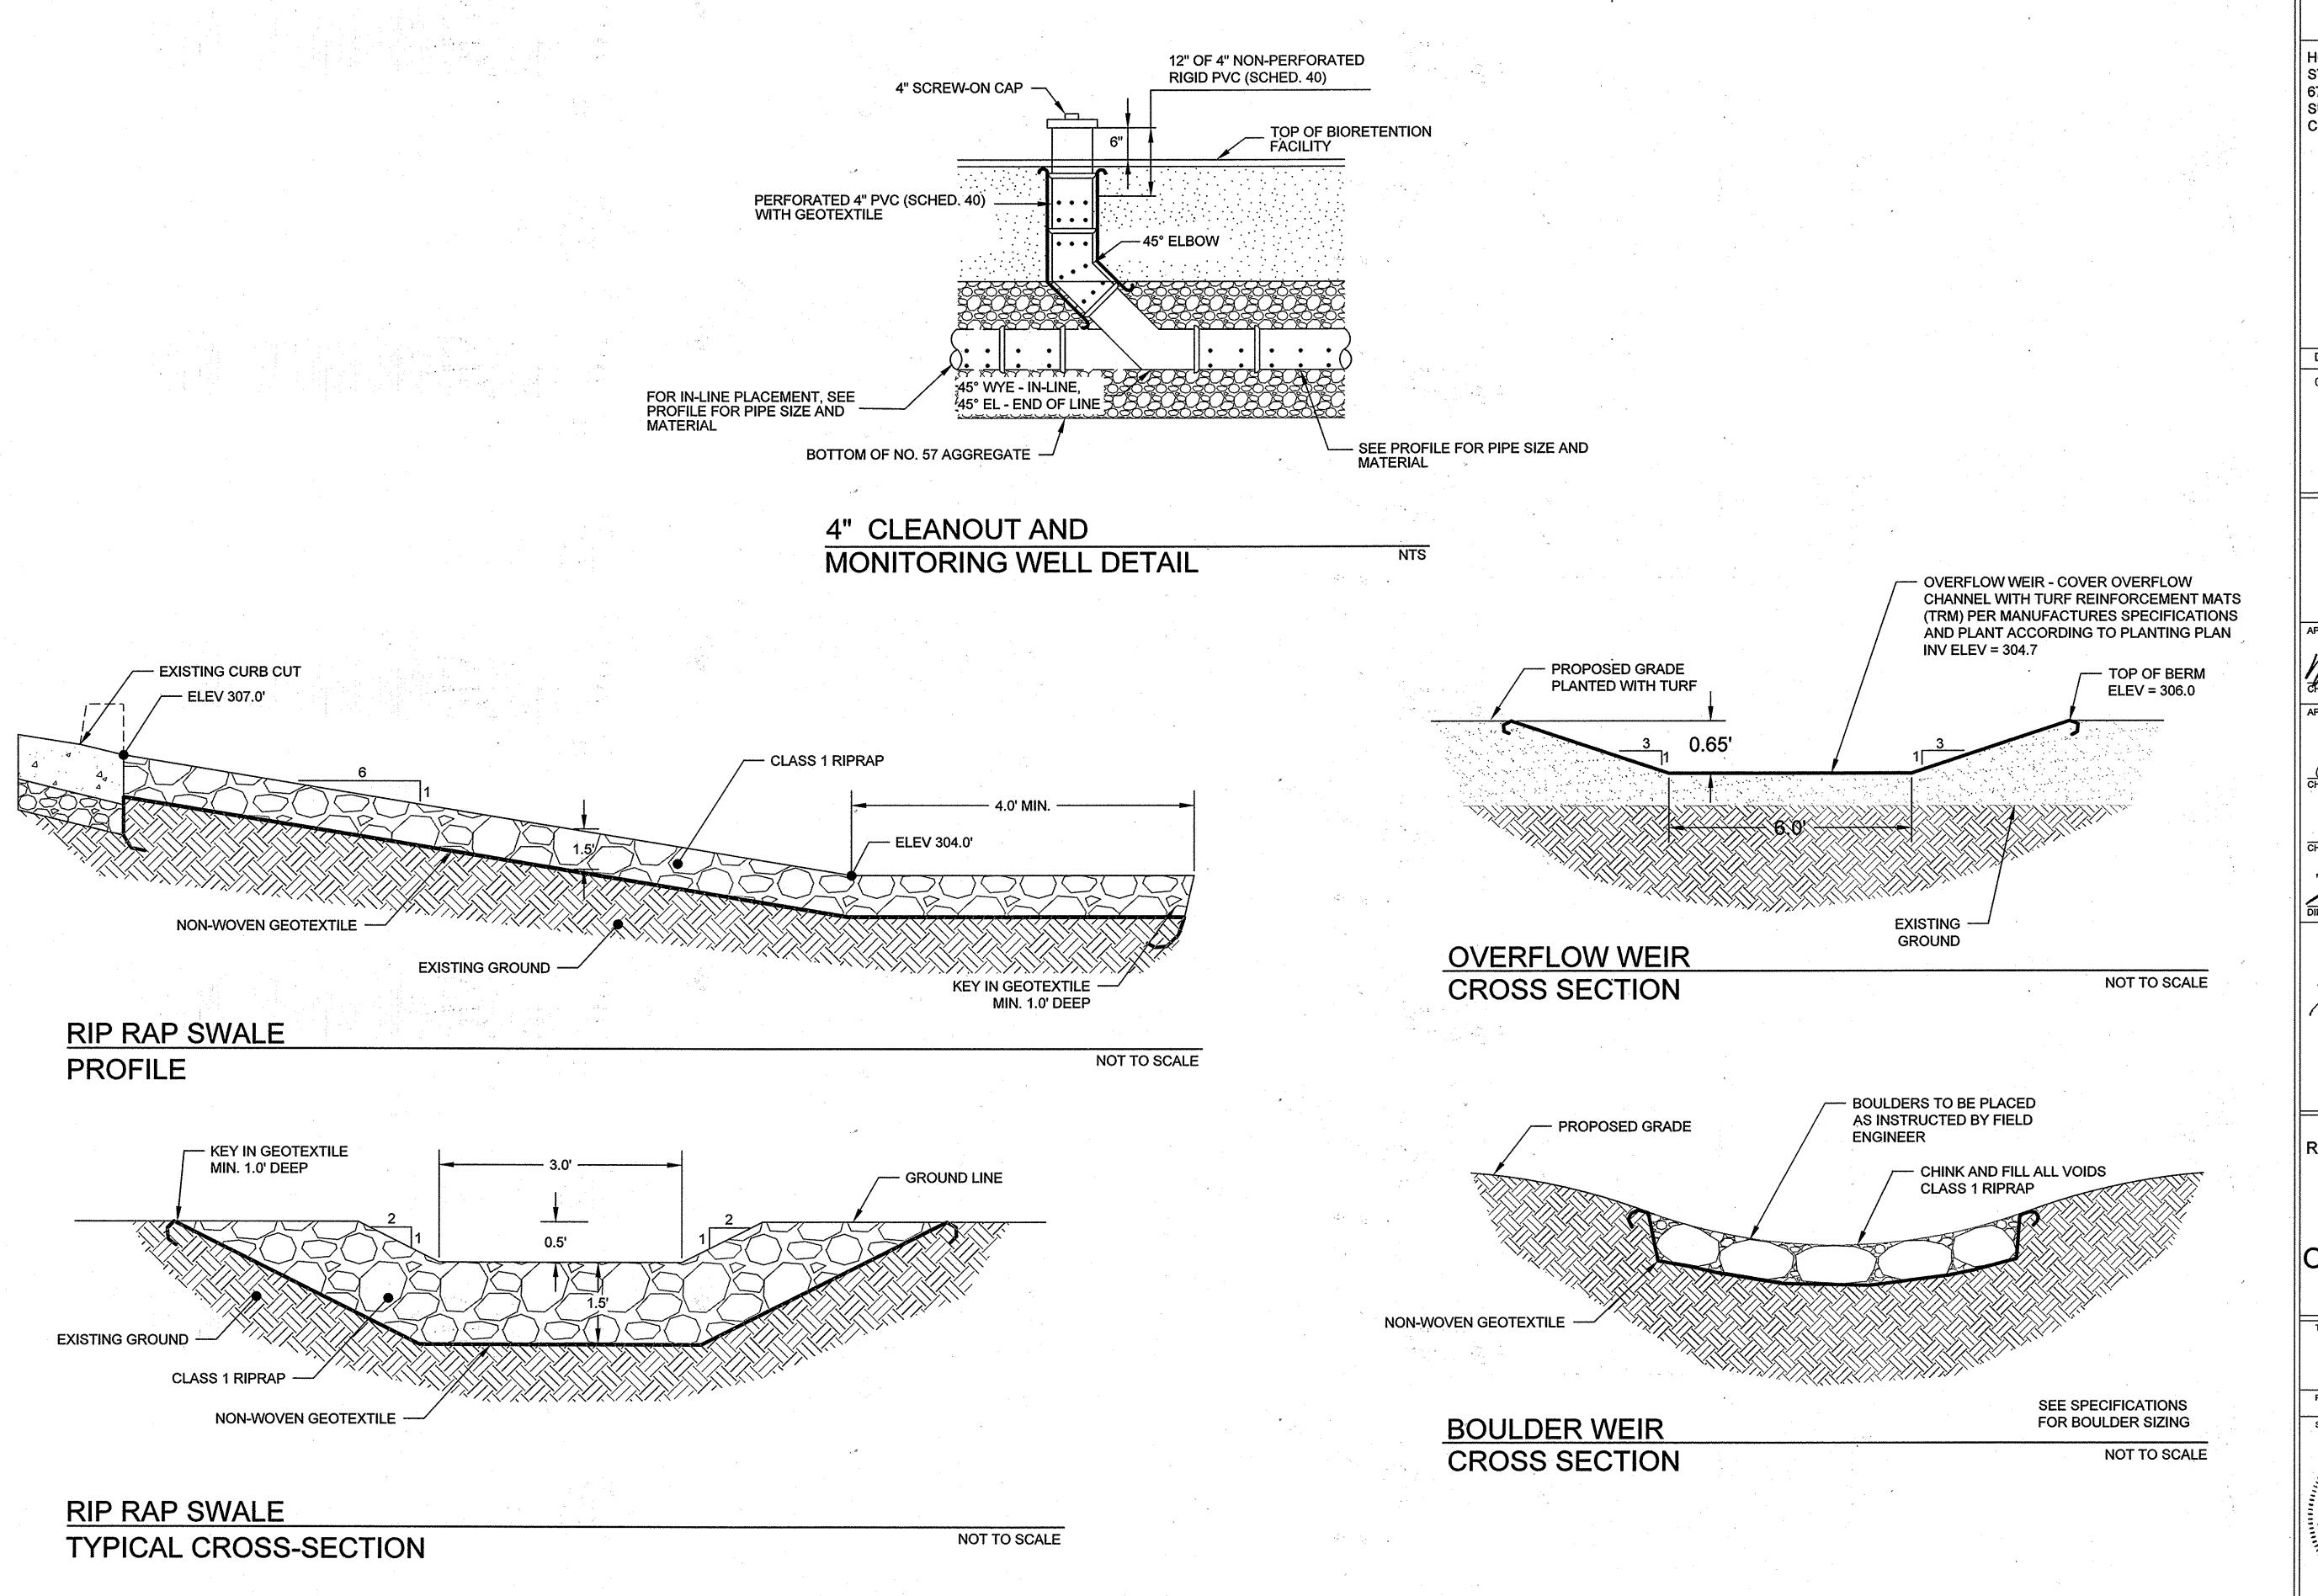










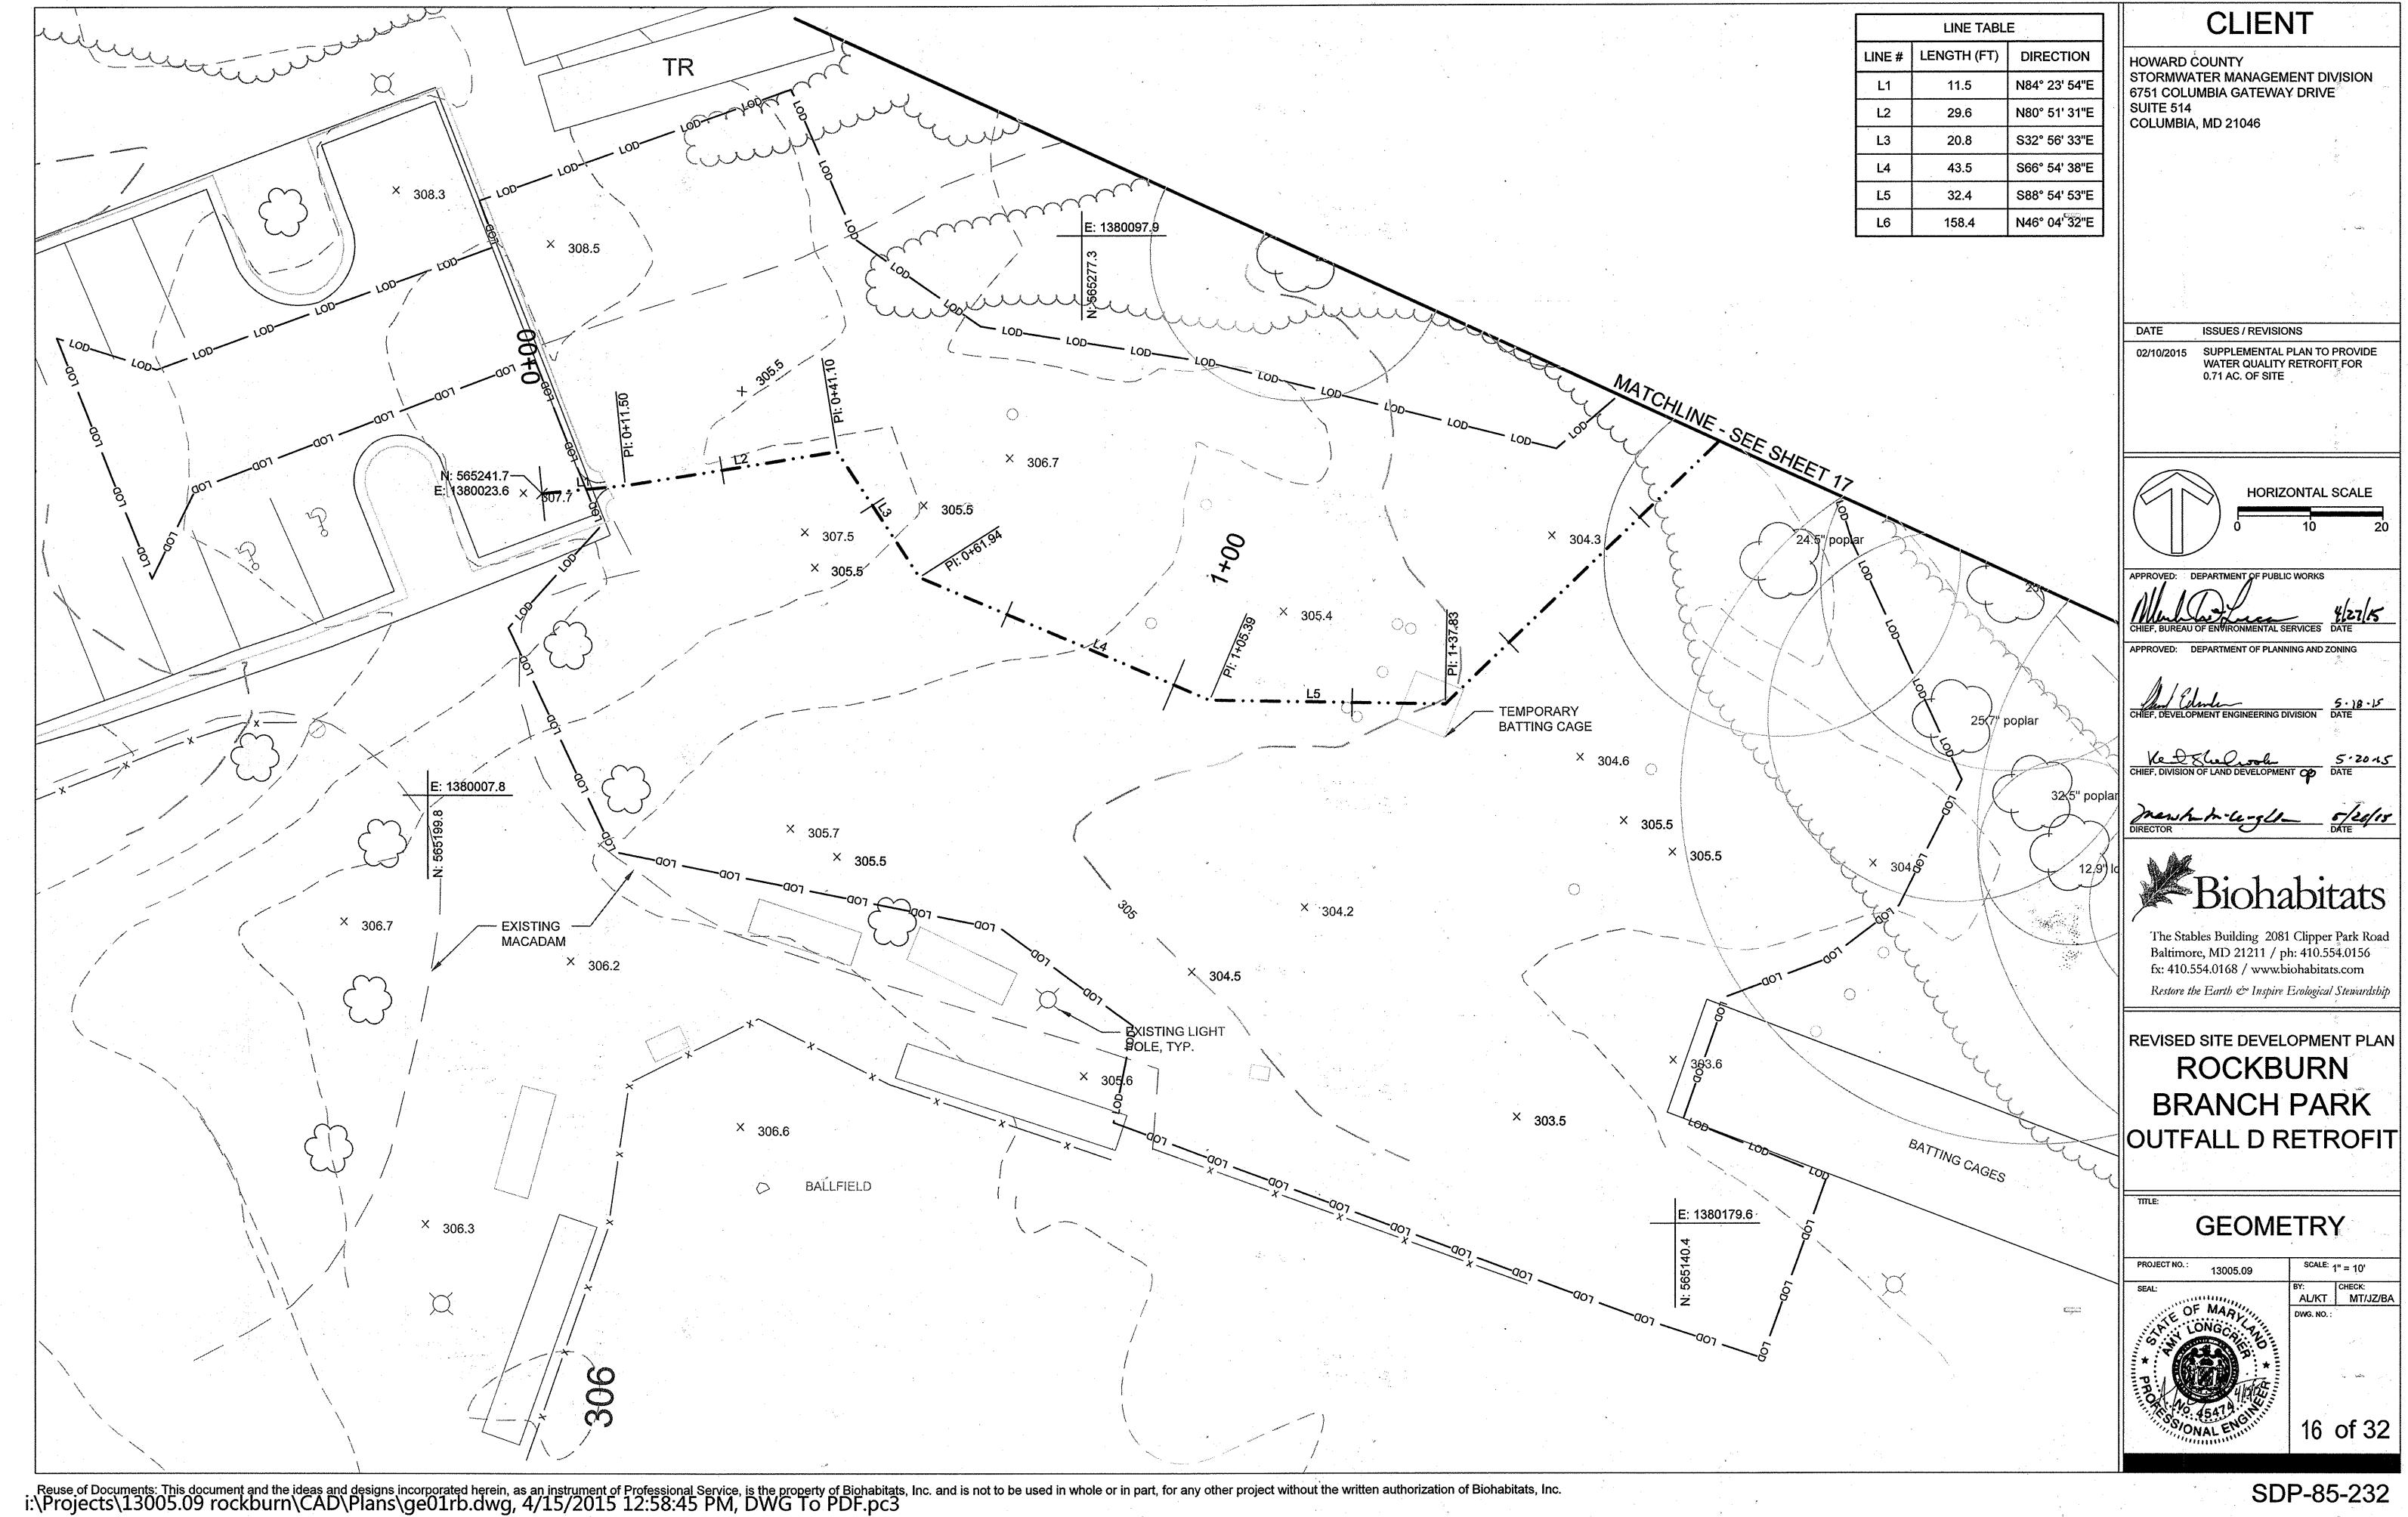

CLIENT

HOWARD COUNTY
STORMWATER MANAGEMENT DIVISION
6751 COLUMBIA GATEWAY DRIVE
SUITE 514
COLUMBIA, MD 21046

DATE

ISSUES / REVISIONS

SUPPLEMENTAL PLAN TO PROVIDE WATER QUALITY RETROFIT FOR 0.71 AC. OF SITE

PPROVED: DEPARTMENT OF PUBLIC WORKS

CHIEF, BUREAU OF ENVIRONMENTAL SERVICES DATE

APPROVED: DEPARTMENT OF PLANNING AND ZONING-

May Cond 5.18.15

Vetshelm 5-20-13

ash he wall speles

Biohabitats

The Stables Building 2081 Clipper Park-Road Baltimore, MID 21211 / ph: 410.554.0156 fx: 410.554.0168 / www.biohabitats.com

Restore the Earth & Inspire Ecological Stewardship

REVISED SITE DEVELOPMENT PLAN
ROCKBURN

BRANCH PARK
OUTFALL D RETROFIT

IIILE.

DETAILS


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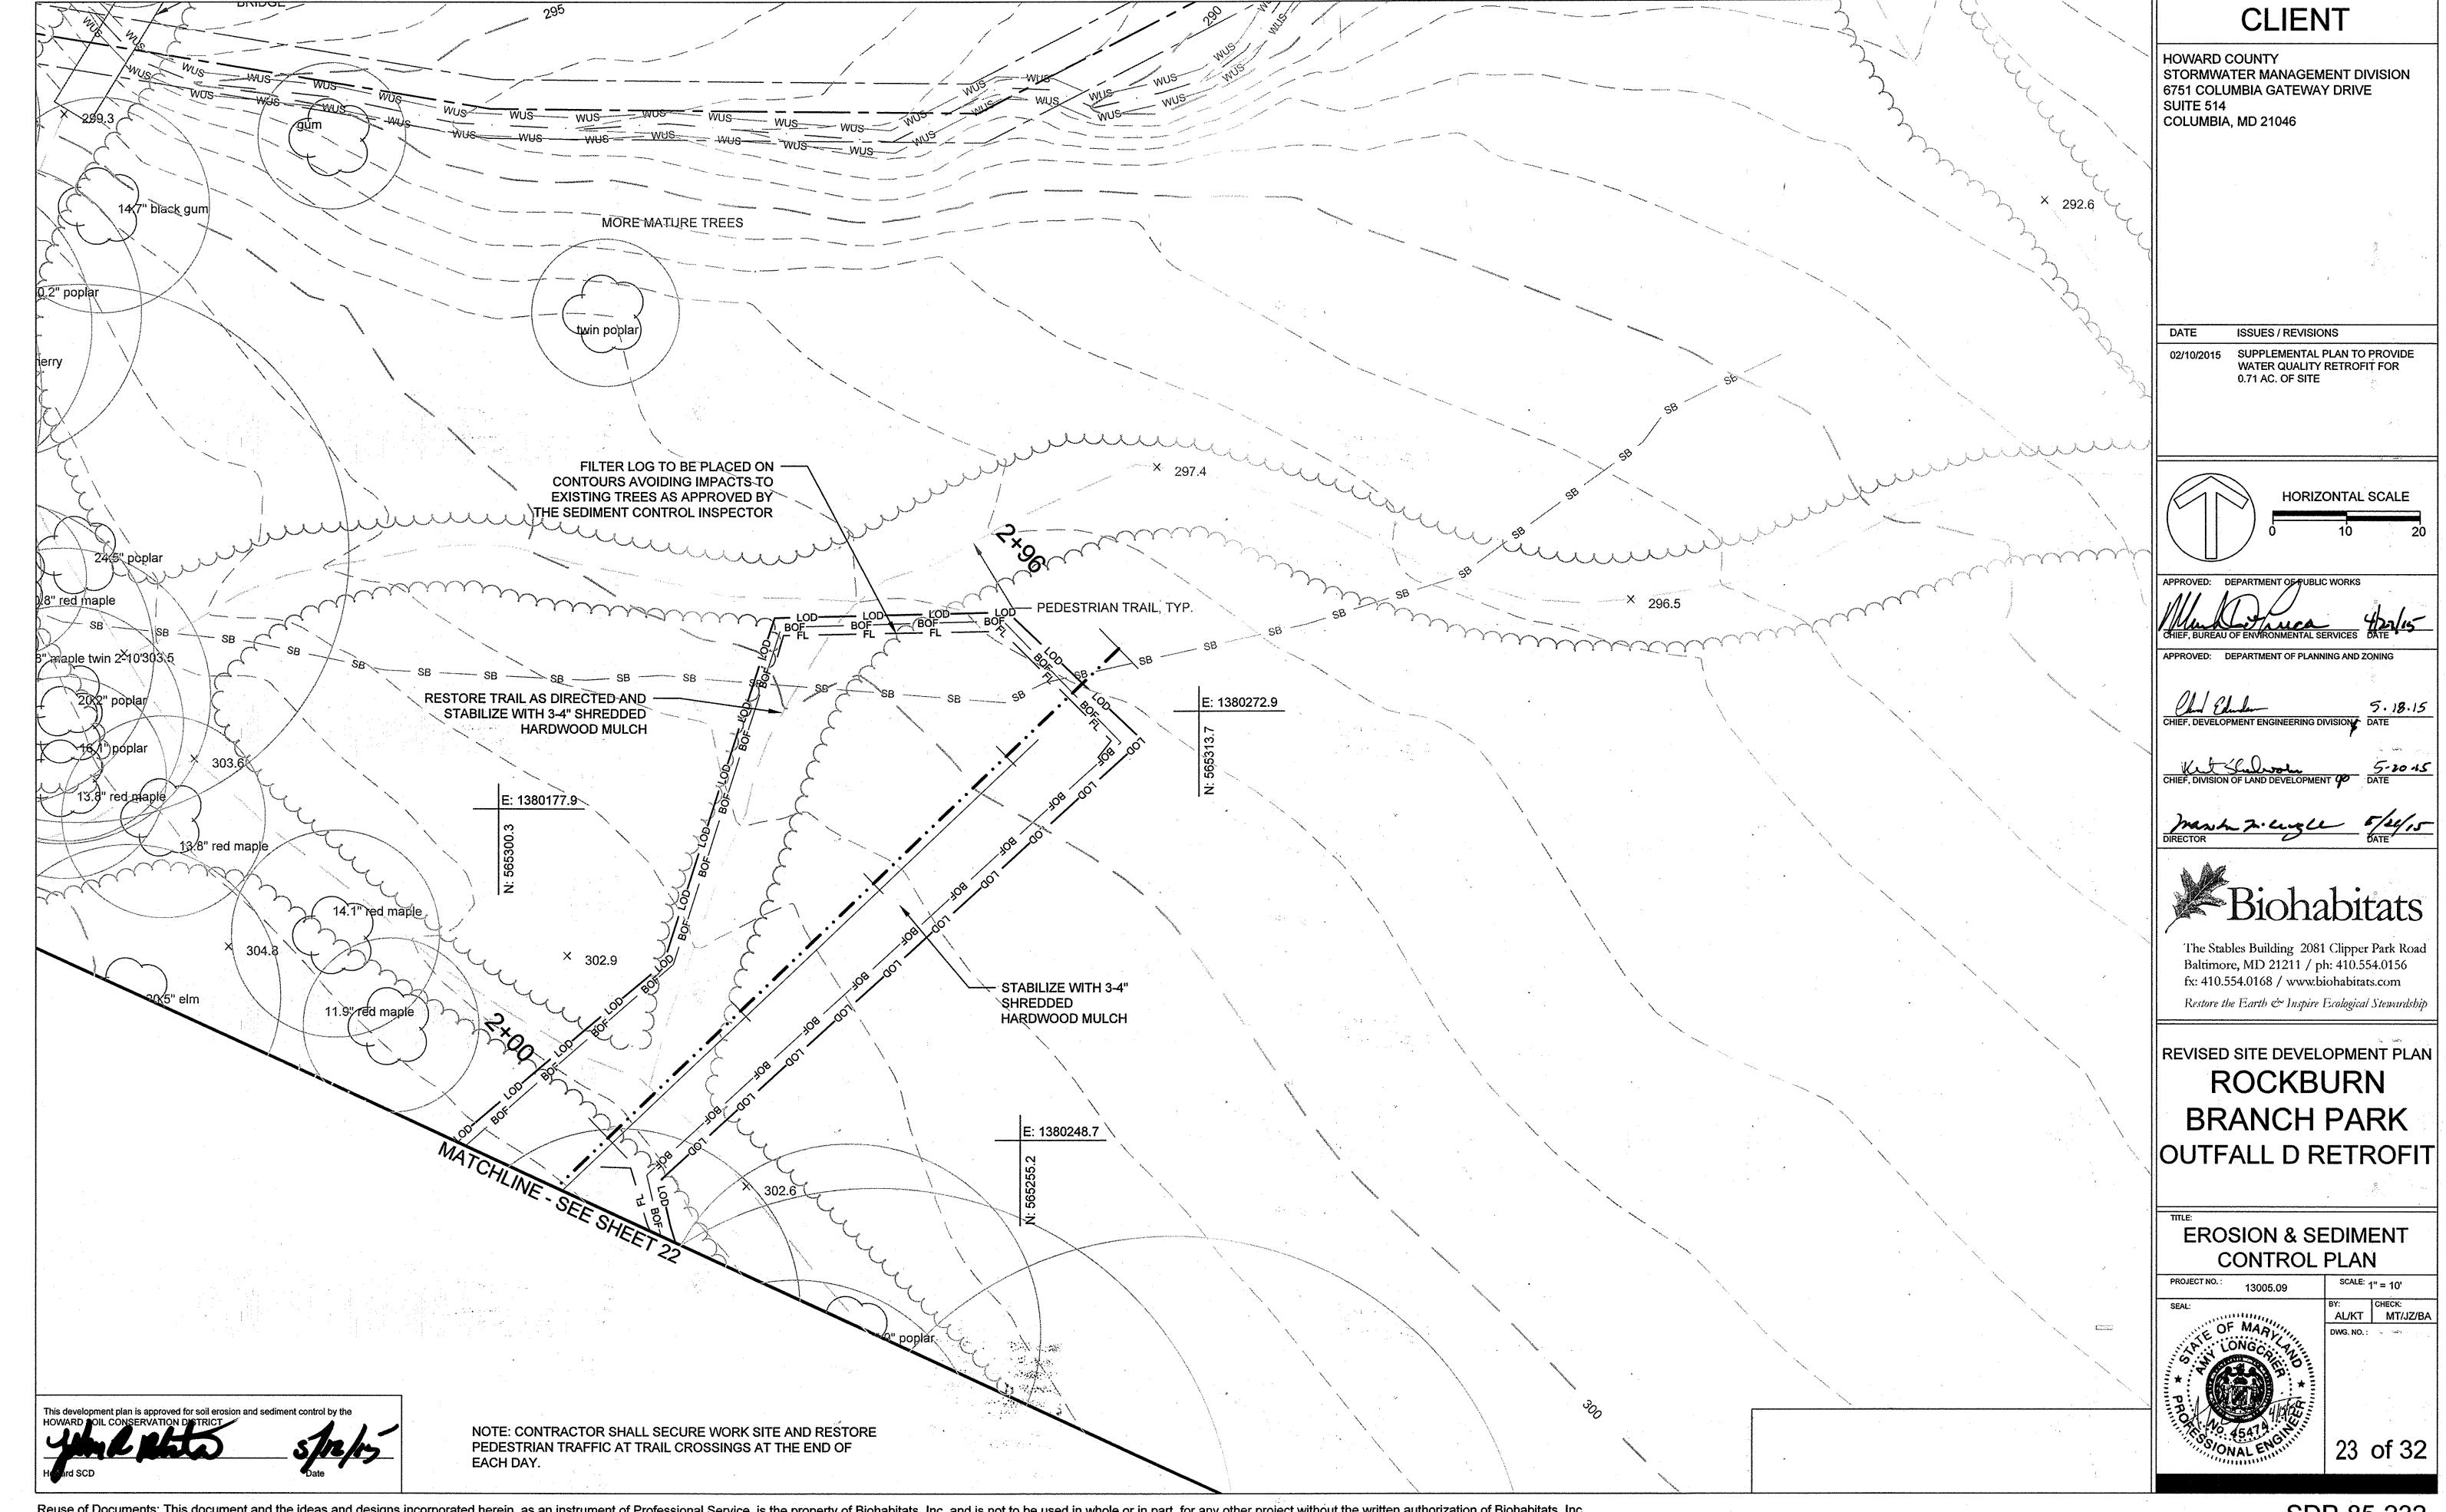
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DWG. NO.:





SEDIMENT CONTROL NOTES

- NOTE: CONDUCT A PRE-CONSTRUCTION MEETING. NOTIFY THE DEPARTMENT OF PUBLIC WORKS, BUREAU OF ENGINEERING/CONSTRUCTION INSPECTION DIVISION AT LEAST 48 HOURS BEFORE COMMENCING WORK AT (410) 313-1880. WORK MAY NOT COMMENCE UNTIL THE PERMITTEE OR THE RESPONSIBLE PE HAVE MET ON SITE WITH THE SEDIMENT AND EROSION CONTROL INSPECTOR TO REVIEW THE APPROVED PLANS
- A MINIMUM OF 48 HOURS NOTICE MUST BE GIVEN TO THE HOWARD COUNTY DEPARTMENT OF INSPECTIONS, LICENCES AND PERMITS, SEDIMENT CONTROL DIVISION PRIOR TO THE START OF ANY CONSTRUCTION (313-1855)
- THE CONTRACTOR SHALL NOTIFY "MISS-UTILITY" AT 1-800-257-7777 AT LEAST 48 HOURS PRIOR TO ANY EXCAVATION WORK BEING DONE.
- ALL VEGETATIVE AND STRUCTURAL PRATICES ARE TO BE INSTALLED ACCORDING TO THE PROVISIONS OF THIS PLAN AND ARE TO BE IN CONFORMANCE WITH THE MOST CURRENT MARYLAND STANDARDS AND SPECIFICATIONS FOR SOIL EROSION AND SEDIMENT CONTROL AND REVISIONS THERETO.
- CONSTRUCTION ACTIVITIES INCLUDING THE INSTALLATION OF EROSION AND SEDIMENT CONTROL MEASURES SHALL NOT BEGIN UNTIL ALL REQUIRED EASEMENTS AND RIGHT-OF-WAYS HAVE BEEN OBTAINED. CONSTRUCTION SHALL NOT BEGIN UNTIL ALL SEDIMENT AND EROSION CONTROL MEASURES HAVE BEEN INSTALLED AND APPROVED BY THE ENGINEER AND THE SEDIMENT CONTROL INSPECTOR. THE CONTRACTOR SHALL STAY WITHIN THE LIMIT OF DISTURBANCE AS SHOWN ON THE PLANS AND MINIMIZE DISTURBANCE WITHIN THE WORKING AREA WHEREEVER POSSIBLE. NO TREES SHALL BE REMOVED WITHIN THE LIMIT OF DISTURBANCE WITHOUT APPROVAL FROM THE ENGINEER THE CONSTRUCTION SEQUENCE MUST BE FOLLOWED UNLESS THE CONTRACTOR GETS WRITTEN APPROVAL FROMN THE HOWARD COUNTY SOIL CONSERVATION DISTRICT OR THE SEDIMENT CONTROL INSPECTOR
- FOR ALL ASPECTS OF CONSTRUCTION FOLLOWING INITIAL SOIL DISTURBANCE OR RE-DISTURBANCE, PERMANENT OR TEMPORARY STABILIZATION MUST BE COMPLETED WITHIN:
- THREE (3) CALENDAR DAYS AS TO THE SURFACE OF ALL PERIMETER DIKES, SWALES DITCHES, PERIMETER SLOPES, AND ALL SLOPES STEEPER THAN 3 HORIZONTAL TO 1 VERTICAL (3:1): AND
- SEVEN (7) CALENDAR DAYS AS TO ALL OTHER DISTURBED OR GRADED AREAS ON THE PROJECT SITE NOT UNDER ACTIVE GRADING.
- ANY SEDIMENT CONTROL PRACTICE THAT IS DISTURBED BY GRADING ACTIVITY FOR PLACEMENT OF UTILITIES MUST BE REPAIRED ON THE SAME DAY OF DISTURBANCE. ADDITIONAL SEDIMENT CONTROL MUST BE PROVIDED. IF DEEMED NECESSARY BY THE
- HOWARD COUNTY SEDIMENT CONTROL INSPECTOR. TRENCHES FOR THE CONSTRUCTION OF UTLITIES IS LIMITED TO THREE PIPE LENGTHS OR THAT WHICH SHALL BE BACK-FILLED AND STABILIZED BY THE END OF EACH WORK DAY. WHICHEVER IS SHORTER.

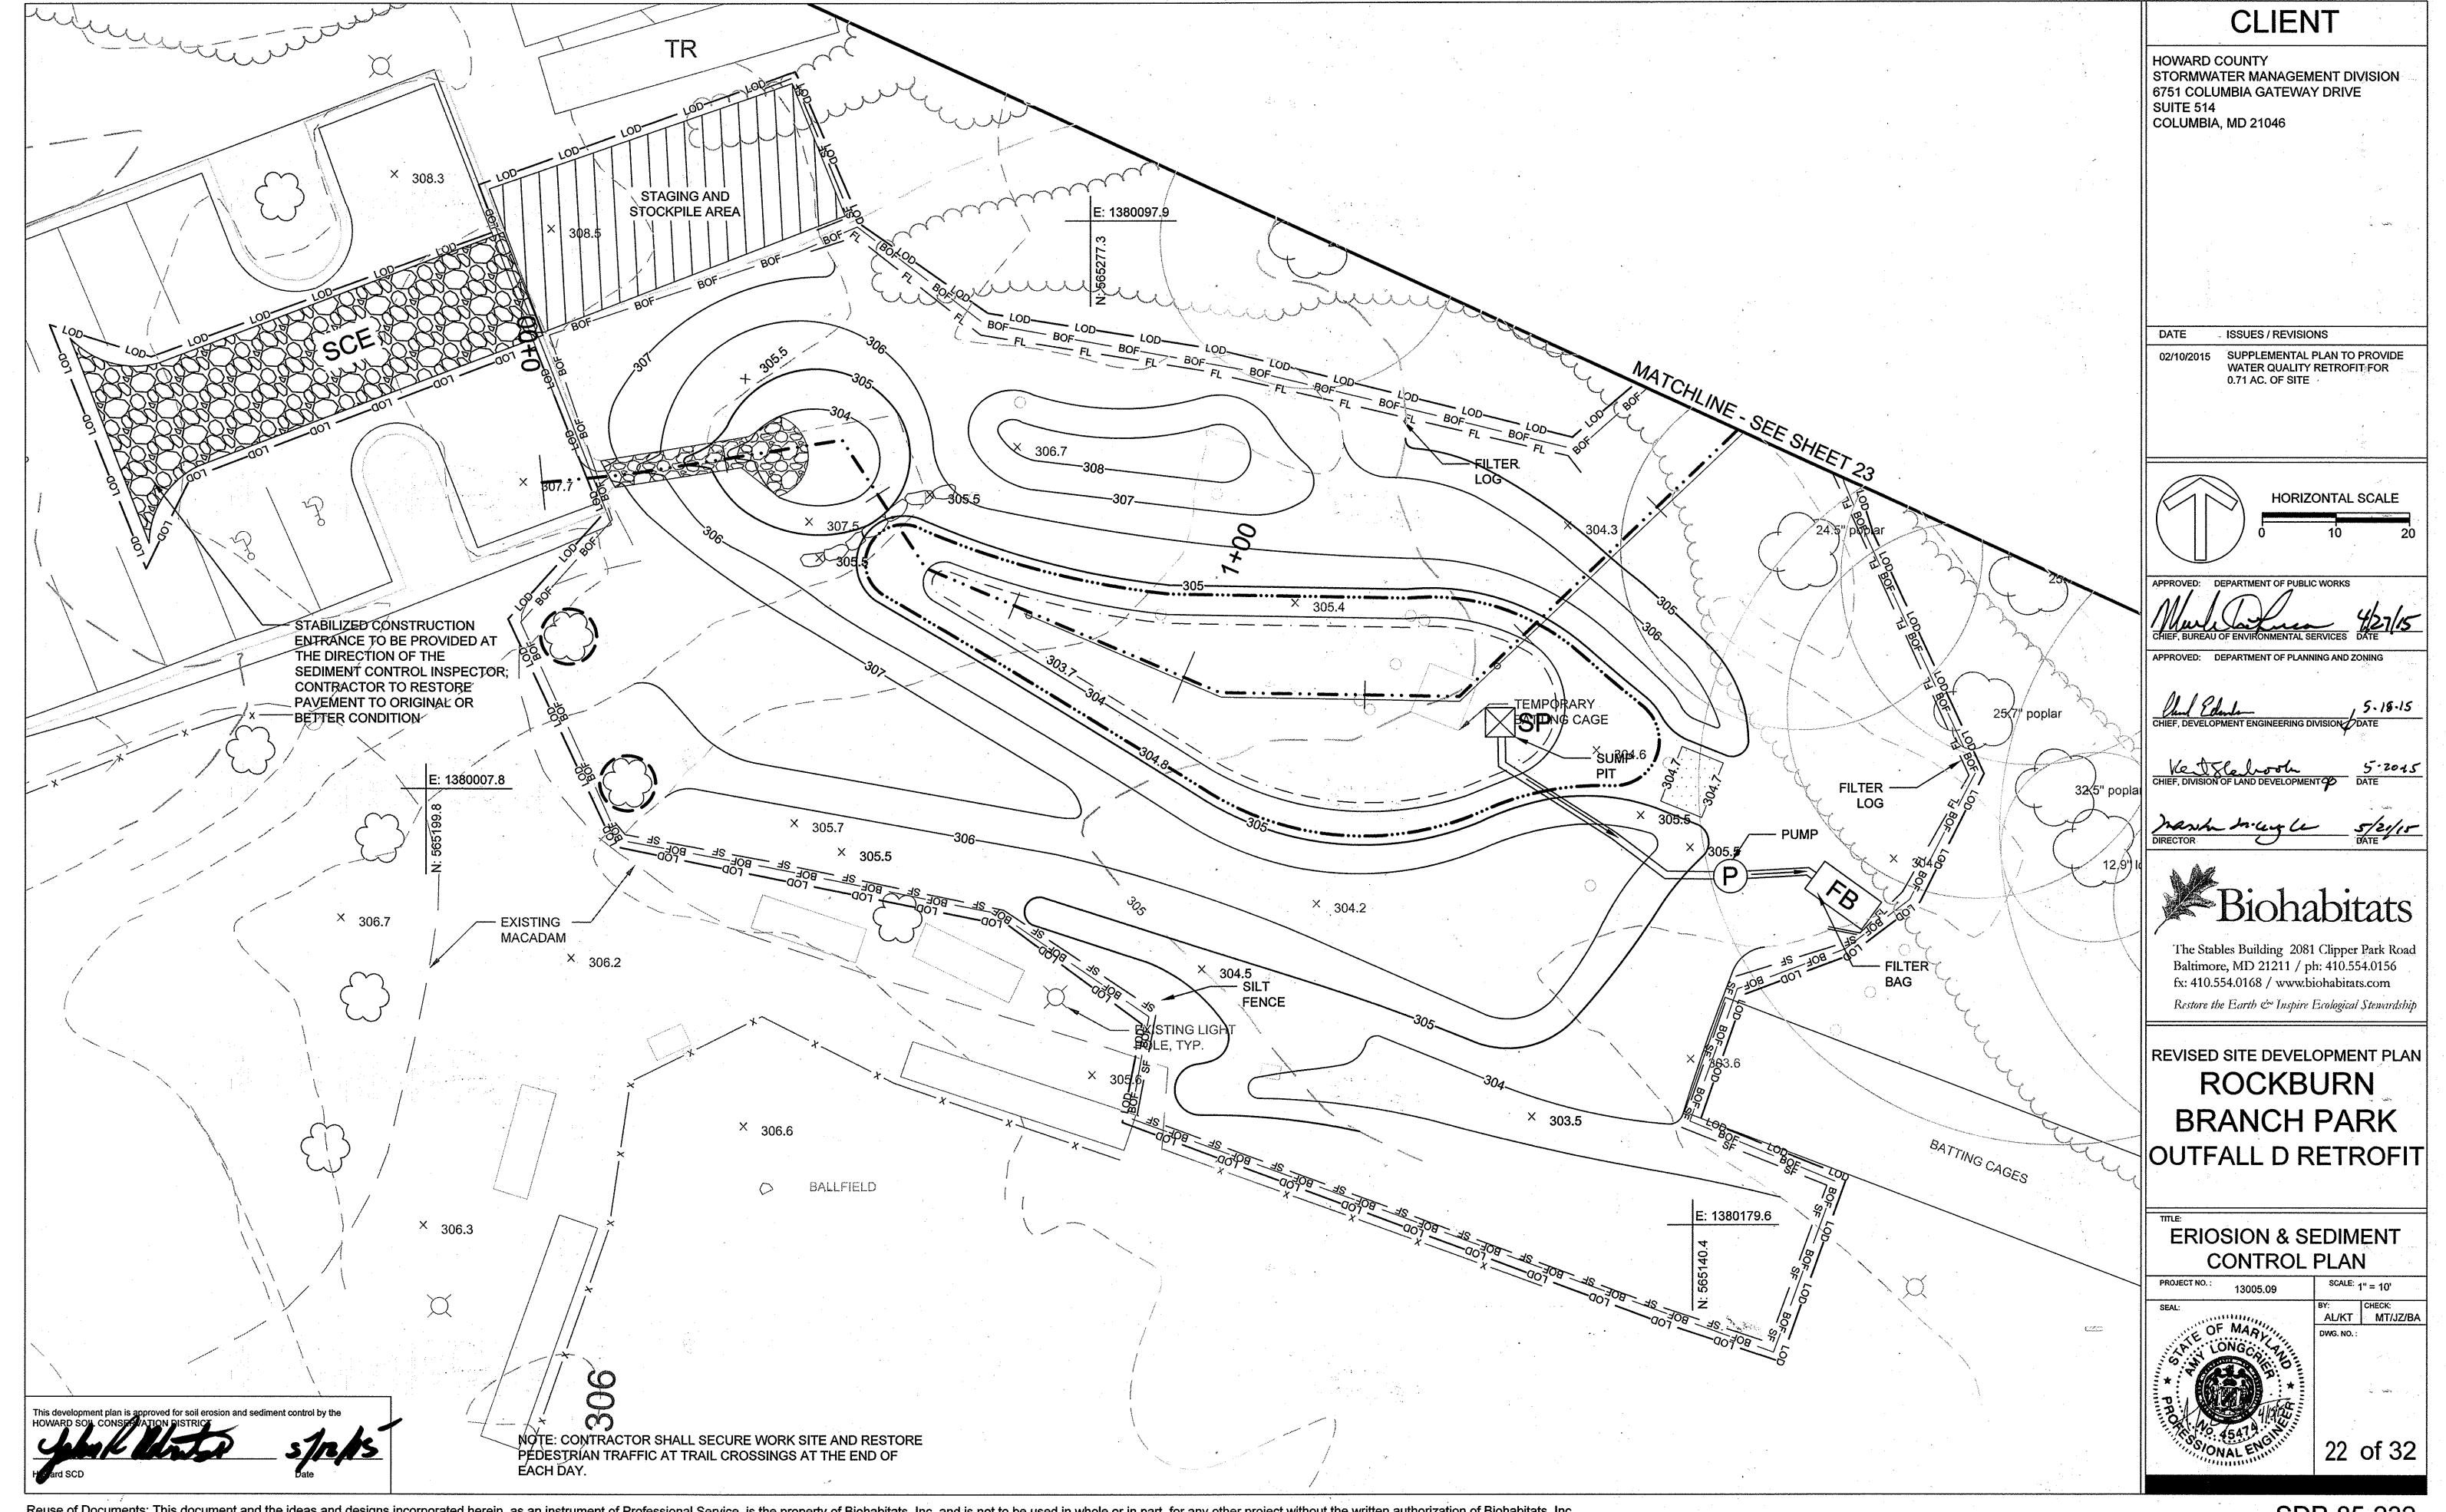SEQUENCE OF CONSTRUCTION

EROSION AND SEDIMENT CONTROL SETUP - 1 WEEK

- 1. THE CONTRACTOR SHALL STAKE OUT THE LIMITS OF DISTURBANCE AS SHOWN ON THE **GRADING PLAN. (1 DAY)**
- 2. THE CONTRACTOR SHALL CONDUCT A PRE-CONSTRUCTION MEETING ONSITE WITH SEDIMENT CONTROL INSPECTOR AND THE ENGINEER TO REVIEW THE LIMITS OF DISTURBANCE, STRUCTURE STAKEOUT, EROSION AND SEDIMENT CONTROL REQUIREMENTS. AND THE SEQUENCE OF CONSTRUCTION. THE PARTICIPANTS WILL ALSO VERIFY THE LOCATION OF THE TEMPORARY STOCKPILE AREA AND ANY NECESSARY STAGING AREA, AND FLAG ANY TREES WITHIN THE LIMITS OF DISTURBANCE WHICH WILL BE REMOVED FOR CONSTRUCTION ACCESS AND GRADING. (1 DAY)
- THE CONTRACTOR SHALL INSTALL THE STABILIZED CONSTRUCTION ENTRANCE AND BLAZE ORANCE FENCE AND TREE PROTECTION AREAS AS SHOWN ON THE GRADING PLANS OR AS DIRECTED BY THE ENGINEER. (1 DAY)
- 4. THE CONTRACTOR SHALL ESTABLISH THE TEMPORARY STOCKPILE AREA IN THE LOCATION INDICATED ON THE GRADING PLAN (NOTE: INSTALL FILTER LOGS AROUND THE PERIMETER OF THE STOCKPILE AREA). (1 DAY)
- 5. INSTALL REMAINING PERIMETER EROSION AND SEDIMENT CONTROL DEVICES AS SHOWN ON THE PLANS, INCLUDING FENCING, FILTER LOGS, AND PUMPS. (1 DAY)
- 6. THE HOWARD COUNTY DEPARTMENT OF INSPECTION AND PERMITS SHALL BE NOTIFIED UPON COMPLETION OF CONTROL INSTALLATION FOR EACH PHASE OF CONSTRUCTION. UPON COMPLETION OF CONTROL INSTALLATION WITH APPROVAL OF SEDIMENT AND EROSION CONTROL INSPECTOR, THE CONTRACTOR MAY BEGIN GRADING OPERATIONS. CONSTRUCTION SHALL BE DONE IN ACCORDANCE WITH THE SEQUENCE OF CONSTRUCTION AND GRADING PLANS AND EROSION AND SEDIMENT CONTROL STANDARD DETAILS AND NOTES. DO NOT CLEAR AND GRUB THE ENTIRE PROJECT AREA. CLEAR AND GRUB ONLY AS DIRECTED BY THE ENGINEER AND ONLY WHERE CONSTRUCTION ACCESS IS NEEDED. (1 DAY) EXCAVATE TO SUBGRADES INDICATED ON PLANS. (1 WEEK)
- 8. CONSTRUCT RISER, OUTFALL PIPE, BOULDER END WALL, AND ROCK OUTLET PROTECTION. (1
- CONNECT UNDERDRAIN AND PLACE NO. 57 STONE, NO. 7 STONE, BIORETENTION SOIL, AND MULCH. (1 WEEK)
- 10. STABILIZE SITE. (1 DAY) TO SHOW AND THE REPORTS
- 11. WITH THE APPROVAL OF THE SEDIMENT CONTROL INSPECTOR AND THE ENGINEER REMOVE ALL SEDIMENT AND EROSION CONTROL MEASURES. (1 DAY)
- 12. PLANT SITE ACCORDING TO PLANTING PLAN IN APPROPRIATE PLANTING SEASON. (1 DAY)

SEDIMENT CONTROL

() By the Developer: "I/We certify that all development and construction will be done according to this plan, and that any responsible personnel involved in the construction project will have a Certificate of Attendance at a Department of the Environment approved Training Program for the Control of Sediment and Erosion before beginning the project. I also authorize periodic on-site inspection by the Howard Soil Conservation District."

Signature of Developer

Date

Print name below signature

() By the Engineer: "I certify that this plan for erosion and sediment control represents a practical and workable plan based on my personal knowledge of the site conditions and that it was prepared in accordance with the requirements of the Howard Soil Conservation District." 5/12/15 Date

Signature of Engineer

Print name below signature () For the Howard Soil Conservation District: This development plan is approved for soil

erosion and sediment control by the Howard Soil Conservation District.

SEE SIGNATURE BELOW **Howard Soil Conservation District**

STANDARD SEDIMENT CONTROL NOTES

- A MINIMUM OF 48 NOTICE MUST BE GIVEN TO THE HOWARD COUNTY DEPARTMENT OF INSPECTIONS, LICENSES AND PERMITS, SEDIMENT CONTROL DIVISION PRIOR TO THE START OF ANY CONSTRUCTION (313-1855)
- ALL VEGETATIVE AND STRUCTURAL PRACTICES ARE TO BE INSTALLED ACCORDING TO THE PROVISIONS OF THIS PLAN AND ARE TO BE IN CONFORMANCE WITH THE MOST CURRENT MARYLAND STANDARDS AND SPECIFICATIONS FOR SOIL EROSION AND SEDIMENT CONTROL AND REVISIONS THERETO.
- FOLLOWING INITIAL SOIL DISTURBANCE OR RE-DISTURBANCE, PERMANENT OR TEMPORARY STABILIZATION SHALL BE COMPLETED WITHIN: A) 3 CALENDAR DAYS FOR ALL PERIMETER SEDIMENT CONTROL STRUCTURES, DIKES, PERIMETER SLOPES AND ALL SLOPES GREATER THAN 3:1. B) 7 DAYS AS TO ALL OTHER DISTURBED OR GRADED AREAS ON THE PROJECT SITE.
- ALL DISTURBED AREAS MUST BE STABILIZED WITHIN THE TIME PERIOD SPECIFIED ABOVE IN ACCORDANCE WITH THE 2011 MARYLAND STANDARDS AND SPECIFICATIONS FOR SOIL EROSION AND SEDIMENT CONTROL FOR PERMANENT SEEDING (SEC. B-4-5), TEMPORARY SEEDING (SEC. B-4-4) AND MULCHING (SEC. B-4-3). TEMPORARY STABILIZATION WITH MULCH ALONE CAN ONLY BE DONE WHEN RECOMMENDED SEEDING DATES DO NOT ALLOW FOR PROPER GERMINATION AND ESTABLISHMENT OF GRASSES.
- ALL SEDIMENT CONTROL STRUCTURES ARE TO REMAIN IN PLACE AND ARE TO BE MAINTAINED IN OPERATIVE CONDITION UNTIL PERMISSION FOR THEIR REMOVAL HAS BEEN OBTAINED FROM THE HOWARD COUNTY SEDIMENT CONTROL INSPECTOR.
- SITE ANALYSIS:

TOTAL AREA OF SITE 0.5 ACRES AREA DISTURBED 0.5 **ACRES** ACRES AREA TO BE ROOFED OR PAVED 0 ACRES AREA TO BE VEGETATIVELY STABILIZED 0.5 438 CU. YDS TOTAL CUT CU. YDS.

OFFSITE WASTE/BORROW ARE LOCATION

- ANY SEDIMENT CONTROL PRACTICE THAT IS DISTURBED BY GRADING ACTIVITY FOR PLACEMENT OF UTILITIES MUST BE REPAIRED ON THE SAME DAY OF DISTURBANCE.
- ADDITIONAL SEDIMENT CONTROL MUST BE PROVIDED, IF DEEMED NECESSARY BY THE HOWARD COUNTY SEDIMENT CONTROL INSPECTOR.
- ON ALL SITES WITH DISTURBED AREAS IN EXCESS OF 2 ACRES, APPROVAL OF THE INSPECTION AGENCY SHALL BE REQUESTED UPON COMPLETION OF INSTALLATION OF PERIMETER EROSION AND SEDIMENT CONTROLS, BUT BEFORE PROCEEDING WITH ANY OTHER EARTH DISTURBANCE OR GRADING. OTHER BUILDING OR GRADING INSPECTION APPROVALS MAY NOT BE AUTHORIZED UNTIL THIS INITIAL APPROVAL BY THE INSPECTION AGENCY IS MADE.
- TRENCHES FOR THE CONSTRUCTION OF UTILITIES IS LIMITED TO THREE PIPE LENGTHS OR THAT WHICH SHALL BE BACK-FILLED AND STABILIZED BY THE END OF EACH WORKDAY. WHICHEVER IS SHORTER.
- ANY CHANGES OR REVISIONS TO THE SEQUENCE OF CONSTRUCTION MUST BE REVIEWED AND APPROVED BY THE PLAN APPROVAL AUTHORITY PRIOR TO PROCEEDING WITH CONSTRUCTION.
- A PROJECT IS TO BE SEQUENCED SO THAT GRADING ACTIVITIES BEGIN ON ONE GRADING UNIT (MAXIMUM ACREAGE OF 20 AC. PER GRADING UNIT) AT A TIME. WORK MAY PROCEED TO A SUBSEQUENT GRADING UNIT WHEN AT LEAST 50 PERCENT OF THE DISTURBED AREA IN THE PRECEDING GRADING UNIT HAS BE STABILIZED AND APPROVED BY THE ENFORCEMENT AUTHORITY. UNLESS OTHERWISE SPECIFIED AND APPROVED BY THE APPROVAL AUTHORITY, NO MORE THAN 30 ACRES CUMULATIVELY MAY BE DISTURBED AT A GIVEN TIME.

B-4-5 STANDARDS AND SPECIFICATIONS

PERMANENT STABILIZATION

Definition

To stabilize disturbed soils with permanent vegetation

To use long-lived perennial grasses and legumes to establish permanent ground cover on disturbed soils.

Conditions Where Practice Applies

Exposed soils where ground cover is needed for 6 months or more.

A. Seed Mixtures

- a. Select one or more of the species or mixtures listed in Table B.3 for the appropriate Plant Hardiness Zone (from Figure B.3) and based on the site condition or purpose found on Table B.2. Enter selected mixture(s), application rates, and seeding dates in the Permanent Seeding Summary. The Summary is to be placed on the plan.
- b. Additional planting specifications for exceptional sites such as shorelines, stream banks, or dunes or for special purposes such as wildlife or aesthetic treatment may be found in USDA-NRCS Technical Field Office Guide, Section 342 - Critical Area Planting
- c. For sites having disturbed area over 5 acres, use and show the rates recommended by the soil testing agency.
- d. For areas receiving low maintenance, apply urea form fertilizer (46-0-0) at 3 ½ pounds per 1000 square feet (150 pounds per acre) at the time of seeding in addition to the soil amendments shown in the Permanent Seeding Summary.

2. Turfgrass Mixtures

- a. Areas where turfgrass may be desired include lawns, parks, playgrounds, and commercial sites which will receive a medium to high level of maintenance.
- b. Select one or more of the species or mixtures listed below based on the site conditions or purpose. Enter selected mixture(s), application rates, and seeding dates in the Permanent Seeding Summary. The summary is to be placed on the plan.
 - i. Kentucky Bluegrass: Full Sun Mixture: For use in areas that receive intensive management. Irrigation required in the areas of central Maryland and Eastern Shore. Recommended Certified Kentucky Bluegrass Cultivars Seeding Rate: 1.5 to 2.0 pounds per 1000 square feet. Choose a minimum of three Kentucky bluegrass cultivars with each ranging from 10 to 35 percent of the total mixture by weight.
 - ii. Kentucky Bluegrass/Perennial Rye: Full Sun Mixture: For use in full sun areas where

anid establishment is necessary and when turf will receive medium to intensive management. Certified Perennial Ryegrass Cultivars/Certified Kentucky Bluegrass Seeding Rate: 2 pounds mixture per 1000 square feet. Choose a minimum of three Kentucky bluegrass cultivars with each ranging from 10 to 35 percent of the total mixture by weight.

- iii. Tall Fescue/Kentucky Bluegrass: Full Sun Mixture: For use in drought prone areas and/or for areas receiving low to medium management in full sun to medium shade. Recommended mixture includes; Certified Tall Pescue Cultivars 95 to 100 percent, Certified Kentucky Bluegrass Cultivars 0 to 5 percent. Seeding Rate: 5 to 8 pounds per 1000 square feet. One or more cultivars may be blended.
- iv. Kentucky Bluegrass/Fine Fescue: Shade Mixture: For use in areas with shade in Bluegrass fawns. For establishment in high quality, intensively managed turf area. Mixture includes; Certified Kentucky Bluegrass Cultivars 30 to 40 percent and Certified Fine Fescue and 60 to 70 percent. Seeding Rate: 1½ to 3 pounds per 1000 square feet.

Sclect turfgrass varieties from those listed in the most current University of Maryland Publication, Agronomy Memo #77, "Turigrass Cultivar Recommendations for Maryland"

Choose certified material. Certified material is the best guarantee of cultivar purity. The certification program of the Maryland Department of Agriculture, Turf and Seed Section, provides a reliable means of consumer protection and assures a pure genetic line

c. Ideal Times of Seeding for Turf Grass Mixtures

Western MD: March 15 to June 1, August 1 to October 1 (Hardiness Zones: 5b, 6a)

Central MD: March 1 to May 15, August 15 to October 15 (Hardiness Zone: 6b)

Southern MD, Eastern Shore: March 1 to May 15, August 15 to October 15 (Hardiness Zones: 7a, 7b)

- d. Till areas to receive seed by disking or other approved methods to a depth of 2 to 4 inches, level and rake the areas to prepare a proper seedbed. Remove stones and debris over 11/2 inches in diameter. The resulting seedbed must be in such condition that future moving of grasses will pose no difficulty.
- e. If soil moisture is deficient, supply new seedings with adequate water for plant growth (1/2 to 1 inch every 3 to 4 days depending on soil texture) until they are firmly established. This is especially true when seedings are made late in the planting season, in abnormally dry or hot seasons, or on adverse sites.

CLIENT

HOWARD COUNTY STORMWATER MANAGEMENT DIVISION 6751 COLUMBIA GATEWAY DRIVE SUITE 514 COLUMBIA, MD 21046

ISSUES / REVISIONS

SUPPLEMENTAL PLAN TO PROVIDE WATER QUALITY RETROFIT FOR

0.71 AC. OF SITE

DEPARTMENT OF PUBLIC WORKS

APPROVED: DEPARTMENT OF PLANNING AND ZONING

5.18.15



The Stables Building 2081 Clipper Park Road Baltimore, MD 21211 / ph: 410.554.0156 fx: 410.554.0168 / www.biohabitats.com

Restore the Earth & Inspire Ecological Stewardship

REVISED SITE DEVELOPMENT PLAN ROCKBURN **BRANCH PARK** OUTFALL D RETROFIT

GENERAL NOTES

13005.09

OF MAR LONGO

AL/KT MT/JZ/BA DWG. NO. :

SCALE: AS SHOWN

Permanent Seeding Summary

		Cone (from Figur e (from Table B				Fertilizer Ra . (10-20-20)	te	_ Lime Rate
No.	Species	Application Rate (lb/ac)	Seeding Dates	Seeding Depths	N	P ₂ O ₅	K₂0	Line Kat
	TALL FESCUE	80	3/1-6/1 8/15-10/15	1⁄4- ½ in	45 pounds	90 lb/ac	90 lb/ac	2 tons/ac
	KENTUCKY BLUEGRASS	1 1/2# 1/2 12) }	(2 lb/	(2 lb/	(90 16/			
				14-12 in	1000 sf)	1000 sf)	1000 sf)	1000 sf)

B. Sod: To provide quick cover on disturbed areas (2:1 grade or flatter).

1. General Specifications

- a. Class of turfgrass sod must be Maryland State Certified. Sod labels must be made available to the job foreman and inspector.
- b. Sod must be machine cut at a uniform soil thickness of % inch, plus or minus 1/2 inch, at the time of cutting. Measurement for thickness must exclude top growth and thatch. Broken pads and torn or uneven ends will not be acceptable.
- c. Standard size sections of sod must be strong enough to support their own weight and retain their size and shape when suspended vertically with a firm grasp on the upper 10 percent of the
- d. Sod must not be harvested or transplanted when moisture content (excessively dry or wet) may adversely affect its survival.
- e. Sod must be harvested, delivered, and installed within a period of 36 hours. Sod not transplanted within this period must be approved by an agronomist or soil scientist prior to its

2. Sod Installation

- a. During periods of excessively high temperature or in areas having dry subsoil, lightly irrigate the subsoil immediately prior to laying the sod.
- b. Lay the first row of sod in a straight line with subsequent rows placed parallel to it and tightly wedged against each other. Stagger lateral joints to promote more uniform growth and strength. Ensure that sod is not stretched or overlapped and that all joints are butted tight in order to prevent voids which would cause air drying of the roots.
- c. Wherever possible, lay sod with the long edges parallel to the contour and with staggering joints. Roll and tamp, peg or otherwise secure the sod to prevent slippage on slopes. Ensure solid contact exists between sod roots and the underlying soil surface.
- d. Water the sod immediately following rolling and tamping until the underside of the new sod pad and soil surface below the sod are thoroughly wet. Complete the operations of laying, tamping and irrigating for any piece of sod within eight hours.

3. Sod Maintenance

- a. In the absence of adequate rainfall, water daily during the first week or as often and sufficiently as necessary to maintain moist soil to a depth of 4 inches. Water sod during the heat of the day
- b. After the first week, sod watering is required as necessary to maintain adequate moisture
- c. Do not mow until the sod is firmly rooted. No more than % of the grass leaf must be removed by the initial cutting or subsequent cuttings. Maintain a grass height of at least 3 inches unless

B-4-4 STANDARDS AND SPECIFICATIONS

TEMPORARY STABILIZATION

Definition

To stabilize disturbed soils with vegetation for up to 6 months.

To use fast growing vegetation that provides cover on disturbed soils.

Conditions Where Practice Applies

Exposed soils where ground cover is needed for a period of 6 months or less. For longer duration of time, permanent stabilization practices are required.

- 1. Select one or more of the species or seed mixtures listed in Table B.1 for the appropriate Plant Hardiness Zone (from Figure B.3), and enter them in the Temporary Seeding Summary below along with application rates, seeding dates and seeding depths. If this Summary is not put on the plan and completed, then Table B.1 plus fertilizer and lime rates must be put on the plan.
- 2. Por sites having soil tests performed, use and show the recommended rates by the testing agency. Soil tests are not required for Temporary Seeding.
- 3. When stabilization is required outside of a seeding season, apply seed and mulch or straw mulch alone as prescribed in Section B-4-3, A. I. b and maintain until the next seeding season.

Temporary Seeding Summary

	Hardiness Zo Seed Mixture	Fertilizer Rate	Lime Rate			
No.	Species	Application Rate (lb/ac)	Seeding Dates	Seeding Depths	(10-20-20)	2,1110 , 1110
	ANNUAL RYE	40	MAY1 - MAY 15 AUG 1 - OCT 15	0.5		
: -					436 lb/ac (10 lb/1000 sf)	2 tons/ac (90 lb/1000 sf)

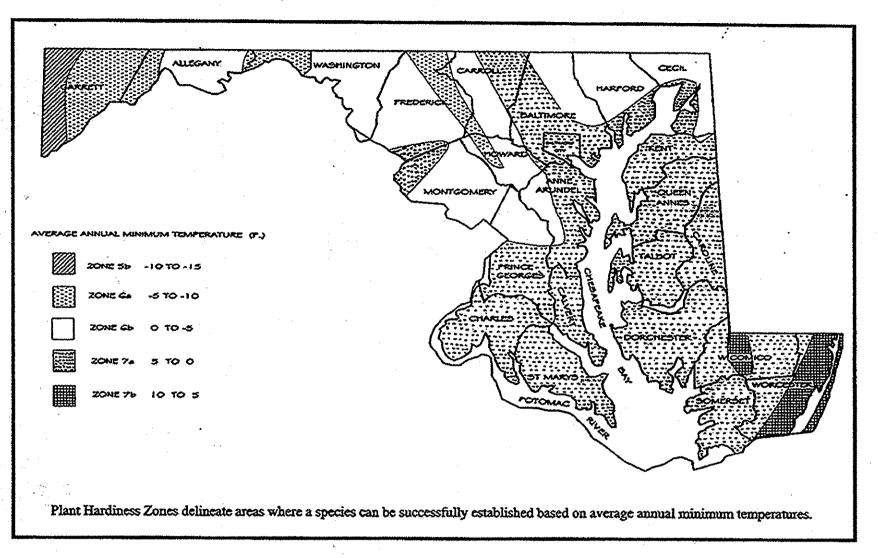


Figure B.3: U.S.D.A. Plant Hardiness Zones

Table B.1: Temporary Seeding for Site Stabilization

Plant Species	Seeding Rate 1/		Seeding Depth ^{2/}	Recommended Seeding Dates by Plant Hardiness Zone 3/			
	lb/ac lb/1000 ft ²		(inches)	5b and 6a	бь	7a and 7b	
Cool-Season Grasses							
Annual Ryegrass (Lolium perenne ssp. multiflorum)	40	1.0	0.5	Mar 15 to May 31; Aug 1 to Sep 30	Mar 1 to May 15: Aug 1 to Oct 15	Feb 15 to Apr 30; Aug 15 to Nov 30	
Barley (Hordeum vulgare)	96	2.2	1.0	Mar 15 to May 31; Aug 1 to Sep 30	Mar 1 to May 15; Aug 1 to Oct 15	Feb 15 to Apr 30; Aug 15 to Nov 30	
Oats (Avena sativa)	72	1.7	1.0	Mar 15 to May 31; Aug 1 to Sep 30	Mar 1 to May 15; Aug 1 to Oct 15	Feb 15 to Apr 30; Aug 15 to Nov 30	
Wheat (Triticum aestivum)	120	2.8	1.0	Mar 15 to May 31; Aug I to Sep 30	Mar 1 to May 15; Aug 1 to Oct 15	Feb 15 to Apr 30; Aug 15 to Nov 30	
Cereal Rye (Secale cereale)	112	2.8	1.0	Mar 15 to May 31; Aug I to Oct 31	Mar 1 to May 15; Aug 1 to Nov 15	Feb 15 to Apr 30; Aug 15 to Dec 15	
Warm-Season Grasses							
Foxtail Millet (Setaria italica)	30	0.7	0.5	Jun 1 to Jul 31	May 16 to Jul 31	May 1 to Aug 14	
Pearl Millet (Pennisetum glaucum)	20	0.5	0.5	Jun 1 to Jul 31	May 16 to Jul 31	May I to Aug 14	

1/ Seeding rates for the warm-season grasses are in pounds of Pure Live Seed (PLS). Actual planting rates shall be adjusted to reflect percent seed germination and purity, as tested. Adjustments are usually not needed for the cool-season grasses.

Seeding rates listed above are for temporary seedings, when planted alone. When planted as a nurse crop with permanent seed mixes, use 1/3 of the seeding rate listed above for barley, oats, and wheat. For smaller-seeded grasses (annual ryegrass, pearl miller, foxtail miller), do not exceed more than 5% (by weight) of the overall permanent seeding mix. Cereal tye generally should not be used as a nurse crop, unless planting will occur in very late fall beyond the seeding dates for other temporary seedings. Cereal rye has allelopathic properties that inhibit the germination and growth of other plants. If it must be used as a nurse crop, seed at 1/3 of the rate listed above.

Oats are the recommended nurse crop for warm-season grasses.

2/ For sandy soils, plant seeds at twice the depth listed above.

3/ The planting dates listed are averages for each Zone and may require adjustment to reflect local conditions; especially near the boundaries of the zone.

CLIENT

HOWARD COUNTY STORMWATER MANAGEMENT DIVISION 6751 COLUMBIA GATEWAY DRIVE SUITE 514 COLUMBIA, MD 21046

ISSUES / REVISIONS

SUPPLEMENTAL PLAN TO PROVIDE WATER QUALITY RETROFIT FOR 0.71 AC. OF SITE

APPROVED: DEPARTMENT OF PLANNING AND ZONING

The Stables Building 2081 Clipper Park Road

Baltimore, MD 21211 / ph: 410.554.0156 fx: 410.554.0168 / www.biohabitats.com Restore the Earth & Inspire Ecological Stewardship

REVISED SITE DEVELOPMENT PLAN ROCKBURN


BRANCH PARK OUTFALL D RETROFIT


GENERAL NOTES

13005.09

AL/KT MT/JZ/BA DWG. NO.:

SCALE: AS SHOWN

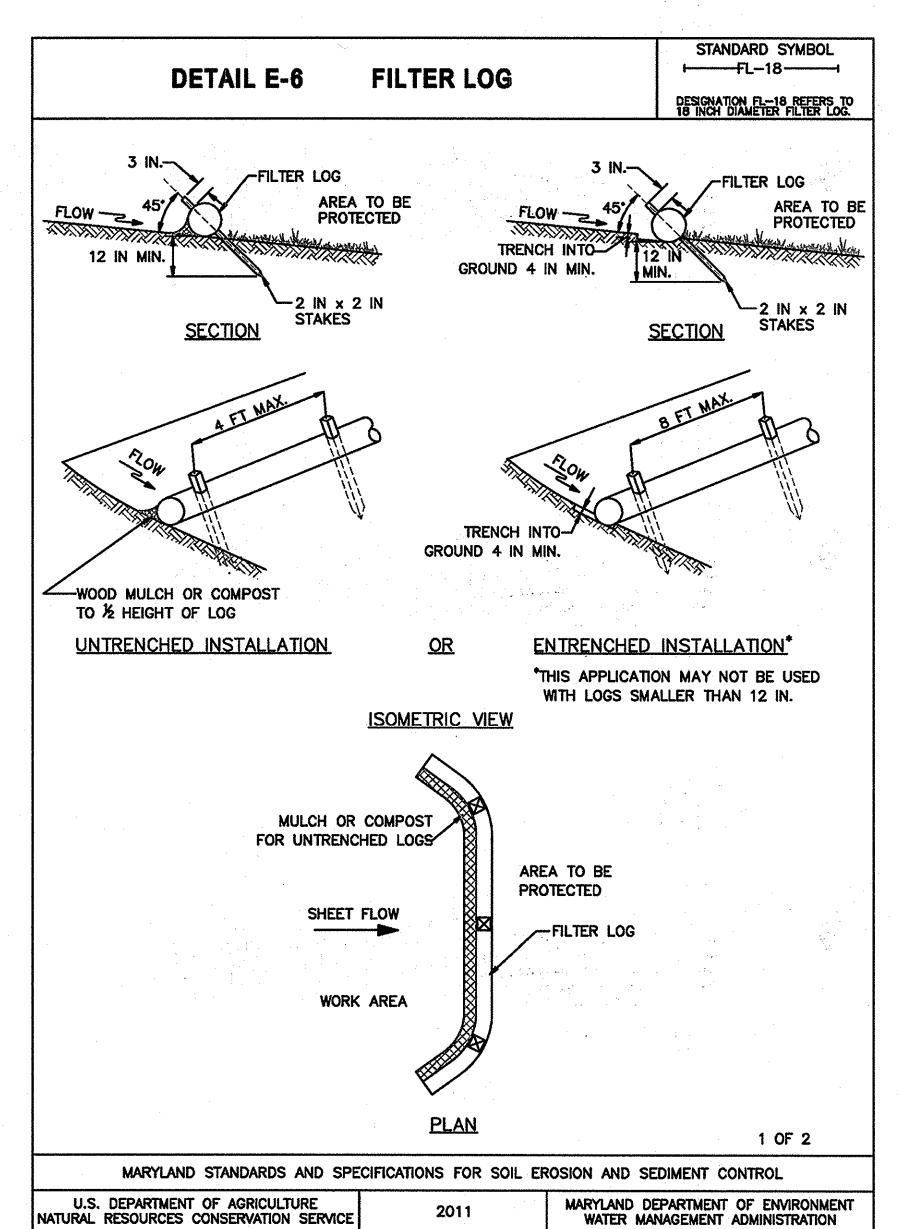

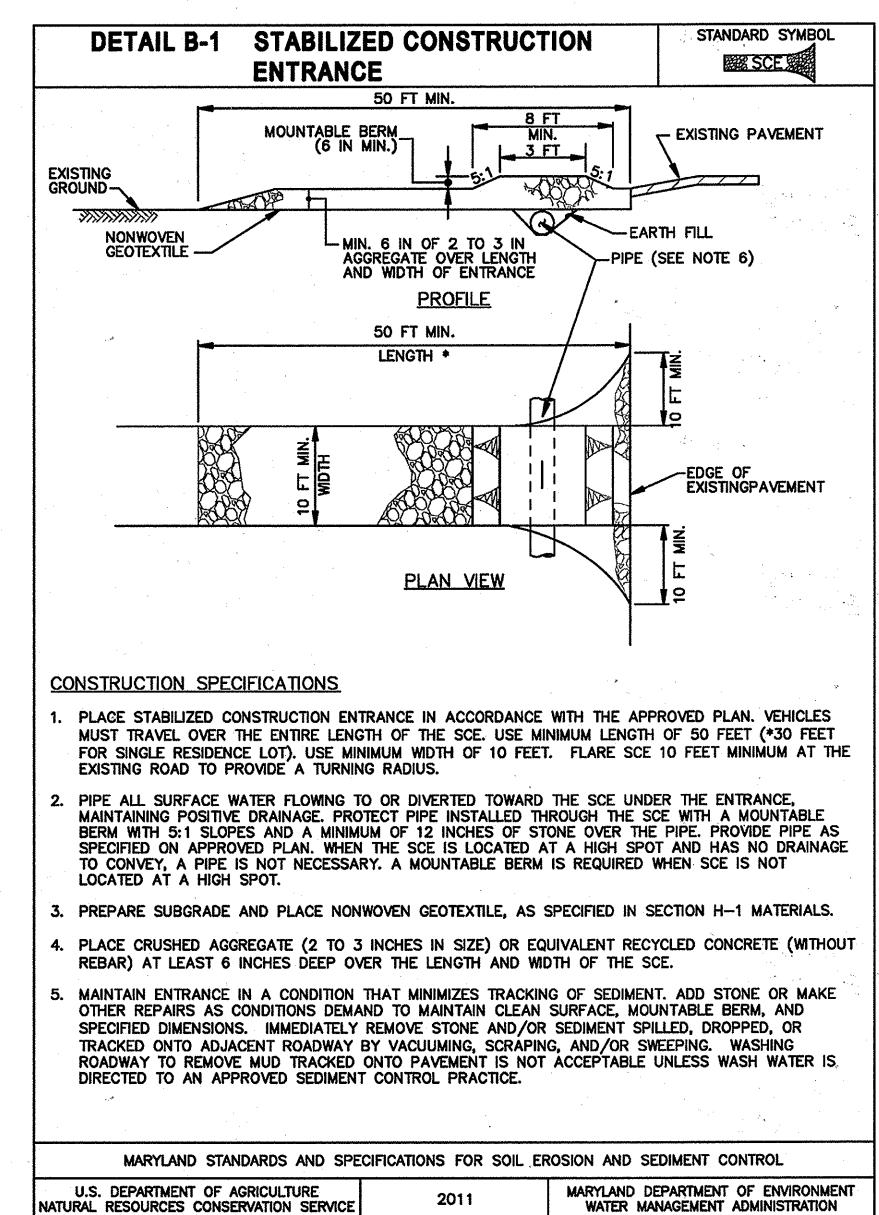

2011



HOWARD COUNTY STORMWATER MANAGEMENT DIVISION 6751 COLUMBIA GATEWAY DRIVE SUITE 514 COLUMBIA, MD 21046

ISSUES / REVISIONS

SUPPLEMENTAL PLAN TO PROVIDE WATER QUALITY RETROFIT FOR 0.71 AC, OF SITE

APPROVED: DEPARTMENT OF PLANNING AND ZONING



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REVISED SITE DEVELOPMENT PLAN ROCKBURN **BRANCH PARK**


OUTFALL D RETROFIT


EROSION AND SEDIMENT **CONTROL DETAILS**

AL/KT MT/JZ/BA DWG. NO.:

26 of 32

SCALE: AS SHOWN

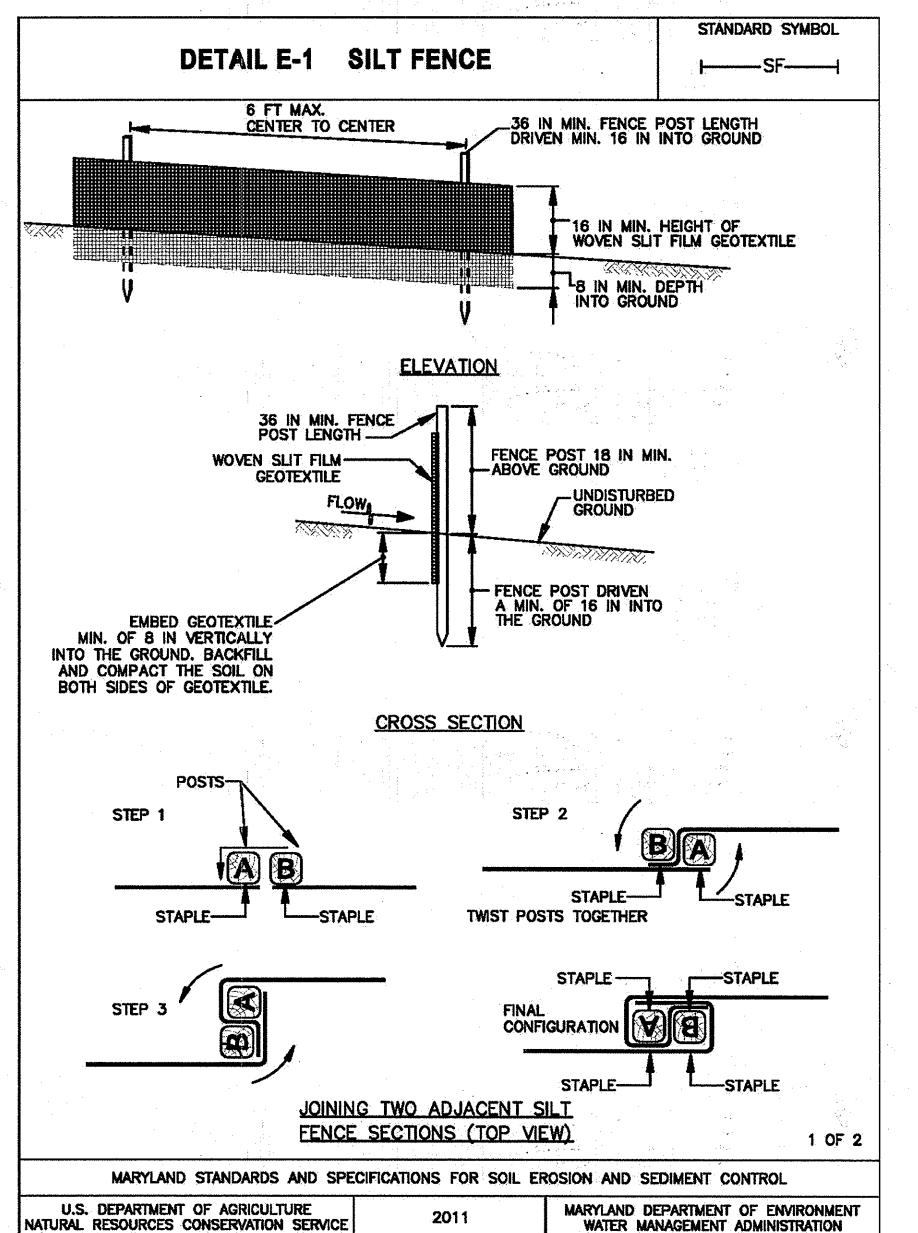


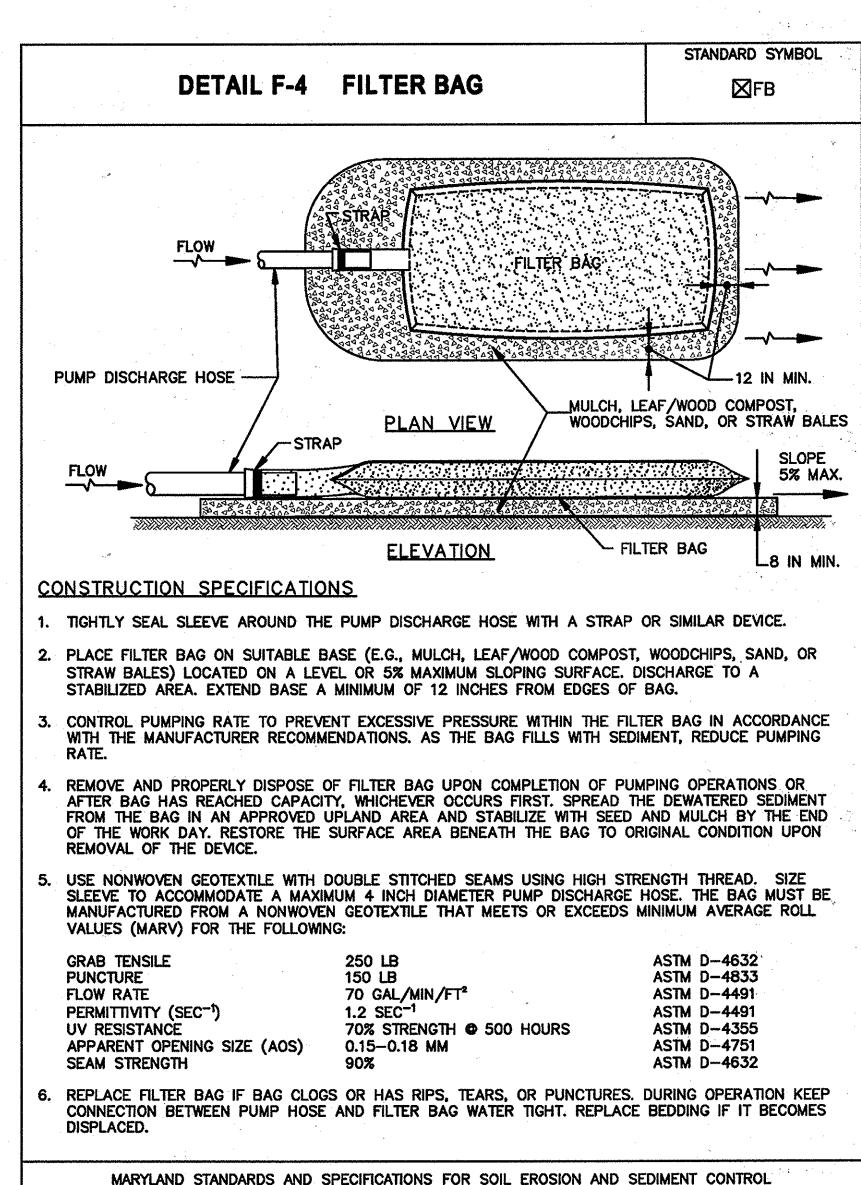


2011

MARYLAND DEPARTMENT OF ENVIRONMENT

WATER MANAGEMENT ADMINISTRATION

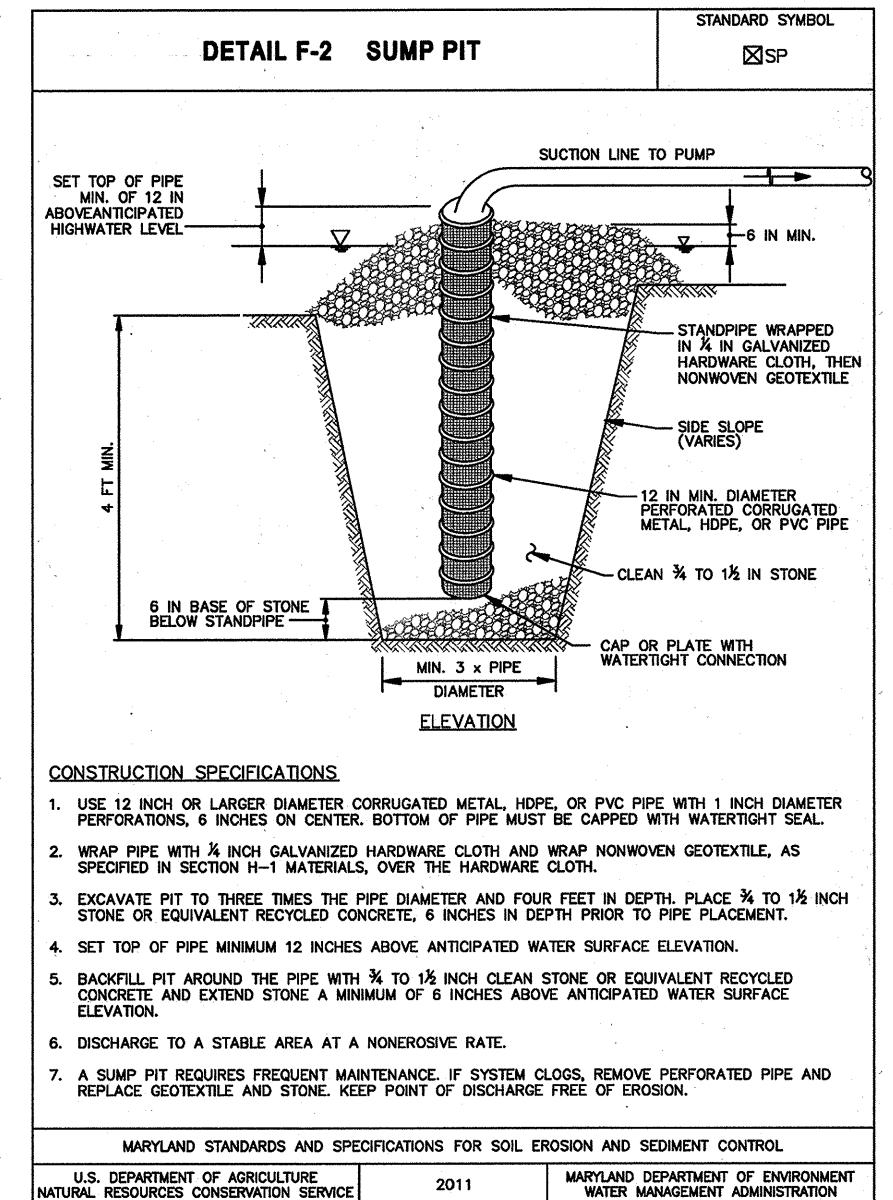

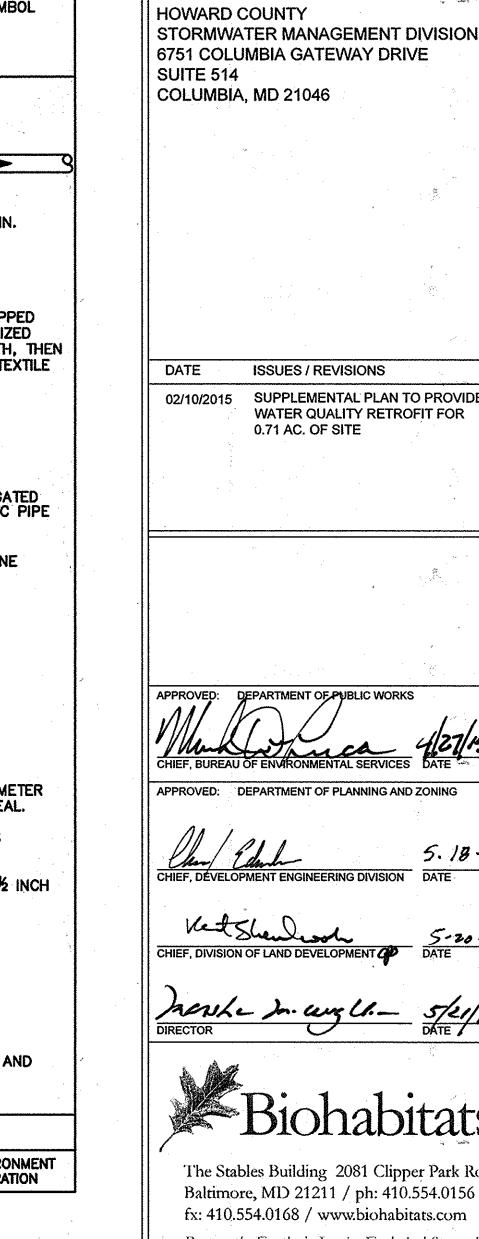

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5.18-15

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ISSUES / REVISIONS

0.71 AC. OF SITE

SUPPLEMENTAL PLAN TO PROVIDE WATER QUALITY RETROFIT FOR

Restore the Earth & Inspire Ecological Stewardship

REVISED SITE DEVELOPMENT PLAN ROCKBURN **BRANCH PARK**

OUTFALL D RETROFIT

EROSION AND SEDIMENT CONTROL DETAILS

PROJECT NO. :

AL/KT MT/JZ/BA DWG. NO.:


27 of 32

SCALE: AS SHOWN


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U.S. DEPARTMENT OF AGRICULTURE

NATURAL RESOURCES CONSERVATION SERVICE

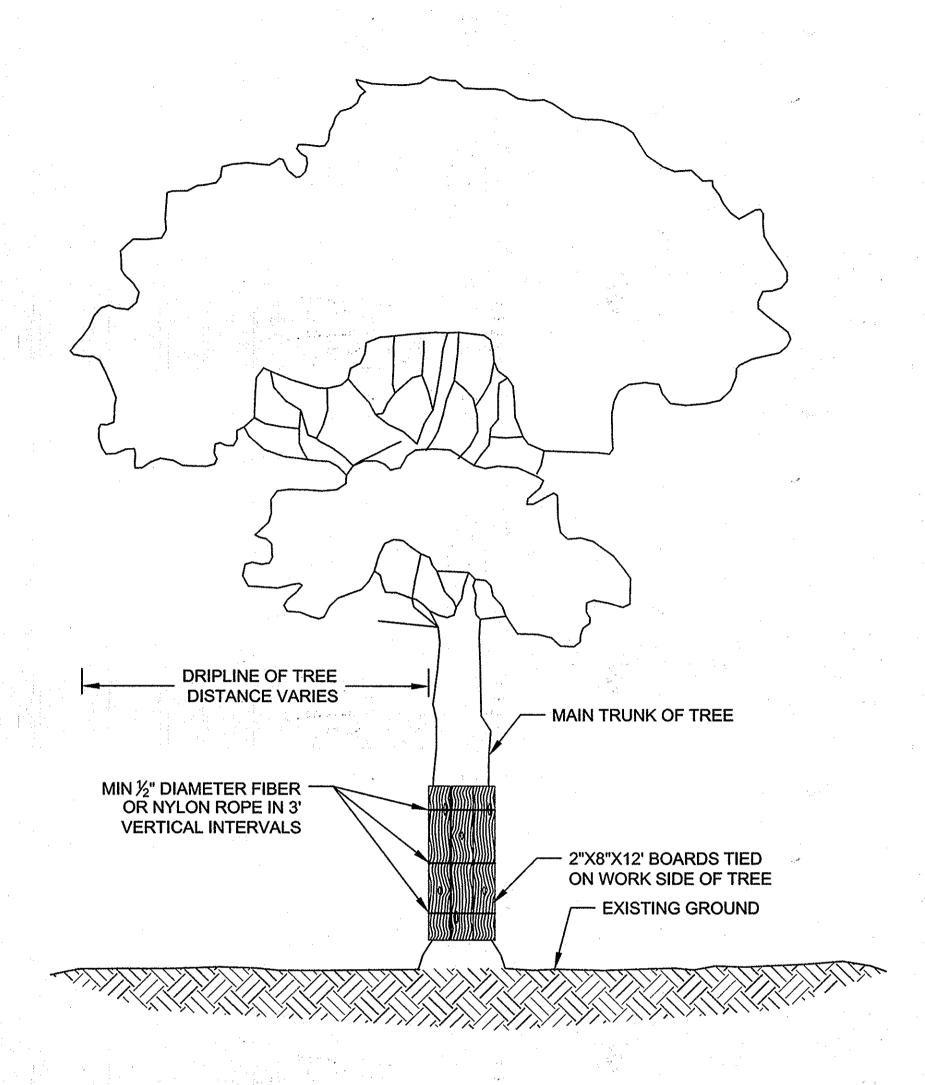



- 1. TIE SUFFICIENT 2"X8"X12' BOARDS AROUND MAIN TRUNK OF TREE WITH ½" DIAMETER ROPE (FIBER OR NYLON) TO PROTECT ALL AREAS EXPOSED TO CONSTRUCTION.
- 2. INSTALL WIRE EYE BOLTS WITH MINIMUM INNER DIAMETER OF %" AND MINIMUM LENGTH OF 4" FIRMLY IN EACH PLANK WHERE FIBER OR NYLON ROPES CROSS OVER PLANKS.
- 3. WHERE SIGNIFICANT TREE BRANCHES EXIST WHICH PREVENT PLANK INSTALLATION, PLANKING SHALL EXTEND TO THE ELEVATION OF THE LOWEST BRANCH.

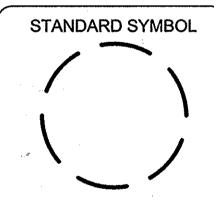

TREE PLANKING

NOT TO SCALE

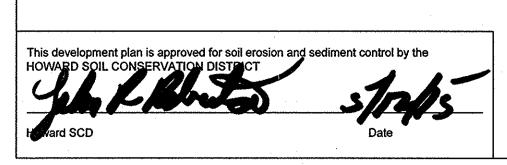

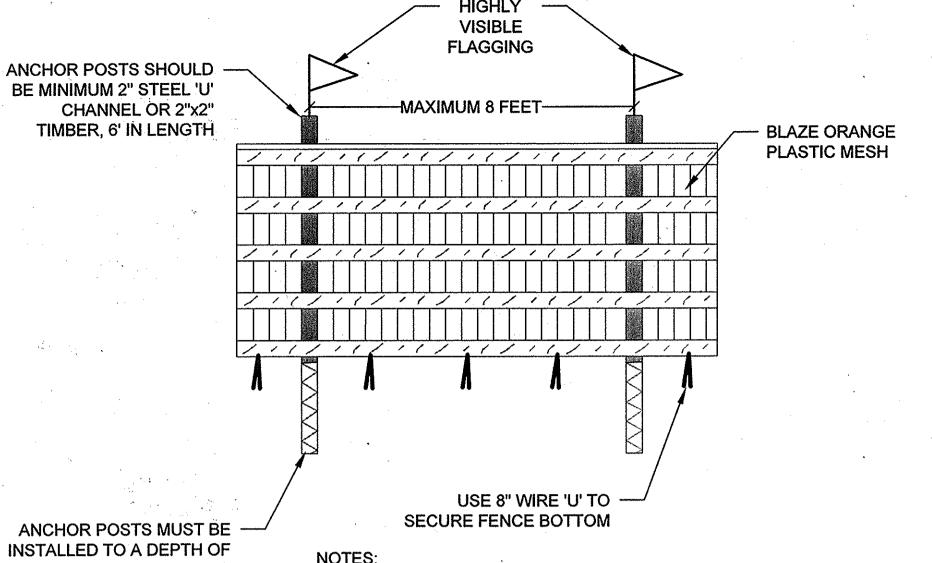


INSTALLED TO A DEPTH OF NO LESS THAN 1/3 OF THE TOTAL HEIGHT OF POST.

- PROTECTION AREA WILL BE SET AS PART OF THE REVIEW PROCESS.
 BOUNDARIES OF PROTECTION AREA SHOULD BE STAKED AND FLAGGED
- PRIOR TO INSTALLING DEVICES. 3. DEVICE SHOULD BE MAINTAINED THROUGHOUT CONSTRUCTION.

TREE PROTECTION BLAZE ORANGE PLASTIC FENCE

NOT TO SCALE

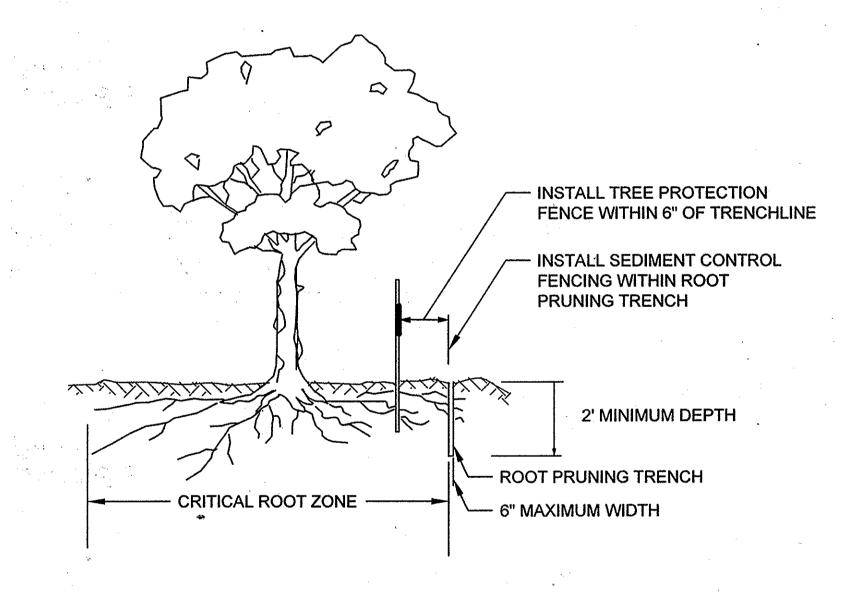

NOTES:

- 1. RETENTION AREAS TO BE ESTABLISHED AS PART OF THE FOREST CONSERVATION PLAN REVIEW PROCESS.
- 2. BOUNDARIES OF RETENTION AREAS TO BE STAKED, FLAGGED AND/OR FENCED PRIOR TO TRENCHING.
- EXACT LOCATION OF TRENCH SHOULD BE IDENTIFIED IN FIELD WITH THE ENGINEER.
- TRENCH SHOULD BE IMMEDIATELY BACKFILLED WITH SOIL REMOVED OR ORGANIC SOIL.
- 5. ROOTS SHOULD BE CLEANLY CUT USING VIBRATORY KNIFE OR OTHER ACCEPTABLE EQUIPMENT.



NOT TO SCALE

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HOWARD COUNTY STORMWATER MANAGEMENT DIVISION 6751 COLUMBIA GATEWAY DRIVE SUITE 514 COLUMBIA, MD 21046

ISSUES / REVISIONS

SUPPLEMENTAL PLAN TO PROVIDE WATER QUALITY RETROFIT FOR 0.71 AC. OF SITE

APPROVED: DEPARTMENT OF PLANNING AND ZONING

5.78.15



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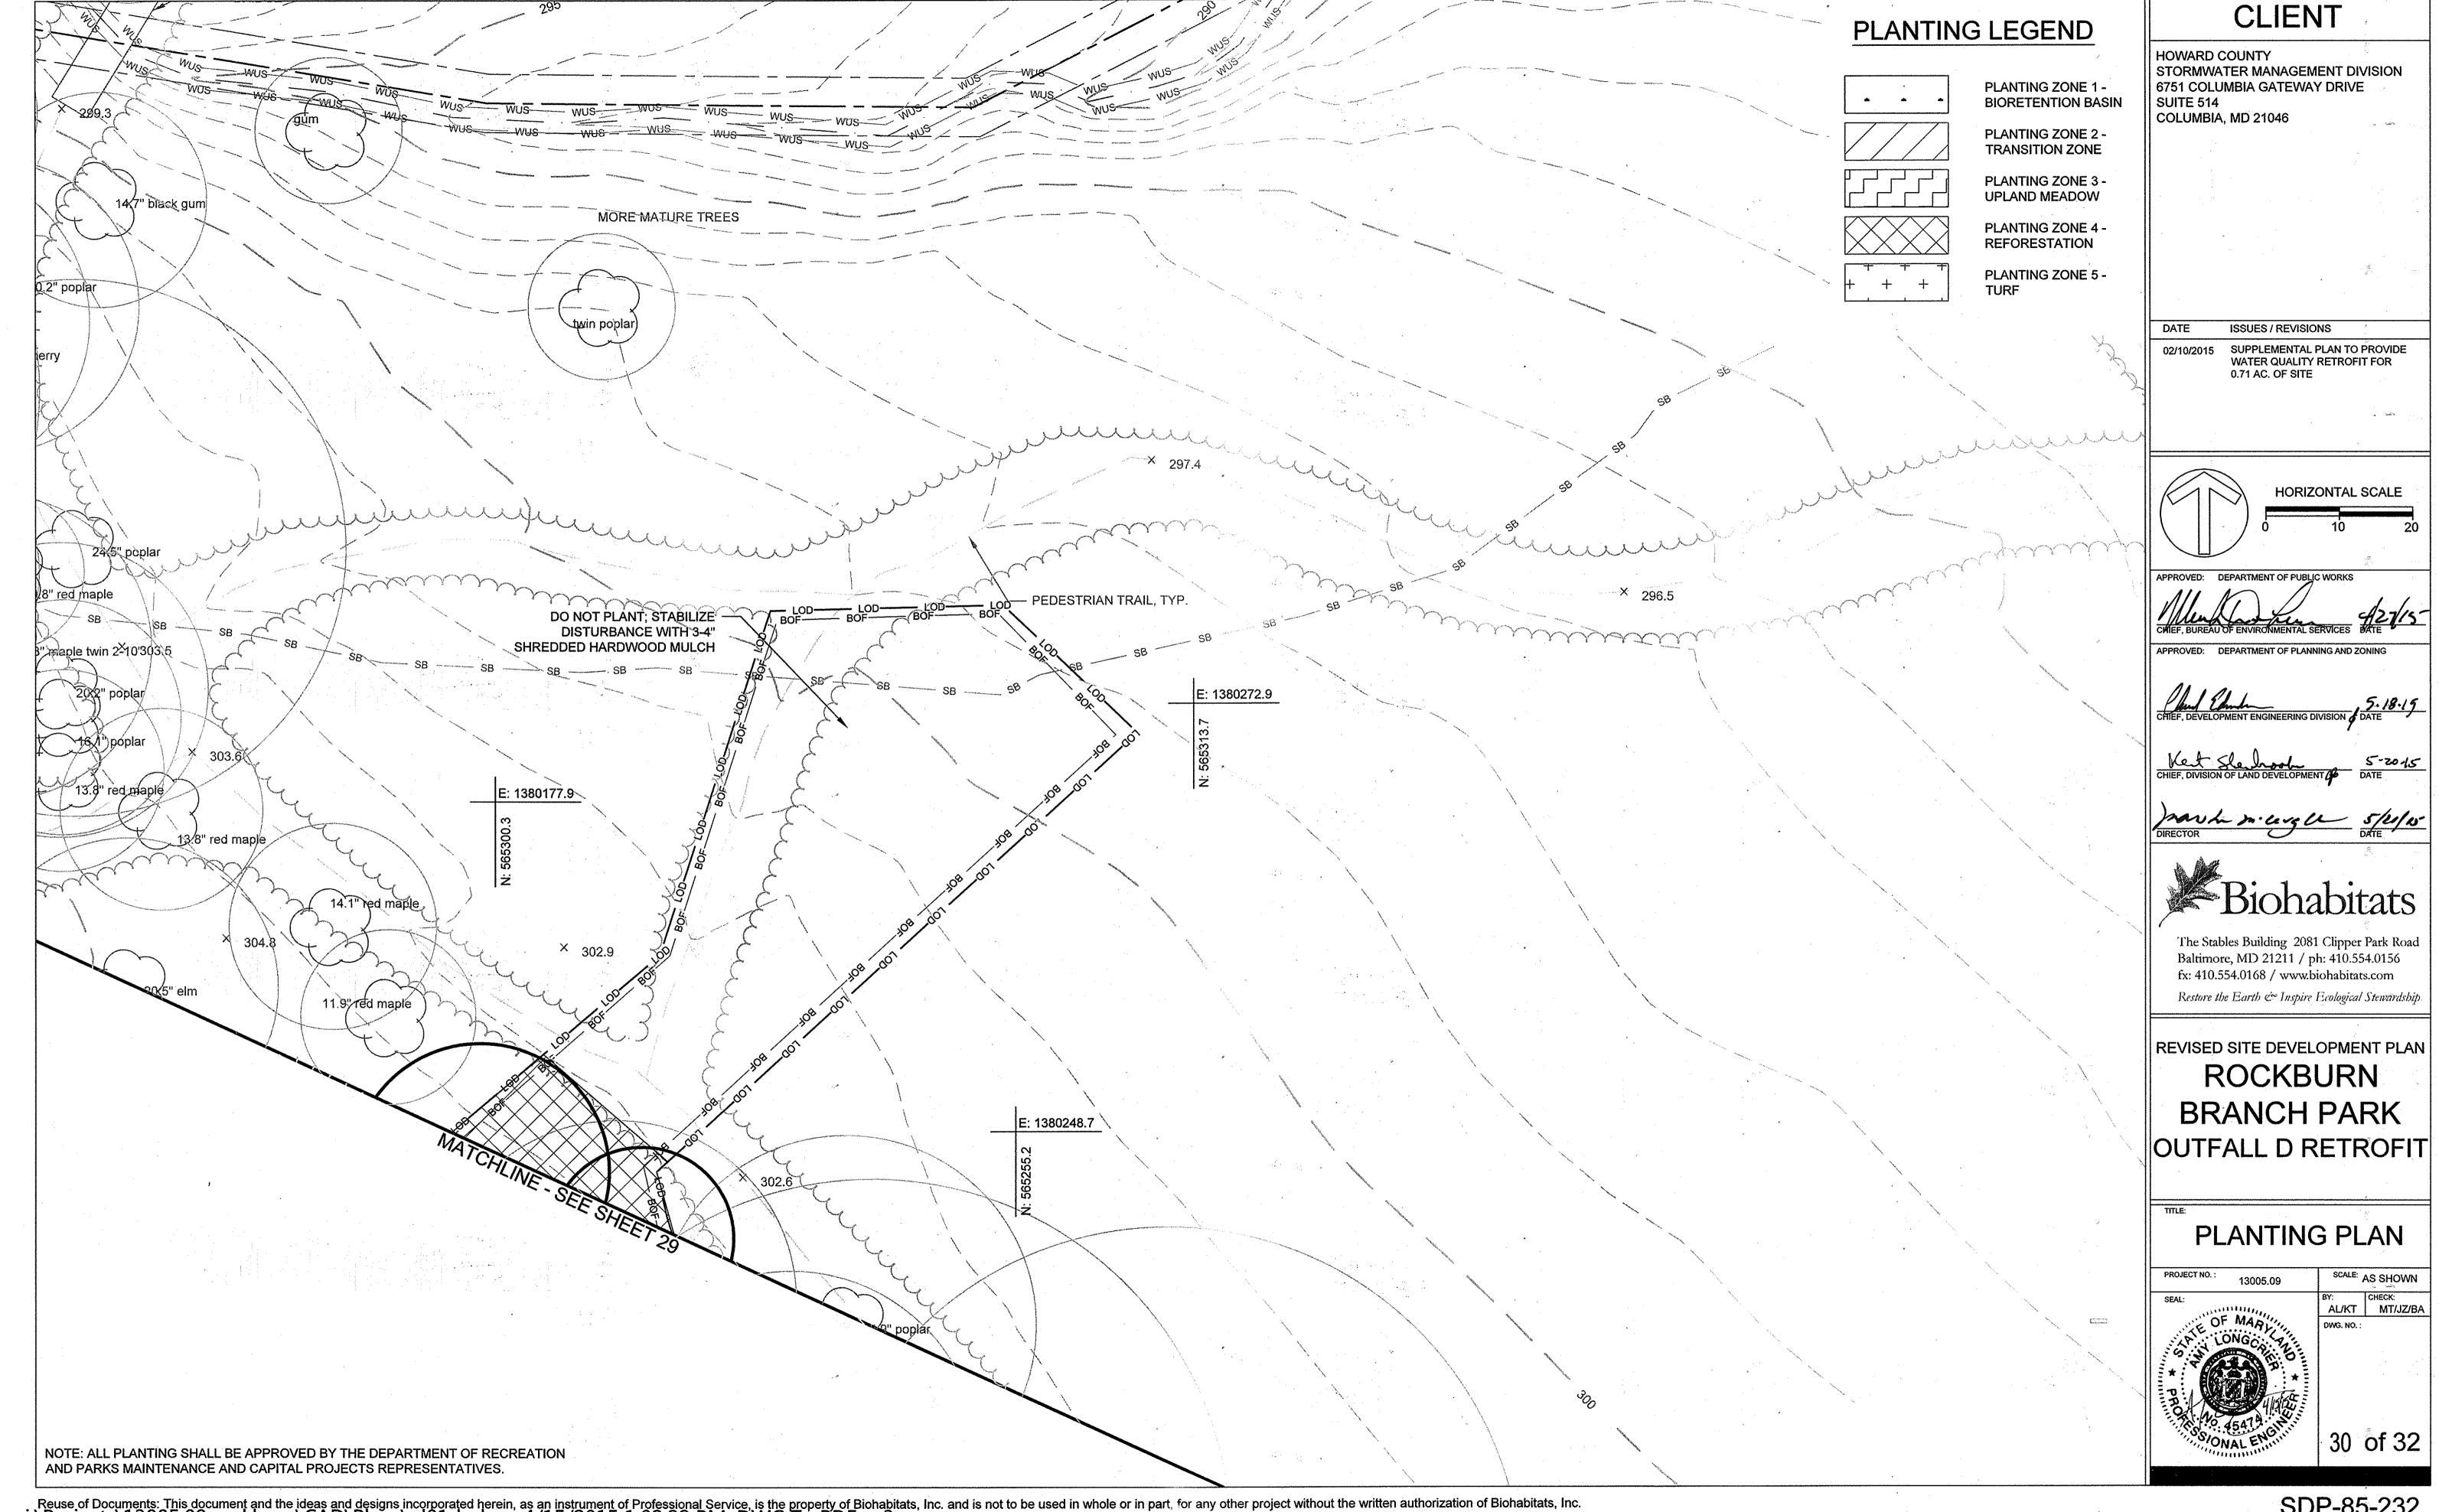
REVISED SITE DEVELOPMENT PLAN ROCKBURN **BRANCH PARK** OUTFALL D RETROFIT


EROSION AND SEDIMENT **CONTROL DETAILS**

AL/KT MT/JZ/BA


SCALE: AS SHOWN





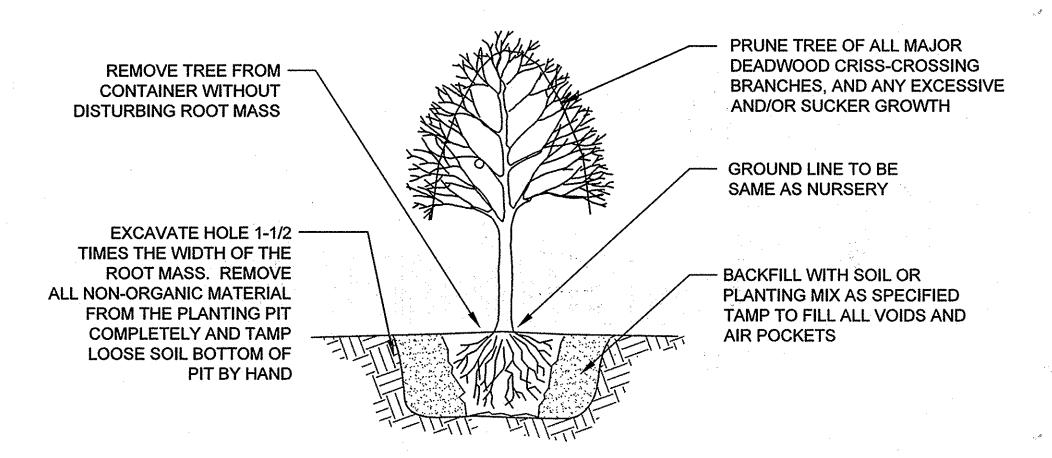


NOT TO SCALE

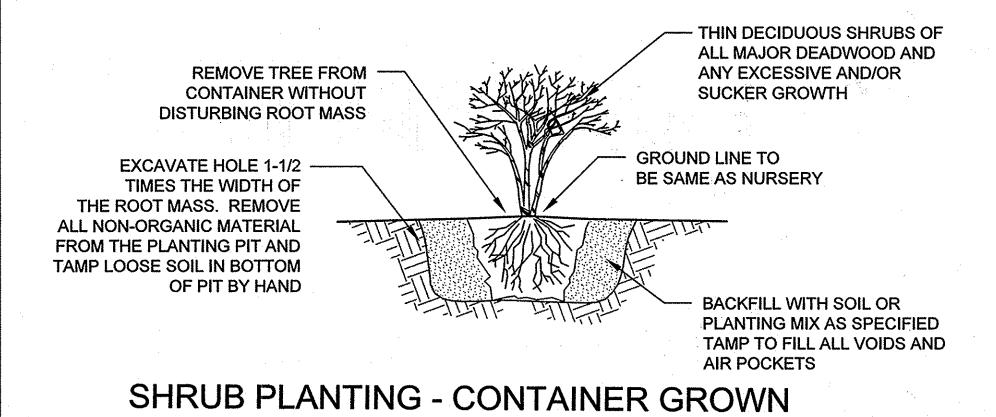

TREE PLANTING - CONTAINER GROWN

NOT TO SCALE

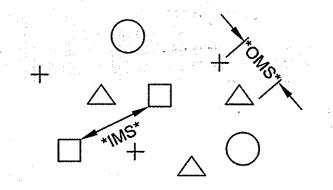

OMS- AN OVERALL MINIMUM SPACING DISTANCE *OMS* IS ASSIGNED TO THE PLANTING CONFIGURATION *SEE PLANT SCHEDULE*
IMS- AN INDIVIDUAL MINIMUM SPACING DISTANCES *IMS* IS ASSIGNED TO EACH INDIVIDUAL SPECIES *SEE PLANT SCHEDULE*

PLANT SPACING - RANDOM

NOTE: EACH SYMBOL INDICATES A DIFFERENT SPECIES

NOT TO SCALE

PLAN VIEW

		N SCHEDULE	•						
ZONE 1	- BIORE	TENTION E	BASIN				Size (a	cres):	0.05
Overall Minimum Spacing (ft.)	Quantity per acre	Frequency (%)	Species Quantity	Vegetation Strata <i>l</i> Species Name	Common Name	Unit	Spacing Type	Size	Individual Minimum Spacing (ft.)
2	10890			HERBACEOUS					
я		10 ,	60	Andropogon gerardii	Big bluestem	con	random	QT	2 ft
		5	30	Asclepias tuberosa	Butterflyweed	con	random	QT	2 ft
		5	30	Aster novae-angliae	New England aster	con	random	QT	2 ft
		10	60	Carex stipata	Awlfruit sedge	con	random	QT	2 ft
	is.	10	60	Eupatorium perfoliatum	Common boneset	con	random	QT	2 ft
ļ	,	5	30	Goldenrod sp.	Solidago sp.	con	random	QΤ	2 ft
		5	30	Iris versicolor	Blue flag iris	con	random	QT	2 ft
		15	89	Juncus effusus	Soft rush	con	random	QT	2 ft
		10	60 ³	Liatris spicata	Gayfeather	con	random	QT	2 ft
		10	60	Lobelia cardinalis	Cardinal flower	con	random	QT	2 ft
		10	60	Panicum virgatum	Switch grass	con	random	QT	2 ft
	i.	5	30	Penstemon digitalis	Talus slope penstemon	con	random	QT	2 ft
		100	599	= total			>		
ON=contain	her								

ONE 2	- TRANS	SITION ZON	E	÷		·	Size (a	cres):	0.08
Overall Minimum Spacing (ft.)	Quantity per acre	Frequency (%)	Species Quantity	Vegetation Strata/ Species Name	Common Name	Unit	Spacing Type	Size	Individual Minimum Spacing (ft.)
2	10890			HERBACEOUS					
		20	174	Andropogon gerardii	Big bluestem	con	random	QT	2 ft
		10	87	Asclepias tuberosa	Butterflyweed	con	random	QT	2 ft
*		10	87	Aster novae-angliae	New England aster	con	random	QT	2 ft
		10 .	87	Goldenrod sp.	Solidago sp.	con	random	QT	2 ft
		5	43	Helianthus angustifolius	Swamp sunflower	con	random	QT	2 ਜ
		15	130	Panicum virgatum	Switch grass	con	random	QT	2 ft
	:	10	87 ·	Penstemon digitalis	Talus slope penstemon	con	random	QT	2 ft
		10	87	Rudbeckia hirta	Black eyed susan	con	random	QT	2 ft
		10	87	Senecio aureus	Golden groundsel	con	random	QT	2 ft
		100	869	= total					

ZONE 3	- UPLA	Size (acres): 0.10							
Overall Minimum Spacing (ft.)	Quantity per acre	Frequency (%)	Species Quantity	Vegetation Strata <i>l</i> Species Name	Common Name	Unit	Spacing Type	Size	Individual Minimum Spacing (ft.)
2.5	6970		-	Herbaceous/ Grasses/ Ferns					
		12 🗀	86	Andropogon virginicus	Broomsedge	plug	Clusters of 3	2"	2 ft
		8	57	Aster novae-angliae	New England aster	plug	Clusters of 3	2"	2 ft
		8	57	Echinacea purpurea	Purple coneflower	plug	Clusters of 3	2"	2 ft
		6	43	Eupatorium fistulosum	Joe-Pye weed	plug	Clusters of 3	2"	2 ft
*		8 ~	57	Heliopsis helianthoides	Oxeye sunflower	plug	Clusters of 3	2"	2 ft
	-	10	71	Lupinus perennis	Sundial lupine	plug	Clusters of 3	2"	2 ft
		10	. 71	Monarda fistulosa	Wild bergamot	plug	Clusters of 3	2"	2 ft
		15	107	Panicum virgatum	Switchgrass	plug	Clusters of 3	2"	2 ft
		8	57 √	Sorghastrum nutans	Indiangrass	plug	Clusters of 3	2"	2 ਜੈ
		15	107	Solidago sempervirens	Seaside goldenrod	plug	Clusters of 3	2"	2 ft
		100	713	= total					

TREES Size (acres):											
Overall Minimum Spacing (ft.)	Quantity per acre	Frequency (%)	Species Quantity	ID	Vegetation Strata <i>l</i> Species Name	Common Name	Unit	Spacing Type	Size	Individual Minimum Spacing (ft.)	
		•	TREES								
		na	2	AR	Acer rubrum	Red maple	con	AS SHOWN	1.5 cal.	AS SHOWN	
		na	2	AC	Amelanchier canadensis	Serviceberry	con	AS SHOWN	1.5 cal.	AS SHOWN	
		na	1	CC.	Cercis canadensis	Redbud	con	AS SHOWN	1.5 cal.	AS SHOWN	
	•	na .	3	NS	Nyssa sylvatica	Black gum	con	AS SHOWN	1.5 cal.	AS SHOWN	
		na 💝	1	DV	Diospyros virginiana	American persimmon	con	AS SHOWN	1.5 cal.	AS SHOWN	

CON=contain

CON=container

ZONE 5 - TURF = APPROXIMATELY 7,000 SQ FT

CLIENT

HOWARD COUNTY
STORMWATER MANAGEMENT DIVISION
6751 COLUMBIA GATEWAY DRIVE
SUITE 514
COLUMBIA, MD 21046

DATE ISSUES / REVISIONS

02/10/2015 SUPPLEMENTAL PLAN TO PROVIDE

WATER QUALITY RETROFIT FOR 0.71 AC. OF SITE

PPROVED: DEPARTMENT OF PUBLIC WORKS

CHIEF, BUREAU OF ENVIRONMENTAL SERVICES DAT

APPROVED: DEPARTMENT OF PLANNING AND ZONING

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Restore the Earth & Inspire Ecological Stewardship

ROCKBURN
BRANCH PARK

OUTFALL D RETROFIT

PLANTING DETAILS

BY: CHECK:
AL/KT MT/JZ/BA
DWG. NO. :

SCALE: AS SHOWN

MATERIAL	SPECIFICATIONS					
	Class 1 Riprap shall be locally sourced stone that is dark in color and meets the requirements for Class 1 Riprap as set					
Select Class 1 Rip Rap*	forth in the Maryland State Highway Administration (MDSHA) Material Specification 901.02.01 Stone for Riprap.					
	Boulders shall have a minimum dimension of 2 feet on any axis and a maximum dimension of 4 feet on any axis.					
Boulders*	Boulders shall be placed in coordination with on-site engineer and should be flush with proposed grade.					
Mulch	3" depth of shredded hardwood mulch; aged for a minimum 6 months; no pine or wood chips					
	Bioretention media shall consist of 60-65% loamy sand & 35-40% compost OR 30% sandy loam, 30% coarse sand, & 40%					
	compost; USDA soil types loamy sand or sandy loam; clay content < 5%; minimum 10% organic content by dry weight					
Bioretention Soil	(ASTM-D-2974); Required permeability rate of 1 inch per hour. Bioretention soil shall meet Appendix B.4.C					
	Specifications for Micro-Bioretention in the Maryland Stormwater Design Manual. Engineer shall provide reference					
· · · · · · · · · · · · · · · · · · ·	standard at kickoff meeting.					
No. 7 Stone*	Double washed, AASHTO No. 7 stone (AASHTO T-27)					
No. 57 Stone*	Double Washed, AASHTO No 57. Stone (meets AASHTO M-43)					
4" Perforated PVC Pipe	4" rigid schedule 40 PVC or SDR35; 3/8" perf. @ 6" on center, 4 holes per row; minimum 3" of gravel over pipes. Meets F758, Type PS 28 or AASHTO M-278					
4" Flexible PE Pipe	4" corrugated nonperforated flexible HDPE pipe. Meets AASHTO M-252. Install per manufactures instructions.					
Non-woven Geotextile	Meets Class "C" - apparent opening size (ASTM-D-4751), grap tensile strength (ASTM-D-4632), puncture resistance (ASTM-D-4833)					
	Tensar Rollmax Eronet P300 or approved equal, as approved by engineer, and meeting Type 5A, 5B, specification					
Turf Reinforcement Mat (TRM)	requirements established by the Erosion Control Technology Council (ECTC) and Federal Highway Administration's					
	(FHWA) FP-03 Section 713.18.					
* NOTE: ALL STONE AND RIPRAP S	HALL BE SOURCED FROM SAVAGE QUARRY					

EARTHWORK		
<u>ltem</u>	Quantity Units	<u>Notes</u>
Cut	438 CY	Includes surface cuts, all material cuts, and pipe excavation cuts
Fill	227 CY	Use cut to fill
Net Cut/Fill	211 CY	Net adjusted (Cut-Fill); Will have excess cut material
Area of Disturbance	0.5 AC	Entire LOD area
MATERIALS		
<u>tem</u>	Quantity Units	<u>Notes</u>
Mulch	715 SY	See specs.
Bioretention Soil	110 CY	See specs.
No. 7 Stone	15 CY	See specs.
No. 57 Stone	66 CY	See specs.
Select Class 1 Rip Rap	17 CY	Used for riprap swale and boulder weir. See specs.
Boulders	5 CY	Used for boulder weir. See specs.
4" Perforated PVC Pipe	70 LF	See specs.
4" Flexible PE Pipe	135 LF	See specs.
Geotextile	455 SF	See specs.
Turf Reinforcement Mat (TFM)	25 SY	See specs.
SEDIMENT AND EROSION CONTROL		
<u>tem</u>	Quantity Units	<u>Notes</u>
Blaze Orange Fence (Construction Fence) 894 LF	
Silt Fence	332 LF	
Filter Logs	286 LF	
ree Protection	2 EA	
Sump Pit	1 EA	
Pump	1 EA	
ilter Bag	1 EA	
Stabilized Construction Enterance	40 TONS	

CLIENT

HOWARD COUNTY STORMWATER MANAGEMENT DIVISION 6751 COLUMBIA GATEWAY DRIVE SUITE 514 COLUMBIA, MD 21046

ISSUES / REVISIONS

SUPPLEMENTAL PLAN TO PROVIDE WATER QUALITY RETROFIT FOR 0.71 AC. OF SITE



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Restore the Earth & Inspire Ecological Stewardship

REVISED SITE DEVELOPMENT PLAN **ROCKBURN** BRANCH PARK OUTFALL D RETROFIT

MATERIAL SPECIFICATIONS

SCALE: AS SHOWN BY: CHECK:
AL/KT MT/JZ/BA