

GENERAL INFORMATION

1. THE SUBJECT PROPERTIES ARE ZONED "POR" AND "NT" IN ACCORDANCE WITH THE OCTOBER 6, 2013 COMPREHENSIVE ZONING REGULATIONS.
2. THE DEPARTMENT OF PLANNING AND ZONING AND THE HOWARD SOIL CONSERVATION DISTRICT HAVE DETERMINED THAT THE DISTURBANCES WITHIN THE 100-YEAR FLOODPLAIN, WETLANDS, STREAM AND REQUIRED BUFFERS FOR THE PROPOSED STREAM RESTORATION PROJECT ARE CONSIDERED ESSENTIAL OR NECESSARY IN ACCORDANCE WITH SECTIONS 16.15(C) AND 16.16(C) OF THE SUBDIVISION AND LAND DEVELOPMENT REGULATIONS.
3. THIS PROJECT IS NOT A SUBDIVISION, AND THEREFORE THIS PLAN IS NOT REQUIRED TO MEET THE PROVISIONS OF SECTION 16.124 OF THE HOWARD COUNTY CODE AND THE LANDSCAPE MANUAL.
4. THERE ARE NO BURIAL GROUNDS OR CEMETERY SITES LOCATED ON THE PROJECT SITE.
5. ALL CONSTRUCTION SHALL BE IN ACCORDANCE WITH THE STANDARDS AND SPECIFICATIONS OF HOWARD COUNTY CONTAINED HEREIN PLUS MSHA STANDARDS AND SPECIFICATIONS, IF APPLICABLE.
6. THE CONTRACTOR SHALL NOTIFY THE DEPARTMENT OF PUBLIC WORKS, BUREAU OF ENGINEERING/CONSTRUCTION INSPECTION DIVISION AT (410) 315-1880 24 HOURS IN ADVANCE OF ANY WORK BEING DONE.
7. THE CONTRACTOR SHALL NOTIFY "MISS UTILITY" AT 1-800-257-7777 AT LEAST 48 HOURS PRIOR TO ANY EXCAVATION WORK BEING DONE.
8. THE COORDINATES SHOWN HEREON ARE BASED ON HOWARD COUNTY GEODETIC CONTROL, WHICH IS BASED UPON THE MARYLAND STATE PLANE COORDINATE SYSTEM. HOWARD COUNTY MONUMENT NUMBERS 55 C2 & 29 IA WERE USED FOR THIS SITE.
9. WATER IS PUBLIC.
10. SEWER IS PUBLIC.
11. EXISTING UTILITIES ARE BASED ON FIELD SURVEYS AND AVAILABLE RECORD DRAWINGS.
12. THE WETLANDS DELINEATION FOR THIS PROJECT WAS PERFORMED BY KC TECHNOLOGIES INC. ON JULY 22, 2013 AND JULY 24, 2013.
13. THE EXISTING TOPOGRAPHY IS TAKEN FROM FIELD RUN SURVEY WITH ONE FOOT CONTOUR INTERVALS PREPARED BY KC TECHNOLOGIES, INC., IN JUNE 2015.
14. ALL WORK SHALL CONFORM TO THE MDE BEST MANAGEMENT PRACTICES FOR WETLANDS AND WATERWAYS AS LISTED IN THE REQUIREMENTS OF THE NONTIDAL WETLANDS AND WATERWAYS PERMIT APPROVED ON (MDE TRACKING #1B-NT-3234/201661425).
15. NO TRAFFIC STUDY IS REQUIRED FOR THIS PROJECT.
16. OBSTRUCTIONS SHOWN ON THIS DRAWING ARE FOR THE CONVENIENCE OF THE CONTRACTOR ONLY AND KC TECHNOLOGIES, INC. DOES NOT WARRANT OR GUARANTEE THE CORRECTNESS OR COMPLETENESS OF THE INFORMATION GIVEN. SHOULD THE CONTRACTOR DISCOVER ANY DISCREPANCIES BETWEEN THE PLANS AND THE FIELD CONDITIONS, THE CONTRACTOR MUST VERIFY SUCH INFORMATION TO HIS OWN SATISFACTION. THE ENGINEER SHALL BE NOTIFIED IMMEDIATELY TO RESOLVE THE SITUATION. SHOULD THE CONTRACTOR MAKE FIELD CORRECTIONS OR ADJUSTMENTS WITHOUT NOTIFYING THE ENGINEER, THE CONTRACTOR ASSUMES ALL RESPONSIBILITY FOR THOSE CHANGES.
17. THE CONTRACTOR SHALL TAKE ALL NECESSARY PRECAUTIONS TO PROTECT THE EXISTING UTILITIES AND MAINTAIN UNINTERRUPTED SERVICE. ANY DAMAGE INCURRED DUE TO THE CONTRACTOR'S OPERATION SHALL BE REPAIRED IMMEDIATELY AT THE CONTRACTOR'S EXPENSE.
18. A WAIVER PETITION (WP-17-021) WAS APPROVED ON OCTOBER 24, 2016 FROM SECTION 16.155(d)(4)(ii), MAKING THE PROJECT EXEMPT FROM AN SDP SUBMITTAL AND SECTION 16.1205(j)(7), THAT ALLOWS THE REMOVAL OF ONE SPECIMEN TREE WITHIN THE PROJECT AREA. APPROVAL OF THE WAVER PETITION IS SUBJECT TO THE FOLLOWING CONDITIONS:

1. THE ALTERNATIVE COMPLIANCE PLAN EXHIBIT SHALL SERVE AS THE SUBSTITUTE FOR A SITE DEVELOPMENT PLAN FOR THE PROPOSED DEVELOPMENT. NO DISTURBANCE IS PERMITTED BEYOND THE 4.22 ACRE LIMIT OF DISTURBANCE AS SHOWN ON THE PLAN EXHIBIT UNLESS IT CAN BE SUFFICIENTLY DEMONSTRATED BY THE APPLICANT TO BE JUSTIFIED.
2. THE PROPOSED DISTURBANCE TO 0.28 ACRES OF EXISTING FOREST CONSERVATION EASEMENT SHALL BE REPLANTED ON-SITE WITHIN THE EXISTING EASEMENT PER HOWARD COUNTY CREATION & PARKS STANDARDS.
3. THE REMOVAL OF SPECIMEN TREE #10 (32" BLACK CHERRY) IS PERMITTED AS SHOWN ON THE PLAN EXHIBIT. THE REMOVAL OF ANY ADDITIONAL SPECIMEN TREE IS NOT PERMITTED UNDER THIS ALTERNATIVE COMPLIANCE REQUEST. ALL EFFORTS SHALL BE MADE TO REDUCE IMPACTS TO SPECIMEN TREES DURING CONSTRUCTION. TREE PROTECTION MEASURES AS DETAILED ON THE PLAN EXHIBIT SHALL BE UTILIZED AS NECESSARY.
4. ONCE THE PROPOSED PROJECT IS COMPLETE, THE LIMIT OF DISTURBANCE SHALL BE RESTORED TO ITS PREVIOUS CONDITION THROUGH STABILIZATION AND REPLANTING OF FOREST RESOURCES.
5. COMPLIANCE WITH THE COMMENTS FROM DPZ- DIVISION OF LAND DEVELOPMENT.
6. THE APPLICANT SHALL OBTAIN ALL REQUIRED AUTHORIZATIONS AND PERMITS FROM THE MARYLAND DEPARTMENT OF THE ENVIRONMENT AND U.S. ARMY CORPS OF ENGINEERS FOR DISTURBANCES WITHIN THE FLOODPLAIN, WETLANDS, STREAMS AND THEIR BUFFERS. REFERENCE ANY APPLICABLE MDE OR USACOE PERMITS OR TRACKING NUMBERS ON THE BUILDING OR GRADING PERMITS.

19. FOREST CONSERVATION OBLIGATIONS FOR THE PORTION OF THE HOWARD COMMUNITY COLLEGE PROPERTY ZONED "POR" HAVE BEEN PREVIOUSLY ADDRESSED UNDER SDP-01-058 AND SDP-03-156. THE PORTION OF PROPERTY ZONED "NT" IS EXEMPT FROM FOREST CONSERVATION IN ACCORDANCE WITH SECTION 16.1202(b)(1)(iv) OF THE SUBDIVISION AND LAND DEVELOPMENT REGULATIONS. THEREFORE, THIS PROJECT IS NOT REQUIRED TO ADDRESS FOREST CONSERVATION.
20. THE UNNAMED TRIBUTARIES TO THE LITTLE PATUXENT RIVER ARE NOT TIER 2 WATERWAYS. ACCORDING TO THE MD303d LIST, THE LITTLE PATUXENT RIVER IS CURRENTLY IMPAIRED FOR CHLORIDES. THE LITTLE PATUXENT RIVER IS LISTED AS CATEGORY 4a, TMDL COMPLETED, FOR TOTAL SUSPENDED SOLIDS AND PHOSPHORUS.
21. THE PROJECT IS WITHIN THE HOWARD COMMUNITY COLLEGE PROPERTY, AND IS OWNED BY THE BOARD OF TRUSTEES, HOWARD COMMUNITY COLLEGE.

SPECIAL CONTRACTOR NOTES

1. 100-YEAR FLOODPLAIN LIMIT IS GRAPHICALLY SHOWN ON THE PLANS.
2. NO STOCKPILE OF ANY MATERIAL IS ALLOWED IN THE 100-YEAR FLOODPLAIN.
3. IN-STREAM WORK IS PROHIBITED FROM MARCH 1 TO MAY 31, INCLUSIVE. STREAM CLASSIFICATIONS: USE IV.
4. CONTRACTOR SHALL CONTINUALLY MONITOR WEATHER FORECASTS DURING WORK ACTIVITIES AND SCHEDULE WORK DURING FAVORABLE CONDITIONS.
5. THE CONTRACTOR SHALL EXERCISE CARE IN ACTIVITIES INVOLVING EITHER CUT AND FILL OR GRADING IN THE VICINITY OF TREES THAT ARE TO REMAIN AT THE CONSTRUCTION SITE. ALL EARTH CUTS AND ACTIVITIES IN THE VICINITY OF TREES TO REMAIN SHALL BE MADE IN A MANNER THAT DOES NOT DISTURB THE CRITICAL ROOT ZONE WITHIN THE DRIPLINE OF THE TREE. PROTECTIVE ORANGE FENCING SHALL BE INSTALLED AROUND THE PERIMETER OF THE CRITICAL ROOT ZONE PRIOR TO CONSTRUCTION. THE LOCATION OF THE PROTECTIVE ORANGE FENCING SHALL BE APPROVED BY HOWARD COUNTY DEPARTMENT OF RECREATION AND PARKS PRIOR TO CONSTRUCTION.
6. CONTRACTOR SHALL NOT STORE EQUIPMENT, MATERIALS AND/OR SUPPLIES BEYOND THE ORANGE FENCING SHOWN ON THE PLANS.
7. UPON COMPLETION OF THE WORK, BUT PRIOR TO DE-MOBILIZATION, THE CONTRACTOR SHALL REMOVE ALL REMNANTS OF CONSTRUCTION MATERIALS FROM THE SITE. THE CONTRACTOR SHALL RESTORE ALL DISTURBED AREAS TO A CONDITION EQUAL TO OR BETTER THAN THE PRE-CONSTRUCTION CONDITIONS.
8. PRIOR TO BEGINNING ANY CONSTRUCTION ACTIVITIES, PHOTOGRAPHS OF THE PROPOSED WORK AREA AND ACCESS SHALL BE TAKEN.
9. ALL TREES TO BE REMOVED SHALL BE CUT AT THE BASE WITH A SAW AND NOT PUSHED OVER. TREE STUMPS MAY BE LEFT IN PLACE, UNLESS OTHERWISE DIRECTED ON THE PLANS.
10. ALL MATERIAL SHALL BE REMOVED AND DISPOSED OFFSITE.
11. THE CONTRACTOR SHALL PAY CLOSE ATTENTION TO PEDESTRIANS WALKING NEAR THE WORK SITE.
12. WORKING HOURS ARE 7AM TO 7PM MONDAY THROUGH FRIDAY.
13. THE CONTRACTOR SHALL AVOID TRACKING HEAVY EQUIPMENT OVER THE CRITICAL ROOT ZONE OF SPECIMEN TREES. IF UNAVOIDABLE, LOAD MATS SHOULD BE USED WHEN TRACKING OVER THE CRITICAL ROOT ZONES.
14. WORK AREAS SHALL BE PERMANENTLY STABILIZED DAILY BEFORE LEAVING THE WORK SITE.
15. PROVIDE TEMPORARY WOOD MATS FOR CONSTRUCTION TRAFFIC THROUGH WETLAND AREAS. WOOD MATS SHALL BE REVIEWED AND APPROVED BY THE INSPECTOR AS APPLIED DURING CONSTRUCTION. ALL MATERIAL SHALL BE REMOVED UPON CONSTRUCTION COMPLETION.
16. SOIL STABILIZATION MATTING IS TO BE PLACED THROUGHOUT THE MAJORITY OF THE SITE DUE TO THE ERUPTION OF HIGHLY ERODIBLE SOILS FOUND ON SITE. NATURAL FIBER MATTING SHALL BE PLACED THROUGHOUT THE PROJECT SITE WHERE ANY GRADING IS PERFORMED. WITH THE EXCEPTION OF AREAS USING REINFORCED NATURAL FIBER MATTING AS SHOWN IN THE DETAILS. AREAS WHERE CLEARING AND GRADING ARE NOT PERFORMED (E.G. LOCATIONS OF HOSE FOR PUMP AROUND CONSTRUCTION ACCESS, OR AREAS NOT GRADED) DO NOT REQUIRE THE APPLICATION OF SOILSTABILIZATION MATTING.

NO.	REVISIONS DESCRIPTION	1 AS-BUILT DRAWING
DATE	03/09/17	KC FILE: M:\2013\17133314.83\

936 RIDGEBROOK ROAD
SPARKS, MARYLAND 21152
TELEPHONE: (410) 316-7818
FAX: (410) 316-7818
www.kci.com



HOWARD COMMUNITY COLLEGE
STREAM RESTORATION PROJECT
CAPITAL PROJECT D-1158
HOWARD COUNTY DEPARTMENT OF PUBLIC WORKS
STORMWATER MANAGEMENT DIVISION
6751 COLUMBIA GATEWAY DRIVE
COLUMBIA, MD 21046
PARCELS 47, 81 TAX MAP 35, 36
ELECTION DISTRICT 05
ZONING POR NT 0006


TITLE SHEET
AS-BUILT

FILE: G:\KCI\Sparks\christopher_dels\11832\11832redline as-built 2017.dwg
DATE: NOVEMBER 2016
KC JOB NO.: 17133314.83
CAPITAL PROJECT NO.: D-1158
PERMIT ISSUE:
CONSTRUCTION ISSUE:
TI-01
SHEET NO.: 1 OF 36


HOWARD COMMUNITY COLLEGE STREAM RESTORATION PROJECT

SHEET INDEX


DWG. NO.	SHEET NO.	SHEET TITLE
TI-01	1	TITLE SHEET (AS-BUILT)
ER-01	2	ENVIRONMENTAL RESOURCES MAP
GS-01 TO GS-04	3-6	GEOMETRY PLANS
PS-01 TO PS-04	7-10	GRADING PLANS (AS-BUILT)
DE-01 TO DE-04	11-14	STREAM DETAILS
PR-01 TO PR-03	15-17	PROFILES (AS-BUILT)
ES-01 TO ES-05	18-22	EROSION & SEDIMENT CONTROL PLANS
ES-06	23	EROSION & SEDIMENT CONTROL DETAILS
ES-07	24	EROSION & SEDIMENT CONTROL NOTES
LS-01 TO LS-04	25-28	LANDSCAPE PLANS
LD-01	29	LANDSCAPE DETAILS
FCP-00	30	FOREST CONSERVATION PLANS KEY MAP
FCP-01 TO FCP-05	31-35	FOREST CONSERVATION PLANS
FCP-06	36	FOREST CONSERVATION NOTES AND DETAILS

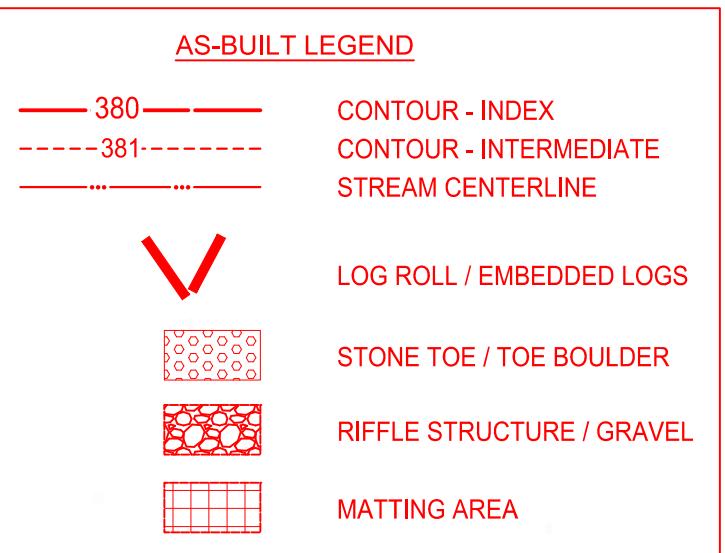

LEGEND

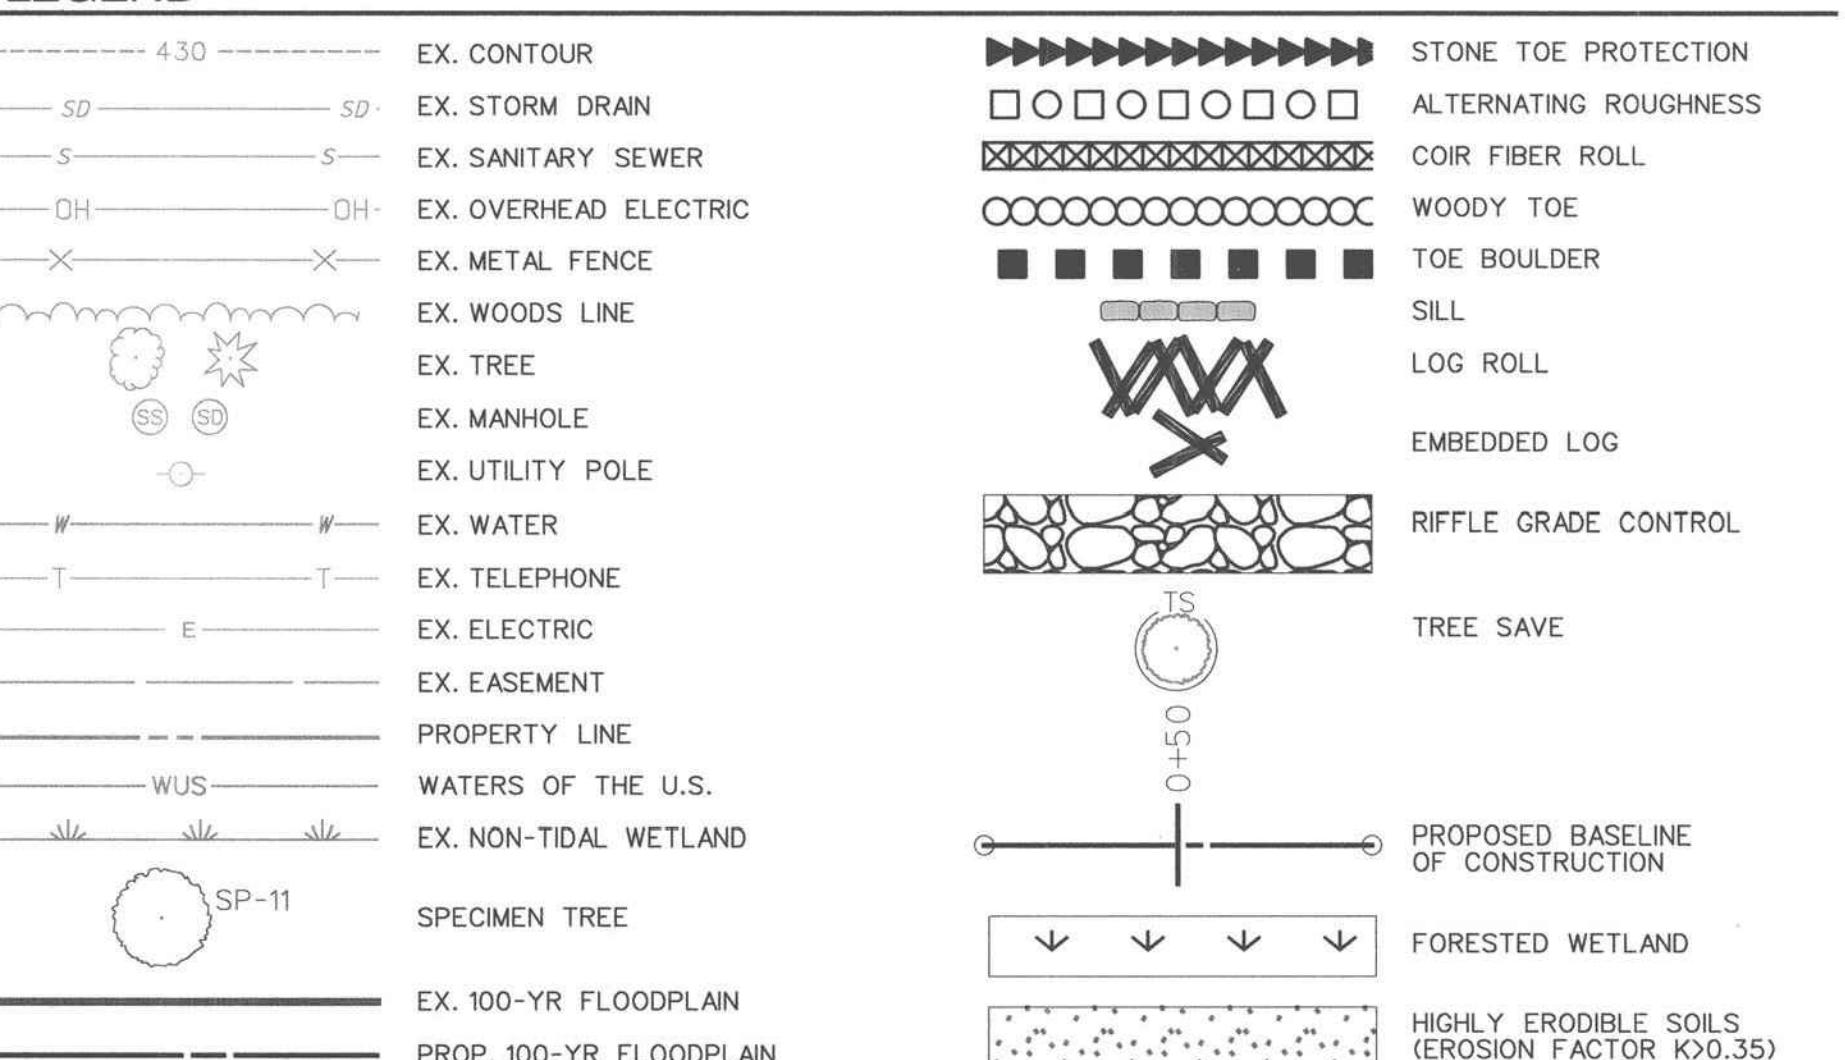

HOWARD COUNTY, MARYLAND DEPARTMENT OF PUBLIC WORKS CAPITAL PROJECT NUMBER D-1158

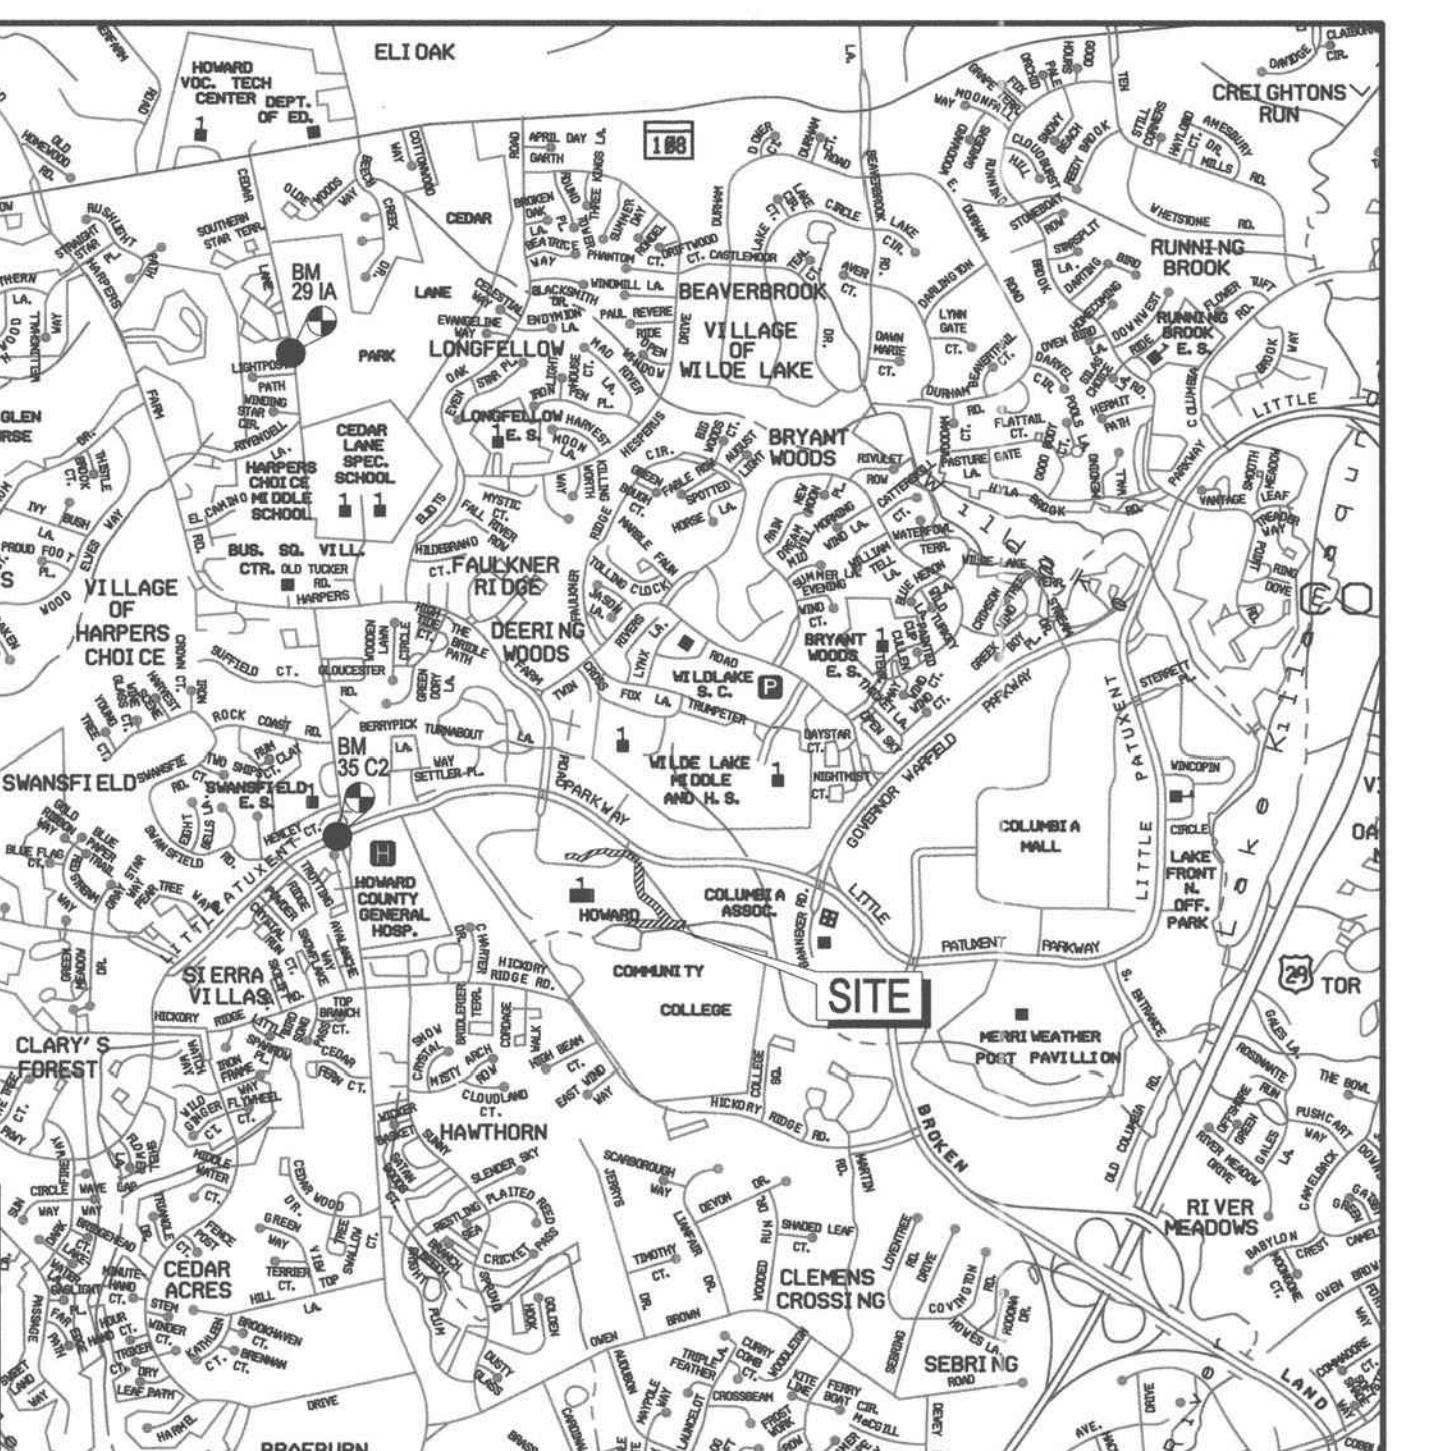

VICINITY MAP
SCALE: 1" = 2000'


ADC MAP COORD. 4934/K6

HOWARD COUNTY SURVEY CONTROL				
DESIGNATION	PID	NORTHING	EASTING	ELEVATION
35 C2	N/A	563,920.835	1,344,204.120	463.40
29 IA	N/A	568,986.073	1,343,640.108	482.04

HORIZ NAD 83/91
VERT NAVD 88

ENGINEER'S CERTIFICATE

"I CERTIFY THAT THIS PLAN FOR SEDIMENT AND EROSION CONTROL REPRESENTS A PRACTICAL AND WORKABLE PLAN BASED ON MY PERSONAL KNOWLEDGE OF THE SITE CONDITIONS AND THAT IT WAS PREPARED IN ACCORDANCE WITH THE REQUIREMENTS OF THE HOWARD COUNTY SOIL CONSERVATION DISTRICT"

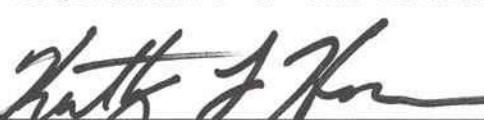
SIGNATURE OF ENGINEER (PRINT NAME BELOW SIGNATURE)

P.E. # 38311

DATE 01/17/16


DEVELOPER'S CERTIFICATE

"I/WE CERTIFY THAT ALL DEVELOPMENT AND CONSTRUCTION WILL BE DONE ACCORDING TO THIS PLAN FOR SEDIMENT AND EROSION CONTROL, AND THAT ALL RESPONSIBLE PERSONNEL INVOLVED IN THE CONSTRUCTION PROJECT WILL HAVE A CERTIFICATE OF ATTENDANCE AT A DEPARTMENT OF THE ENVIRONMENT APPROVED TRAINING PROGRAM FOR THE CONTROL OF SEDIMENT AND EROSION BEFORE THE BEGINNING OF THE PROJECT. I ALSO AUTHORIZE PERIODIC ON-SITE INSPECTION BY THE HOWARD COUNTY SOIL CONSERVATION DISTRICT"


SIGNATURE OF DEVELOPER (PRINT NAME BELOW SIGNATURE)


DATE 12-8-16

DEPARTMENT OF PUBLIC WORKS, HOWARD COUNTY, MD

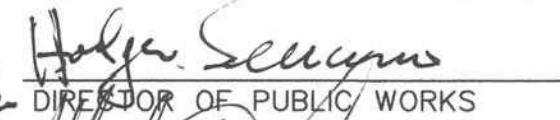
DATE 12/6/16
DIRECTOR OF PUBLIC WORKS


DATE 12/6/16
CHIEF, BUREAU OF ENVIRONMENTAL SERVICES


DATE 12/6/16
CHIEF, STORMWATER MANAGEMENT DIVISION

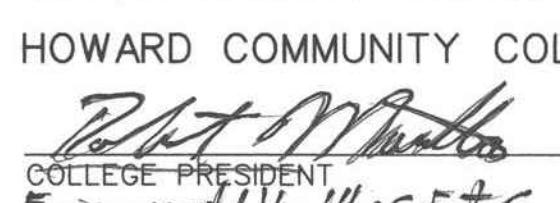
DATE 12/8/16
COLLEGE PRESIDENT
Environmental Health & Safety Supervisor


PERMIT INFORMATION CHART


SUBDIVISION NAME	SECTION/AREA	PARCEL # (LOTS A-1-A-4)
0000		47, 81 (LOTS A-1-A-4)

PLAT# or L/F	GRID #	ZONING	TAX MAP NO.	ELECT. DISTR.	CENSUS TRACT
18178, 2352	0006	POR, NT	35, 36	05	602202

WATER CODE	PUBLIC	SEWER CODE	PUBLIC

THIS DEVELOPMENT IS APPROVED FOR SOIL EROSION AND SEDIMENT CONTROL BY THE HOWARD SOIL CONSERVATION DISTRICT.

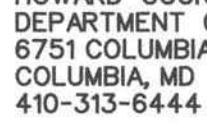
DATE 12/11/16
OWNER:
HOWARD COUNTY
DEPARTMENT OF PUBLIC WORKS
6751 COLUMBIA GATEWAY DRIVE
COLUMBIA, MD 21046
410-313-6444

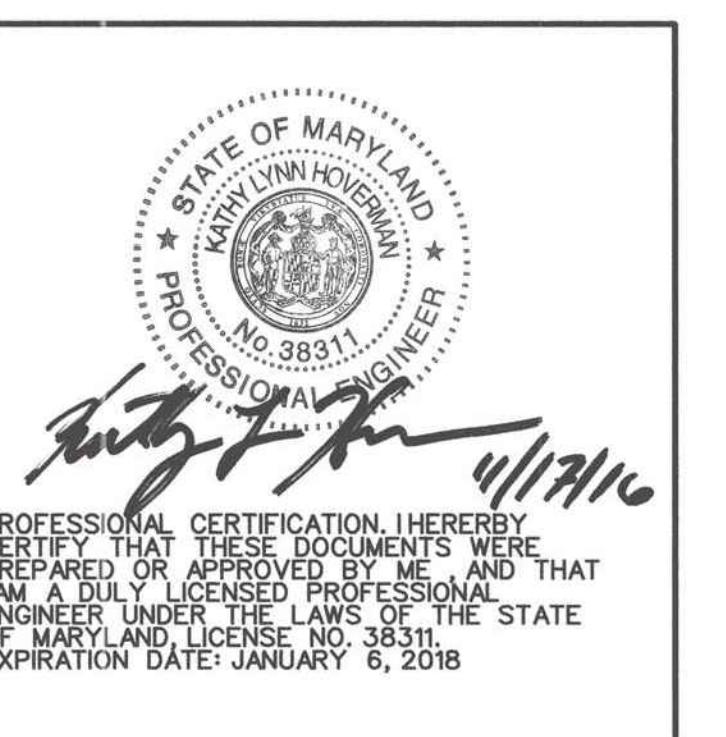

PROFESSIONAL ENGINEER
No. 38311
Signature 12/11/16

GEORGE WILLIAM STEPHENS, JR. and ASSOCIATES, INC.
ENGINEERS, PLANNERS, SURVEYORS, TRANSPORTATION
4692 MILLENNIUM DRIVE, SUITE 100
BELCAMP, MARYLAND 21027
Phone: (410) 297-2340 gwestephens.com Fax: (410) 297-2345

AS-BUILT LEGEND	
380	CONTOUR - INDEX
381	CONTOUR - INTERMEDIATE
	STREAM CENTERLINE
✓	LOG ROLL / EMBEDDED LOGS
██████	STONE TOE / TOE BOULDER
████	RIFFLE STRUCTURE / GRAVEL
██████	MATTING AREA

RIFFLE GRADE CONTROL		
FROM STATION	TO STATION	OFFSET
1+02	1+27	

COIR FIBER ROLL		
FROM STATION	TO STATION	OFFSET
2+07	2+67	R
3+00	3+06	R/L
3+45	4+26	R
3+75	4+29	L

* OFFSETS ARE DETERMINED FACING DOWNSTREAM


STONE TOE PROTECTION		
FROM STATION	TO STATION	OFFSET
1+02	1+27	R/L

* OFFSETS ARE DETERMINED FACING DOWNSTREAM

ALTERNATING ROUGHNESS		
FROM STATION	TO STATION	OFFSET
1+27	1+57	L
1+75	2+07	R
2+07	2+67	L
2+67	3+00	R
3+06	3+40	L

* OFFSETS ARE DETERMINED FACING DOWNSTREAM

EMBEDDED LOG		
STATION		
2+20		
2+49		
3+87		
4+15		

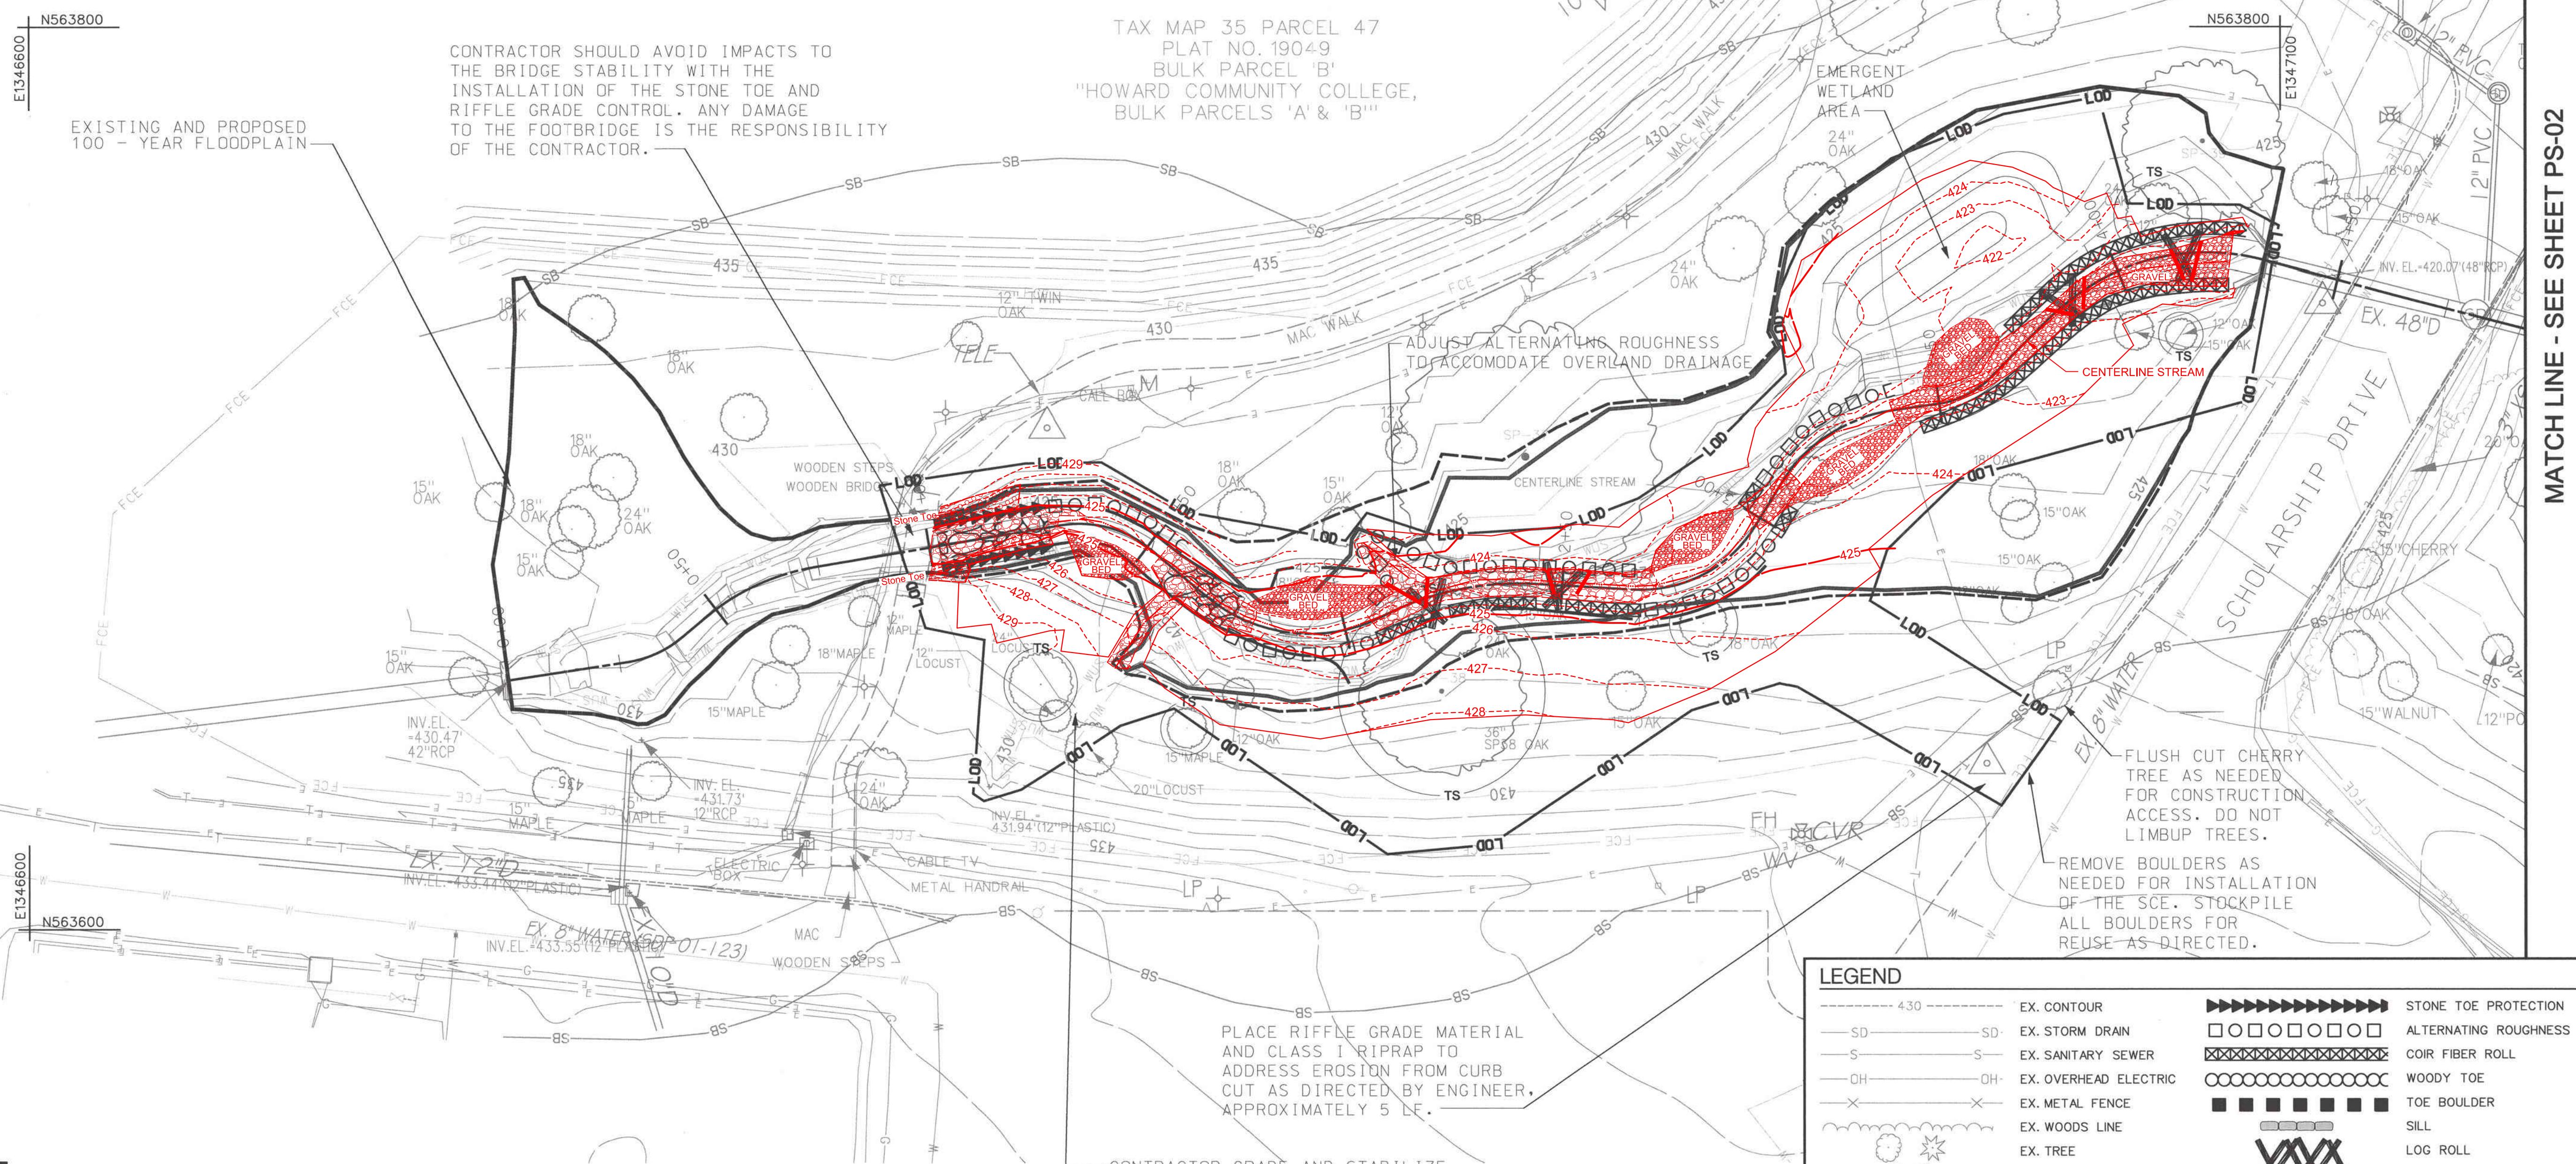

GEORGE WILLIAM STEPHENS, JR. and ASSOCIATES, INC.
ENGINEERS, PLANNERS, SURVEYORS, TRANSPORTATION
4092 MILLENNIUM DRIVE, SUITE 100
BELCAMP, MARYLAND 21027
Phone: (410) 297-3340 gwestephen.com Fax: (410) 297-2345

GRAPHIC SCALE
20 0 10 20 40
(IN FEET)
1 inch = 20ft.


NO. / REVISIONS DESCRIPTION	DATE
1 / AS-BUILT DRAWING	03 / 09 / 17
KCIFILE: M:\2013\17133314.83\	



HOWARD COMMUNITY COLLEGE
STREAM RESTORATION PROJECT
CAPITAL PROJECT D-1158
HOWARD COUNTY DEPARTMENT OF PUBLIC WORKS
STORMWATER MANAGEMENT DIVISION
6751 COLUMBIA GATEWAY DRIVE
COLUMBIA, MD 21046
PARCELS 47, 81 TAX MAP 35-36
GRID BLOCK 0006
ZONING POR, NT ELECTION DISTRICT 06


GRADING PLAN AS-BUILT

SCALE: 1" - 20'
DATE: NOVEMBER 2016
KCI JOB NO.: 17133314.83
CAPITAL PROJECT NO.: D-1158
PERMIT ISSUE:
CONSTRUCTION ISSUE:
PS-01
SHEET NO.: 7 OF 36

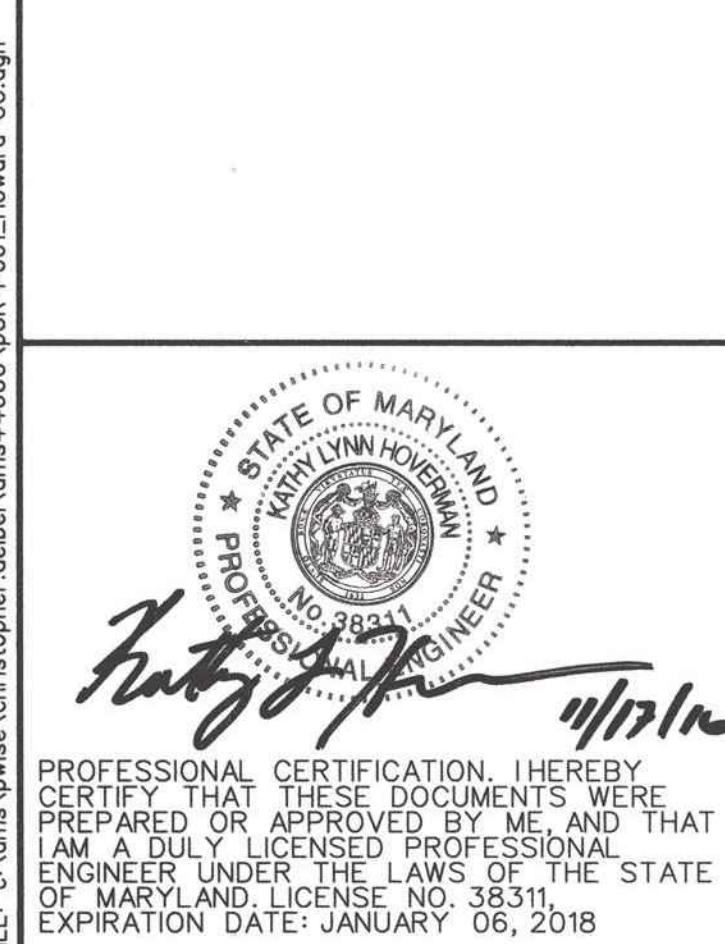

DEPARTMENT OF PUBLIC WORKS, HOWARD COUNTY, MD
Mark D. Luehrs
CHIEF, BUREAU OF ENVIRONMENTAL SERVICES
DATE: 12/16/16

MATCH LINE - SEE SHEET PS-01

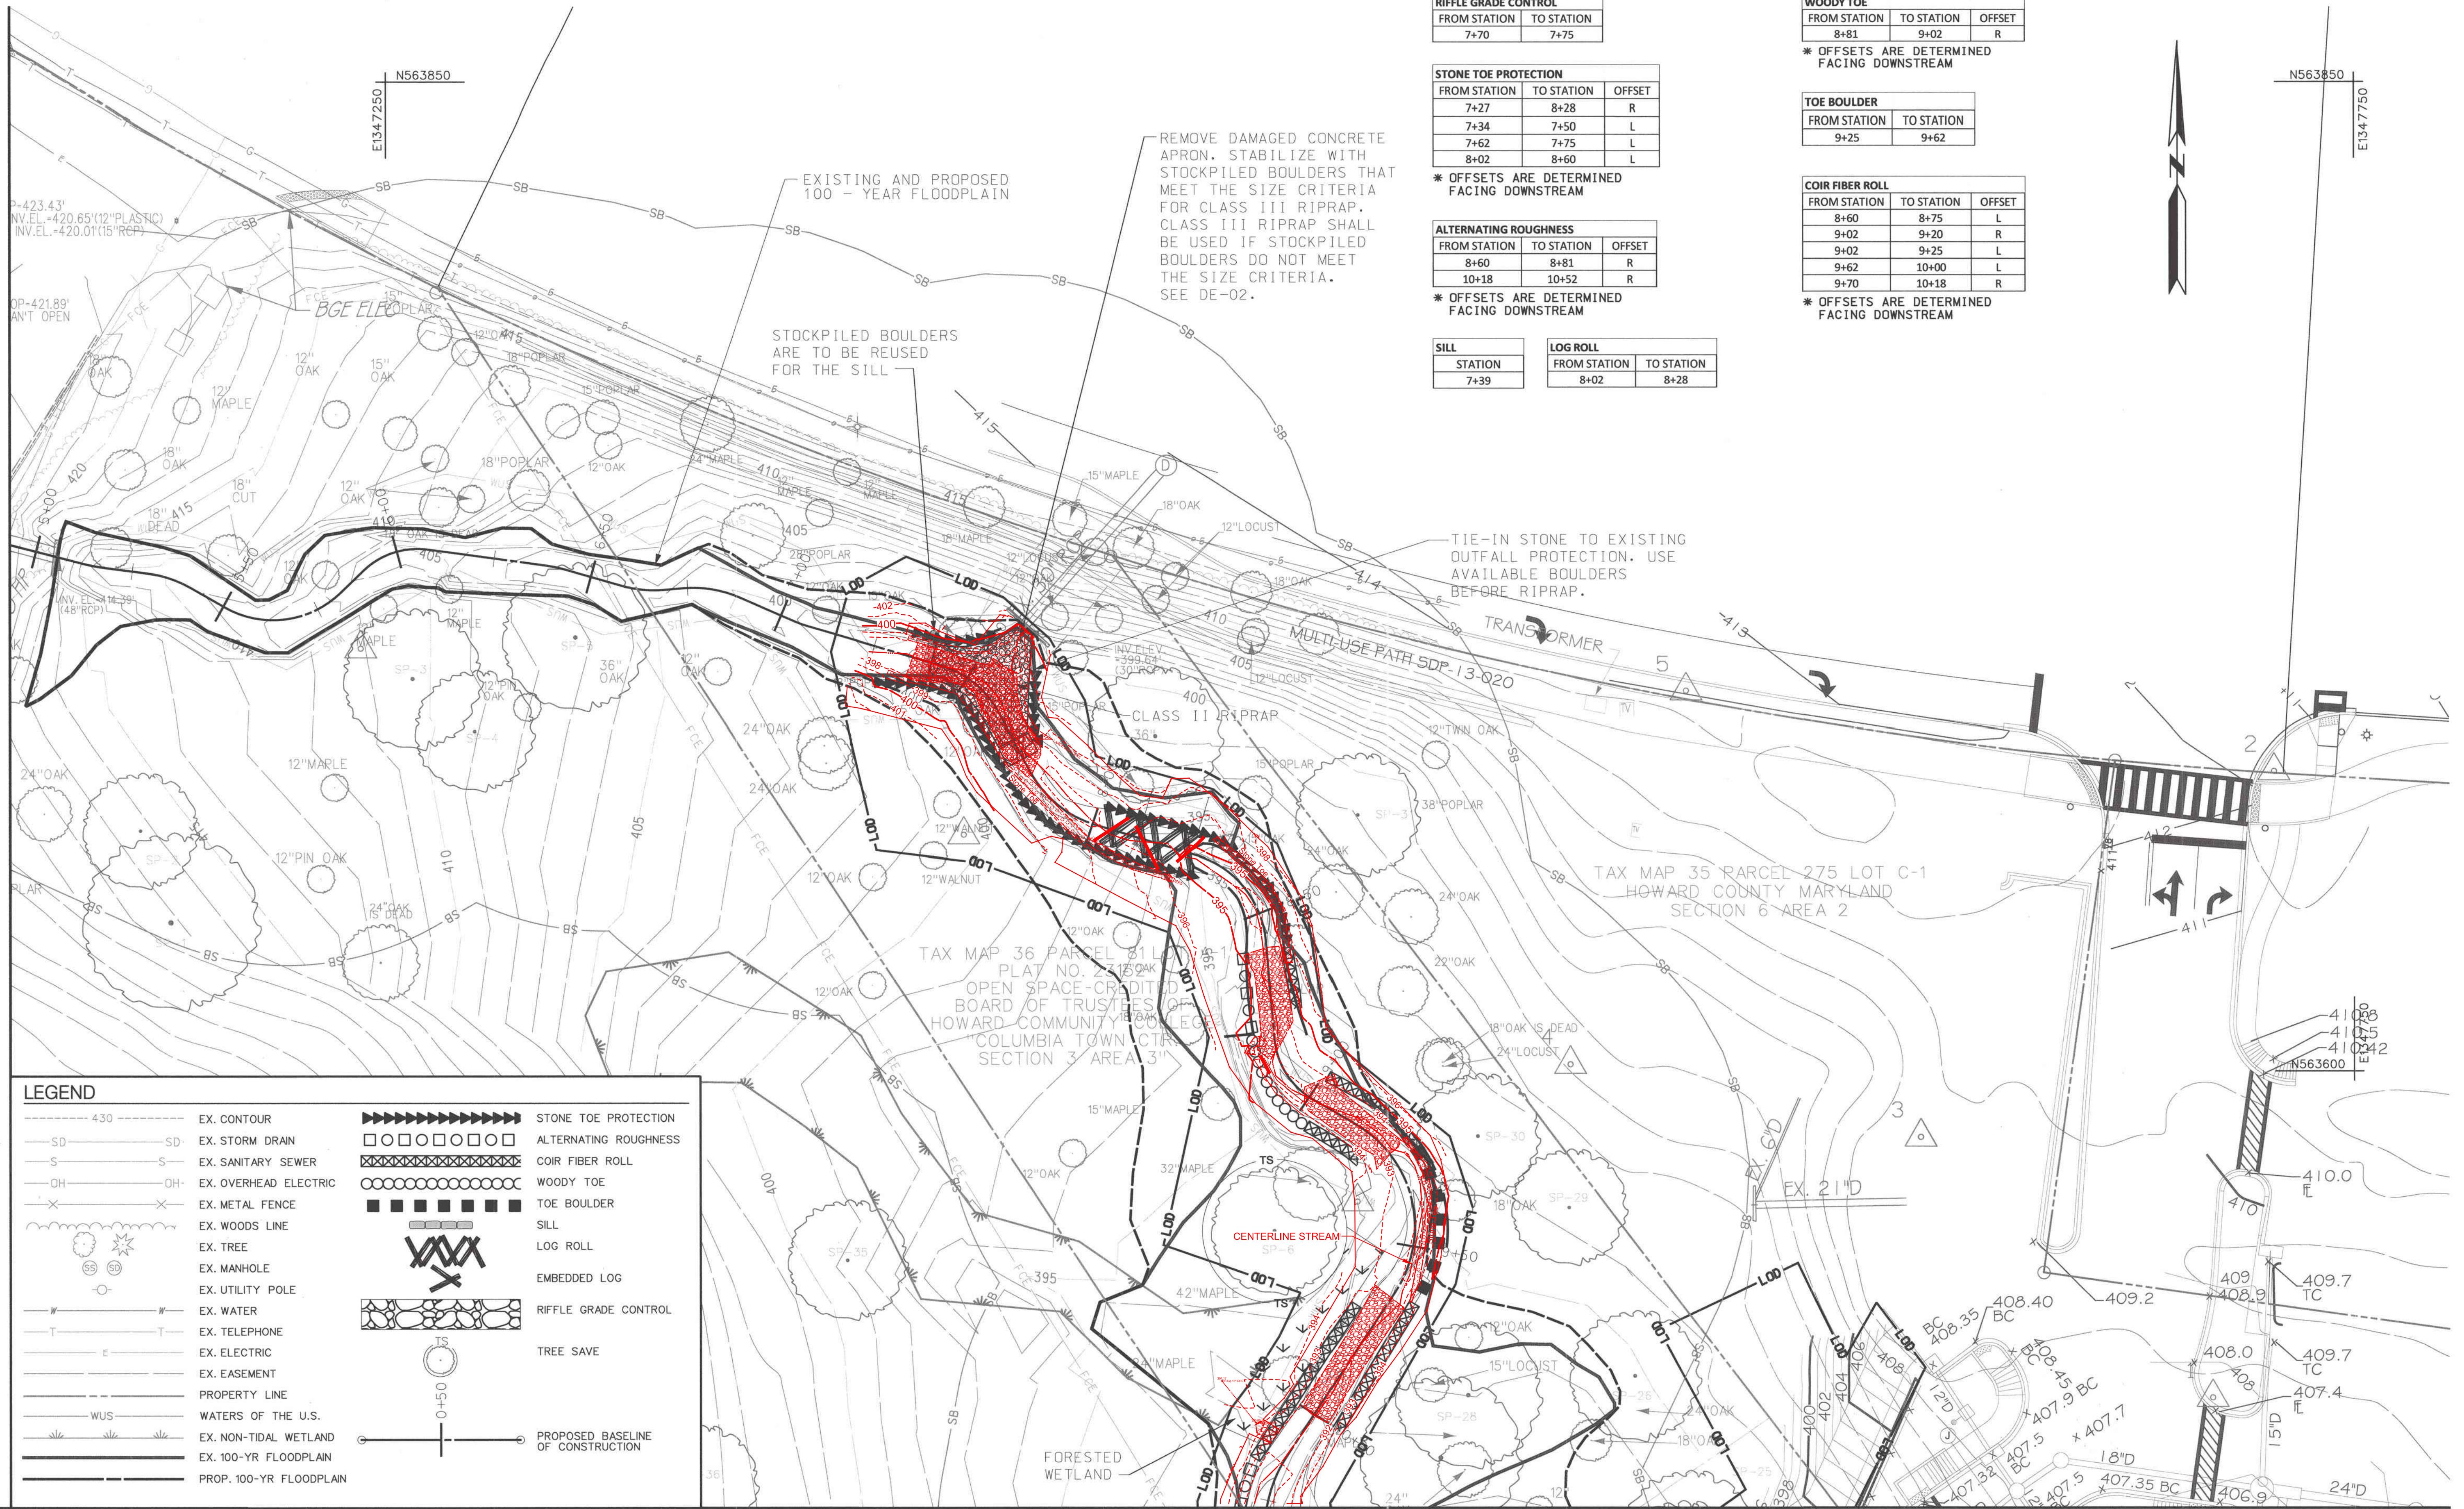



NOTED: "12:40 PM on Wednesday, November 16, 2016"
FILE: C:\dmoc\mwise\christopher dekel\dmc4A000\SCP-B002 Howard CC dan

PROFESSIONAL CERTIFICATION. I HEREBY CERTIFY THAT THESE DOCUMENTS WERE PREPARED OR APPROVED BY ME, AND THAT I AM A DULY LICENSED PROFESSIONAL ENGINEER UNDER THE LAWS OF THE STATE OF MARYLAND. LICENSE NO. 38311, EXPIRATION DATE: JANUARY 06, 2018

AT
DEPARTMENT OF PUBLIC WORKS, HOWARD COUNTY, MD
Mark A. Bruce
CHIEF, BUREAU OF ENVIRONMENTAL SERVICES

MATCH LINE - SEE SHEET PS-03

A graphic scale diagram with markings at 0, 10, 20, and 40. The scale is labeled "GRAPHIC SCALE" at the top. Below the scale, it says "(IN FEET)" and "1 inch = 20ft".

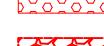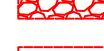
<u>AS-BUILT LEGEND</u>	
— 380 —	CONTOUR - INDEX
- - - 381 - - -	CONTOUR - INTERMEDIATE
— ... — .. —	STREAM CENTERLINE
	LOG ROLL / EMBEDDED LOGS
	STONE TOE / TOE BOULDER
	RIFFLE STRUCTURE / GRAVEL
	MATTING AREA

GEORGE WILLIAM STEPHENS, JR. and ASSOCIATES, INC.
ENGINEERS·PLANNERS·SURVEYORS·TRANSPORTATION
4692 MILLENNIUM DRIVE, SUITE 100
BELCAMP, MARYLAND 21017
Phone: (410) 207-2240 Fax: (410) 207-2245
www.gwss.com

1" - 20'
NOVEMBER 2016
B NO.: 17133314.83
AL PROJECT NO.: D-1158
T ISSUE:
STRUCTION ISSUE:

PS-02

MATCH LINE - SEE SHEET PS-02

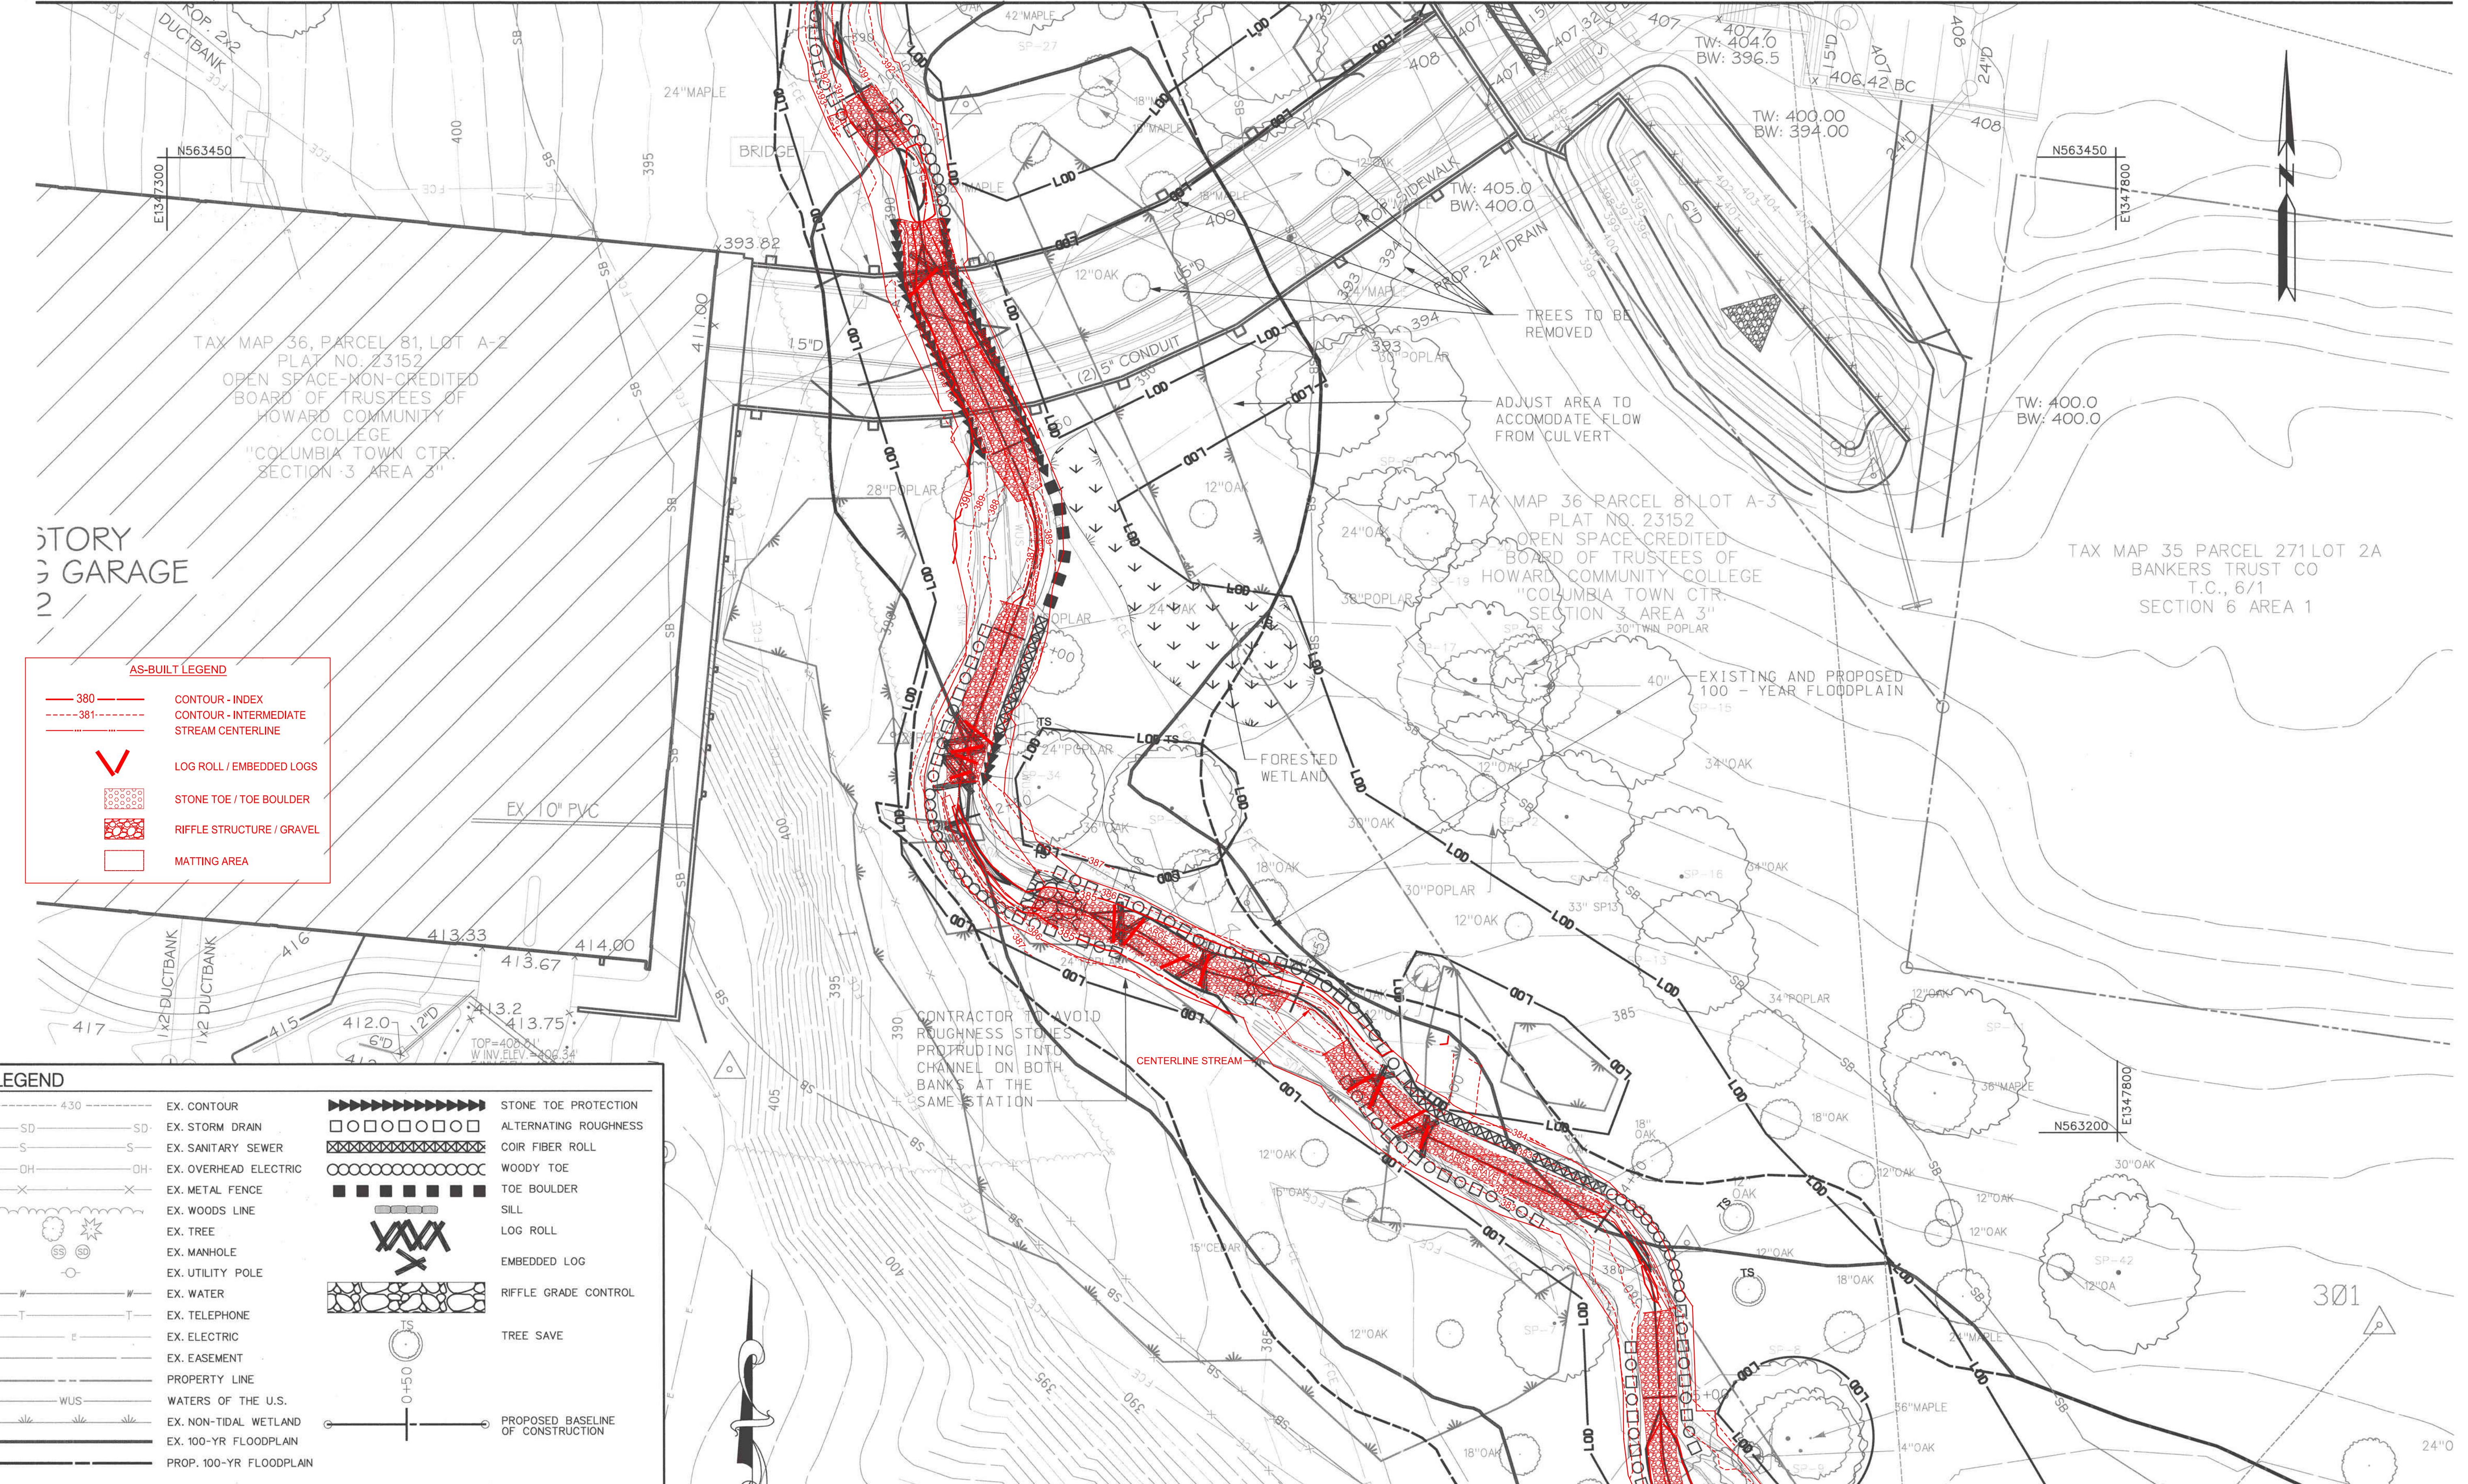

MATCH LINE - SEE SHEET PS-04

<p>KATHY LYNN HOLLOWAY PROFESSIONAL ENGINEER NO. 38311</p> <p>Natalie J. Phillips, P.E. Wednesday, November 16, 2016 FILE: G:\kci\sparks\psr\psr-d1158\ams4\d000\psr\P003HowardCC.dgn</p>	GRAPHIC SCALE																												
	20	0 10 20 40																											
(IN FEET) 1 inch = 20ft.																													
RIFFLE GRADE CONTROL <table border="1"> <thead> <tr> <th>FROM STATION</th> <th>TO STATION</th> </tr> </thead> <tbody> <tr> <td>10+52</td> <td>10+65</td> </tr> <tr> <td>12+78</td> <td>12+90</td> </tr> <tr> <td>13+34</td> <td>13+45</td> </tr> </tbody> </table>			FROM STATION	TO STATION	10+52	10+65	12+78	12+90	13+34	13+45																			
FROM STATION	TO STATION																												
10+52	10+65																												
12+78	12+90																												
13+34	13+45																												
ALTERNATING ROUGHNESS <table border="1"> <thead> <tr> <th>FROM STATION</th> <th>TO STATION</th> <th>OFFSET</th> </tr> </thead> <tbody> <tr> <td>10+18</td> <td>10+52</td> <td>R</td> </tr> <tr> <td>10+52</td> <td>10+65</td> <td>L</td> </tr> <tr> <td>12+00</td> <td>12+40</td> <td>R</td> </tr> <tr> <td>12+78</td> <td>13+03</td> <td>R</td> </tr> <tr> <td>12+81</td> <td>13+85</td> <td>L</td> </tr> <tr> <td>13+75</td> <td>14+35</td> <td>R</td> </tr> <tr> <td>14+77</td> <td>15+15</td> <td>L</td> </tr> <tr> <td>14+85</td> <td>15+82</td> <td>R</td> </tr> </tbody> </table>			FROM STATION	TO STATION	OFFSET	10+18	10+52	R	10+52	10+65	L	12+00	12+40	R	12+78	13+03	R	12+81	13+85	L	13+75	14+35	R	14+77	15+15	L	14+85	15+82	R
FROM STATION	TO STATION	OFFSET																											
10+18	10+52	R																											
10+52	10+65	L																											
12+00	12+40	R																											
12+78	13+03	R																											
12+81	13+85	L																											
13+75	14+35	R																											
14+77	15+15	L																											
14+85	15+82	R																											
COIR FIBER ROLL <table border="1"> <thead> <tr> <th>FROM STATION</th> <th>TO STATION</th> <th>OFFSET</th> </tr> </thead> <tbody> <tr> <td>11+92</td> <td>12+25</td> <td>L</td> </tr> <tr> <td>13+85</td> <td>14+47</td> <td>L</td> </tr> </tbody> </table> <p>* OFFSETS ARE DETERMINED FACING DOWNSTREAM</p>			FROM STATION	TO STATION	OFFSET	11+92	12+25	L	13+85	14+47	L																		
FROM STATION	TO STATION	OFFSET																											
11+92	12+25	L																											
13+85	14+47	L																											
STONE TOE PROTECTION <table border="1"> <thead> <tr> <th>FROM STATION</th> <th>TO STATION</th> <th>OFFSET</th> </tr> </thead> <tbody> <tr> <td>10+86</td> <td>11+50</td> <td>R</td> </tr> <tr> <td>10+86</td> <td>11+60</td> <td>L</td> </tr> <tr> <td>12+25</td> <td>12+40</td> <td>L</td> </tr> </tbody> </table> <p>* OFFSETS ARE DETERMINED FACING DOWNSTREAM</p>			FROM STATION	TO STATION	OFFSET	10+86	11+50	R	10+86	11+60	L	12+25	12+40	L															
FROM STATION	TO STATION	OFFSET																											
10+86	11+50	R																											
10+86	11+60	L																											
12+25	12+40	L																											
WOODY TOE <table border="1"> <thead> <tr> <th>FROM STATION</th> <th>TO STATION</th> <th>OFFSET</th> </tr> </thead> <tbody> <tr> <td>10+65</td> <td>10+86</td> <td>L</td> </tr> <tr> <td>12+40</td> <td>12+78</td> <td>R</td> </tr> <tr> <td>14+47</td> <td>14+77</td> <td>L</td> </tr> </tbody> </table> <p>* OFFSETS ARE DETERMINED FACING DOWNSTREAM</p>			FROM STATION	TO STATION	OFFSET	10+65	10+86	L	12+40	12+78	R	14+47	14+77	L															
FROM STATION	TO STATION	OFFSET																											
10+65	10+86	L																											
12+40	12+78	R																											
14+47	14+77	L																											
EMBEDDED LOG <table border="1"> <thead> <tr> <th>STATION</th> <th>FROM STATION</th> <th>TO STATION</th> <th>OFFSET</th> </tr> </thead> <tbody> <tr> <td>11+00</td> <td>11+60</td> <td>11+92</td> <td>L</td> </tr> <tr> <td>13+02</td> <td></td> <td></td> <td></td> </tr> <tr> <td>13+24</td> <td></td> <td></td> <td></td> </tr> <tr> <td>13+80</td> <td></td> <td></td> <td></td> </tr> <tr> <td>13+98</td> <td></td> <td></td> <td></td> </tr> </tbody> </table>			STATION	FROM STATION	TO STATION	OFFSET	11+00	11+60	11+92	L	13+02				13+24				13+80				13+98						
STATION	FROM STATION	TO STATION	OFFSET																										
11+00	11+60	11+92	L																										
13+02																													
13+24																													
13+80																													
13+98																													
TOE BOULDER <table border="1"> <thead> <tr> <th>FROM STATION</th> <th>TO STATION</th> <th>OFFSET</th> </tr> </thead> <tbody> <tr> <td>12+25</td> <td>12+40</td> <td></td> </tr> </tbody> </table> <p>* OFFSETS ARE DETERMINED FACING DOWNSTREAM</p>			FROM STATION	TO STATION	OFFSET	12+25	12+40																						
FROM STATION	TO STATION	OFFSET																											
12+25	12+40																												
LOG ROLL <table border="1"> <thead> <tr> <th>FROM STATION</th> <th>TO STATION</th> </tr> </thead> <tbody> <tr> <td>12+25</td> <td>12+40</td> </tr> </tbody> </table>			FROM STATION	TO STATION	12+25	12+40																							
FROM STATION	TO STATION																												
12+25	12+40																												

GEORGE WILLIAM STEPHENS, JR. and ASSOCIATES, INC.
ENGINEERS-PLANNERS-SURVEYORS-TRANSPORTATION
4092 MILLENNIUM DRIVE, SUITE 100
BELCAMP, MARYLAND 21020
Phone: (410) 297-2340 gwestephens.com Fax: (410) 297-2345

PS-03

SHEET NO.: 9 OF 36

DATE: 03/09/17
NO. REVISIONS DESCRIPTION: 1 AS-BUILT DRAWING
K0FILE: M:\2013\17133314.83

936 RIDGEBROOK ROAD
SPARKS, MARYLAND 21152
TELEPHONE: (410) 316-7800
FAX: (410) 316-7818
www.kci.com




HOWARD COMMUNITY COLLEGE
STREAM RESTORATION PROJECT
CAPITAL PROJECT D-1158
HOWARD COUNTY DEPARTMENT OF PUBLIC WORKS
STORMWATER MANAGEMENT DIVISION
6751 COLUMBIA GATEWAY DRIVE
COLUMBIA, MD 21046
PARCELS 47, 81 TAX MAP 36, 36 GRID BLOCK 0006
ZONING POR, NT ELECTION DISTRICT 05

GRADING
PLAN
AS-BUILT

SCALE: 1" - 20'
DATE: NOVEMBER 2016
KCI JOB NO.: 17133314.83
CAPITAL PROJECT NO.: D-1158
PERMIT ISSUE:
CONSTRUCTION ISSUE:

MATCH LINE - SEE SHEET PS-03

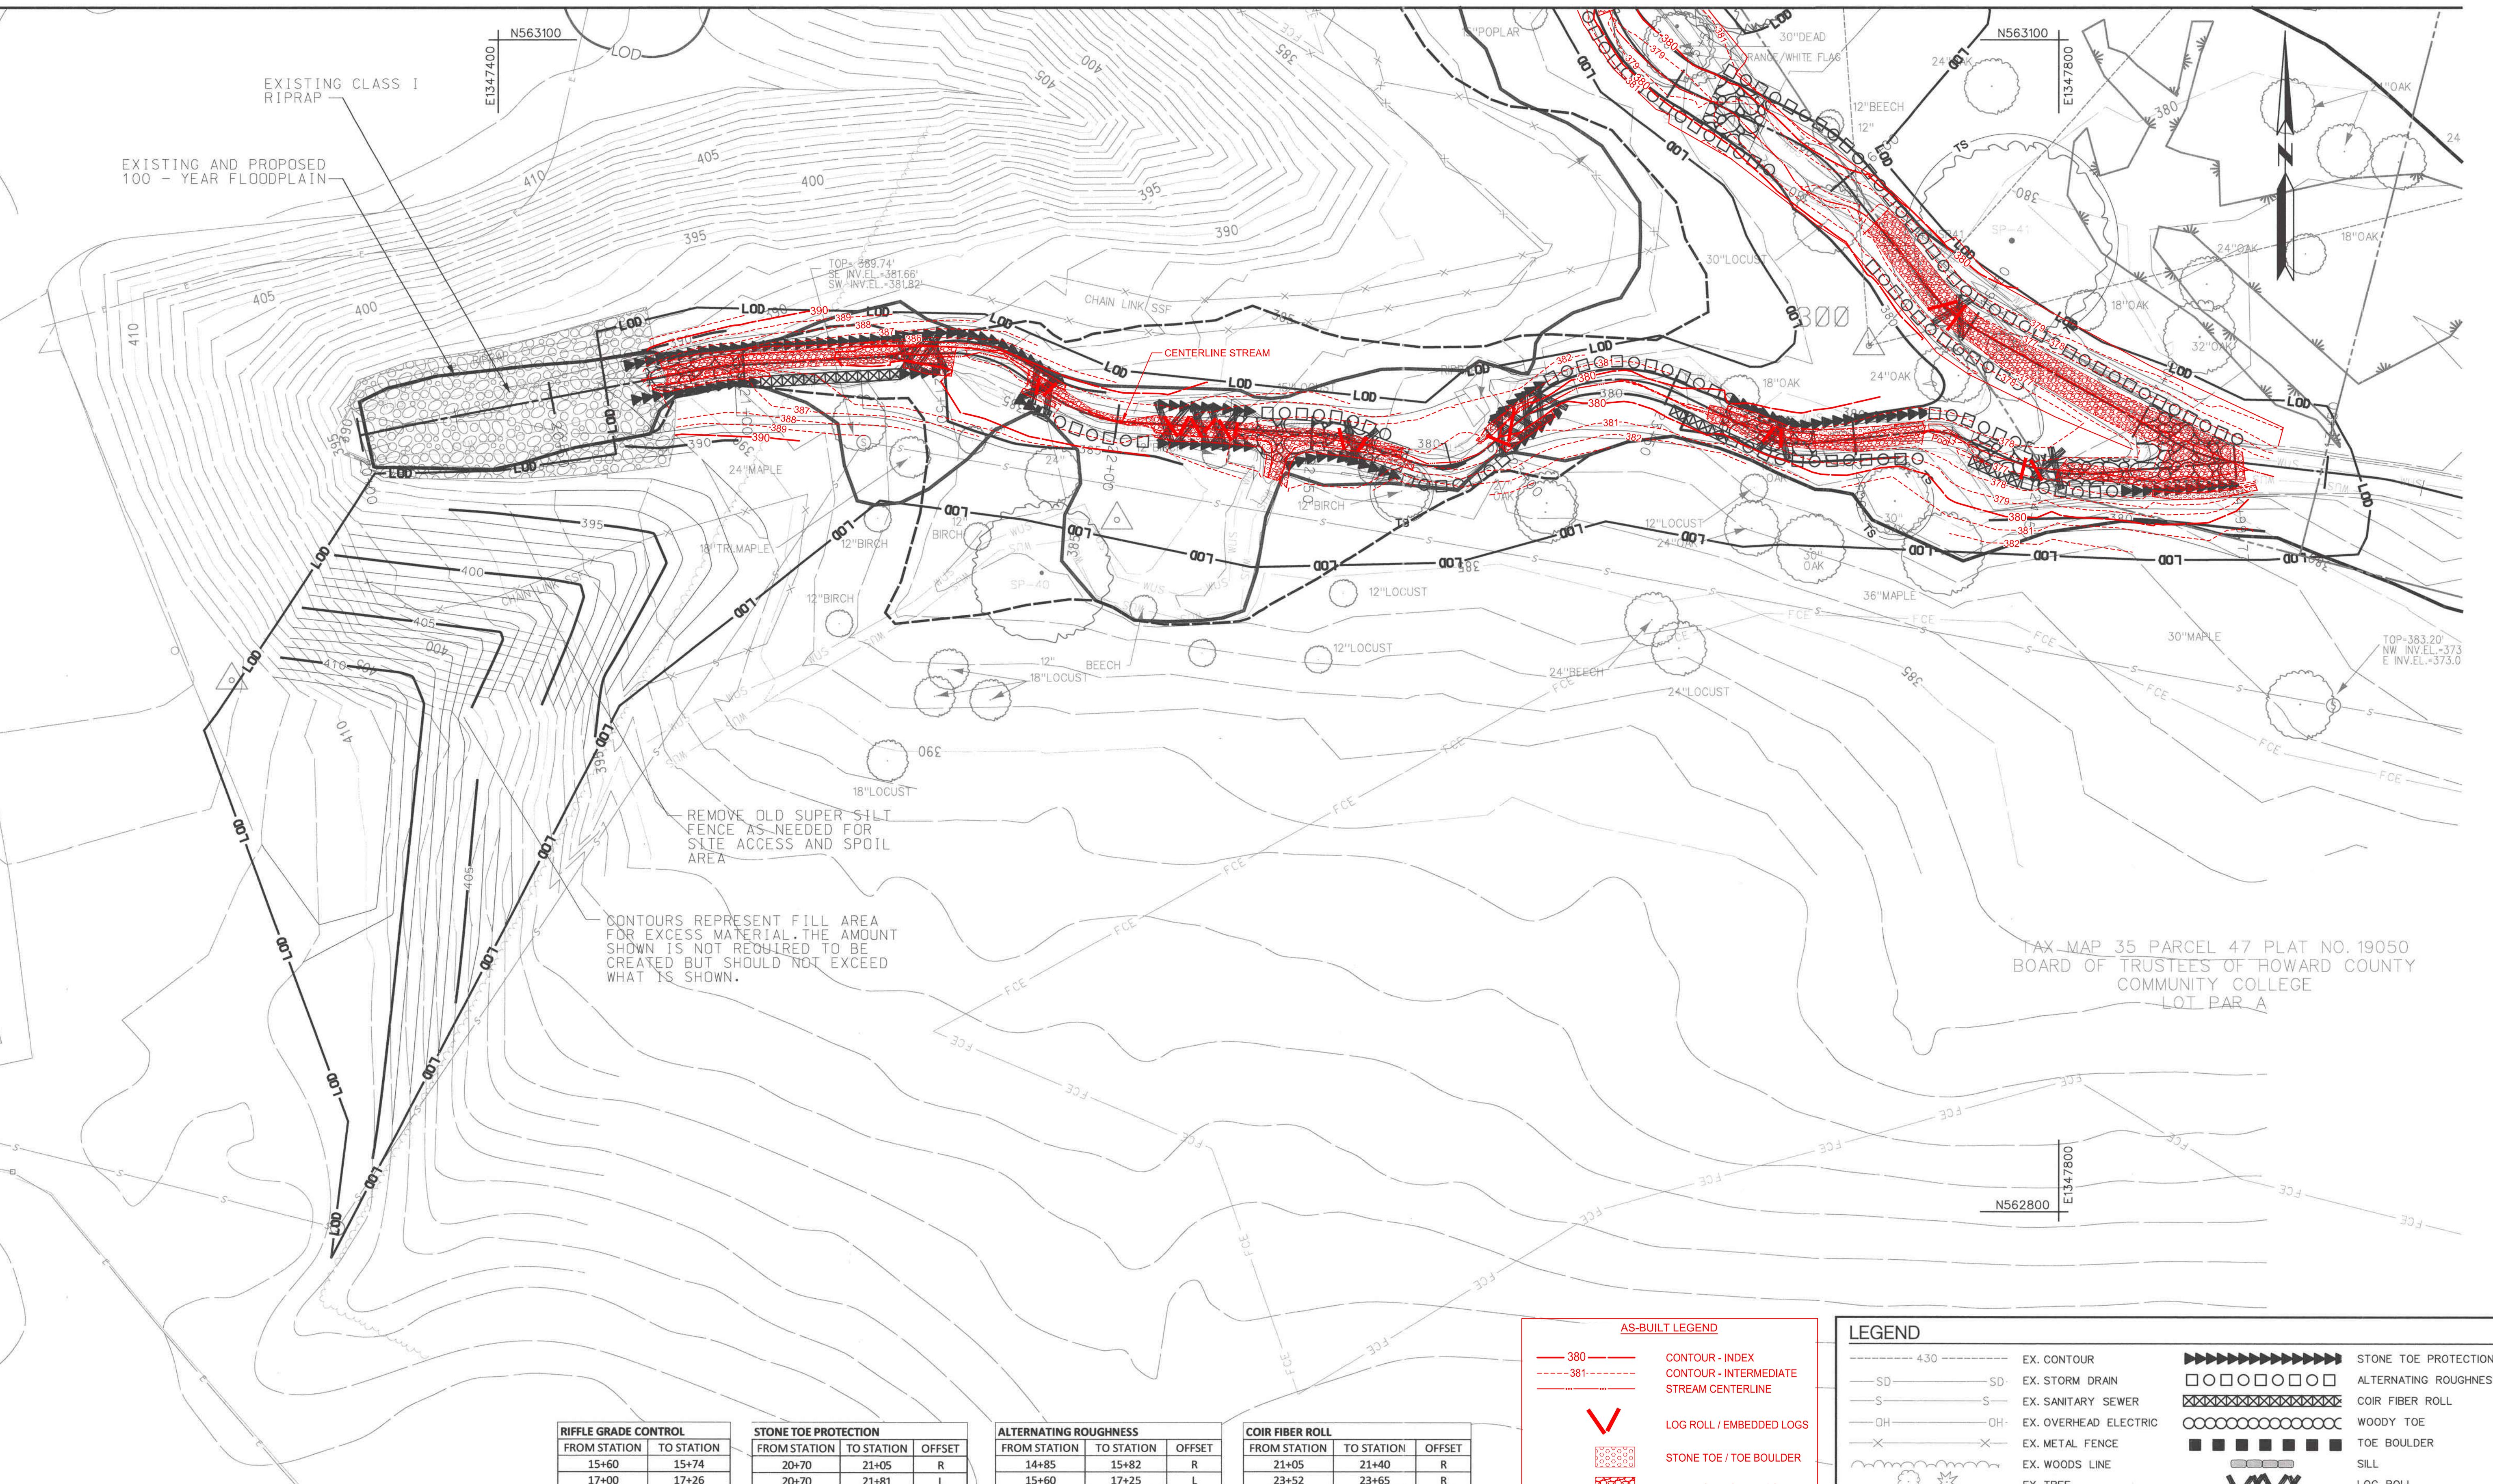

HOWARD COMMUNITY COLLEGE
STREAM RESTORATION PROJECT
CAPITAL PROJECT D-1158
HOWARD COUNTY DEPARTMENT OF PUBLIC WORKS
STORMWATER MANAGEMENT DIVISION
6701 COLUMBIA GATEWAY DRIVE
COLUMBIA, MD 21046
PARCELS 47, 81 TAX MAP 35, 36
GRID BLOCK 0006
ZONING POR, NT ELECTION DISTRICT 06

**GRADING PLAN
AS-BUILT**


SCALE: 1" - 20'
DATE: NOVEMBER 2016
KCIJOB NO.: 17133314.83
CAPITAL PROJECT #: D-1158
PERMIT ISSUE:
CONSTRUCTION ISSUE:

PS-04
SHEET NO.: 10 OF 36


FILE: c:\dms\spw\christopher_debelius\ps-04Howard_cc.dgn
FILED: 10:34 AM on Wednesday, November 16, 2016
BY: KATHY LYNN HOFFMANN
PROFESSIONAL ENGINEER
NO. 38311
STATE OF MARYLAND
CERTIFY THAT THESE DOCUMENTS WERE
PREPARED OR APPROVED BY ME, AND THAT
AN UNLICENCED PROFESSIONAL
ENGINEER UNDER THE LAWS OF THE STATE
OF MARYLAND, LICENSE NO. 38311,
EXPIRATION DATE: JANUARY 06, 2018

936 RIDGEBROOK ROAD
SPARKS, MARYLAND 21152
TELEPHONE: (410) 316-7800
FAX: (410) 316-7818
www.kci.com

NO. REVISIONS DESCRIPTION
1 AS-BUILT DRAWING
DATE
03 / 09 / 17
KFILE: M: 2013 \ 17133314.83

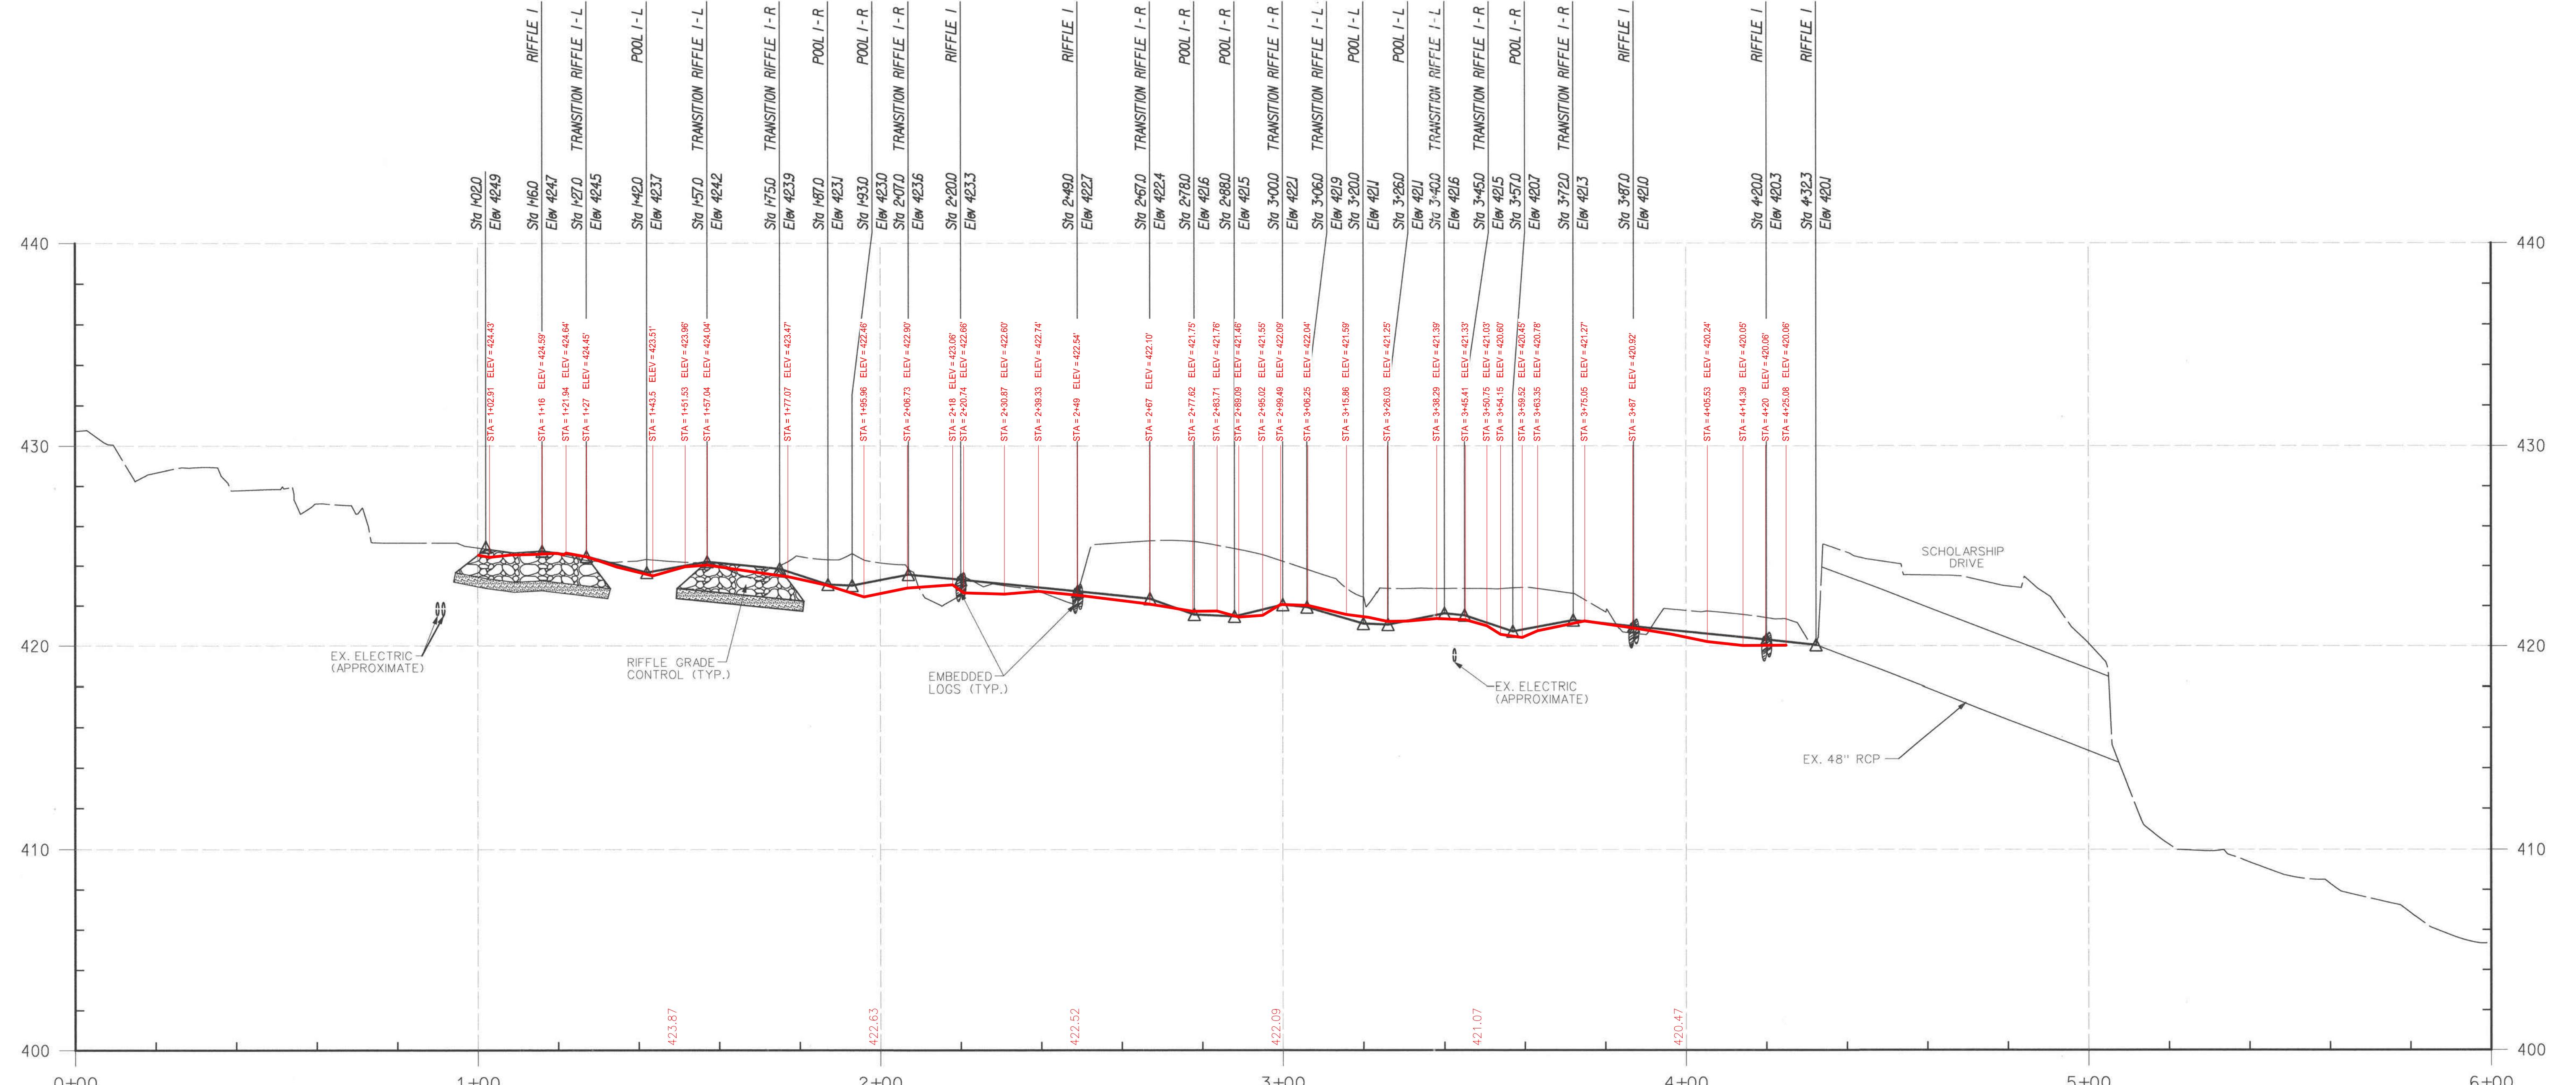

REACH 1 PROFILE

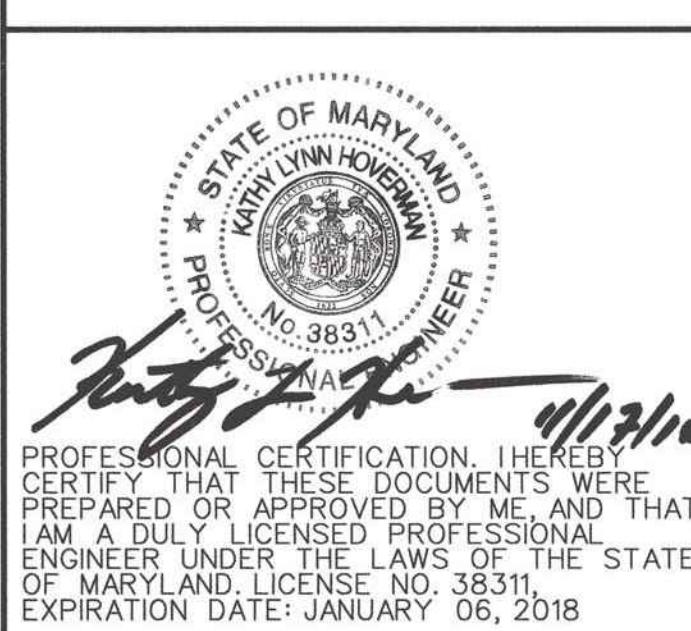

LEGEND

DEPARTMENT OF PUBLIC WORKS, HOWARD COUNTY, MD

CHIEF, BUREAU OF ENVIRONMENTAL SERVICES

12/6

936 RIDGEBROOK ROAD
SPARKS, MARYLAND 21152
TELEPHONE: (410) 316-7800
FAX: (410) 316-7818
www.kci.com

KCT
TECHNOLOGIES

**HOWARD COMMUNITY COLLEGE
STREAM RESTORATION PROJECT**

CAPITAL PROJECT D-1158

HOWARD COUNTY DEPARTMENT OF PUBLIC WORKS
STORMWATER MANAGEMENT DIVISION
6751 COLUMBIA GATEWAY DRIVE
COLUMBIA, MD 21046

PARCELS 47, 81 TAX MAP 35, 36
ELECTION DISTRICT 05 GRID/BLOCK 0006


WING POR, NT

PROFILE
AS-BUILT

SCALE: HOR. 1" = 20'
VERT. 1" = 4'
DATE: NOVEMBER 2016
KCI JOB NO.: 17133314.83
CAPITAL PROJECT NO.: D-1158
PERMIT ISSUE:
CONSTRUCTION ISSUE:

GE WILLIAM STEPHENS, JR. and ASSOCIATES, INC.
EERS· PLANNERS· SURVEYORS· TRANSPORTATION
4692 MILLENNIUM DRIVE, SUITE 100
BELCAMP, MARYLAND 21017
(410) 297-2340 www.stephens.com Fax: (410) 297-2345

PR-01

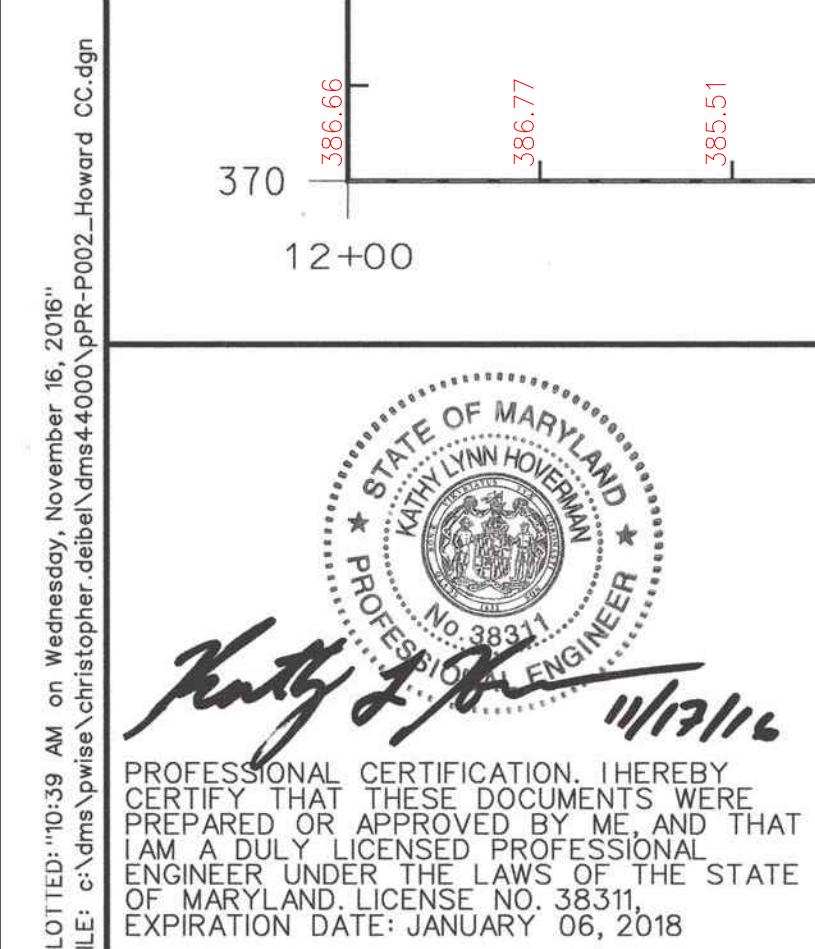


LEGEND

EXISTING GROUND ALONG BASELINE
PROPOSED GRADE ALONG BASELINE

DEPARTMENT OF PUBLIC WORKS, HOWARD COUNTY, MD
CHIEF, BUREAU OF ENVIRONMENTAL SERVICES
12/16/16
DATE

REACH 2 PROFILE

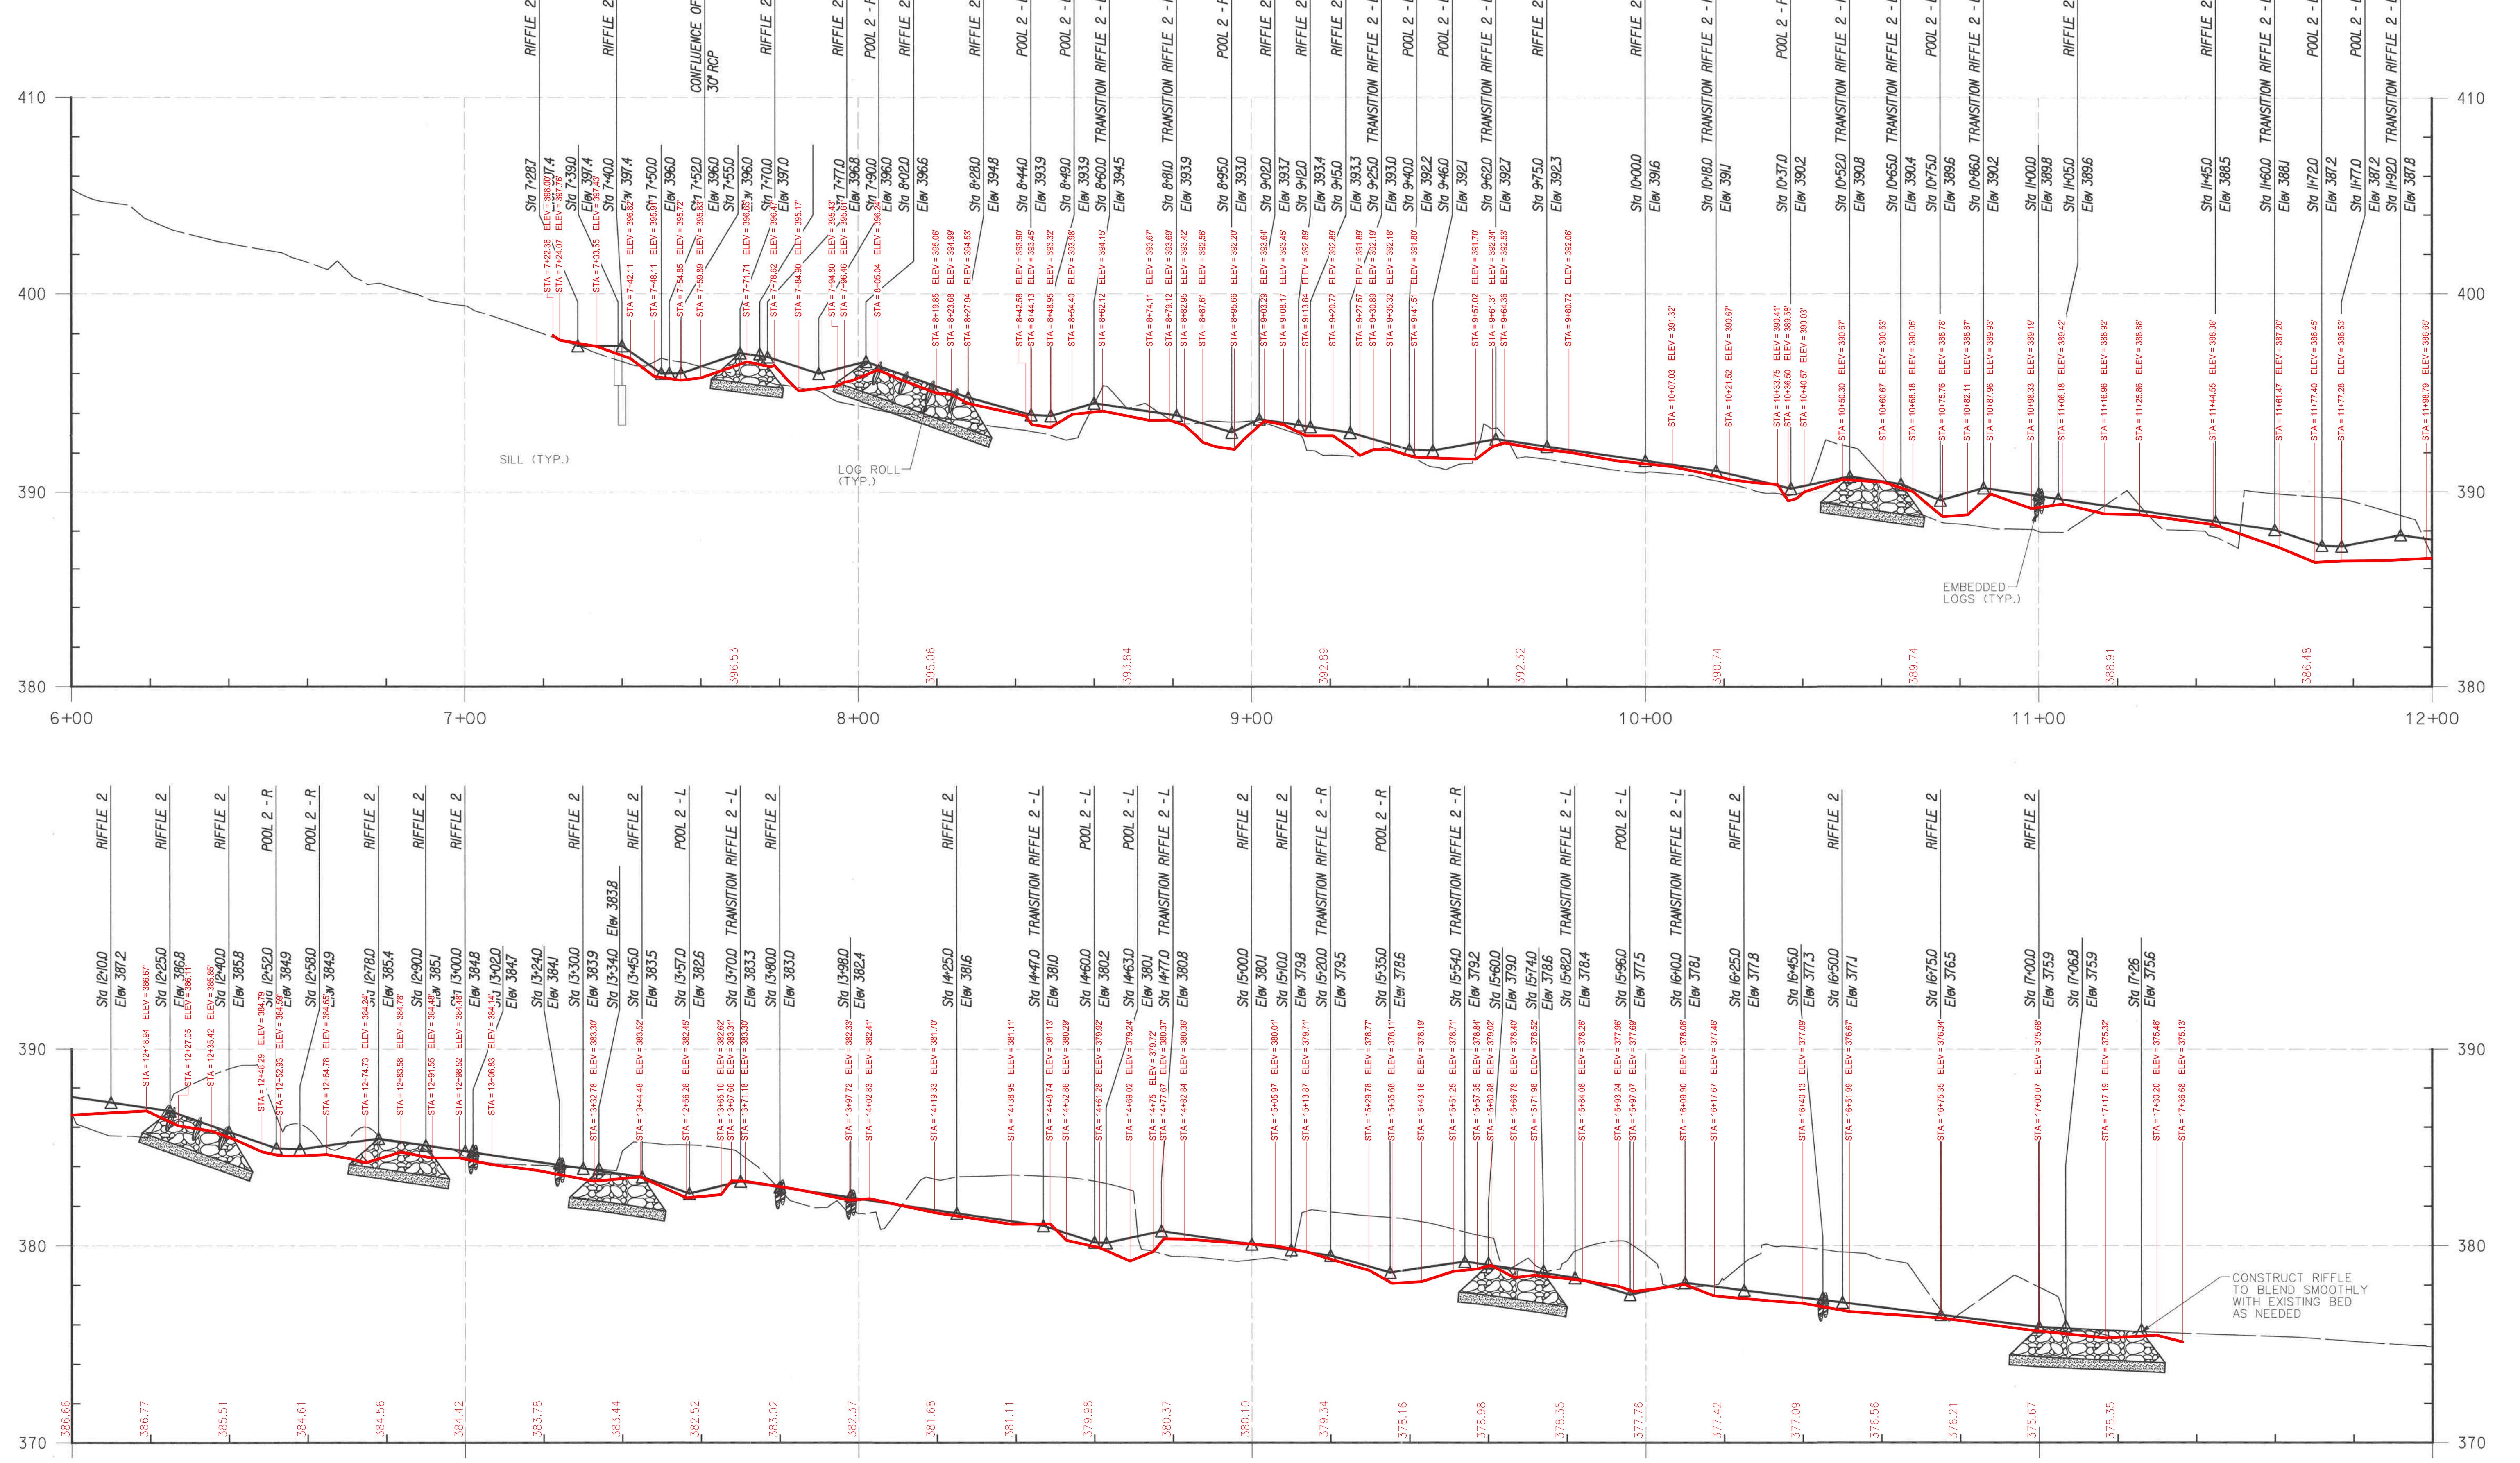

HOWARD COMMUNITY COLLEGE
STREAM RESTORATION PROJECT

CAPITAL PROJECT D-1158

HOWARD COUNTY DEPARTMENT OF PUBLIC WORKS
STORMWATER MANAGEMENT DIVISION
6751 COLUMBIA GATEWAY DRIVE
COLUMBIA, MD 21046

PARCELS 47, 81
ZONING: POR, INT
ELECTION DISTRICT 05
GRID/BLOCK 0006


PROFILE
AS-BUILT

SCALE: HOR. 1" = 20'
VERT. 1" = 4'
DATE: NOVEMBER 2016
KCI JOB NO.: 17133314.83
CAPITAL PROJECT NO.: D-1158
PERMIT ISSUE:
CONSTRUCTION ISSUE:


GEORGE WILLIAM STEPHENS, JR. and ASSOCIATES, INC.
ENGINEERS PLANNERS SURVEYORS TRANSPORTATION
4002 MILLENNIUM DRIVE, SUITE 100
BELCAMP, MARYLAND 21017
Phone: (410) 297-2340 geostephens.com Fax: (410) 297-2345

PR-02
SHEET NO.: 16 OF 36

936 RIDGEBROOK ROAD
SPARKS, MARYLAND 21152
TELEPHONE: (410) 316-7800
FAX: (410) 316-7818
www.kci.com

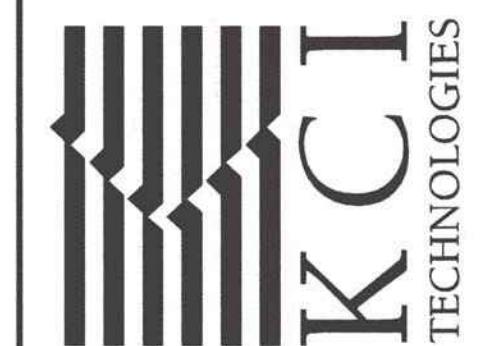


NO. REVISIONS DESCRIPTION DATE
1 AS-BUILT DRAWING 03 / 09 / 17
KFILE: M:\ 2013\ 17133314.83\

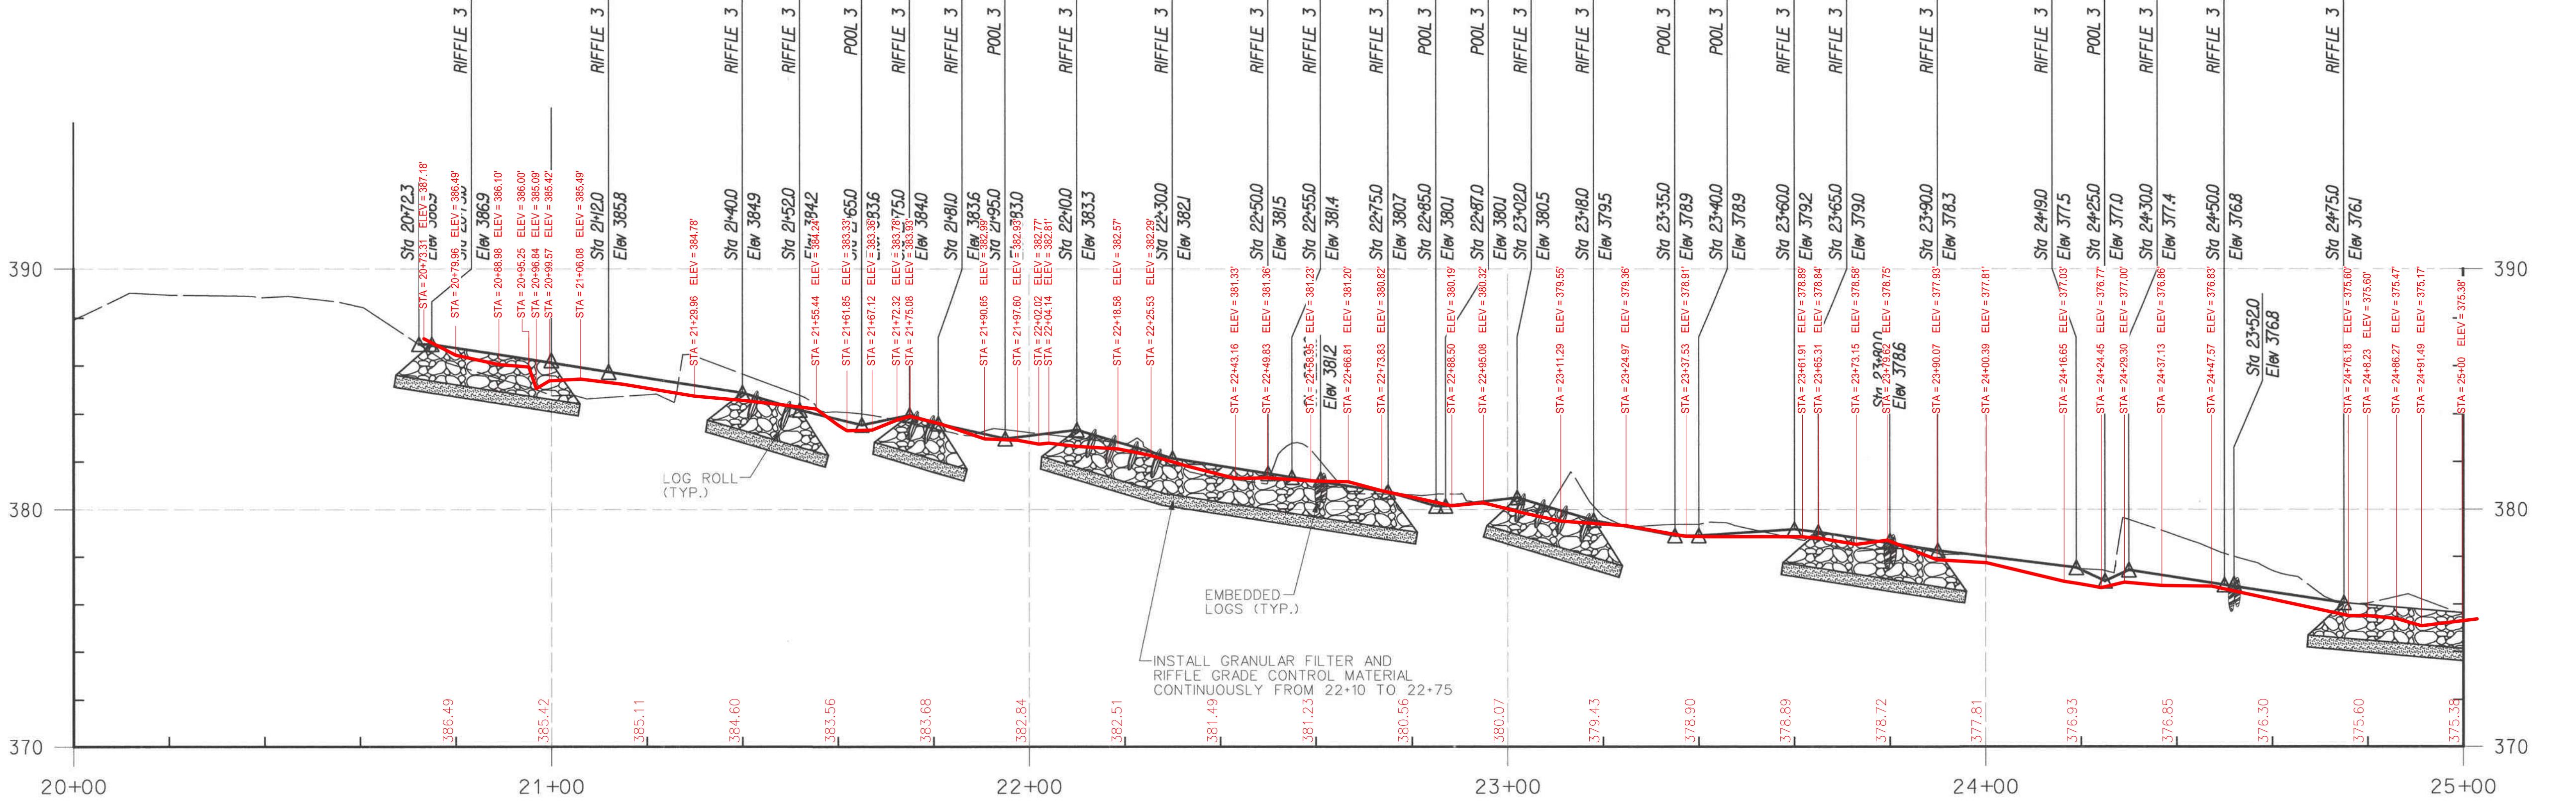

REACH 3 PROFILE


LEGEND

EXISTING GROUND ALONG BASELINE
PROPOSED GRADE ALONG BASELINE

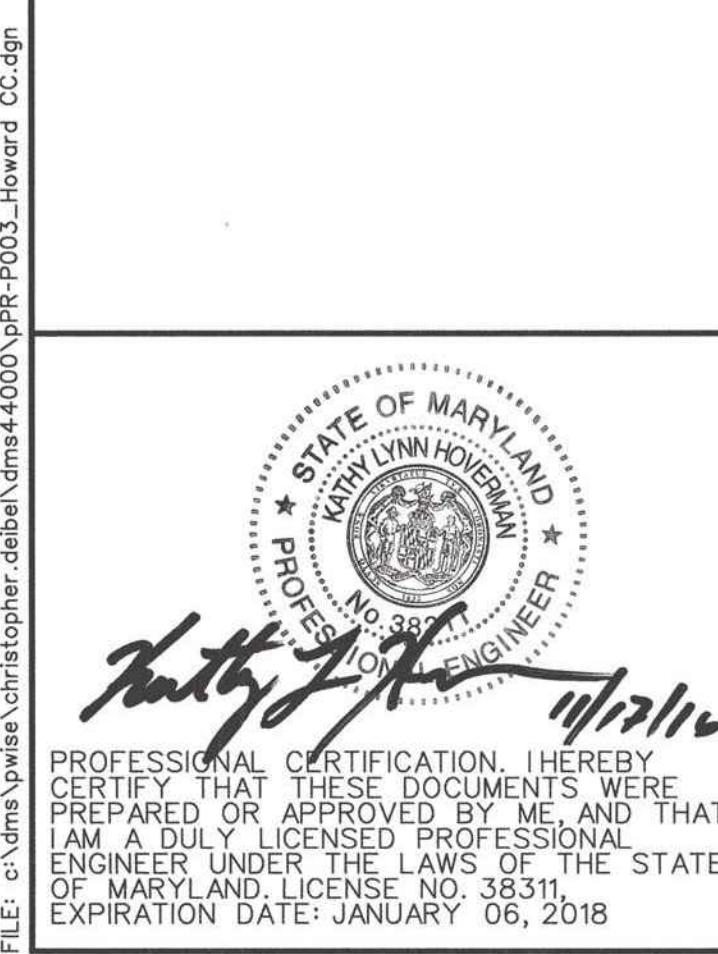

DEPARTMENT OF PUBLIC WORKS, HOWARD COUNTY, MD
CHIEF, BUREAU OF ENVIRONMENTAL SERVICES
DATE: 12/16/16

HOWARD COMMUNITY COLLEGE
STREAM RESTORATION PROJECT
CAPITAL PROJECT D-1158
HOWARD COUNTY DEPARTMENT OF PUBLIC WORKS
STORMWATER MANAGEMENT DIVISION
6751 COLUMBIA GATEWAY DRIVE
COLUMBIA, MD 21046
PARCELS 47, 81 TAX MAP 35, 36
ZONING: POR, NT ELECTION DISTRICT 06 GRID/BLOCK 0006

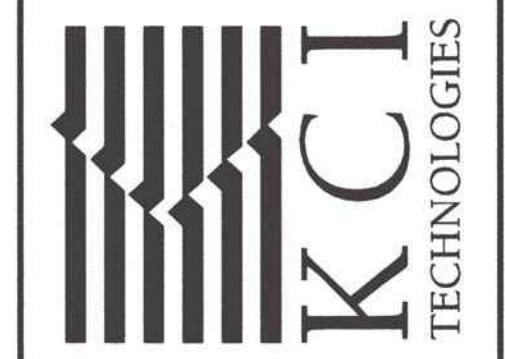

936 RIDGEBROOK ROAD
SPARKS, MARYLAND 21152
TELEPHONE: (410) 316-7800
FAX: (410) 316-7818
www.kci.com

FILE: M:\2013\17133314.83\
NO. REVISIONS DESCRIPTION DATE
1 AS-BUILT DRAWING 03/09/17

SCALE: HOR. 1" = 20'
VERT. 1" = 4'
DATE: NOVEMBER 2016
KCI JOB NO.: 17133314.83
CAPITAL PROJECT NO.: D-1158
PERMIT ISSUE:
CONSTRUCTION ISSUE:

GEORGE WILLIAM STEPHENS, JR. and ASSOCIATES, INC.
ENGINEERS PLANNERS SURVEYORS TRANSPORTATION
4002 MILLENNIUM DRIVE, SUITE 100
BELCAMP, MARYLAND 21007
Phone: (410) 297-2340 geostephens.com Fax: (410) 297-2345

PR-03
SHEET NO.: 17 OF 36



MEMORANDUM

TO: Brian Cleary, P.E.,
Howard County Department of Public Works
Stormwater Management Division

FROM: Kathy L. Hoverman, P.E.
KCI Technologies, Inc.

DATE: June 2, 2017

SUBJECT: Howard County Community College Restoration Project Construction
As-Built Review
KCI Job Order No. 17133314.111

Meadville Land Services Contractors (MLS) completed construction of the Howard Community College stream restoration project in March 2017. George William Stephen Jr. and Associates Inc. conducted an as-built survey of the stream corridor immediately after construction to ensure that the survey represents the condition of the channel immediately following construction and was not influenced by severe weather or other outside factors. As-built survey was completed over a period of time from February 1st through the 20th. The survey data presented to KCI Technologies Inc. (KCI) by MLS are based on the design baseline of construction, which runs the entire project site, with stationing, and right and left bank designations oriented in the downstream direction. As-built data were overlaid on the Construction Drawings of the grading plans and profiles by MLS. MLS also provided a CADD file of the as-built survey which KCI used to generate cross sections. These cross sections were needed to fully evaluate the constructed results and are provided as an attachment to this memo.

Stream restoration occurred on an unnamed tributary to the Little Patuxent River and the named LPR-1 tributary to the Little Patuxent River. Restoration of the upstream reach (Reach 1) on the unnamed tributary is approximately 430 linear feet (LF) and ends downstream at the culvert at Scholarship Drive. Reach 2 continues on the unnamed tributary and starts at the outfall at Scholarship Drive and includes one outfall. Restoration of Reach 2 starts at station 7+28 and extends 998 LF downstream to a confluence with LPR-1. Reach 3 is on LPR-1 and originates from a storm water management pond. It daylights from a culvert at station 20+00 but restoration did not begin until station 20+72. Reach 3 extends downstream for 403 LF to the confluence with the unnamed tributary.

Discrepancies greater than 0.3 feet (ft) are considered to be beyond the tolerance limits as determined by KCI's established criteria. These areas are identified and described herein. Discrepancies are generally documented using the greatest vertical and/or horizontal deviation from the proposed cross section. However, several adjustments were made in the field during construction that would affect the as-built survey. A list of those changes discussed in the weekly summary reports can be found in Table 1 below.

Howard Community College Stream Construction

As-built Review

Page 2 of 5

June 2, 2017

Most of the field changes encountered include grading adjustments in order to accommodate tree saves within the College's property. In these cases, construction of steeper tie-ins or narrower benches than proposed were approved by KCI (the Engineer) in the field and are not considered variances from the design.

Table 1. Summary of approved field changes during construction.

<i>Station</i>	<i>Weekly Summary</i>	<i>Field Change</i>
Wetland (adjacent to 3+50)	Week 5	Wetland contour elevations were raised due to exposed electrical line decreasing the overall depression of the wetland.
7+70 to 8+25	Week 5	The centerline was shifted to the right to avoid removing large trees.
15+75 to 16+25	Week 9	The stream was rerouted to the right to avoid removing several trees. Alternating roughness was then installed on opposite side.
16+75 to 17+50	Week 9	Stream width was widened to keep consistent with upstream dimensions.

Mainstem 0+00 through 4+50 (Reach 1)

A variety of discrepancies outside the approved variance and not associated with an approved field change are noted below.

The invert at station 2+07 appears to be 0.6 feet lower than designed. Station 2+07 is close to the head of a riffle and could influence overall channel slope. The channel invert in the pools from stations 2+78 through 3+26 appear to be 0.5 ft higher than designed.

None of the benches designed between 2+00 and 2+67 are visible on the as-built drawings. Instead the bank continues at an angle upward to tie-in to the existing bank. This could reduce the floodplain connection that is an important part of the design. However, many of the cross sections examined from 2+00 to 2+07 have some other lowered bench or cross section variation that will help with some of the floodplain connection intended with the design. From 2+20 to 2+67 the cross section does not display this characteristic and is considered oversized. Stations 2+20 to 2+25 also reflect channel inverts approximately 0.5 ft lower than designed.

Sections 4+00 through 4+25 reflect an over-excavated channel. The constructed channel width is twice as wide as designed and the constructed invert is lower than designed. The bench features were not constructed on either side of the channel. Section 4+25 is the transition to the culvert so its overwide dimensions are acceptable as it ties into the existing wing walls.

Howard Community College Stream Construction

As-built Review

Page 3 of 5

June 2, 2017

Other minor variations exist in the cross section overlays in the Reach 1 stream channel. Those variations lie within the KCI standards of 0.3 ft or are deemed to be a result of inherent survey overlay. The wetland cross sections display greater variance but, this change was a field approved change due to an electrical line being so close to the surface.

Mainstem 7+28 through 17+26 (Reach 2)

From station 7+70 to 8+25 the channel dimensions were altered and horizontal alignments shifted to save trees on the right bank and a large specimen tree along the left bank. The channel was shifted first to the left and then over to the right to avoid the root system of the specimen trees. This was a KCI approved field change.

Typical riffle and pool features occur from station 7+28 to 17+26. Riffle grade control features are also included in this area, which are constructed using the same dimensions as typical riffles, but constructed using larger channel bed material. Horizontal and vertical variances were observed throughout the riffle and pool features that are outside of the KCI tolerance.

Throughout the reach, riffle features appear to be constructed lower than designed, with variances ranging from 0.4 to 1.0 ft below designed elevations. It is possible that some of the variation may be the result of some of the voids in the cobble materials being surveyed, which may not represent the overall bed elevation. However, in addition to the cross section, the profile also reveals lower bed elevations in the riffle features. This can have an effect on overall channel slope and potentially channel stability. Riffle features constructed at or near the design elevations may provide grade control sufficient to maintain the designed channel slope. The table below summarizes the discrepancies for the riffle reaches in Reach 2.

Table 2. Summary of notable vertical discrepancies in riffle features.

Riffle Stationing	Vertical difference (ft)
7+70 to 7+77	-0.5
8+02 to 8+28	-0.4
8+60 to 8+80	-0.4
<i>9+03; 9+64; 10+52 heads of riffles</i>	<i>-0.1 to -0.2 (okay)</i>
11+06	-0.5
12+25 to 12+40	-0.7 (up to)
12+84 to 12+92	-0.4 to -0.6
12+98 to 13+33	-0.5

Vertical and horizontal variances in pool features are observed throughout Reach 2 as well. For example, sections 11+60 to 12+00 the channel is 0.8 to 1.0 ft lower, and sections 15+96 to 16+00 the channel is higher and shifted right to more closely match existing grades. These changes in

Howard Community College Stream Construction

As-built Review

Page 4 of 5

June 2, 2017

pool section are most likely a result of either shifting the channel slightly with the approved changes in Table 1 or adjusting the tie in slopes to avoid trees. In most cases, the pool cross sectional area appears to be the same or greater than designed. This should not cause channel instability. The pools will adjust, likely filling in if constructed with excess capacity.

Stations 11+92 and 12+78 are designed as riffle cross sections but appears more like pools with a cross sectional area more than 20 square ft larger than designed. Station 11+92 is more than a foot lower than designed.

While the shift of the meander bend from 15+50 to 16+75 was approved the constructed cross section lacks a defined point bar and has a more narrow section than typical for pools within the Reach.

From station 16+75 to 17+50 cross sections were widened to maintain same cross section width as upstream. Although stream was widened in this area the proposed shape was maintained. This change was approved in the field as seen in Table 1.

Mainstem 20+72 to 24+75 (Reach 3)

Only minor variations exist in Reach 3, however the constructed channel shape does not conform well to that of the design. The only major adjustment was made at the upstream tie in point at station 20+72 where there was a drop from the existing rip-rap in the channel. The proposed cross section was changed and approved in the field to create a gradual slope from the rip-rap to the proposed elevation to prevent a scour pool formation in the channel. Excess riprap was also placed along the banks of this section to create a gradual slope from the existing riprap to the newly created bench.

The following riffle features are lower than design by more than the 0.3 ft tolerance: station 23+02 to 23+18 (-0.5), station 24+75 to 25+00 (-1.0).

Horizontal variance beyond the 0.3 ft tolerance was observed beginning near 23+40 and continuing through 23+50. Channel over-widening ranges from approximately 1.8 ft to 3.5 ft. The tie in slope angle on the right bank was decreased to reduce the cut into tree roots that were adjacent to the designed tie-in location. The combination between the channel shift and tie in slope change eliminated the bench in this area.

Summary

The Howard Community College Stream Restoration was constructed mostly in accordance with the design plans with minor and noted variances. Noted variances are missing riffle heads and benches around 2+00- 2+20, missing riffle heads at 11+92 and 12+78 and overwide channel from 23+50 to 24+30. Monitoring cross sections should go in all or most of these locations. The

Howard Community College Stream Construction

As-built Review

Page 5 of 5

June 2, 2017

constructed channel should not have any impact on the installed structures or overall function of the restoration. However, based on the noted variances (and inherent channel adjustment), it is recommended that monitoring include detailed observations, if they are not included in cross section survey, of these locations to document any changes that occur due to the discrepancies and correct things as needed to ensure permit compliance.

If you have any questions regarding this as-built review please feel free to contact me at 804-887- 7531 x8551 or kathy.hoverman@kci.com.

KLH/sdr

Attachments:

MLS As-Built Drawings

KCI developed Cross Section Overlays

LEGEND

EXISTING GRADE	—
PROPOSED GRADE	—
AS-BUILT GRADE	—

NOTES:
 UTILITIES SHOWN ON THESE PLANS HAVE BEEN LOCATED
 USING SURVEY DATA AND ARE NOT DRAWN TO SCALE.
 THE CONTRACTOR IS TO EXERCISE EXTREME CAUTION WHEN
 EXCAVATING NEAR ANY UTILITIES TEST PIT IF REQUIRED.

THIS DEVELOPMENT IS APPROVED FOR SOIL EROSION AND SEDIMENT CONTROL

BY THE HOWARD SOIL CONSERVATION DISTRICT.

PROFESSIONAL CERTIFICATION, I HEREBY
 CERTIFY THAT THESE DOCUMENTS WERE
 PREPARED OR APPROVED BY ME AND THAT
 I AM A DULY LICENSED PROFESSIONAL
 ENGINEER UNDER THE LAWS OF THE STATE
 OF MARYLAND, LICENSE NO. 38311,
 EXPIRATION DATE: JANUARY 06, 2018







HOWARD SCD

DATE

DEPARTMENT OF PUBLIC WORKS, HOWARD COUNTY, MD
 CHIEF, BUREAU OF ENVIRONMENTAL SERVICES

DATE

REACH 1

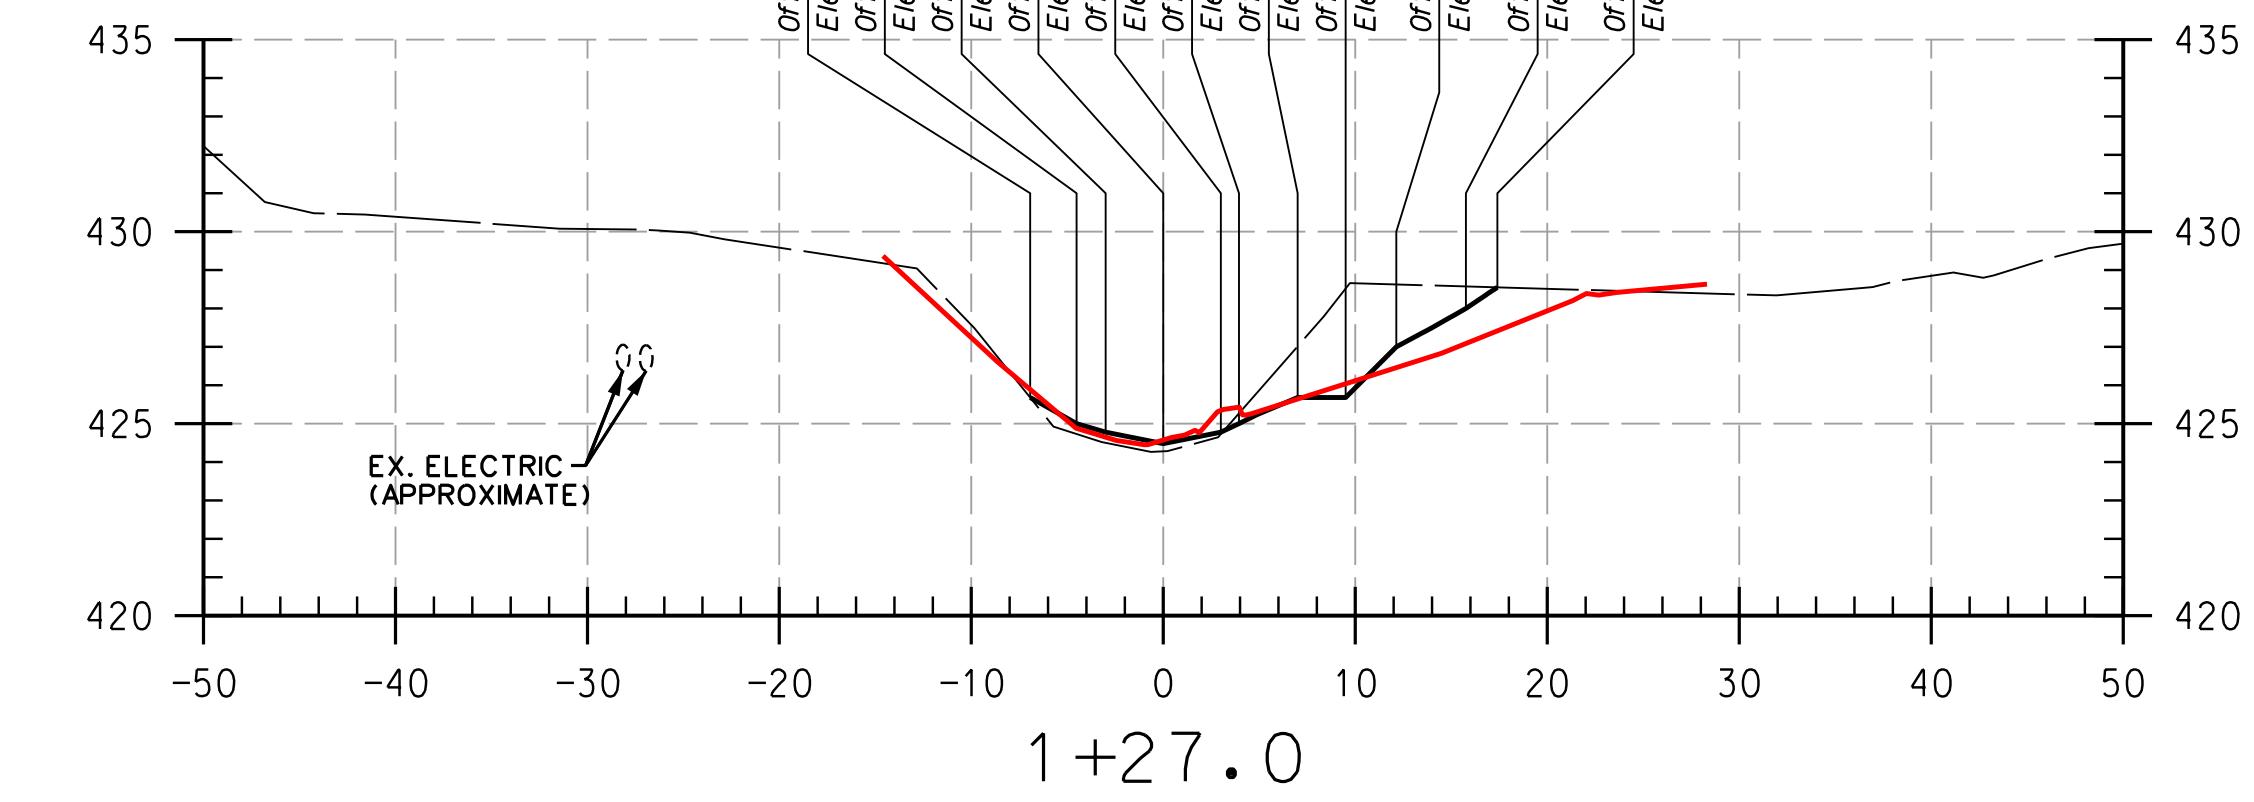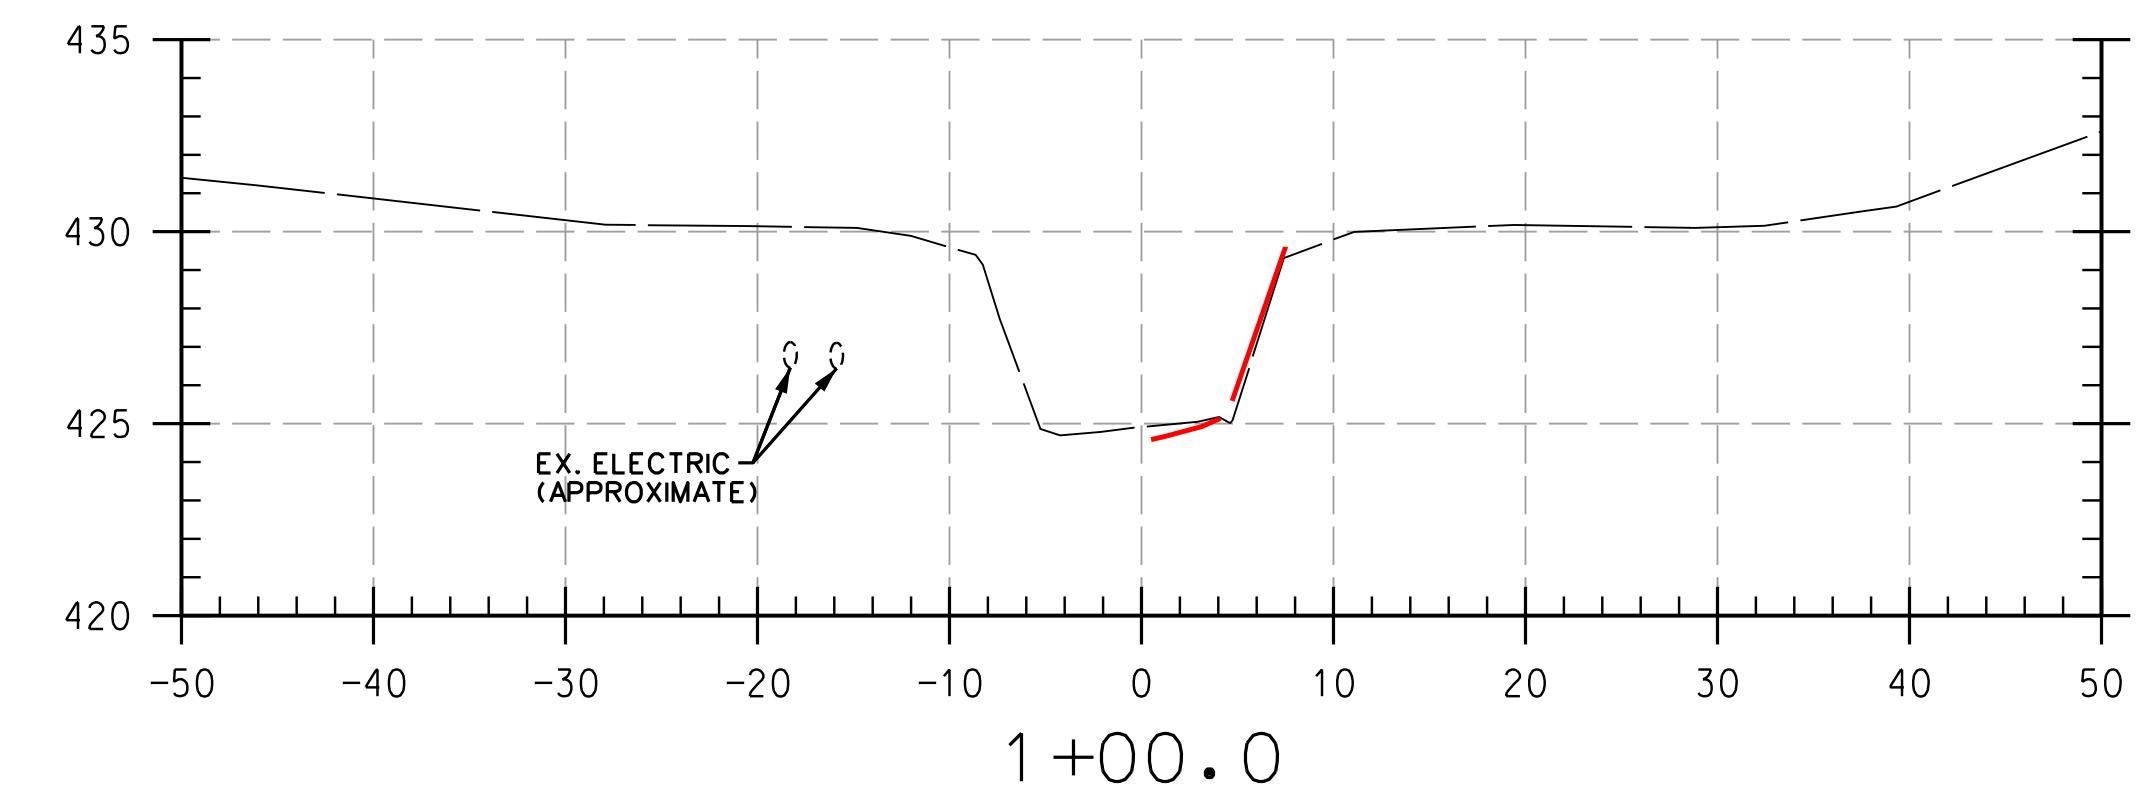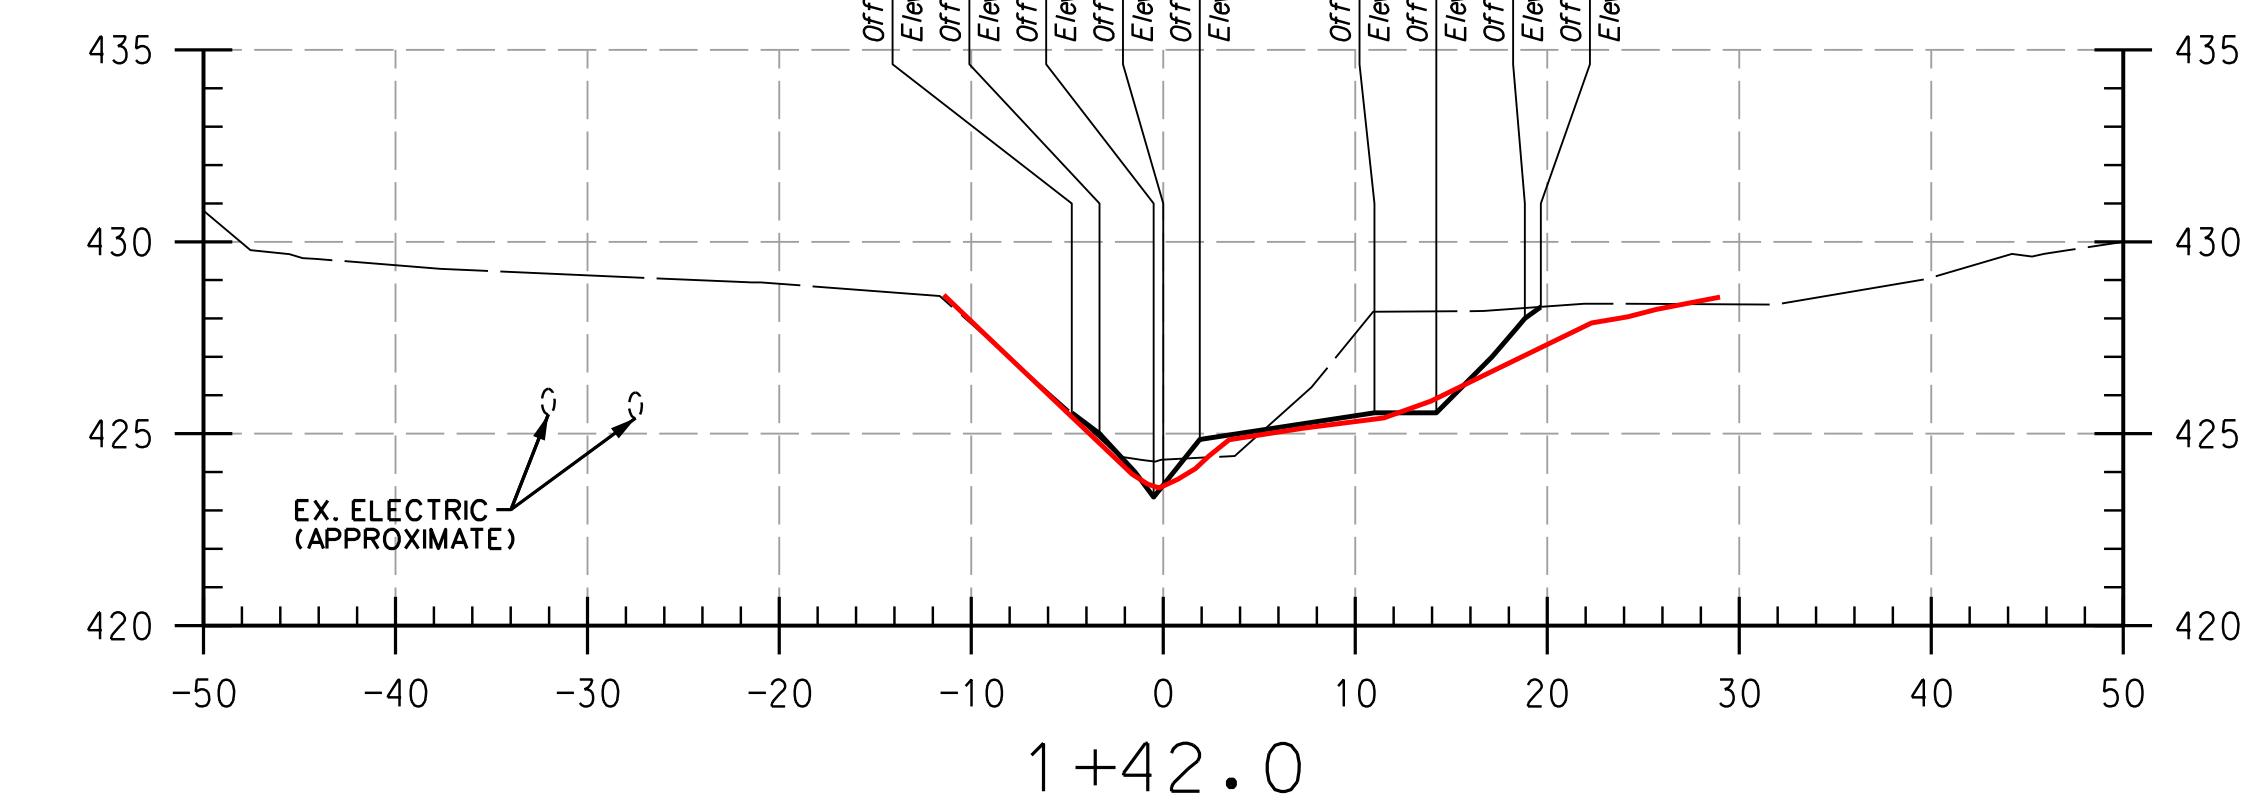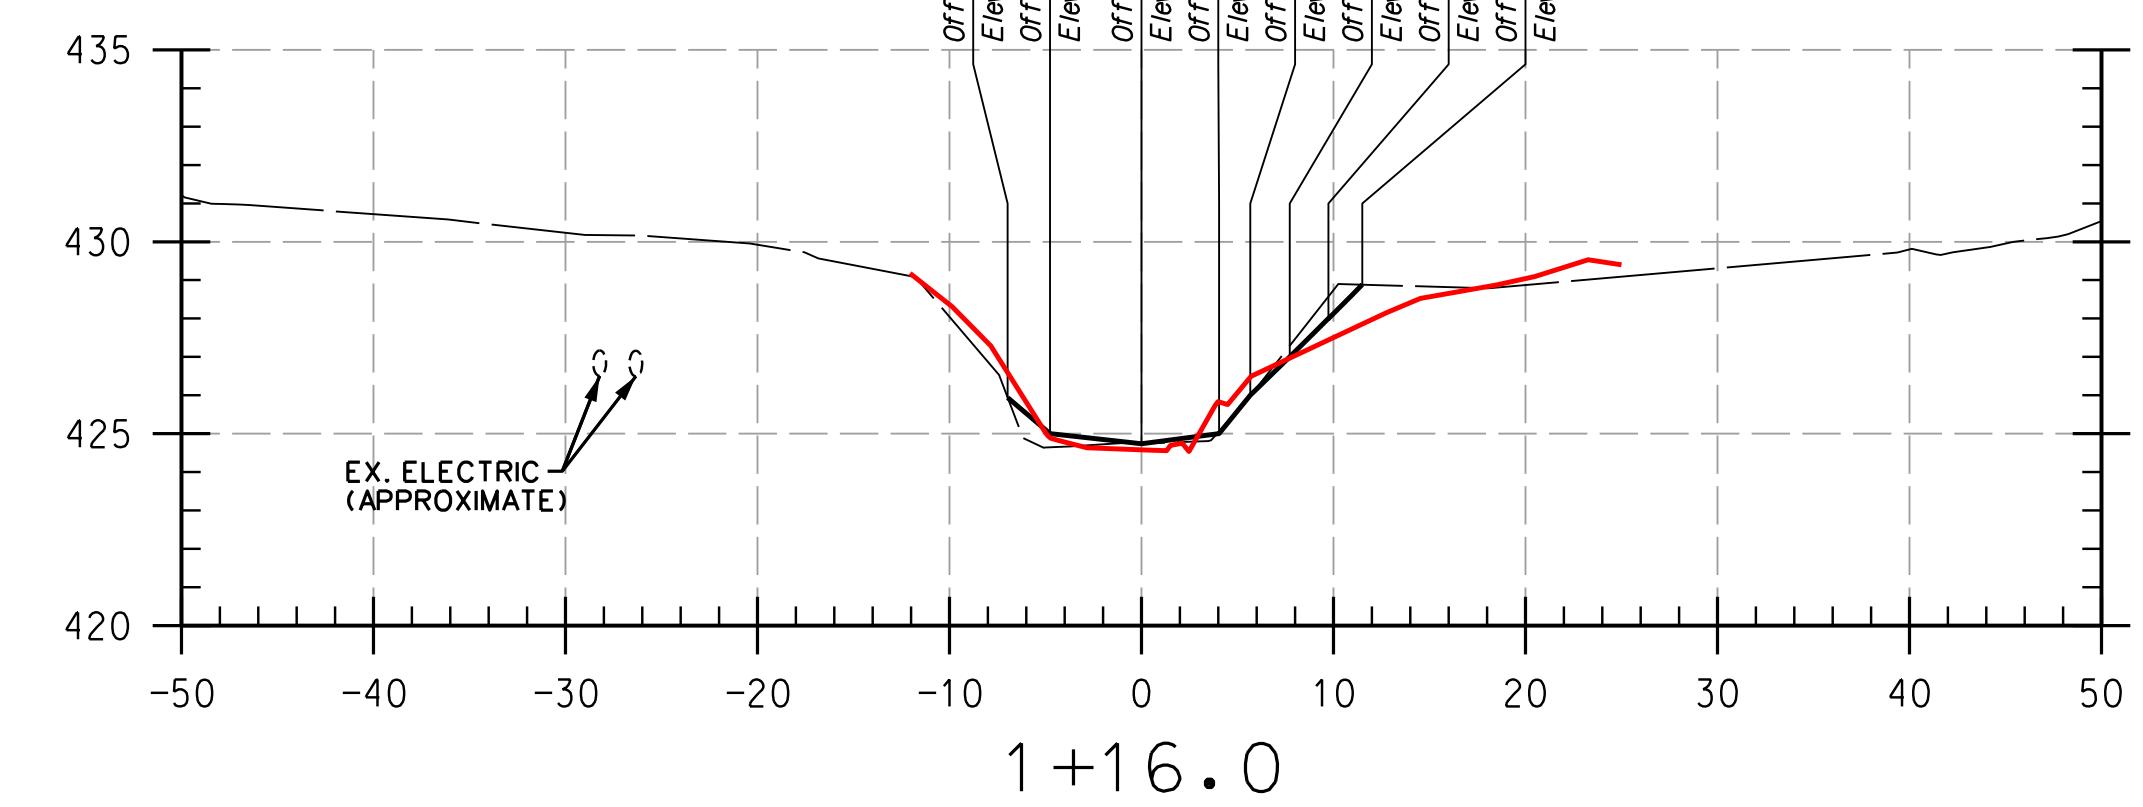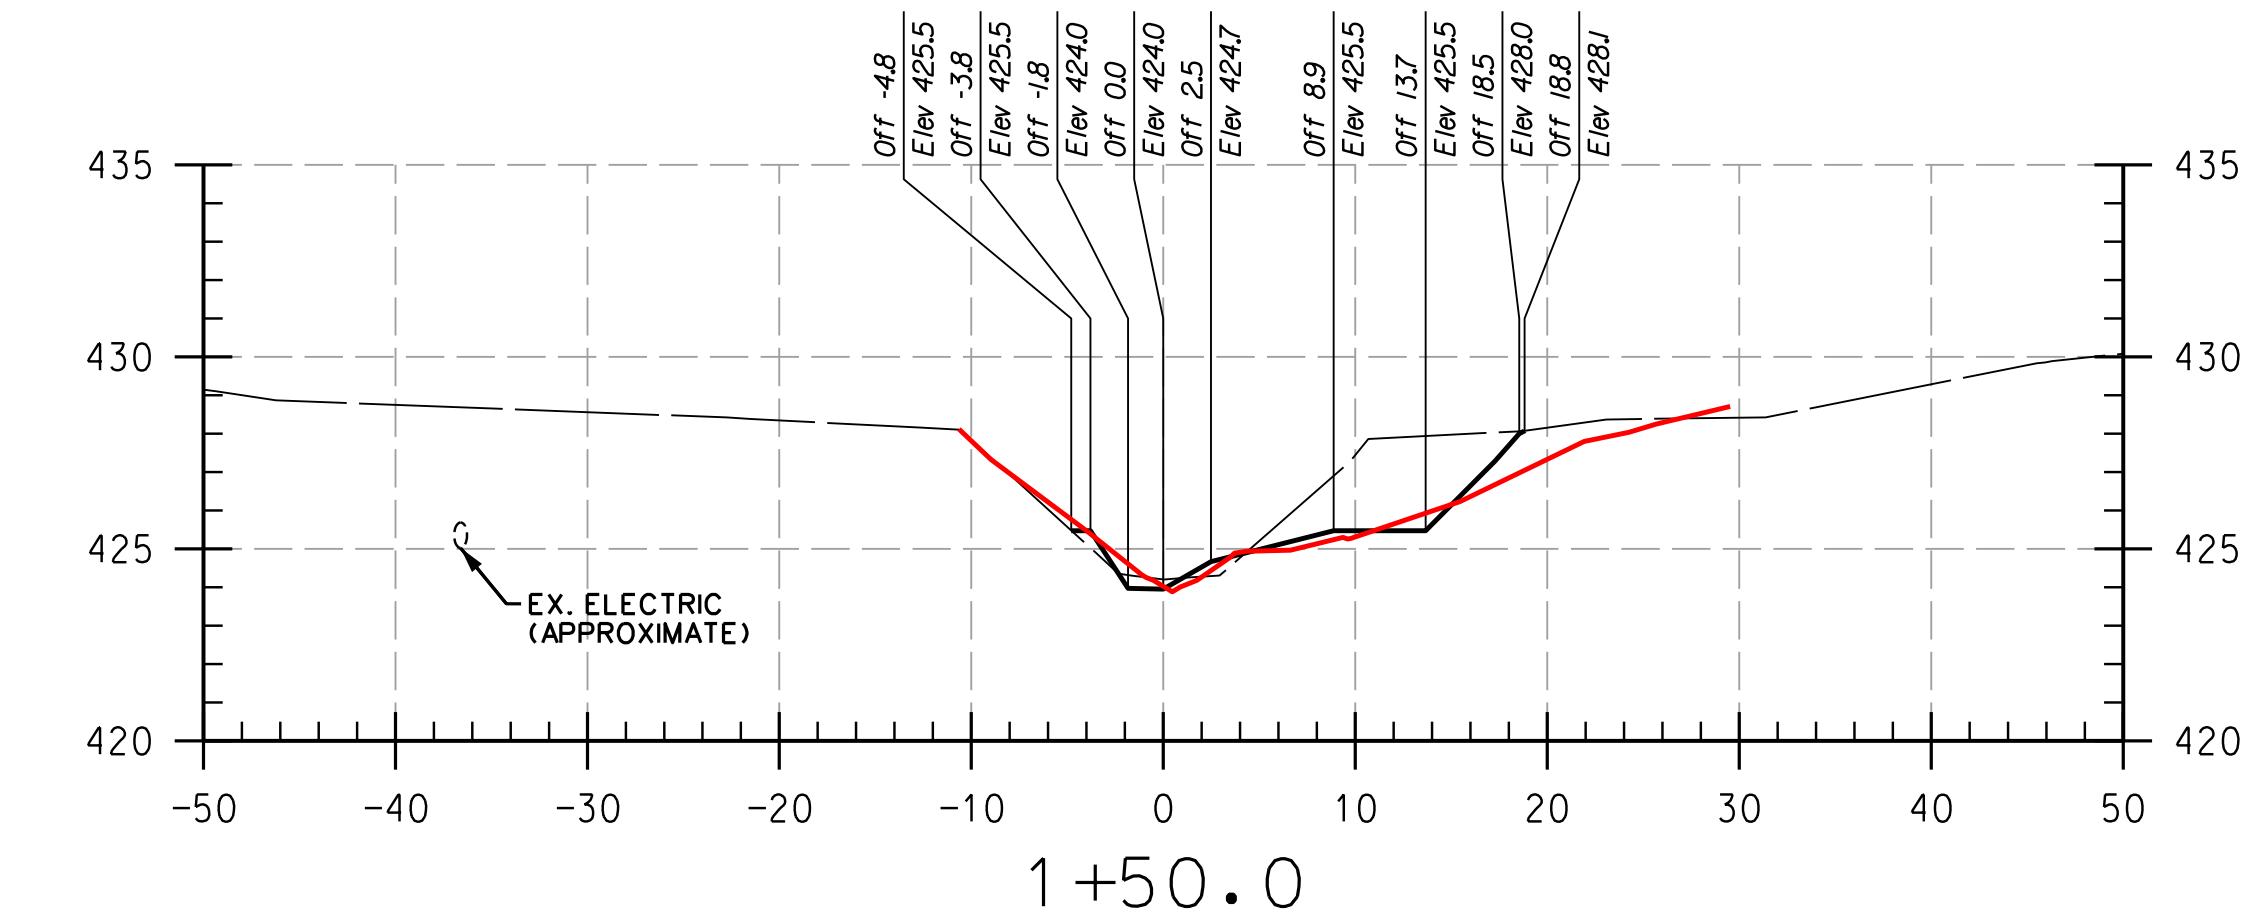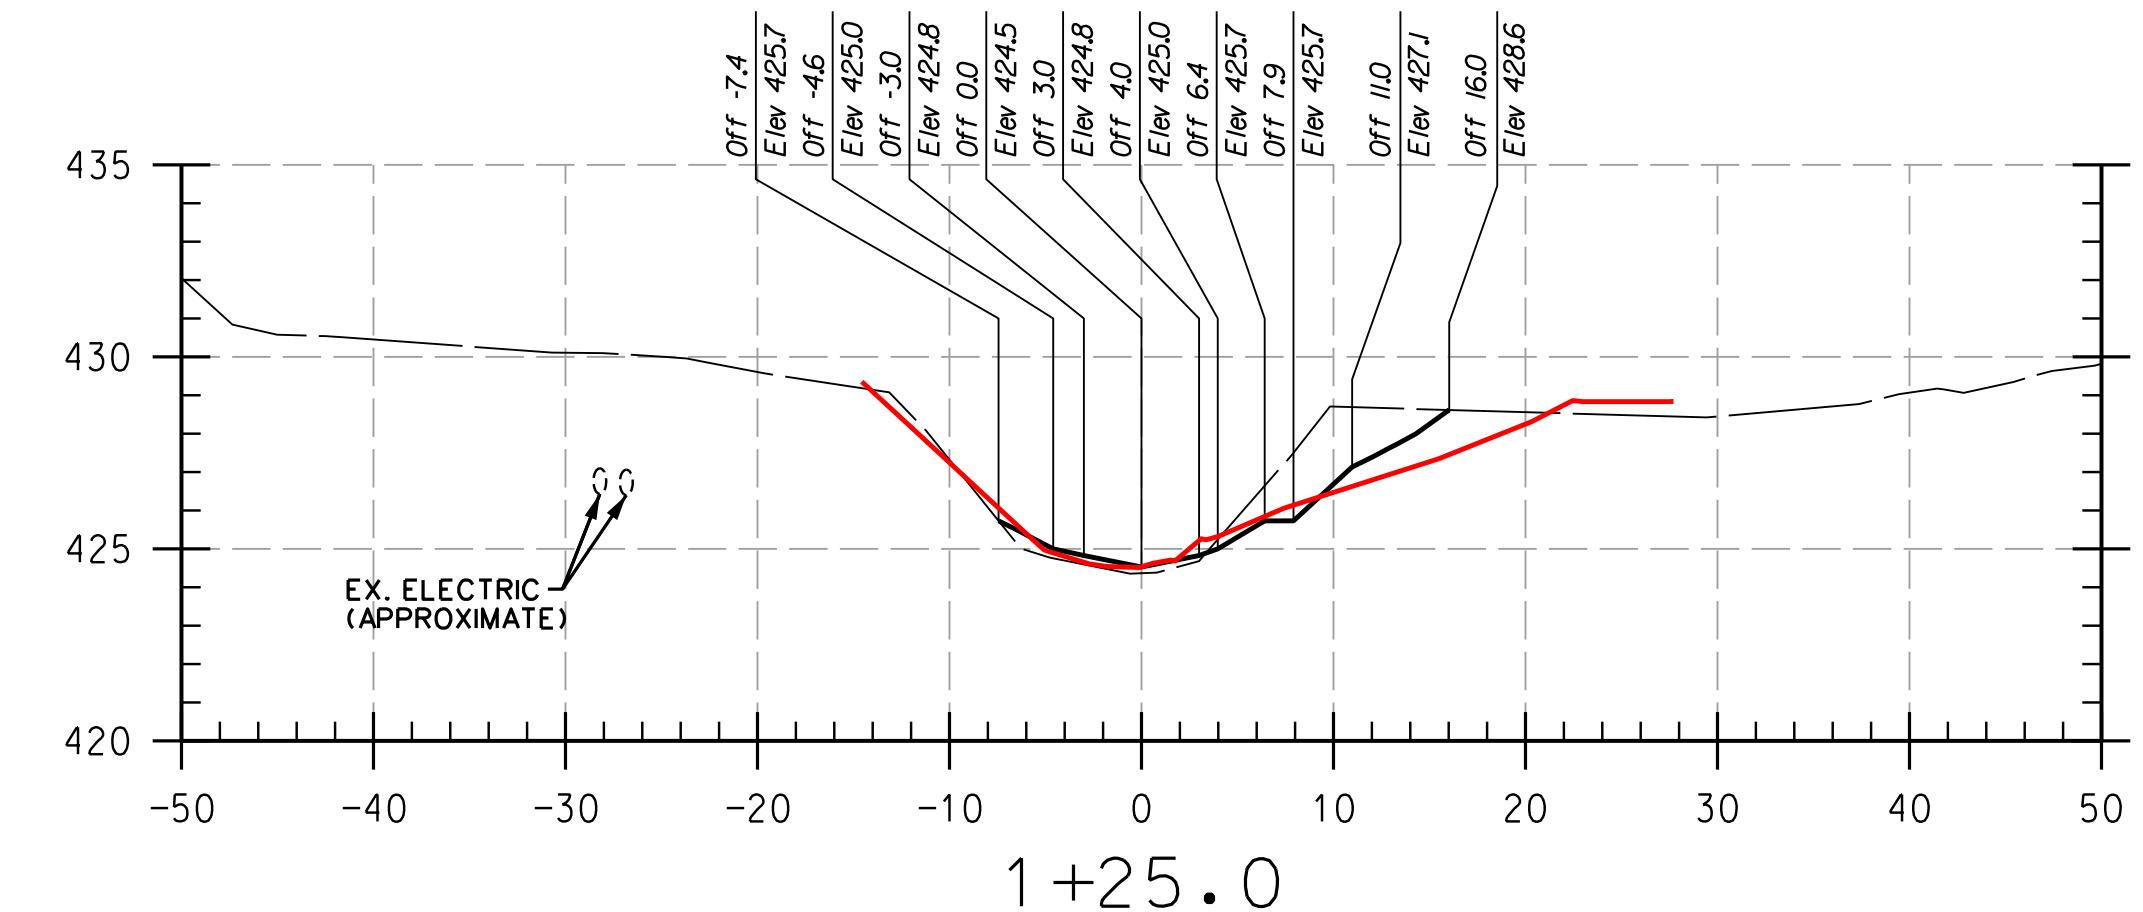

HOWARD COMMUNITY COLLEGE
 STREAM RESTORATION PROJECT
 CAPITAL PROJECT D-1158
 HOWARD COUNTY DEPARTMENT OF PUBLIC WORKS
 STORMWATER MANAGEMENT DIVISION
 6751 COLUMBIA GATEWAY DRIVE
 COLUMBIA, MD 21046
 PARCELS 47, 81, TAX MAP 35, 36
 GRID BLOCK 0006
 ZONING: R-1, ELECTION DISTRICT 06

**AS-BUILT
 CROSS
 SECTIONS**







SCALE: HOR: 1" = 10'
 VERT: 1" = 5'
 DATE: APRIL 2017
 KC JOB NO.: 17133314.83
 CAPITAL PROJECT NO.: D-1158
 PERMIT ISSUE:
 CONSTRUCTION ISSUE:

CS-01

SHEET NO.: 1 OF 27

936 RIDGEBROOK ROAD
 SPARKS, MARYLAND 21152
 TELEPHONE: (410) 316-7800
 FAX: (410) 316-7818
 www.kci.com

NO. REVISIONS DESCRIPTION DATE
 KC FILE: M:\ 2013 \ 17133314.83\

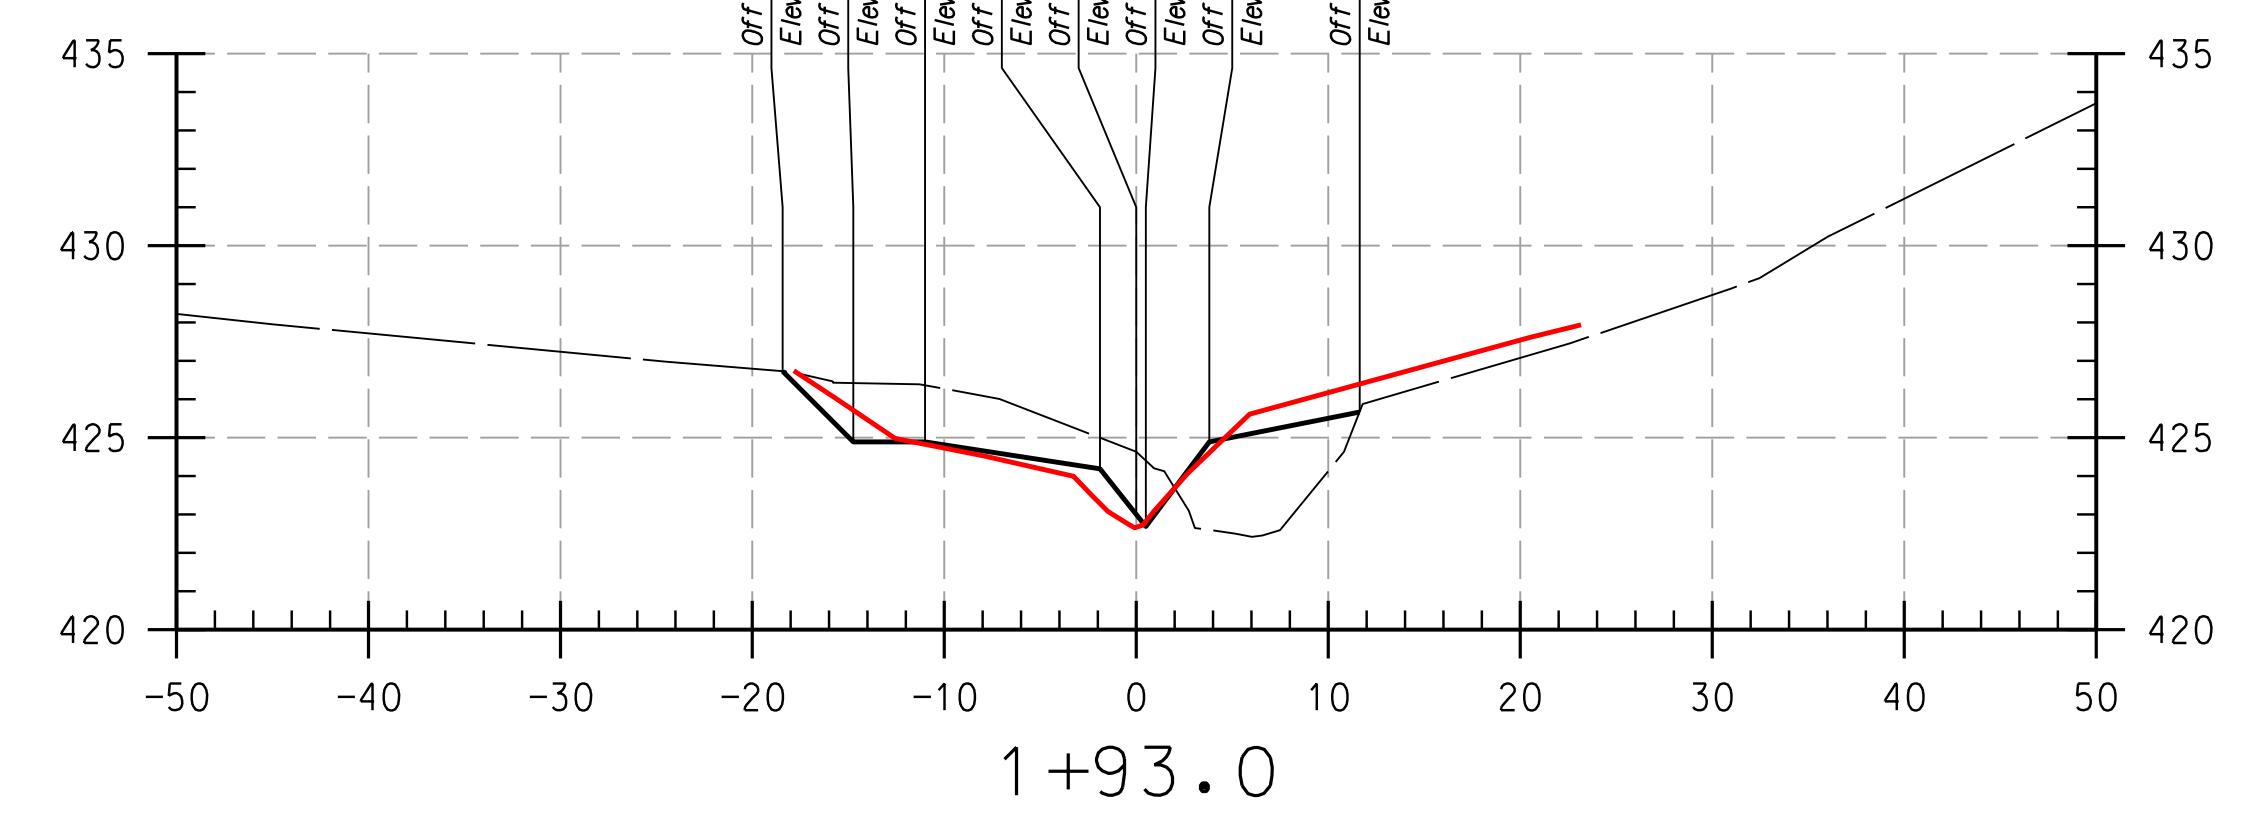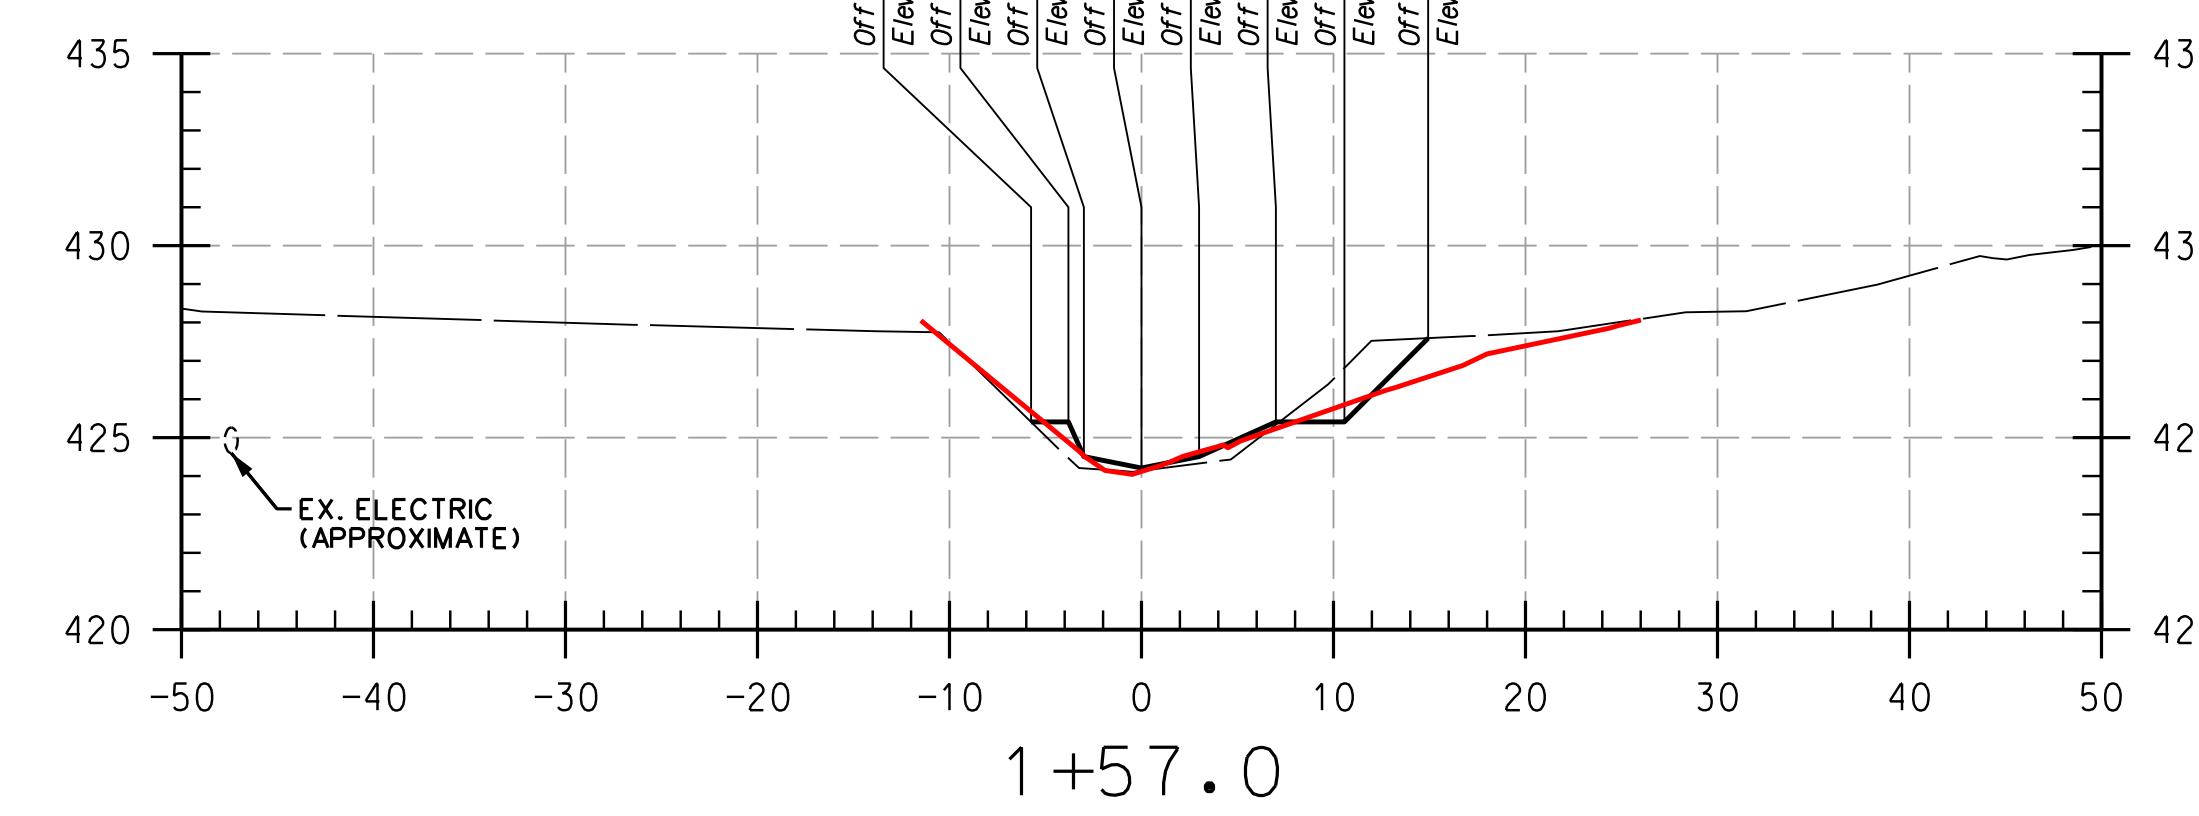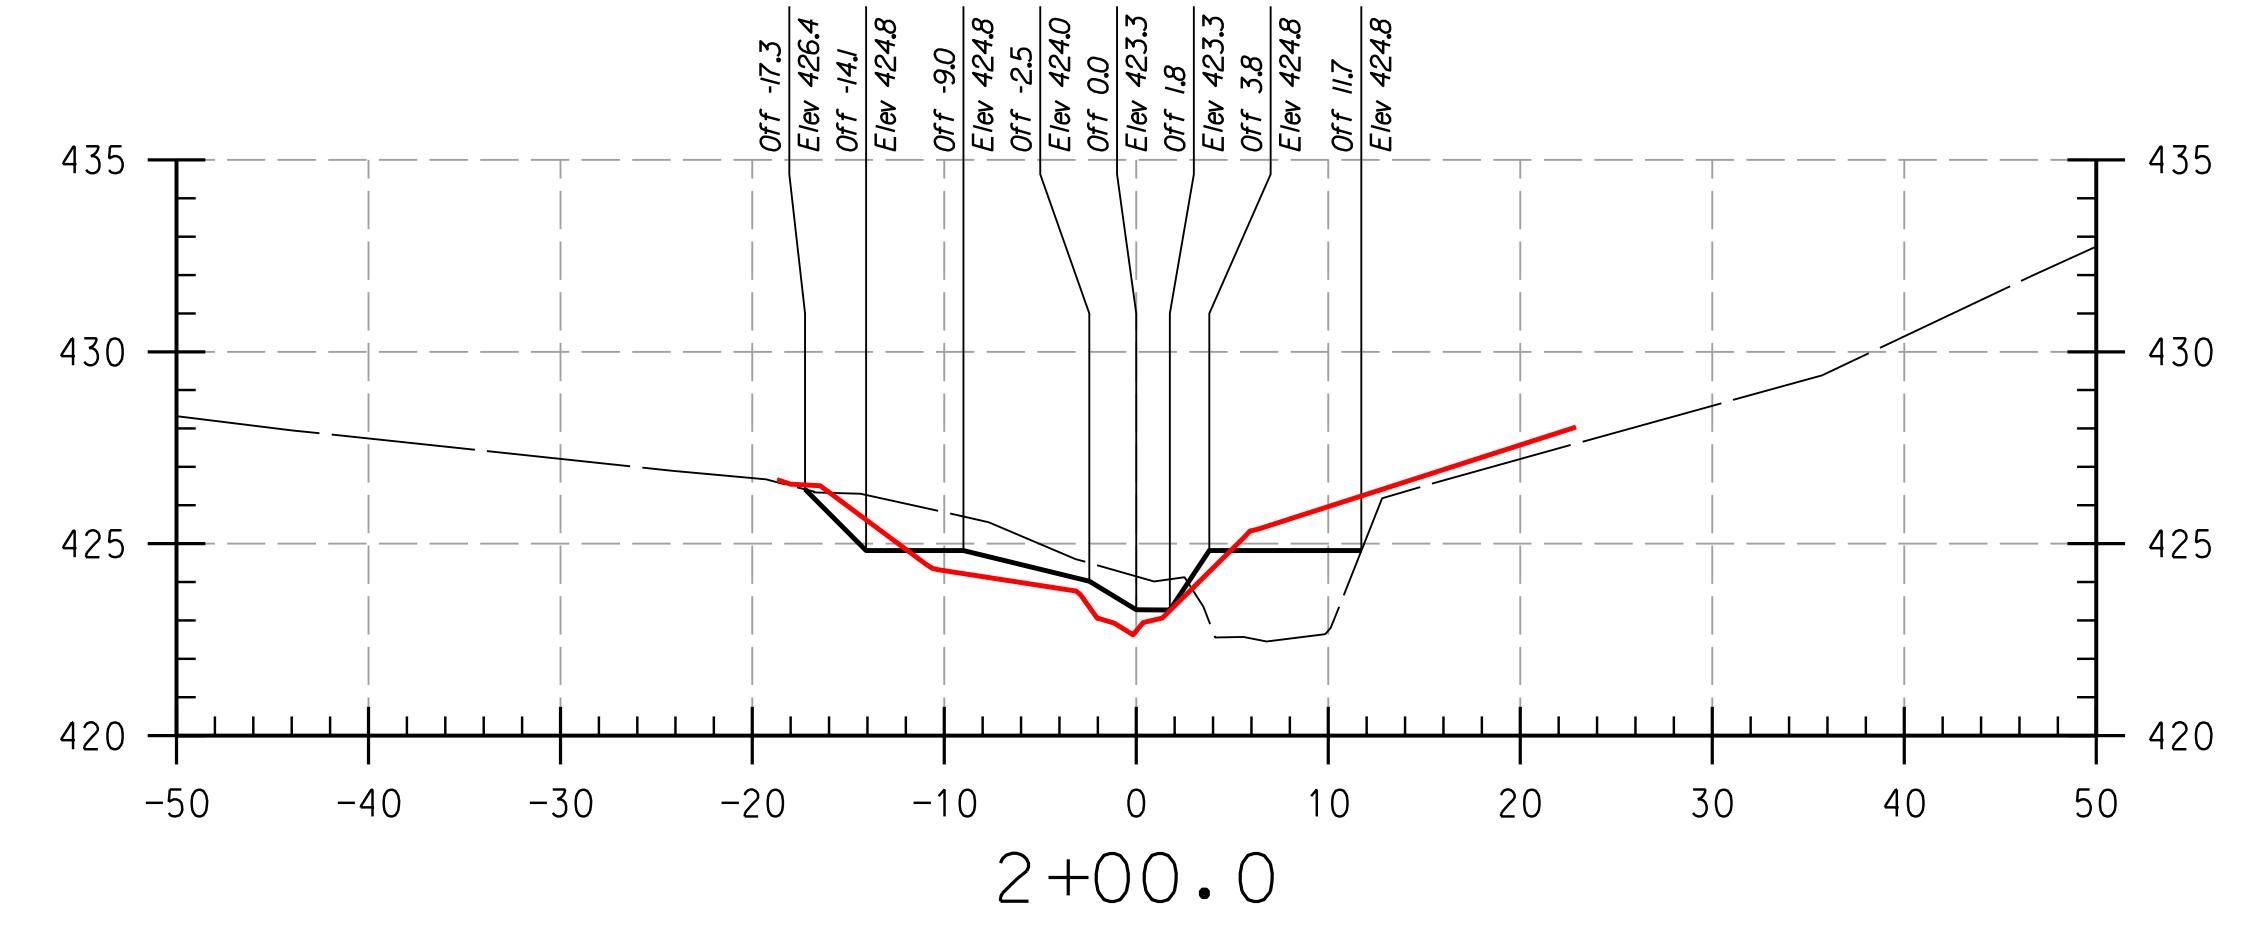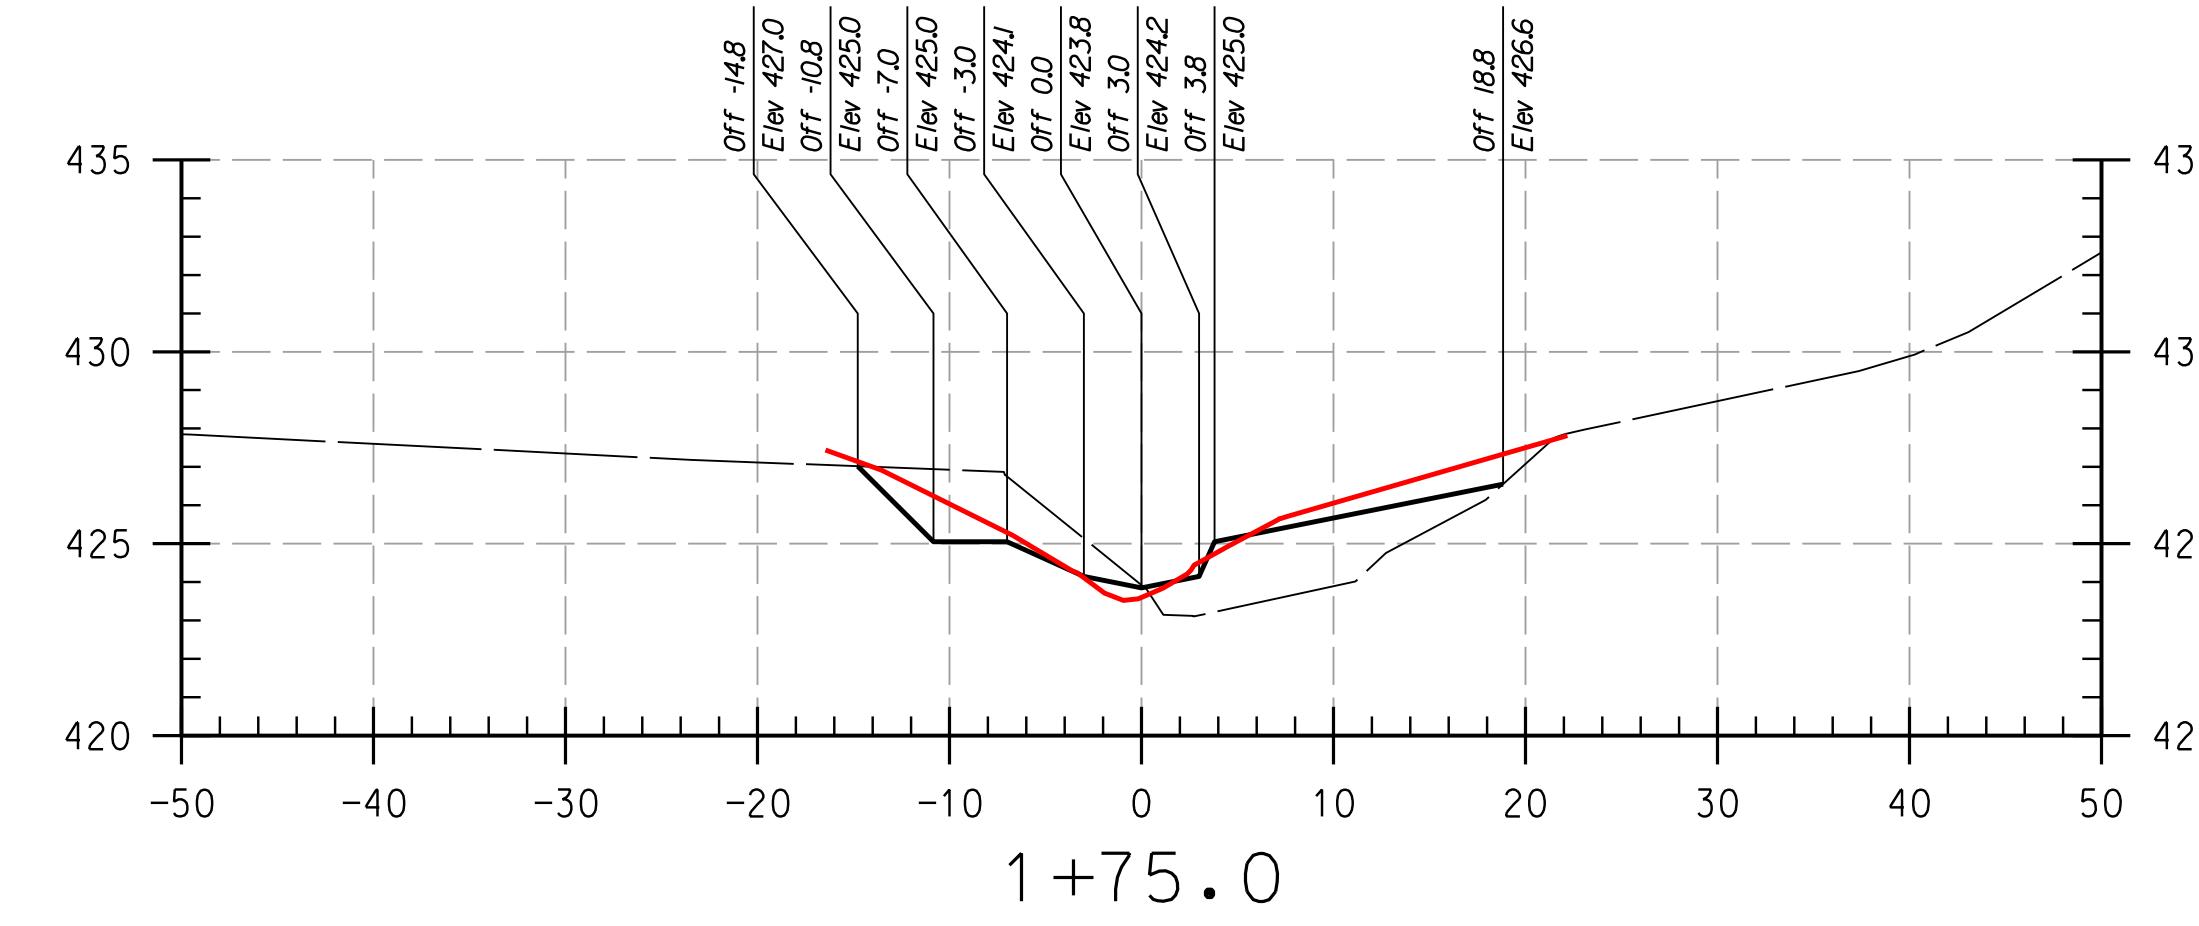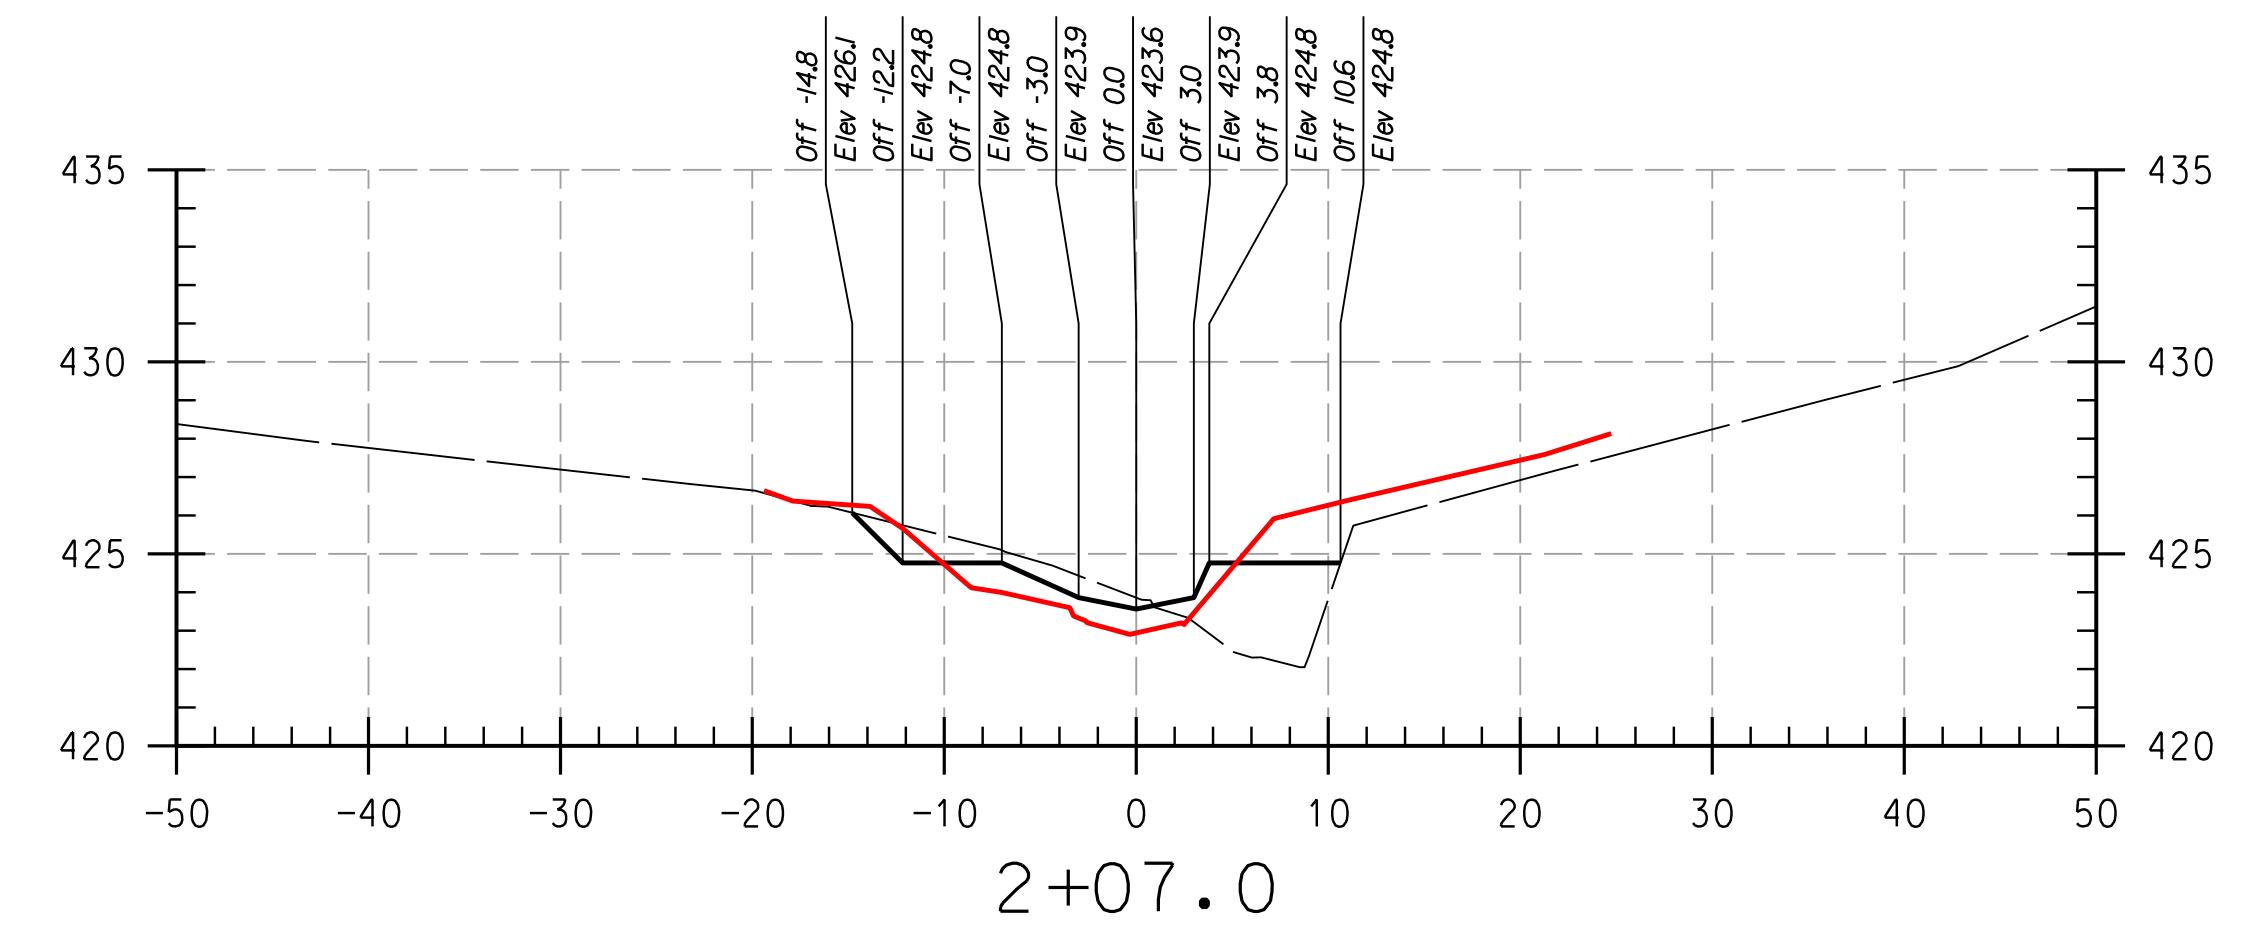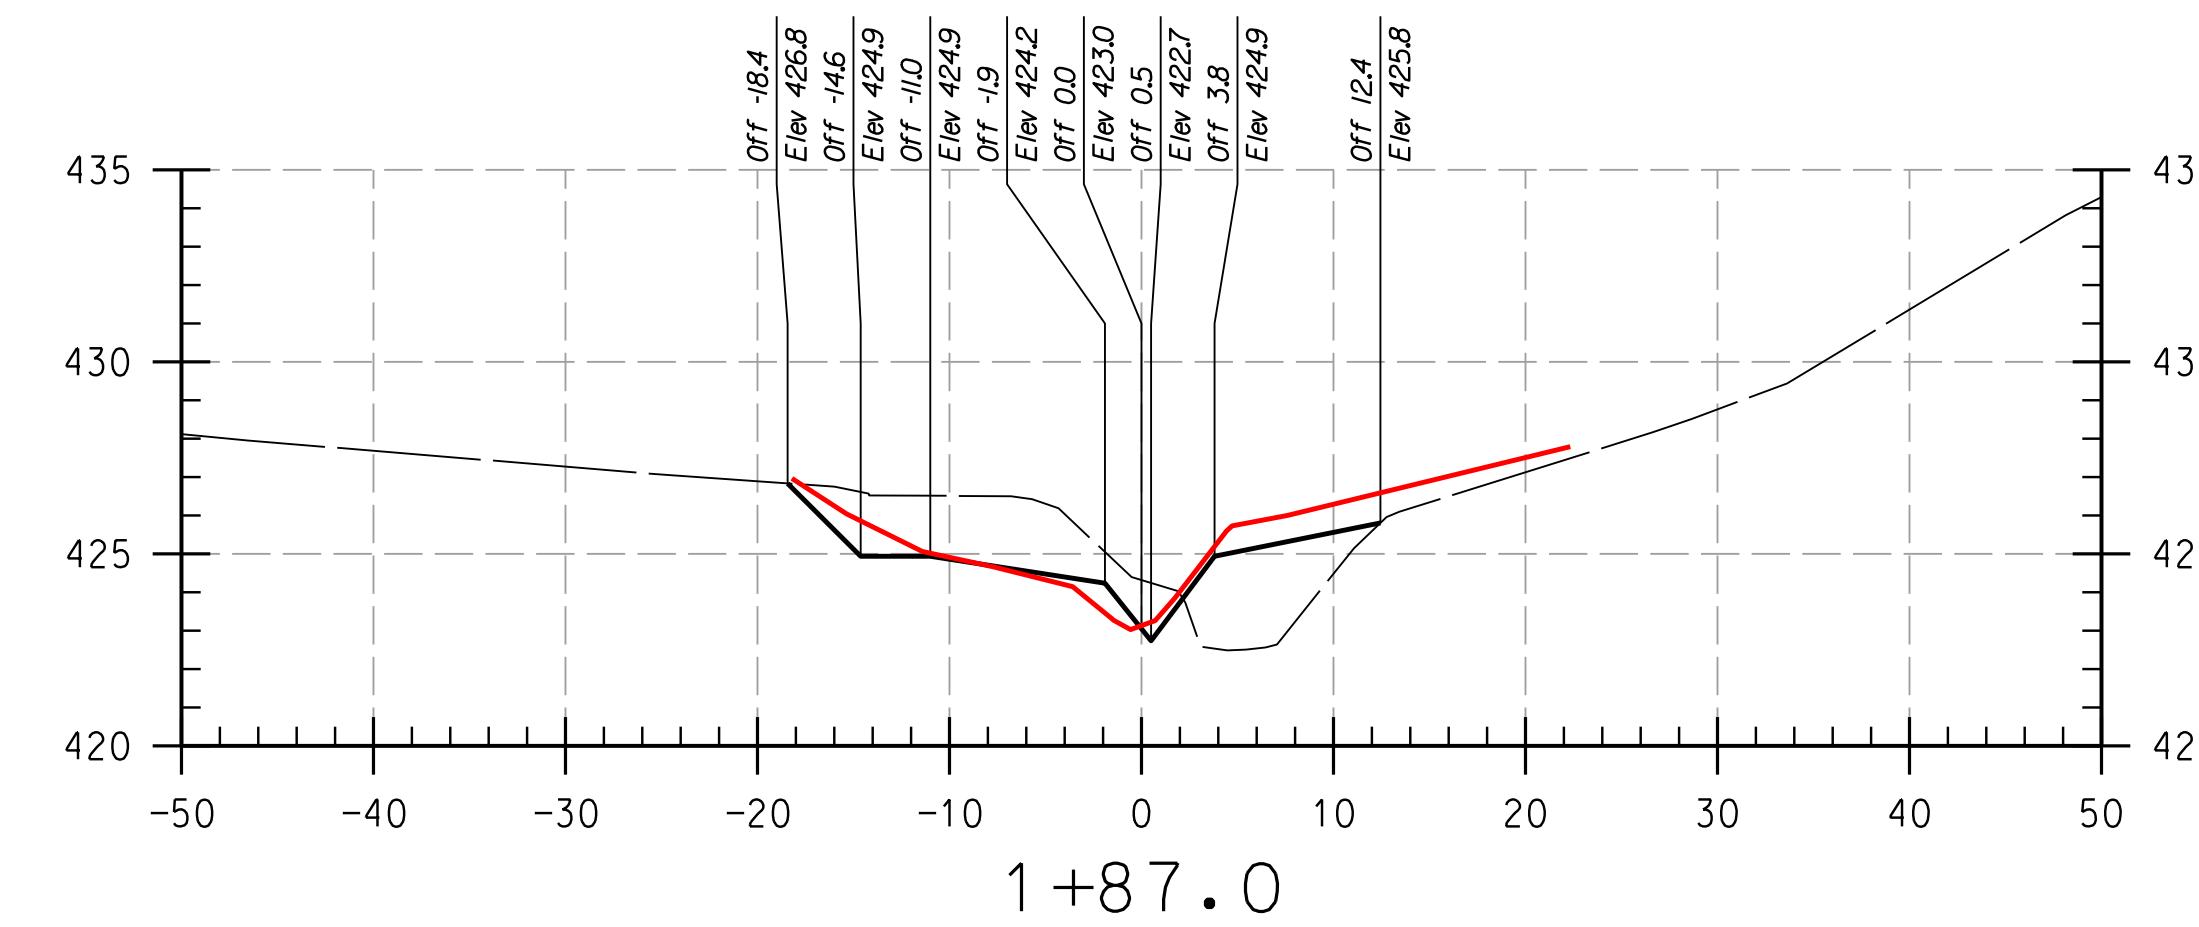

REACH 1

LEGEND

NOTE:
UTILITIES SHOWN ON THESE PLANS HAVE BEEN
USING THE BEST AVAILABLE INFORMATION. HOWE
CONTRACTOR IS TO EXERCISE EXTREME CAUTION
EXCAVATING NEAR ANY UTILITIES. TEST PIT IF

PROFESSIONAL CERTIFICATION. I HEREBY CERTIFY THAT THESE DOCUMENTS WERE PREPARED OR APPROVED BY ME, AND THAT I AM A DULY LICENSED PROFESSIONAL ENGINEER UNDER THE LAWS OF THE STATE OF MARYLAND. LICENSE NO. 38311.
EXPIRATION DATE: JANUARY 06 2018

THIS DEVELOPMENT IS APPROVED FOR SOIL EROSION AND SEDIMENT CONTROL
BY THE HOWARD SOIL CONSERVATION DISTRICT.

DEPARTMENT OF PUBLIC WORKS, HOWARD COUNTY, MD

SCALE:	HOR: 1" = 10'
	VERT: 1" = 5'
DATE:	APRIL 2017
KCI JOB NO.:	17133314.83
CAPITAL PROJECT NO.:	D-1158
PERMIT ISSUE:	
CONSTRUCTION ISSUE:	
CS-02	

LEGEND

EXISTING GRADE	—
PROPOSED GRADE	—
AS-BUILT GRADE	—

NOTES:
 UTILITIES SHOWN ON THESE PLANS HAVE BEEN LOCATED
 USING SURVEY AND DRILLING METHODS. THE
 CONTRACTOR IS TO EXERCISE EXTREME CAUTION WHEN
 EXCAVATING NEAR ANY UTILITIES TEST PIT IF REQUIRED.

PROFESSIONAL CERTIFICATION, I HEREBY
 CERTIFY THAT THESE DOCUMENTS WERE
 PREPARED OR APPROVED BY ME AND THAT
 I AM A DULY LICENSED PROFESSIONAL
 ENGINEER UNDER THE LAWS OF THE STATE
 OF MARYLAND, LICENSE NO. 38311,
 EXPIRATION DATE: JANUARY 06, 2018

THIS DEVELOPMENT IS APPROVED FOR SOIL EROSION AND SEDIMENT CONTROL
 BY THE HOWARD SOIL CONSERVATION DISTRICT.

HOWARD SCD


DATE

DEPARTMENT OF PUBLIC WORKS, HOWARD COUNTY, MD


DATE

CHIEF, BUREAU OF ENVIRONMENTAL SERVICES


DATE

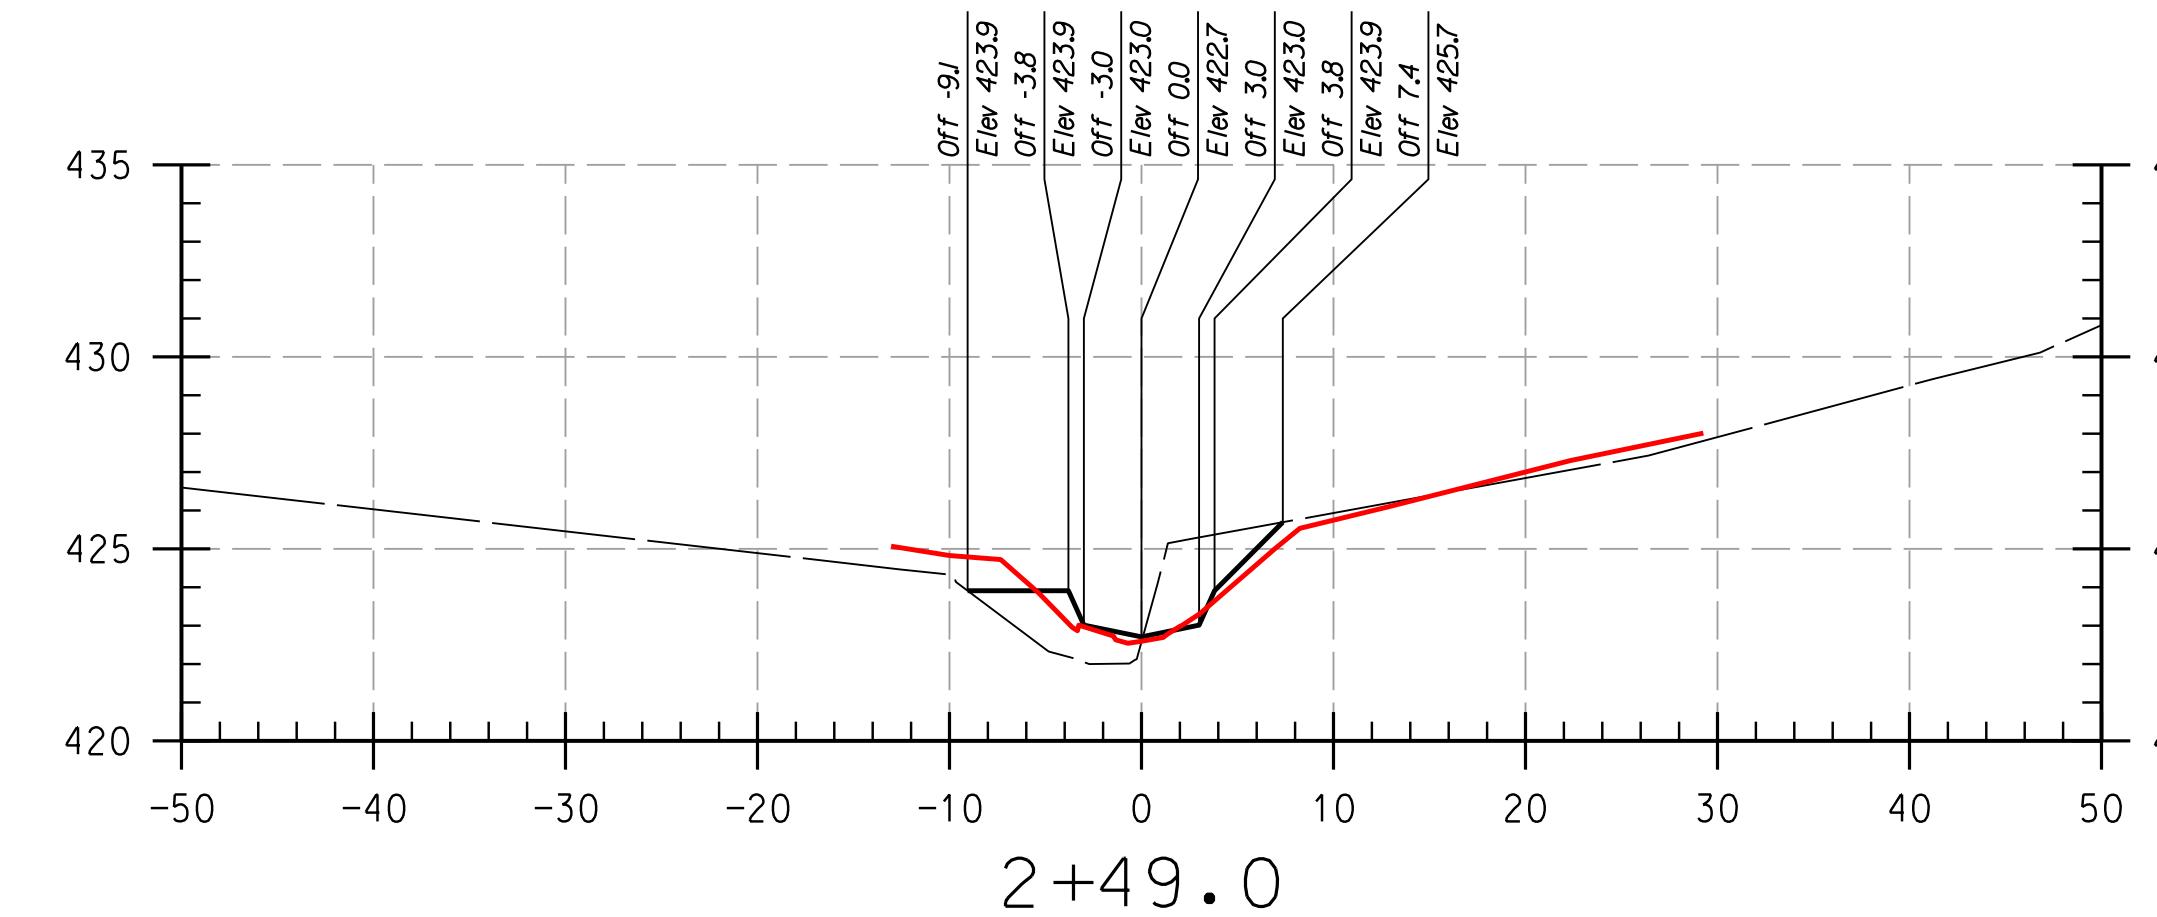


2+49.0

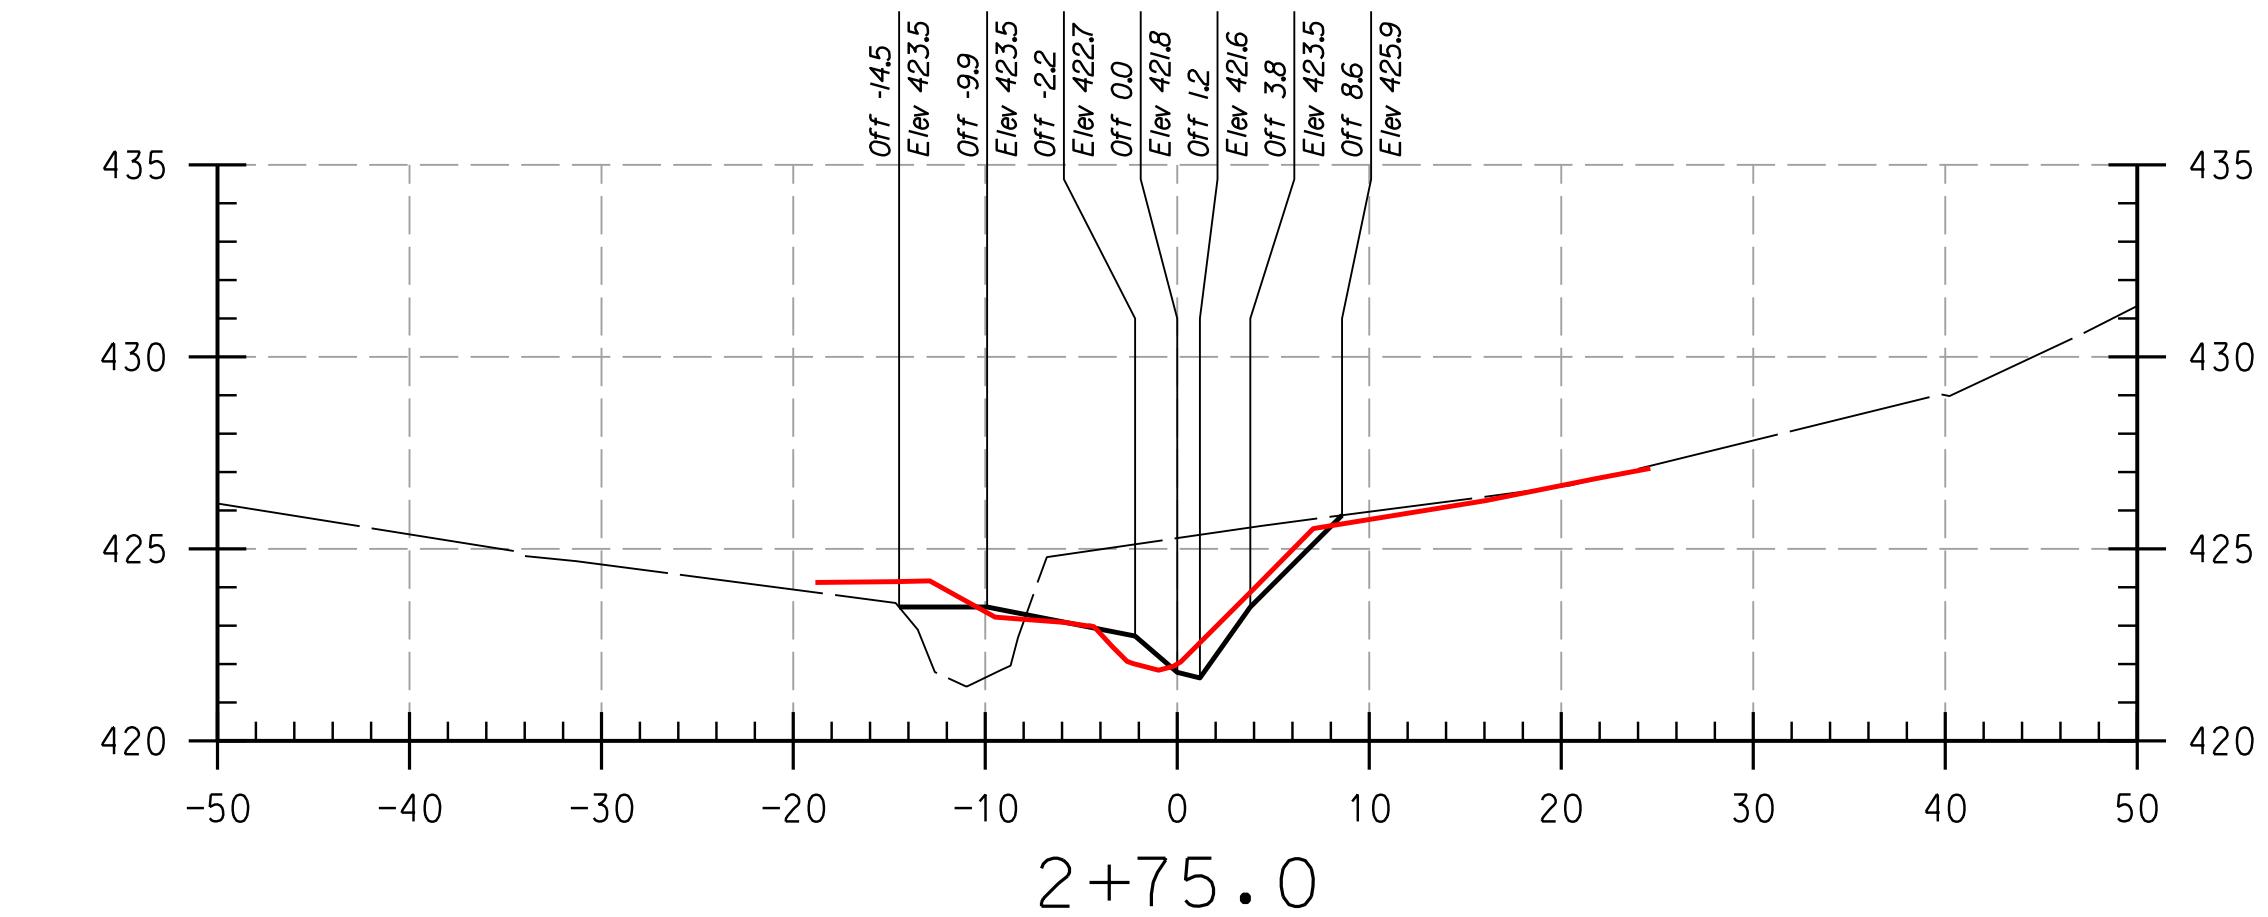


2+75.0

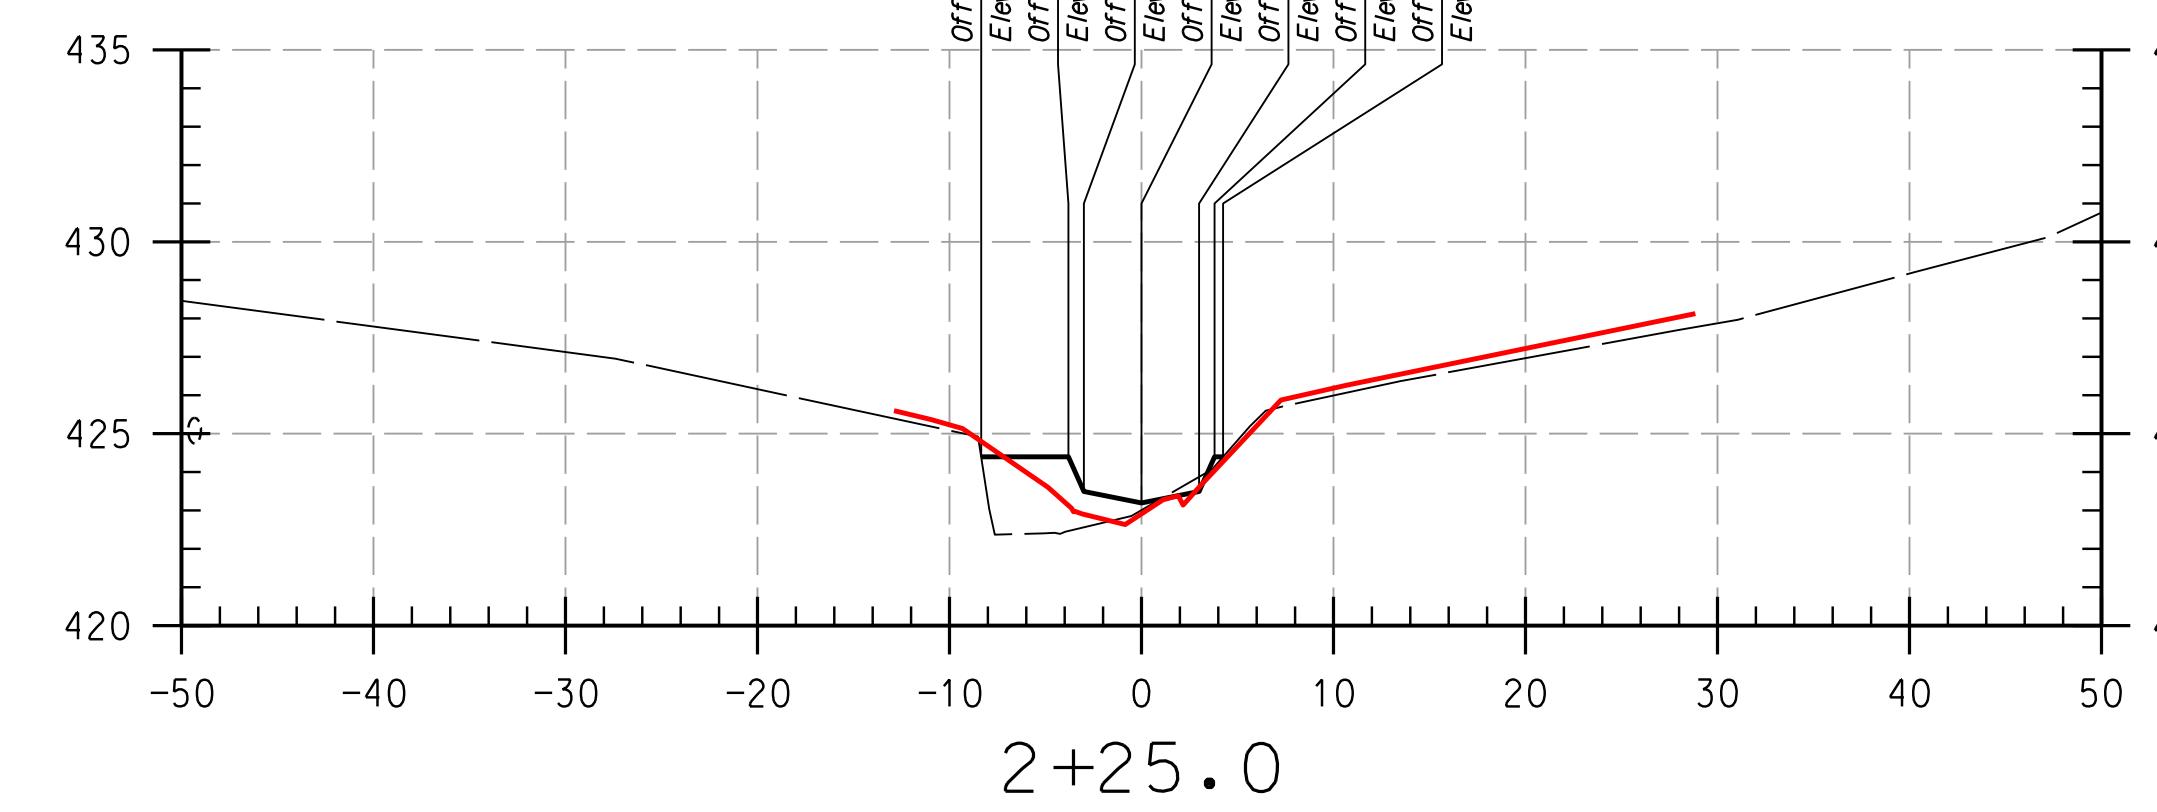


2+25.0

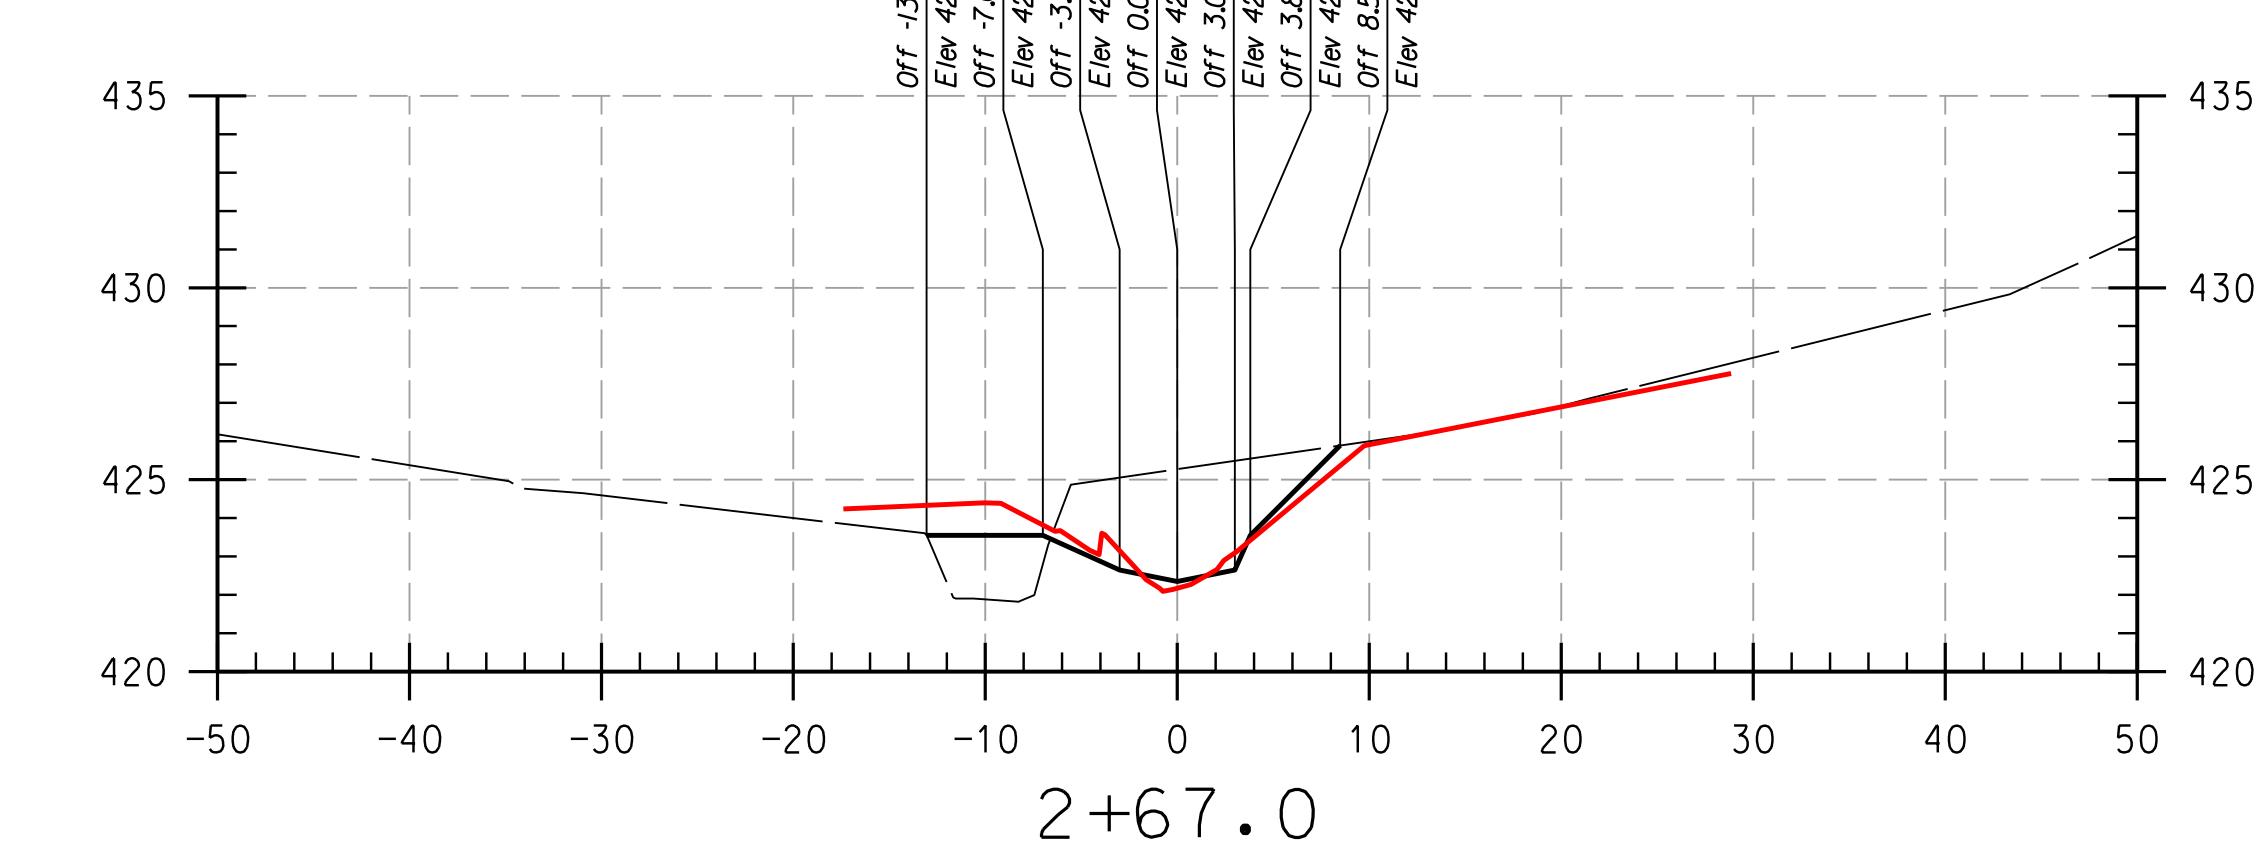

2+67.0

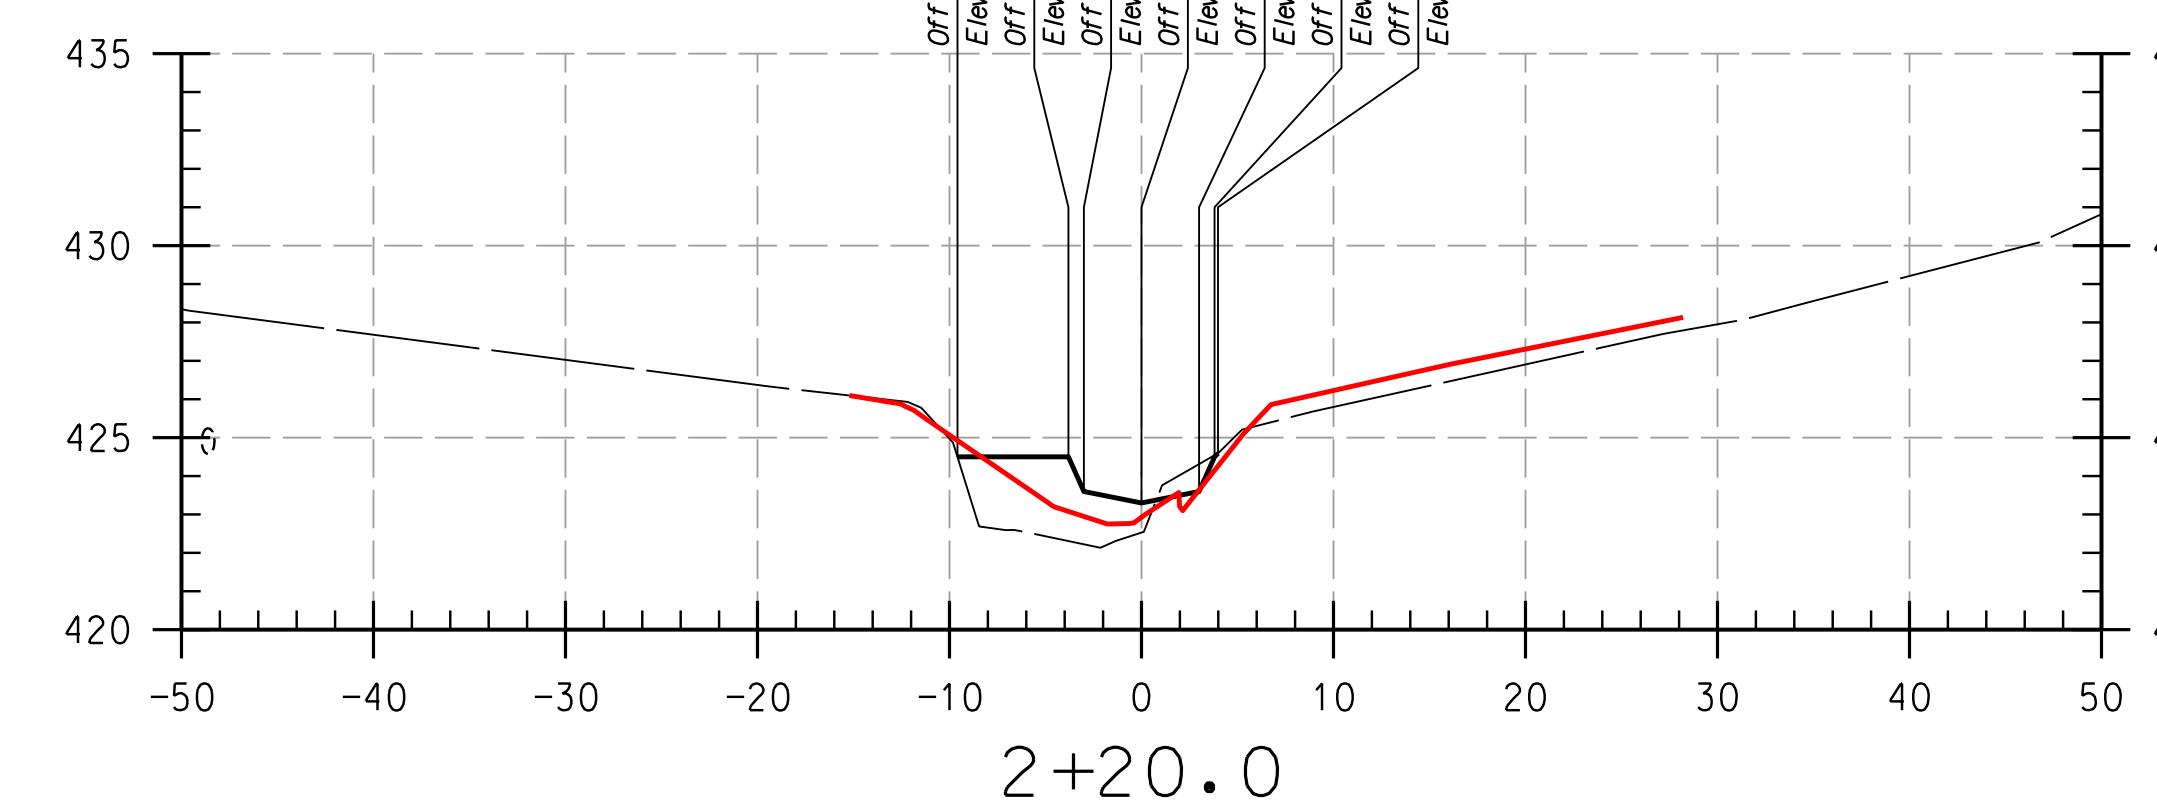

2+20.0

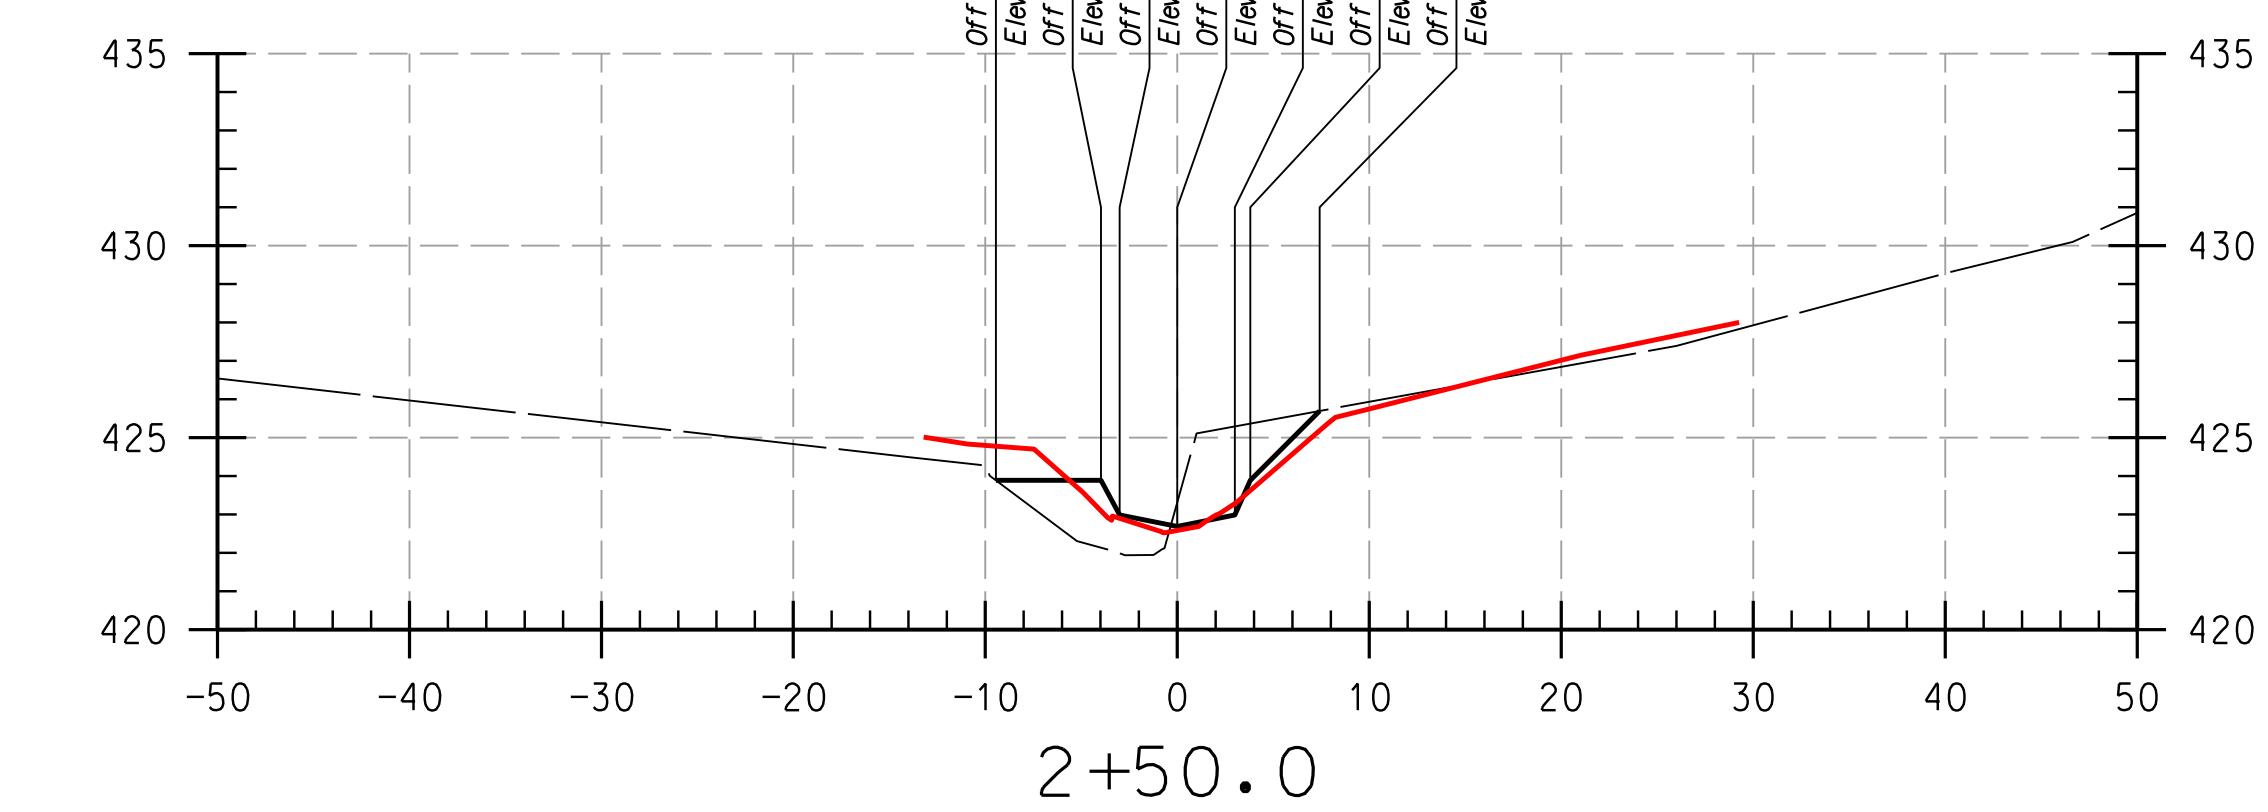

2+50.0

REACH 1

HOWARD COMMUNITY COLLEGE
 STREAM RESTORATION PROJECT
 CAPITAL PROJECT D-1158
 HOWARD COUNTY DEPARTMENT OF PUBLIC WORKS
 STORMWATER MANAGEMENT DIVISION
 6751 COLUMBIA GATEWAY DRIVE
 COLUMBIA, MD 21046
 PARCELS 47, 81, TAX MAP 35, 36
 ZONING POR, NT, ELECTION DISTRICT 06 GRID BLOCK 0006


**AS-BUILT
 CROSS
 SECTIONS**

SCALE: HOR: 1" - 10'
 VERT: 1" - 5'
 DATE: APRIL 2017
 KC JOB NO.: 17133314.83
 CAPITAL PROJECT NO.: D-1158
 PERMIT ISSUE:
 CONSTRUCTION ISSUE:

CS-03


SHEET NO.: 3 OF 27

936 RIDGEBROOK ROAD
 SPARKS, MARYLAND 21152
 TELEPHONE: (410) 316-7800
 FAX: (410) 316-7818
 www.kci.com

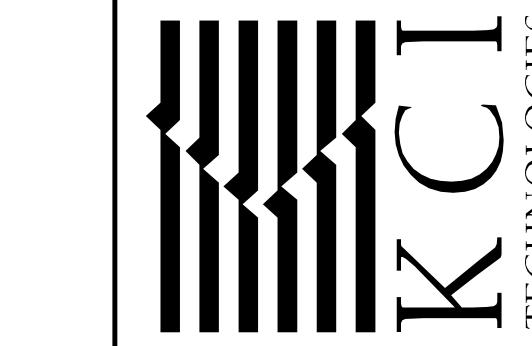

PLOTTED 12:28 PM on Monday, April 24, 2017
FILE: C:\CAD_Files\Howard CC\DXS\2001 Howard CC As-Built.dwg

PROFESSIONAL CERTIFICATION, I HEREBY
CERTIFY THAT THESE DOCUMENTS WERE
PREPARED OR APPROVED BY ME AND THAT
I AM A DULY LICENSED PROFESSIONAL
ENGINEER UNDER THE LAWS OF THE STATE
OF MARYLAND, LICENSE NO. 3831,
EXPIRATION DATE: JANUARY 06, 2018

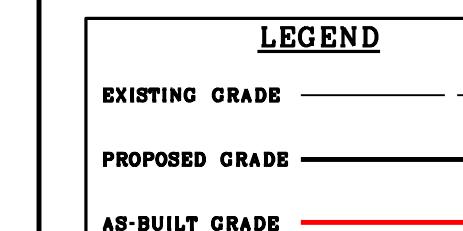

NOTES:
UTILITIES SHOWN ON THESE PLANS HAVE BEEN LOCATED
USING SURVEY DATA AND ARE NOT DRAWN TO SCALE.
THE CONTRACTOR IS TO EXERCISE EXTREME CAUTION WHEN
EXCAVATING NEAR ANY UTILITIES TEST PIT IF REQUIRED.

THIS DEVELOPMENT IS APPROVED FOR SOIL EROSION AND SEDIMENT CONTROL
BY THE HOWARD SOIL CONSERVATION DISTRICT.

HOWARD SCD

DATE









DEPARTMENT OF PUBLIC WORKS, HOWARD COUNTY, MD

DATE

CHIEF, BUREAU OF ENVIRONMENTAL SERVICES

DATE

REACH 1

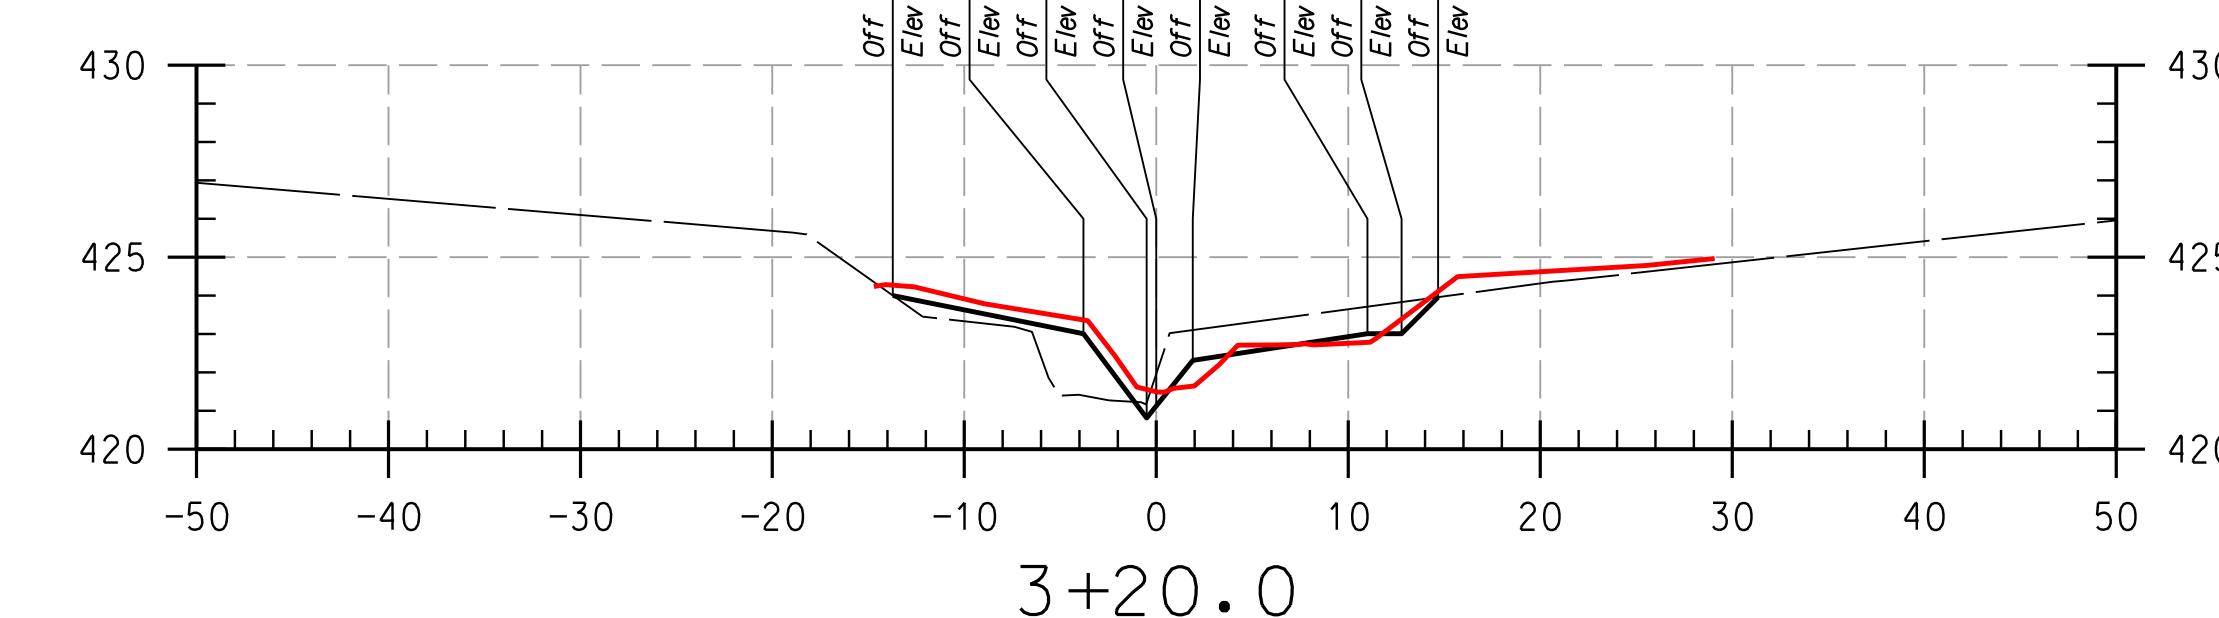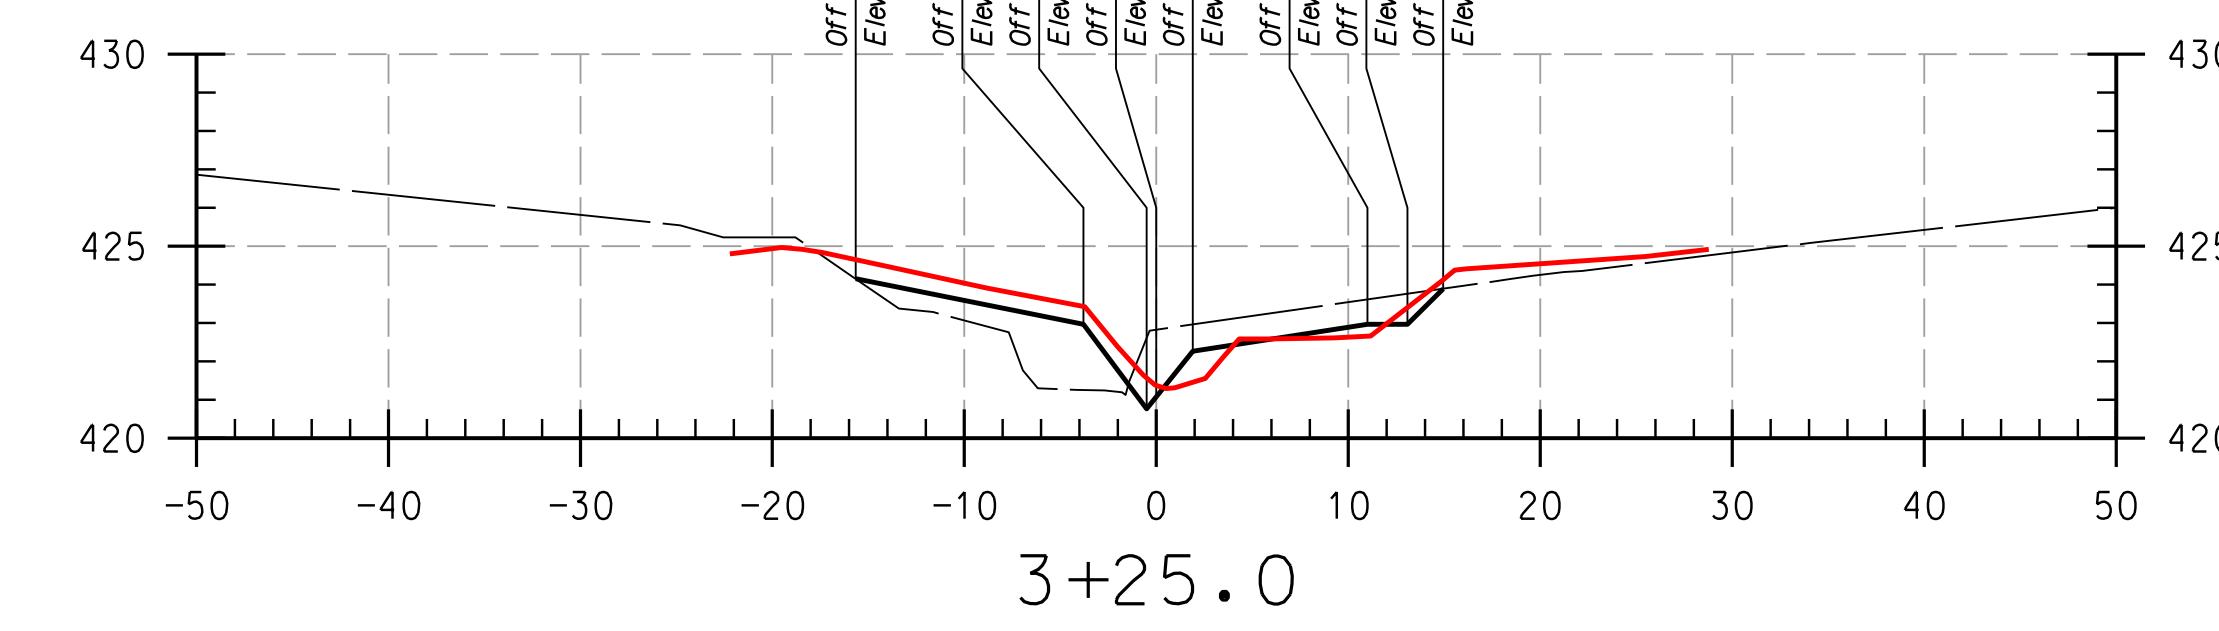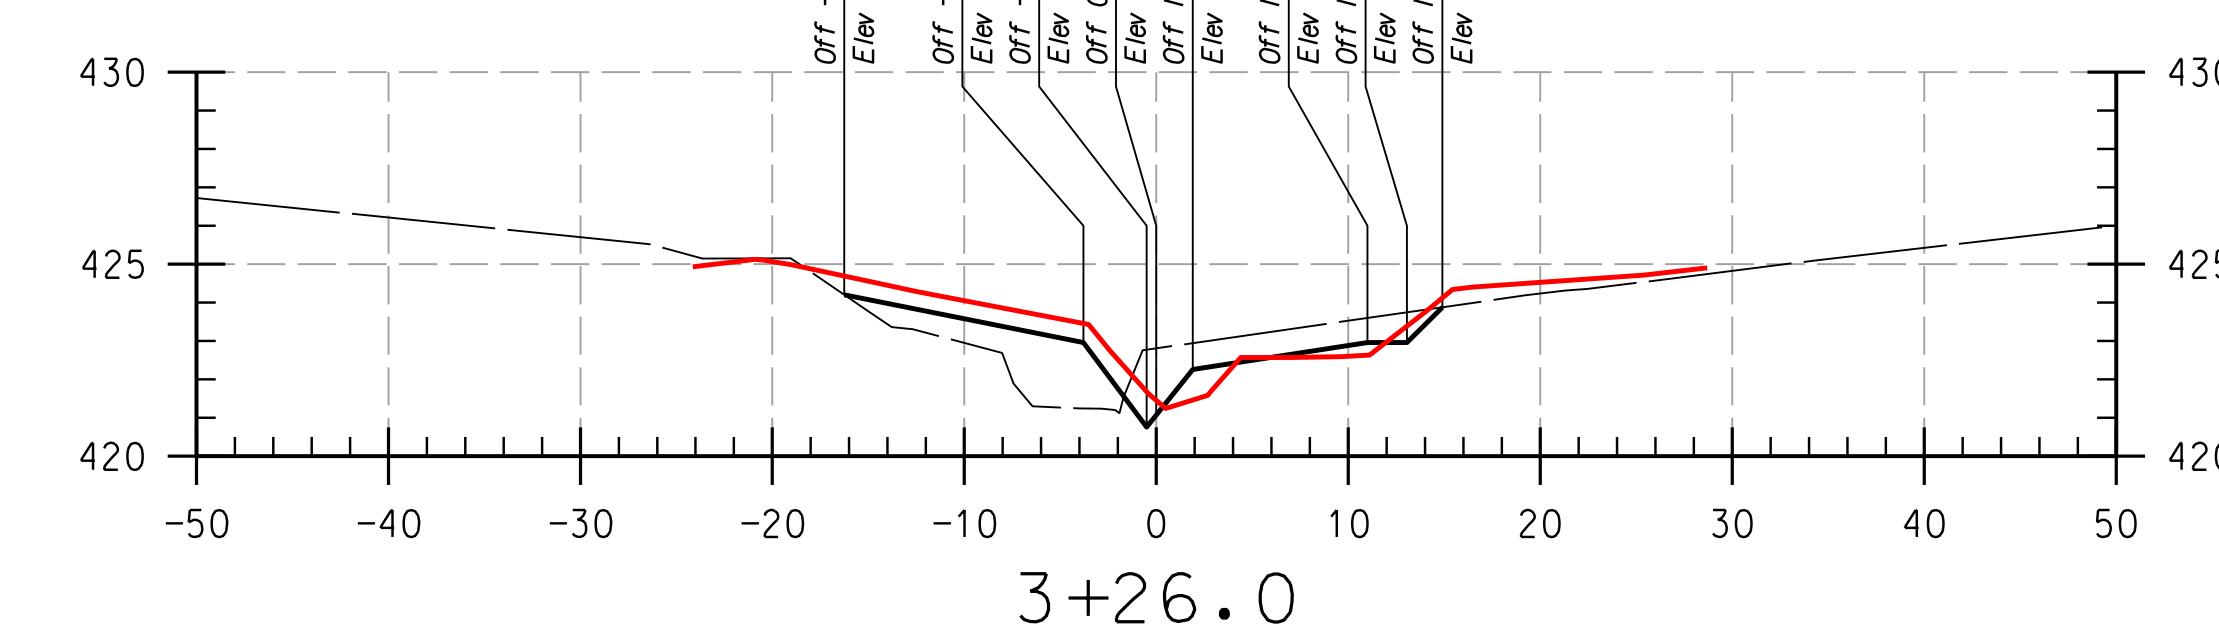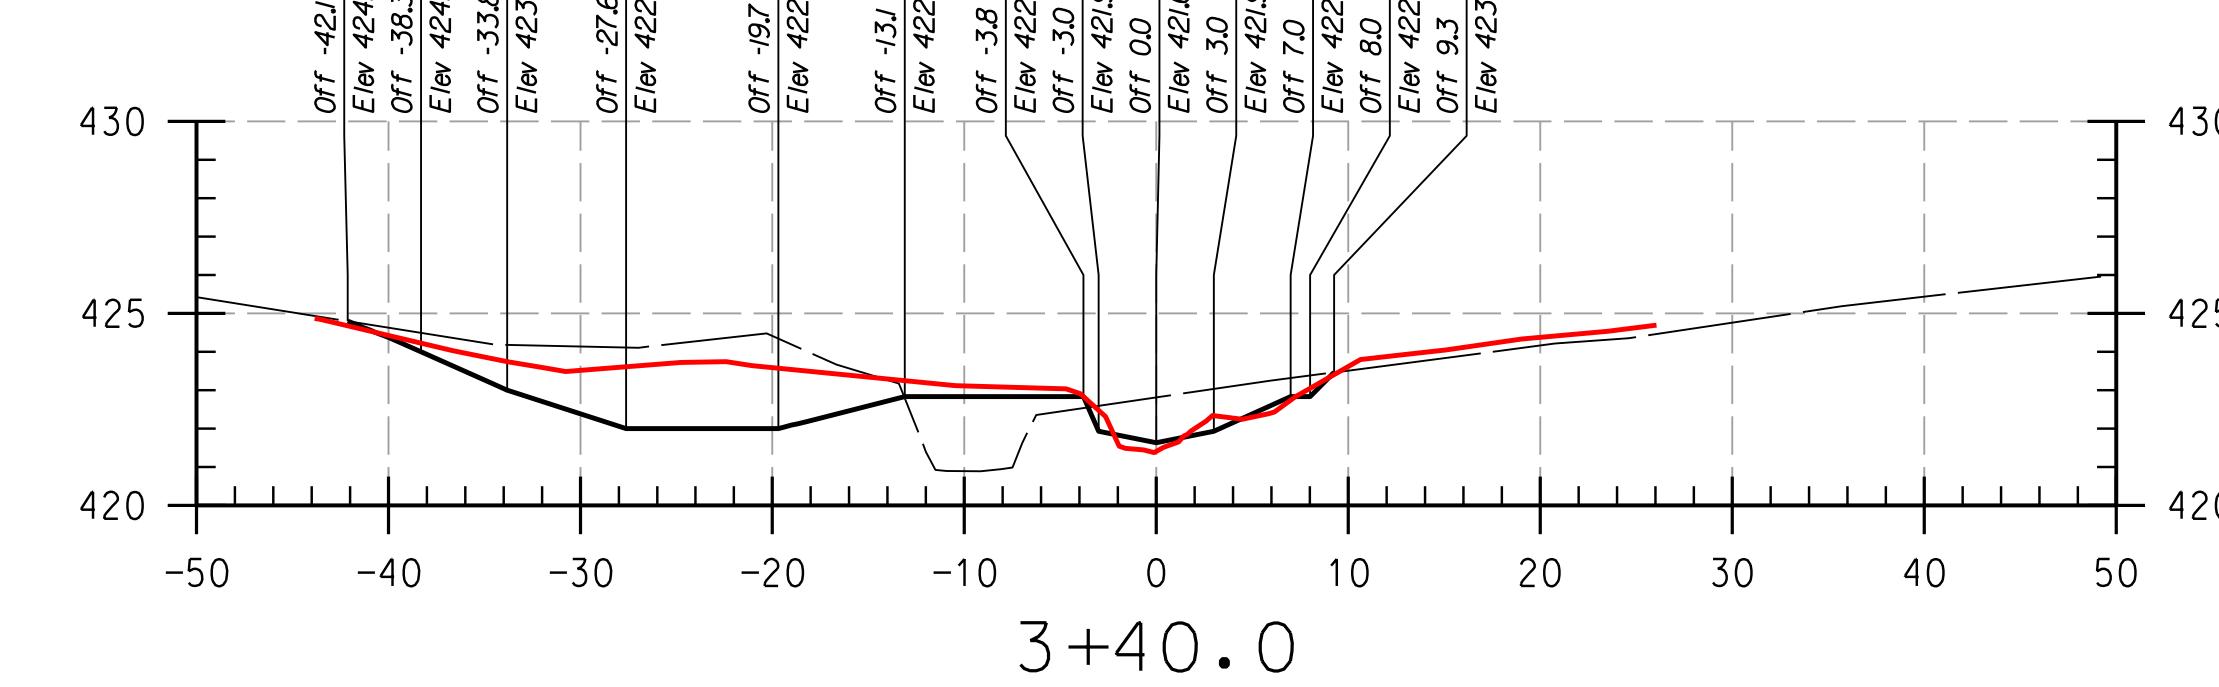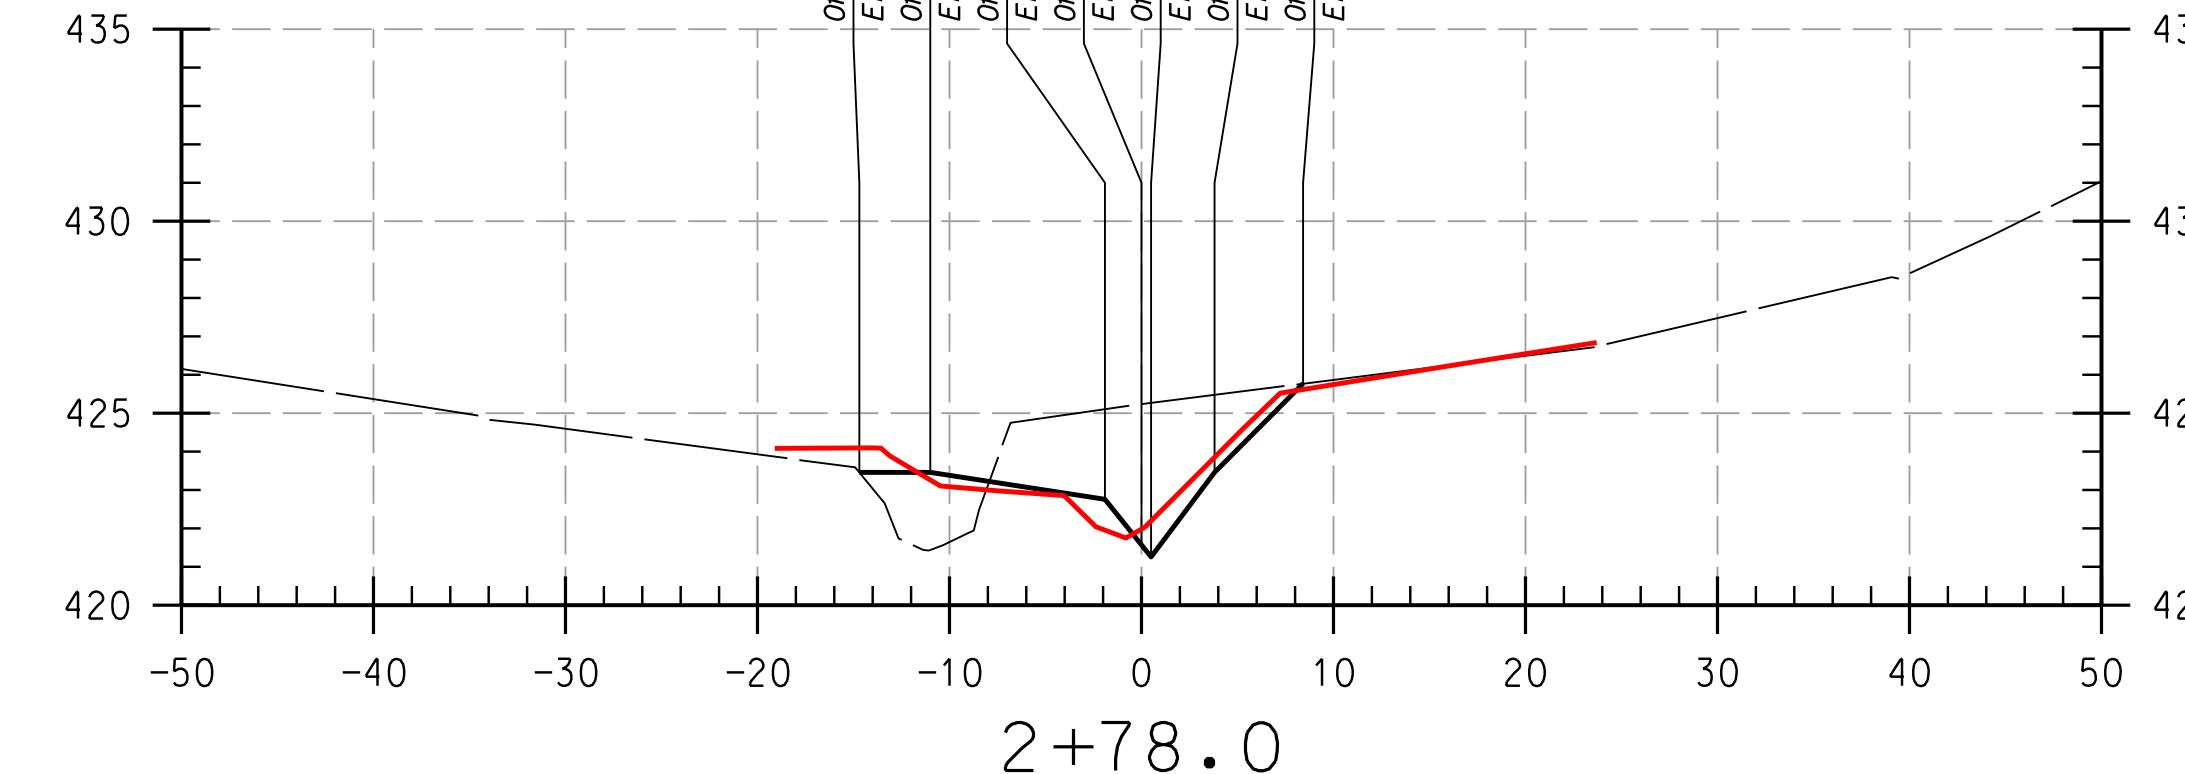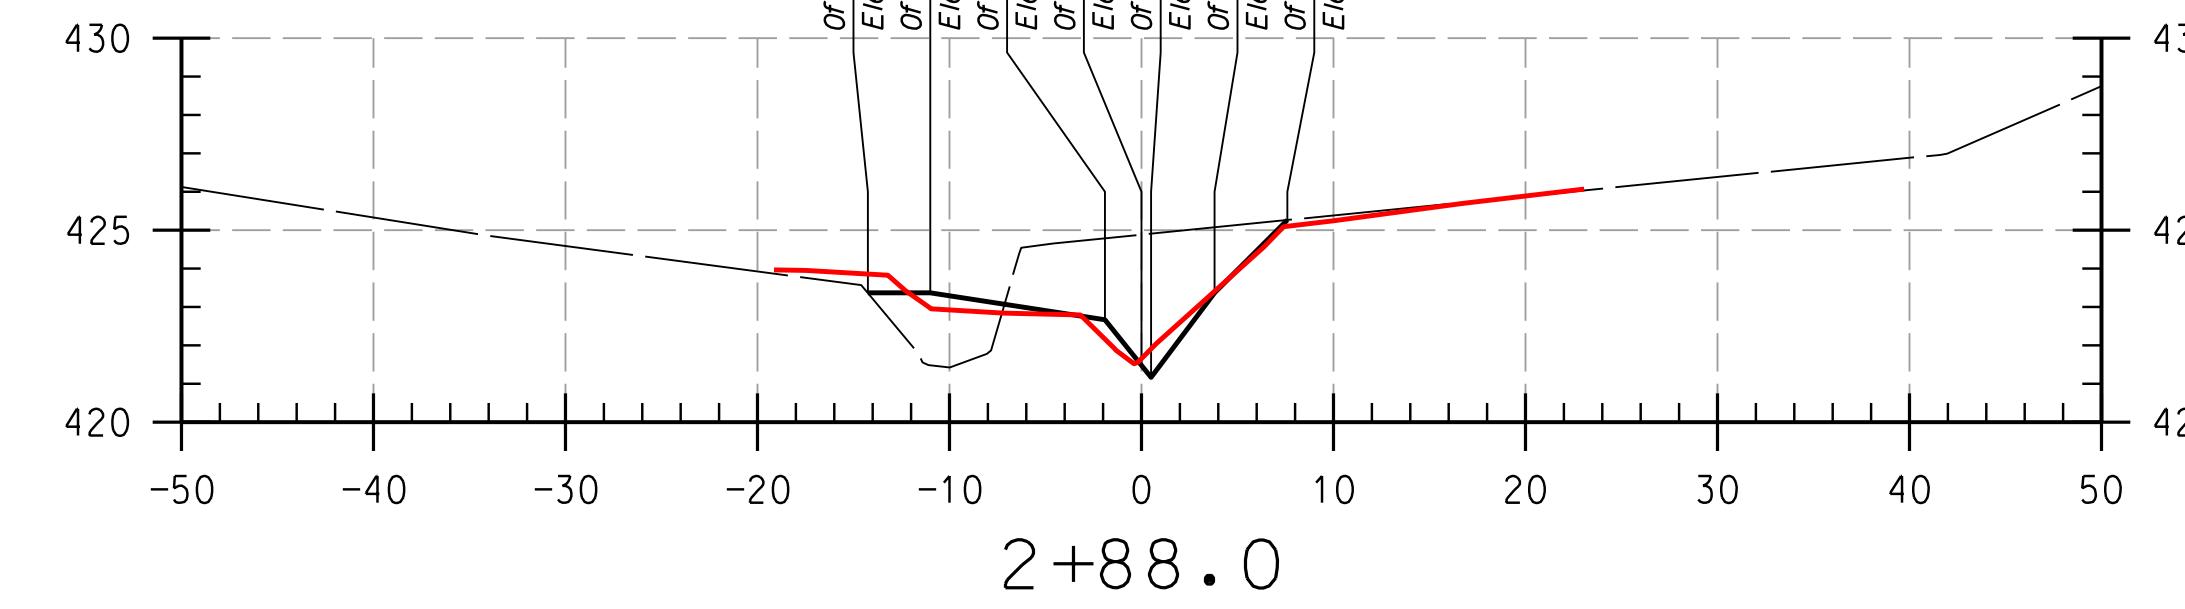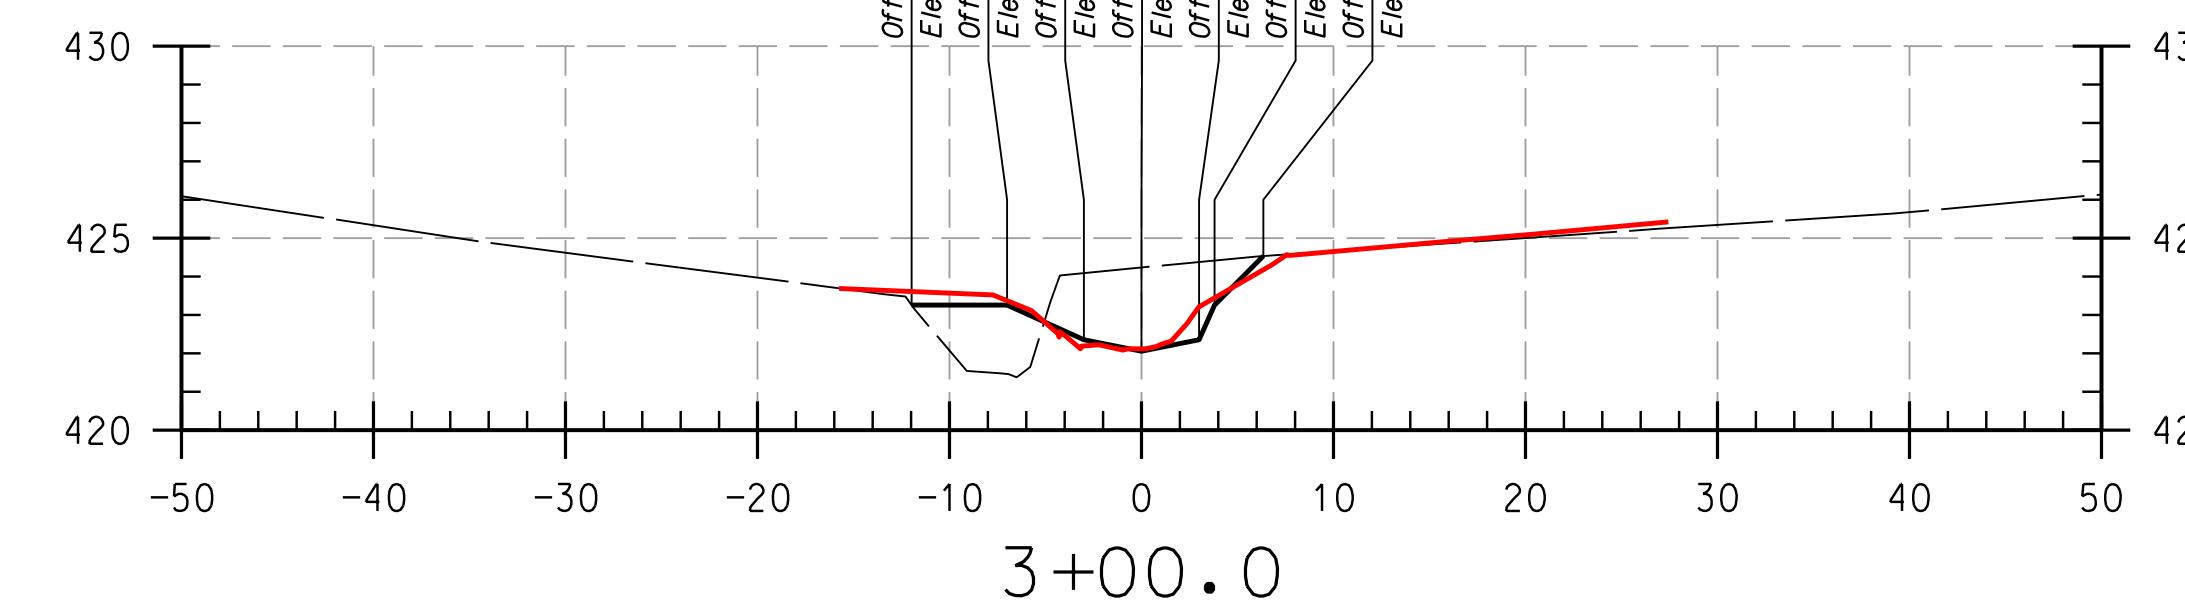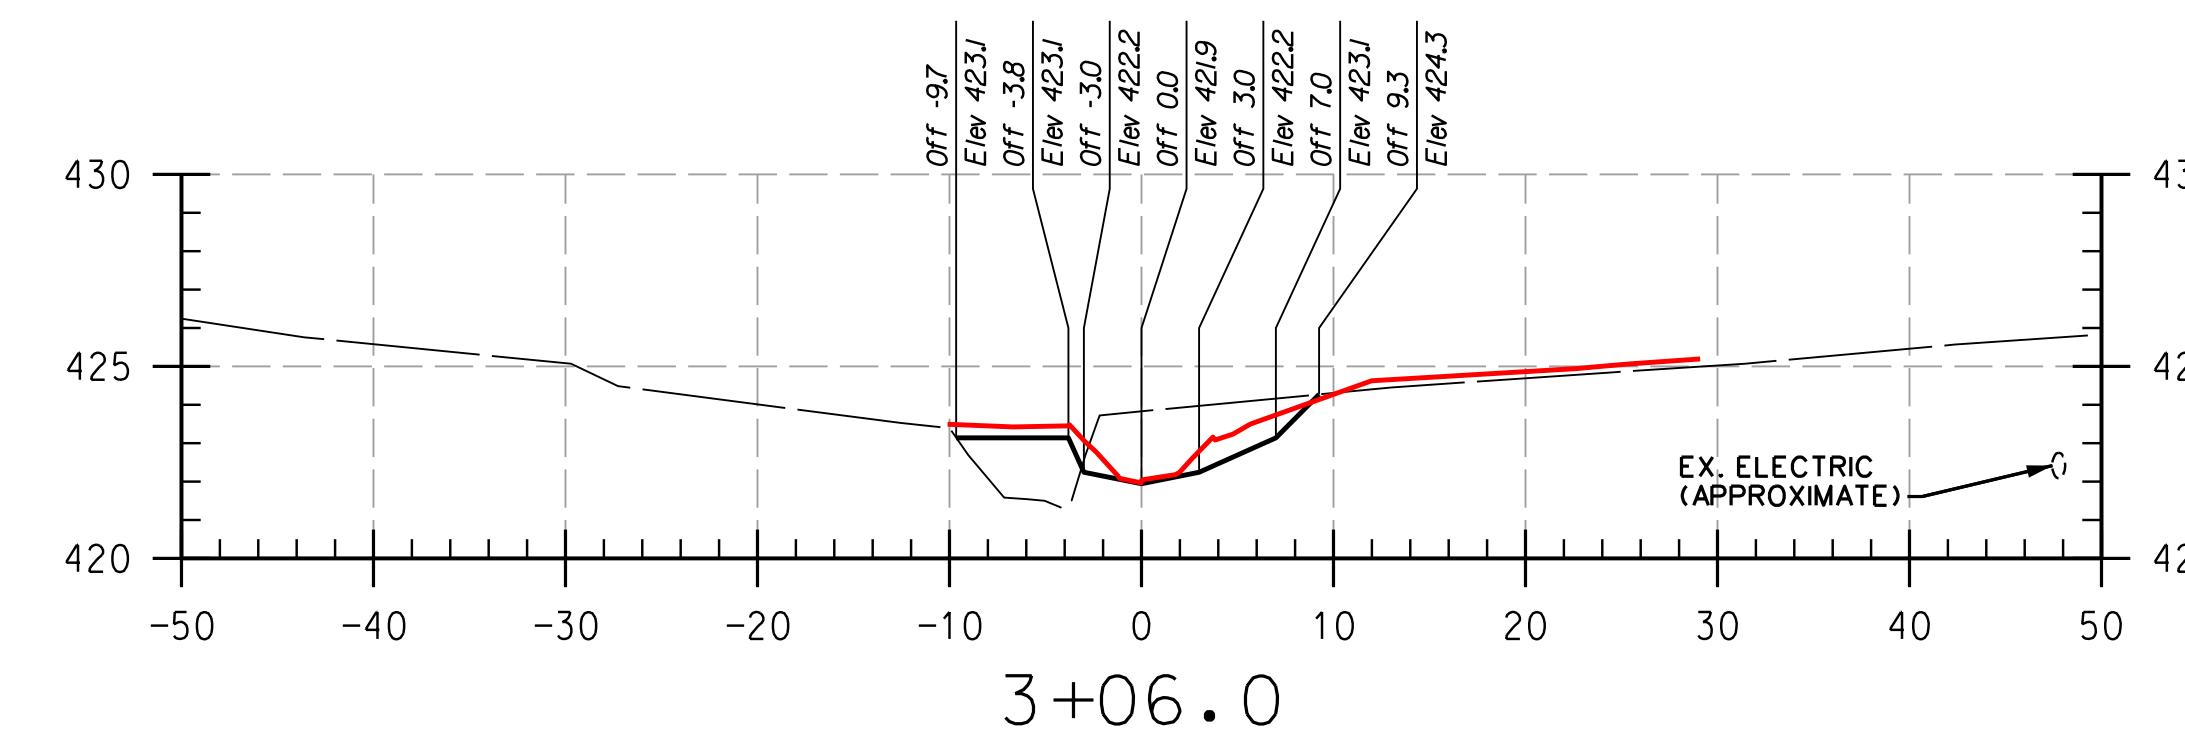

HOWARD COMMUNITY COLLEGE
STREAM RESTORATION PROJECT
CAPITAL PROJECT D-1158
HOWARD COUNTY DEPARTMENT OF PUBLIC WORKS
STORMWATER MANAGEMENT DIVISION
6751 COLUMBIA GATEWAY DRIVE
COLUMBIA, MD 21046
PARCELS: 47, 81 TAX MAP: 35, 36
GRID/BLOCK: 0006
ZONING: P, NT, ELECTION DISTRICT 06


AS-BUILT CROSS SECTIONS

SCALE: HOR: 1" = 10'
VERT: 1" = 5'
DATE: APRIL 2017
KCI JOB NO.: 17133314.83
CAPITAL PROJECT NO.: D-1158
PERMIT ISSUE:
CONSTRUCTION ISSUE:

CS-04

SHEET NO.: 4 OF 27

936 RIDGEBROOK ROAD
SPARKS, MARYLAND 21152
TELEPHONE: (410) 316-7800
FAX: (410) 316-7818
www.kci.com

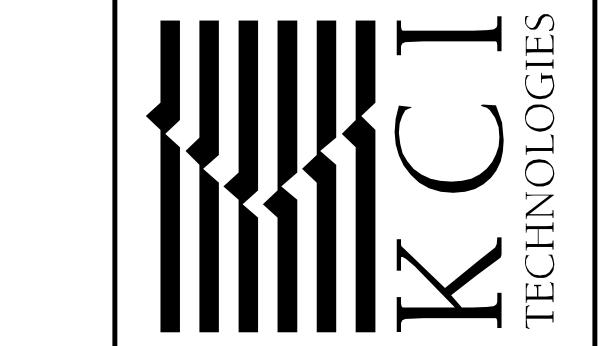

FILE: M:\2013\17133314.83\

www.kci.com





TECHNOLOGIES



936 RIDGEBROOK ROAD
SPARKS, MARYLAND 21152
TELEPHONE: (410) 316-7800
FAX: (410) 316-7818
www.kci.com

AS-BUILT CROSS SECTIONS

SCALE: HOR: 1" - 10'
DATE: APRIL 2017
VERT: 1" - 5'
KCI JOB NO.: 17133314.83
CAPITAL PROJECT: D-1158
STORMWATER MANAGEMENT DIVISION
HOWARD COUNTY DEPARTMENT OF PUBLIC WORKS
6751 COLUMBIA GATEWAY DRIVE
COLUMBIA, MD 21046
PARCELS: 47, 81, TAX MAP: 35, 36
ELECTION DISTRICT: 06
GRID BLOCK: 0006
ZONING: P, R, NT
FILE: M:\2013\17133314.83\

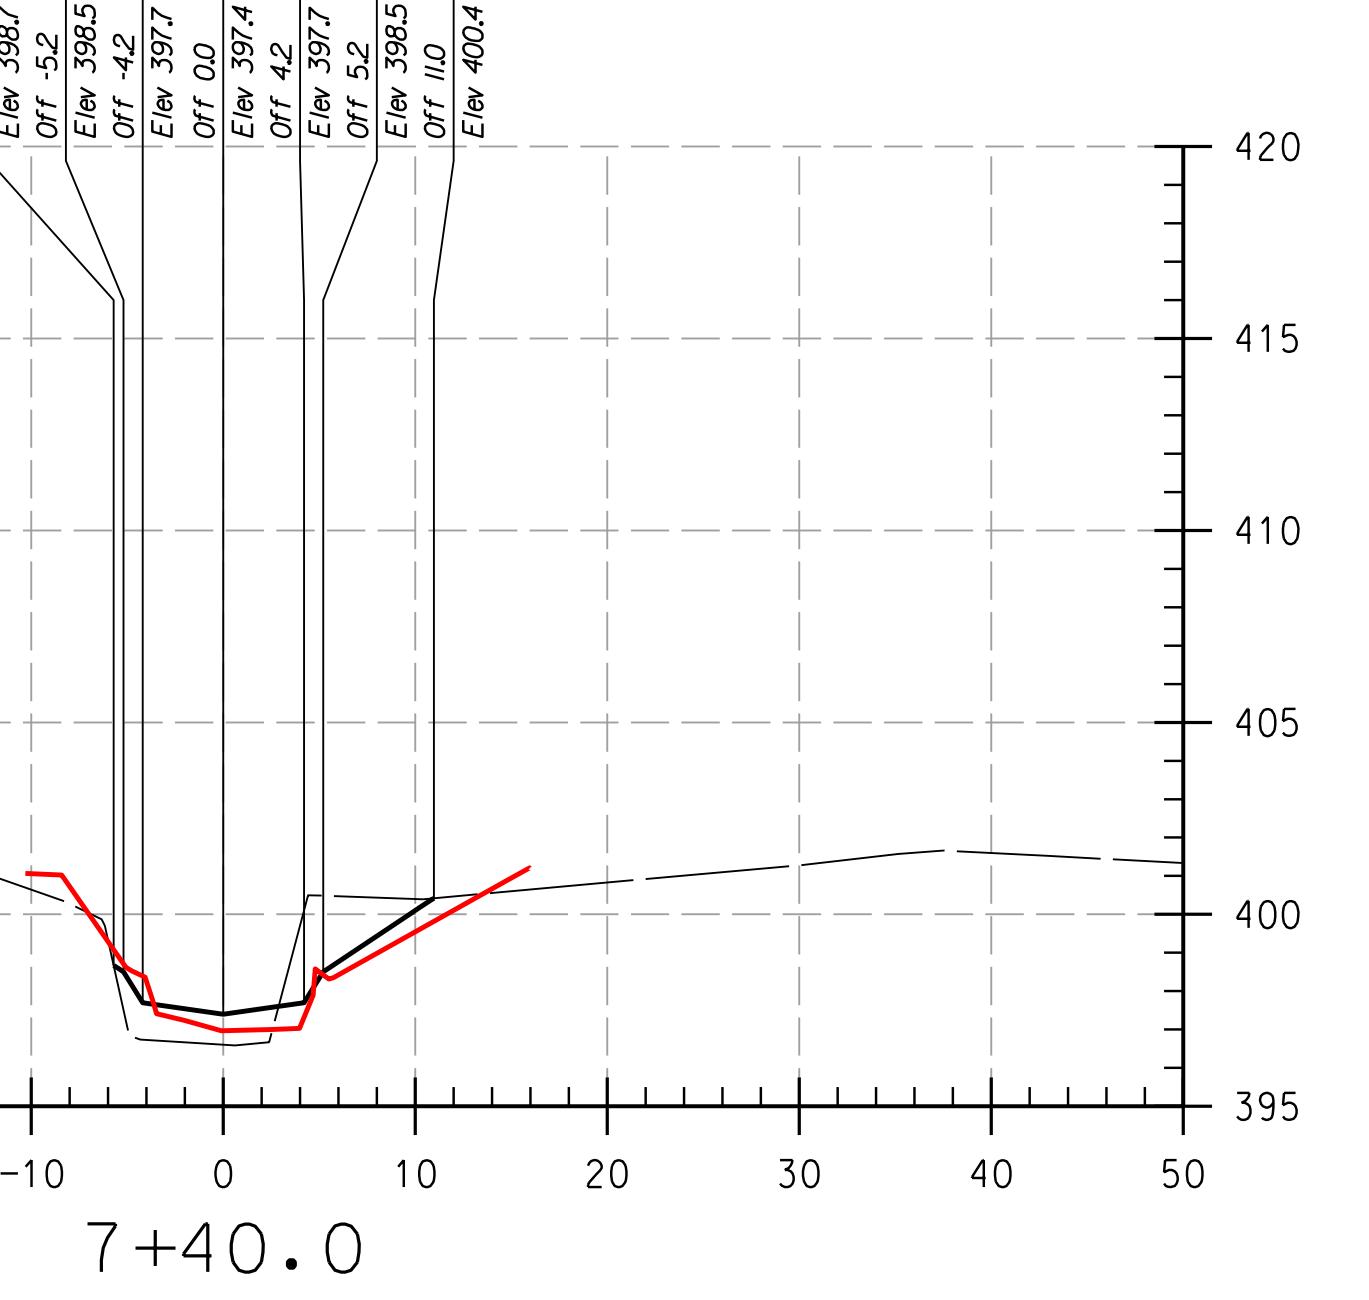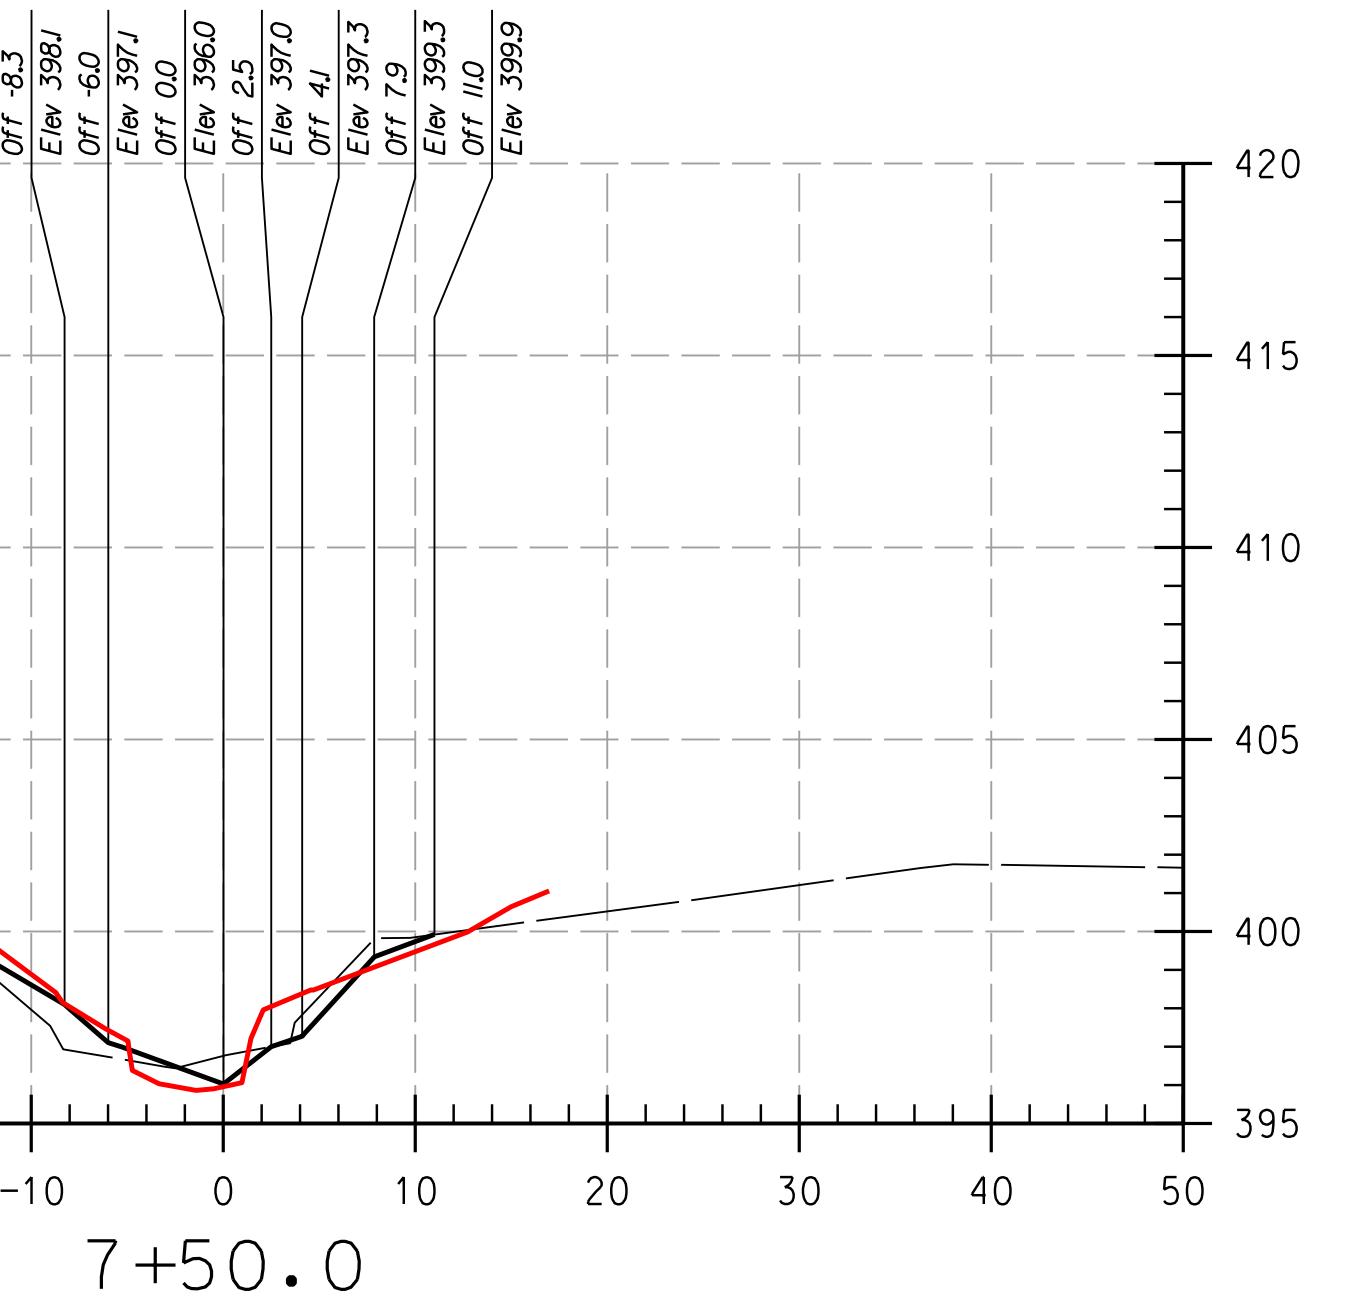

REACH 2

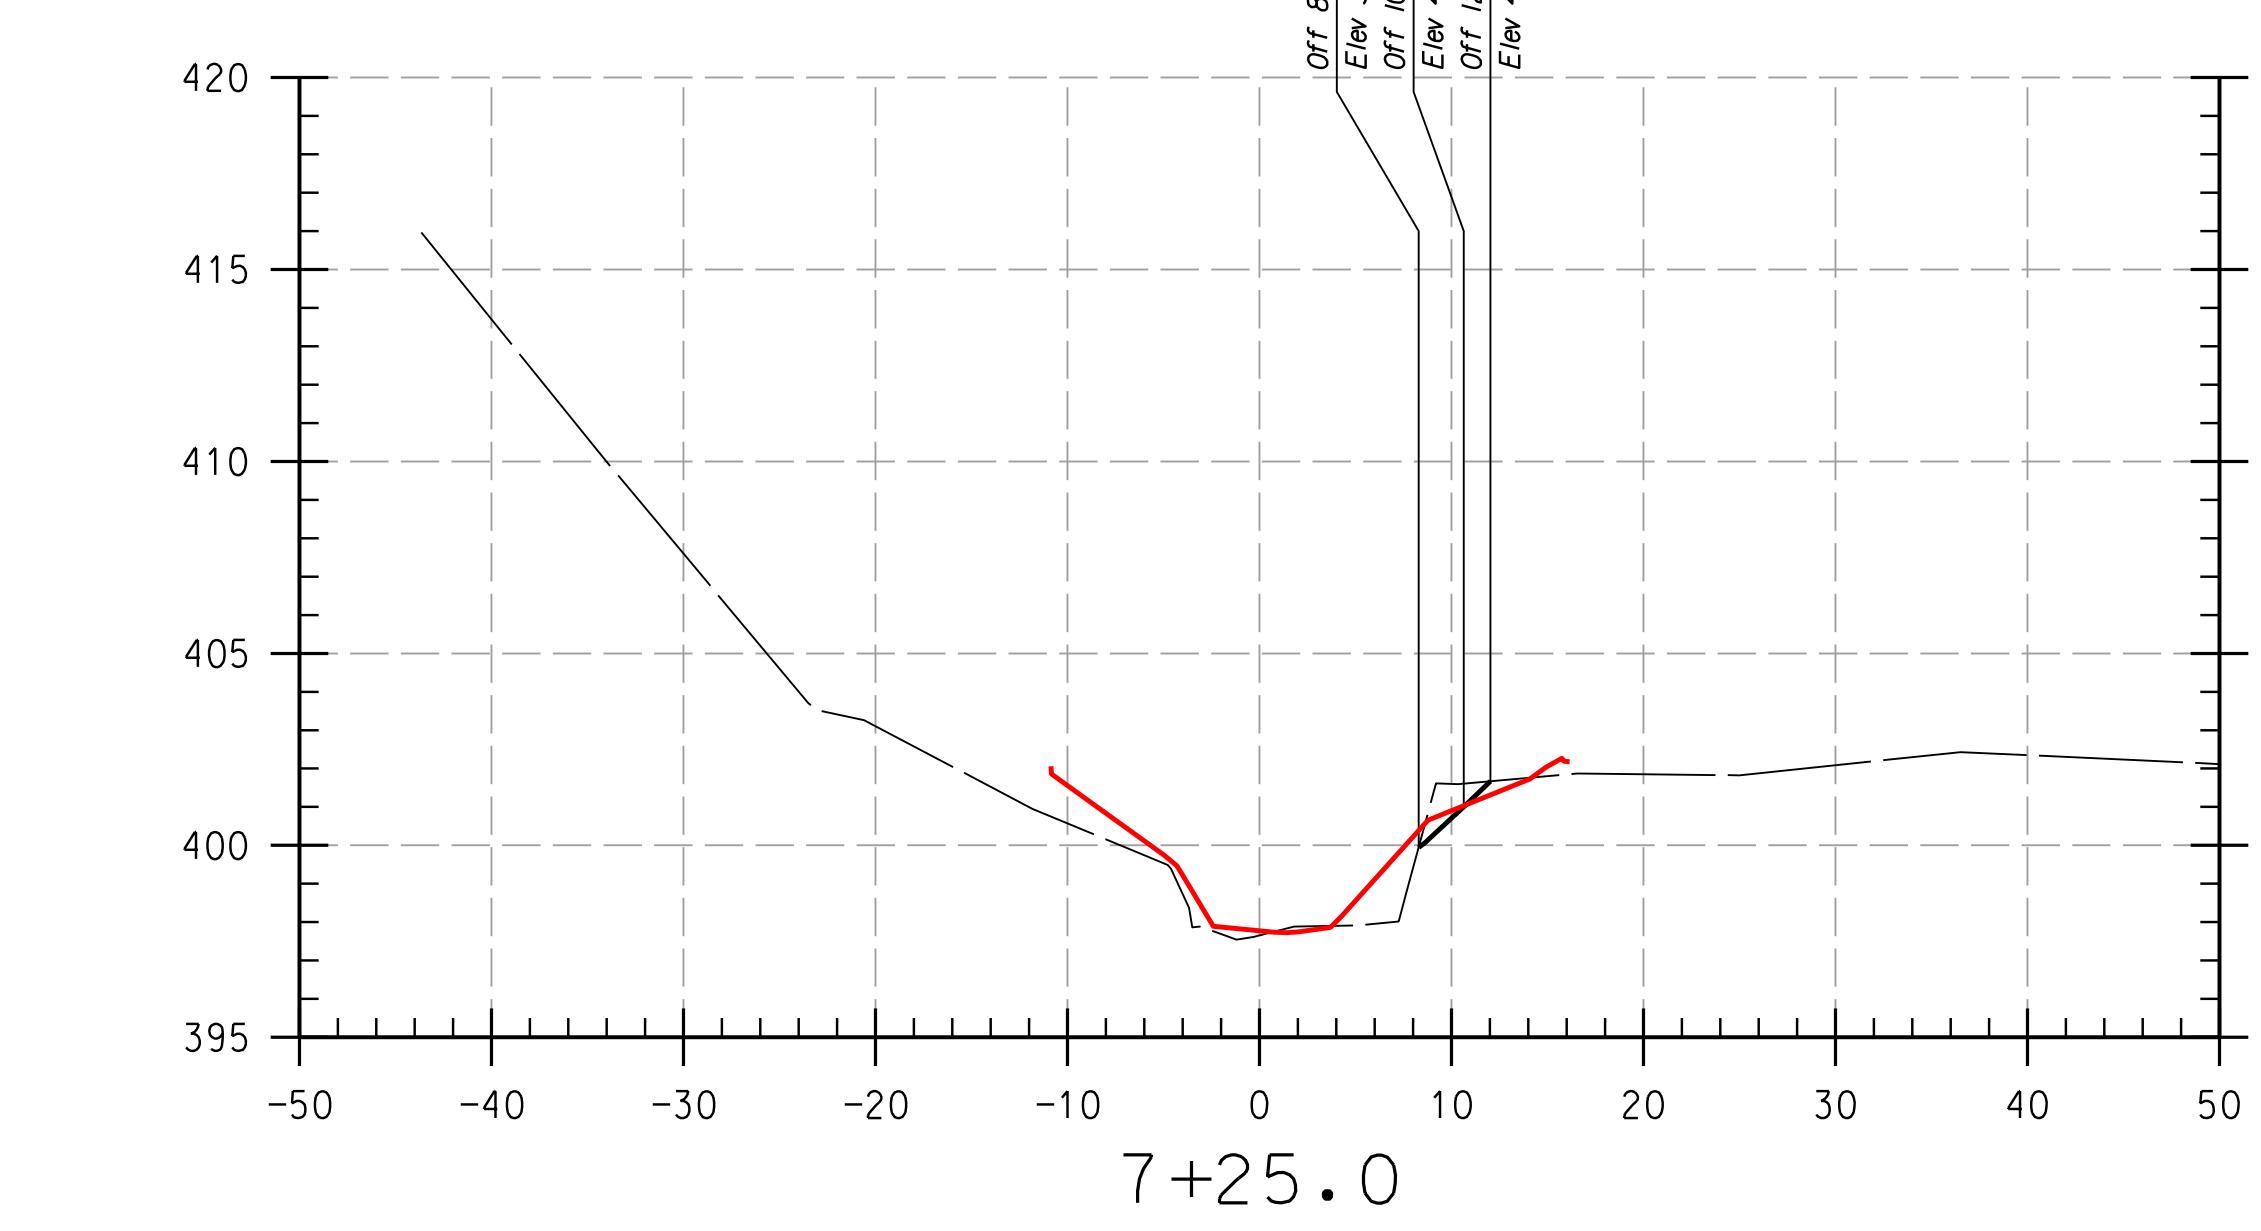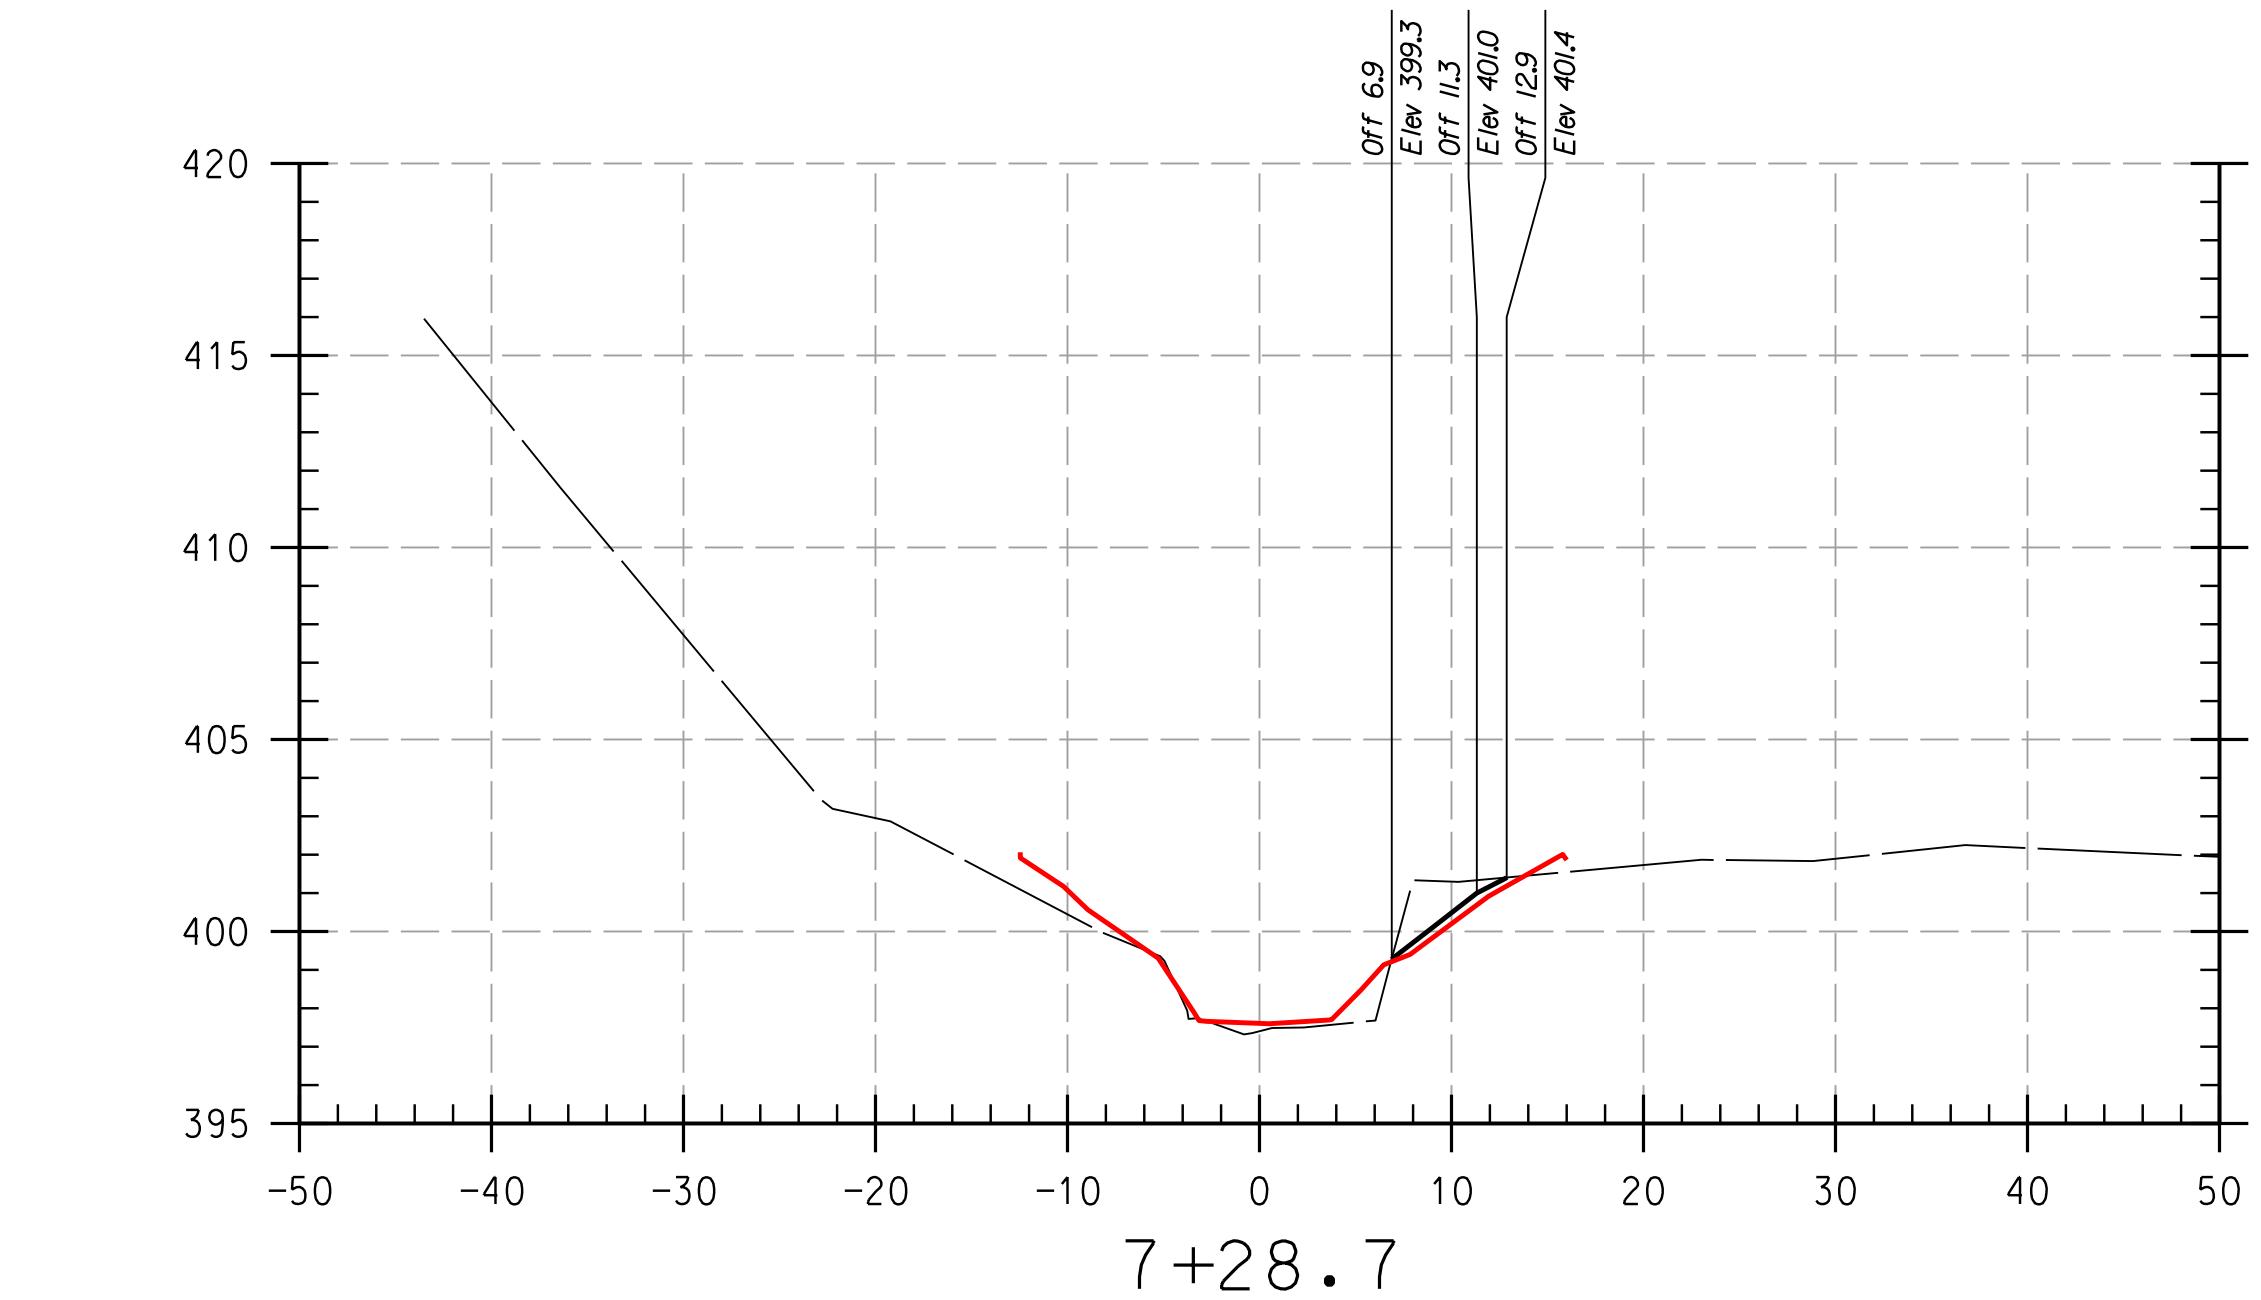

LEGEND	
EXISTING GRADE	—
PROPOSED GRADE	—
AS-BUILT GRADE	—

NOTES:
UTILITIES SHOWN ON THESE PLANS HAVE BEEN LOCATED
USING THE INFORMATION PROVIDED BY THE CONTRACTOR.
THE CONTRACTOR IS TO EXERCISE EXTREME CAUTION WHEN
EXCAVATING NEAR ANY UTILITIES TEST PIT IF REQUIRED.

PROFESSIONAL CERTIFICATION: I HEREBY
CERTIFY THAT THESE DOCUMENTS WERE
PREPARED OR APPROVED BY ME AND THAT
I AM A DULY LICENSED PROFESSIONAL
ENGINEER UNDER THE LAWS OF THE STATE
OF MARYLAND, LICENSE NO. 3831,
EXPIRATION DATE: JANUARY 06, 2018

THIS DEVELOPMENT IS APPROVED FOR SOIL EROSION AND SEDIMENT CONTROL
BY THE HOWARD SOIL CONSERVATION DISTRICT.

HOWARD SCD







DATE

DEPARTMENT OF PUBLIC WORKS, HOWARD COUNTY, MD
CHIEF, BUREAU OF ENVIRONMENTAL SERVICES

DATE

CS-07

SHEET NO.: 7 OF 27

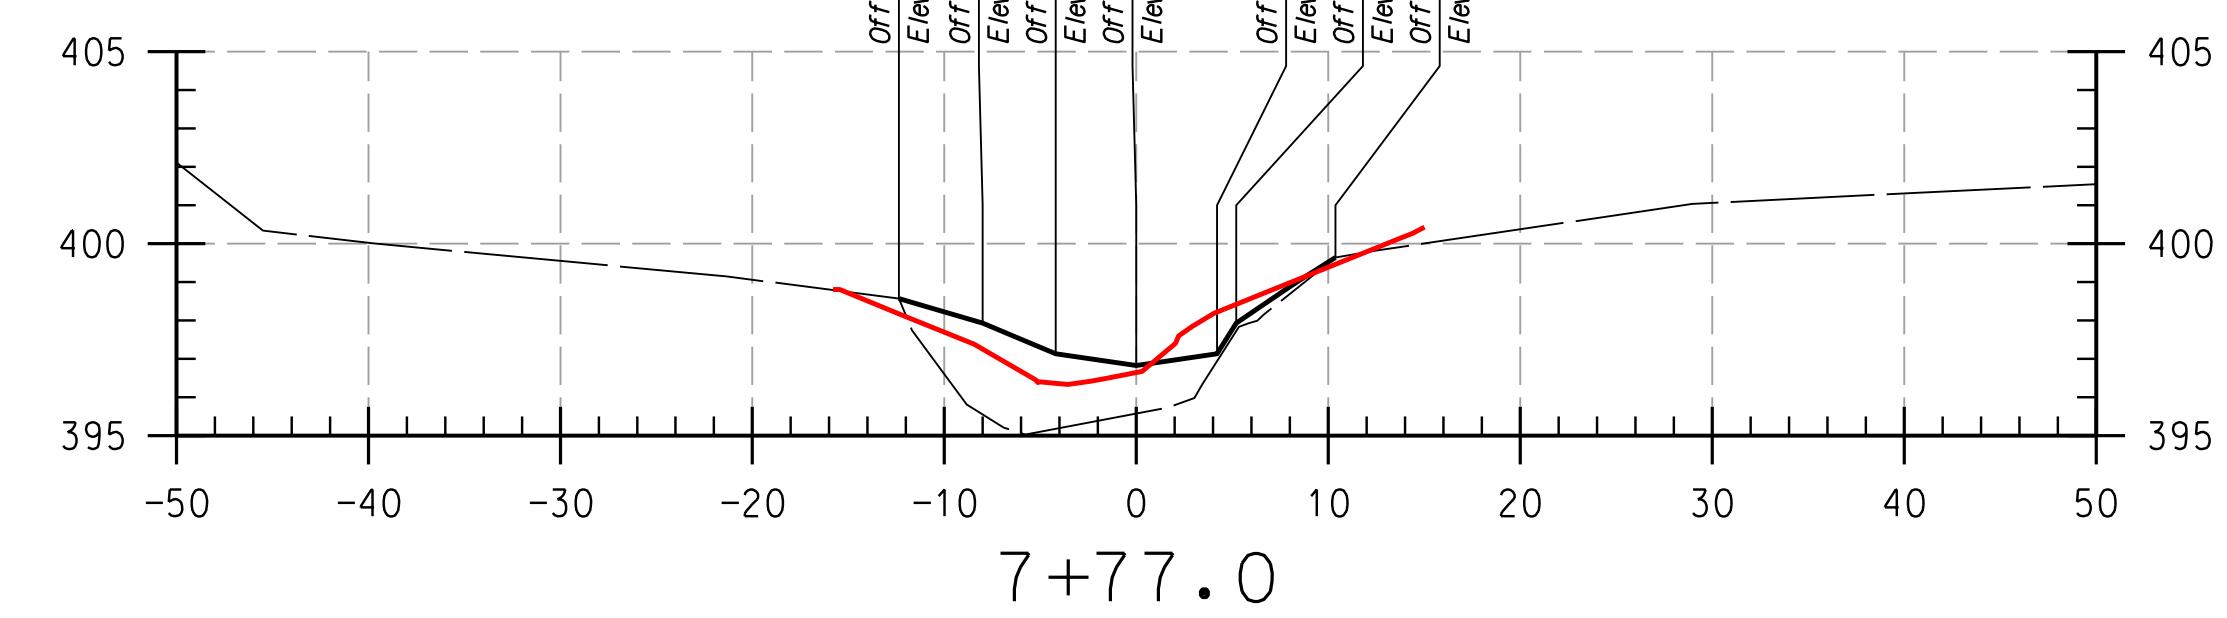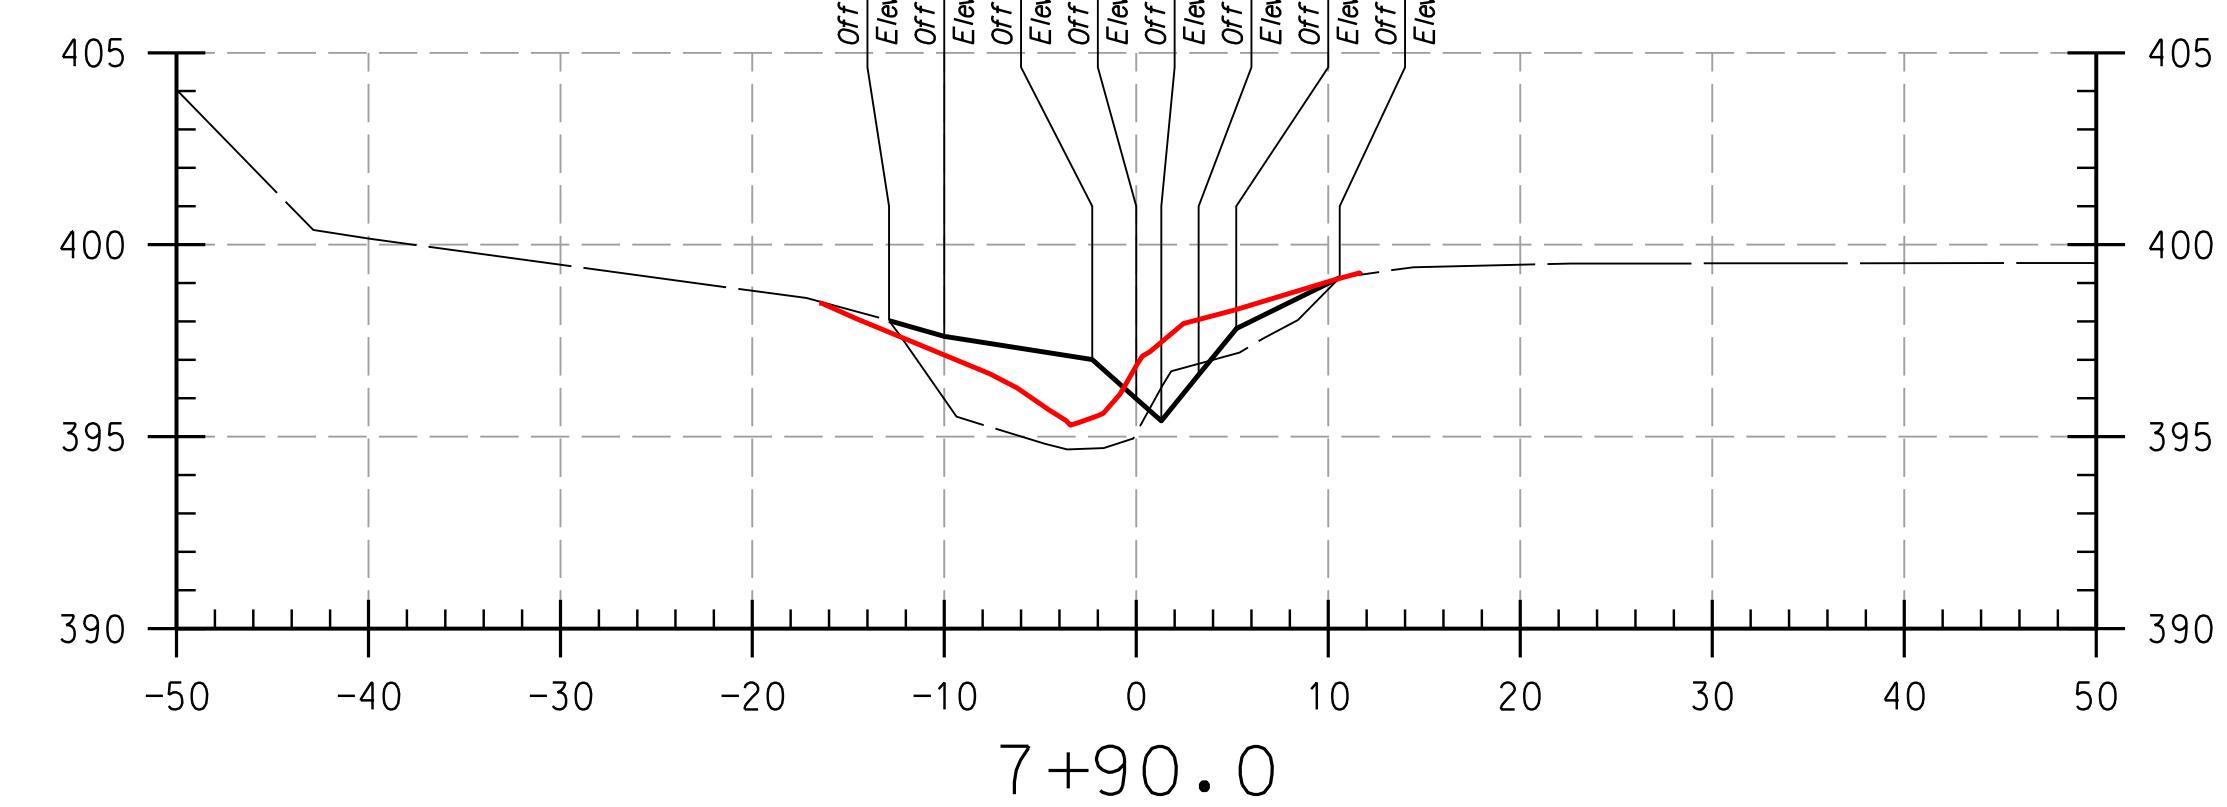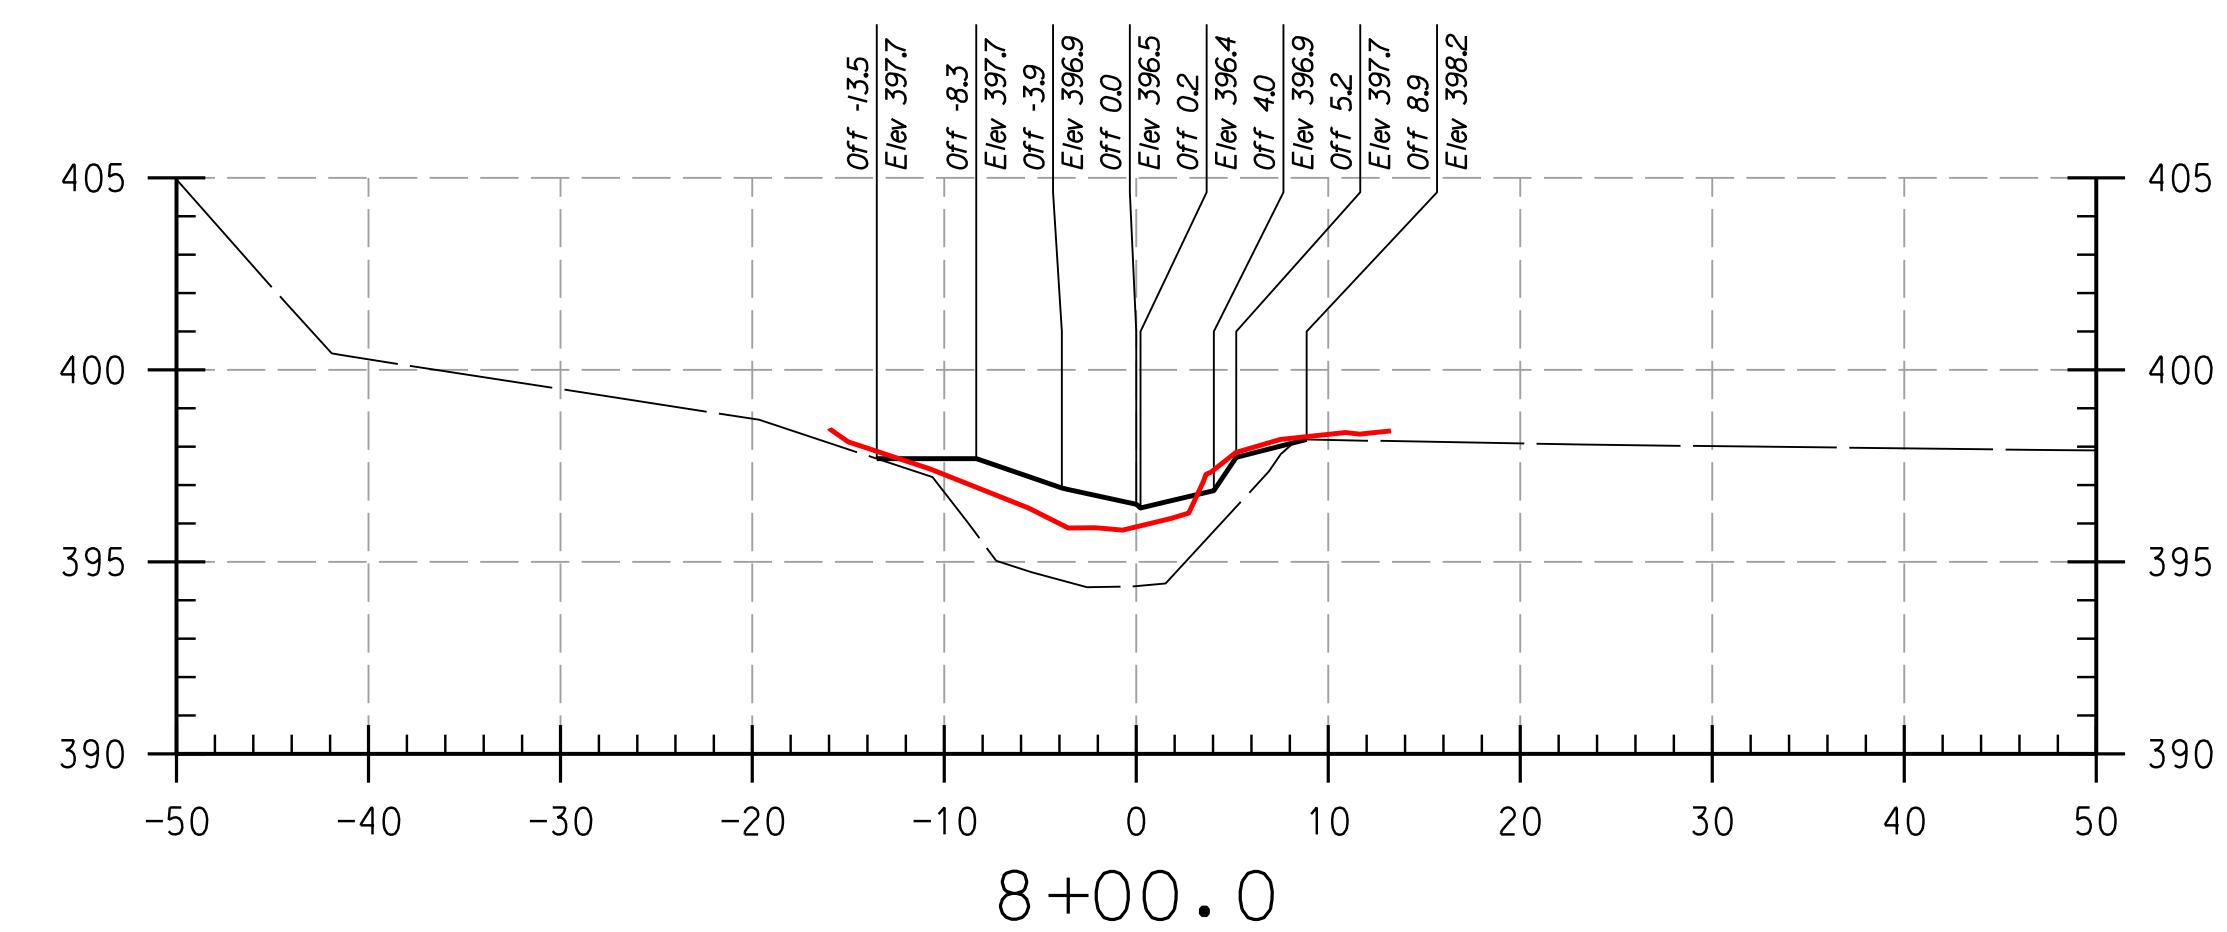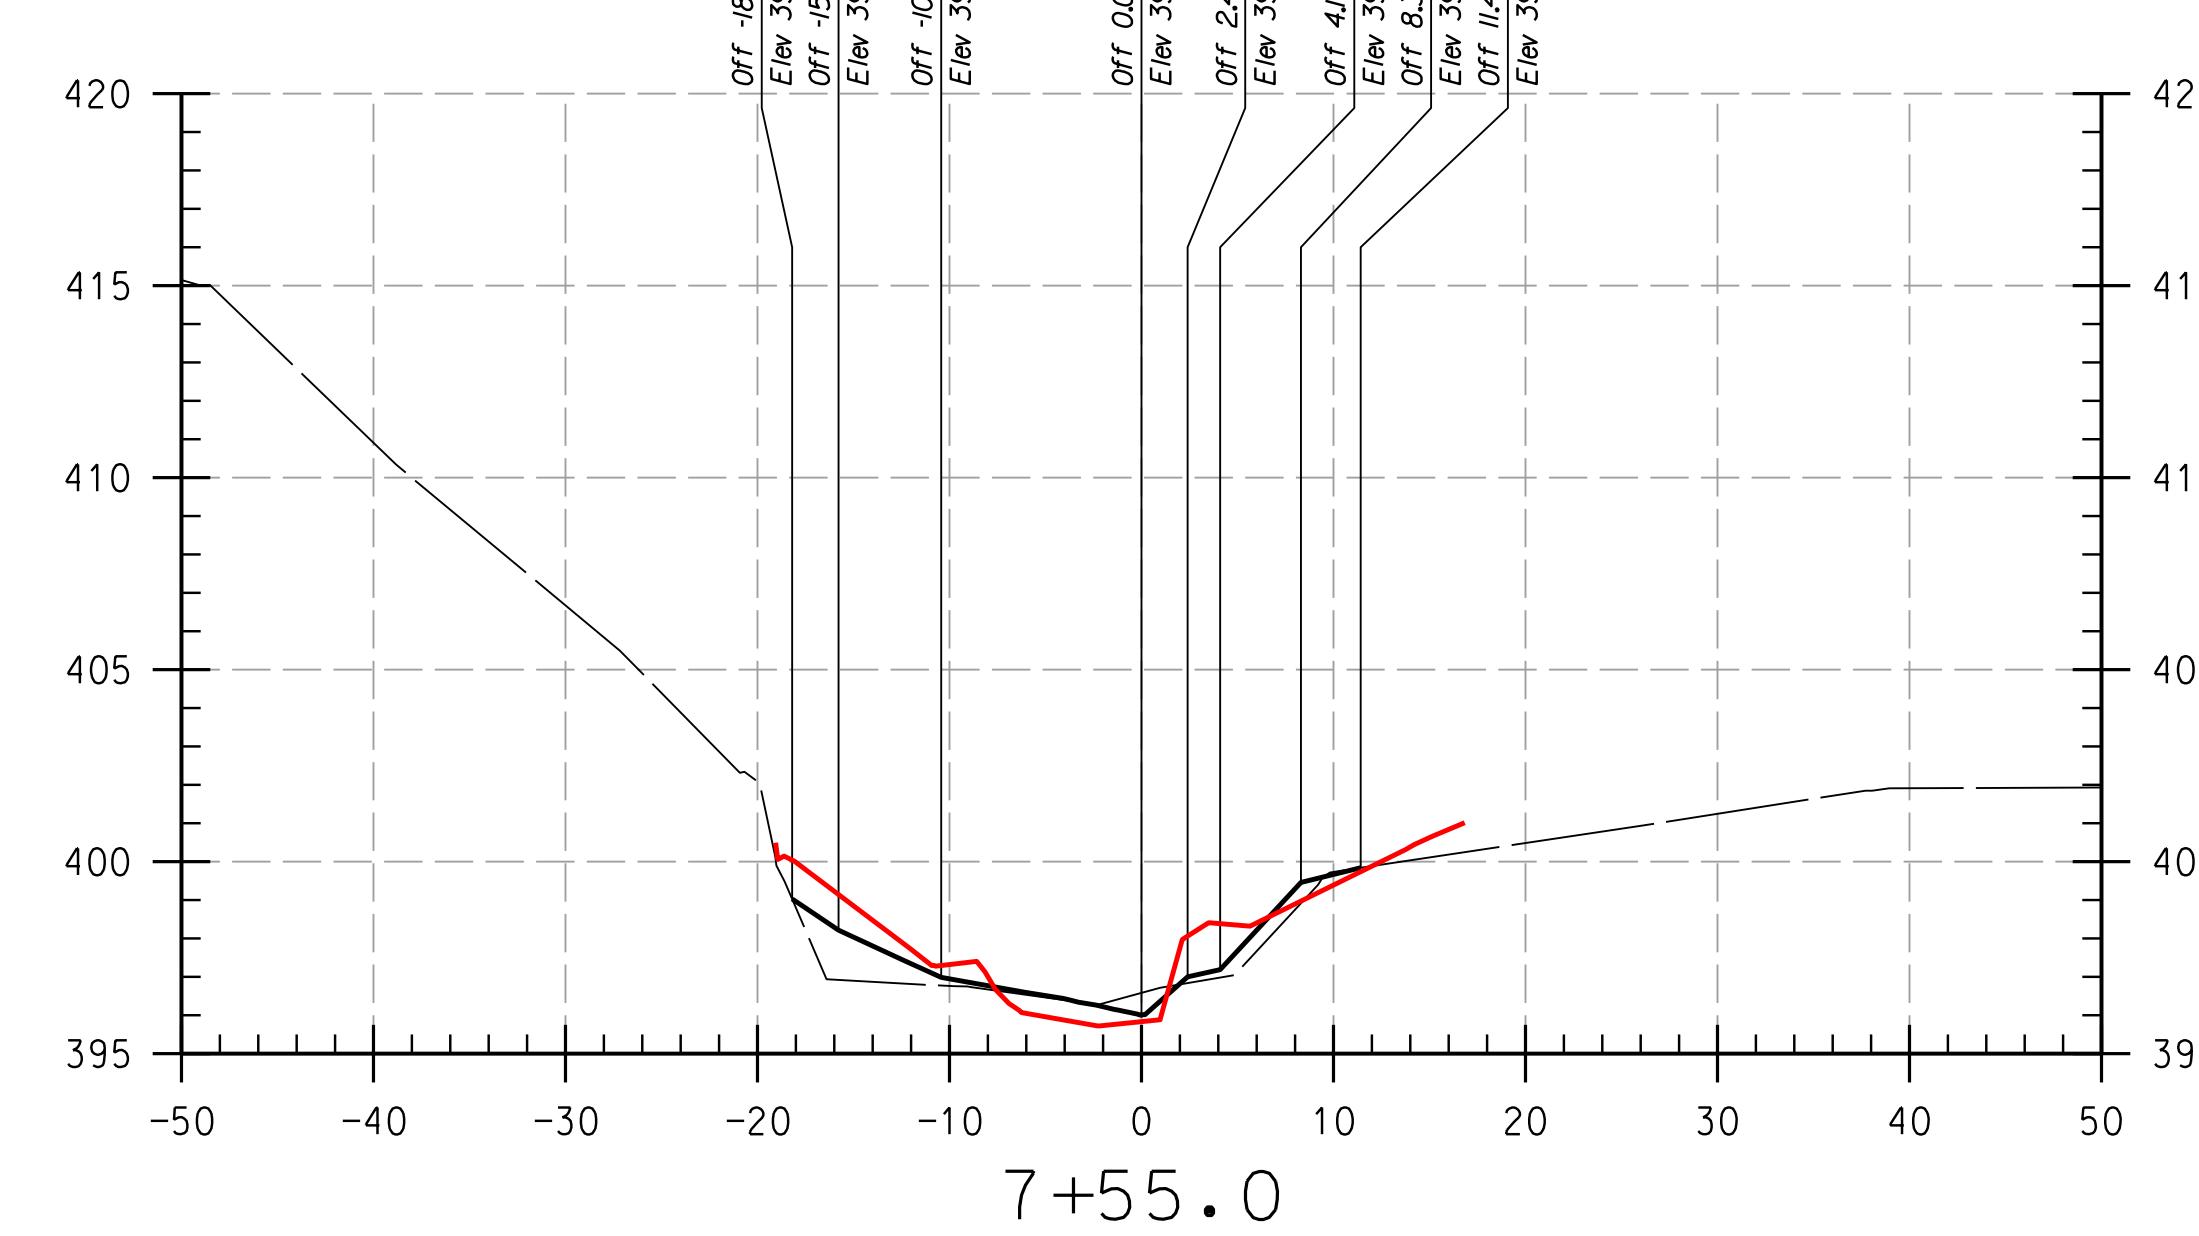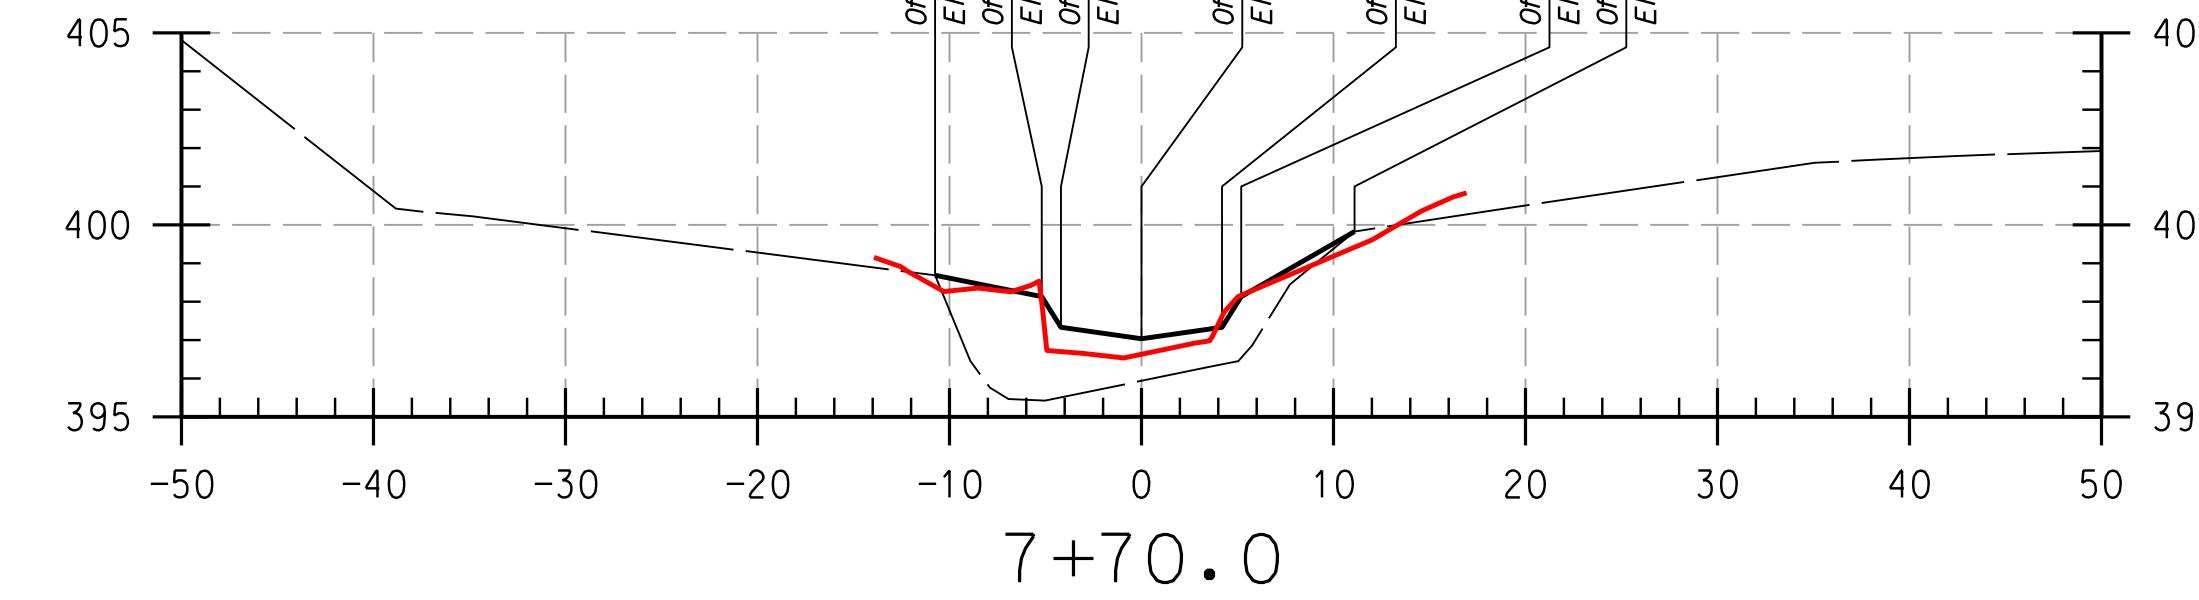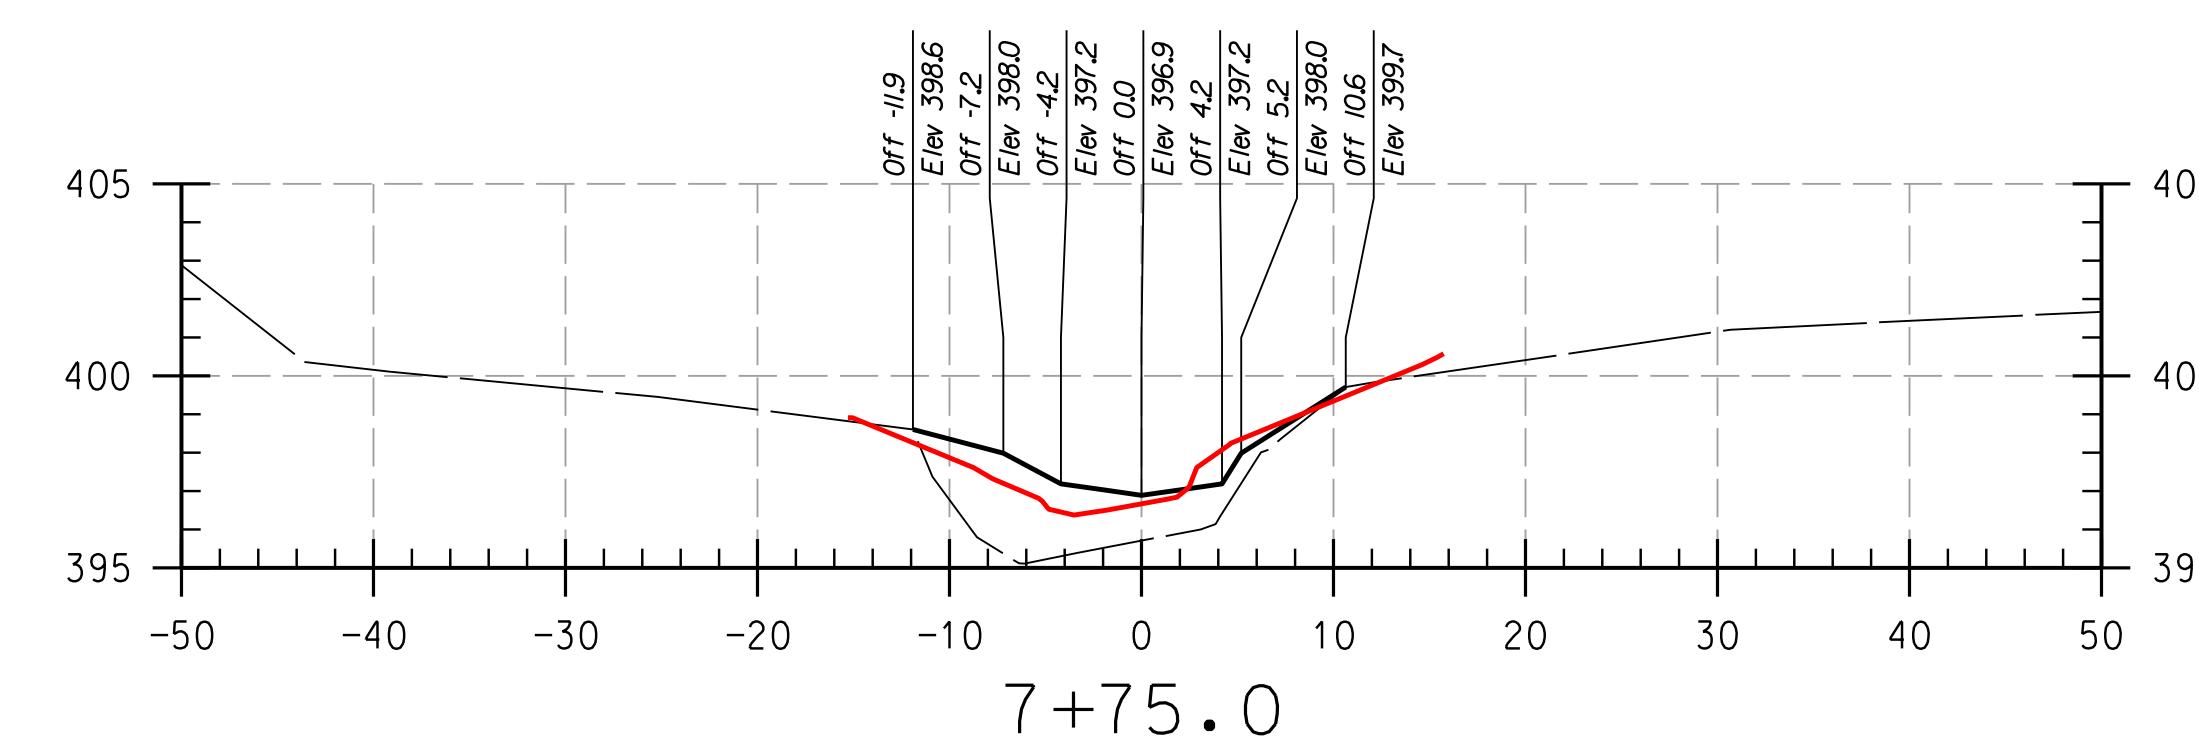

REACH 2

LEGEND

NOTE:
UTILITIES SHOWN ON THESE PLANS HAVE BEEN
USING THE BEST AVAILABLE INFORMATION. HOWE
CONTRACTOR IS TO EXERCISE EXTREME CAUTION
EXCAVATING NEAR ANY UTILITIES TEST PIT IF







PROFESSIONAL CERTIFICATION. I HEREBY CERTIFY THAT THESE DOCUMENTS WERE PREPARED OR APPROVED BY ME, AND THAT I AM A DULY LICENSED PROFESSIONAL ENGINEER UNDER THE LAWS OF THE STATE OF MARYLAND. LICENSE NO. 38311.
EXPIRATION DATE: JANUARY 06 2018

AT THIS DEVELOPMENT IS APPROVED FOR SOIL EROSION AND SEDIMENT CONTROL BY THE HOWARD SOIL CONSERVATION DISTRICT.

DEPARTMENT OF PUBLIC WORKS, HOWARD COUNTY, MD

SCALE:	HOR: 1" = 10'
	VERT: 1" = 5'
DATE:	APRIL 2017
KCI JOB NO.:	17133314.83
CAPITAL PROJECT NO.:	D-1158
PERMIT ISSUE:	

CS-08

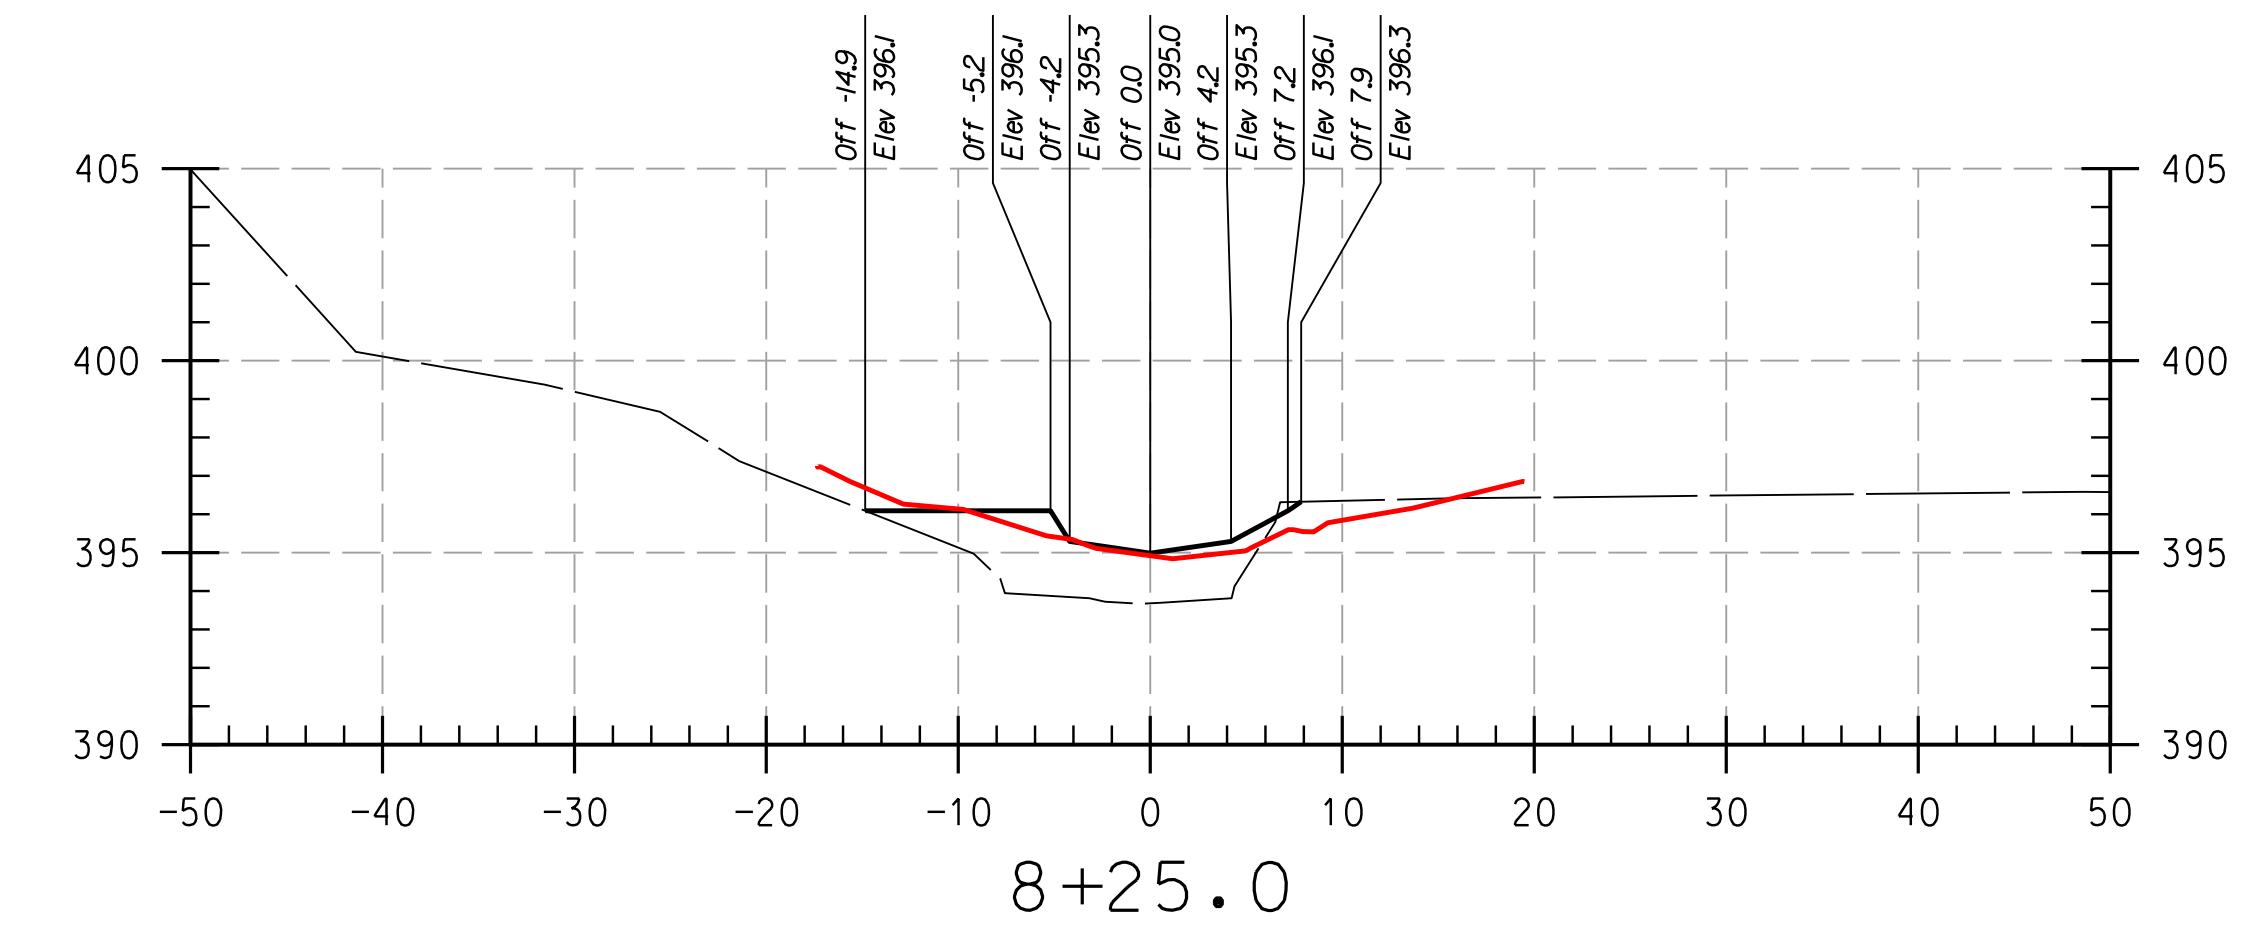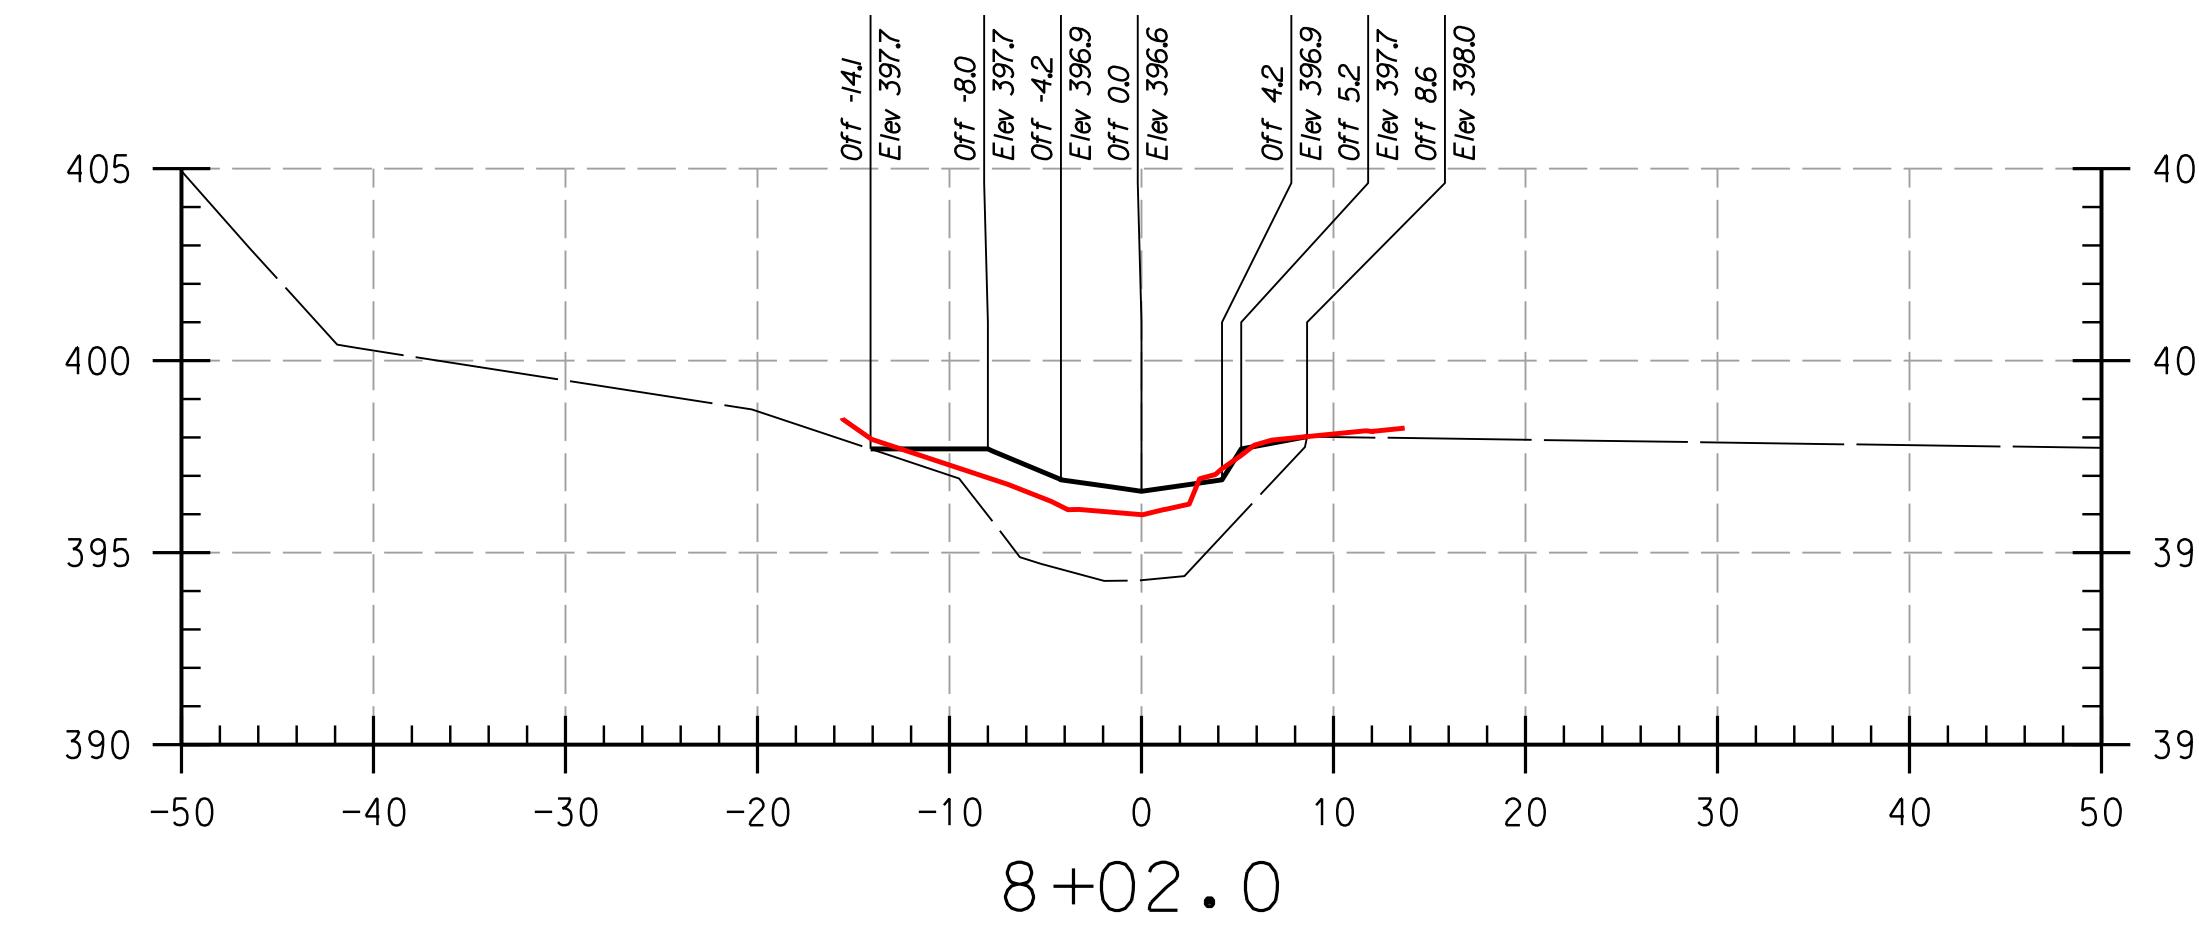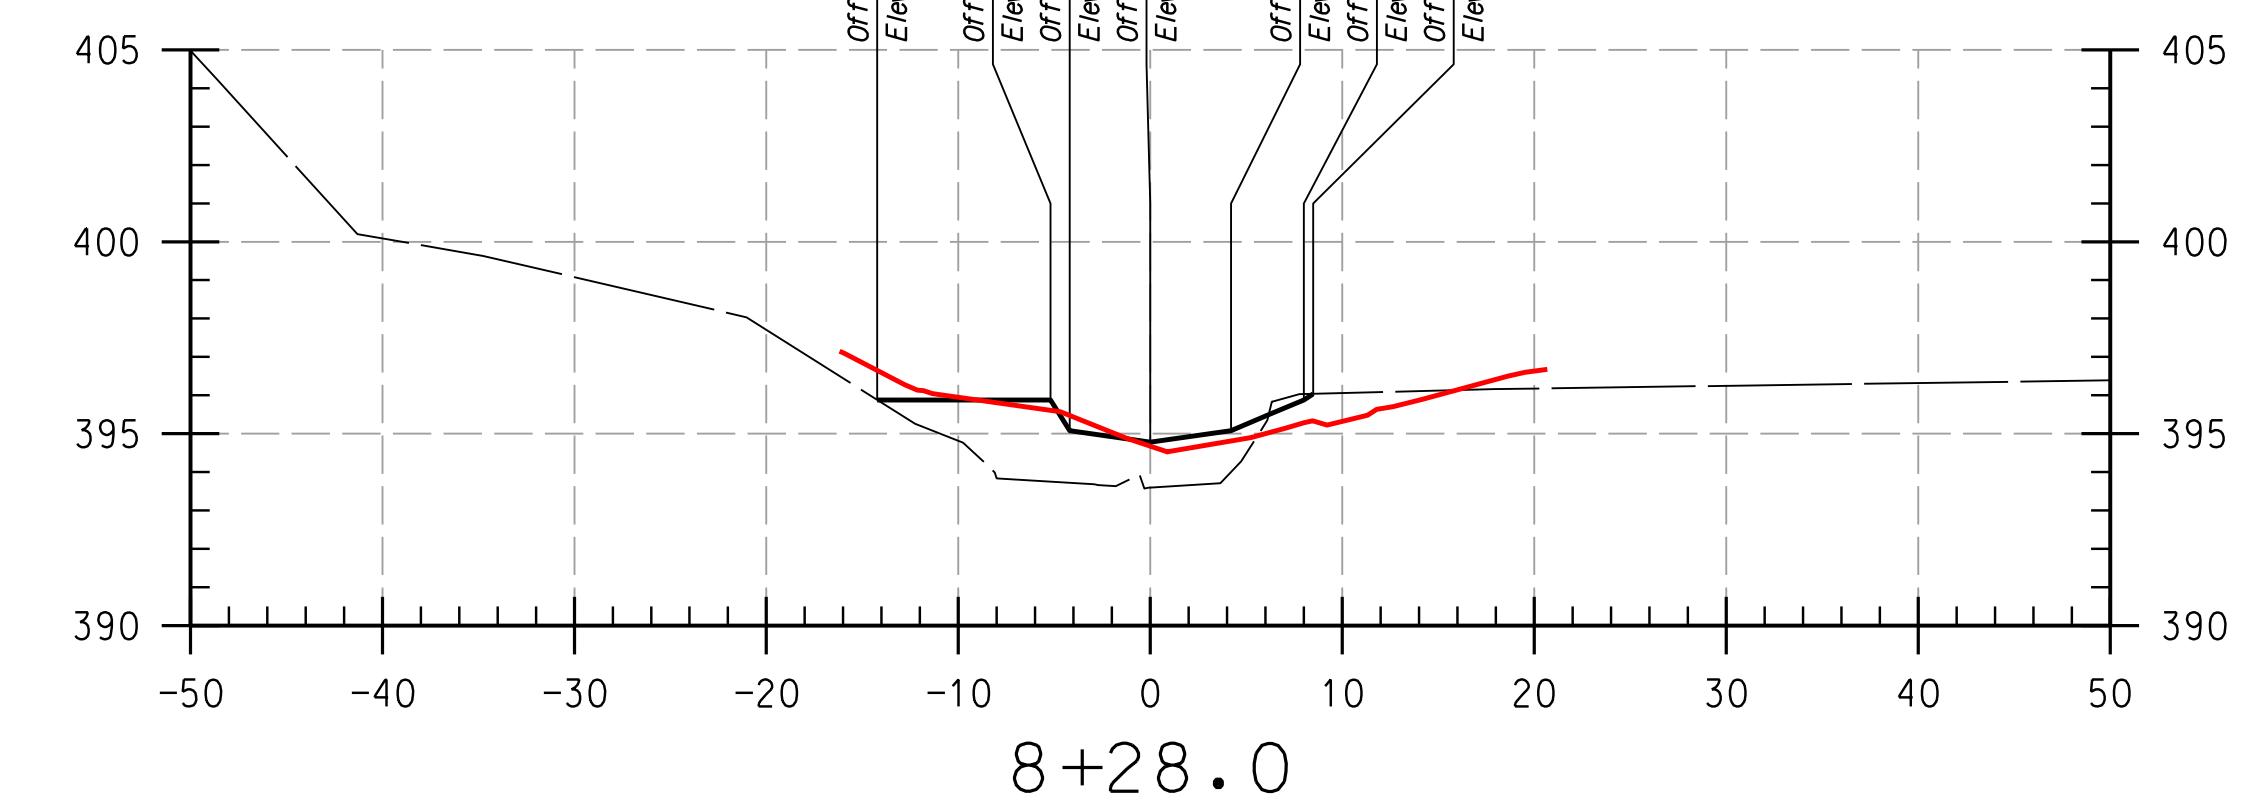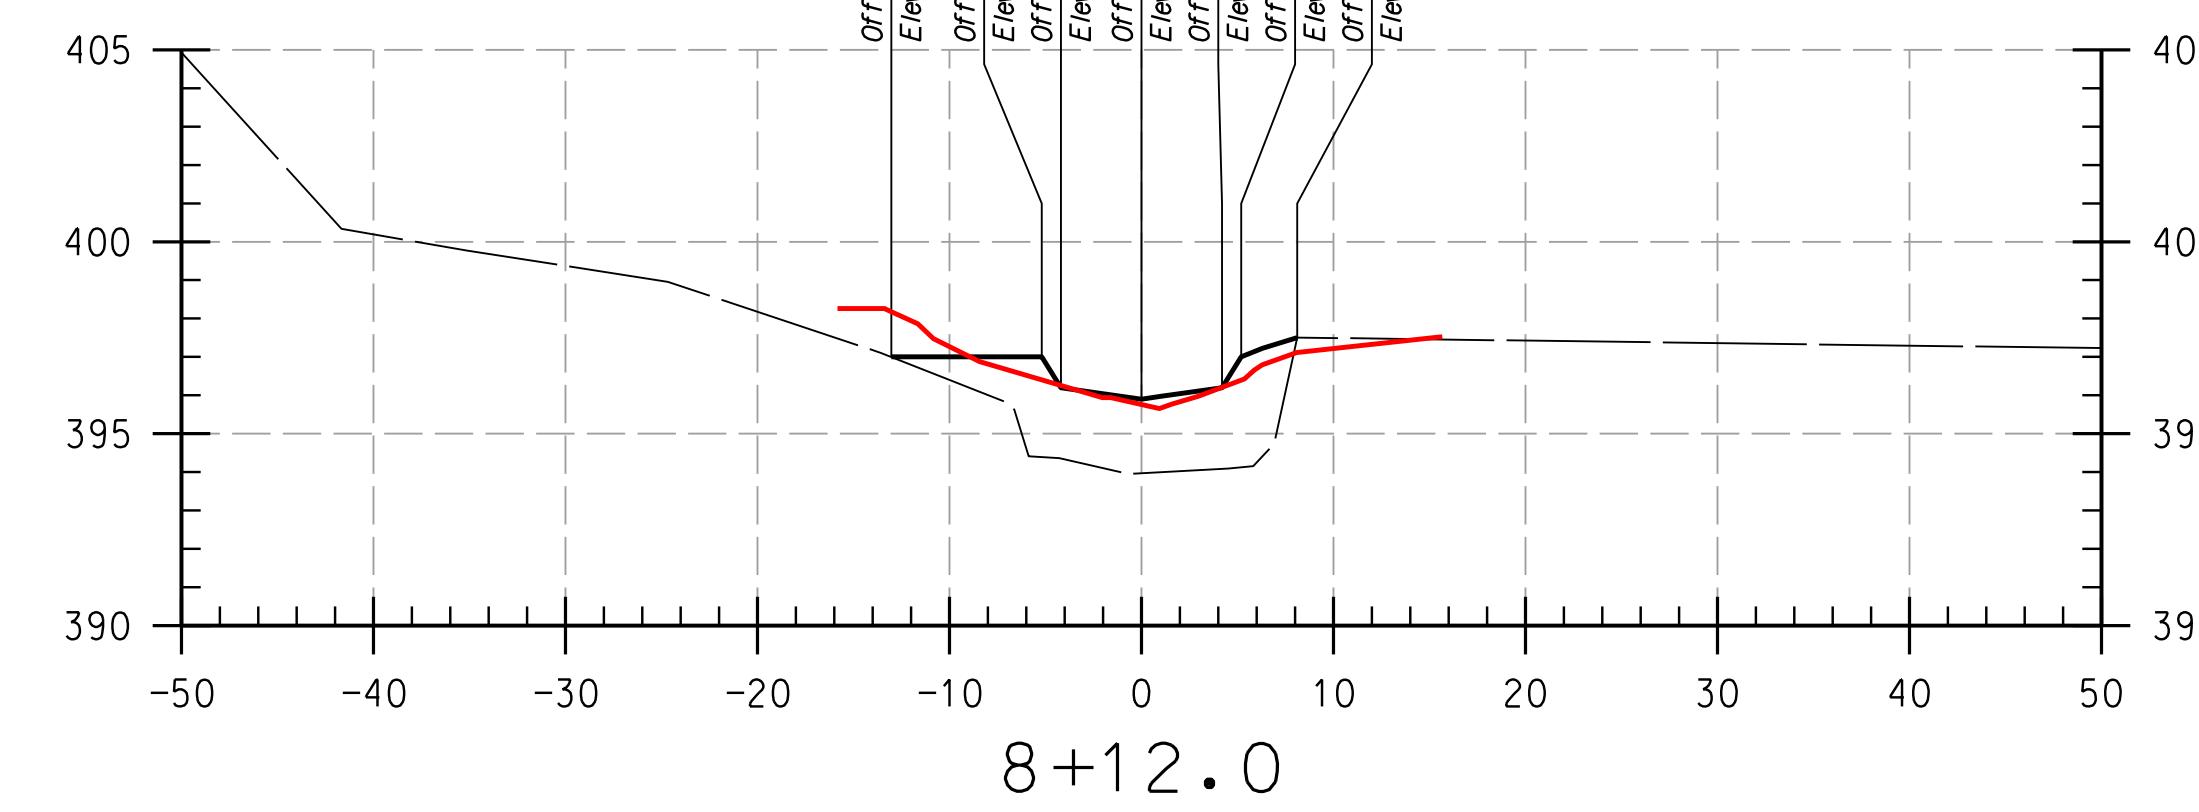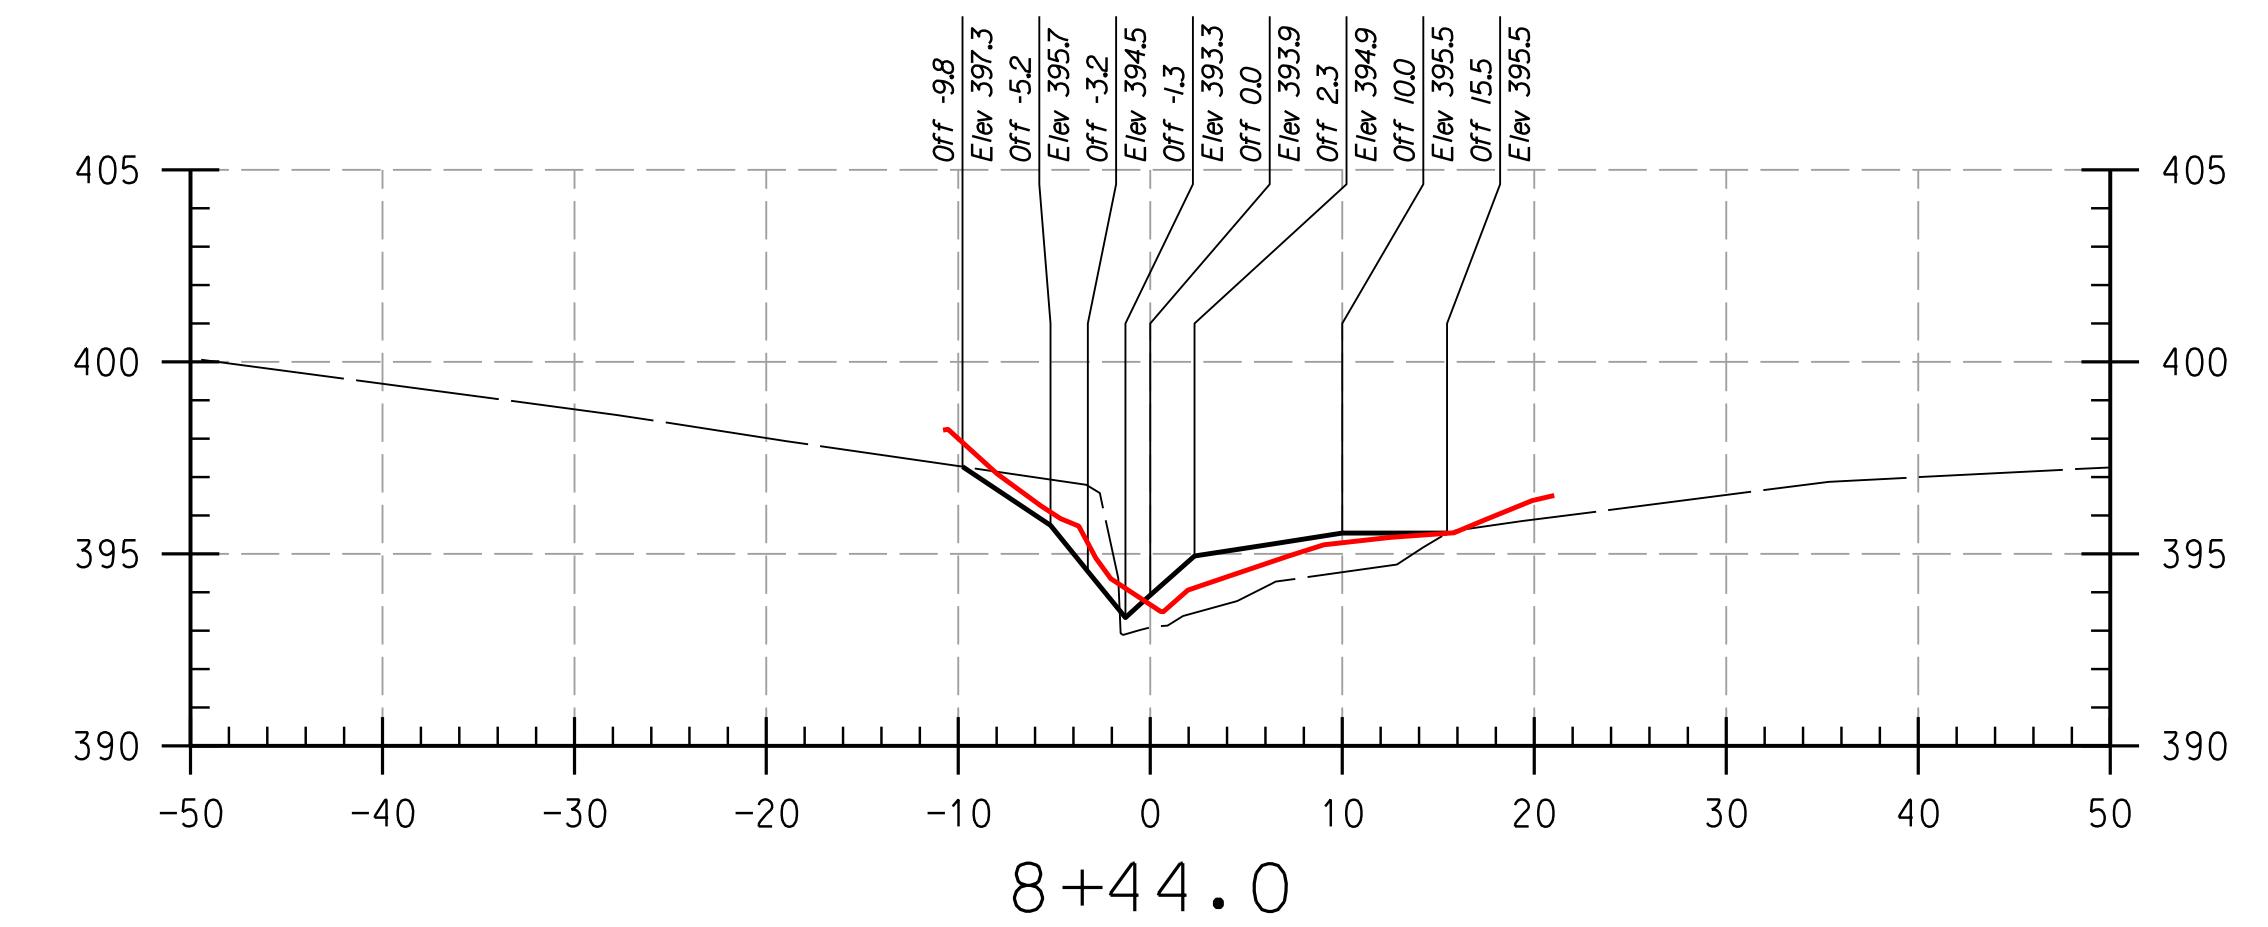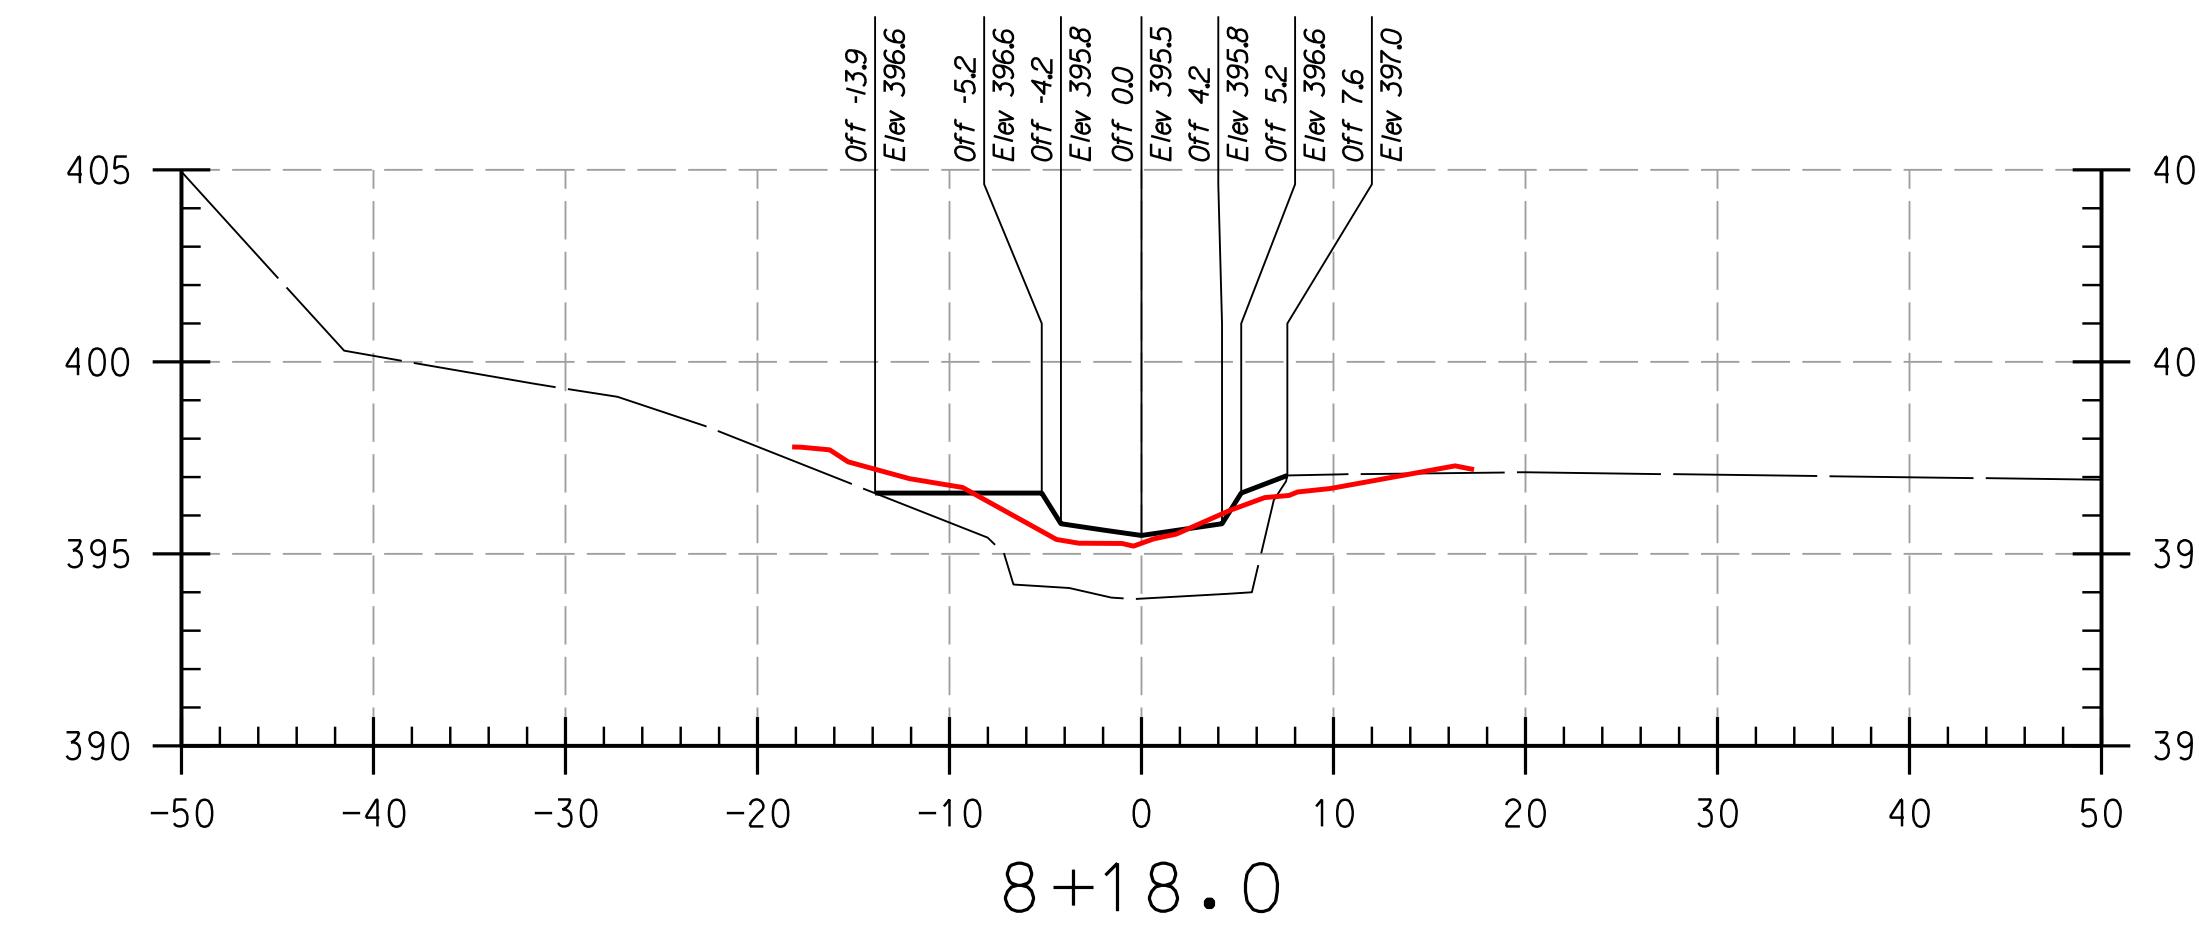

REACH 2

LEGEND

NOTE:
UTILITIES SHOWN ON THESE PLANS HAVE BEEN
USING THE BEST AVAILABLE INFORMATION. HOW-
EVER, CONTRACTOR IS TO EXERCISE EXTREME CAUTION
EXCAVATING NEAR ANY UTILITIES. TEST PIT IF

PROFESSIONAL CERTIFICATION. I HEREBY CERTIFY THAT THESE DOCUMENTS WERE PREPARED OR APPROVED BY ME, AND THAT I AM A DULY LICENSED PROFESSIONAL ENGINEER UNDER THE LAWS OF THE STATE OF MARYLAND. LICENSE NO. 38311, EXPIRATION DATE: JANUARY 06, 2018

THIS DEVELOPMENT IS APPROVED FOR SOIL EROSION AND SEDIMENT CONTROL BY THE HOWARD SOIL CONSERVATION DISTRICT.

DEPARTMENT OF PUBLIC WORKS, HOWARD COUNTY, MD

AS-BUILT CROSS SECTIONS

SCALE:	HOR: 1" = 10'
	VERT: 1" = 5'
DATE:	APRIL 2017
KCI JOB NO.:	17133314.83
CAPITAL PROJECT NO.:	D-1158
PERMIT ISSUE:	
CONSTRUCTION ISSUE	

CS 09

SHEET NO. 6 OF 6





K C I

HOWARD COMMUNITY COLLEGE
STREAM RESTORATION PROJECT
CAPITAL PROJECT D-1158

HOWARD COUNTY DEPARTMENT OF PUBLIC WORKS
STORMWATER MANAGEMENT DIVISION
6751 COLUMBIA GATEWAY DRIVE
COLUMBIA, MD 21046

PARCELS 47, 81 TAX MAP 35, 36
ELECTION DISTRICT 05 GRIDBLOCK 01
ING POR, NT

PLOTTED: "12:28 PM on Monday, April 24, 2017"
BY: Division:
FILE: C:\CADD_Files\Howard CC\pXS-P001_Howard CC As-Built.dgn

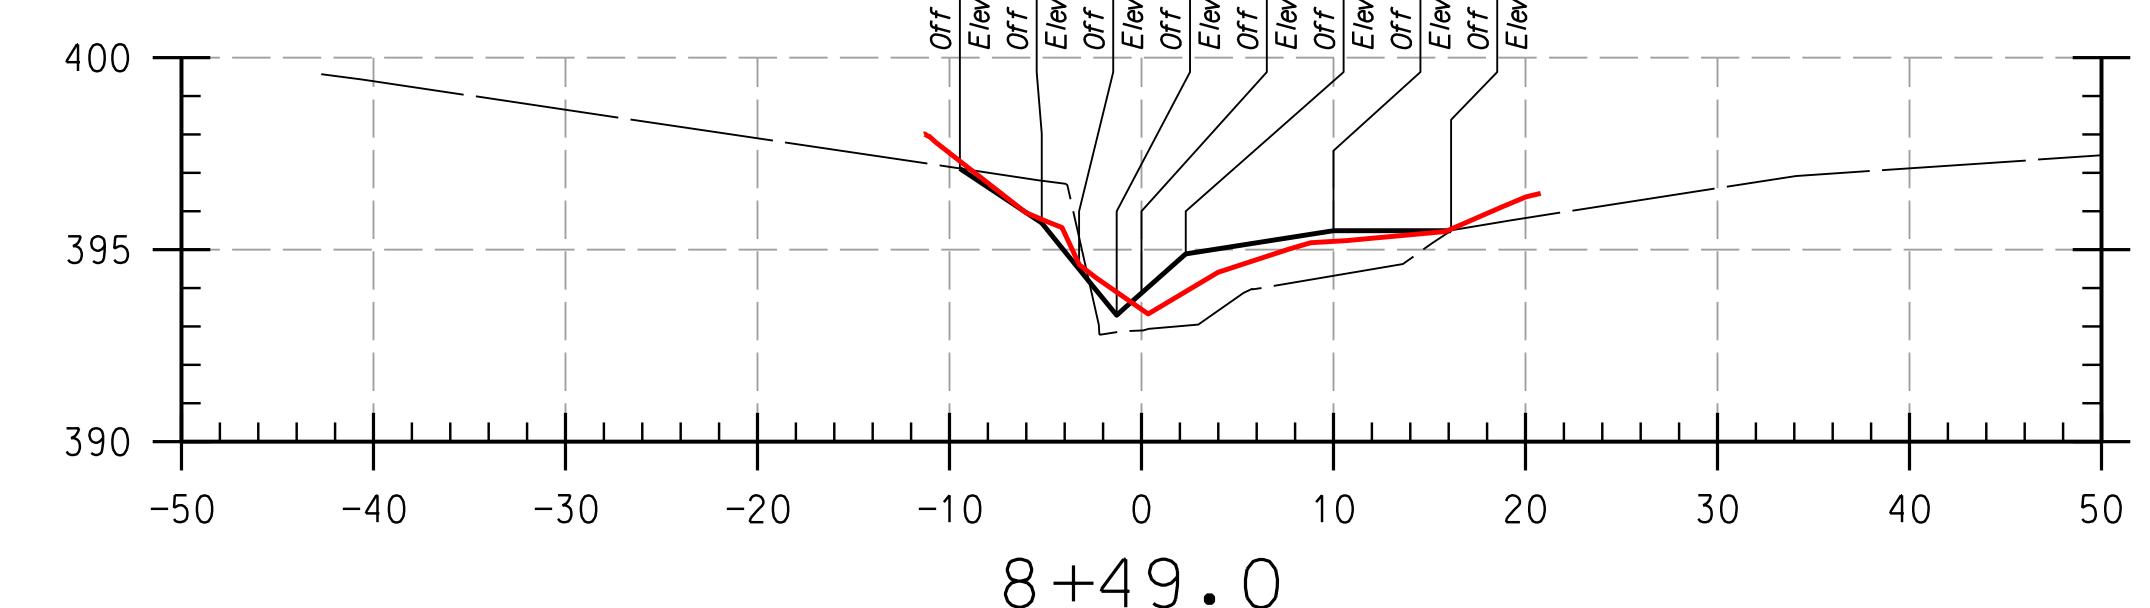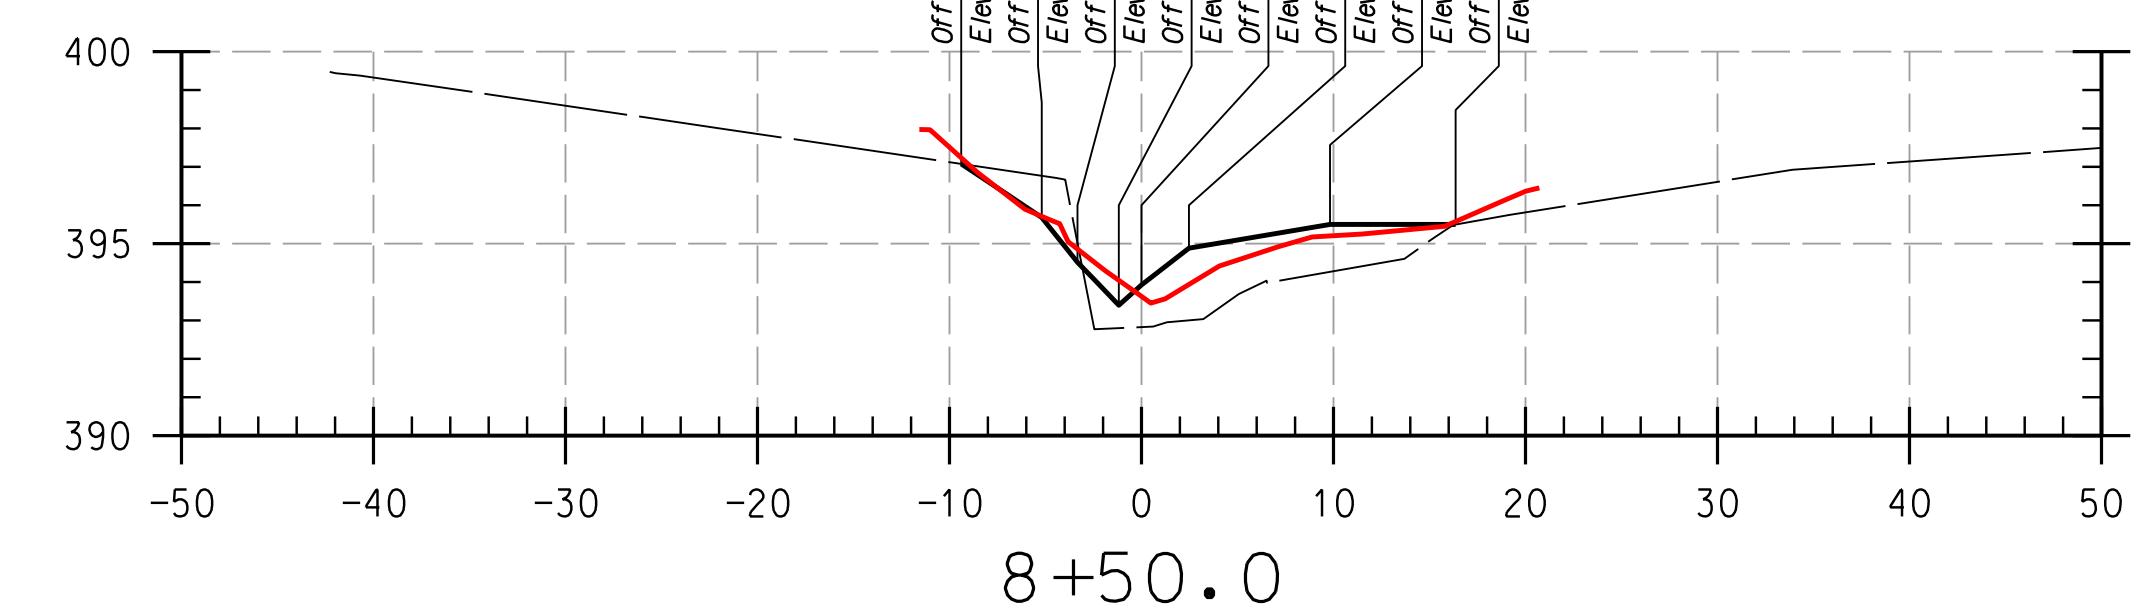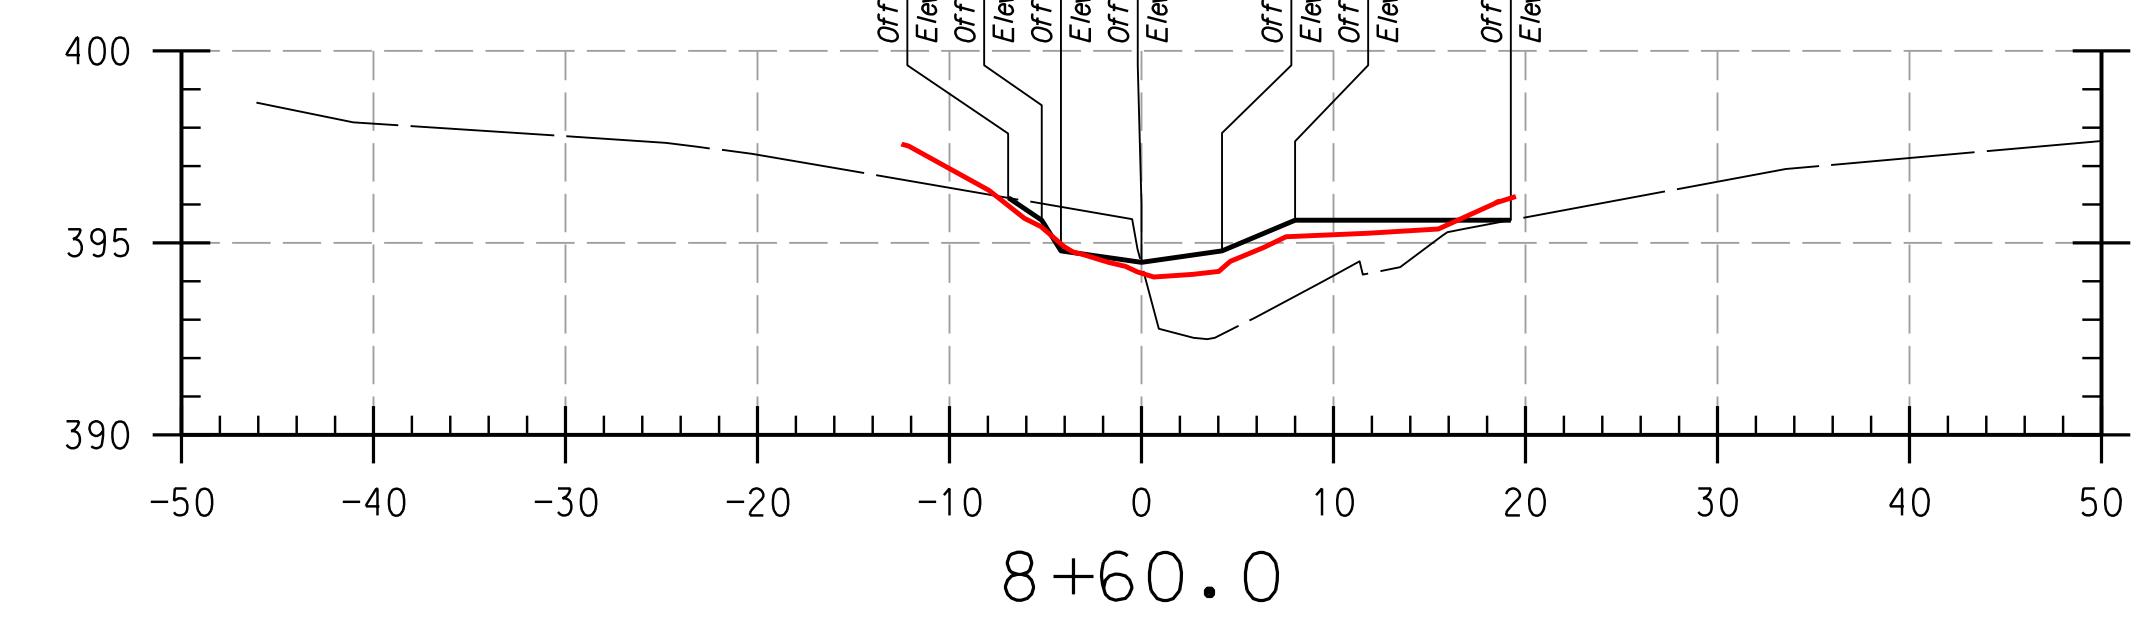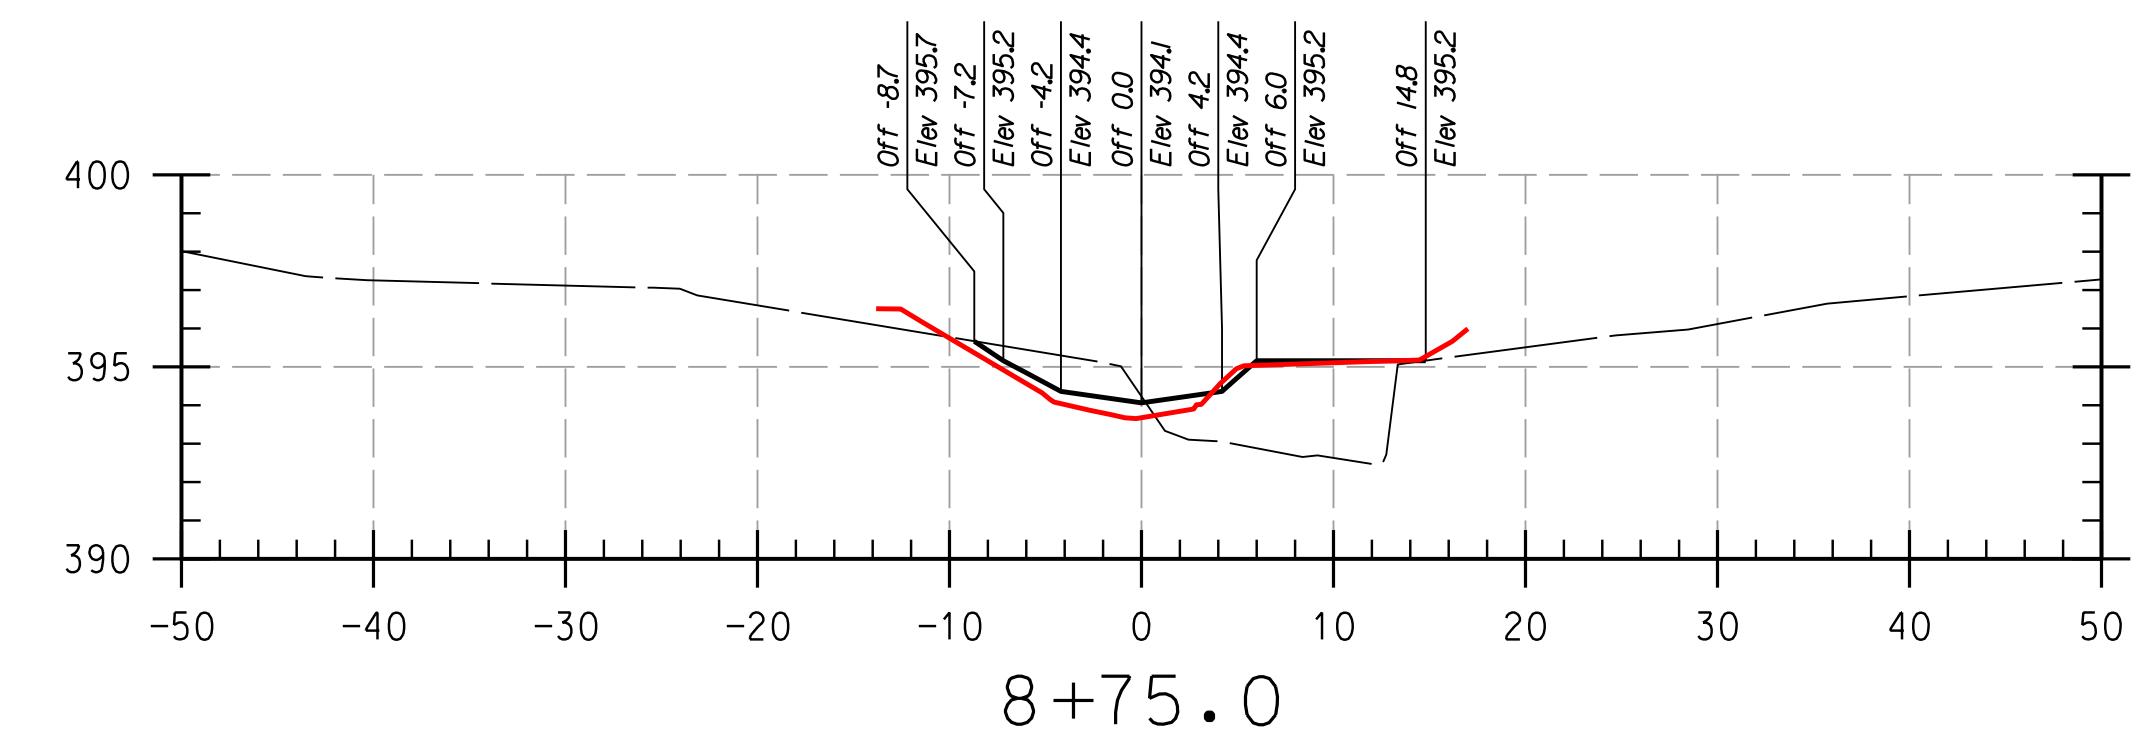

REACH 2

LEGEND





NOTE:
UTILITIES SHOWN ON THESE PLANS HAVE BEEN
USING THE BEST AVAILABLE INFORMATION. THE
CONTRACTOR IS TO EXERCISE EXTREME CAUTION
EXCAVATING NEAR ANY UTILITIES. TEST PIT

14
HAT
ATE

THIS DEVELOPMENT IS APPROVED FOR SOIL EROSION AND SEDIMENT CONTROL BY THE HOWARD SOIL CONSERVATION DISTRICT.

1

DEPARTMENT OF PUBLIC WORKS, HOWARD COUNTY

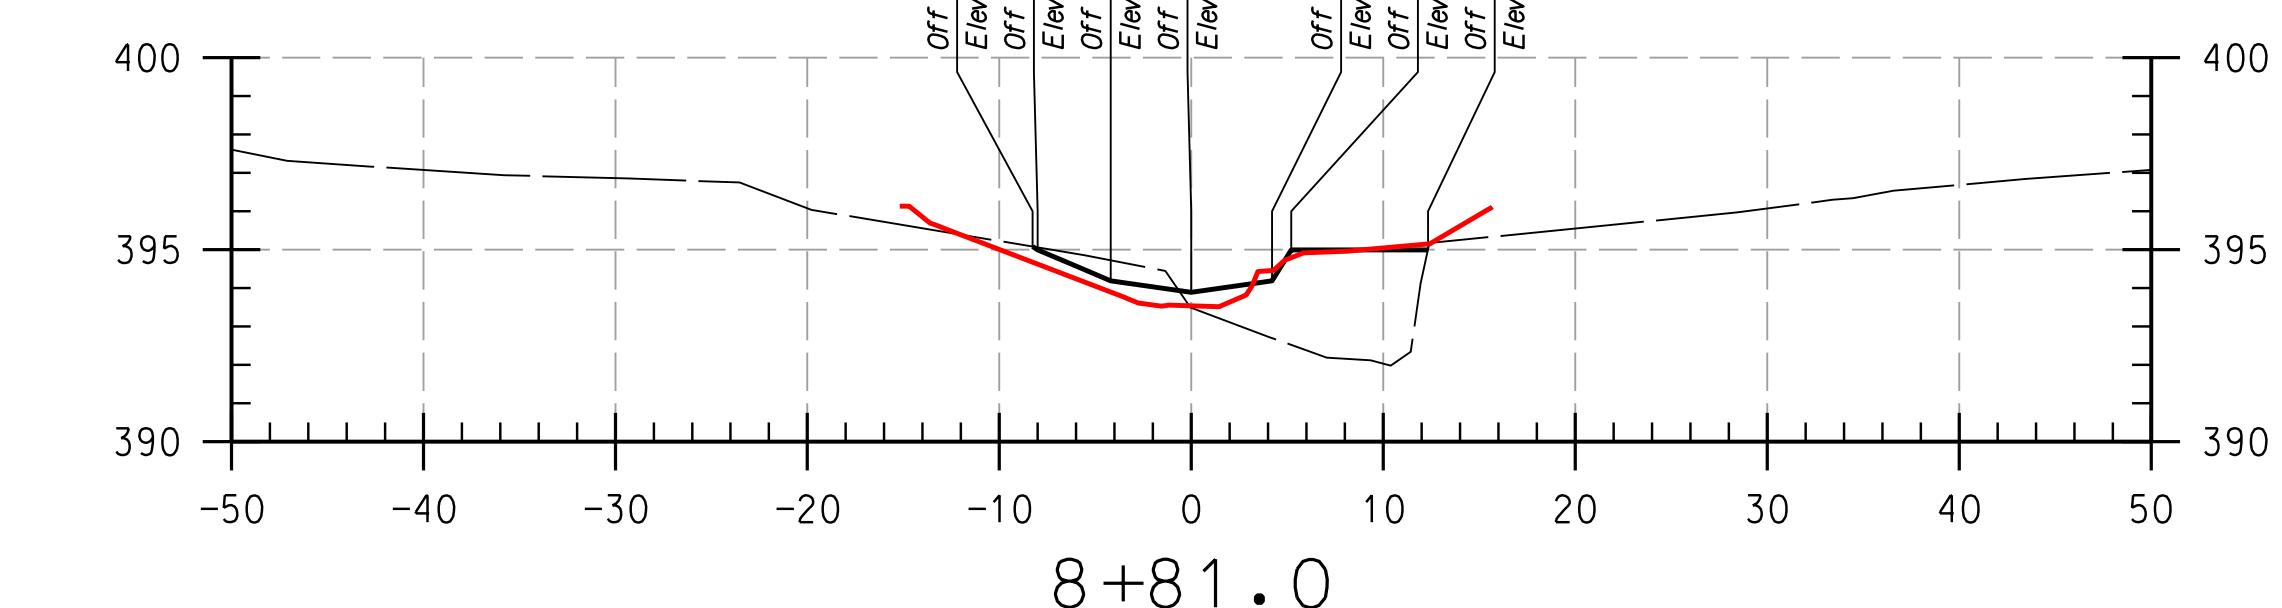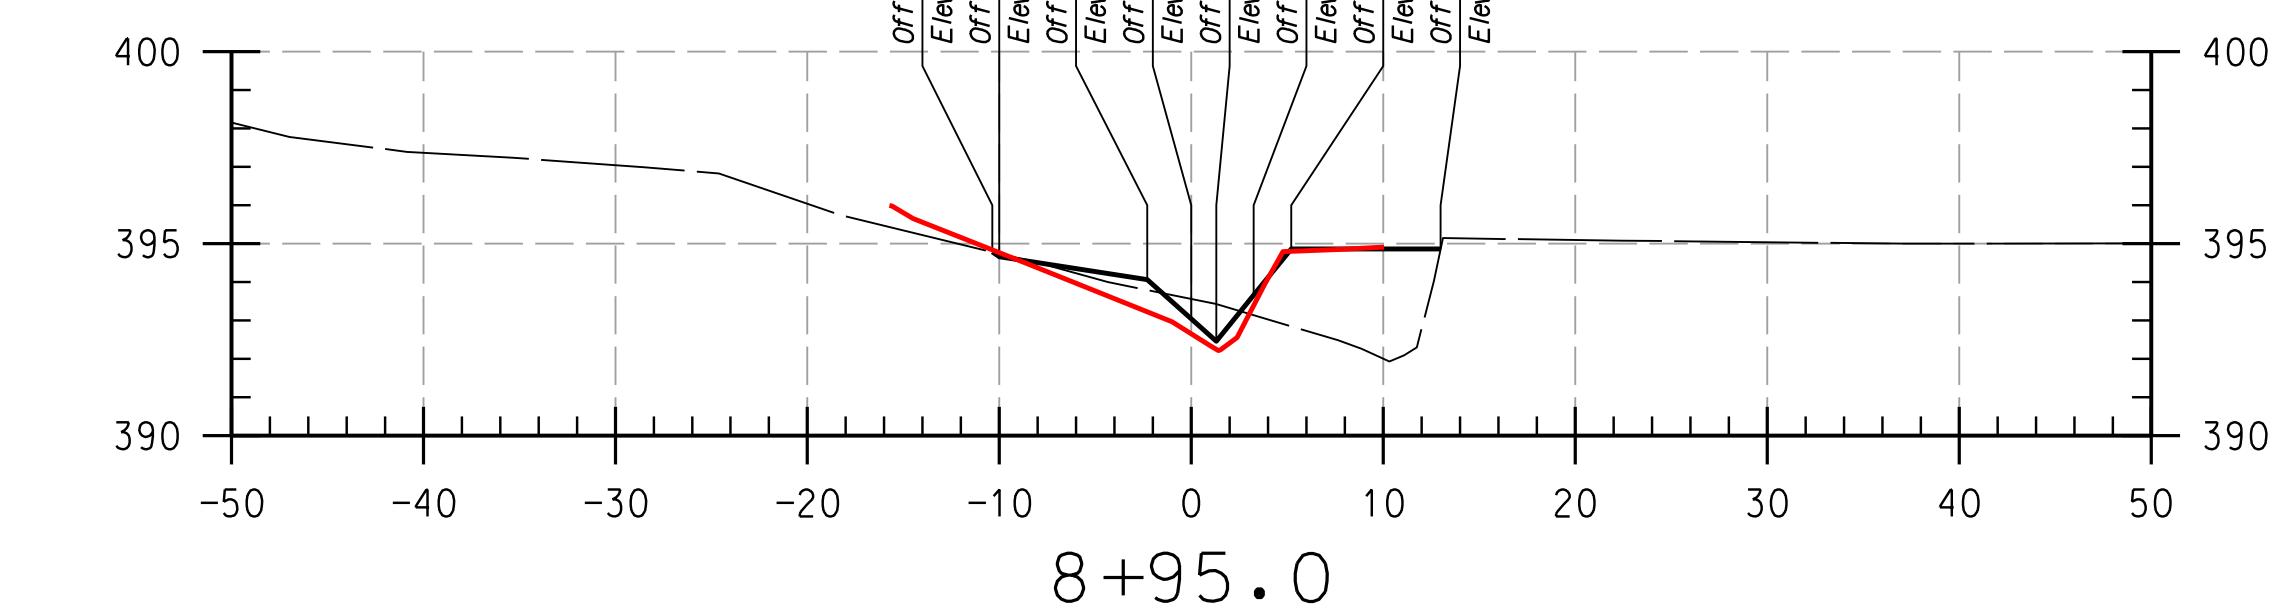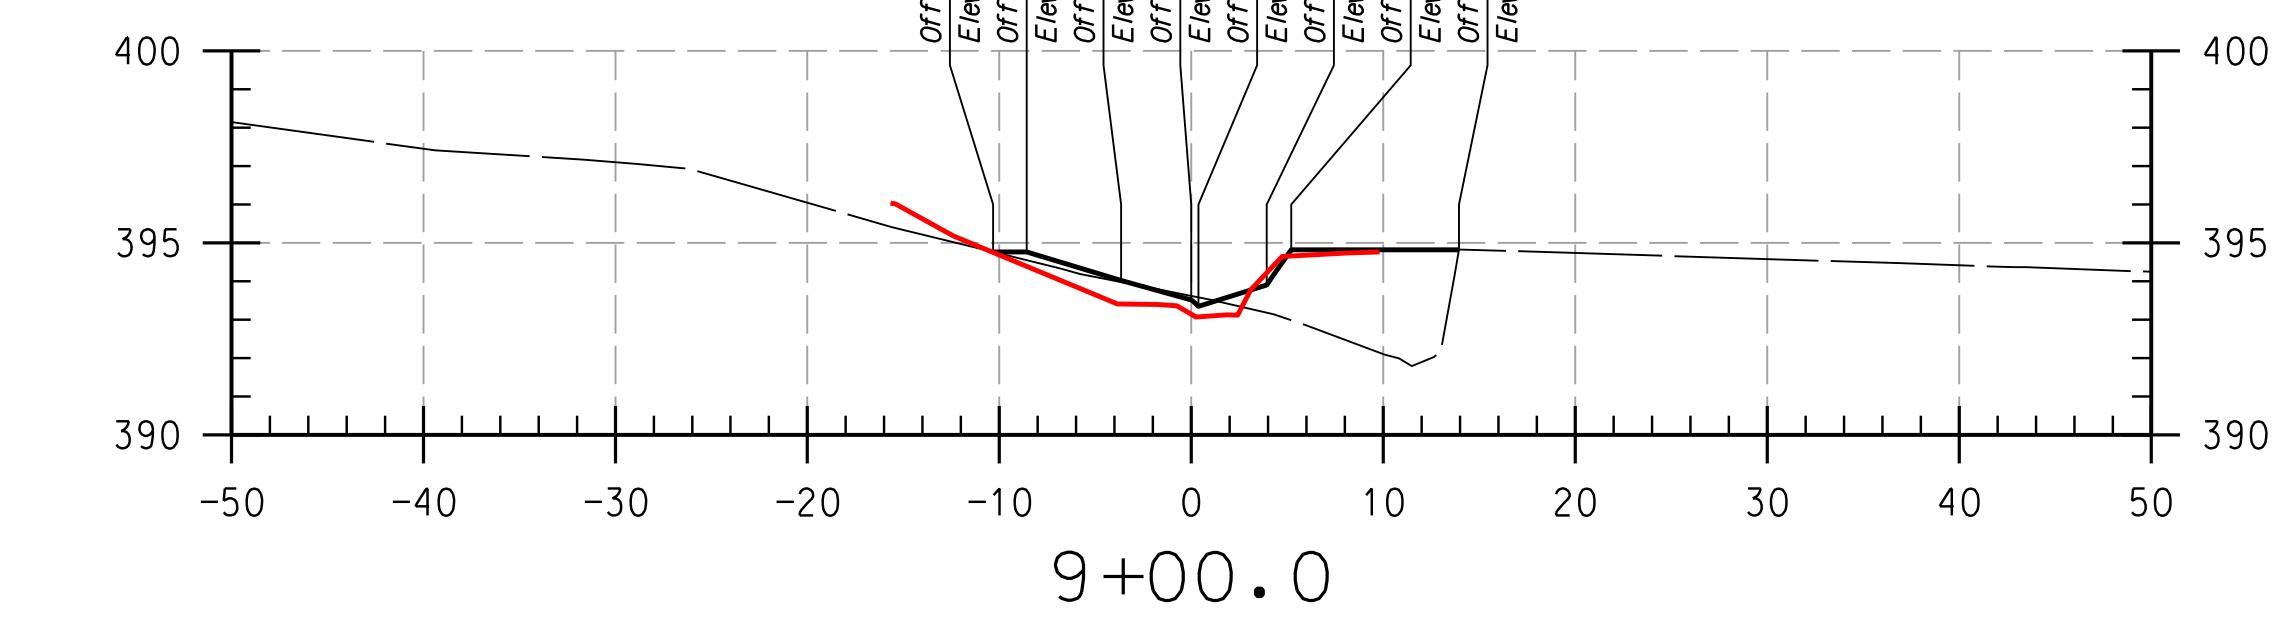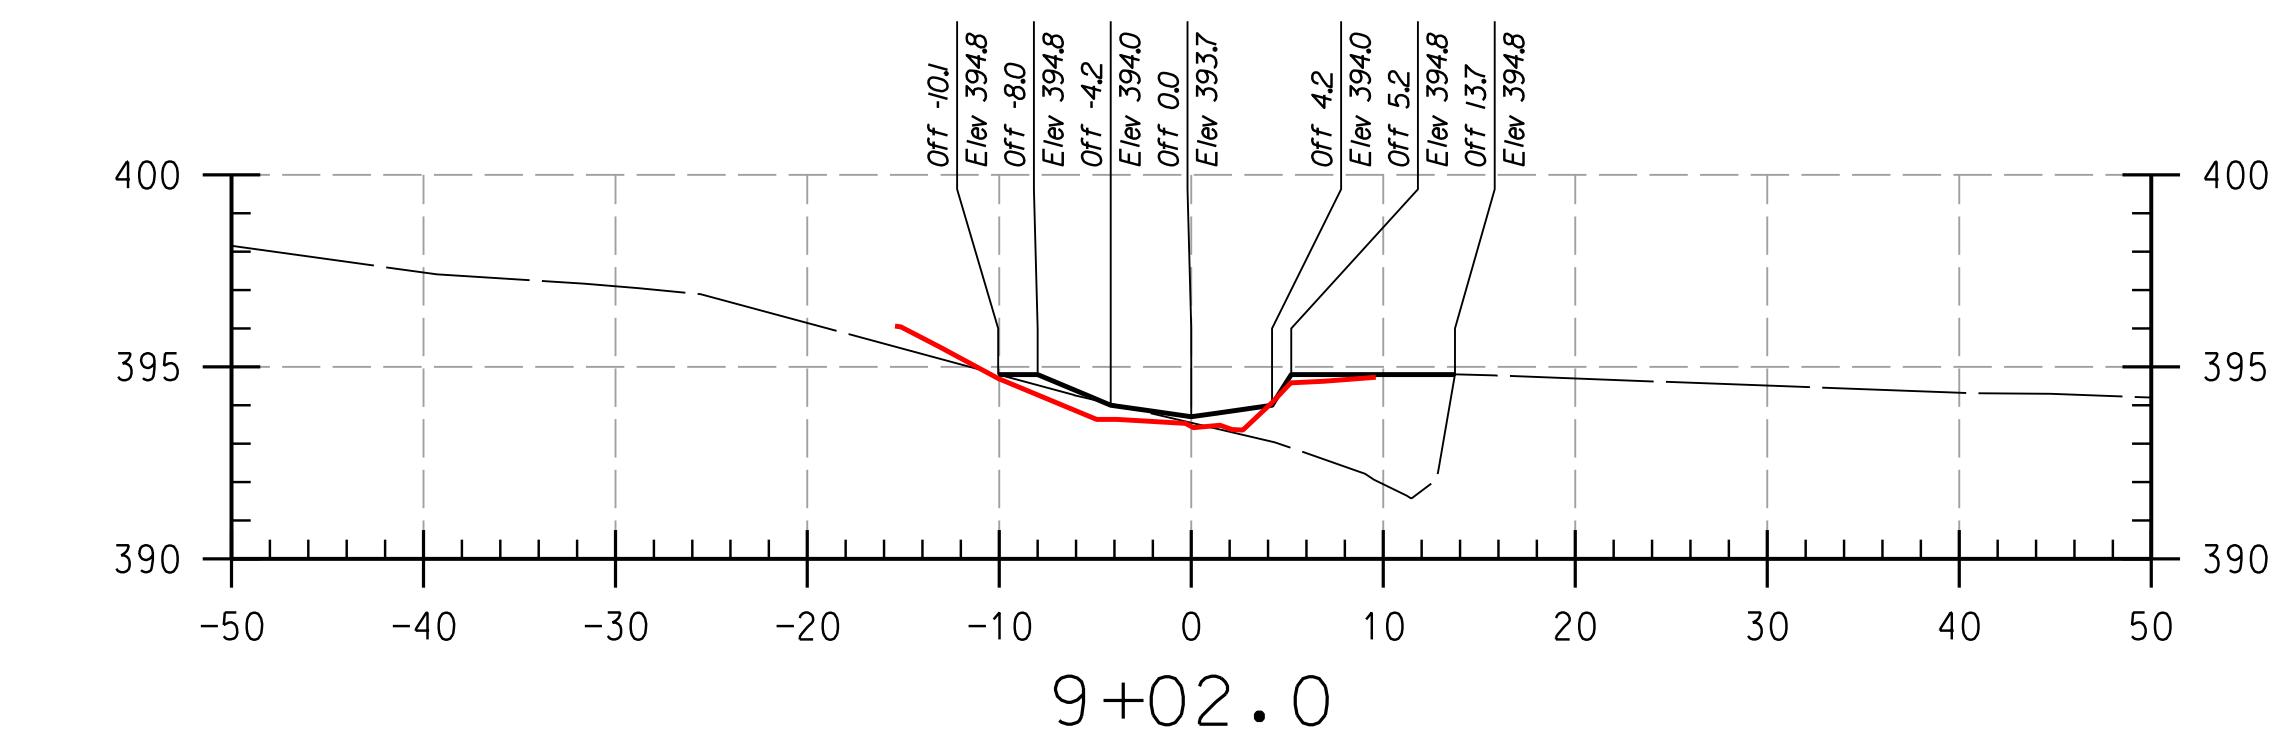


HOWARD COMMUNITY COLLEGE
STREAM RESTORATION PROJECT
CAPITAL PROJECT D-1158
HOWARD COUNTY DEPARTMENT OF PUBLIC WORKS
STORMWATER MANAGEMENT DIVISION
6751 COLUMBIA GATEWAY DRIVE
COLUMBIA, MD 21046
PARCELS 47, 81 TAX MAP 35, 36
NG POR, NT ELECTION DISTRICT 05 GRID/BLOCK 00

AS-BUILT CROSS SECTIONS

SCALE:	HOR: 1" = 10'
	VERT: 1" = 5'
DATE:	APRIL 2017
KCI JOB NO.:	17133314.83
CAPITAL PROJECT NO.:	D-1158
PERMIT ISSUE:	
CONSTRUCTION ISSUE:	

CS 10

SHEET NO.: 10 OF 27

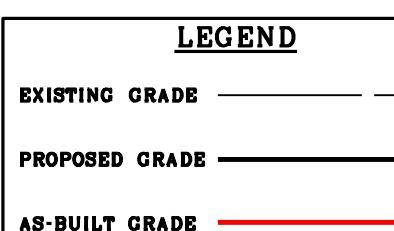

NOTES:
 UTILITIES SHOWN ON THESE PLANS HAVE BEEN LOCATED
 USING SURVEY DATA AND ARE NOT DRAWN TO SCALE.
 THE CONTRACTOR IS TO EXERCISE EXTREME CAUTION WHEN
 EXCAVATING NEAR ANY UTILITIES TEST PIT IF REQUIRED.

PROFESSIONAL CERTIFICATION, I HEREBY
 CERTIFY THAT THESE DOCUMENTS WERE
 PREPARED OR APPROVED BY ME AND THAT
 I AM A DULY LICENSED PROFESSIONAL
 ENGINEER UNDER THE LAWS OF THE STATE
 OF MARYLAND, LICENSE NO. 38311,
 EXPIRATION DATE: JANUARY 06, 2018

THIS DEVELOPMENT IS APPROVED FOR SOIL EROSION AND SEDIMENT CONTROL
 BY THE HOWARD SOIL CONSERVATION DISTRICT.

HOWARD SCD

DATE









DEPARTMENT OF PUBLIC WORKS, HOWARD COUNTY, MD

DATE

CHIEF, BUREAU OF ENVIRONMENTAL SERVICES


DATE

REACH 2

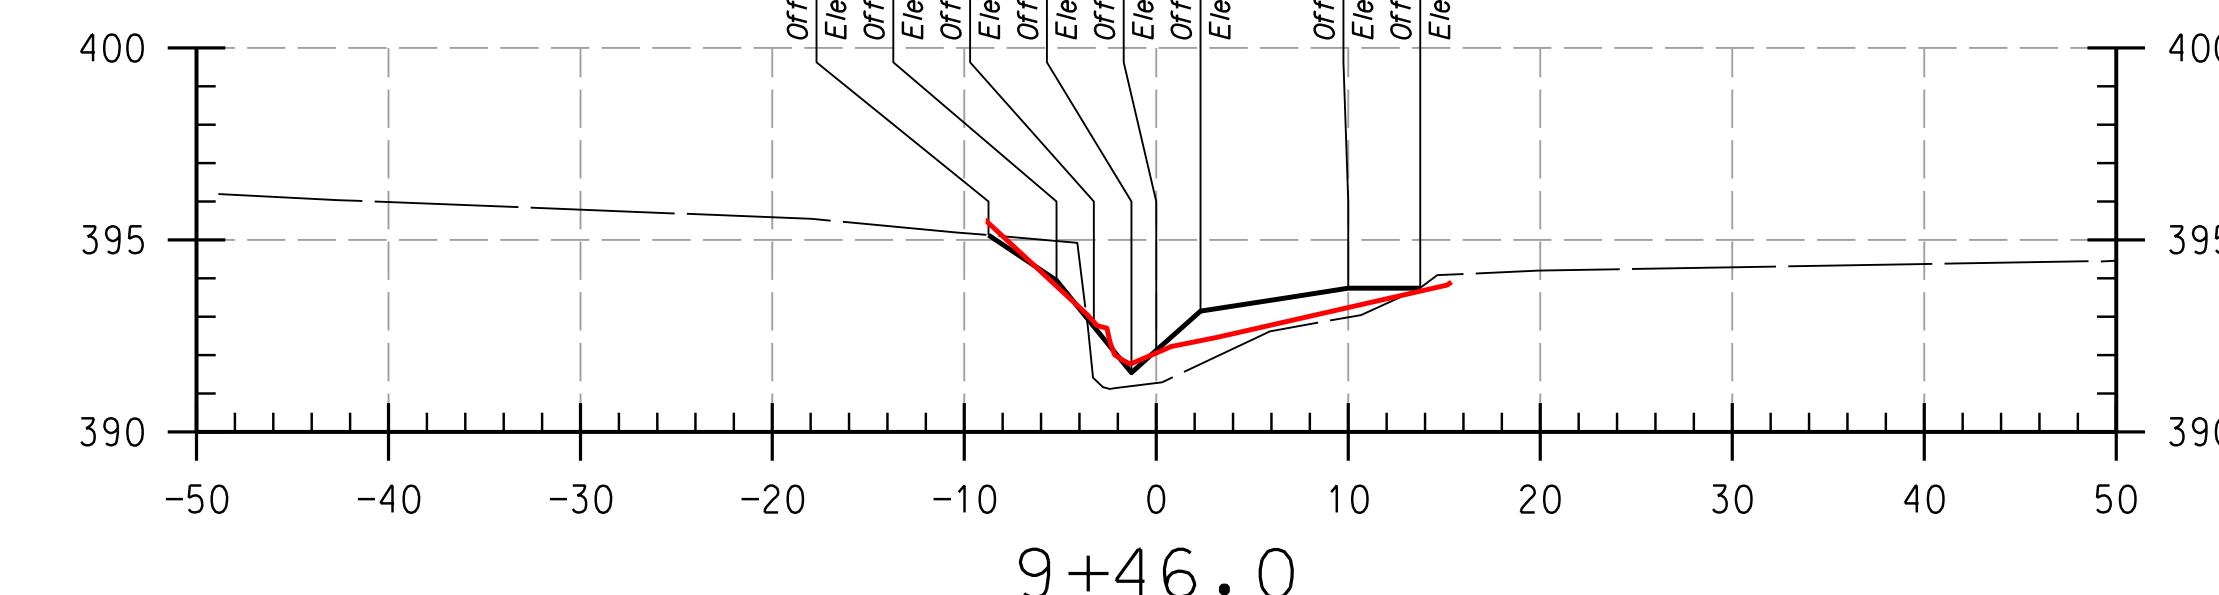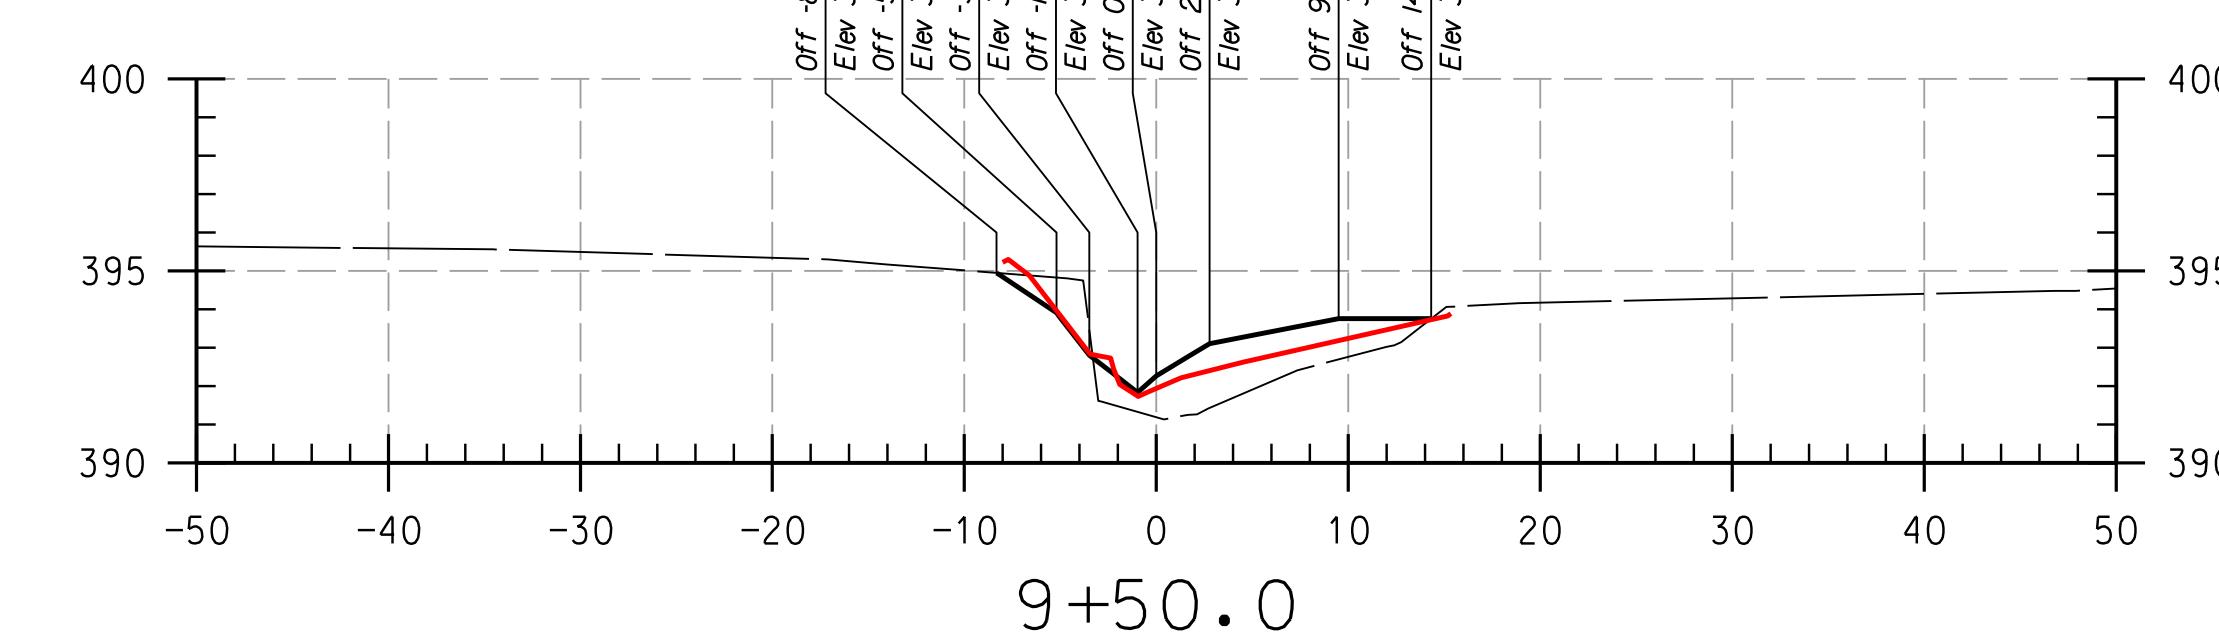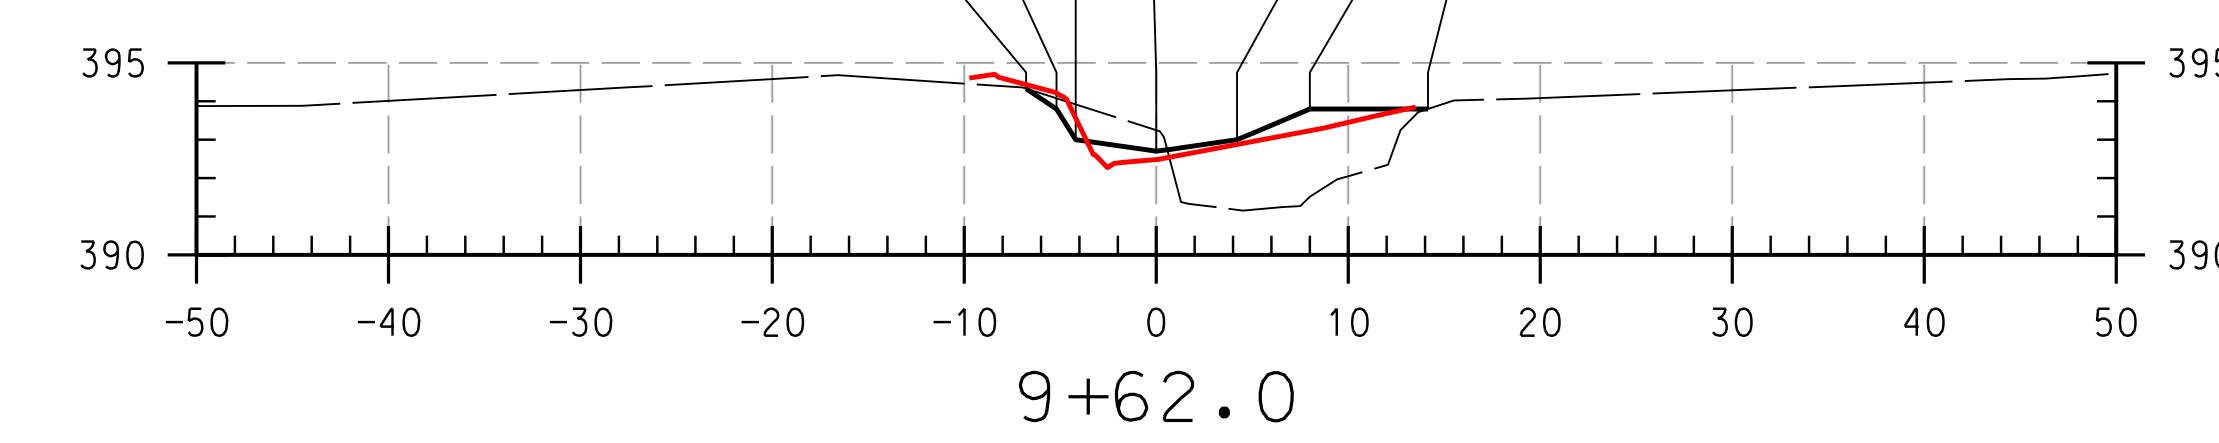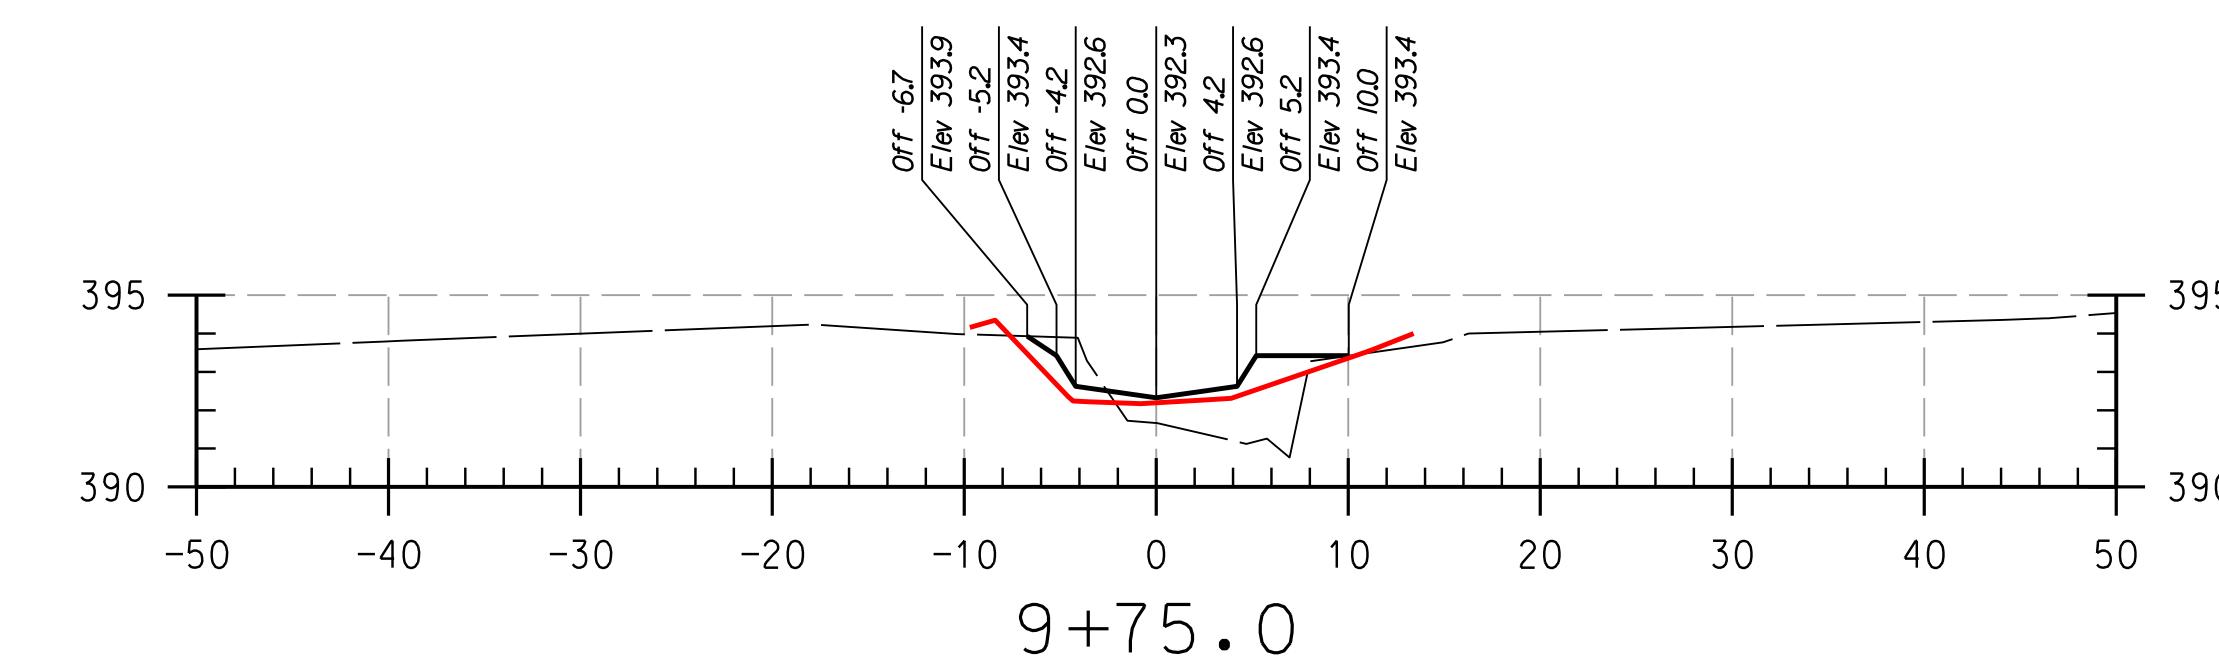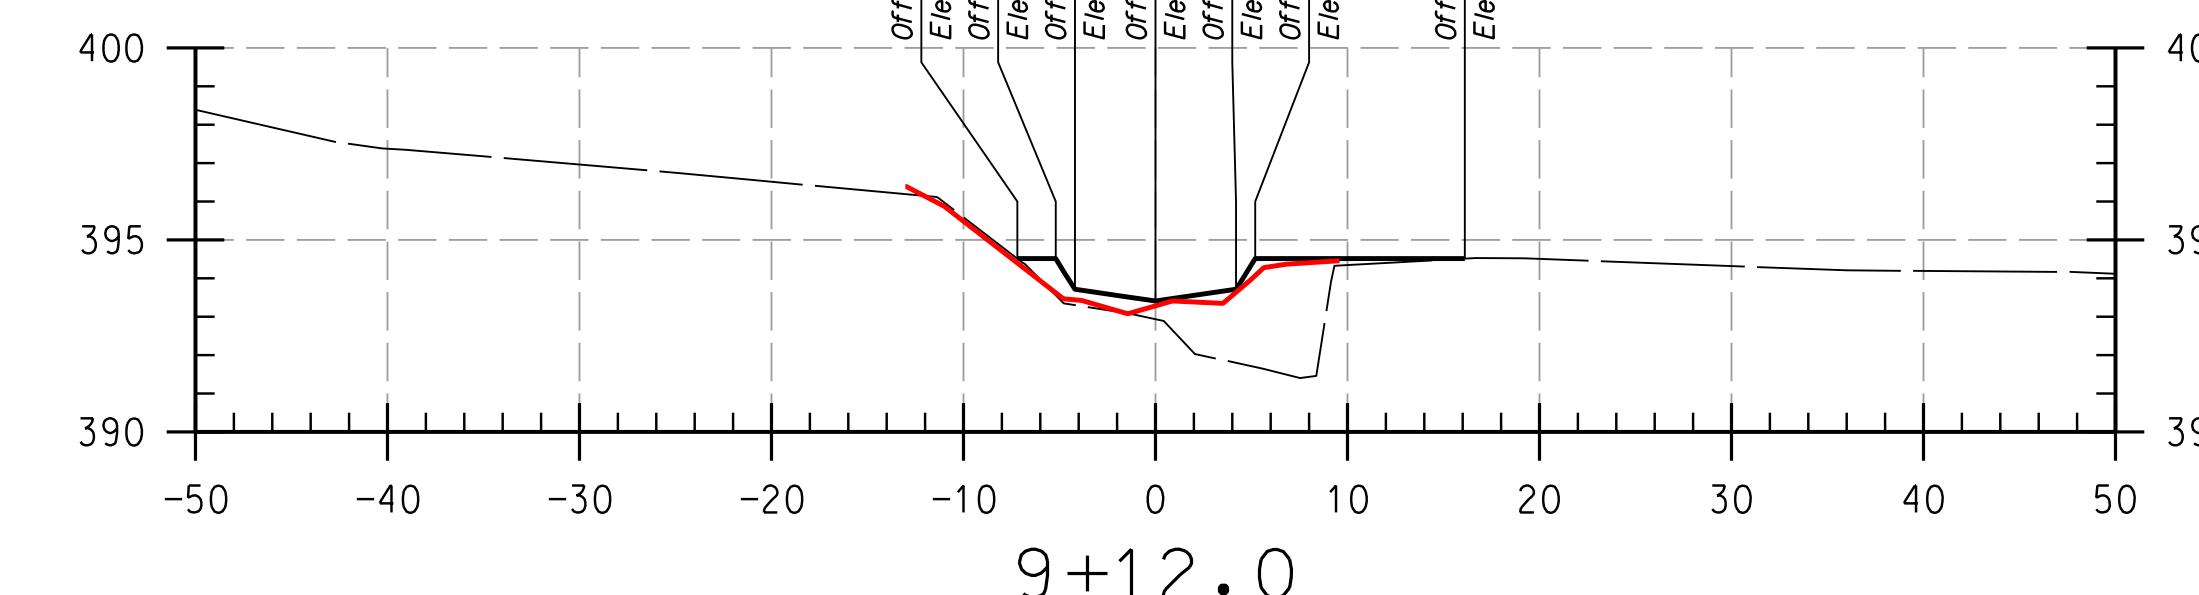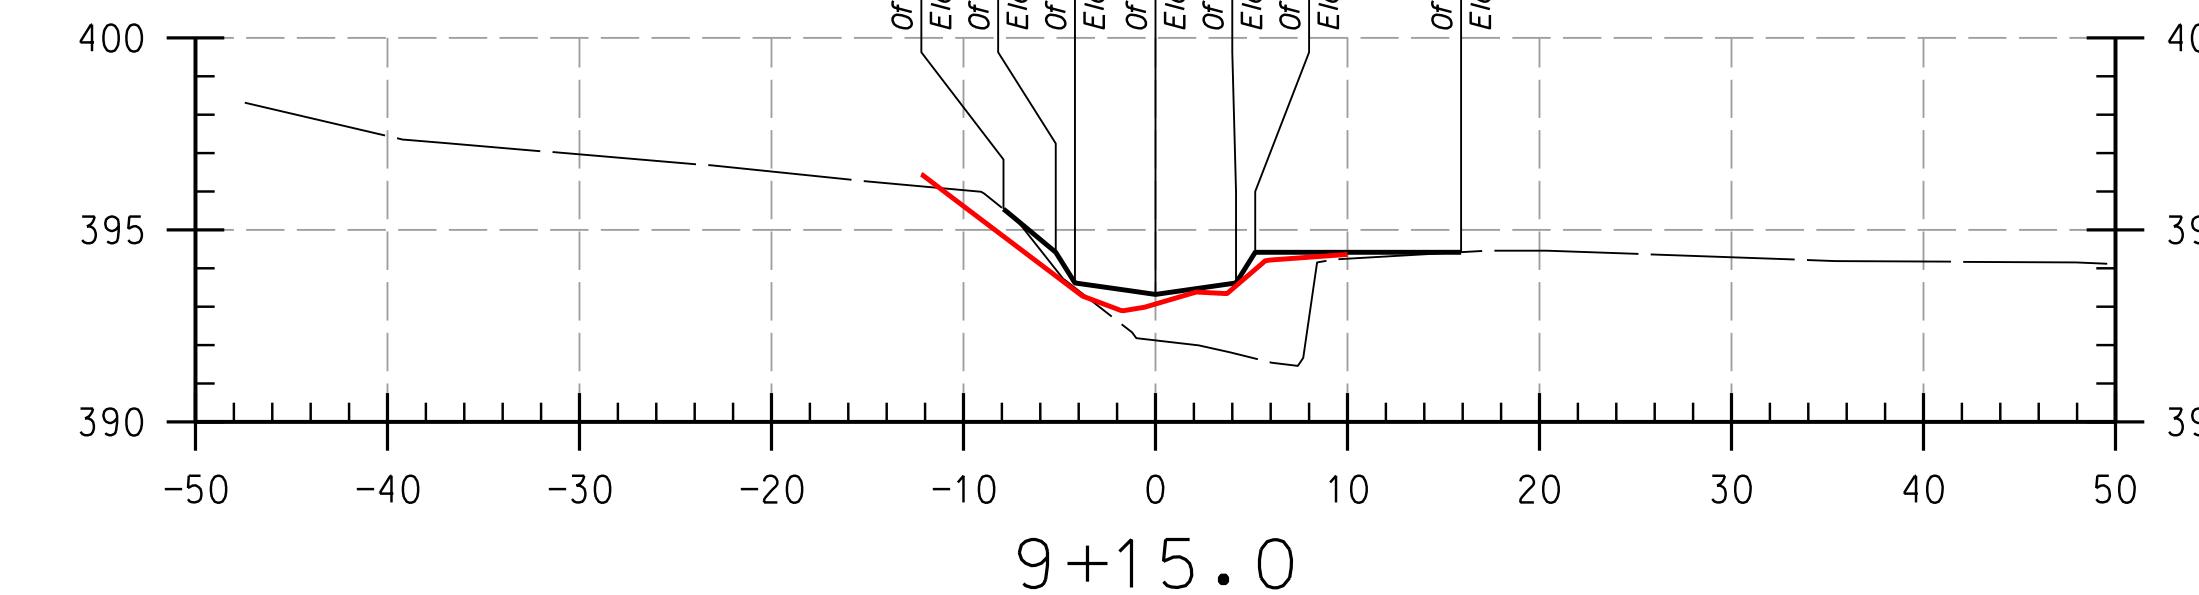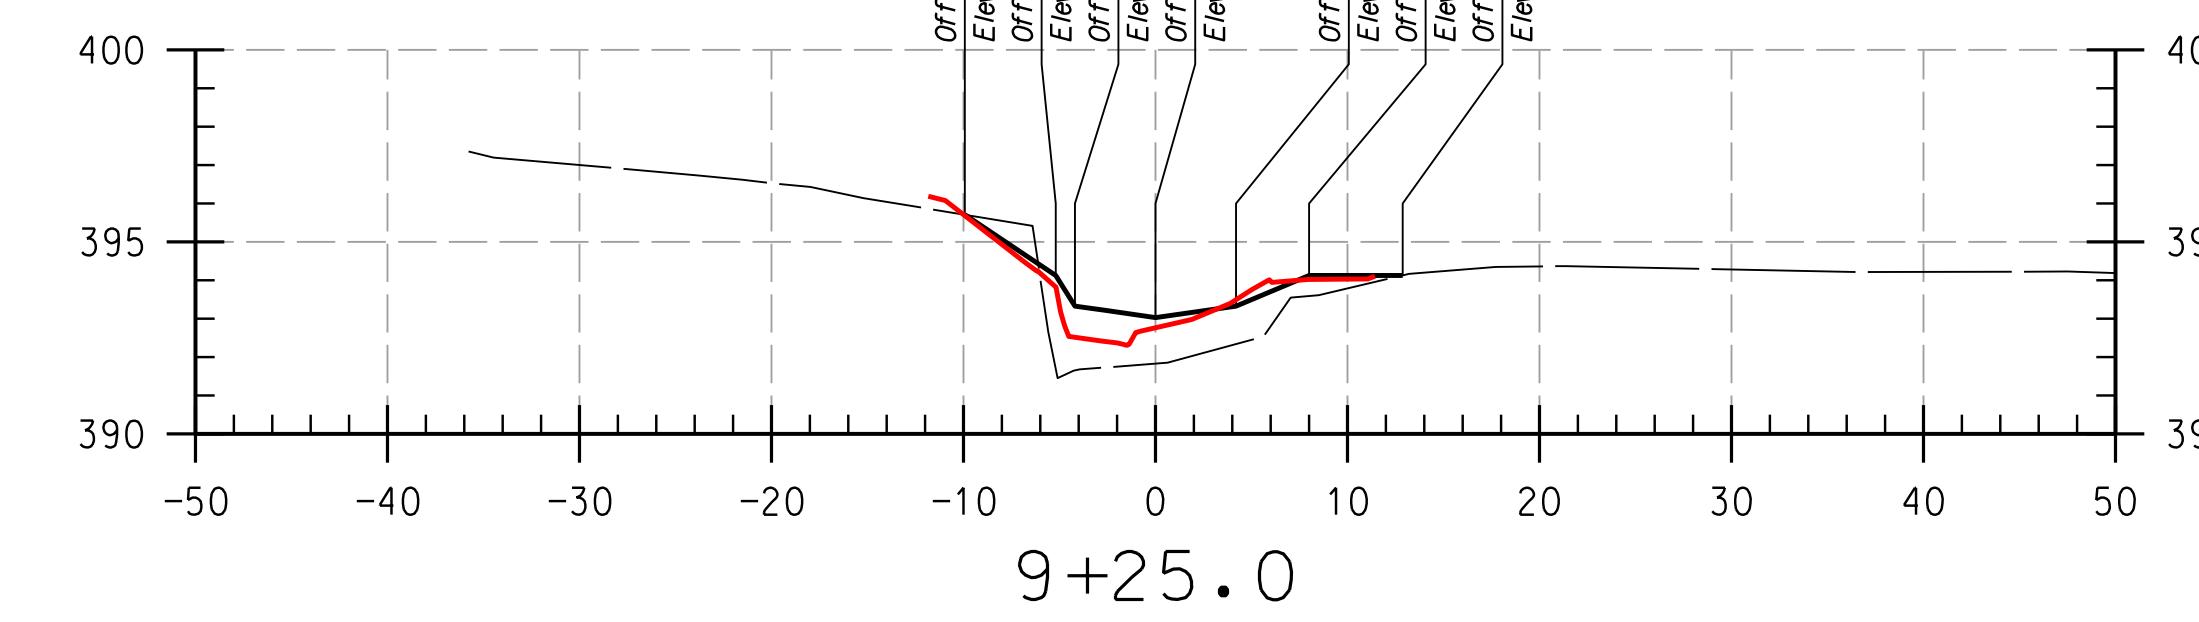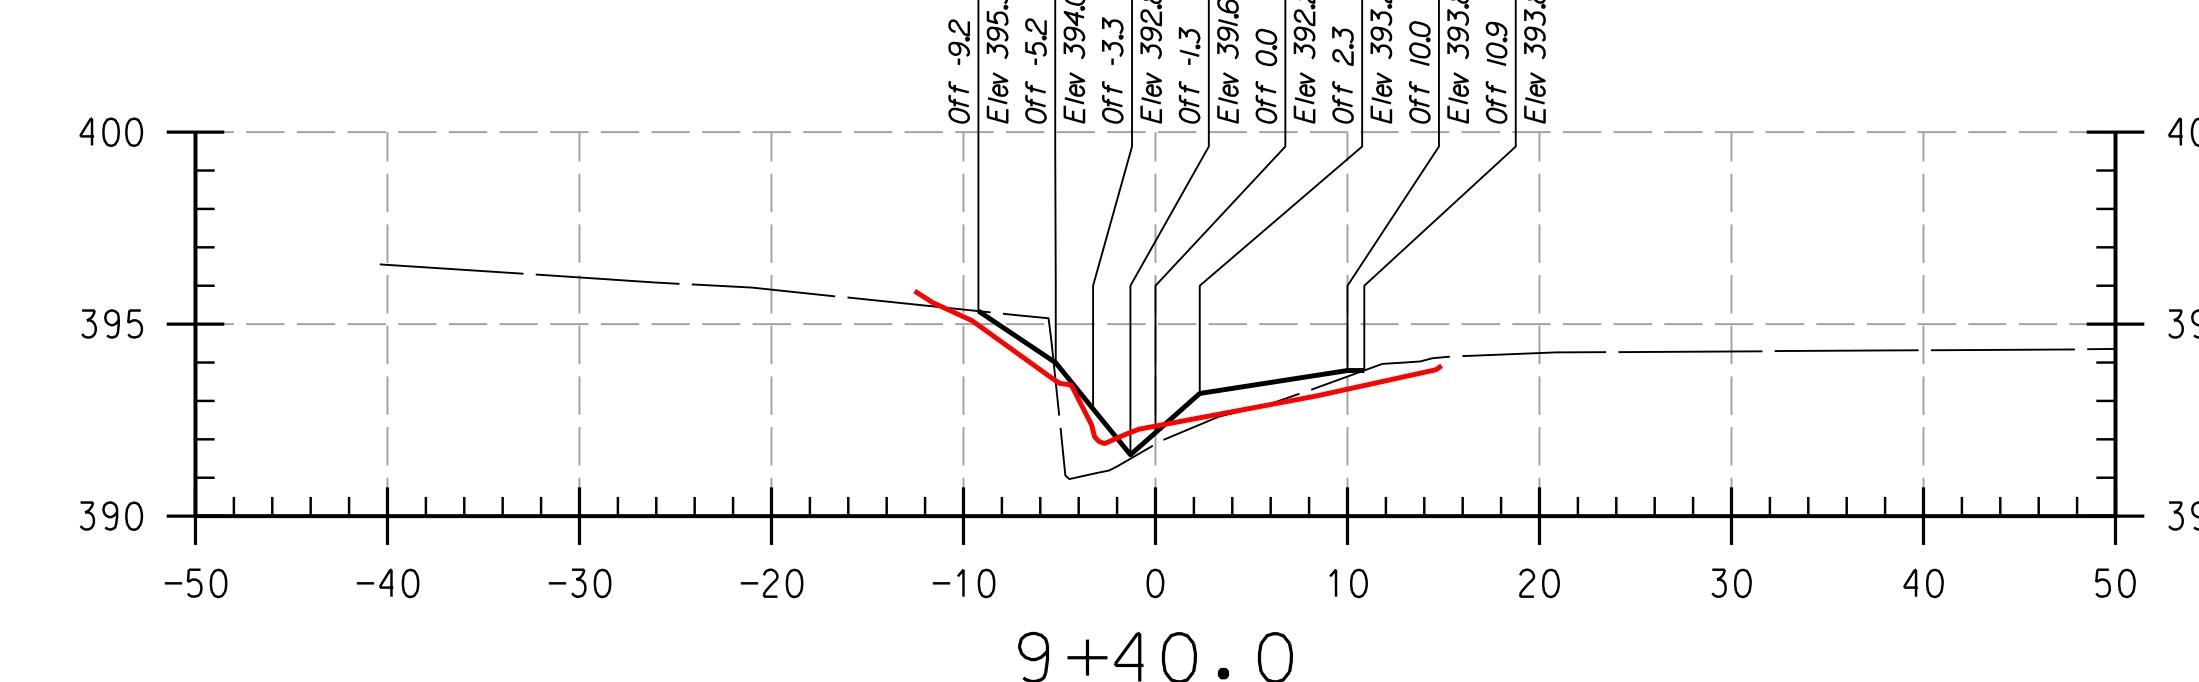

HOWARD COMMUNITY COLLEGE
 STREAM RESTORATION PROJECT
 CAPITAL PROJECT D-1158
 HOWARD COUNTY DEPARTMENT OF PUBLIC WORKS
 STORMWATER MANAGEMENT DIVISION
 6751 COLUMBIA GATEWAY DRIVE
 COLUMBIA, MD 21046
 PARCELS: 47, 81 TAX MAP: 35, 36
 ZONING: POR, NT GRID BLOCK: 0006

KC FILE: M:\2013\1713334.83
 NO. REVISIONS DESCRIPTION DATE
 KC FILE: M:\2013\1713334.83

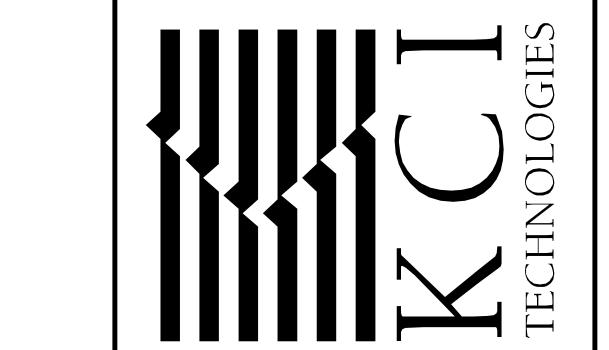

SCALE: HOR: 1" = 10'
 VERT: 1" = 5'
 DATE: APRIL 2017
 KC JOB NO.: 1713334.83
 CAPITAL PROJECT NO.: D-1158
 PERMIT ISSUE:
 CONSTRUCTION ISSUE:
 CS-11
 SHEET NO.: 11 OF 27

LEGEND

EXISTING GRADE	—
PROPOSED GRADE	—
AS-BUILT GRADE	—

NOTES:
 UTILITIES SHOWN ON THESE PLANS HAVE BEEN LOCATED
 USING SURVEY DATA AND ARE NOT DRAWN TO SCALE.
 THE CONTRACTOR IS TO EXERCISE EXTREME CAUTION WHEN
 EXCAVATING NEAR ANY UTILITIES TEST PIT IF REQUIRED.

THIS DEVELOPMENT IS APPROVED FOR SOIL EROSION AND SEDIMENT CONTROL

BY THE HOWARD SOIL CONSERVATION DISTRICT.

EXPIRATION DATE: JANUARY 06, 2018









HOWARD SCD

DATE

DEPARTMENT OF PUBLIC WORKS, HOWARD COUNTY, MD
 CHIEF, BUREAU OF ENVIRONMENTAL SERVICES

DATE

REACH 2

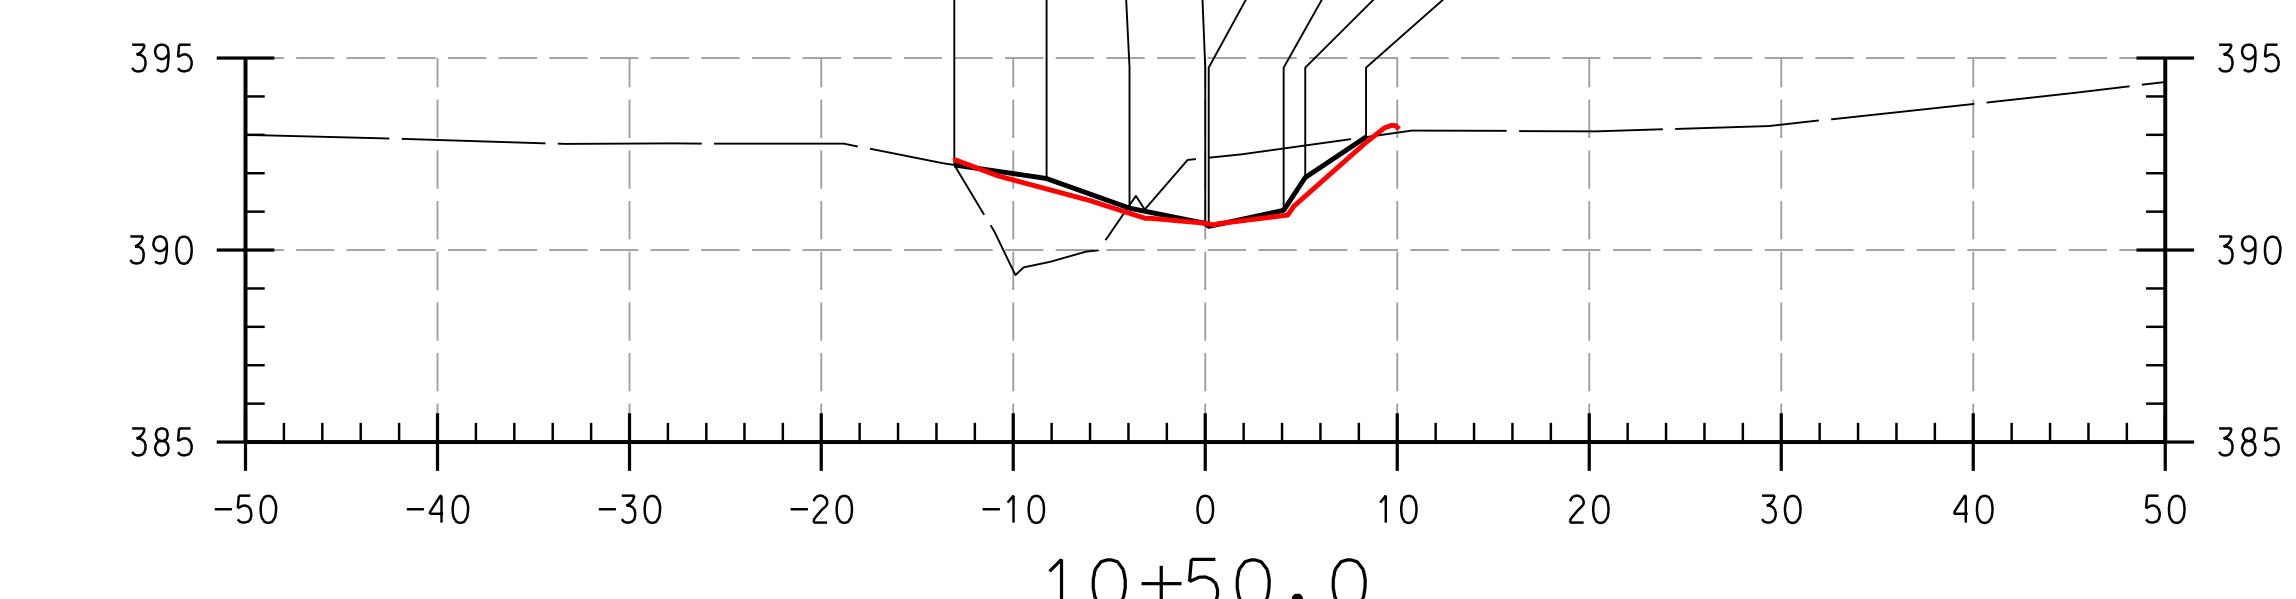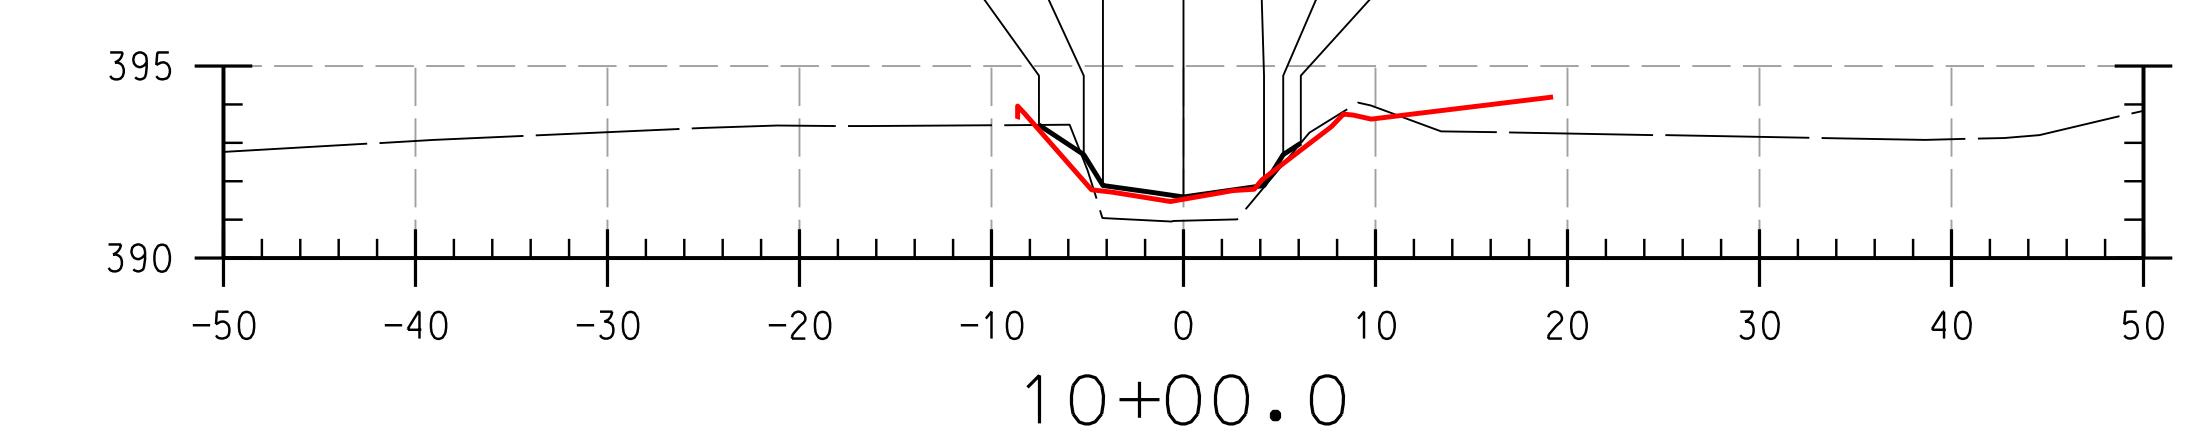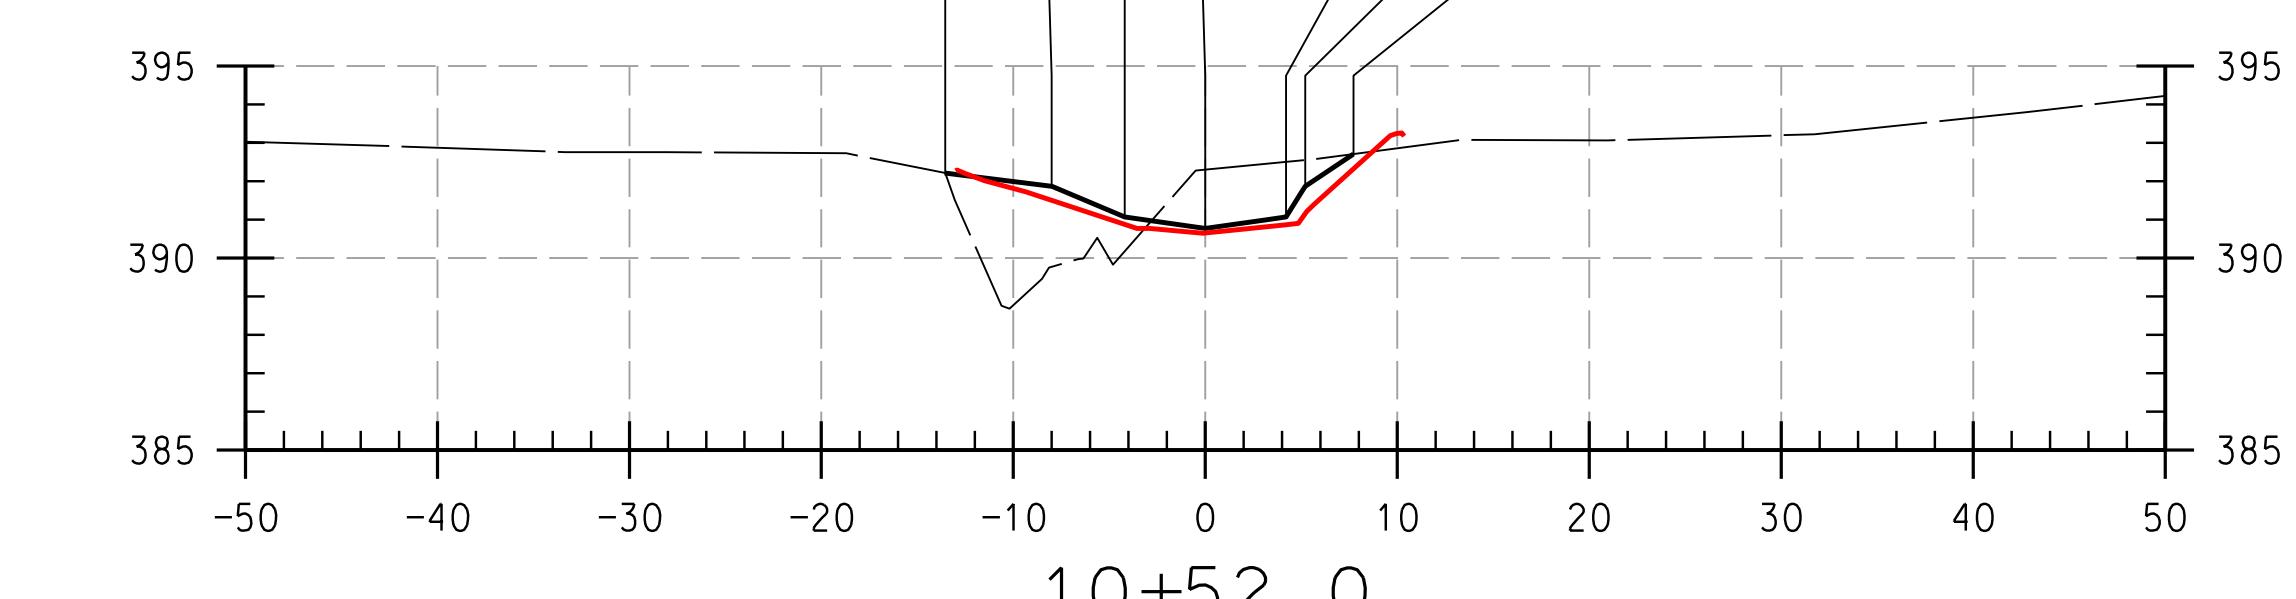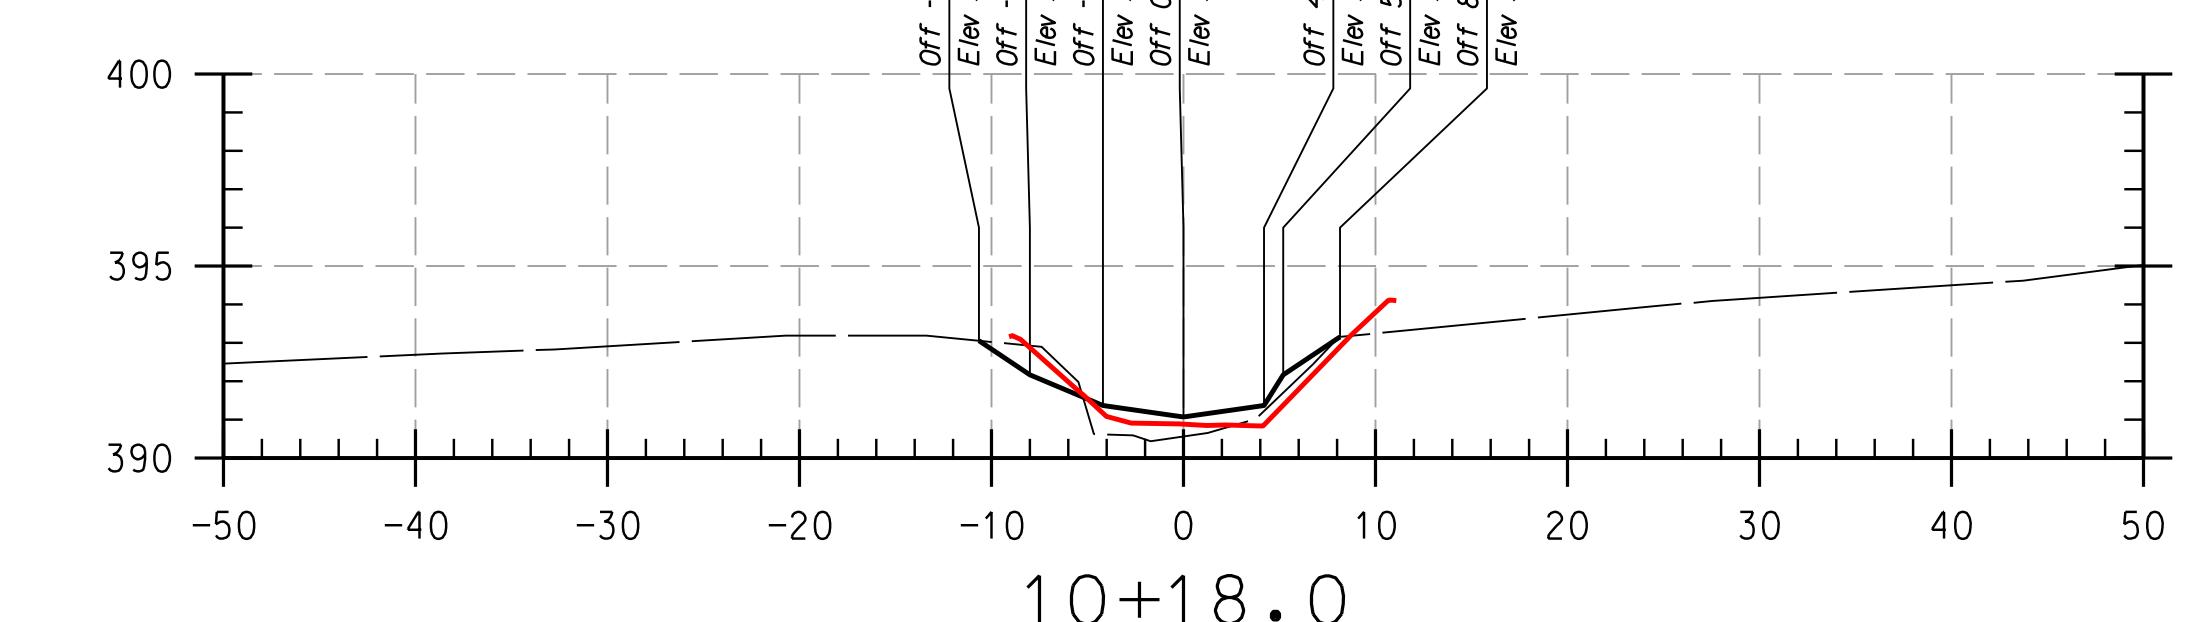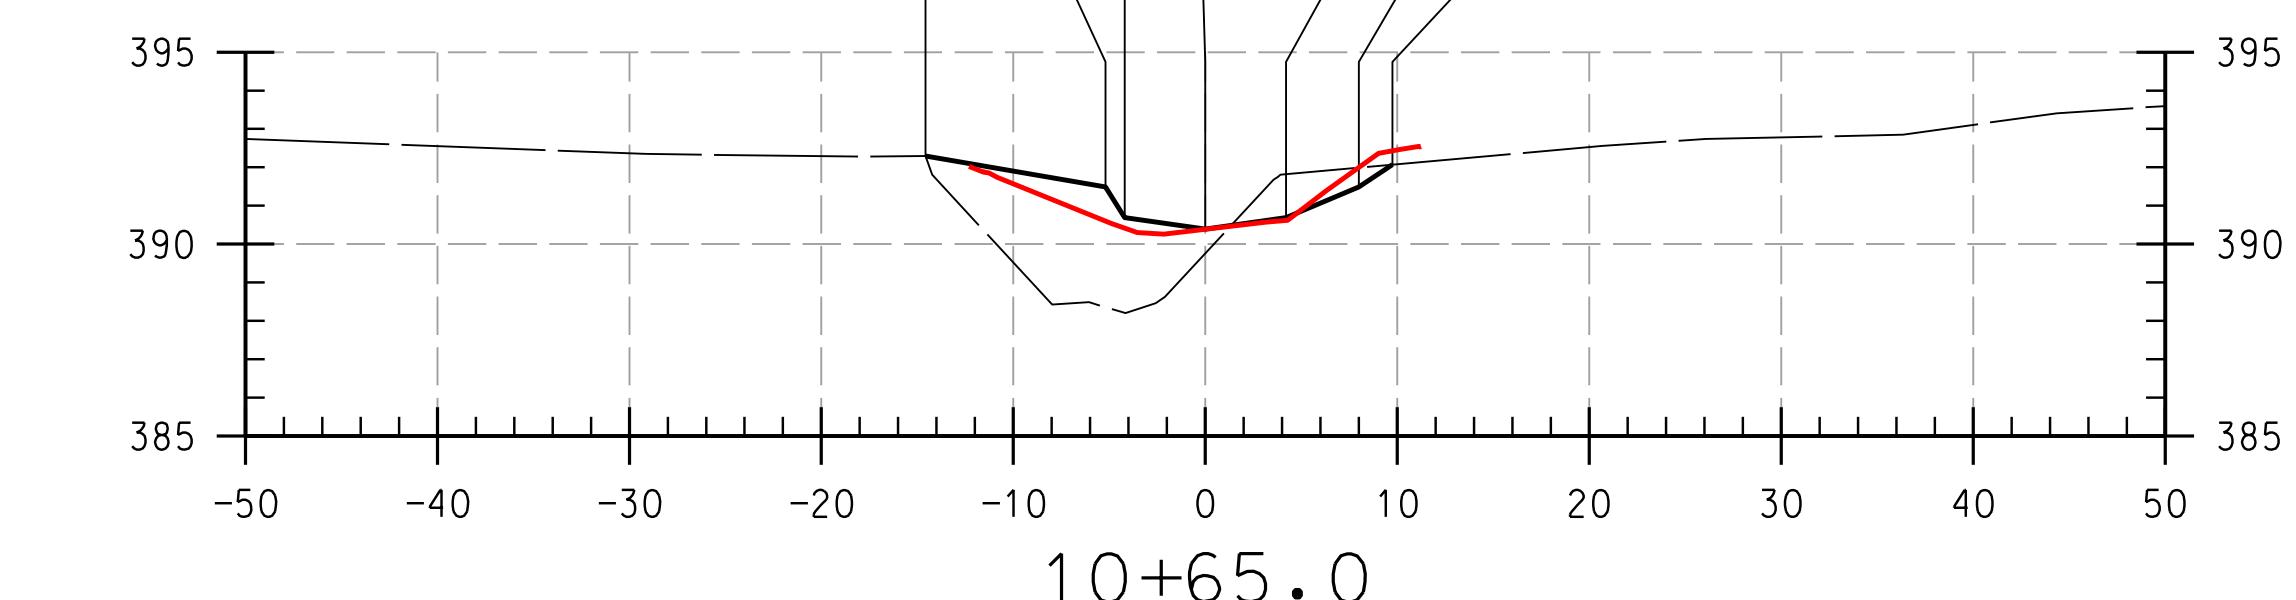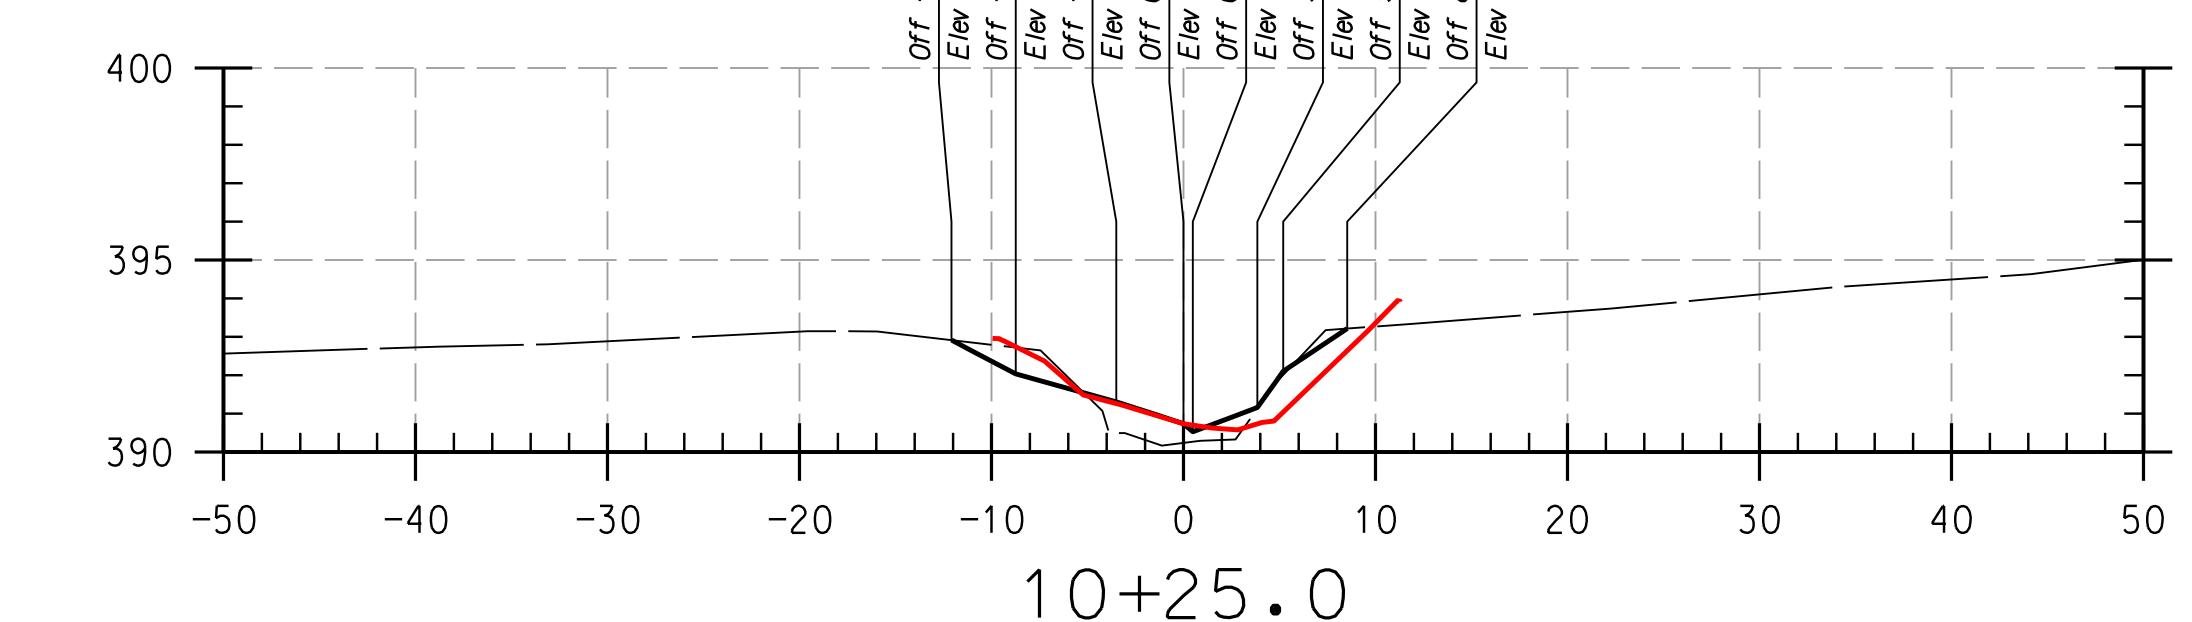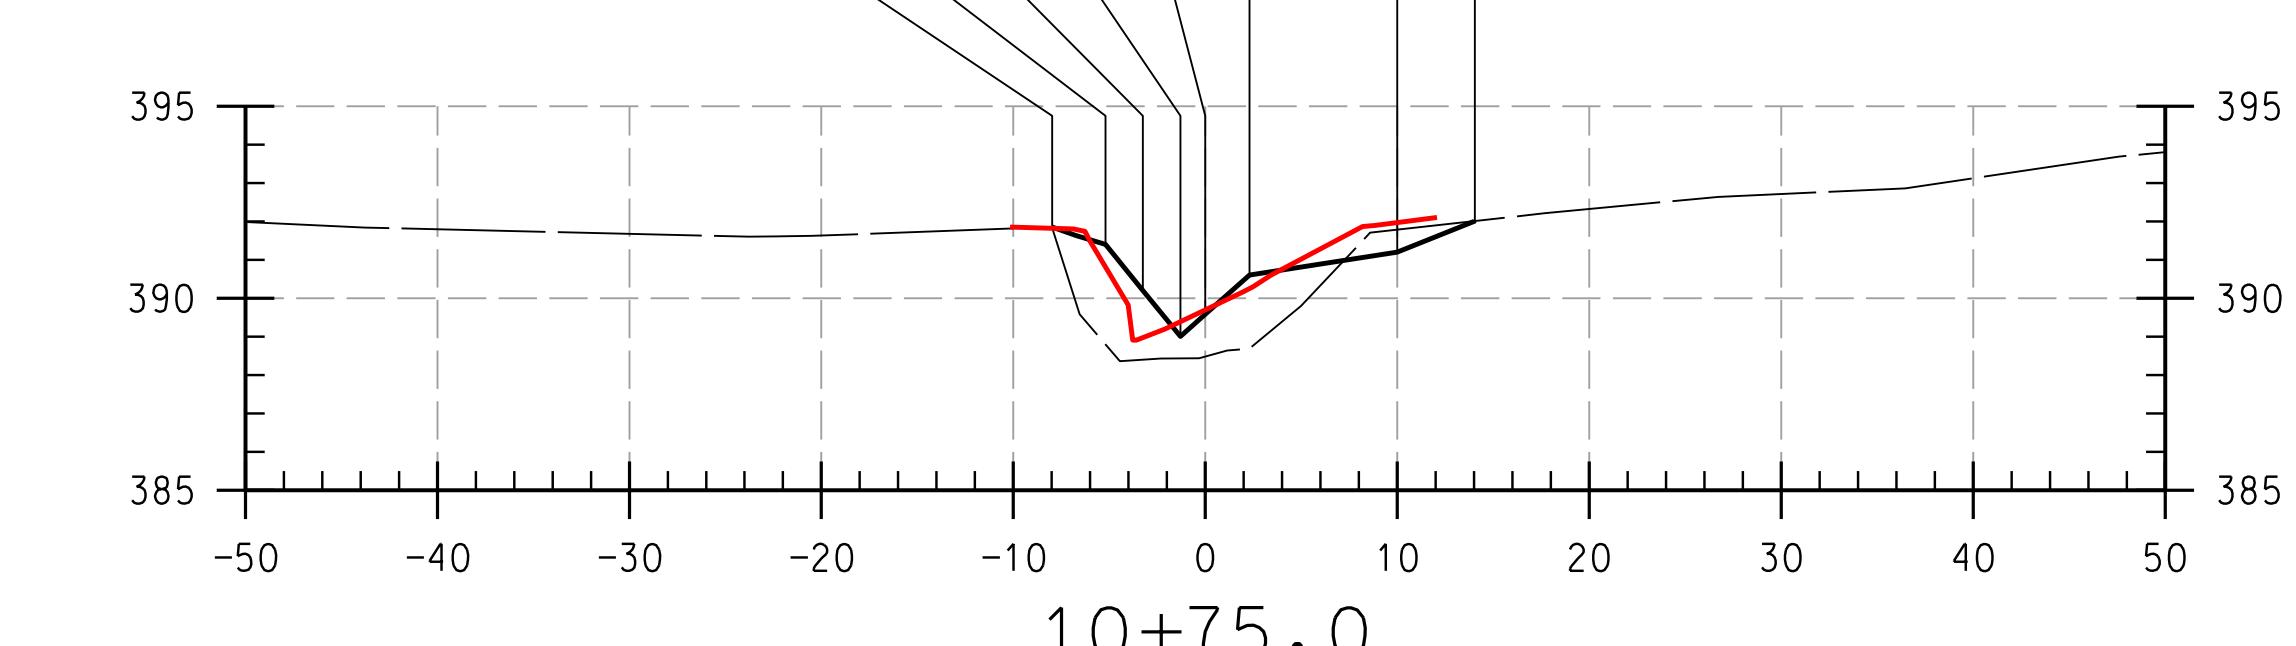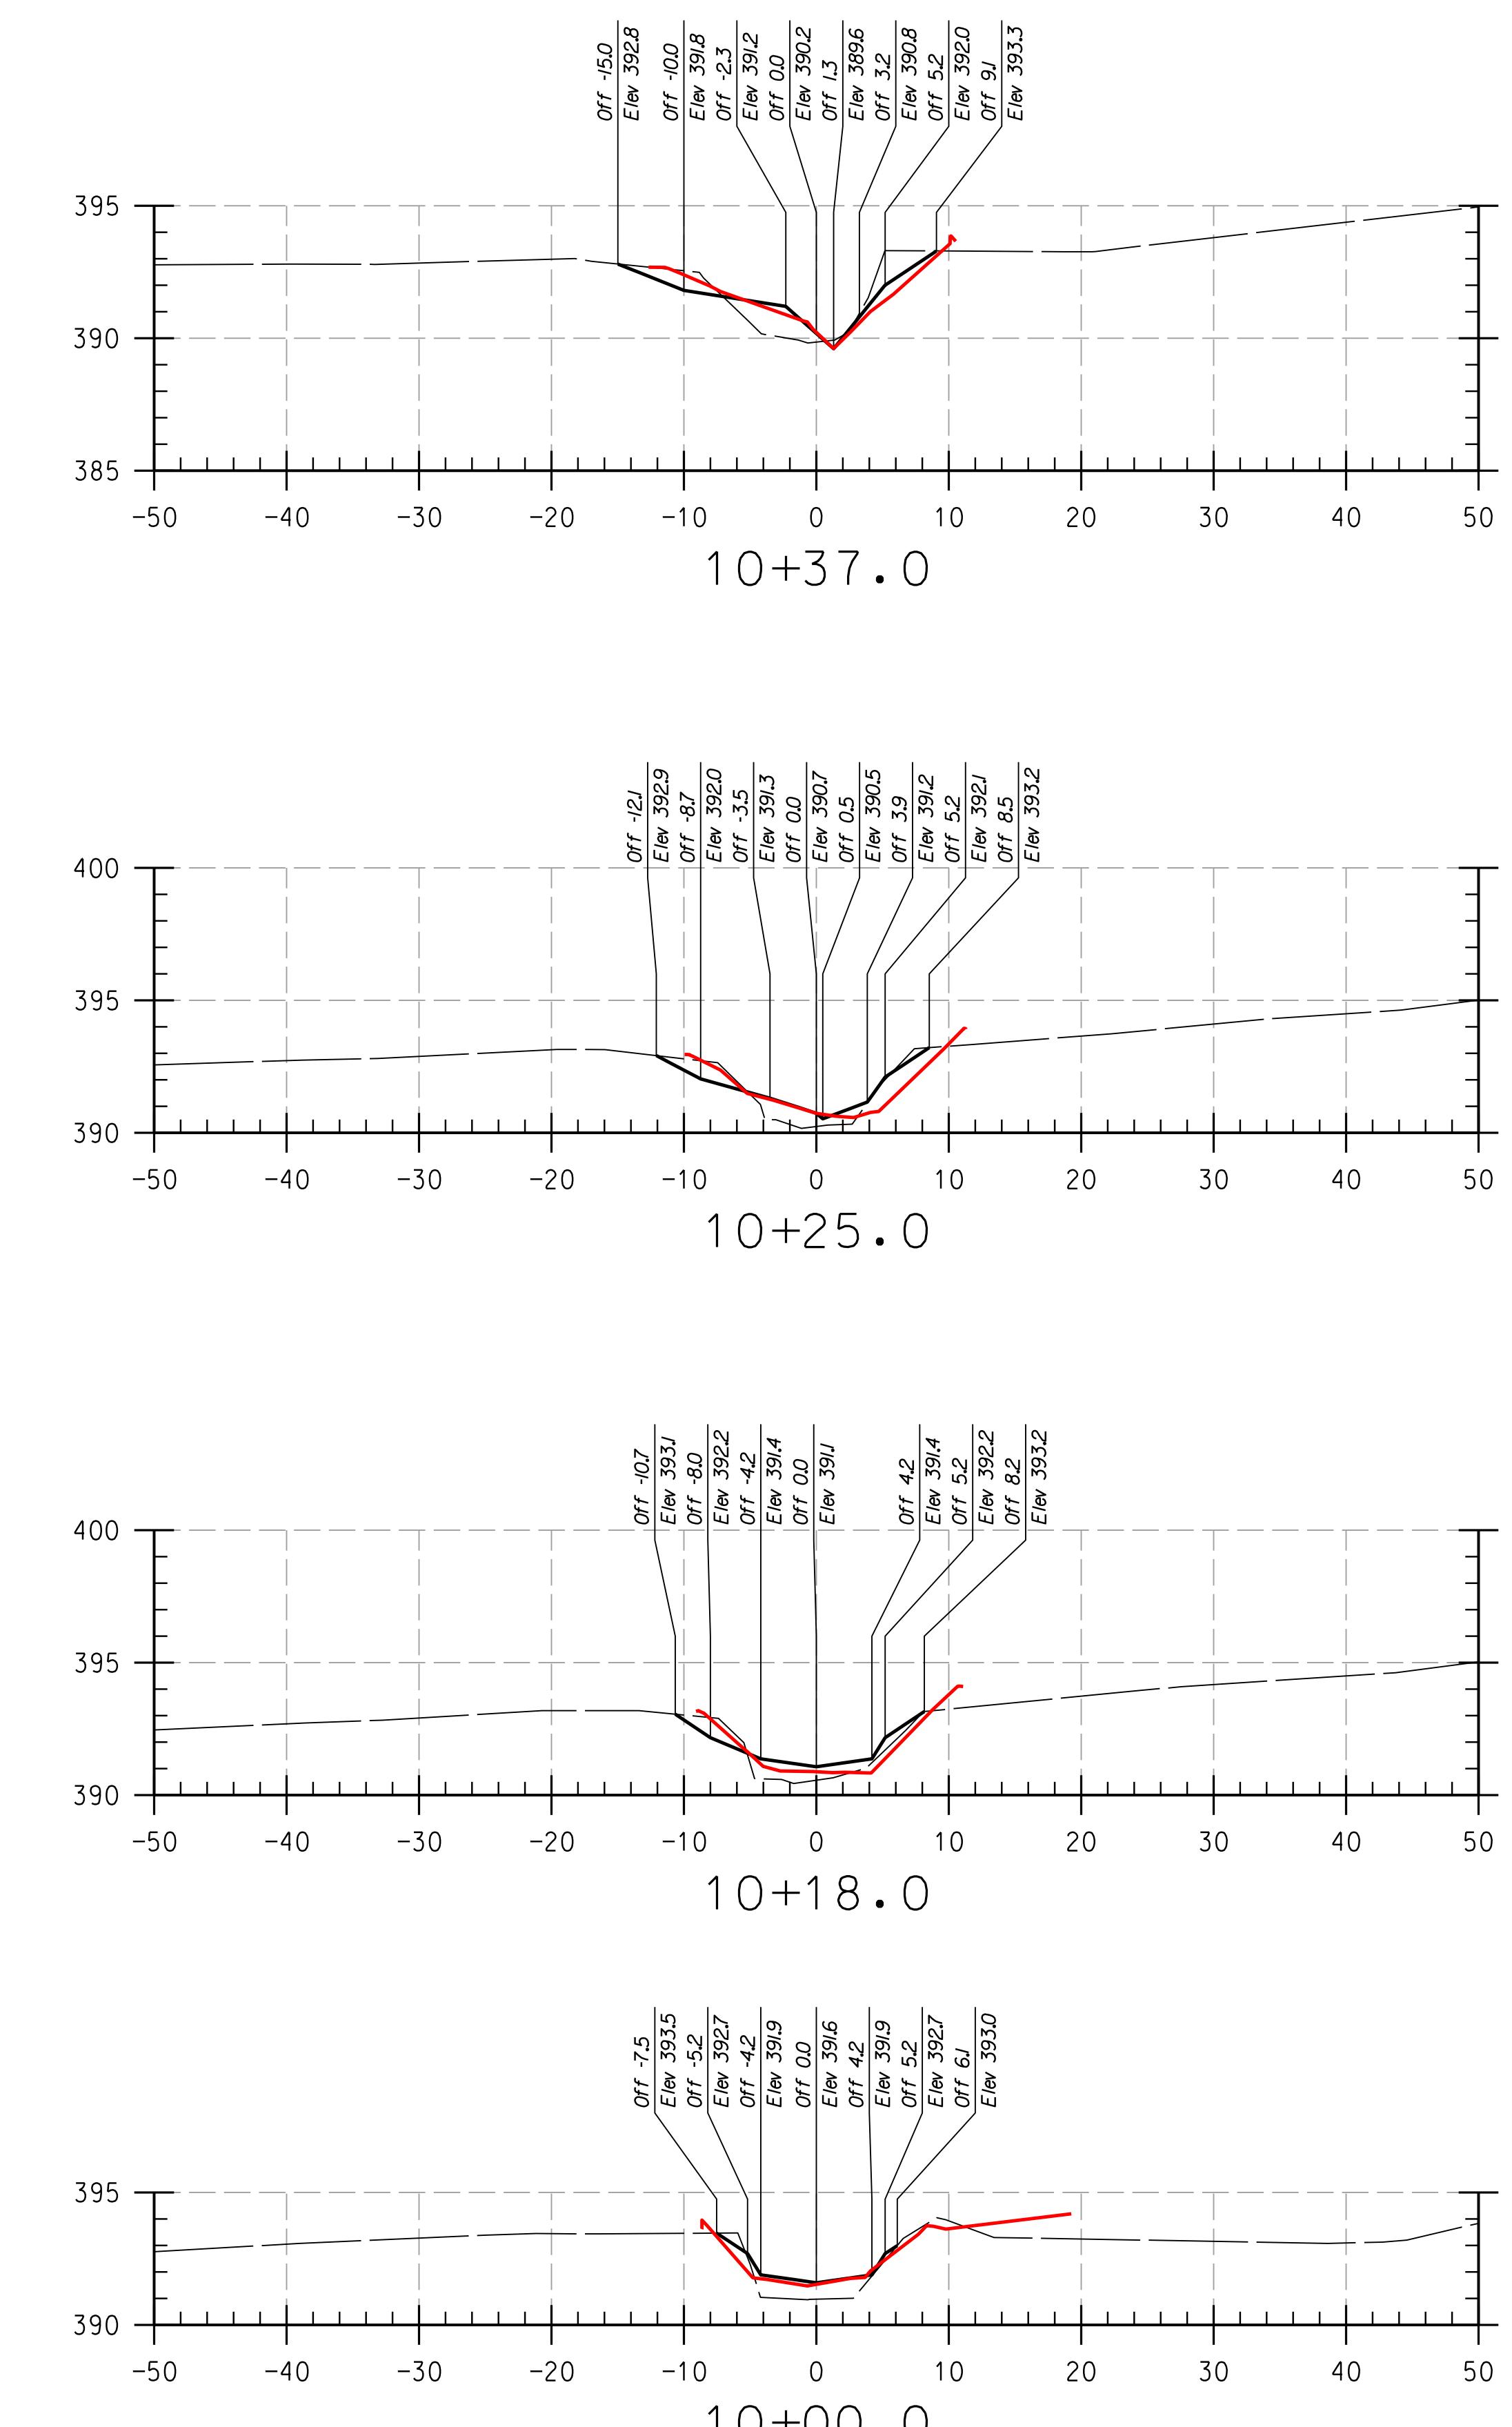

HOWARD COMMUNITY COLLEGE
 STREAM RESTORATION PROJECT
 CAPITAL PROJECT D-1158
 HOWARD COUNTY DEPARTMENT OF PUBLIC WORKS
 STORMWATER MANAGEMENT DIVISION
 6751 COLUMBIA GATEWAY DRIVE
 COLUMBIA, MD 21046
 PARCELS 47 & 81 TAX MAP 35-36
 GRID BLOCK 0006
 ZONING POR, NT, ELECTION DISTRICT 06

AS-BUILT CROSS SECTIONS

SCALE: HOR: 1" = 10'
 VERT: 1" = 5'
 DATE: APRIL 2017
 KC JOB NO.: 17133314.83
 CAPITAL PROJECT NO.: D-1158
 PERMIT ISSUE:
 CONSTRUCTION ISSUE:


CS-12

SHEET NO.: 12 OF 27

KC FILE: M:\2013\17133314.83\
 NO. REVISIONS DESCRIPTION DATE
 10+37.0 0 10+37.0 04/24/2017
 10+25.0 0 10+25.0 04/24/2017
 10+18.0 0 10+18.0 04/24/2017
 10+00.0 0 10+00.0 04/24/2017
 10+52.0 0 10+52.0 04/24/2017
 10+75.0 0 10+75.0 04/24/2017
 10+50.0 0 10+50.0 04/24/2017

KCI
 TECHNOLOGIES

PLOTTED 12:28 PM on Monday, April 24, 2017
FILE: C:\CAD\Files\Howard CC\DXS\Howard CC As-Built.dwg
PROFESSIONAL CERTIFICATION, I HEREBY
CERTIFY THAT THESE DOCUMENTS WERE
PREPARED OR APPROVED BY ME AND THAT
I AM A DULY LICENSED PROFESSIONAL
ENGINEER UNDER THE LAWS OF THE STATE
OF MARYLAND, LICENSE NO. 38311,
EXPIRATION DATE: JANUARY 06, 2018

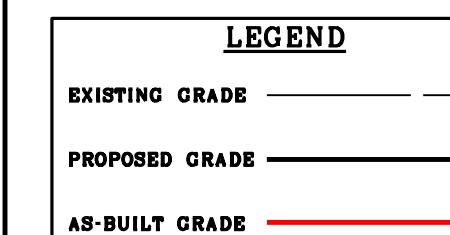

NOTES:
UTILITIES SHOWN ON THESE PLANS HAVE BEEN LOCATED
USING SURVEY DATA PROVIDED BY THE CONTRACTOR.
THE CONTRACTOR IS TO EXERCISE EXTREME CAUTION WHEN
EXCAVATING NEAR ANY UTILITIES TEST PIT IF REQUIRED.

THIS DEVELOPMENT IS APPROVED FOR SOIL EROSION AND SEDIMENT CONTROL
BY THE HOWARD SOIL CONSERVATION DISTRICT.

HOWARD SCD









DATE

DEPARTMENT OF PUBLIC WORKS, HOWARD COUNTY, MD

CHIEF, BUREAU OF ENVIRONMENTAL SERVICES

DATE

REACH 2

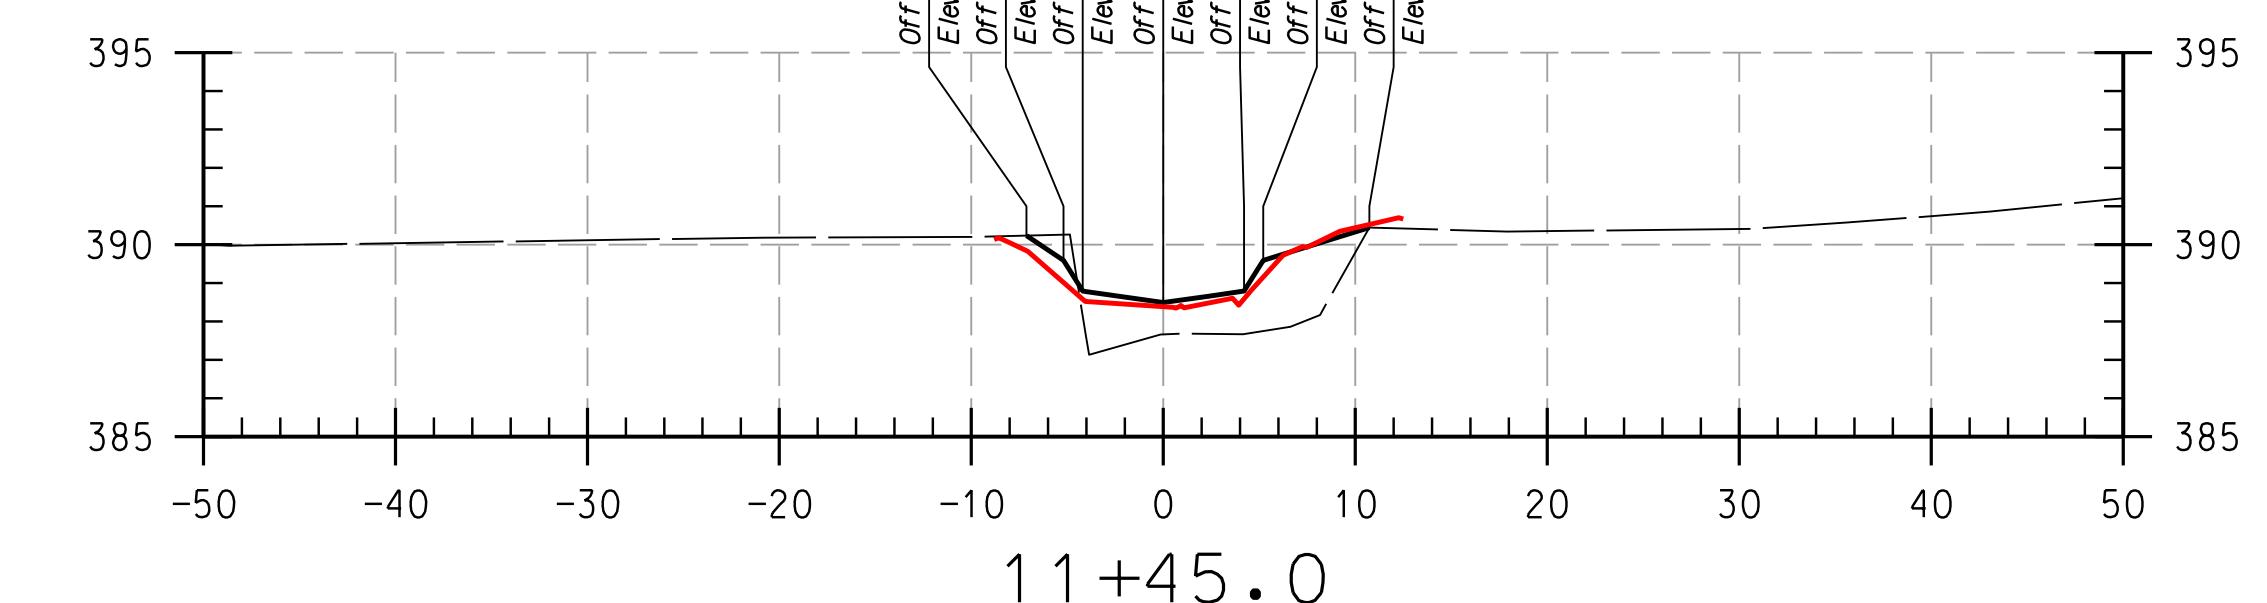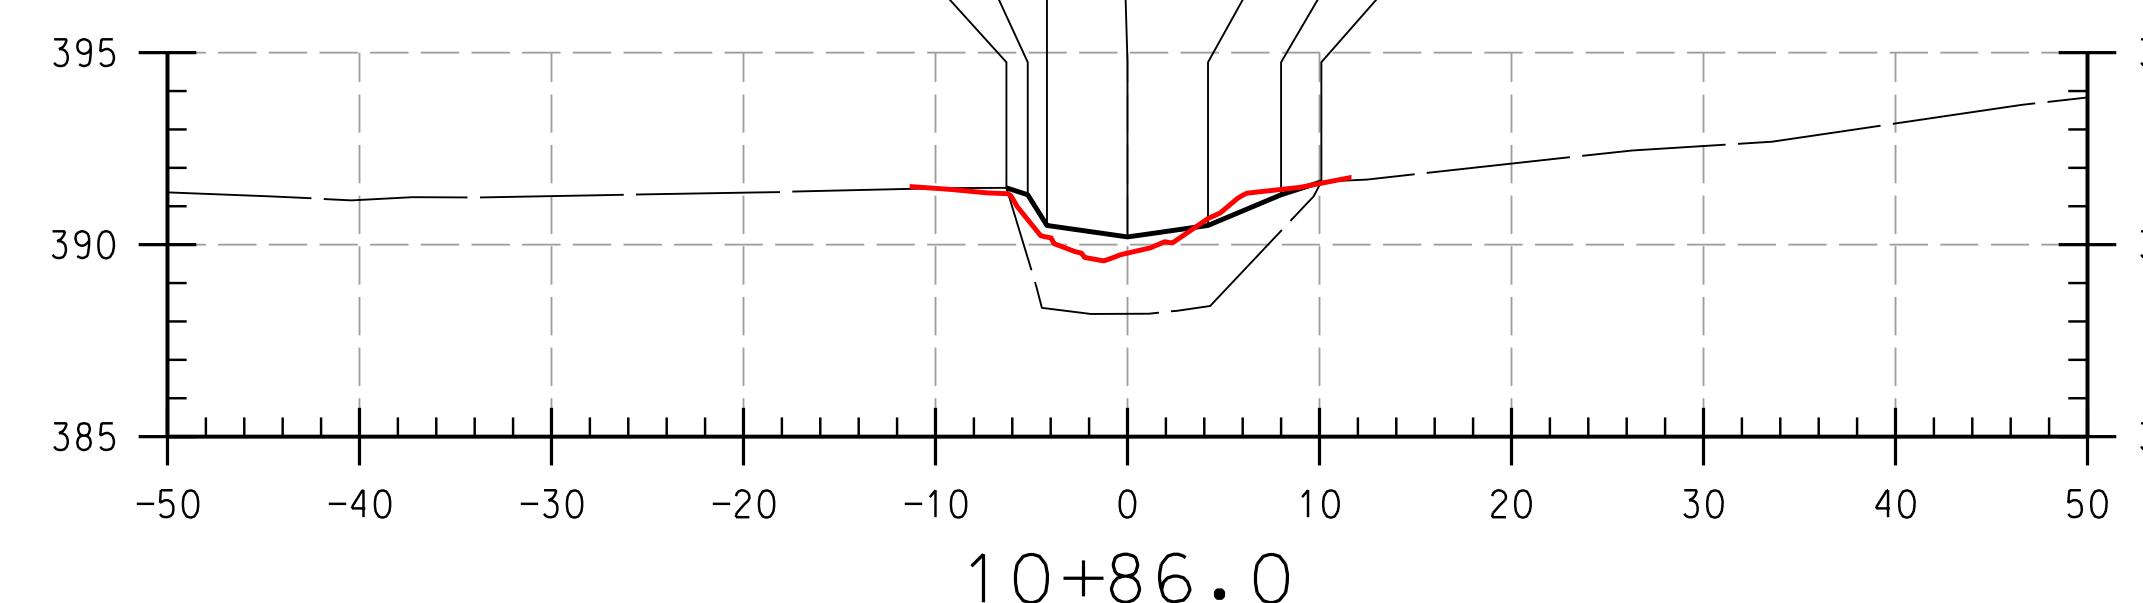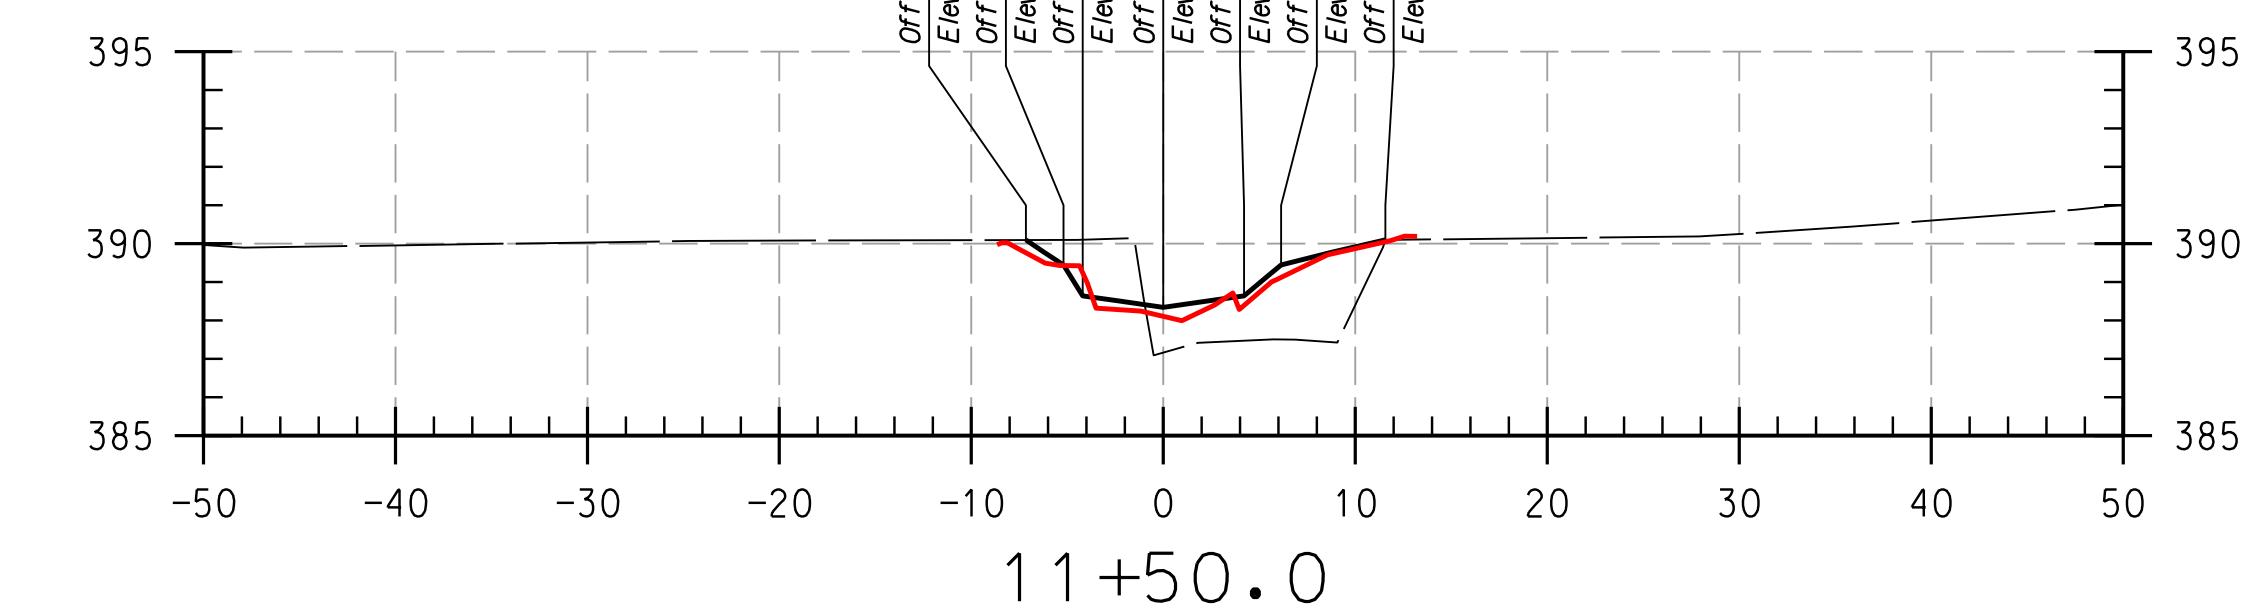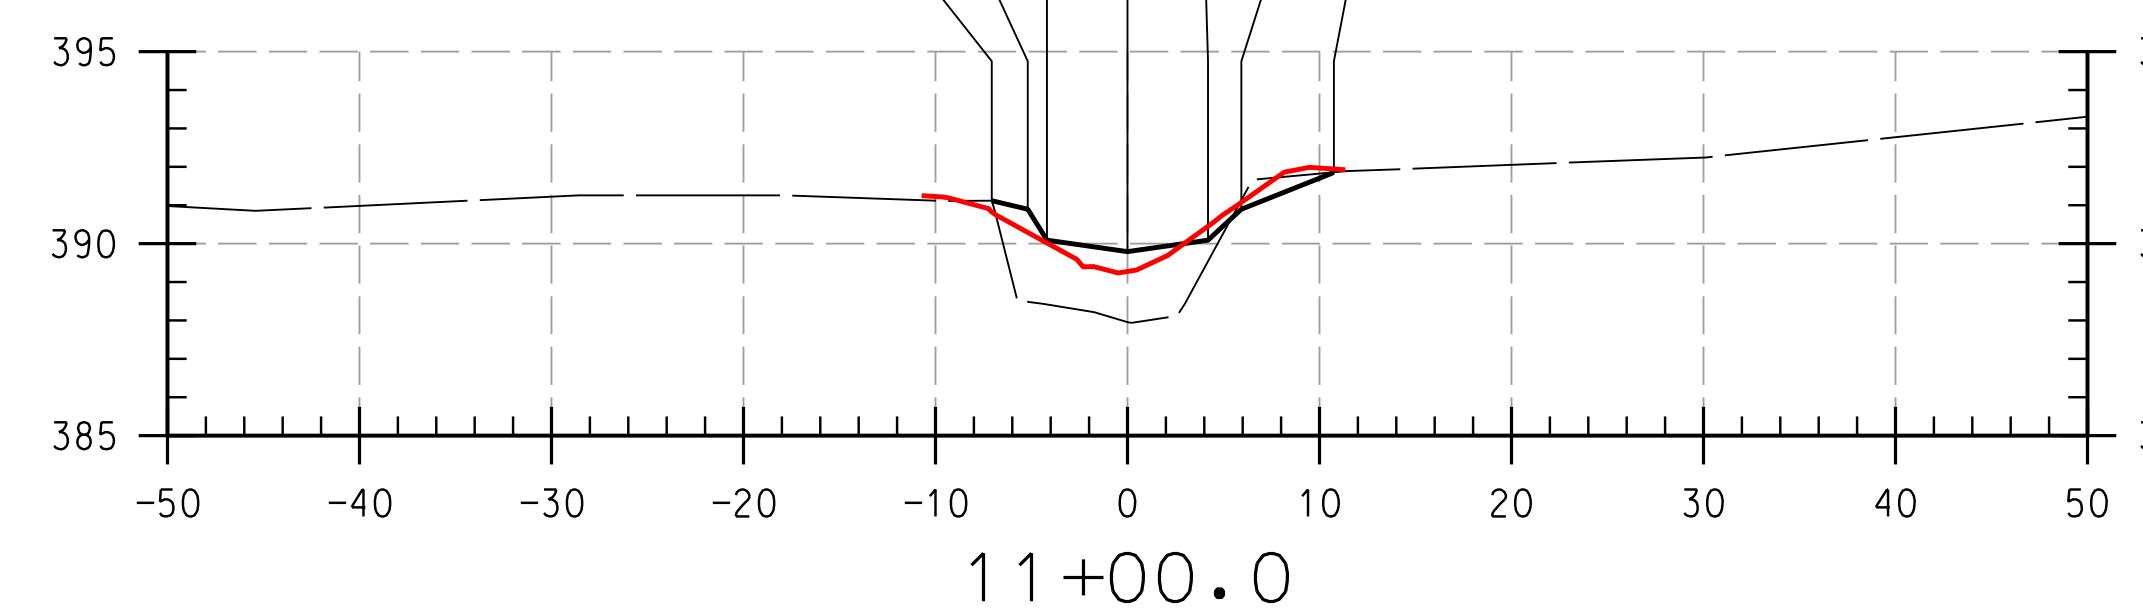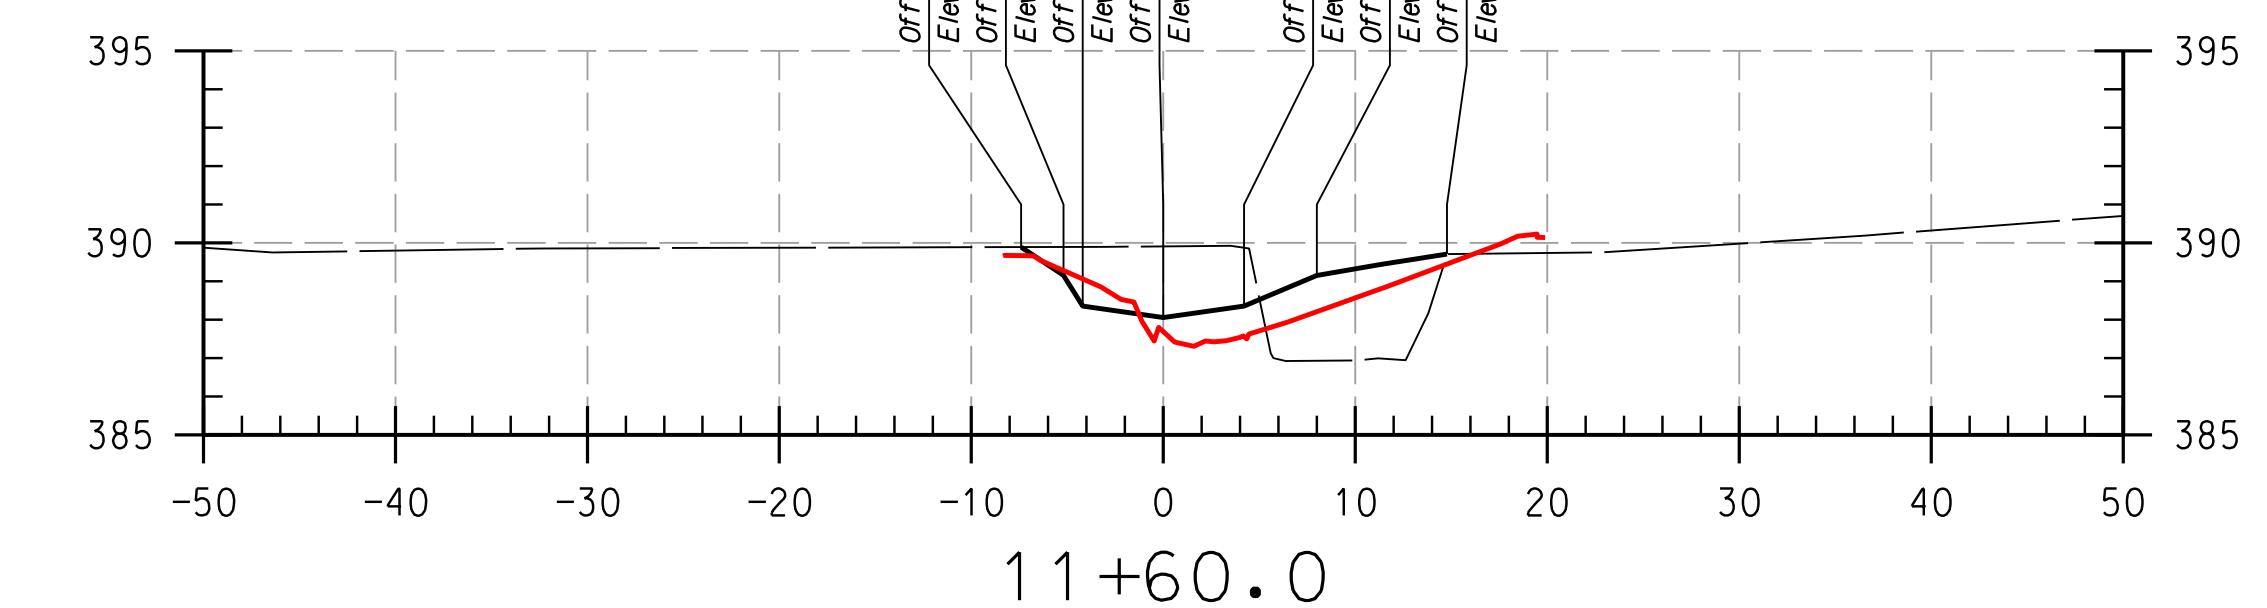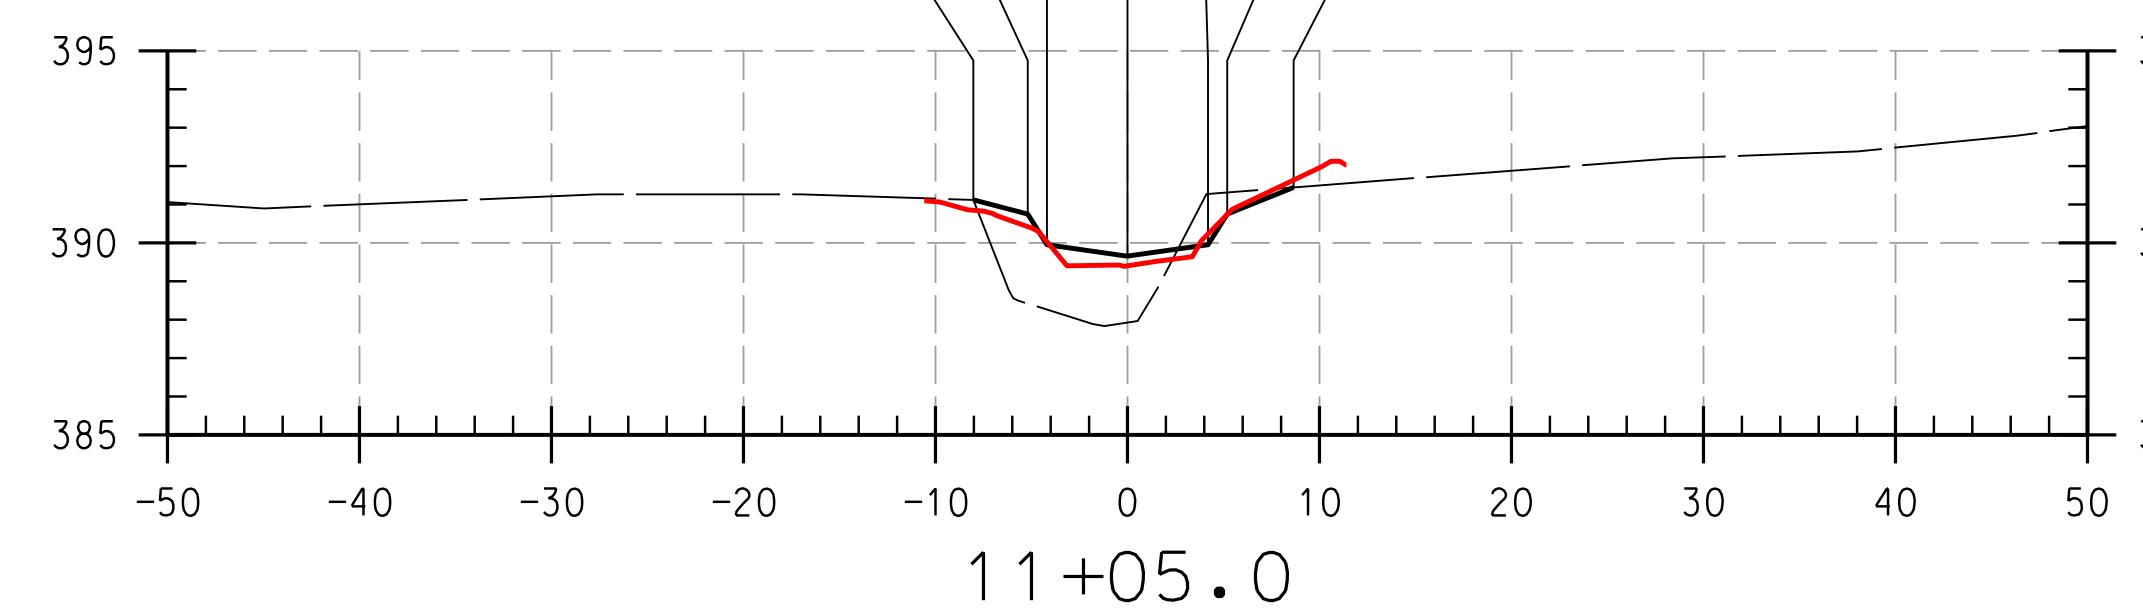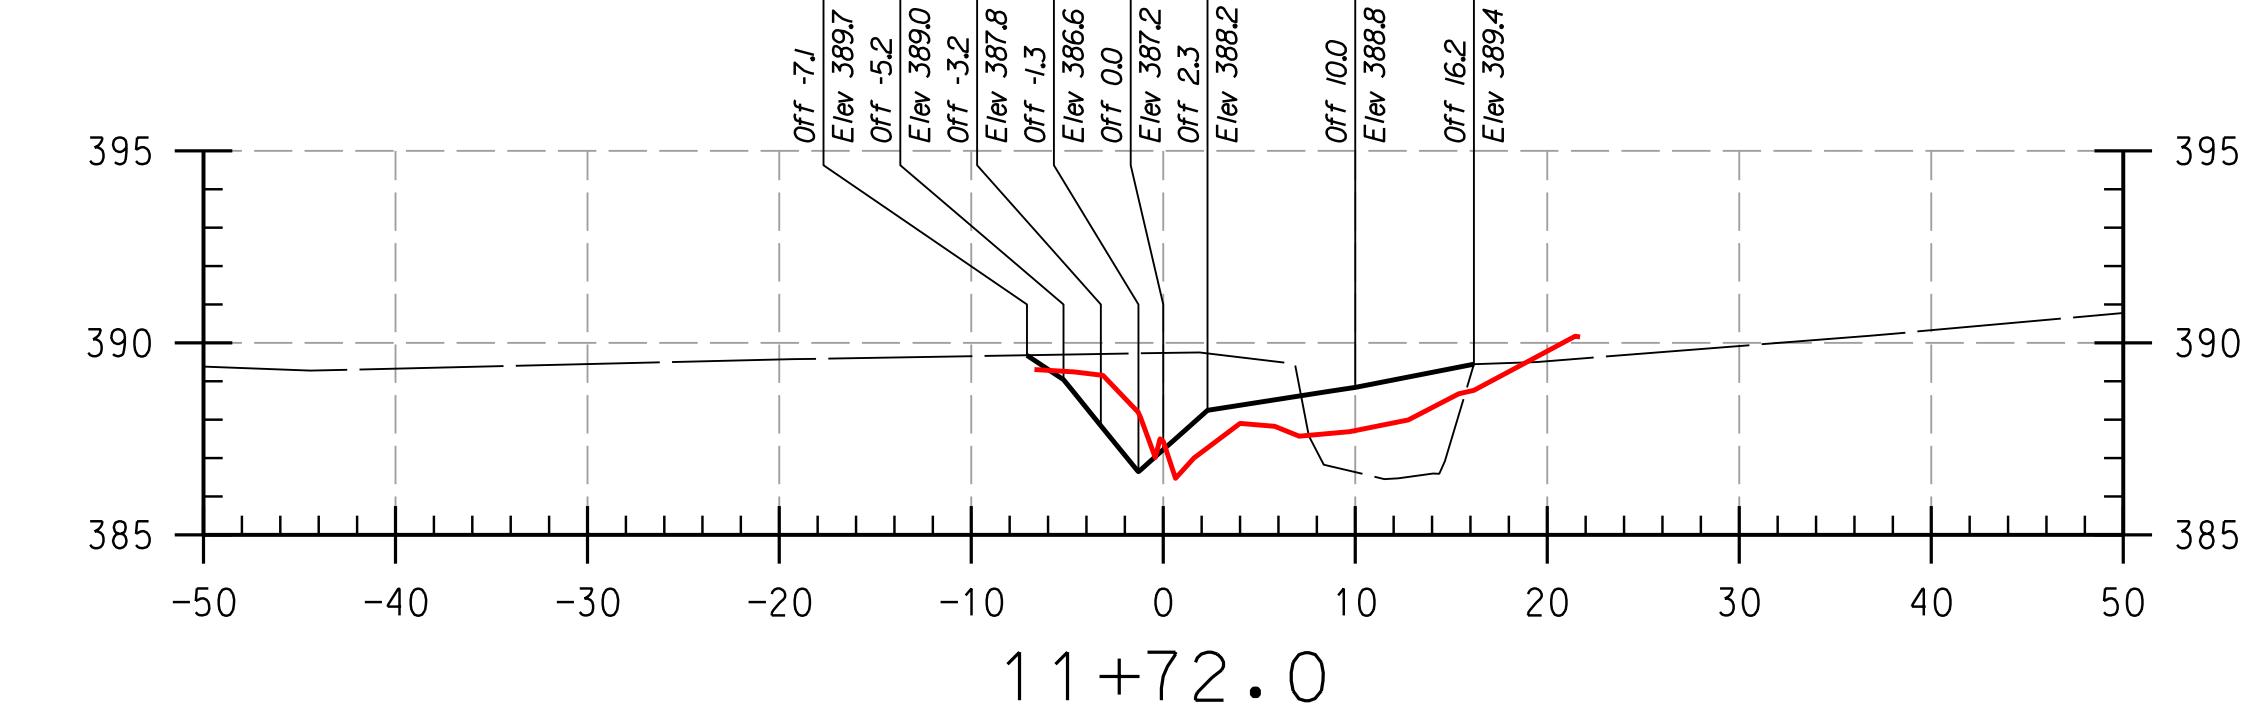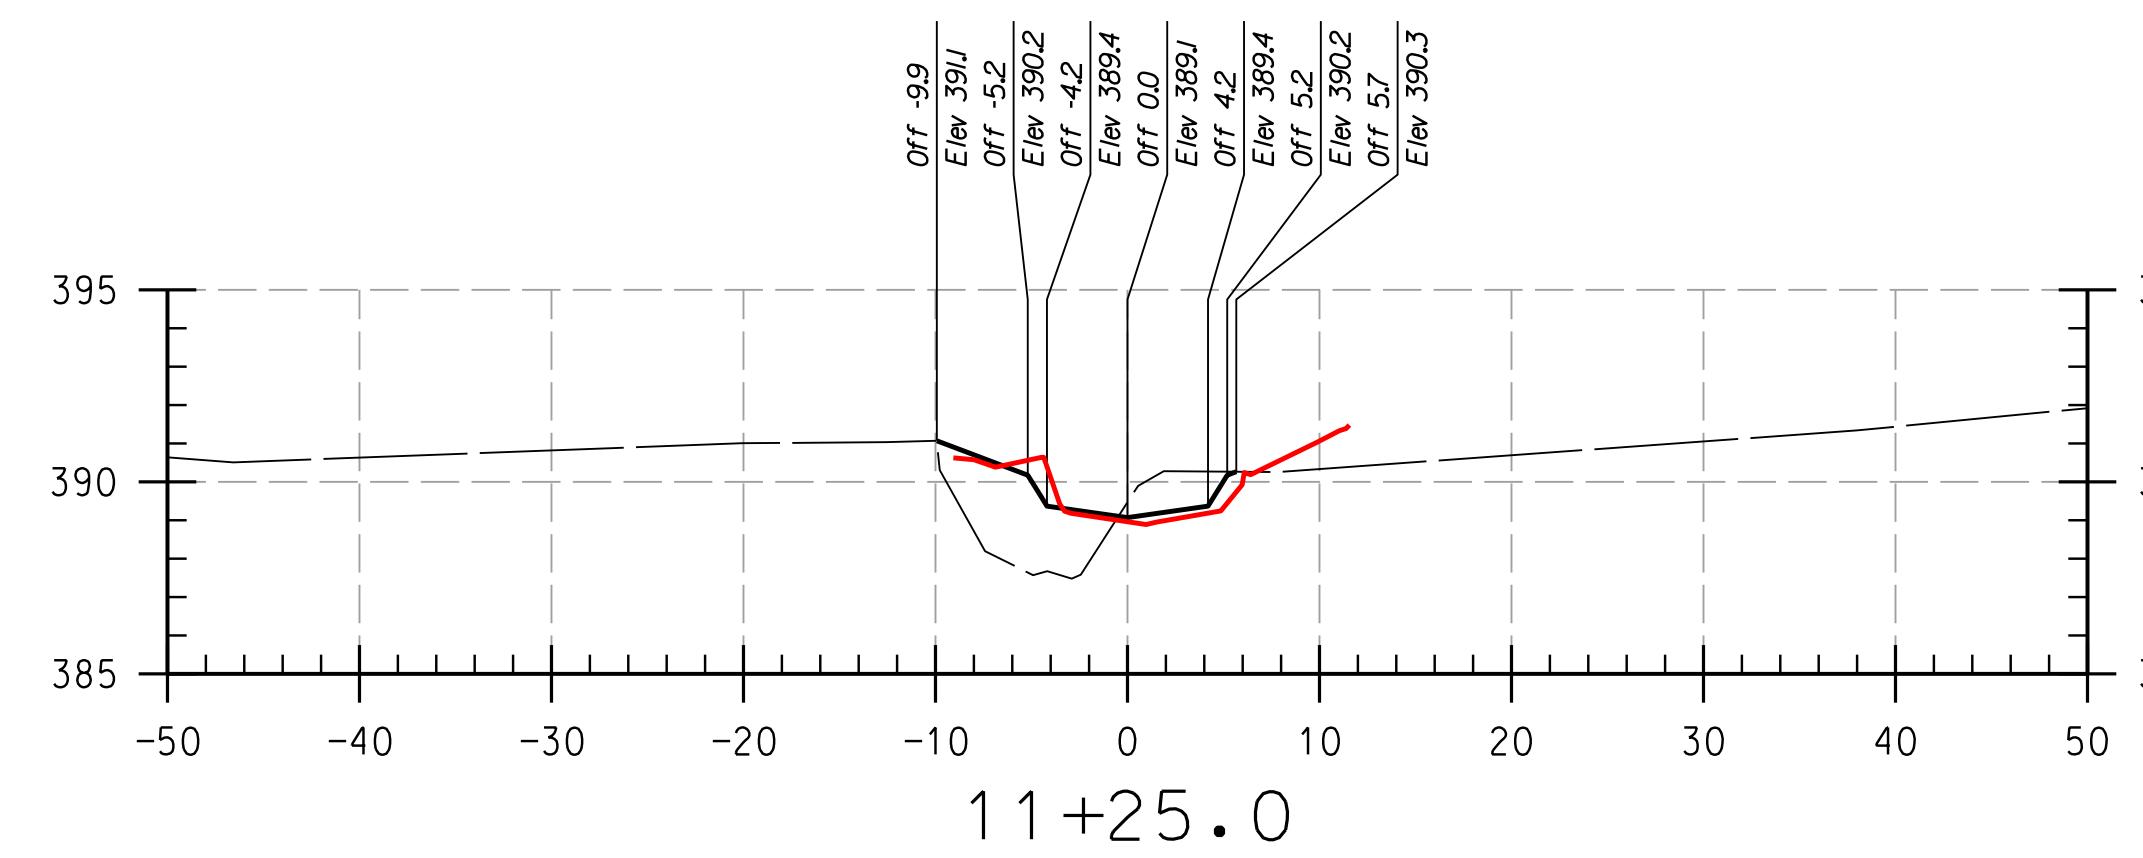

HOWARD COMMUNITY COLLEGE
STREAM RESTORATION PROJECT
CAPITAL PROJECT D-1158
HOWARD COUNTY DEPARTMENT OF PUBLIC WORKS
STORMWATER MANAGEMENT DIVISION
6751 COLUMBIA GATEWAY DRIVE
COLUMBIA, MD 21046
PARCELS 47, 81, TAX MAP 35, 36
GRID BLOCK 0006
ZONING POR, NT, ELECTION DISTRICT 06


AS-BUILT CROSS SECTIONS

SCALE: HOR: 1" = 10'
VERT: 1" = 5'
DATE: APRIL 2017
KCI JOB NO.: 17133314.83
CAPITAL PROJECT NO.: D-1158
PERMIT ISSUE:
CONSTRUCTION ISSUE:

CS-13

SHEET NO.: 13 OF 27

936 RIDGEBROOK ROAD
SPARKS, MARYLAND 21152
TELEPHONE: (410) 316-7800
FAX: (410) 316-7818
www.kci.com

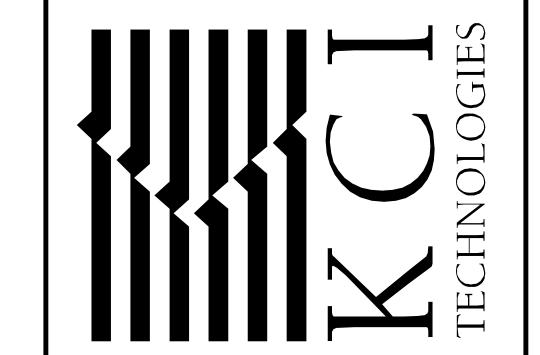


KC FILE: M:\2013\17133314.83\

NO. REVISIONS DESCRIPTION DATE

LOTTED: "12:28 PM on Monday, April 24, 2017"
Y: Division:

PROFESSIONAL CERTIFICATION. I HEREBY CERTIFY THAT THESE DOCUMENTS WERE PREPARED OR APPROVED BY ME, AND THAT I AM A DULY LICENSED PROFESSIONAL ENGINEER UNDER THE LAWS OF THE STATE OF MARYLAND. LICENSE NO. 38311, EXPIRATION DATE: JANUARY 06, 2018

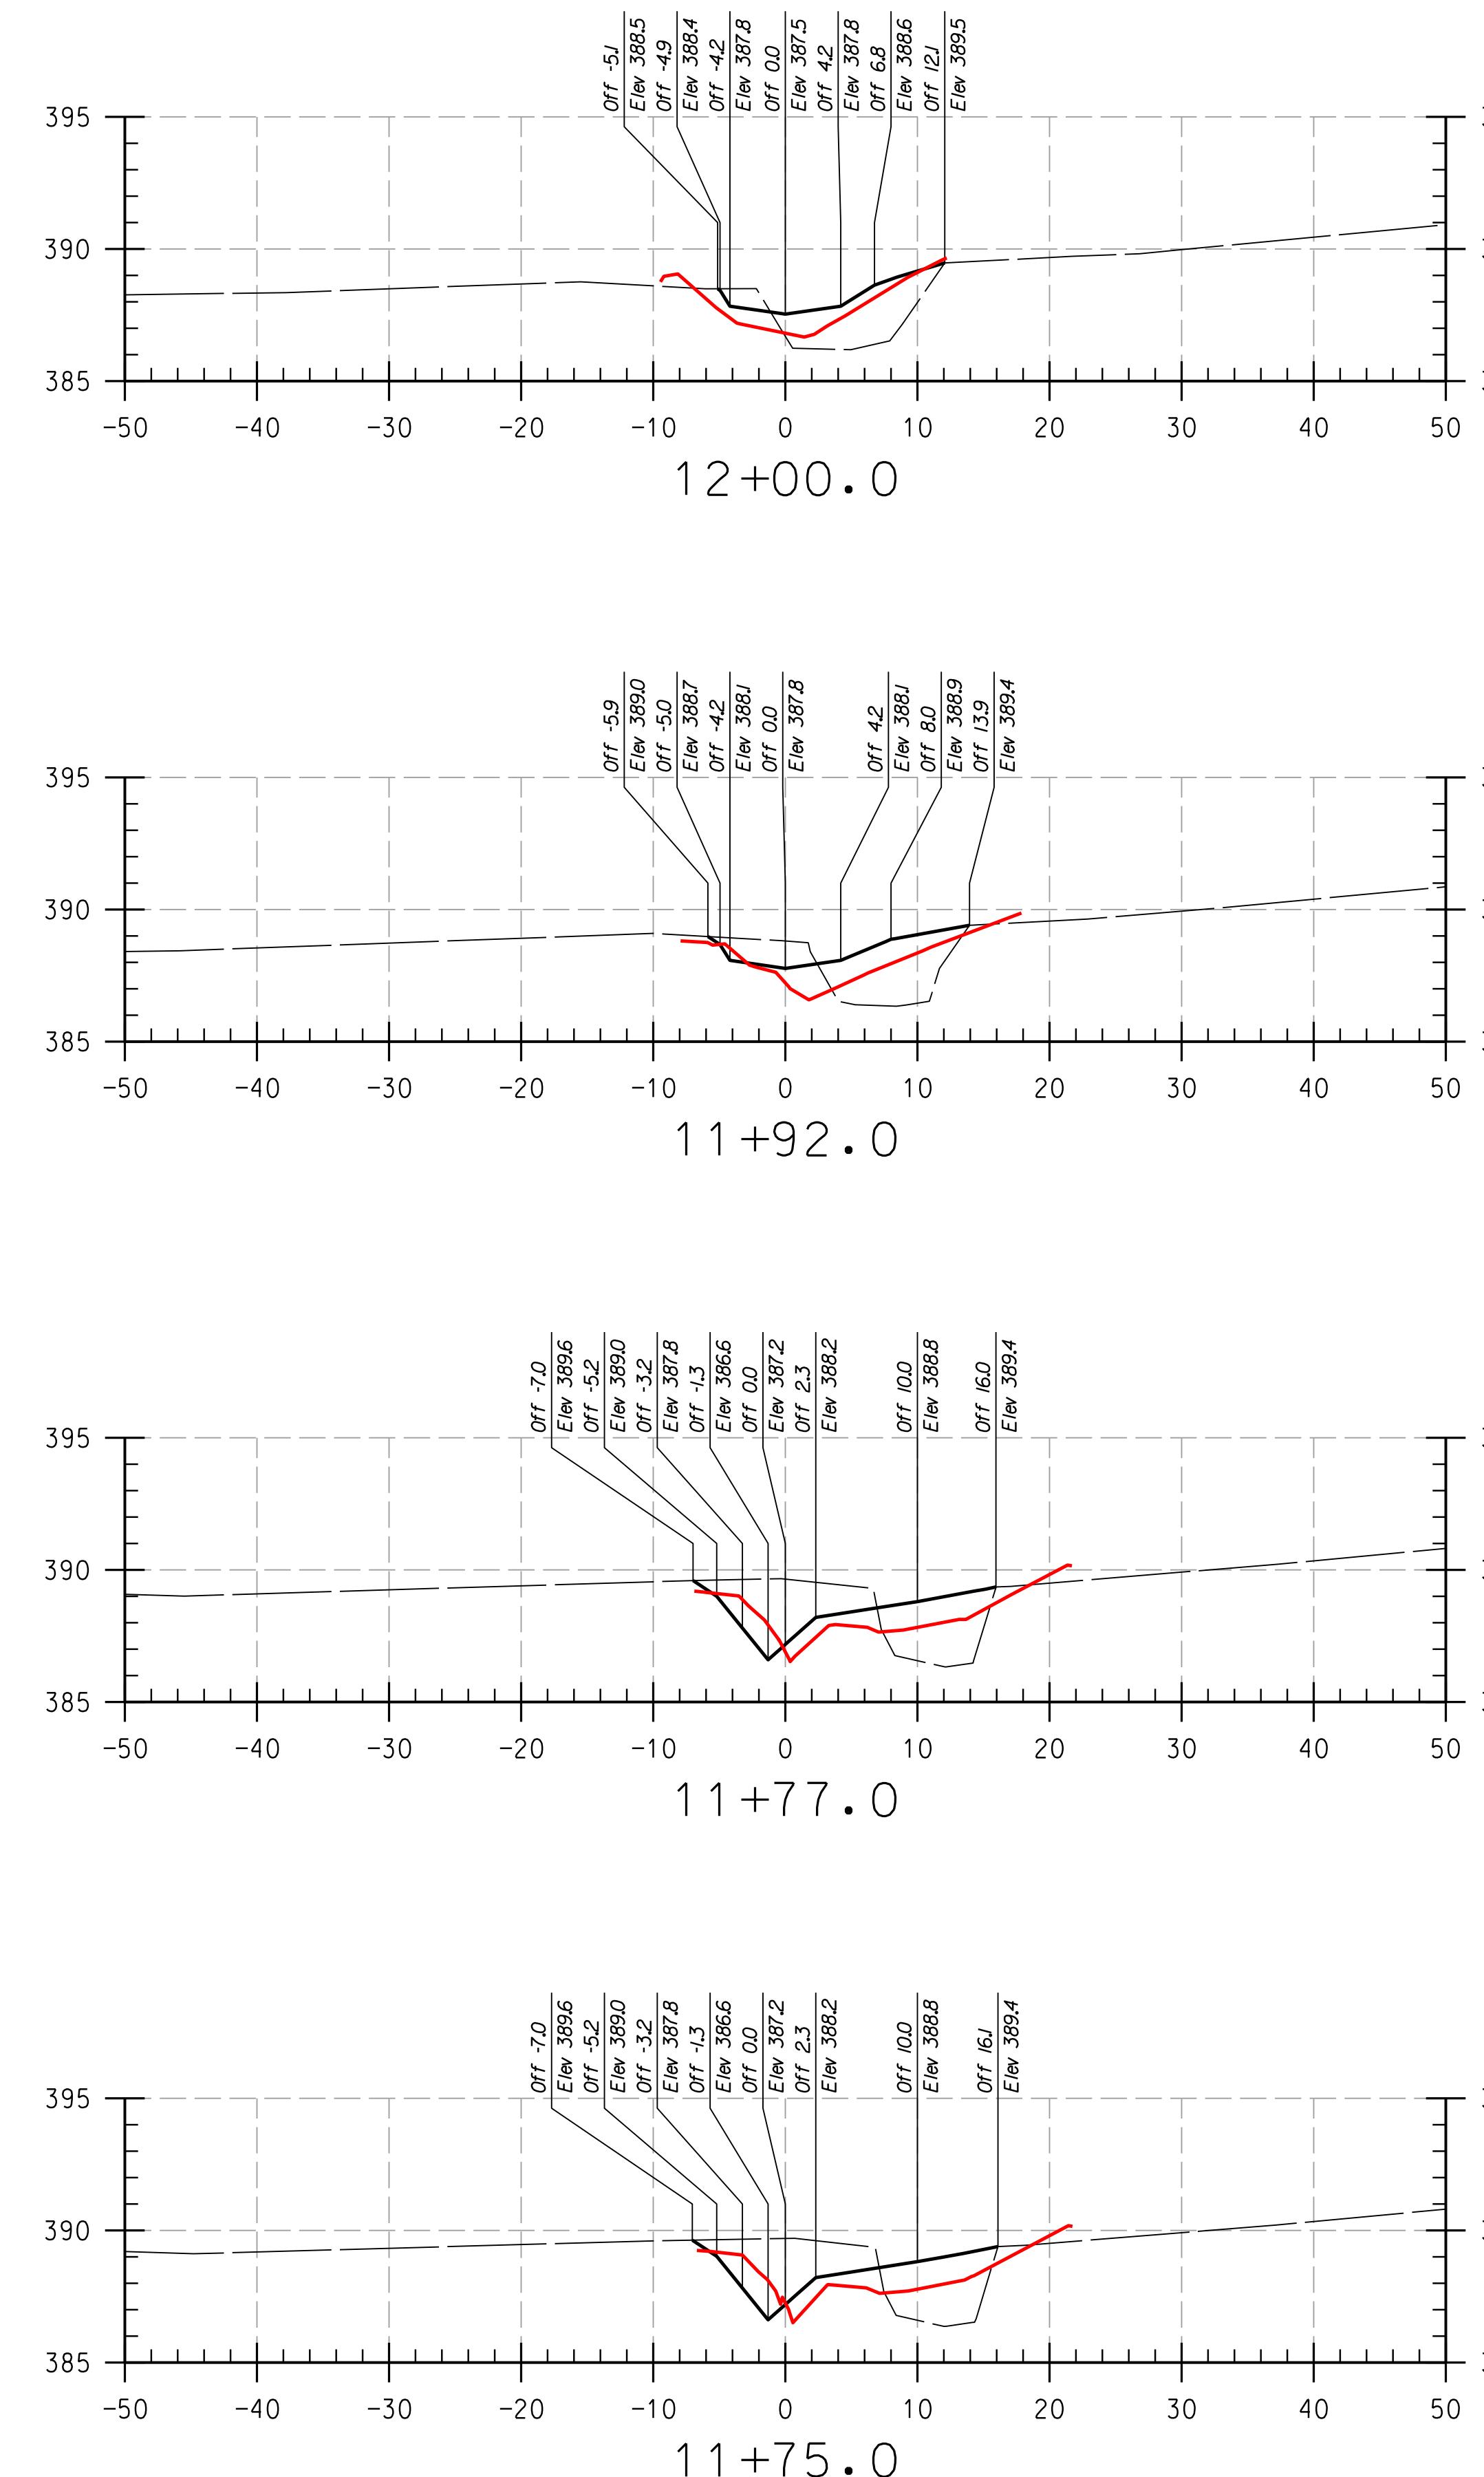

REACH 2

LEGEND

EXISTING GRADE _____

PROPOSED GRADE _____

AS-BUILT GRADE _____

NOTE:
UTILITIES SHOWN ON THESE PLANS HAVE BEEN
USING THE BEST AVAILABLE INFORMATION. HOW-
EVER, CONTRACTOR IS TO EXERCISE EXTREME CAU-
TION IN EXCAVATING NEAR ANY UTILITIES. TEST PIT IF


THIS DEVELOPMENT IS APPROVED FOR SOIL EROSION AND SEDIMENT CONTROL
BY THE HOWARD SOIL CONSERVATION DISTRICT.

ATE

1

DEPARTMENT OF PUBLIC WORKS, HOWARD COUNTY.

1




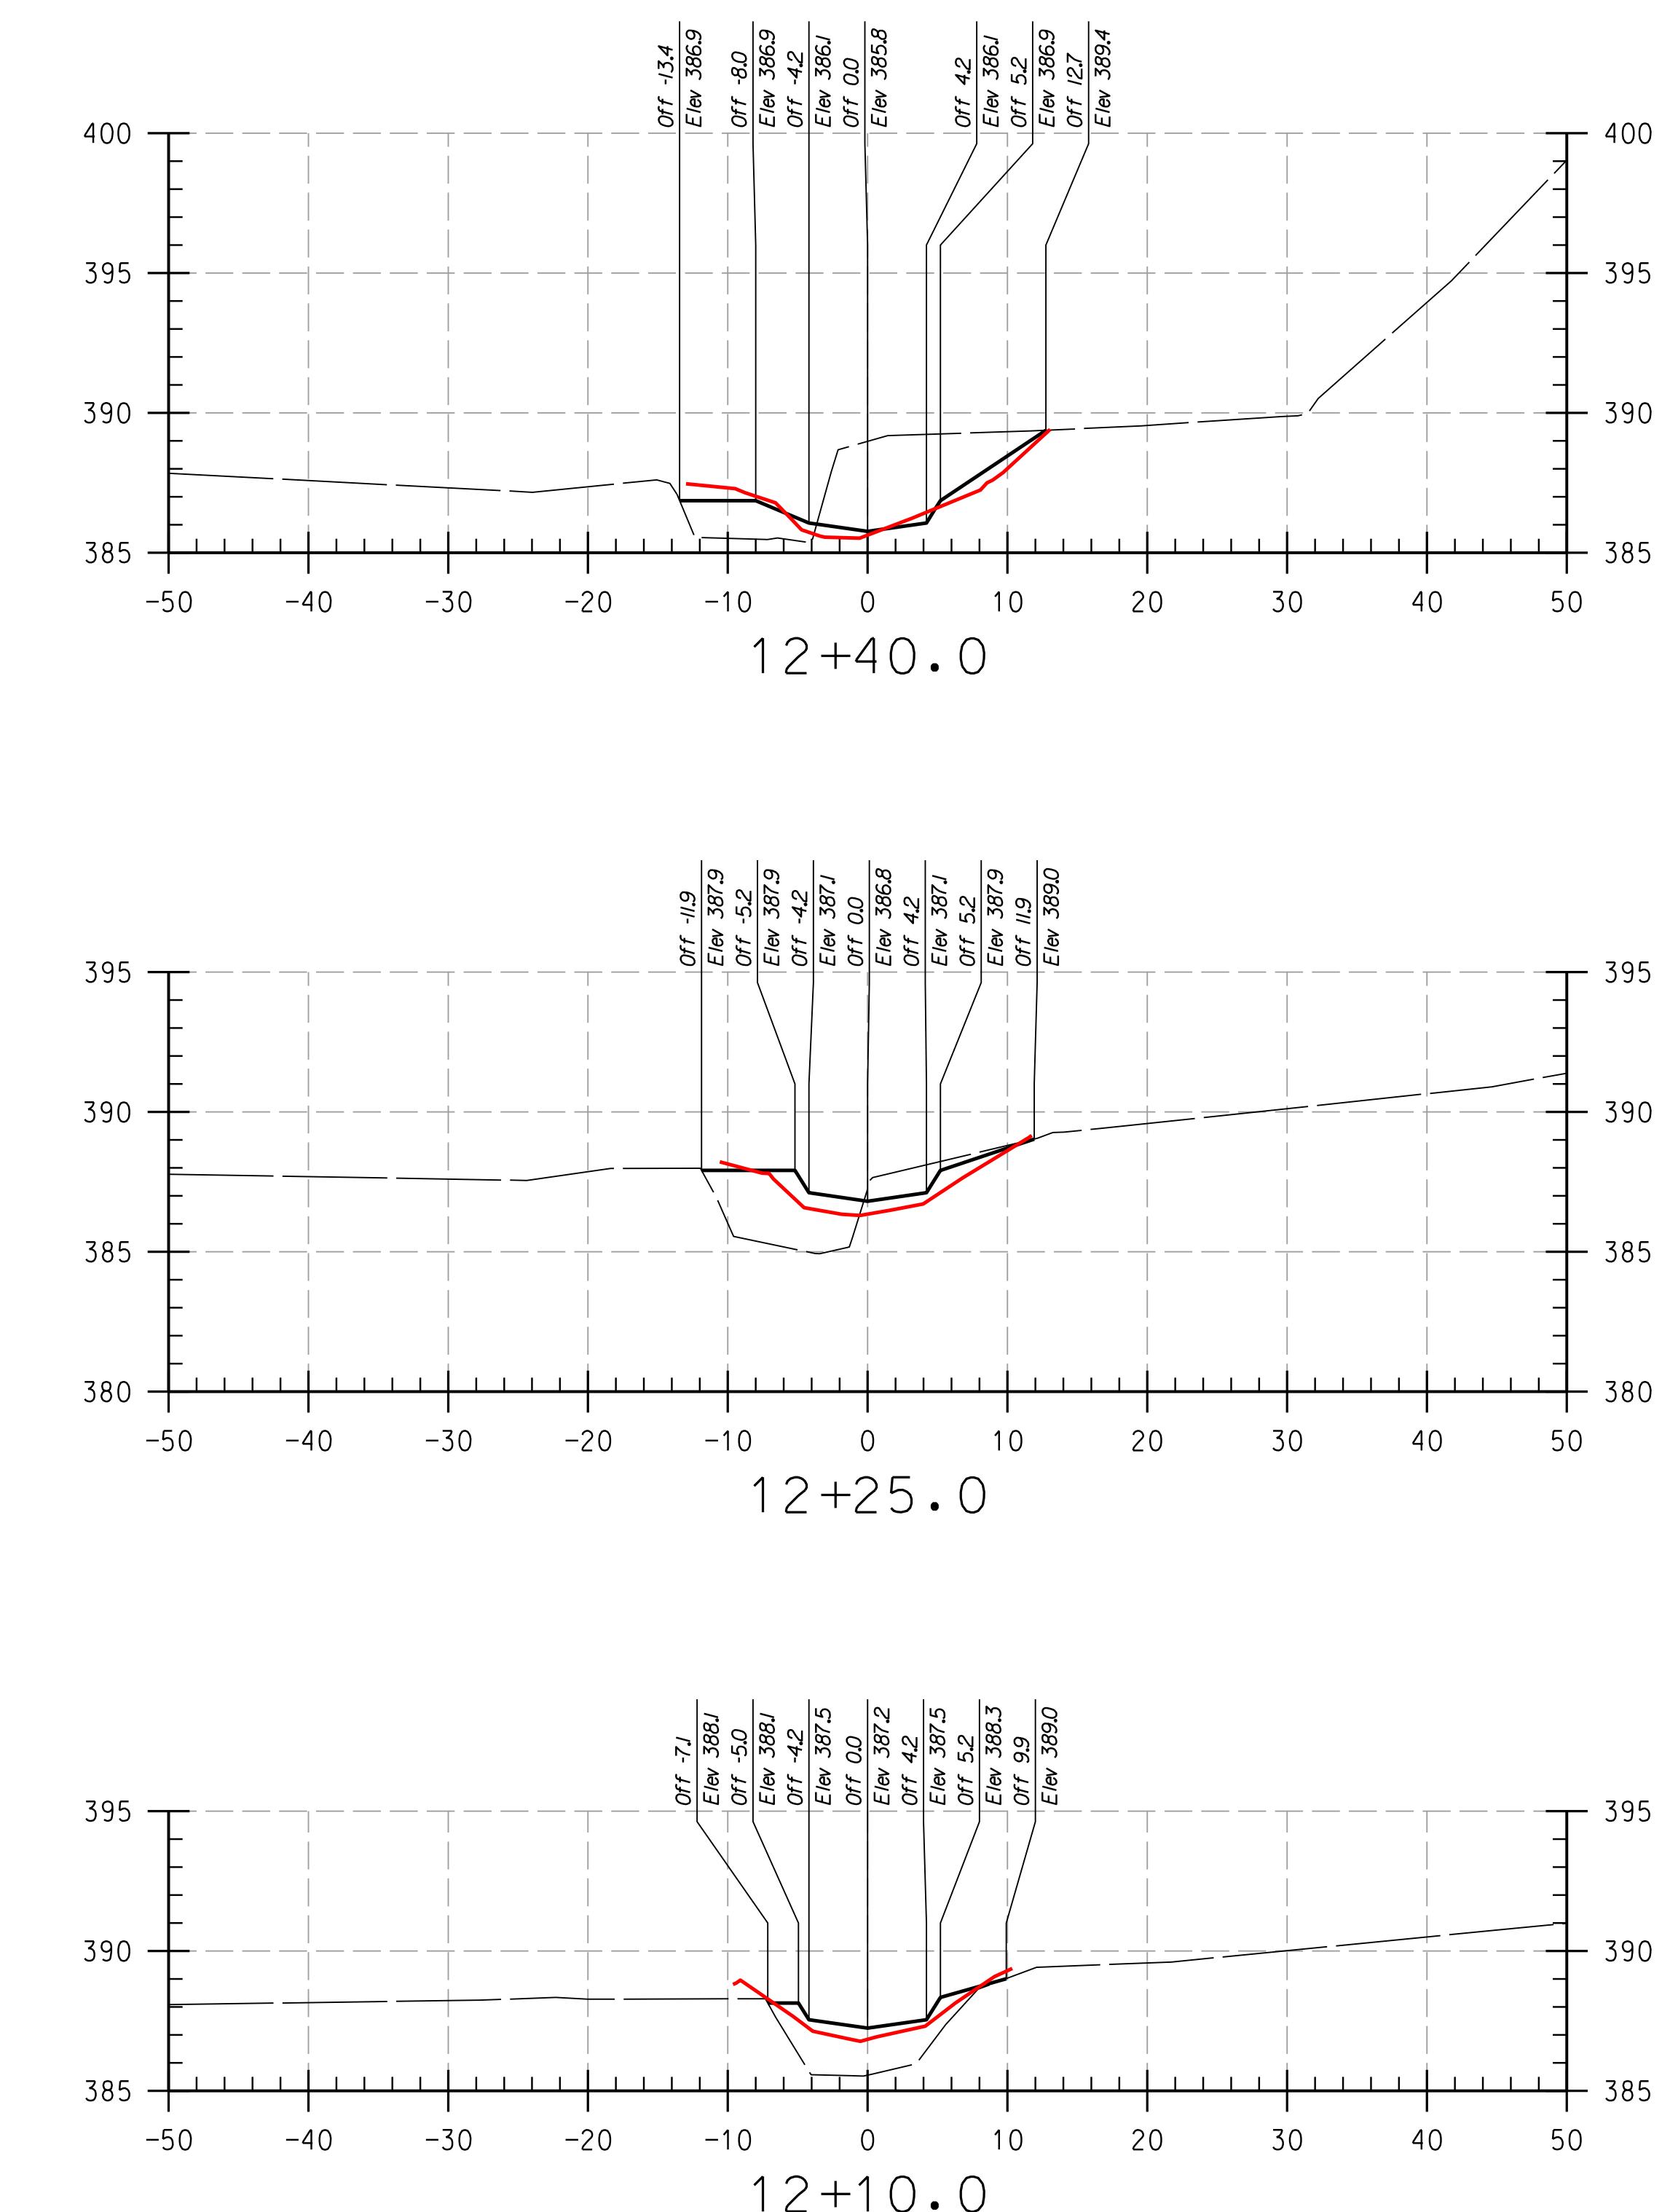


AS-BUILT CROSS SECTIONS

SCALE: HOR: 1" = 10'
VERT: 1" = 5'
DATE: APRIL 2017
KCI JOB NO.: 17133314.83
CAPITAL PROJECT NO.: D-1158
PERMIT ISSUE:
CONSTRUCTION ISSUE:

CS-14

SHEET NO.: 14 OF 27

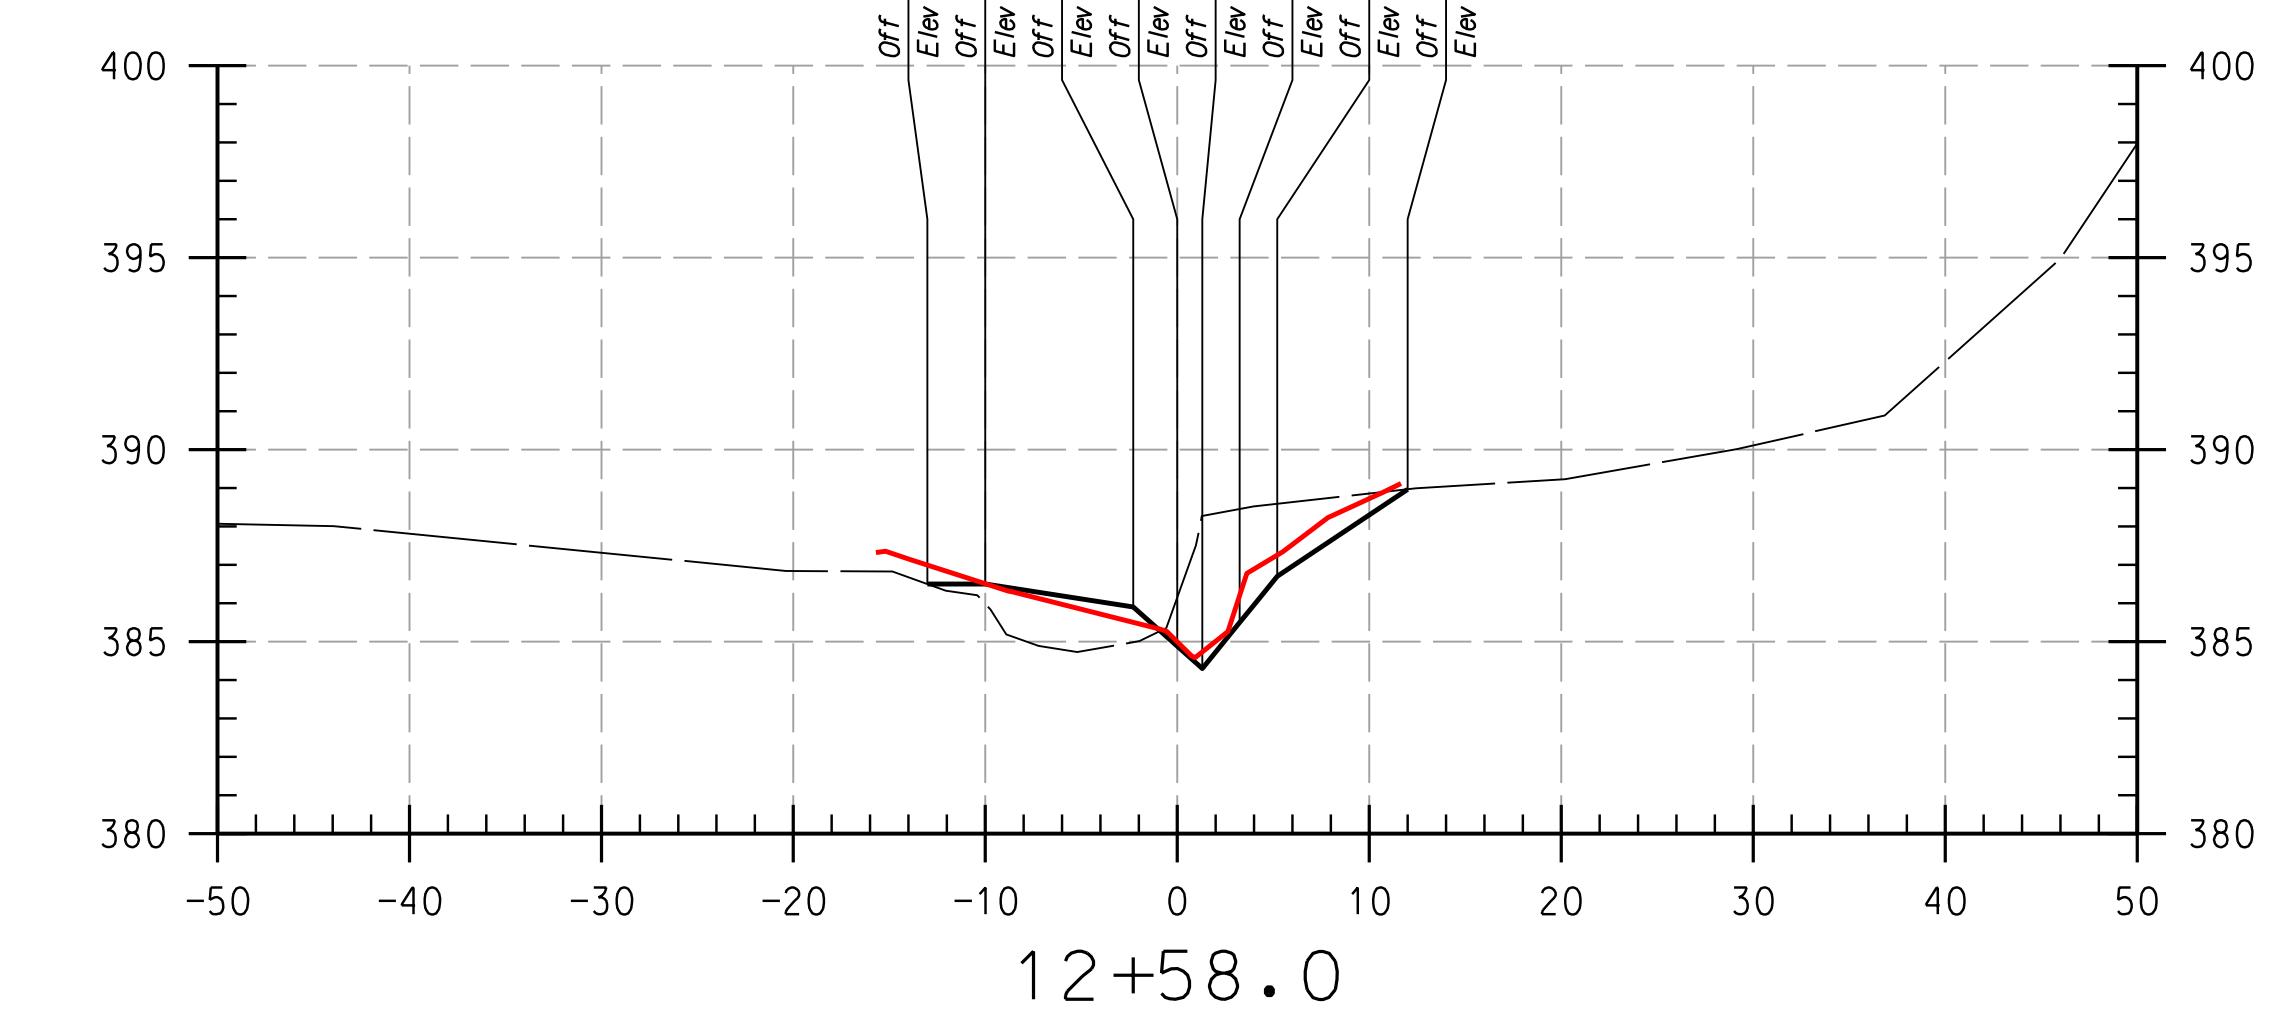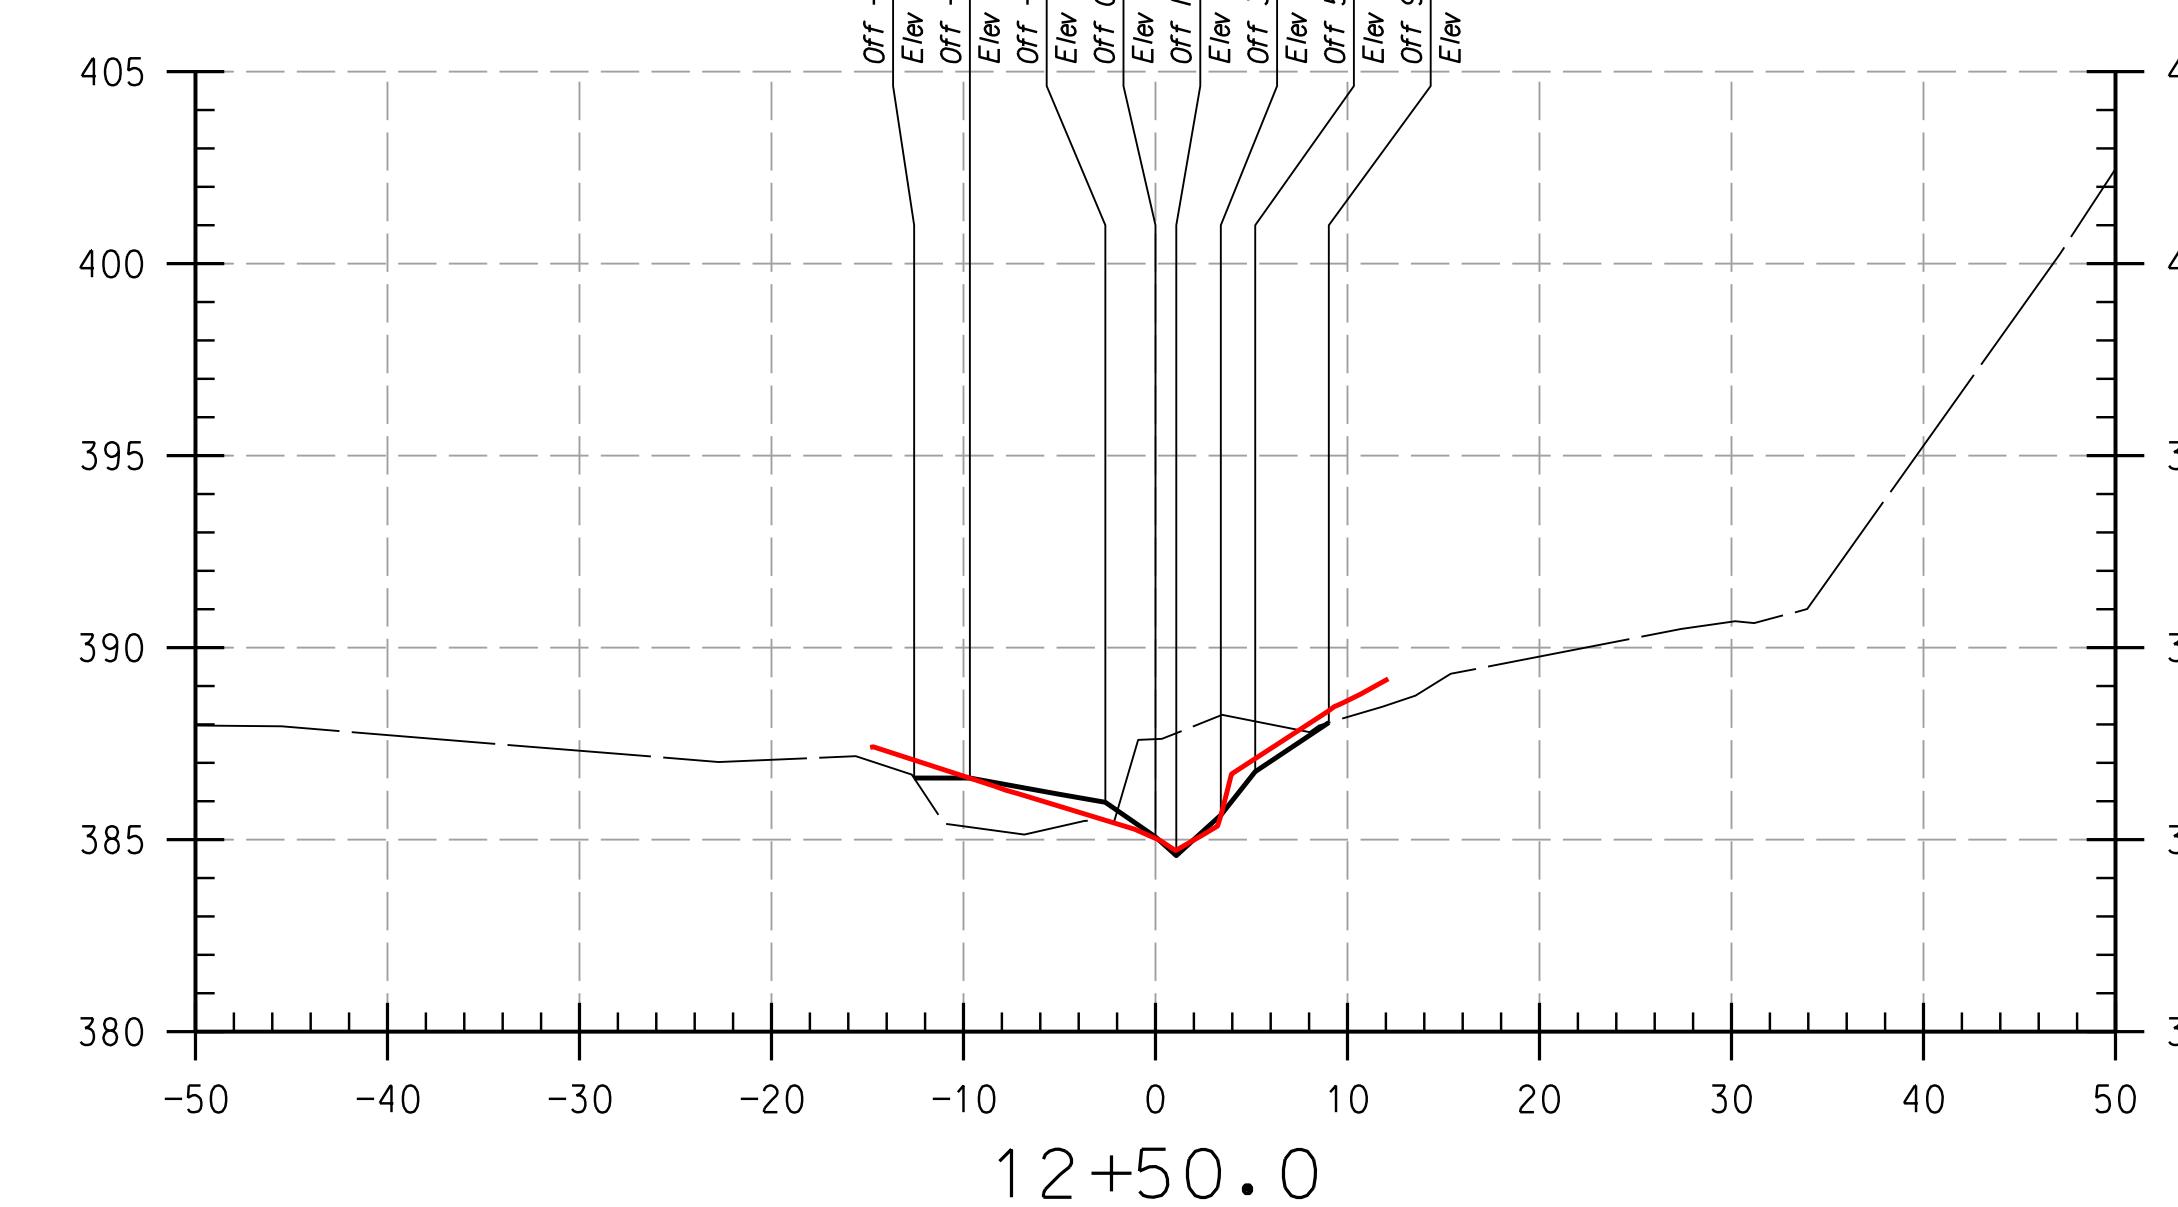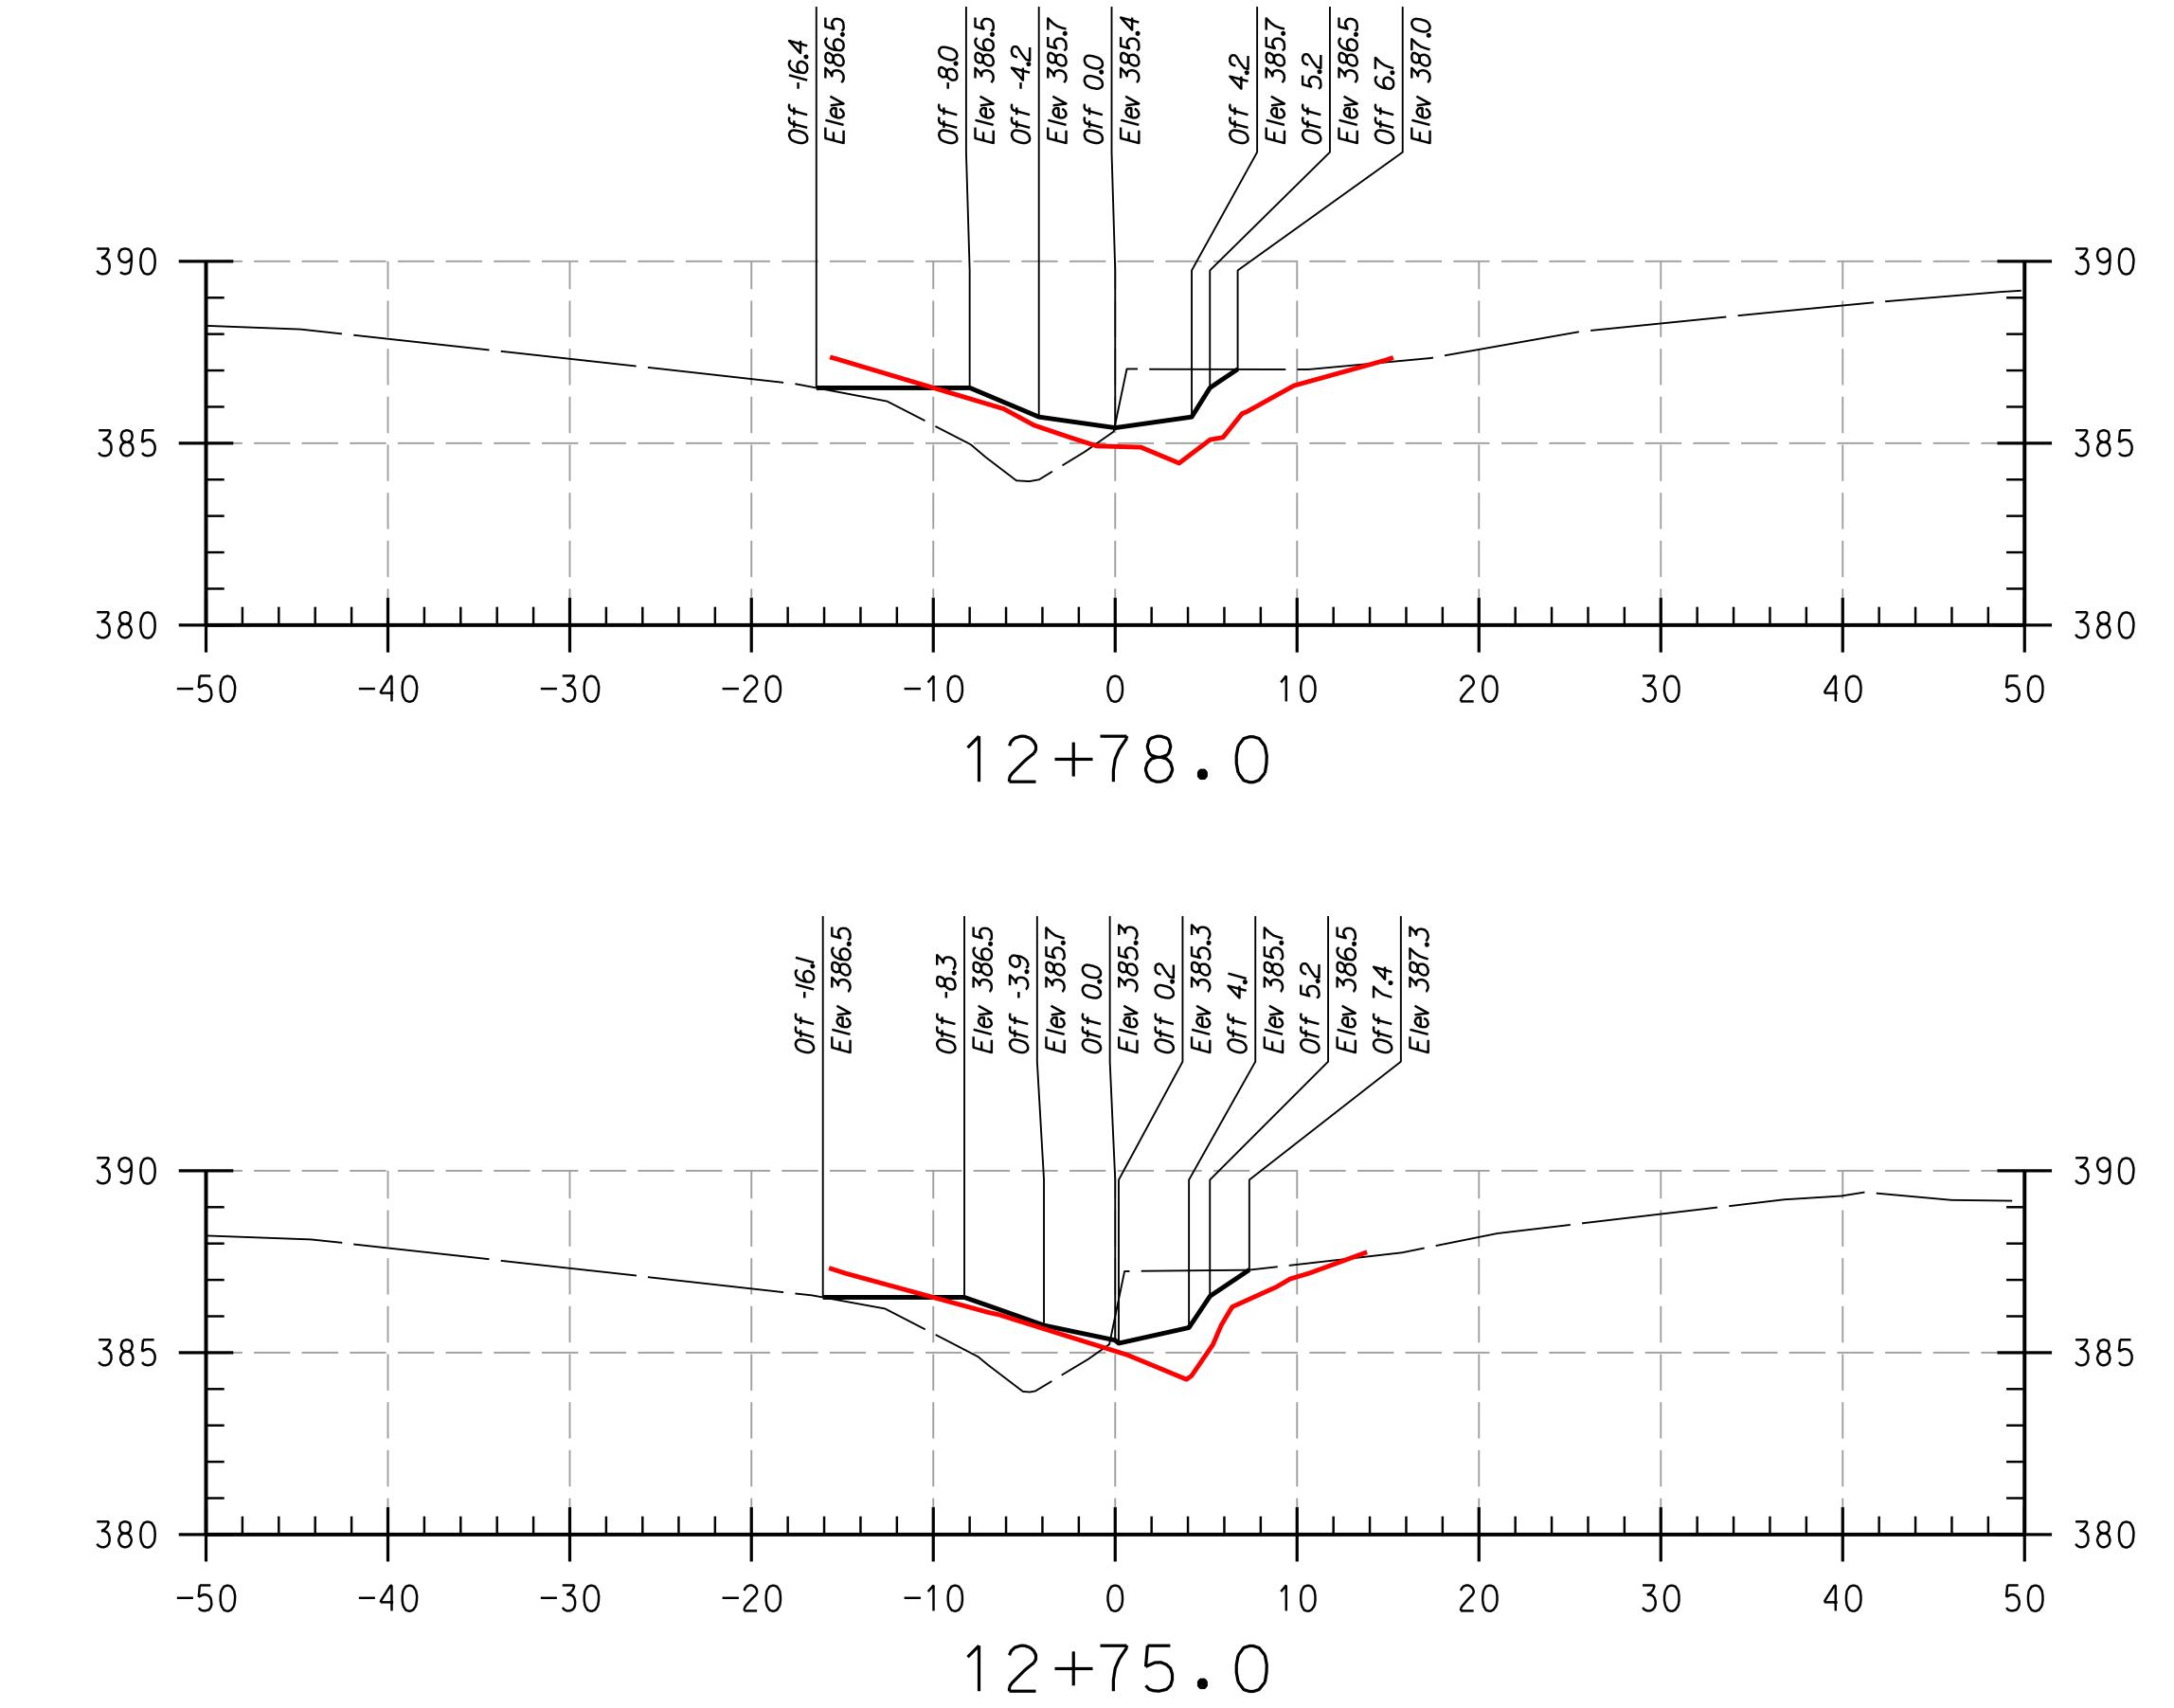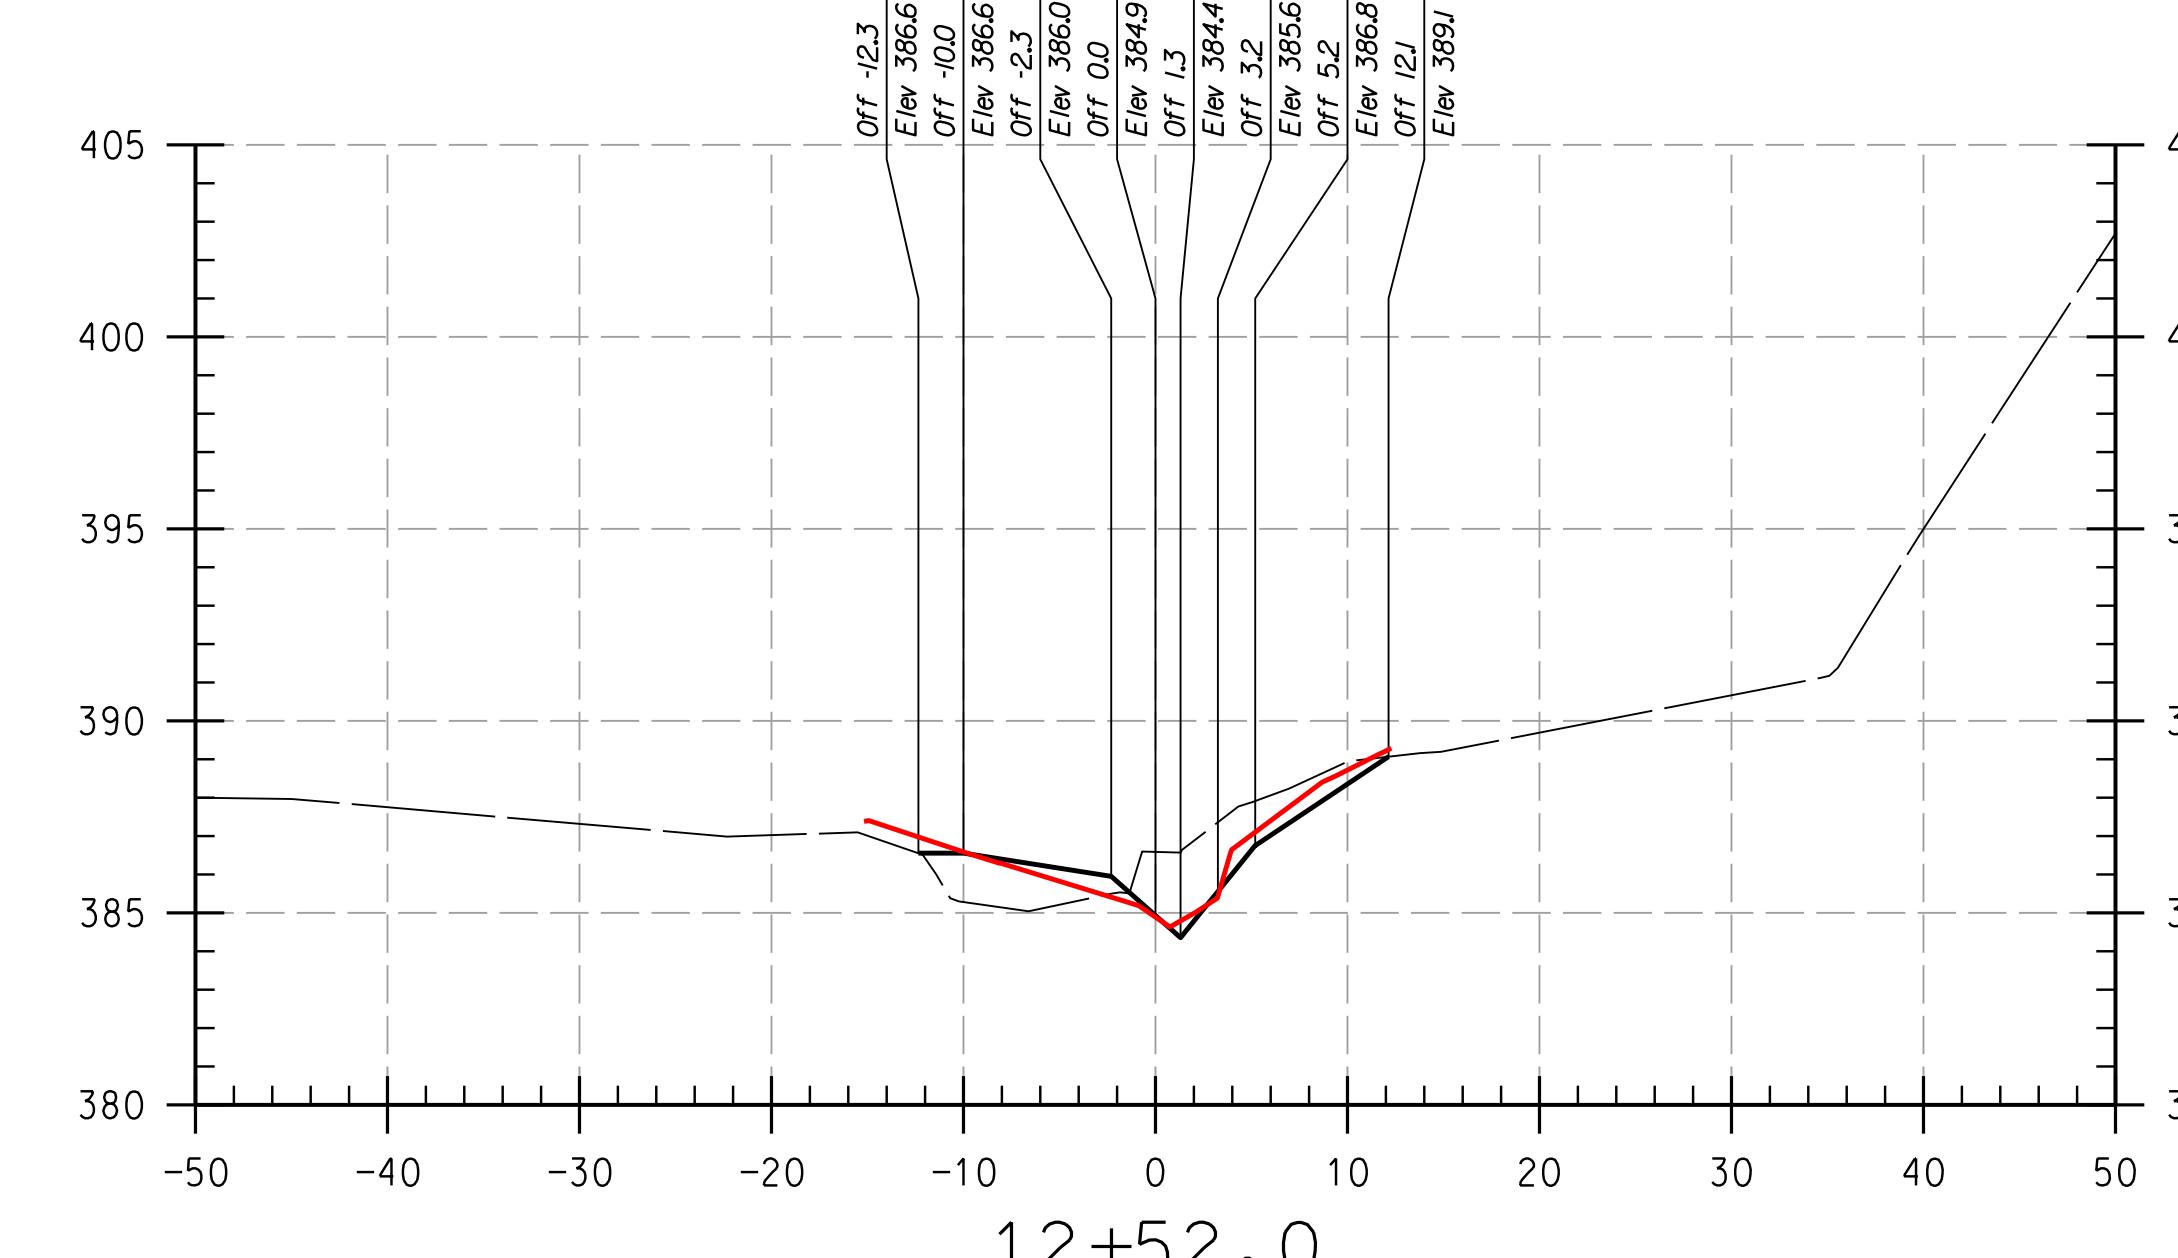

REACH 2

LEGEND

NOTE:
UTILITIES SHOWN ON THESE PLANS HAVE BEEN
USING THE BEST AVAILABLE INFORMATION. HOWE
CONTRACTOR IS TO EXERCISE EXTREME CAUTION
EXCAVATING NEAR ANY UTILITIES TEST PIT IF

PROFESSIONAL CERTIFICATION. I HEREBY CERTIFY THAT THESE DOCUMENTS WERE PREPARED OR APPROVED BY ME, AND THAT I AM A DULY LICENSED PROFESSIONAL ENGINEER UNDER THE LAWS OF THE STATE OF MARYLAND. LICENSE NO. 38311, EXPIRATION DATE: JANUARY 06 2018

THIS DEVELOPMENT IS APPROVED FOR SOIL EROSION AND SEDIMENT CONTROL
BY THE HOWARD SOIL CONSERVATION DISTRICT.









DEPARTMENT OF PUBLIC WORKS, HOWARD COUNTY,

AS-BUILT CROSS SECTIONS

SCALE:	HOR: 1" = 10'
	VERT: 1" = 5'
DATE:	APRIL 2017
KCI JOB NO.:	17133314.83
CAPITAL PROJECT NO.:	D-1158
PERMIT ISSUE:	

CS-15

SHEET NO : 15 OF 2

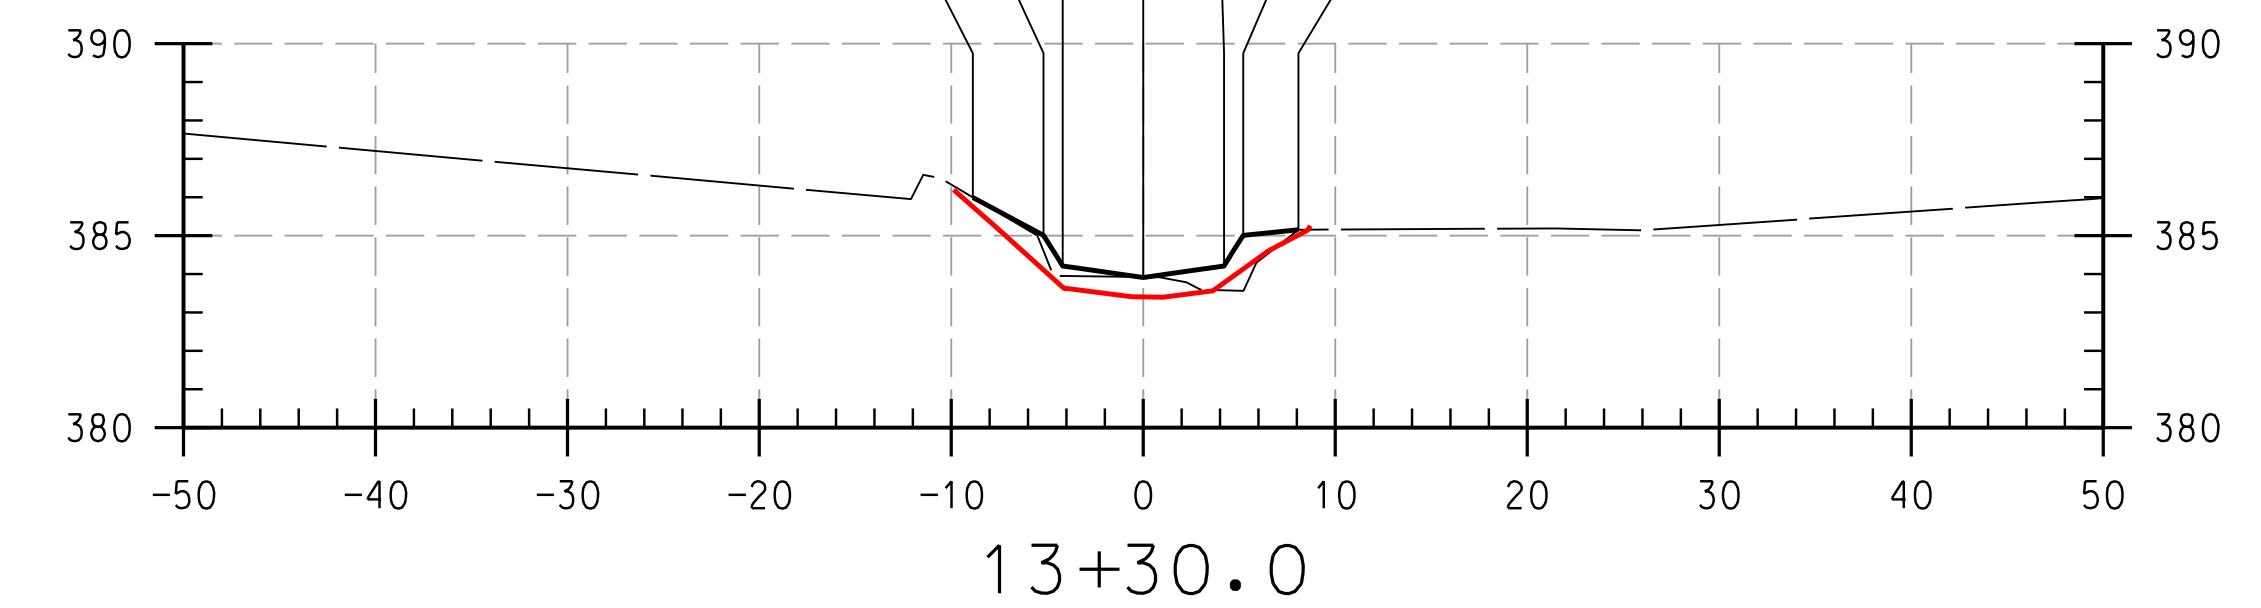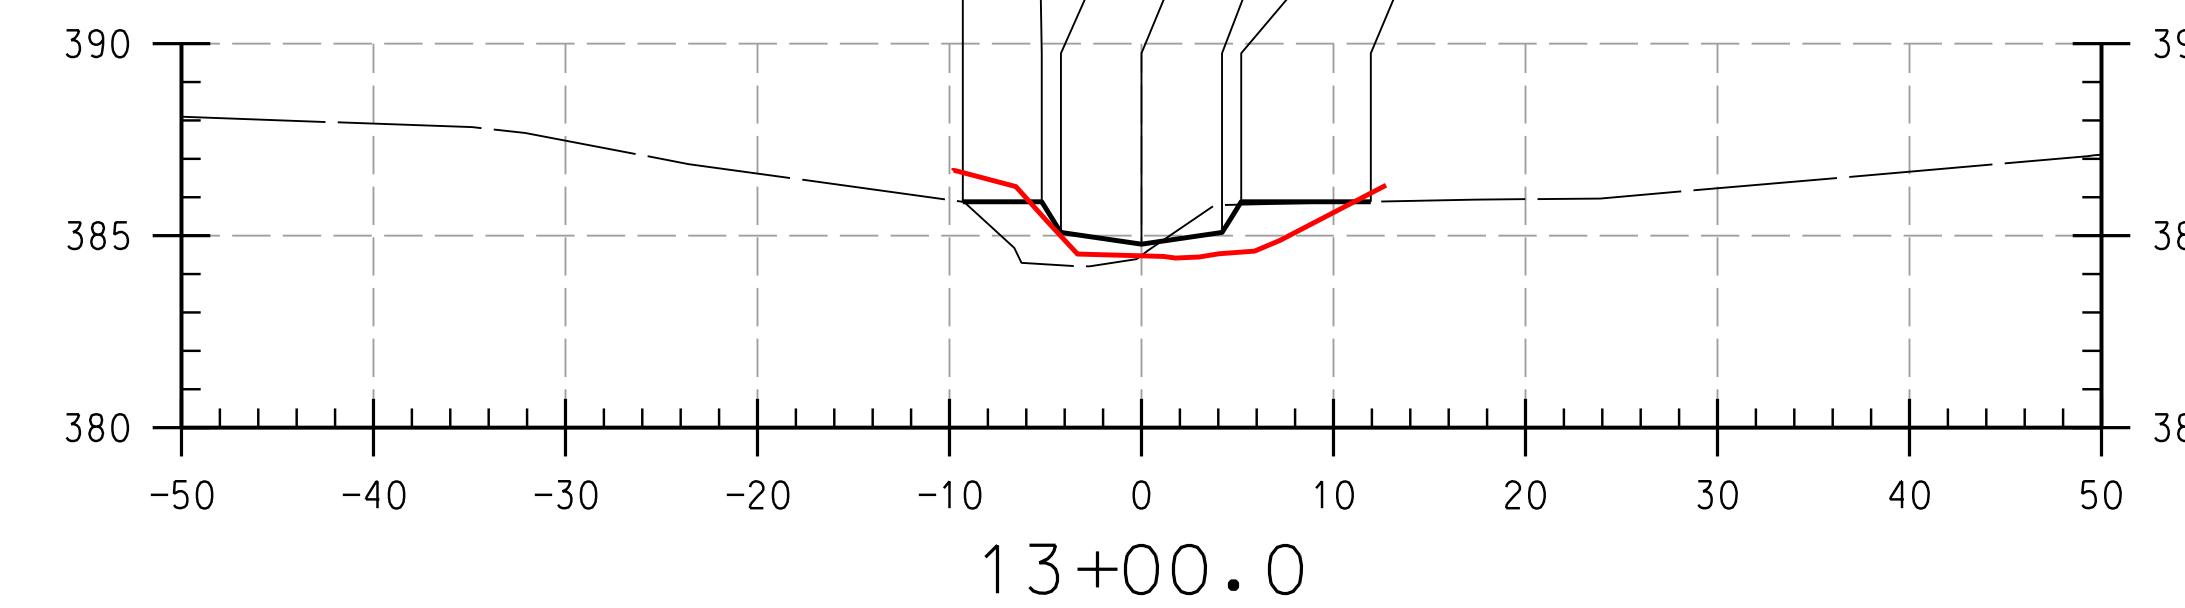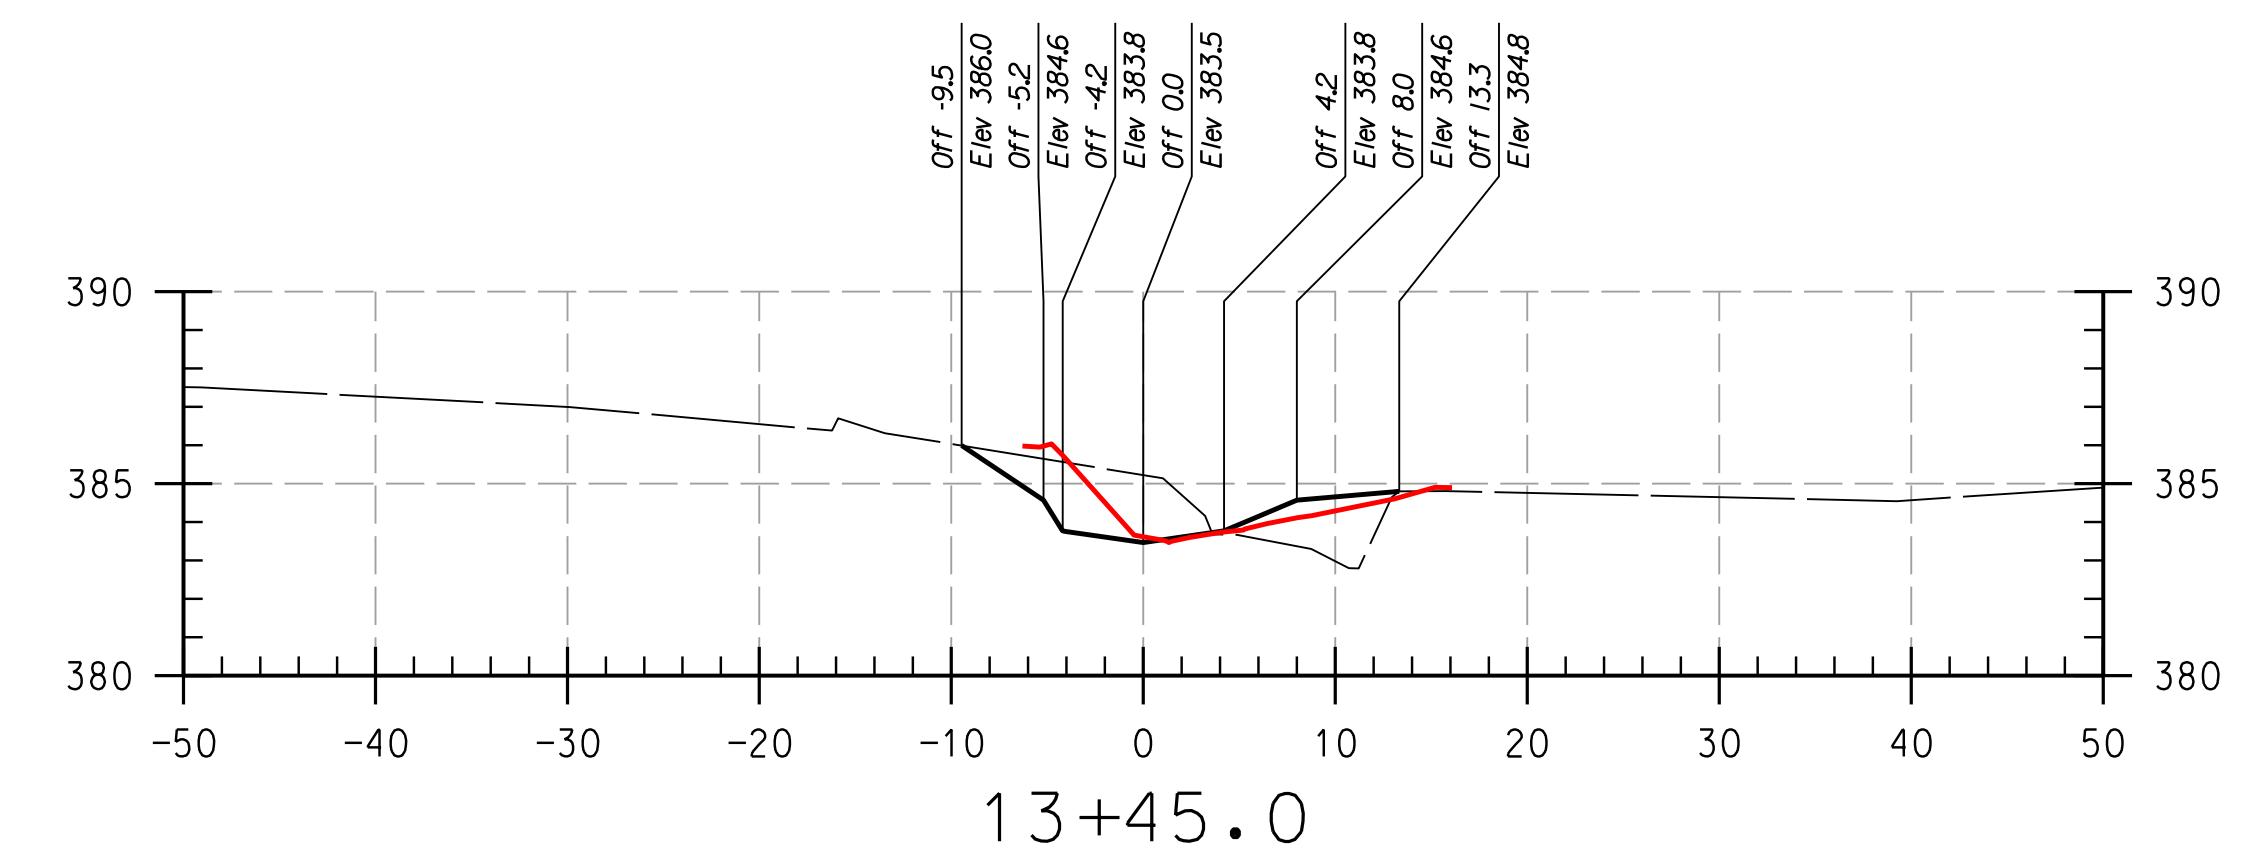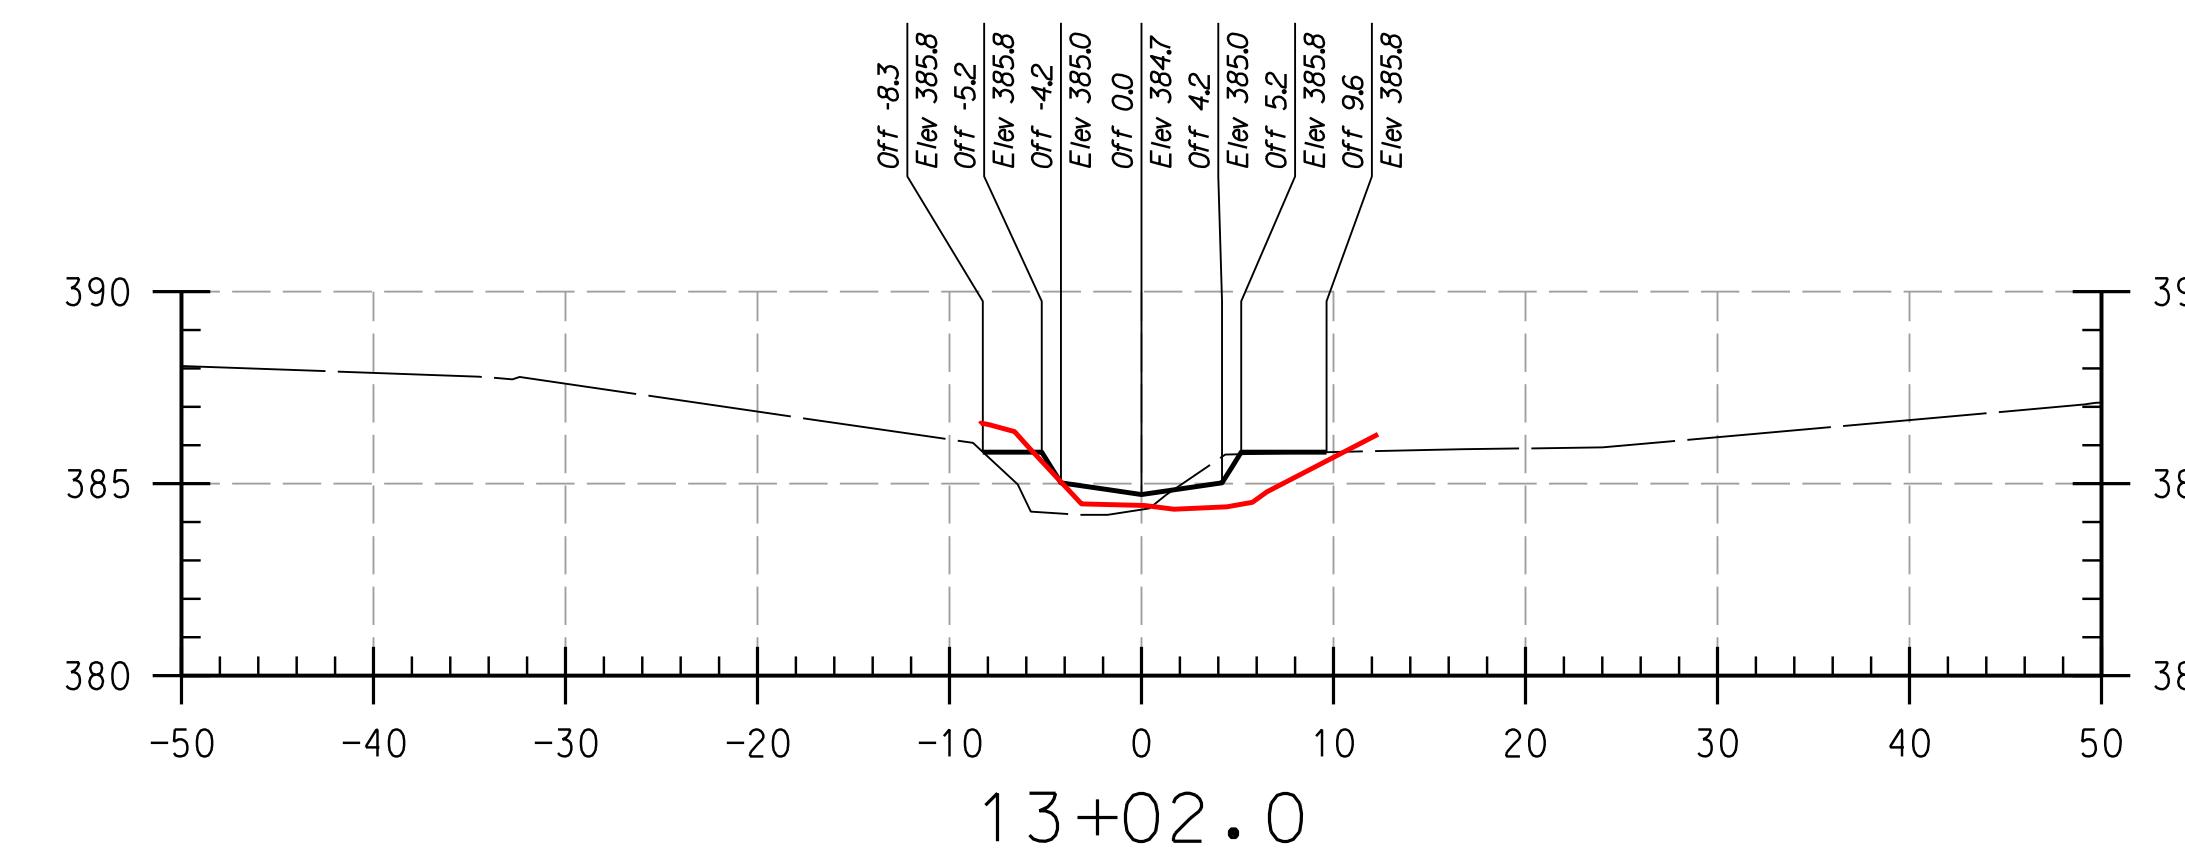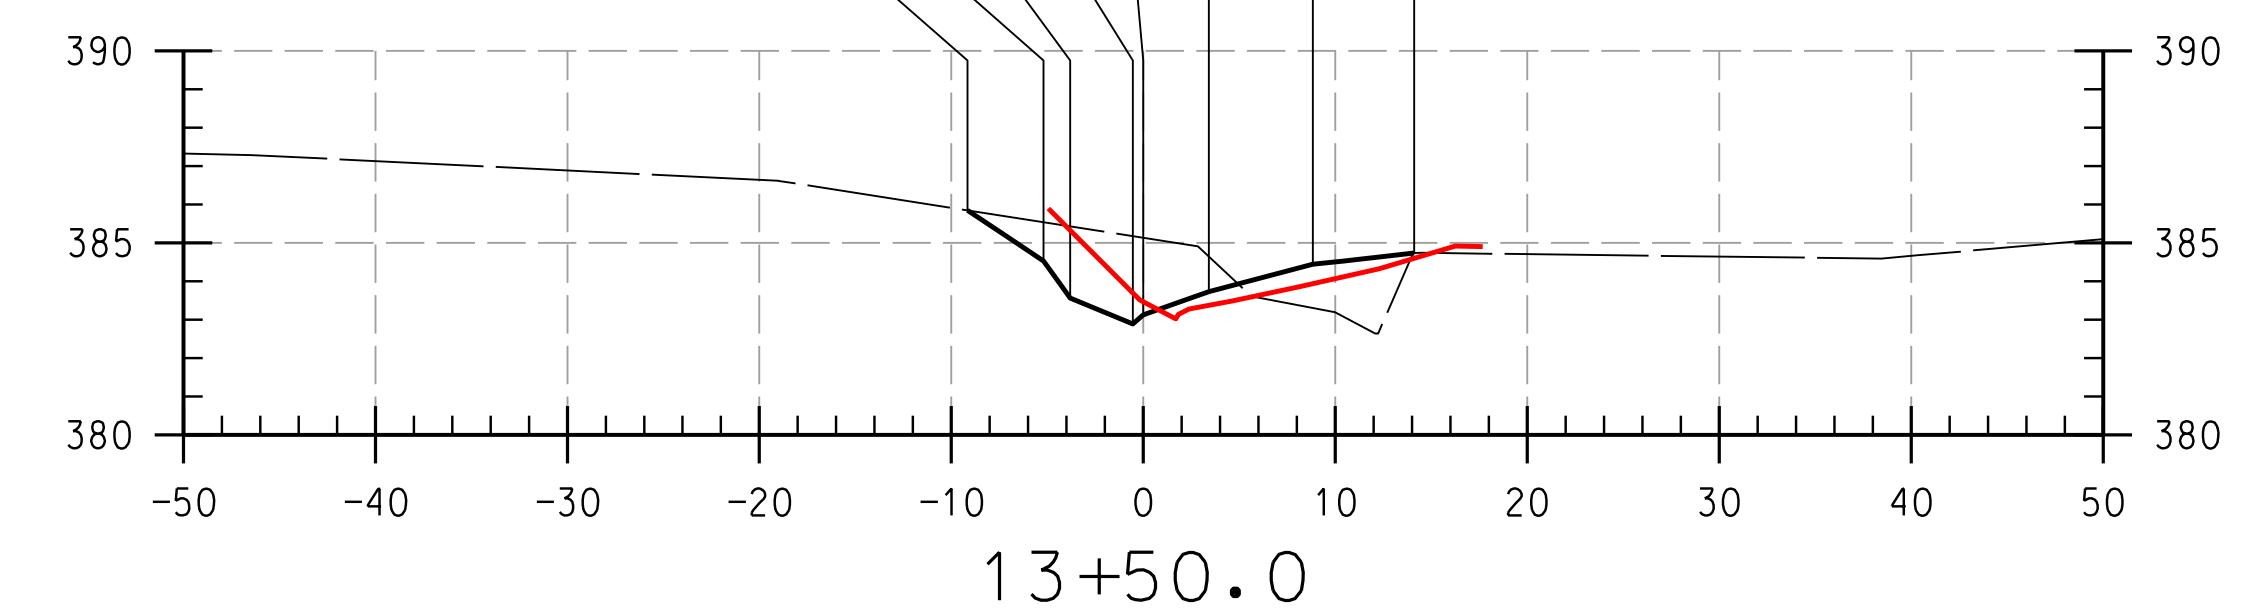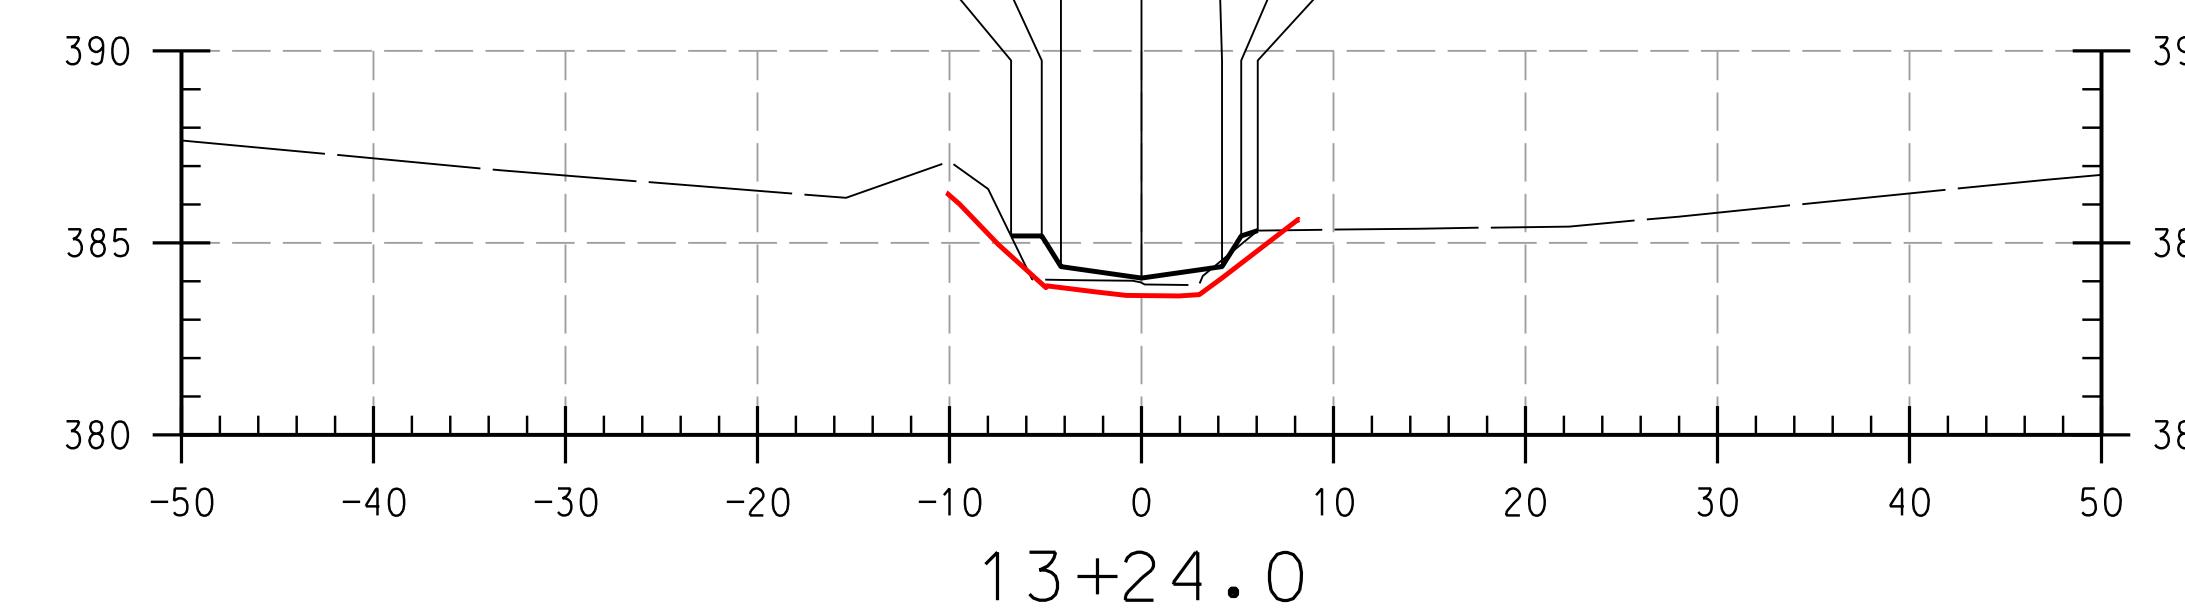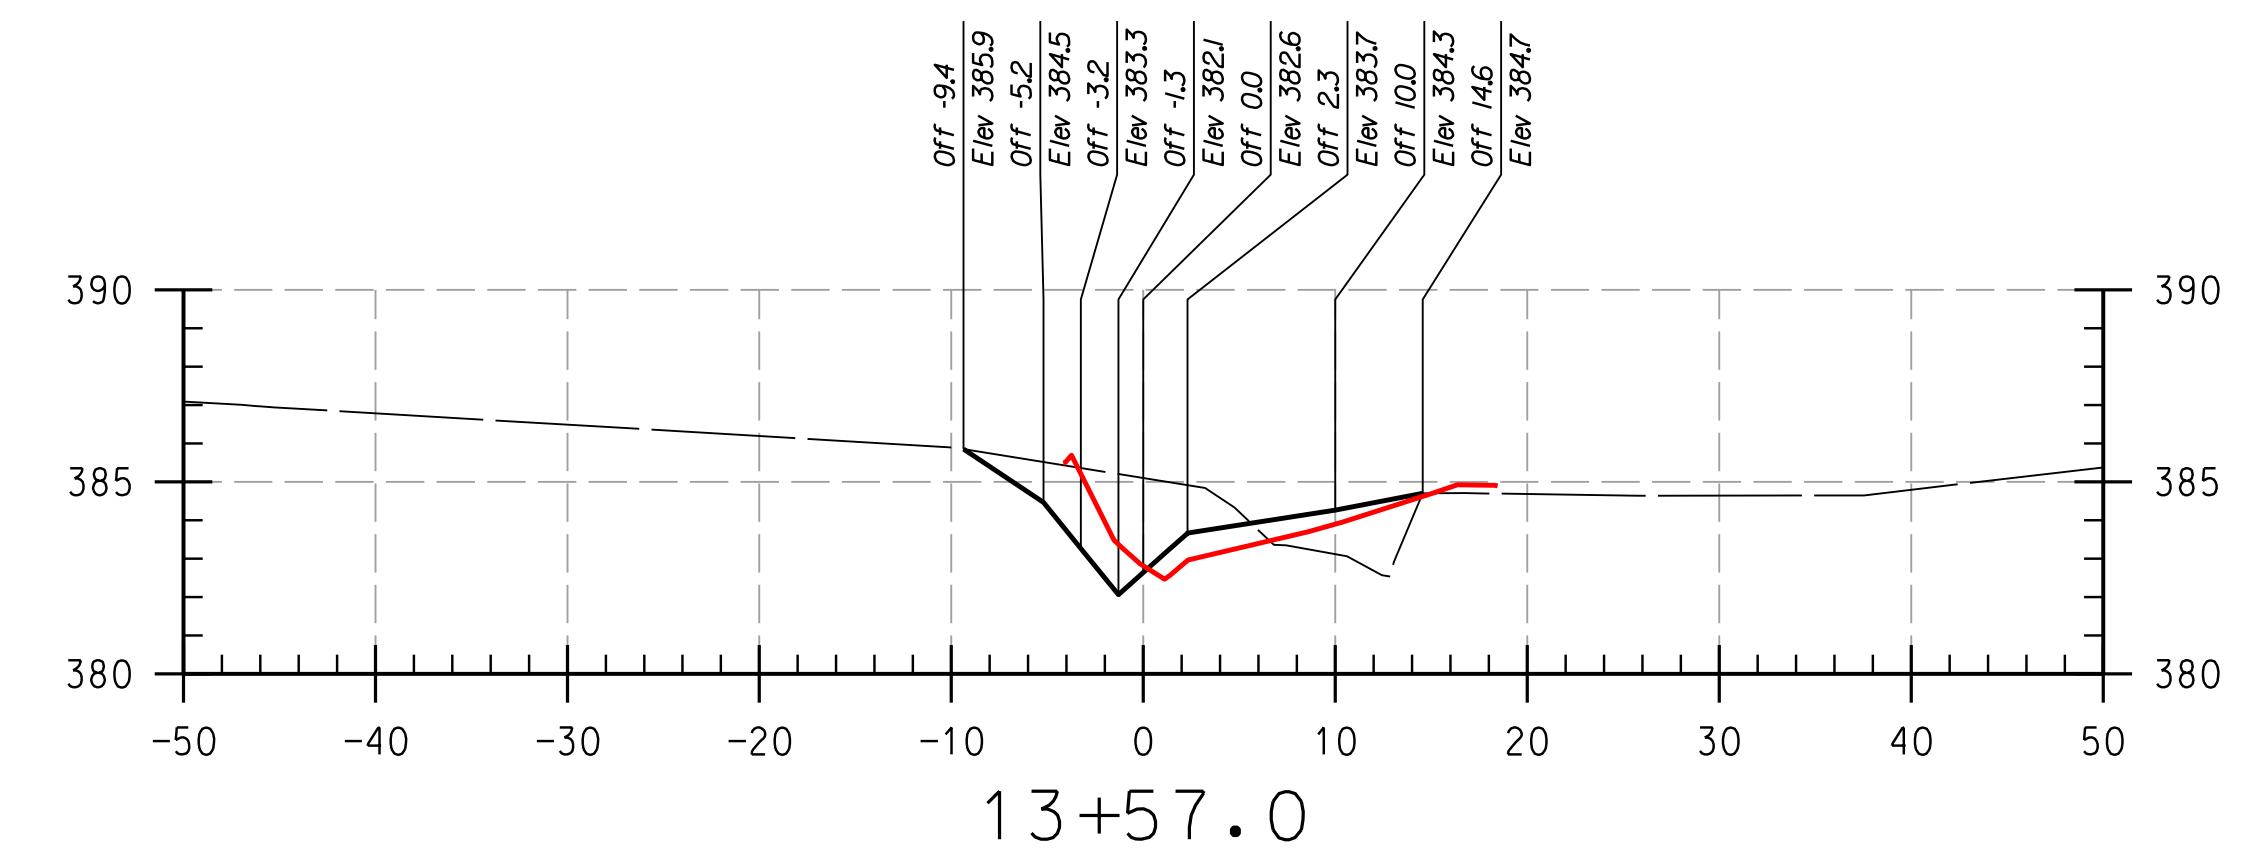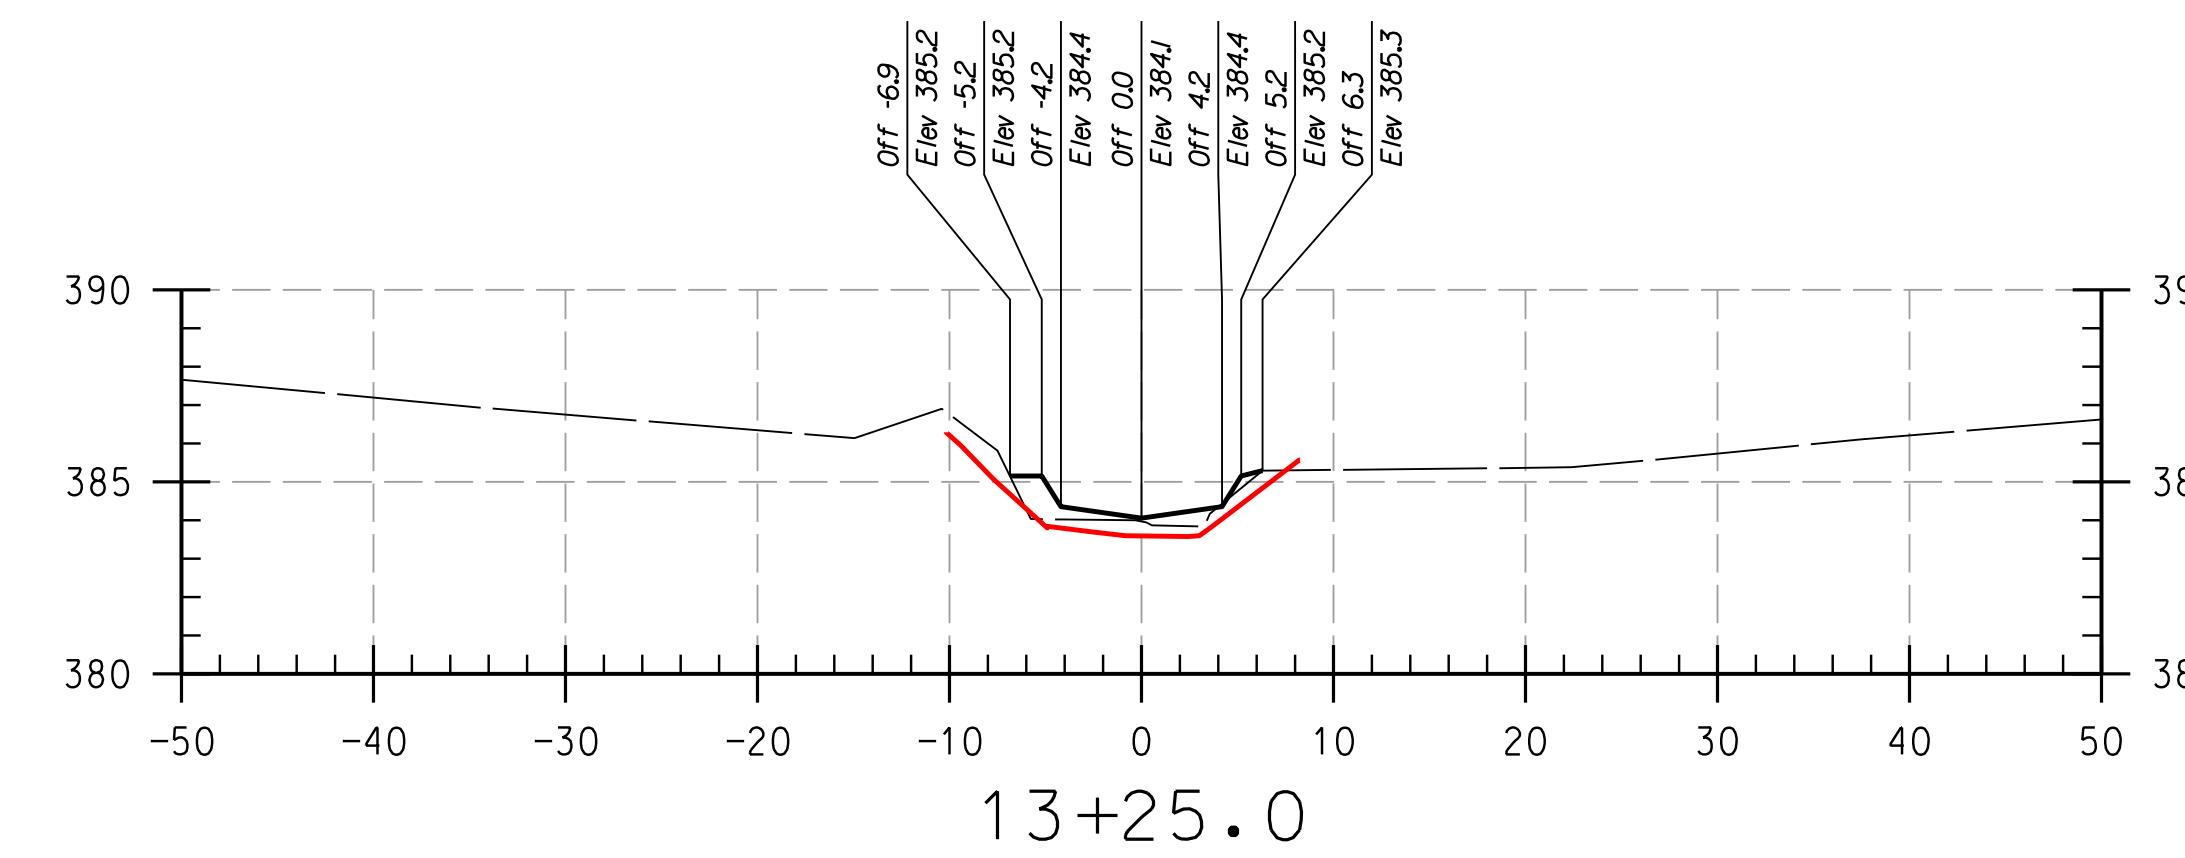

REACH 2

LEGEND

NOTE:
UTILITIES SHOWN ON THESE PLANS HAVE BEEN
USING THE BEST AVAILABLE INFORMATION. HOW
CONTRACTOR IS TO EXERCISE EXTREME CAUTION
EXCAVATING NEAR ANY UTILITIES. TEST PIT IF

AT

THIS DEVELOPMENT IS APPROVED FOR SOIL EROSION AND SEDIMENT CONTROL BY THE HOWARD SOIL CONSERVATION DISTRICT.

0

DEPARTMENT OF PUBLIC WORKS, HOWARD COUNTY, MD

AS-BUILT CROSS SECTIONS

SCALE:	HOR: 1" = 10'
	VERT: 1" = 5'
DATE:	APRIL 2017
KCI JOB NO.:	17133314.83
CAPITAL PROJECT NO.:	D-1158
PERMIT ISSUE:	
CONSTRUCTION ISSUE	

CS 16









SHEET NO.: 16 OF 27

HOWARD COMMUNITY COLLEGE
STREAM RESTORATION PROJECT
CAPITAL PROJECT D-1158
HOWARD COUNTY DEPARTMENT OF PUBLIC WORKS
STORMWATER MANAGEMENT DIVISION
6751 COLUMBIA GATEWAY DRIVE
COLUMBIA, MD 21046
PARCELS 47, 81 TAX MAP 35, 36
ELECTION DISTRICT 05 GRID BLOCK 01

SCALE: HOR: 1" = 10'
VERT: 1" = 5'
DATE: APRIL 2017
KCI JOB NO.: 17133314.83
CAPITAL PROJECT NO.: D-1158
PERMIT ISSUE:
CONSTRUCTION ISSUE:

CS-16

SHEET NO.: 16 OF 27

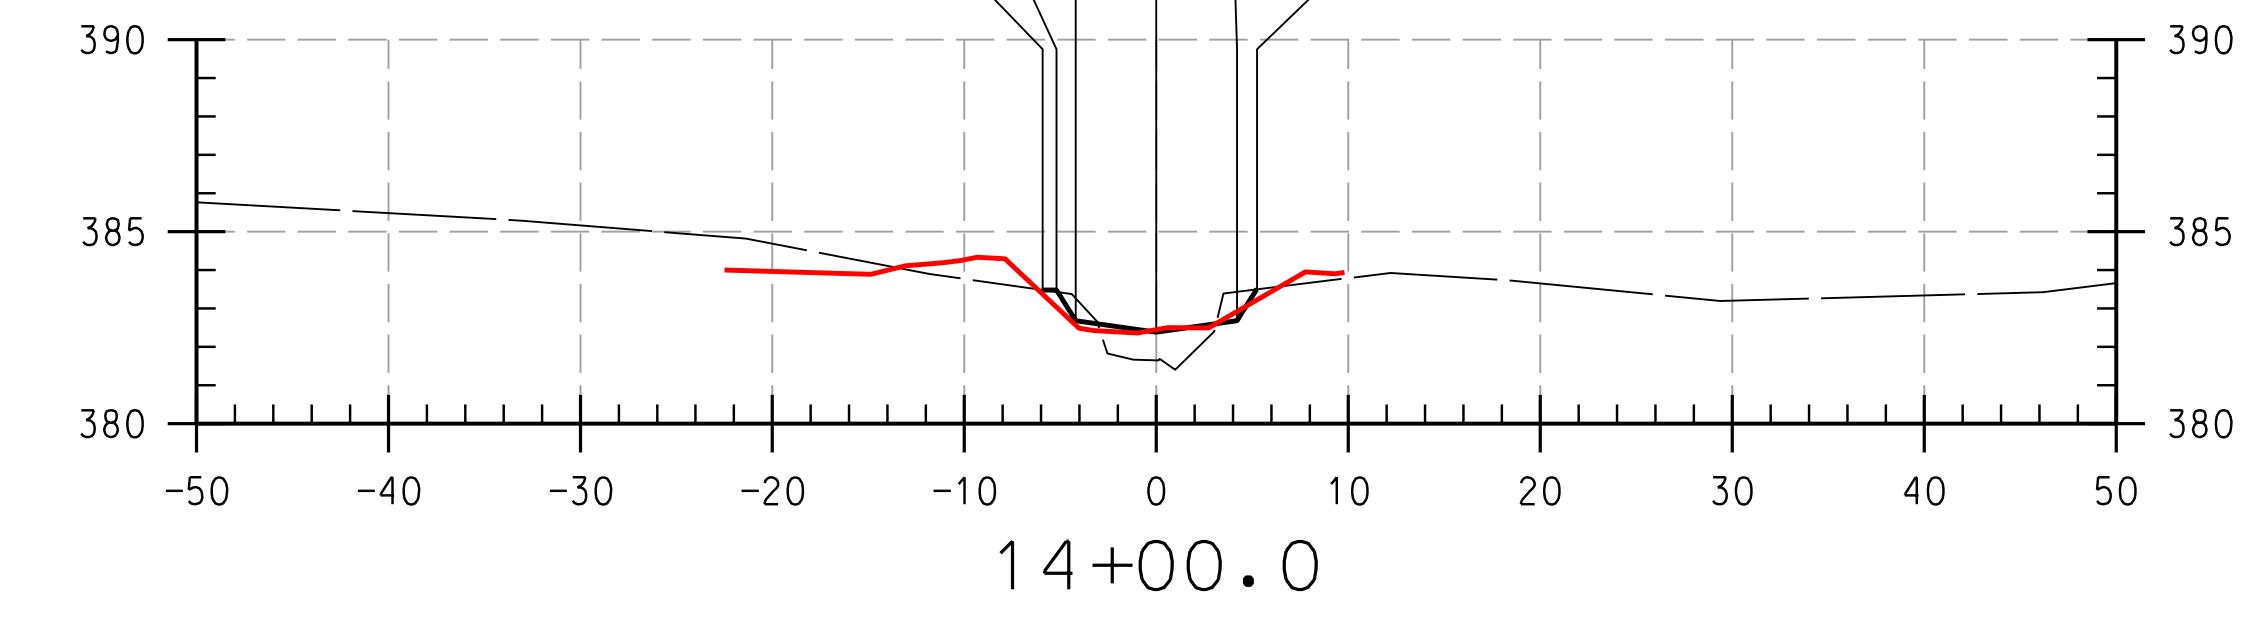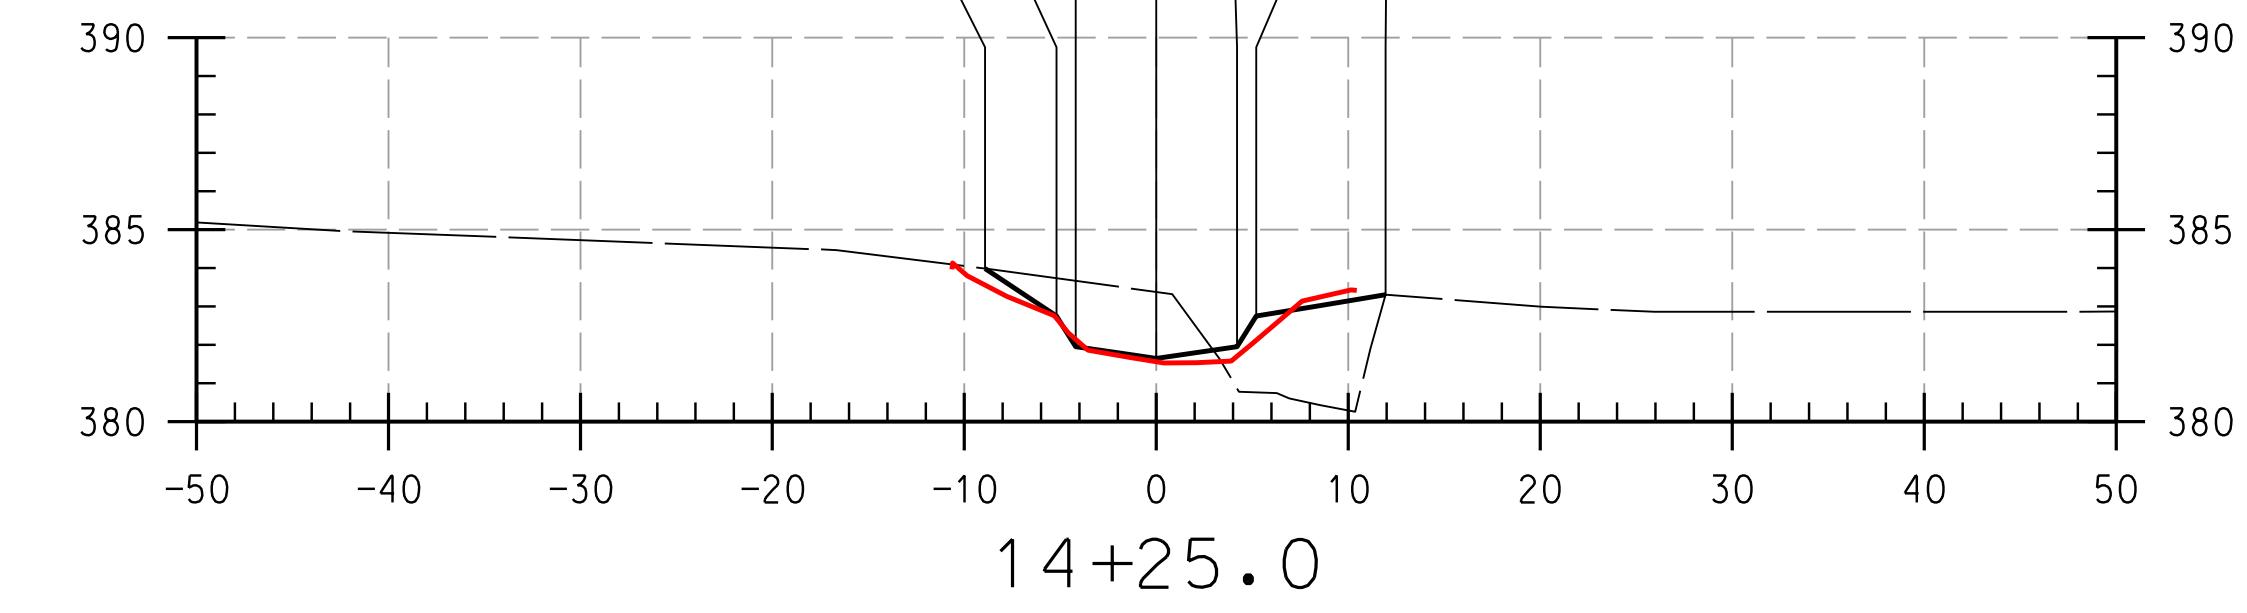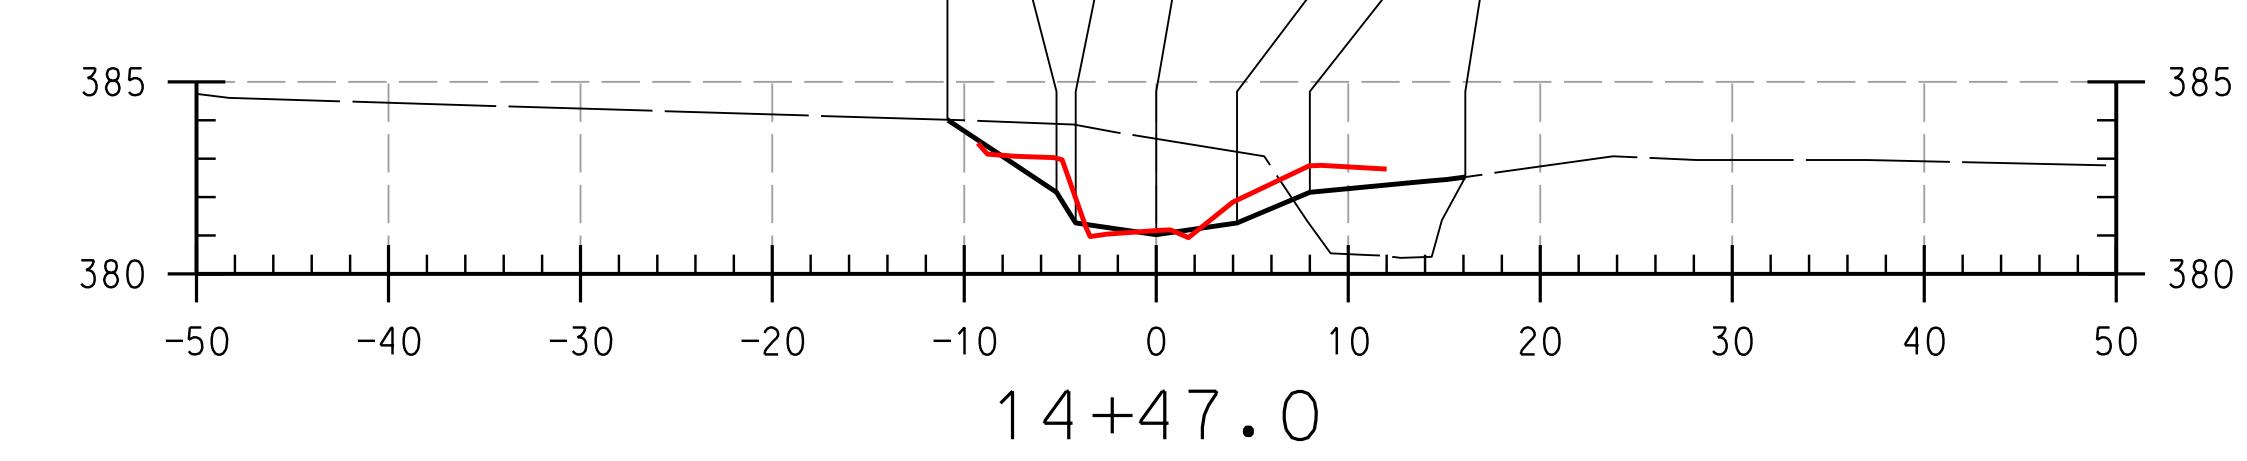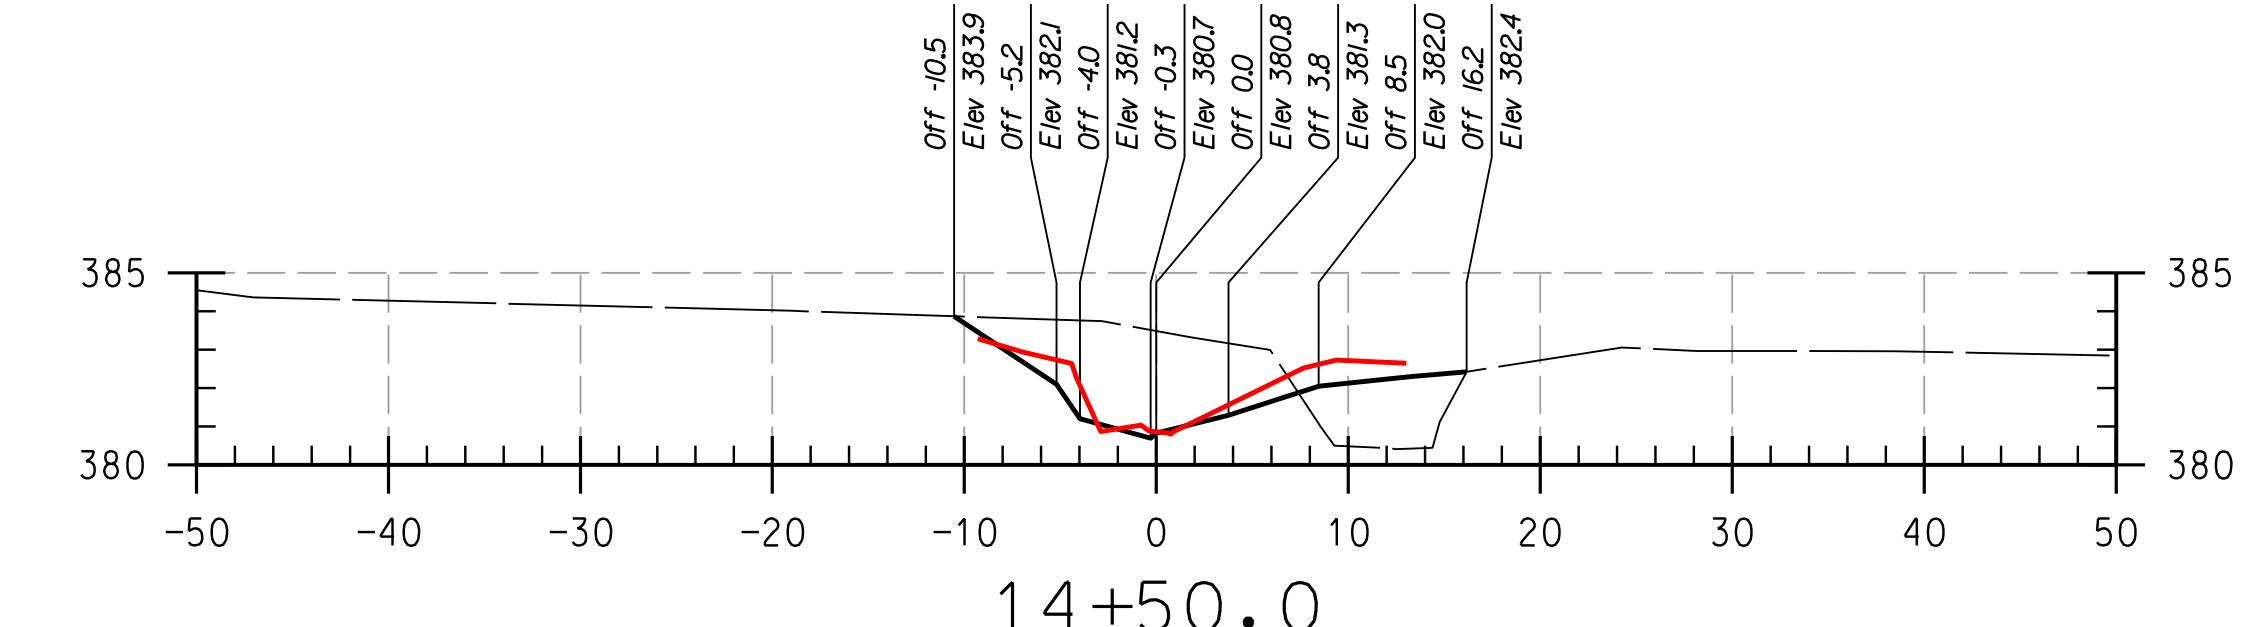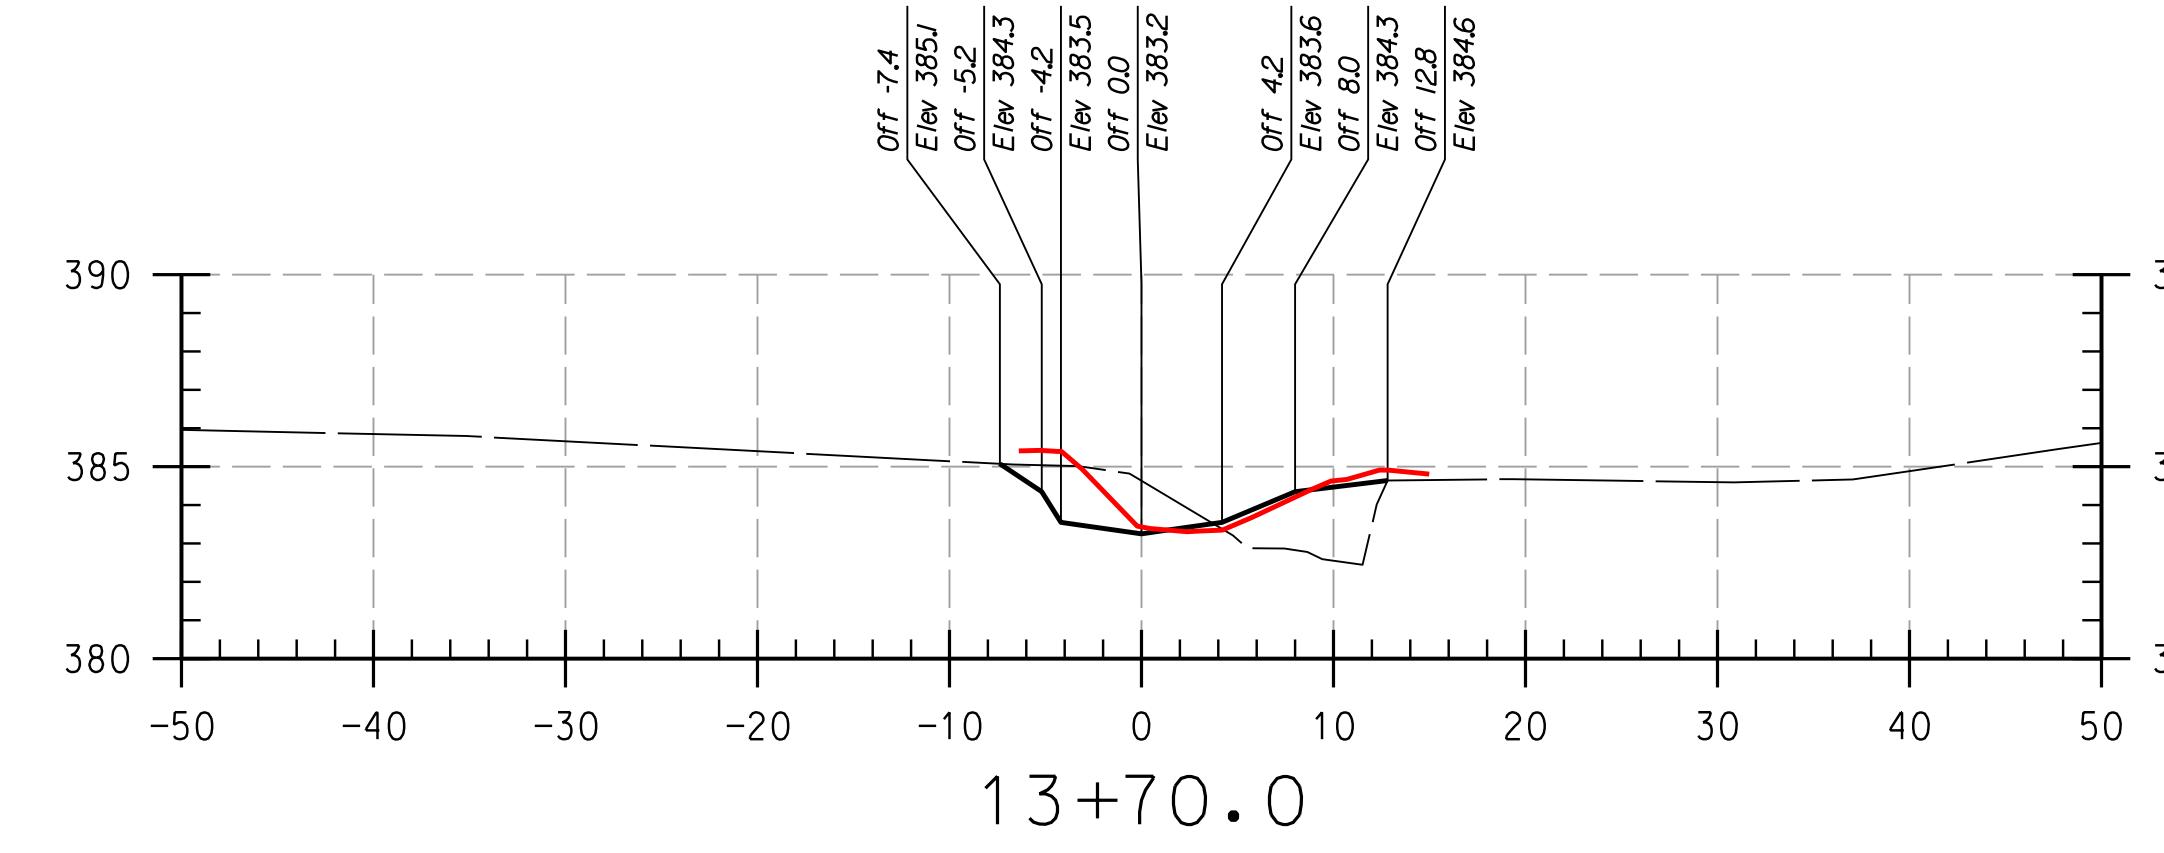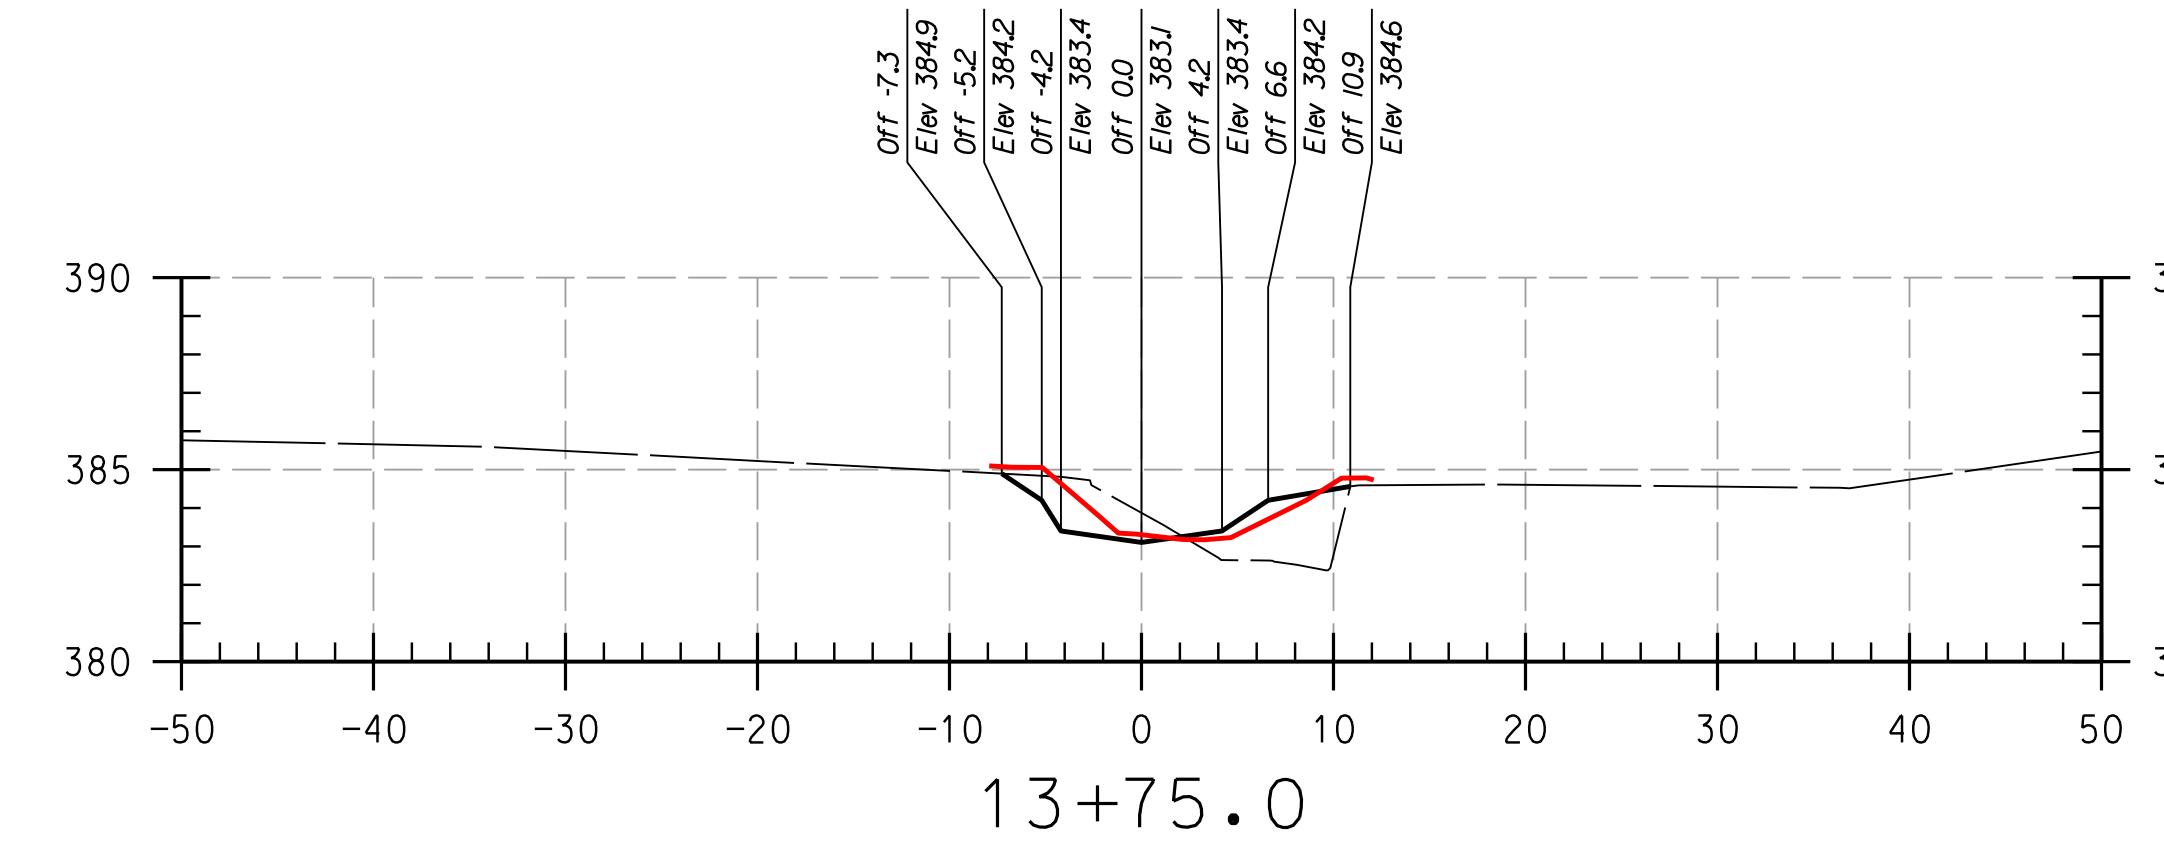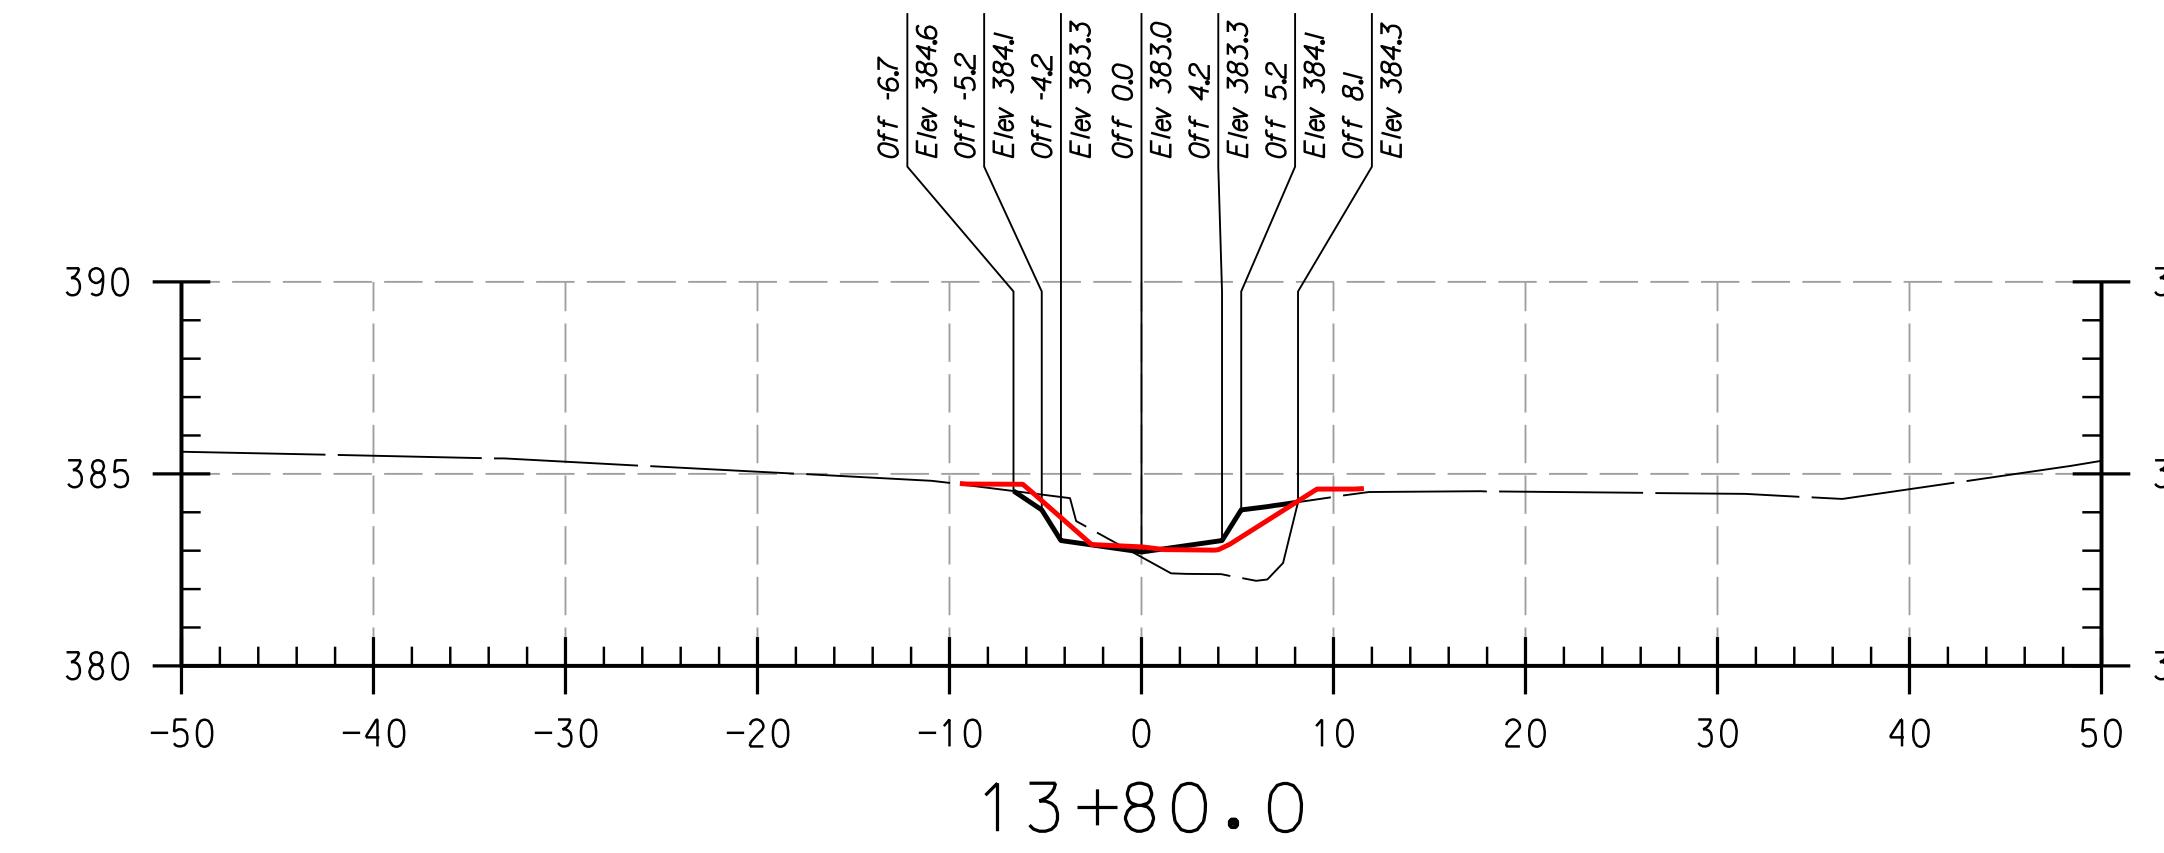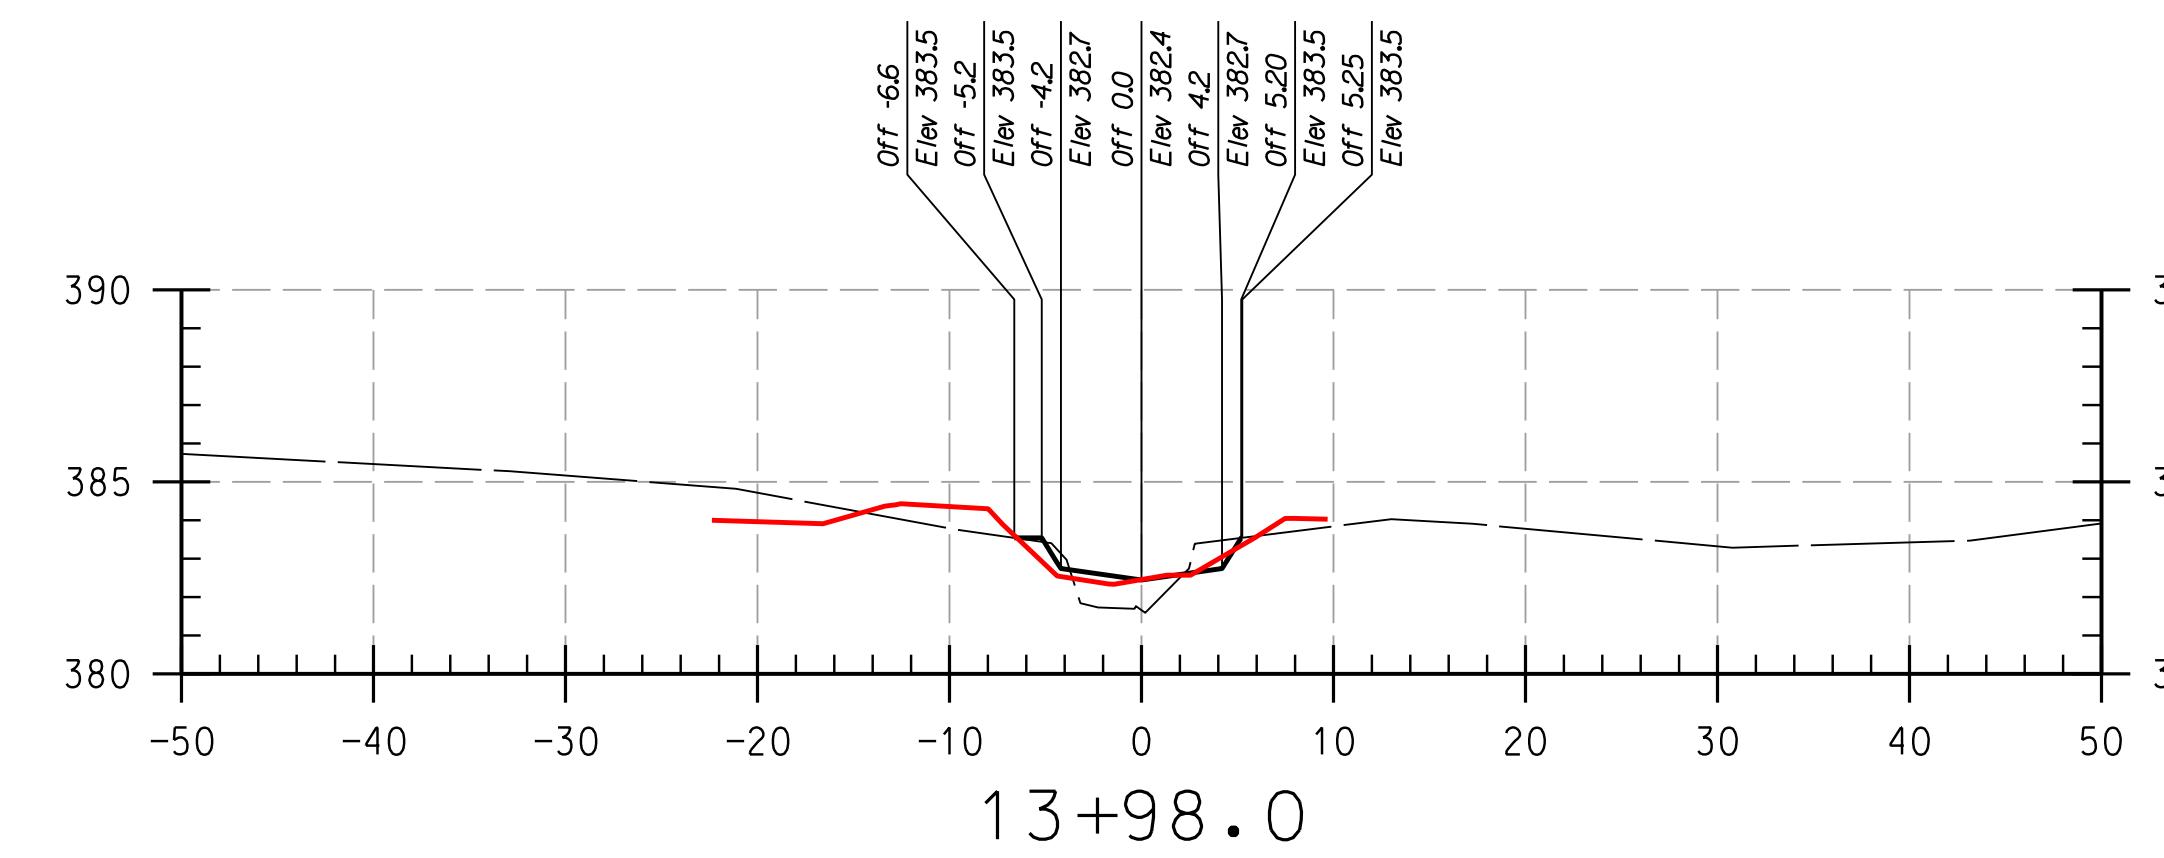

REACH 2

LEGEND

**NOTE:
UTILITIES SHOWN ON THESE PLANS HAVE BEEN
USING THE BEST AVAILABLE INFORMATION. HOW-
EVER, CONTRACTOR IS TO EXERCISE EXTREME CAUTION
EXCAVATING NEAR ANY UTILITIES. TEST PIT IF**

PROFESSIONAL CERTIFICATION. I HEREBY CERTIFY THAT THESE DOCUMENTS WERE PREPARED OR APPROVED BY ME, AND THAT I AM A DULY LICENSED PROFESSIONAL ENGINEER UNDER THE LAWS OF THE STATE OF MARYLAND; LICENSE NO. 38311, EXPIRATION DATE: JANUARY 06 2018

THIS DEVELOPMENT IS APPROVED FOR SOIL EROSION AND SEDIMENT CONTROL
BY THE HOWARD SOIL CONSERVATION DISTRICT.

DEPARTMENT OF PUBLIC WORKS, HOWARD COUNTY.

936 RIDGEBROOK ROAD
SPARKS, MARYLAND 21152
TELEPHONE: (410) 316-7800
FAX: (410) 316-7818
www.kci.com



KCTI
TECHNOLOGIES

**HOWARD COMMUNITY COLLEGE
STREAM RESTORATION PROJECT**

CAPITAL PROJECT D-1158

HOWARD COUNTY DEPARTMENT OF PUBLIC WORKS
STORMWATER MANAGEMENT DIVISION
6751 COLUMBIA GATEWAY DRIVE
COLUMBIA, MD 21046

PARCELS 47, 81 TAX MAP 35, 36









ING POR, NT ELECTION DISTRICT 05 GRIDBLOCK

AS-BUILT CROSS SECTIONS

SCALE:	HOR: 1" = 10' VERT: 1" = 5'
DATE:	APRIL 2017
KCI JOB NO.:	17133314.83
CAPITAL PROJECT NO.:	D-1158
PERMIT ISSUE:	
CONSTRUCTION ISSUE:	

CS-17

SHEET NO.: 17 OF 27

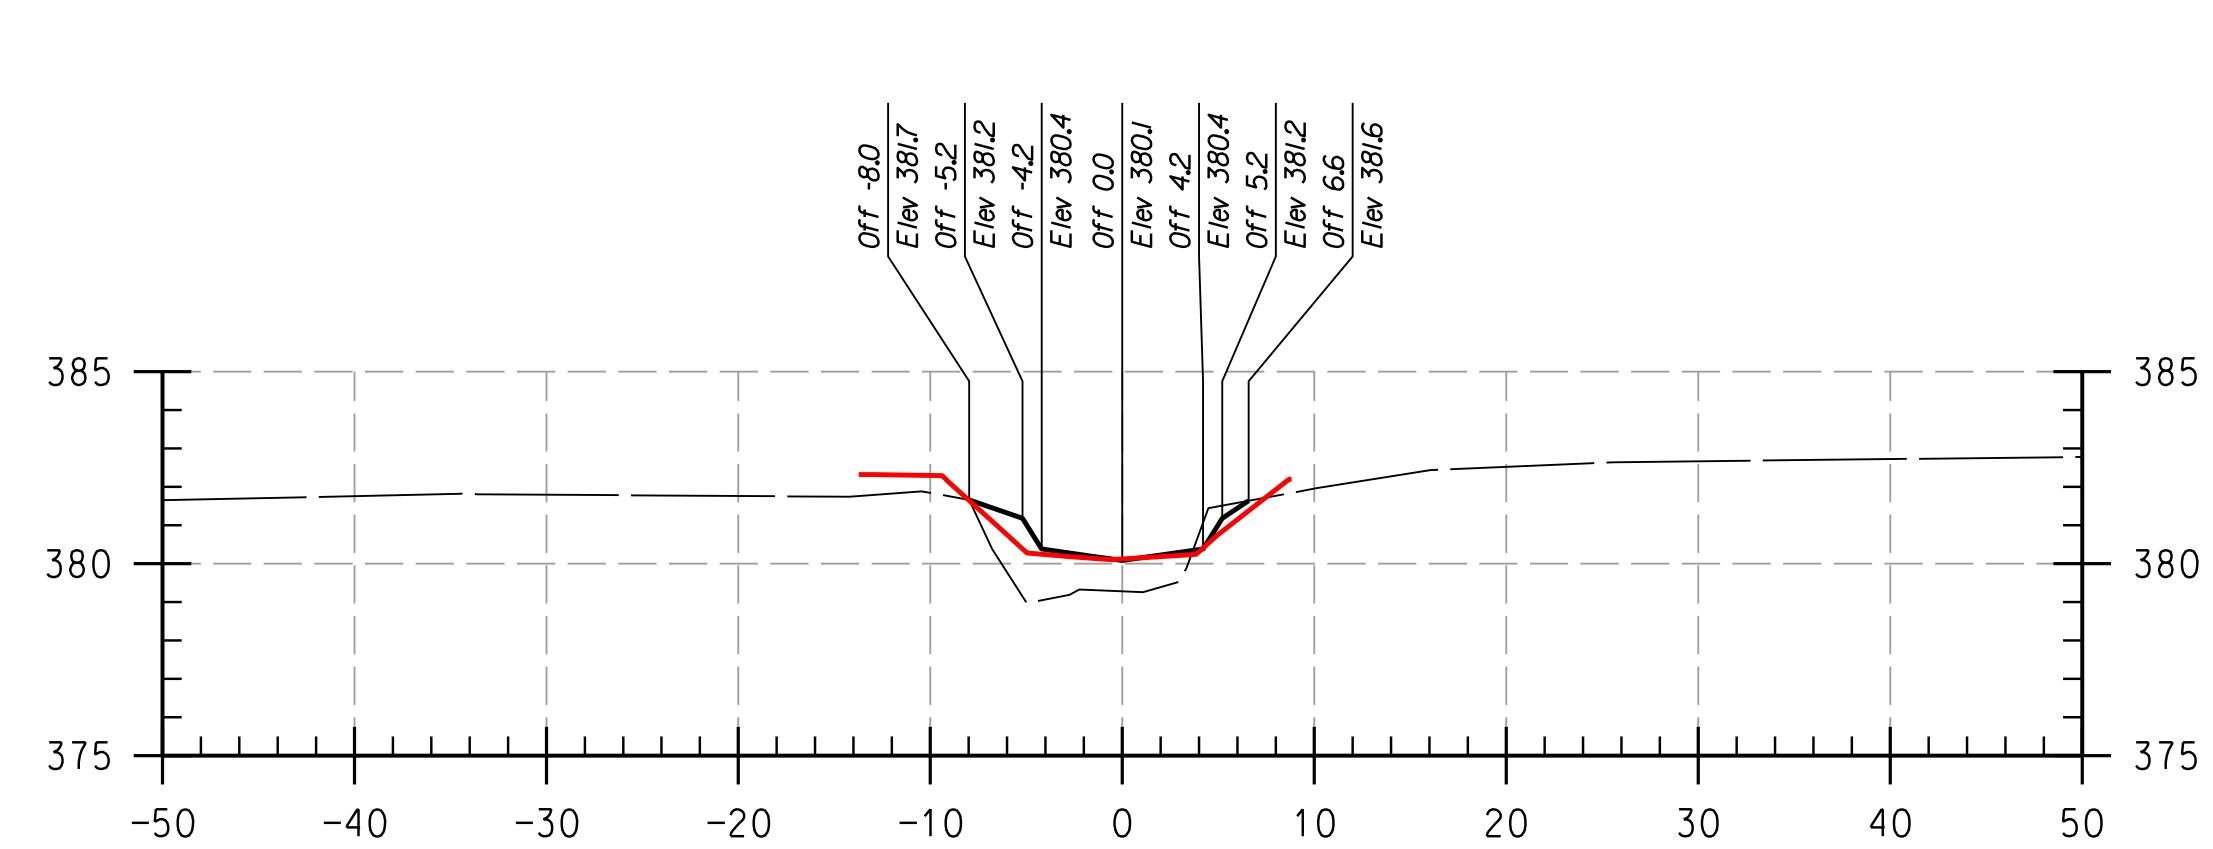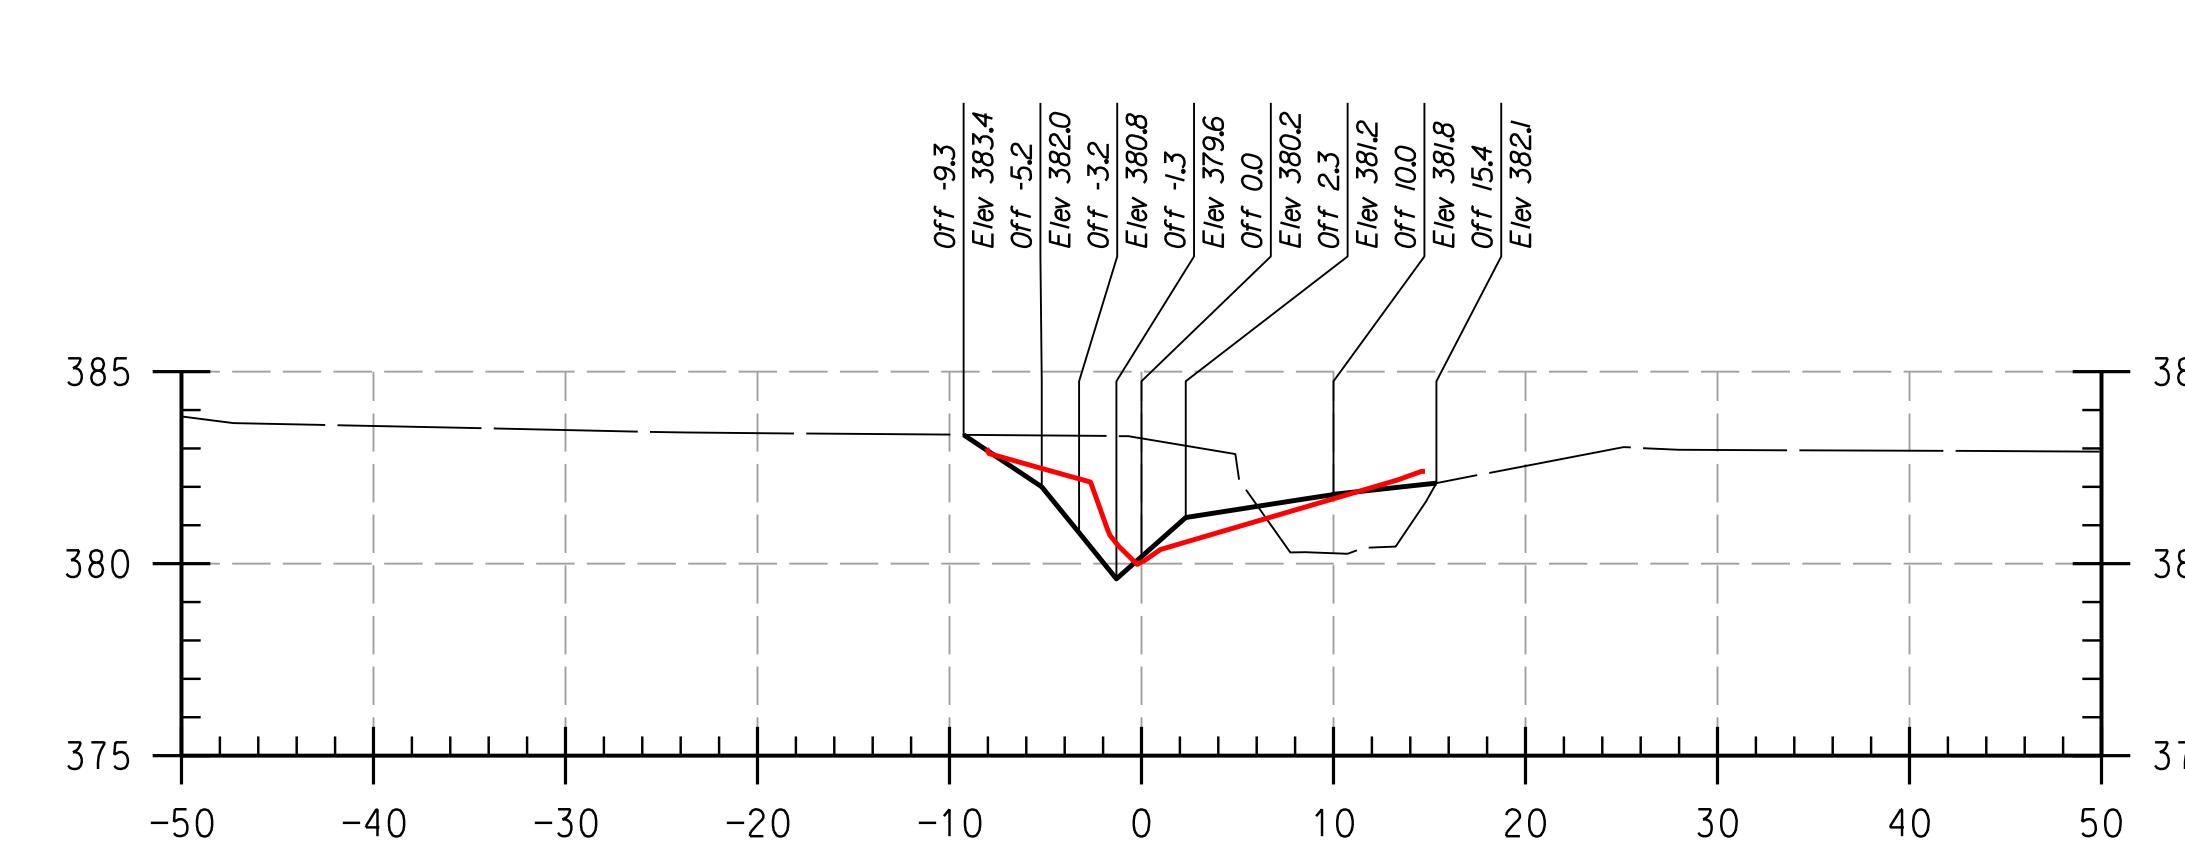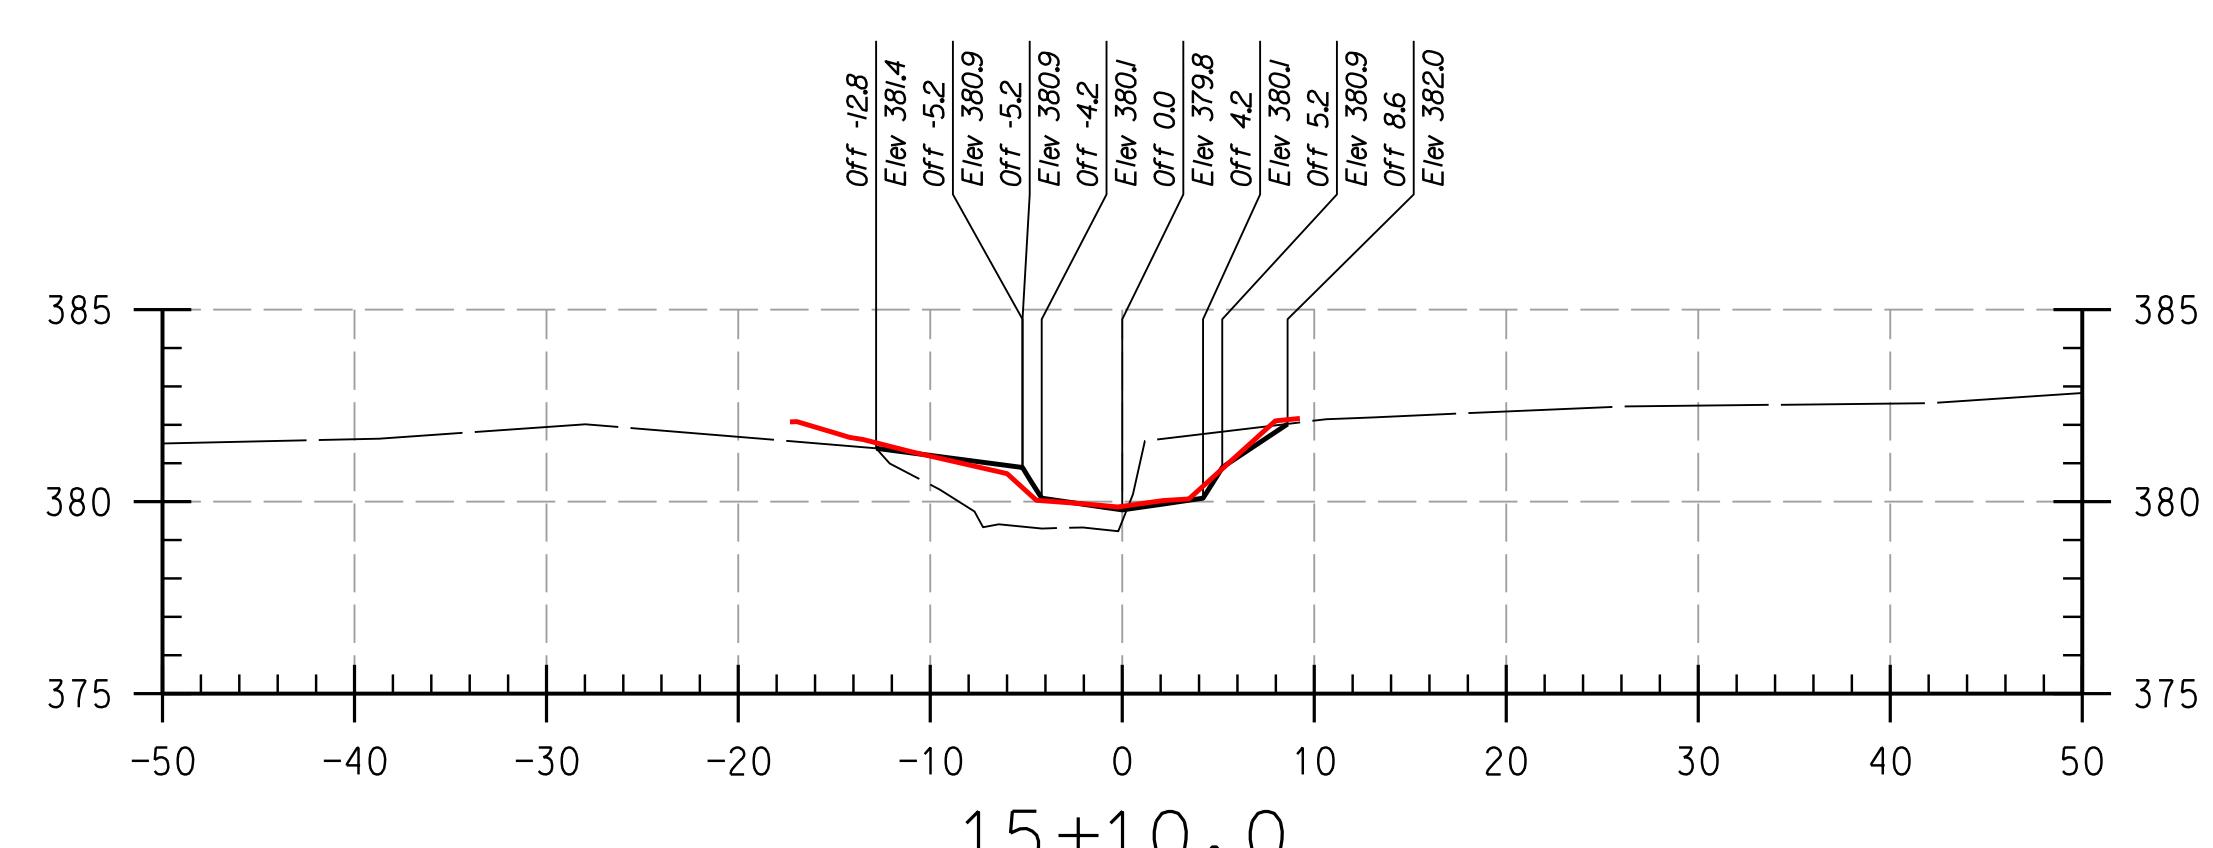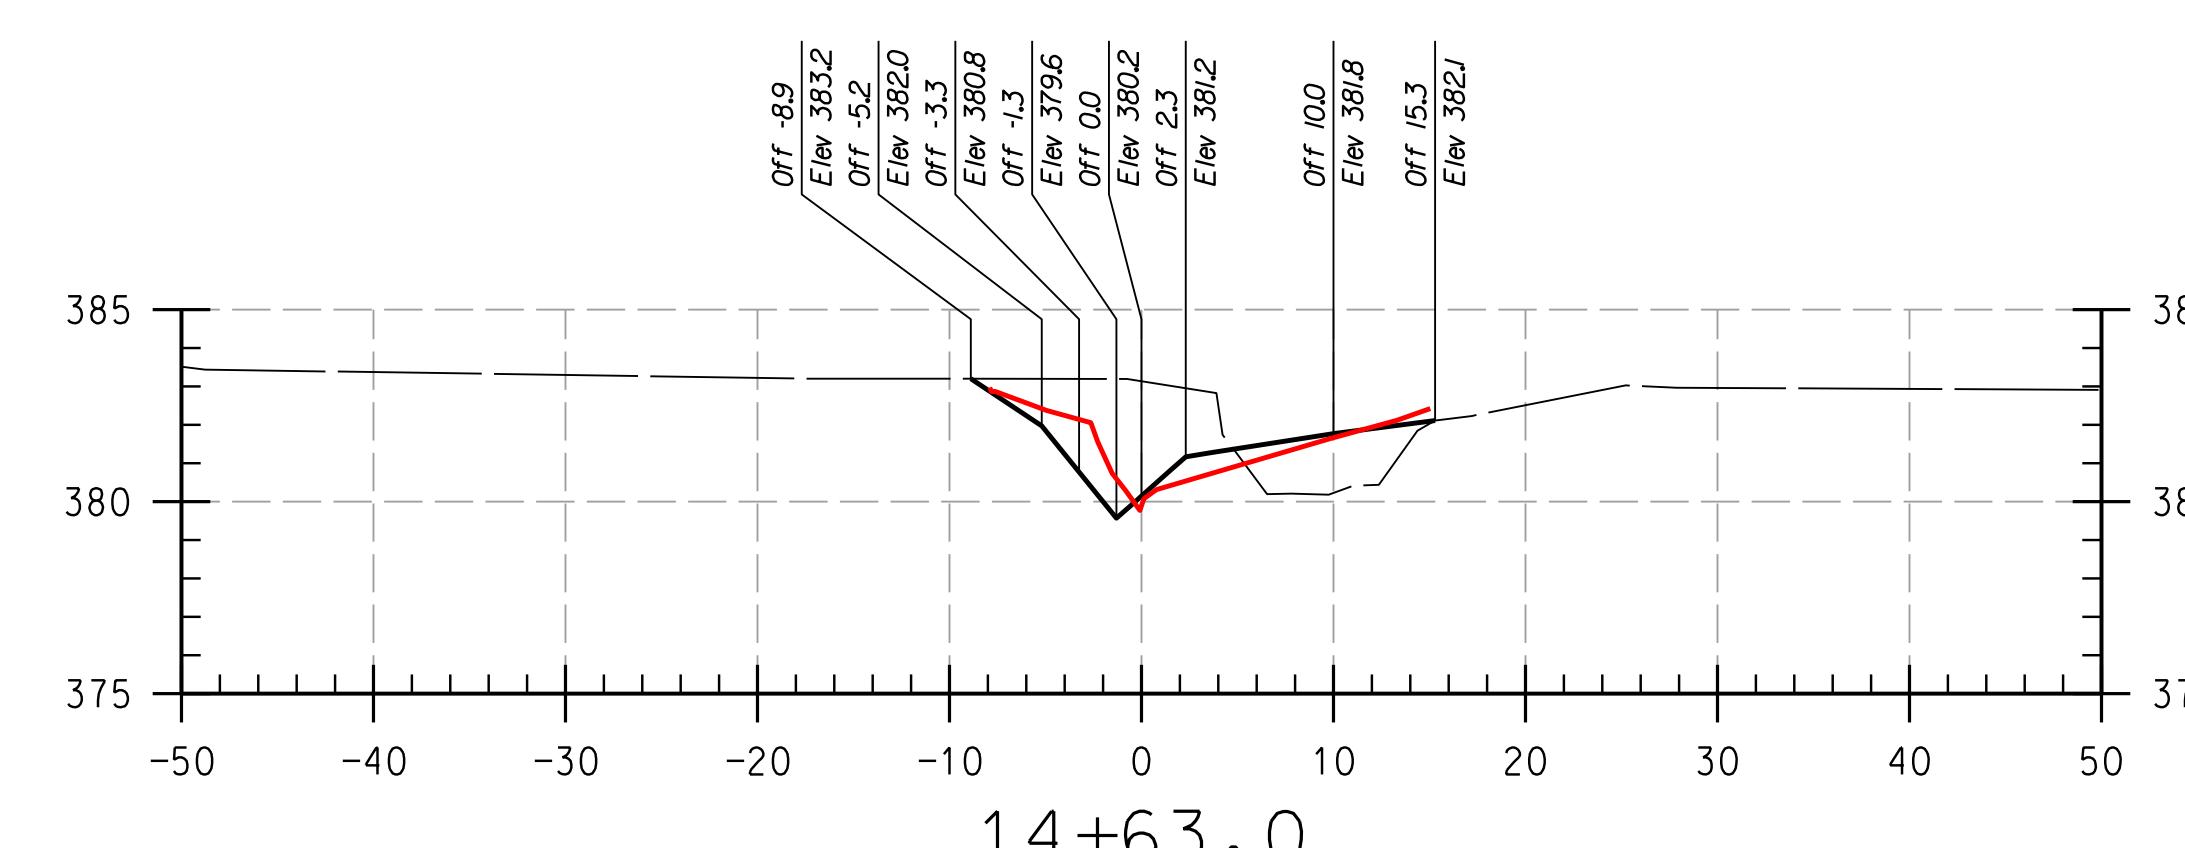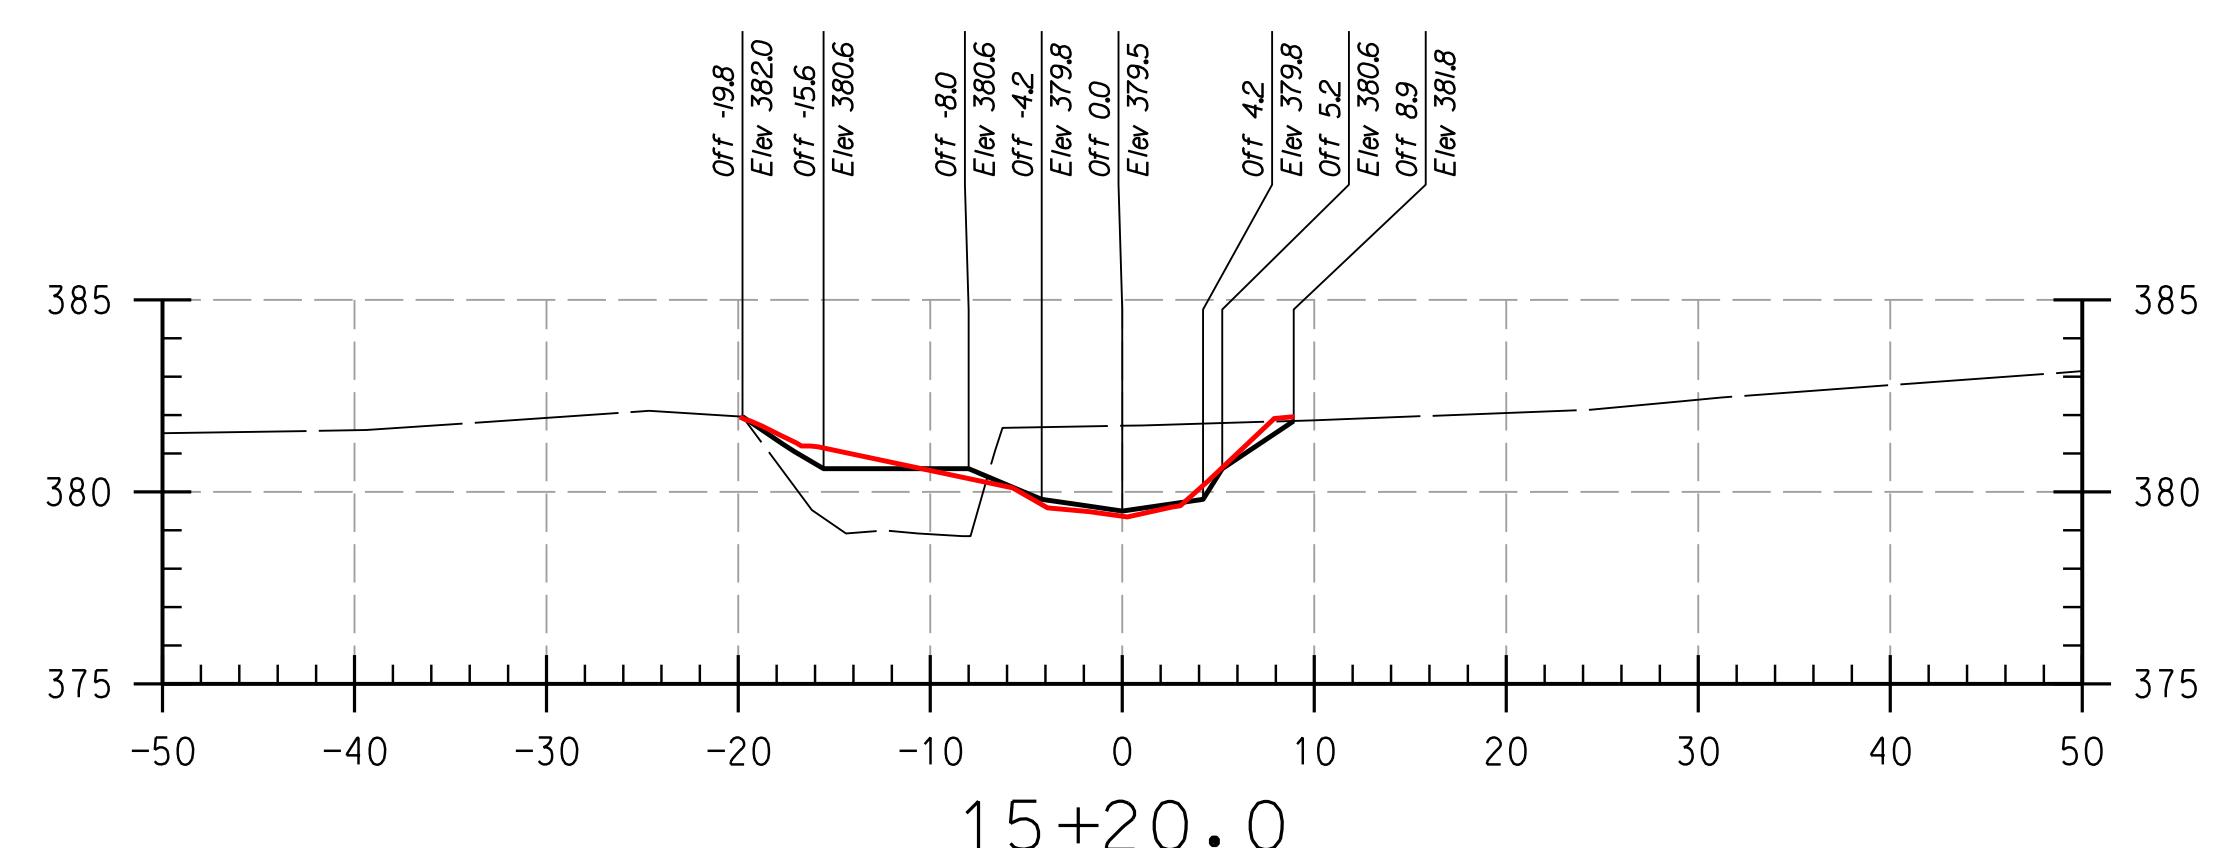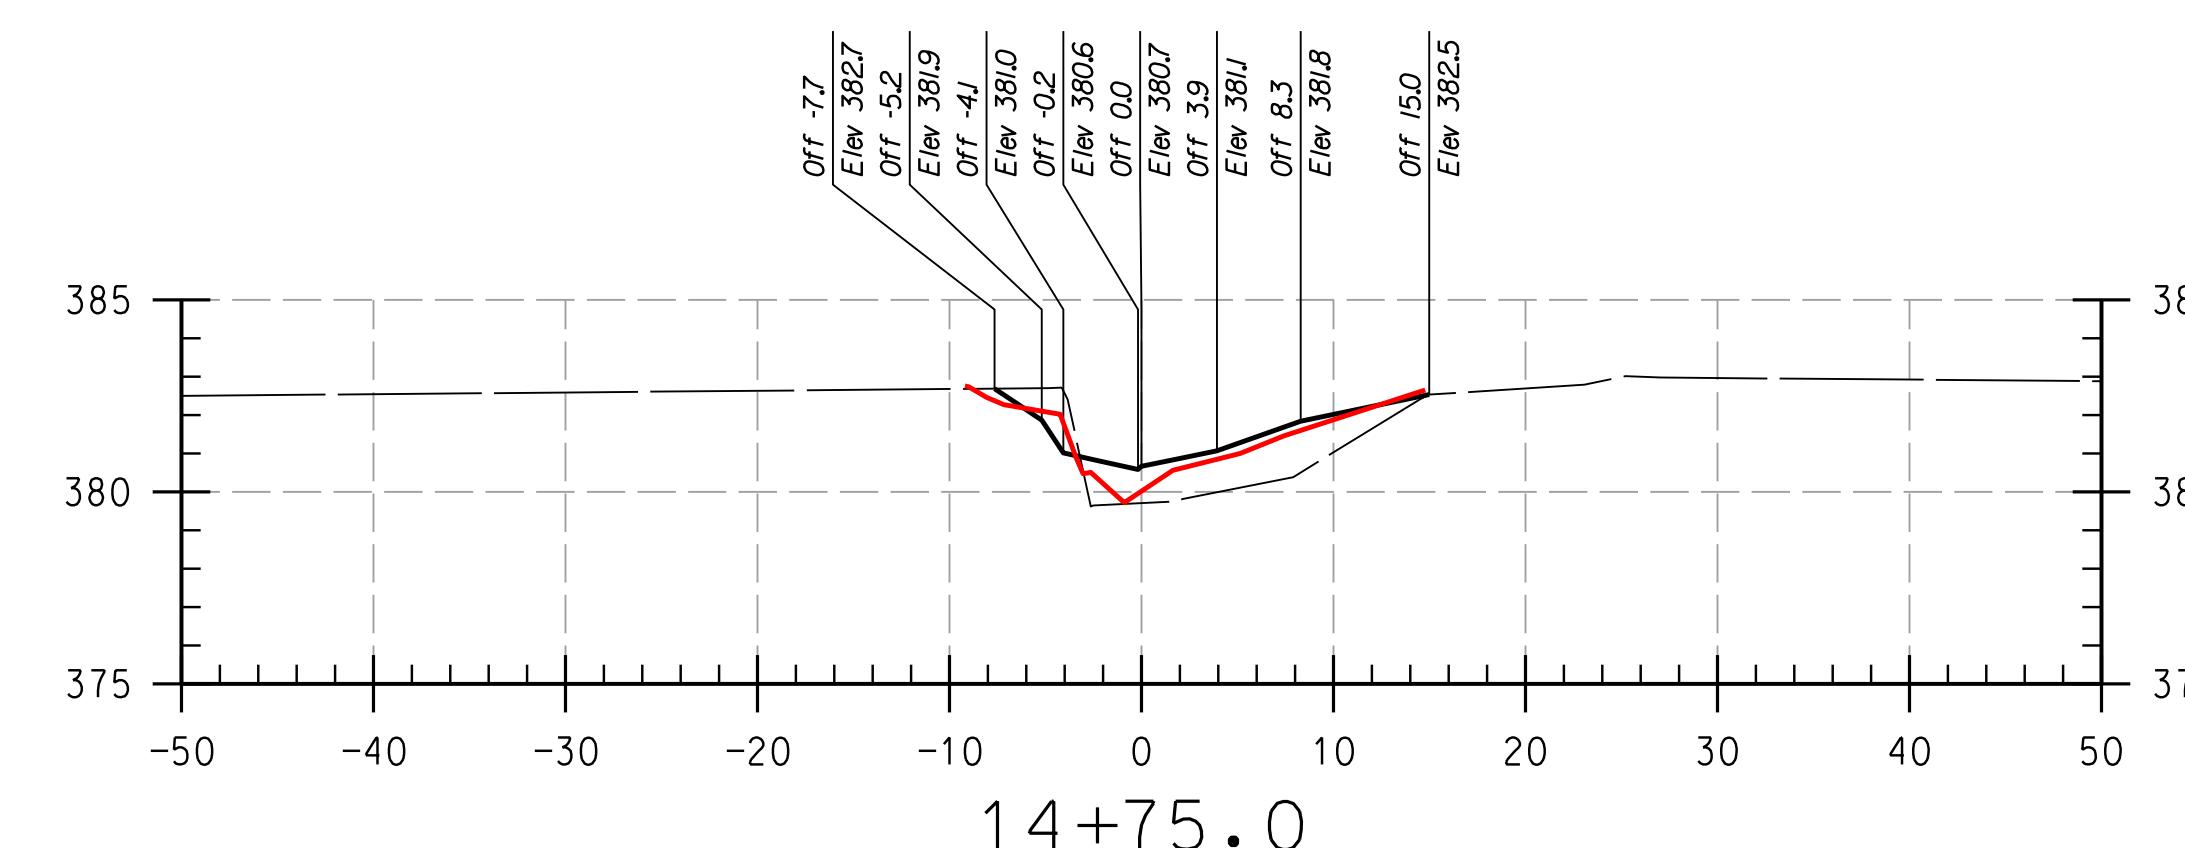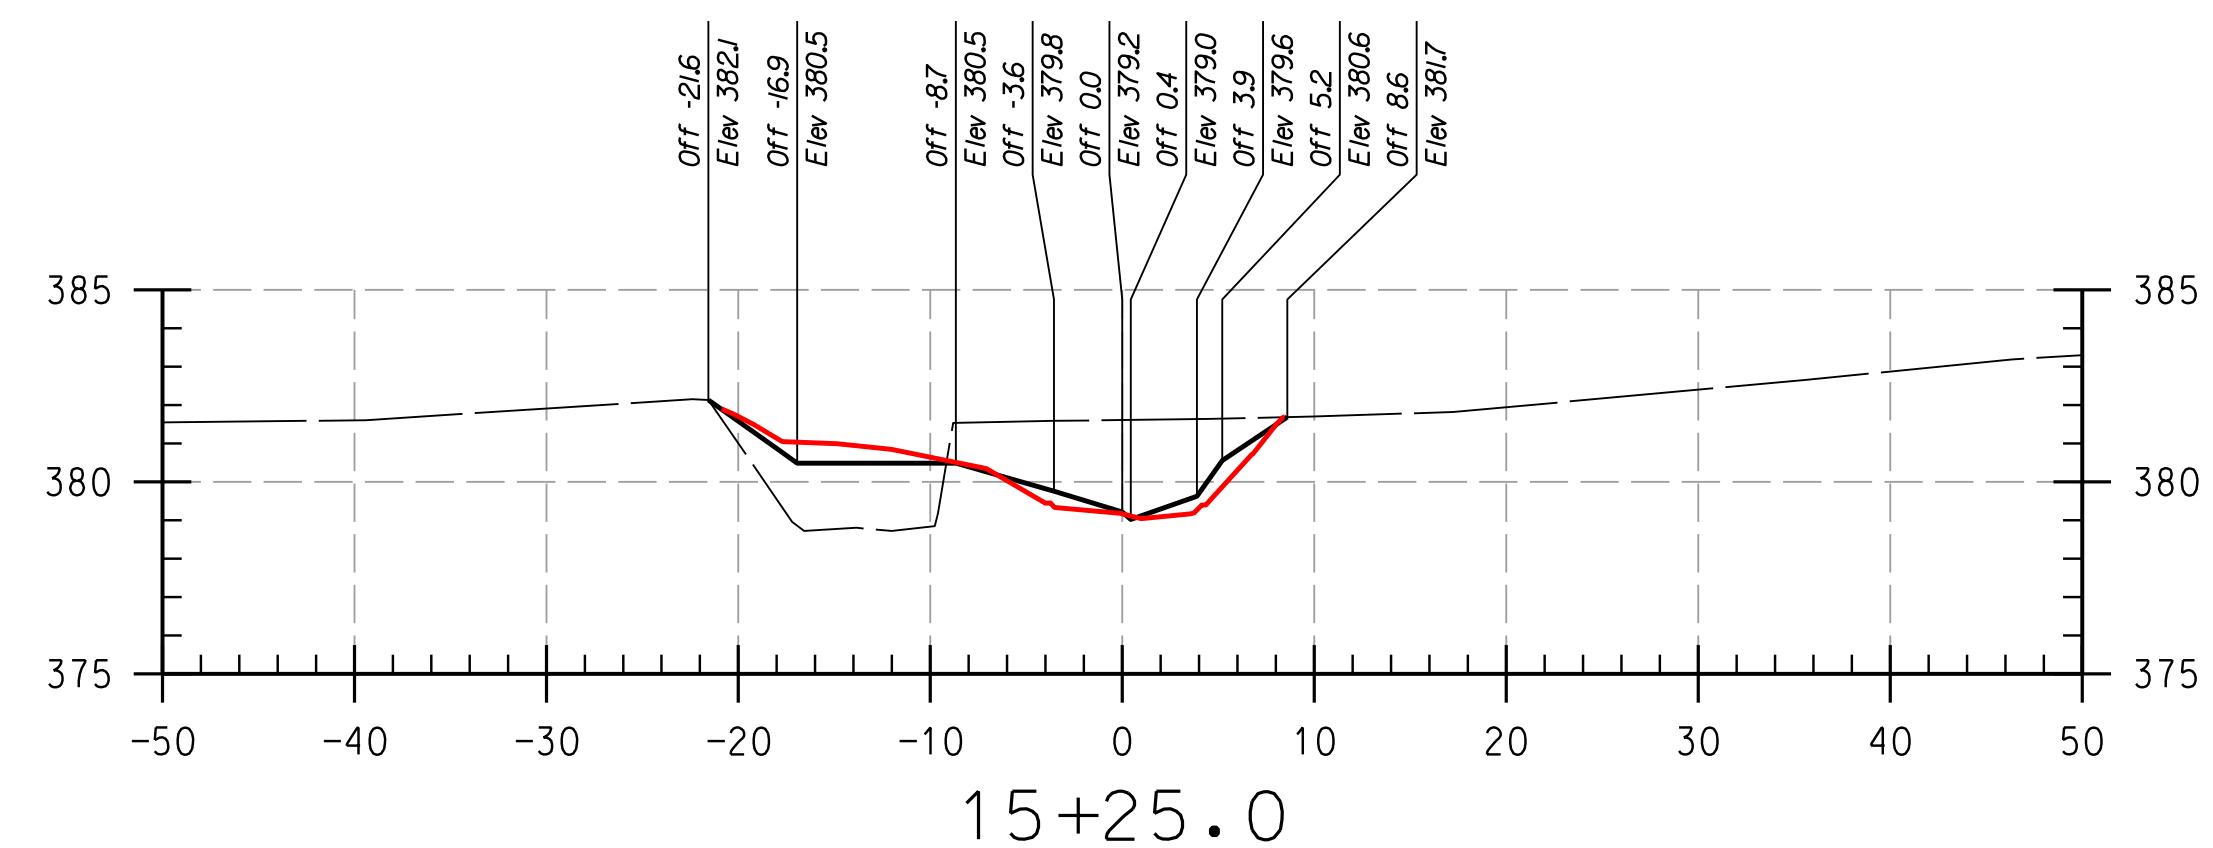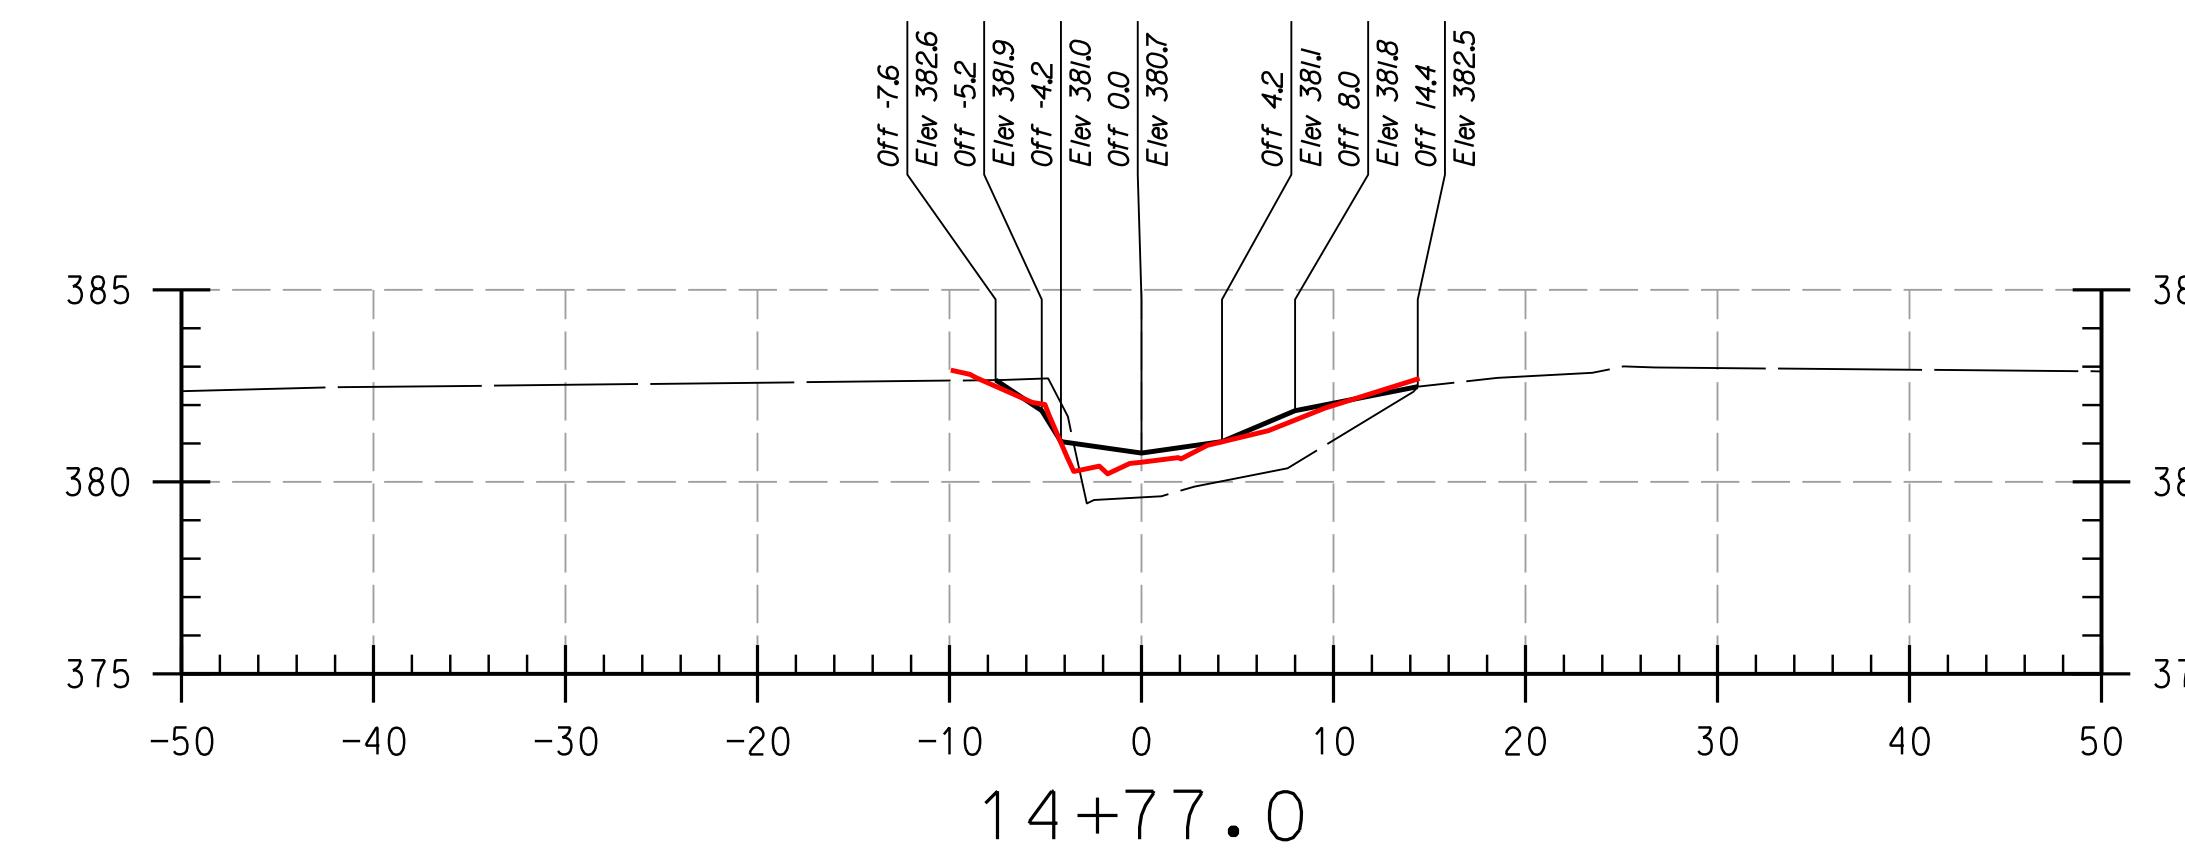

REACH 2

LEGEND

NOTE:
UTILITIES SHOWN ON THESE PLANS HAVE BEEN
USING THE BEST AVAILABLE INFORMATION. HOW-
EVER, CONTRACTOR IS TO EXERCISE EXTREME CAUTION
EXCAVATING NEAR ANY UTILITIES. TEST PIT IF

4

THIS DEVELOPMENT IS APPROVED FOR SOIL EROSION AND SEDIMENT CONTROL BY THE HOWARD SOIL CONSERVATION DISTRICT.

OL

DEPARTMENT OF PUBLIC WORKS, HOWARD COUNTY, MD

—

AS-BUILT CROSS SECTIONS

SCALE:	HOR: 1" = 10'
	VERT: 1" = 5'
DATE:	APRIL 2017
KCI JOB NO.:	17133314.83
CAPITAL PROJECT NO.:	D-115
PERMIT ISSUE:	
CONSTRUCTION ISSUE	

CS-18

SHEET NO.: 18 OF 20









CTK

HOWARD COMMUNITY COLLEGE
STREAM RESTORATION PROJECT
CAPITAL PROJECT D-1158
HOWARD COUNTY DEPARTMENT OF PUBLIC WORKS
STORMWATER MANAGEMENT DIVISION
6751 COLUMBIA GATEWAY DRIVE
COLUMBIA, MD 21046
PARCELS 47, 81 TAX MAP 35, 36
GIBSON ROCK
NG POB NT ELECTION DISTRICT 05

SCALE: HOR: 1" = 10'
VERT: 1" = 5'
DATE: APRIL 2017
KCI JOB NO.: 17133314.83
CAPITAL PROJECT NO.: D-1158
PERMIT ISSUE:
CONSTRUCTION ISSUE:

CS-18

SHEET NO.: 18 OF 27

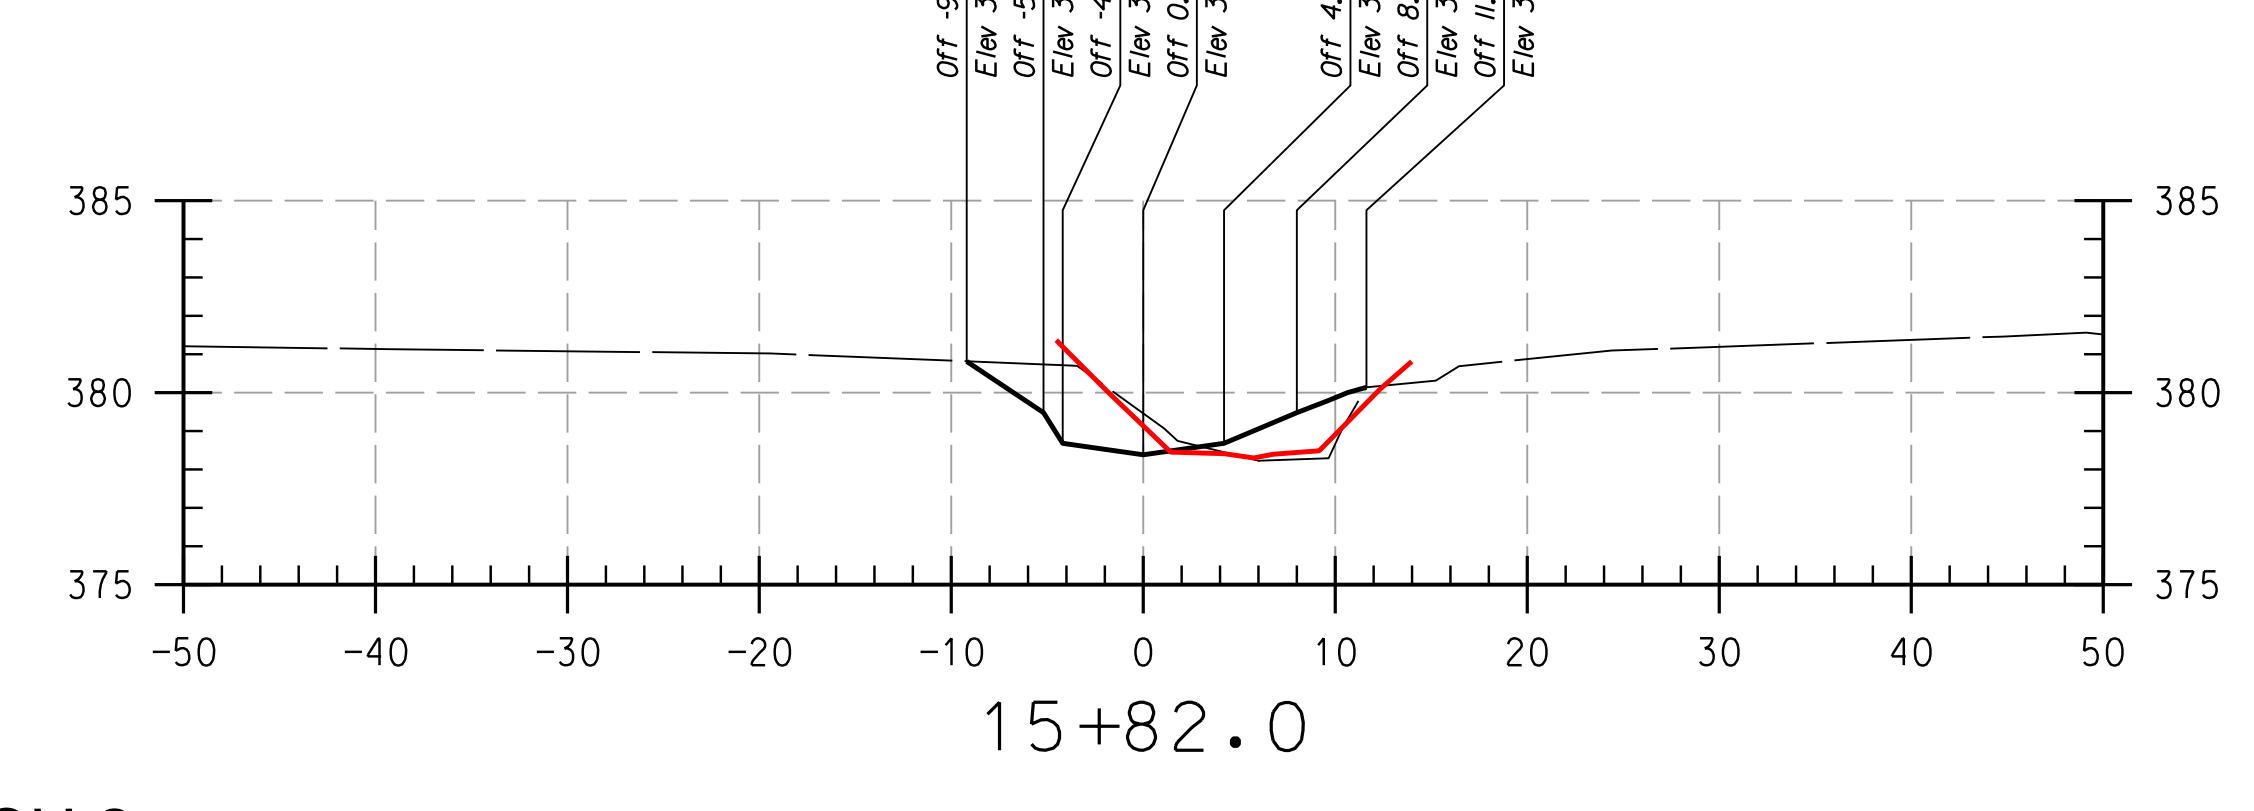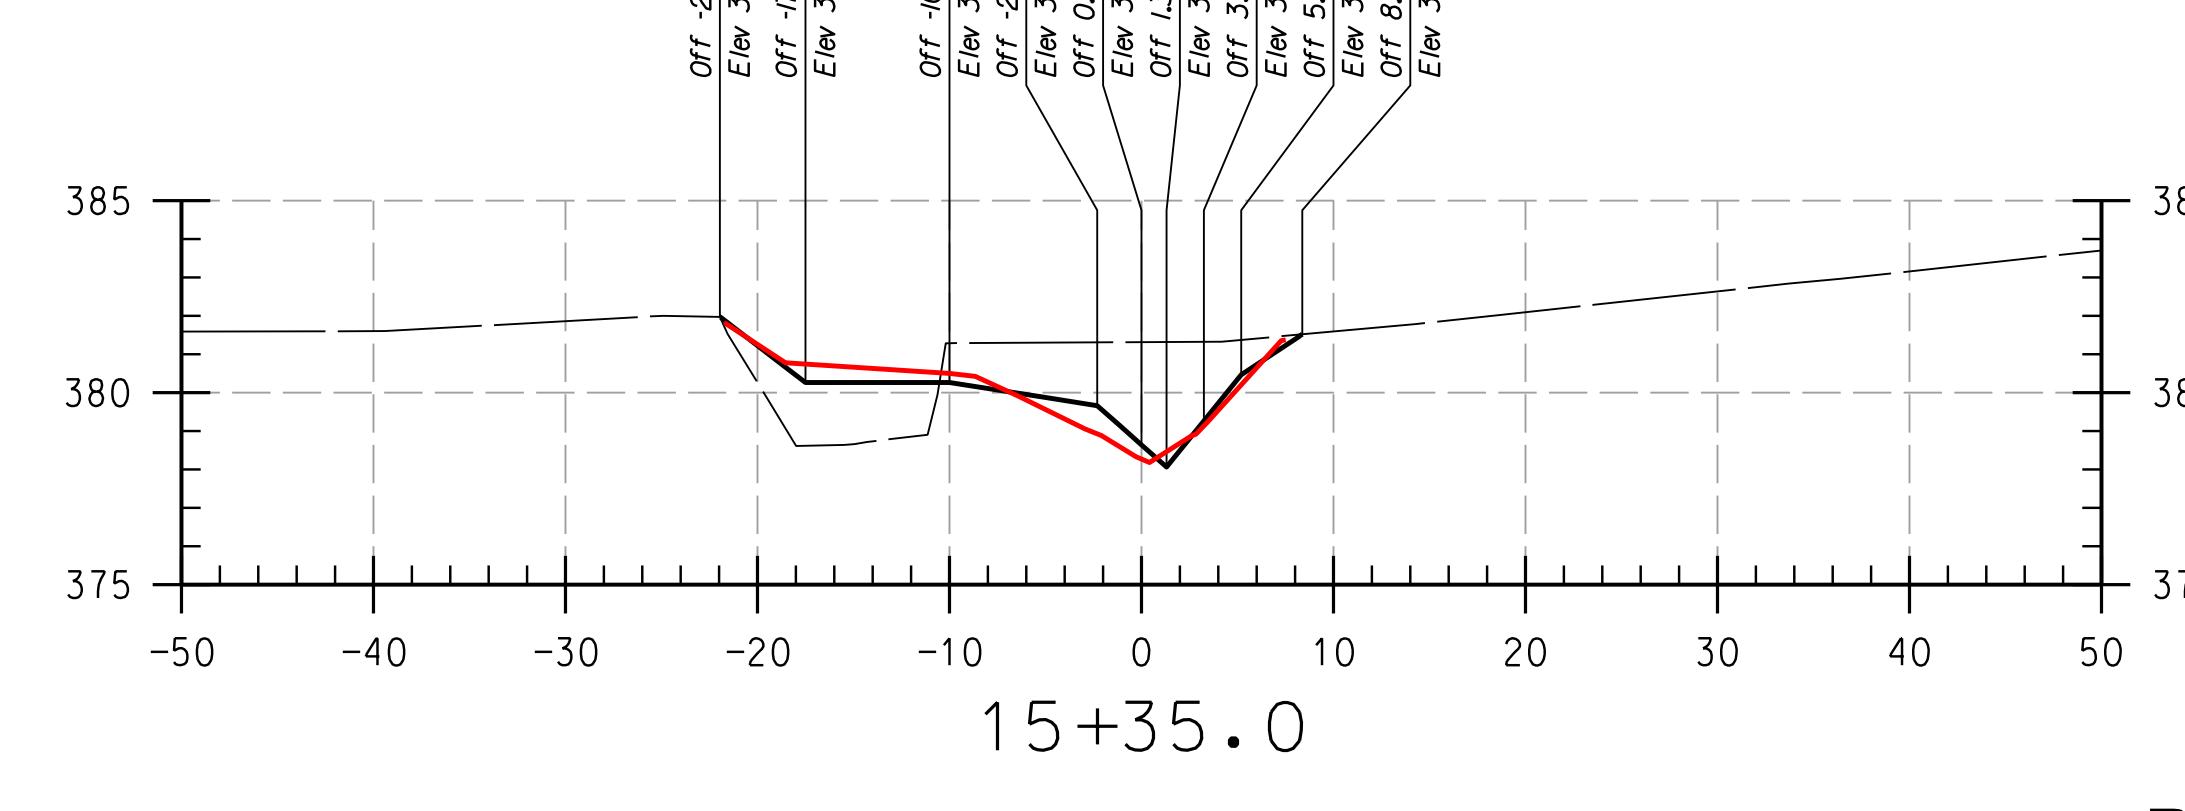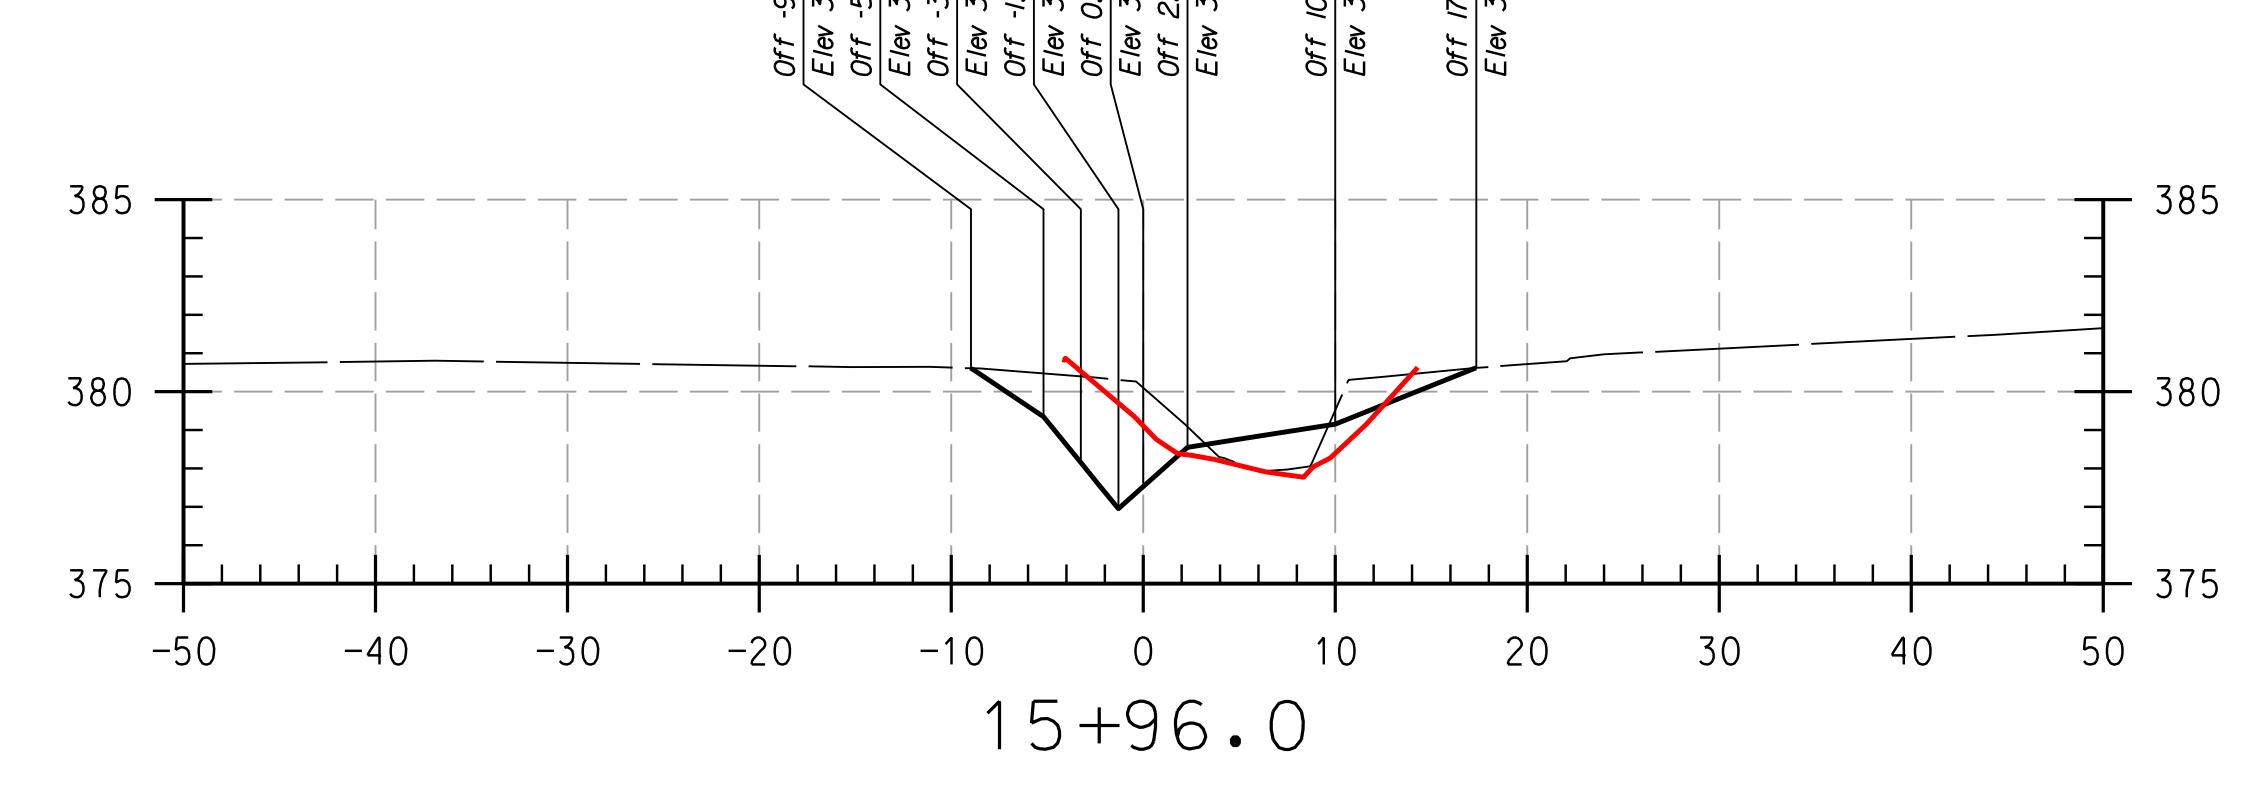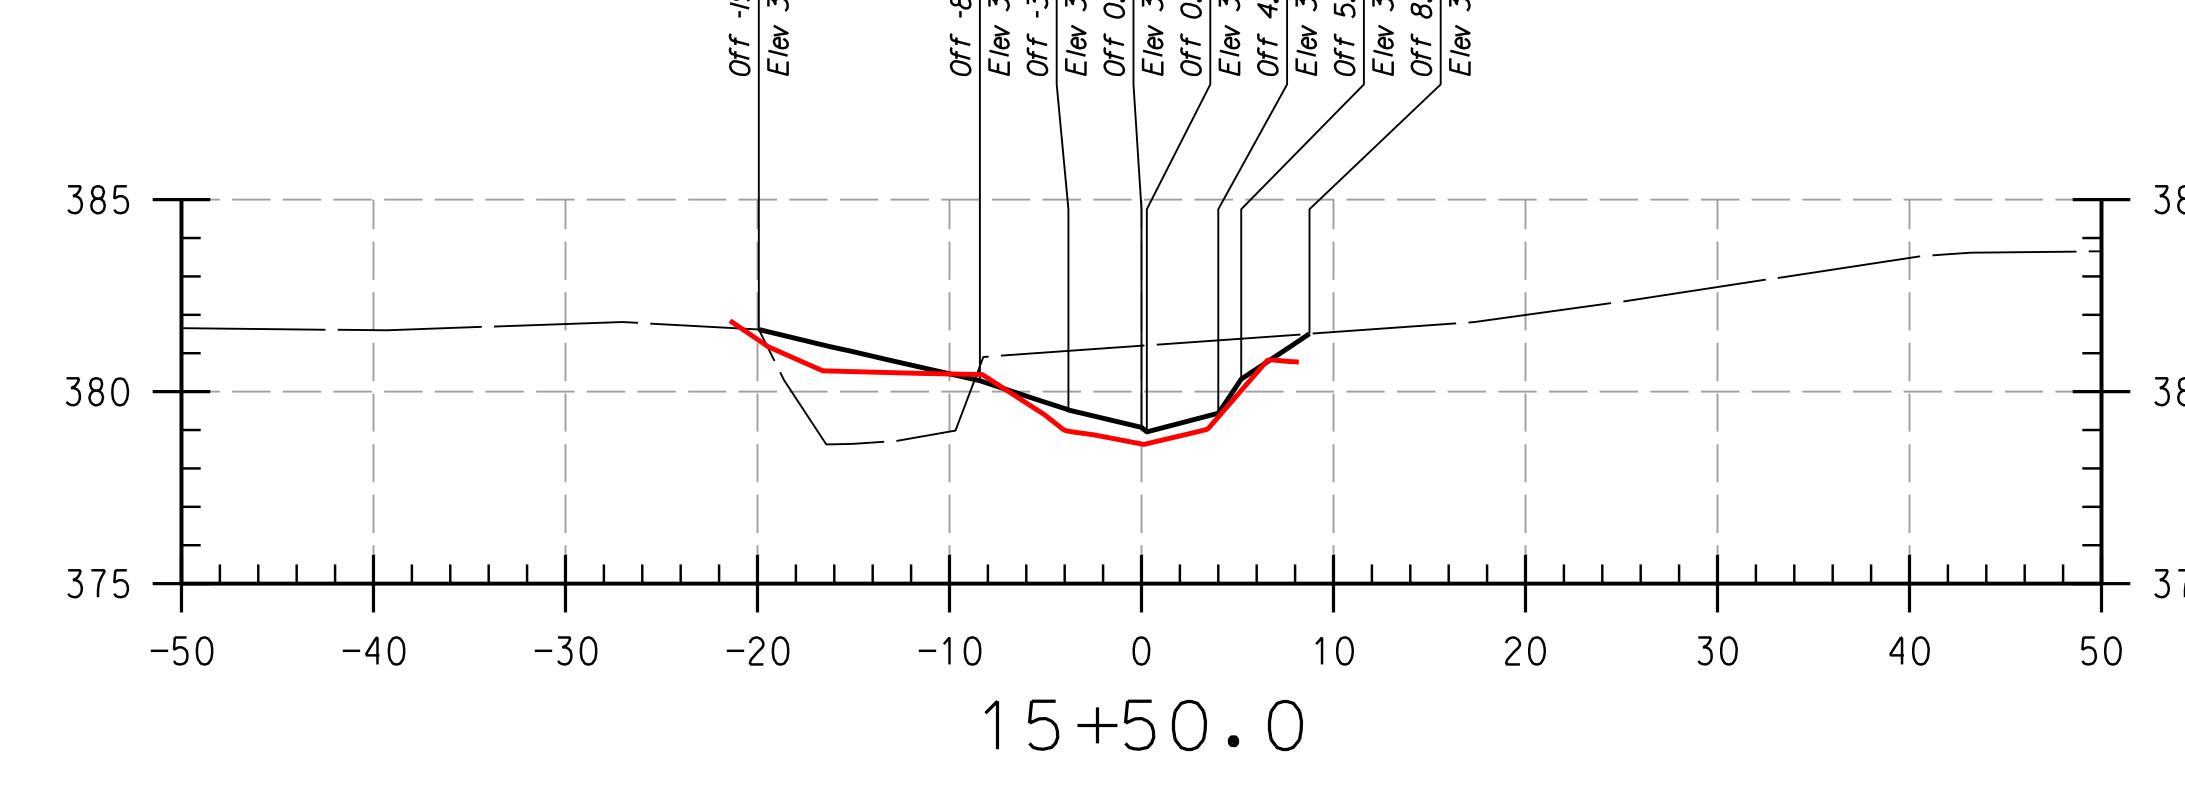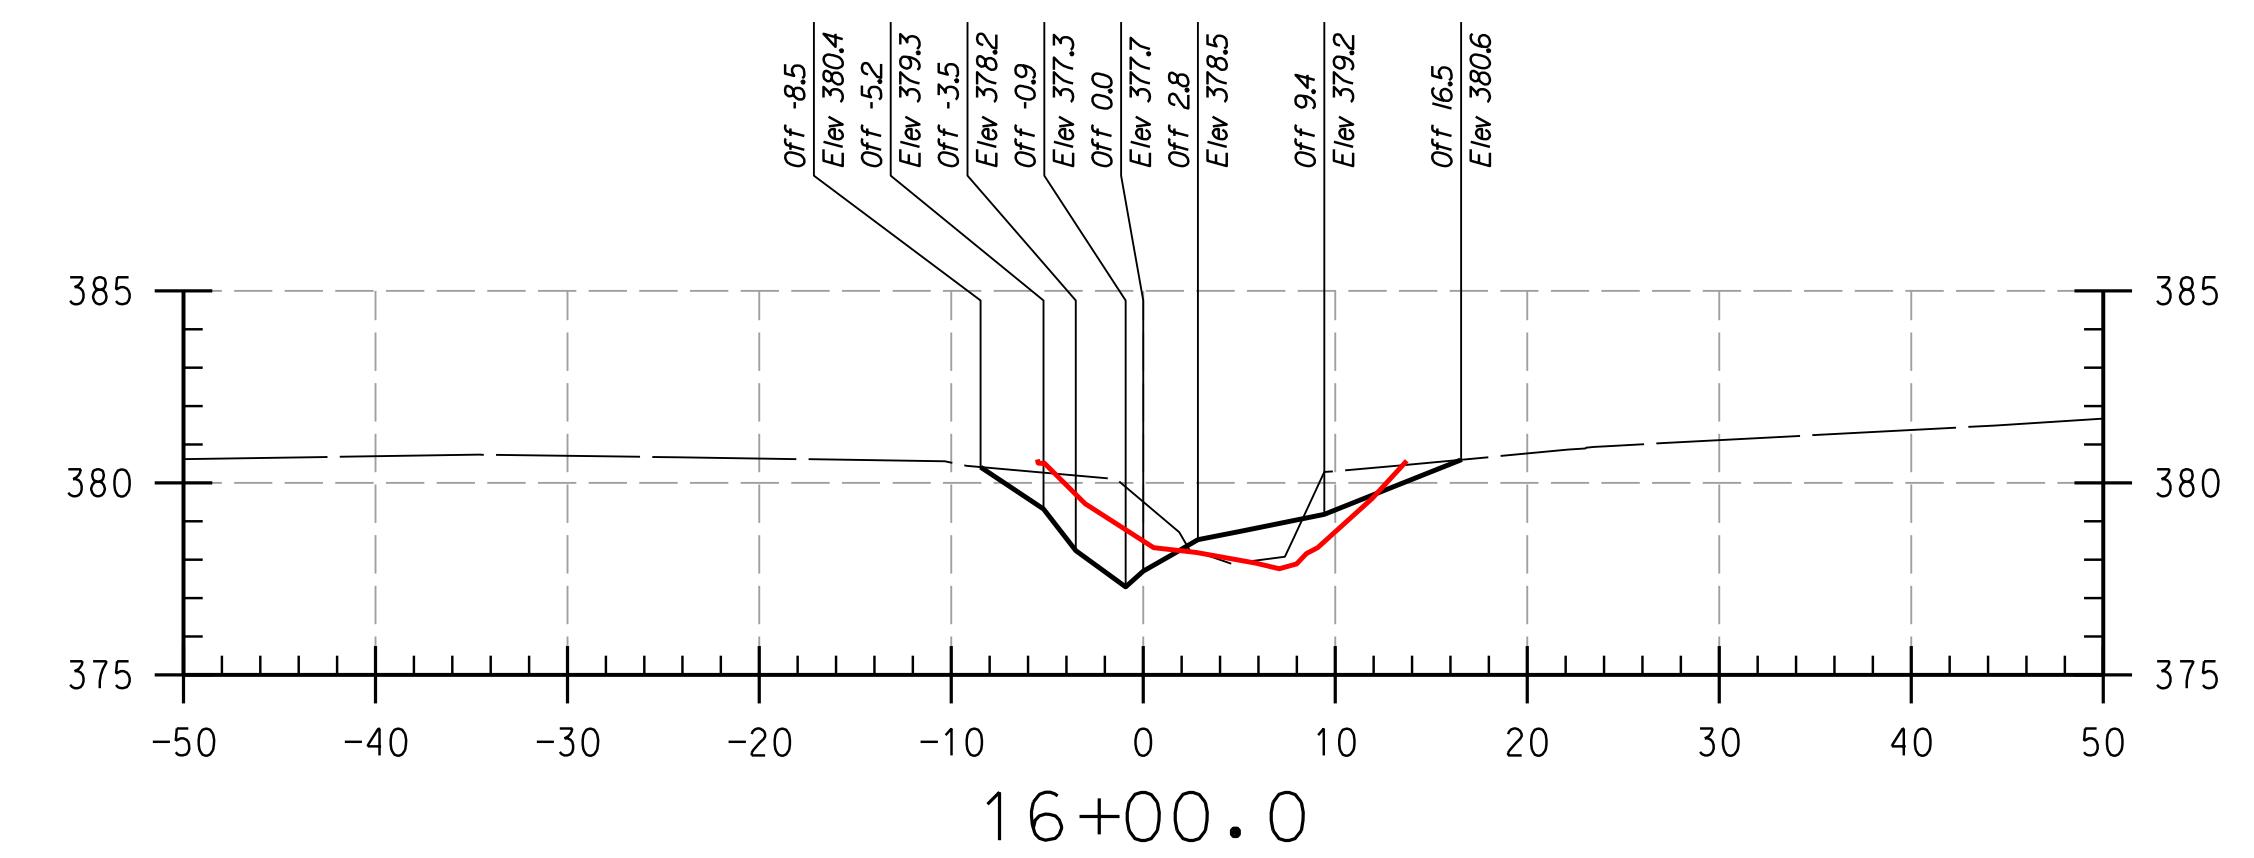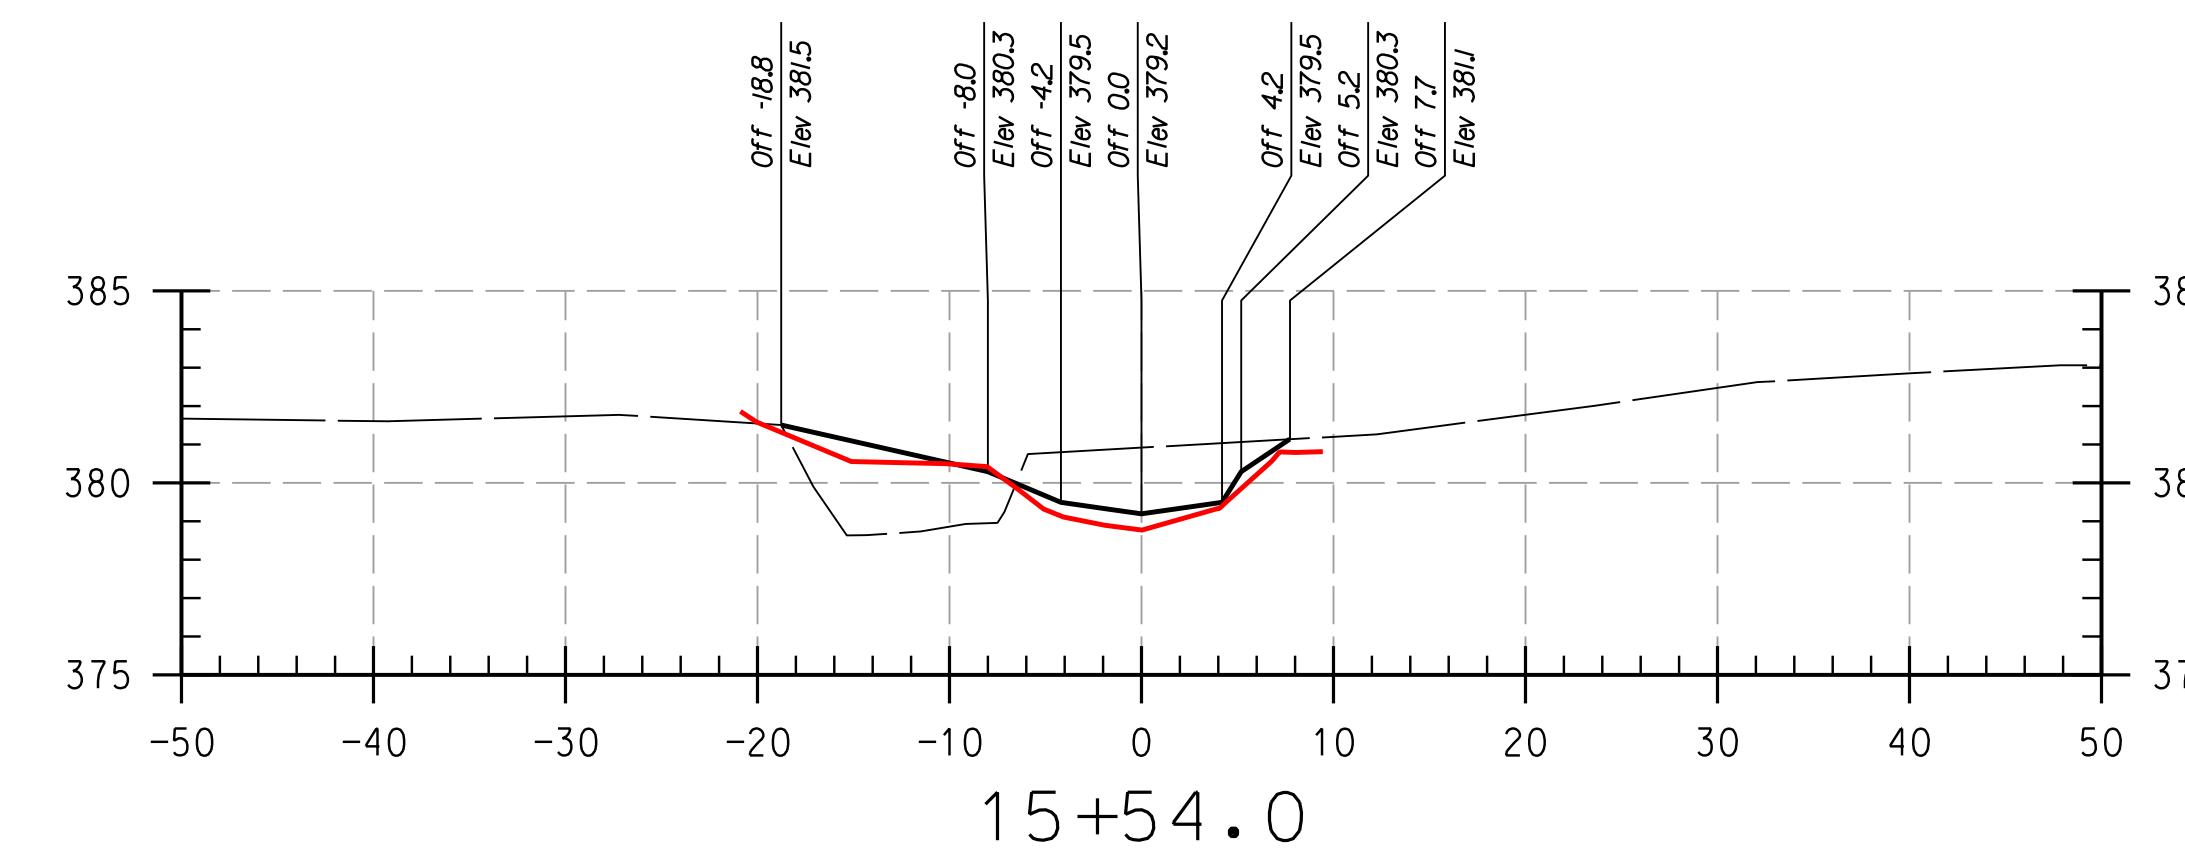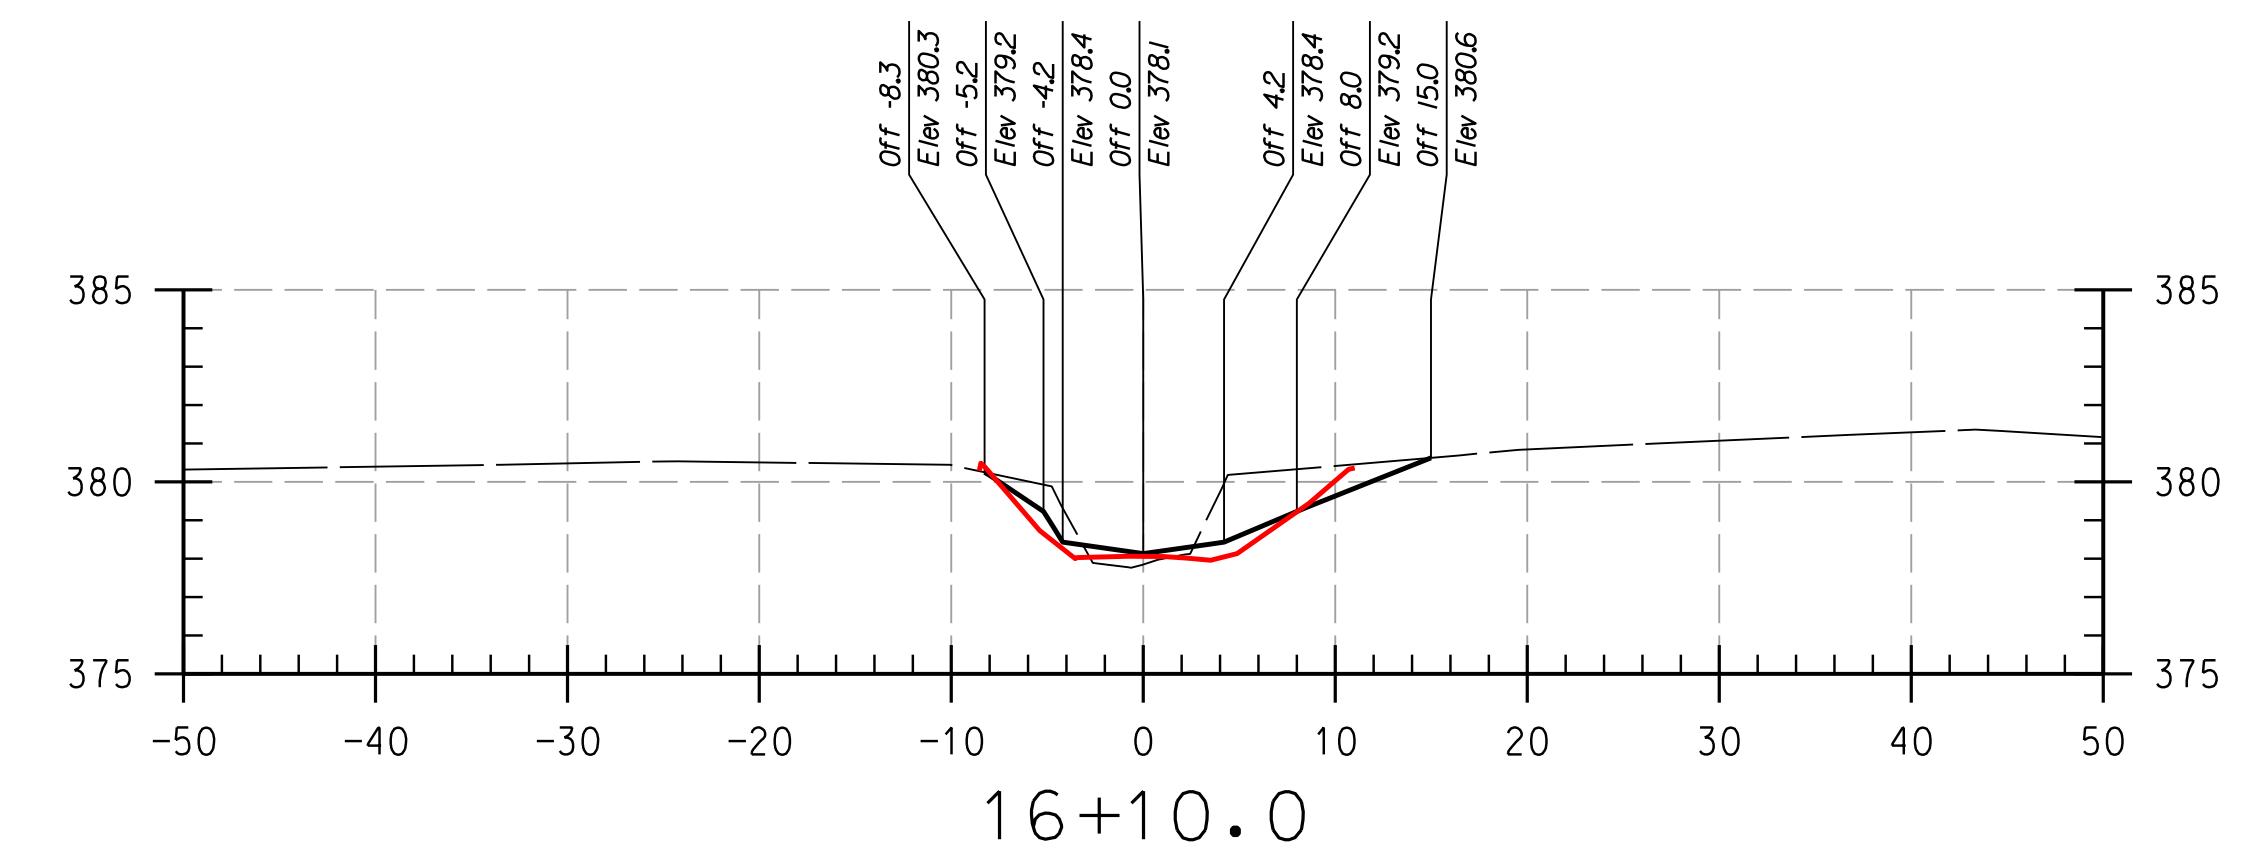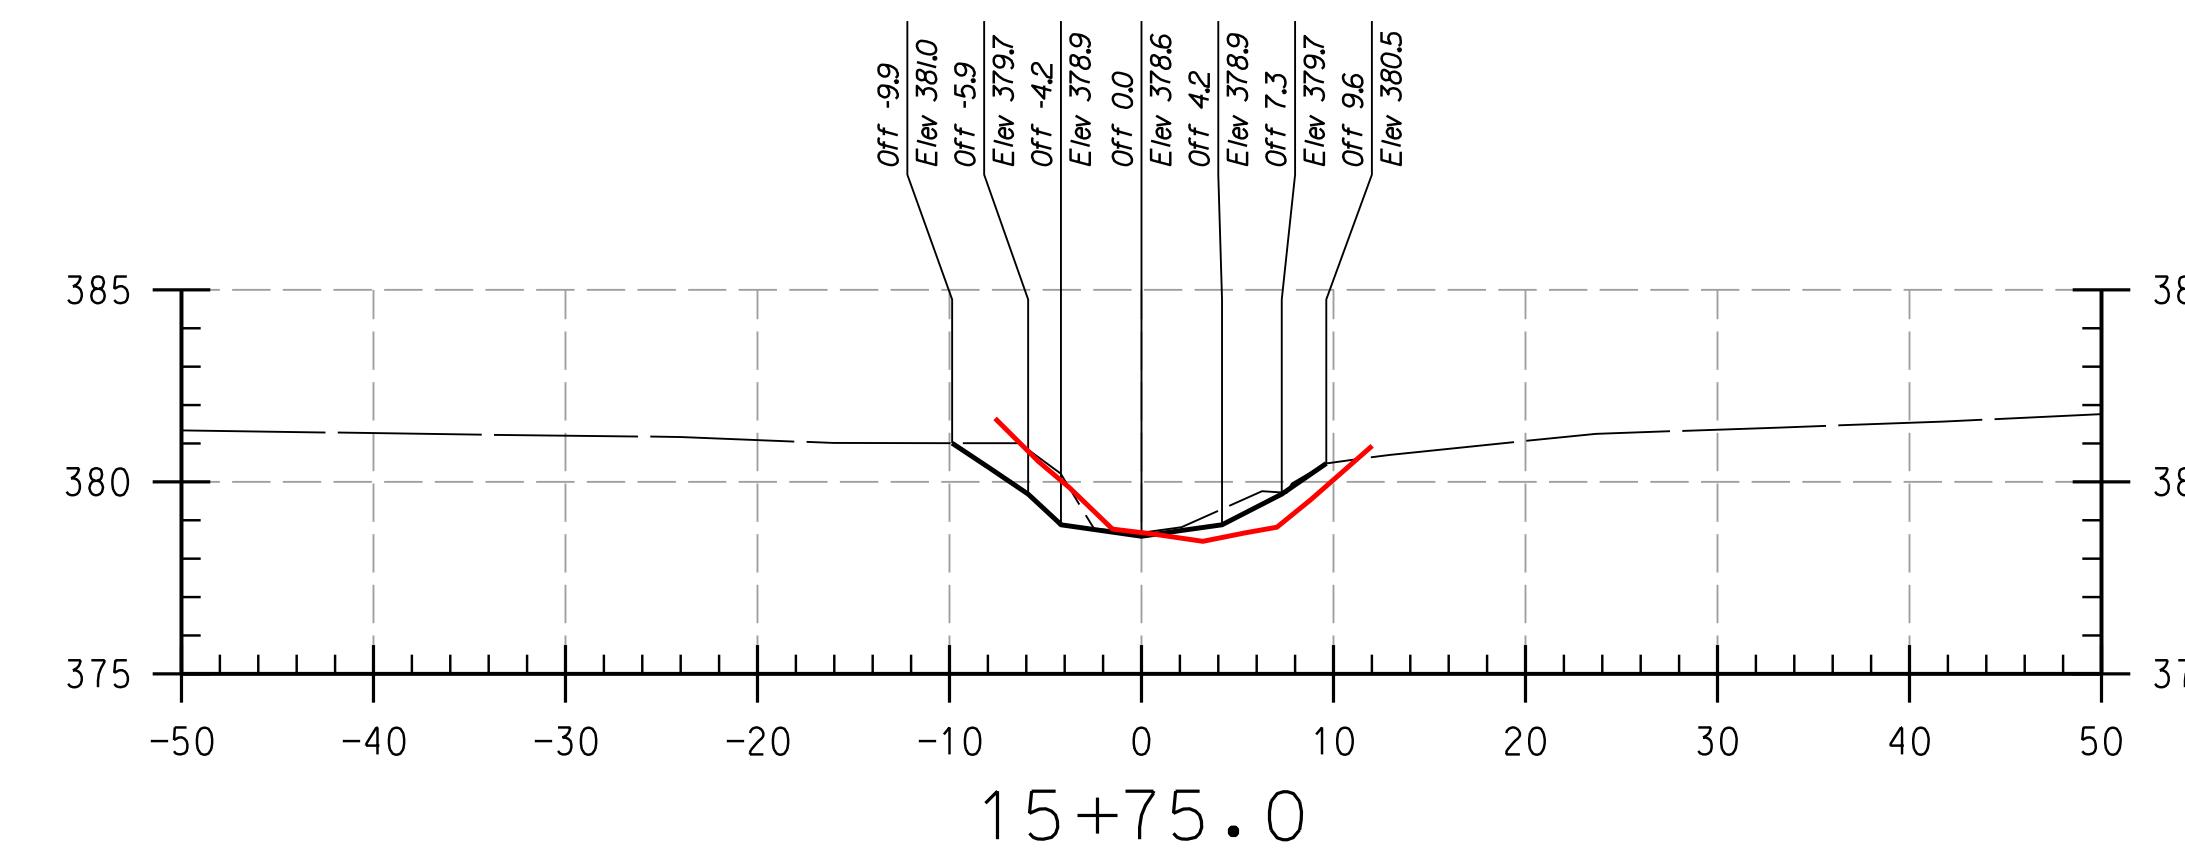

REACH 2

LEGEND

NOTE:
UTILITIES SHOWN ON THESE PLANS HAVE BEEN
USING THE BEST AVAILABLE INFORMATION. HOW-
EVER, CONTRACTOR IS TO EXERCISE EXTREME CAUTION
EXCAVATING NEAR ANY UTILITIES. TEST PIT IF

AT
E

THIS DEVELOPMENT IS APPROVED FOR SOIL EROSION AND SEDIMENT CONTROL
BY THE HOWARD SOIL CONSERVATION DISTRICT.

OL

DEPARTMENT OF PUBLIC WORKS, HOWARD COUNTY, MD

—

936 RIDGEBROOK ROAD
SPARKS, MARYLAND 21152
TELEPHONE: (410) 316-7800
FAX: (410) 316-7818
www.kci.com

The logo for KCI Technologies features a stylized graphic on the left composed of vertical bars of varying widths and heights, creating a pattern reminiscent of a barcode or a series of steps. To the right of this graphic, the letters "KCI" are written in a large, bold, black serif font. Below "KCI", the words "TECHNOLOGIES" are written in a smaller, black sans-serif font.

**HOWARD COMMUNITY COLLEGE
STREAM RESTORATION PROJECT**

CAPITAL PROJECT D-1158

HOWARD COUNTY DEPARTMENT OF PUBLIC WORKS

STORMWATER MANAGEMENT DIVISION

6751 COLUMBIA GATEWAY DRIVE

COLUMBIA, MD 21046

PARCELS 47, 81 TAX MAP 35, 36

POR, NT ELECTION DISTRICT 05 GRID/BLOCK





AS-BUILT CROSS SECTIONS

SCALE:	HOR: 1" = 10' VERT: 1" = 5'
DATE:	APRIL 2017
KCI JOB NO.:	17133314.83
CAPITAL PROJECT NO.:	D-1158
PERMIT ISSUE:	
CONSTRUCTION ISSUE:	

CS-19

LOTTED: "12:28 PM on Monday, April 24, 2017"
Y: Division:

PROFESSIONAL CERTIFICATION. I HEREBY CERTIFY THAT THESE DOCUMENTS WERE PREPARED OR APPROVED BY ME, AND THAT I AM A DULY LICENSED PROFESSIONAL ENGINEER UNDER THE LAWS OF THE STATE OF MARYLAND. LICENSE NO. 38311, EXPIRATION DATE: JANUARY 06, 2018

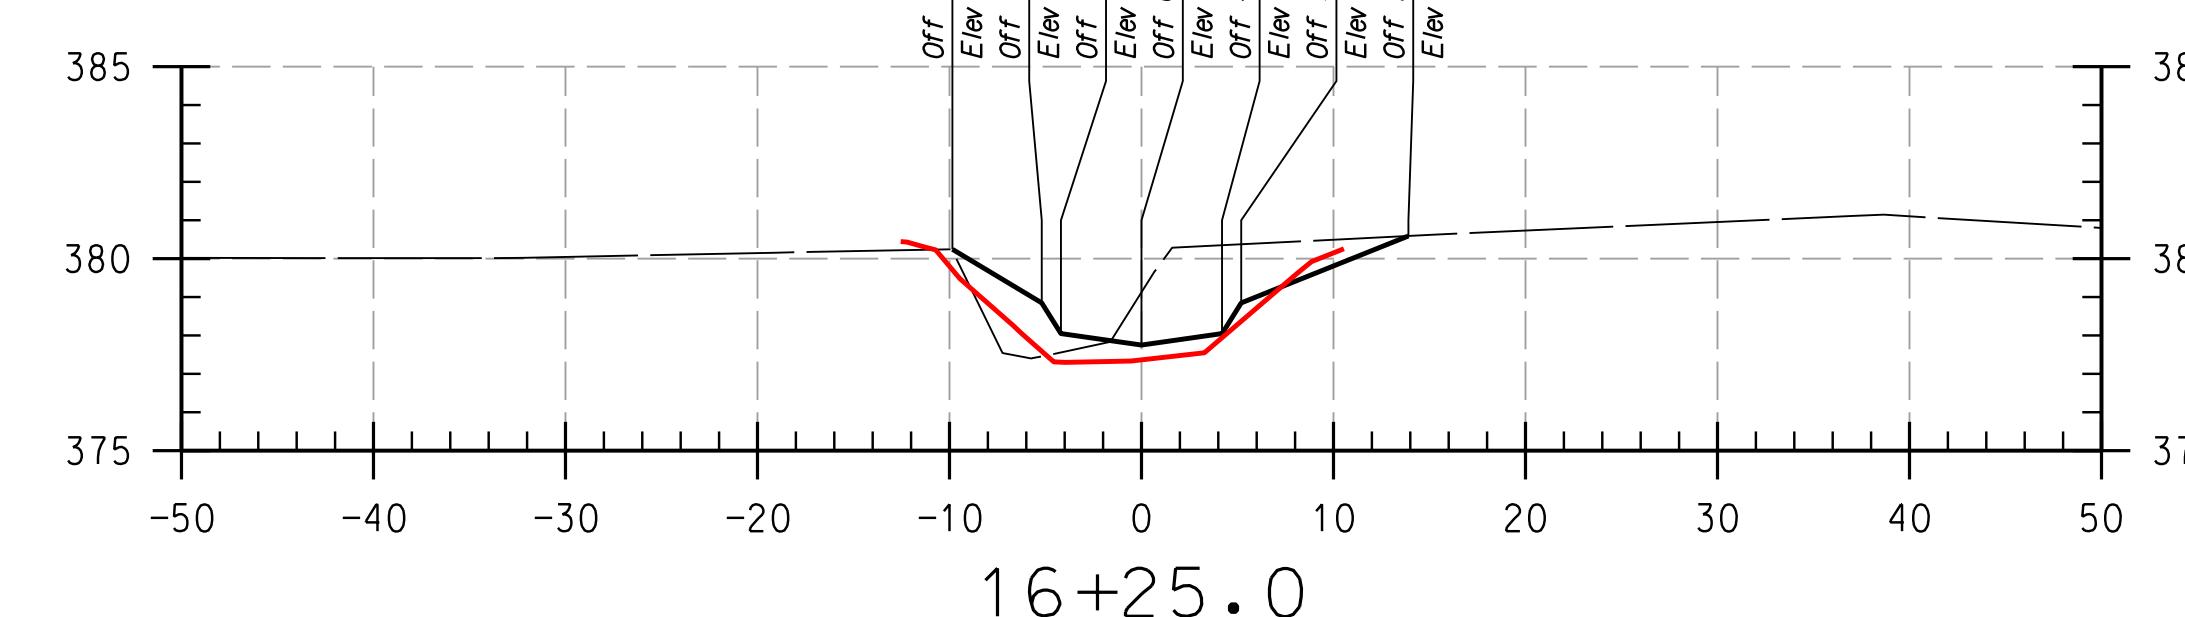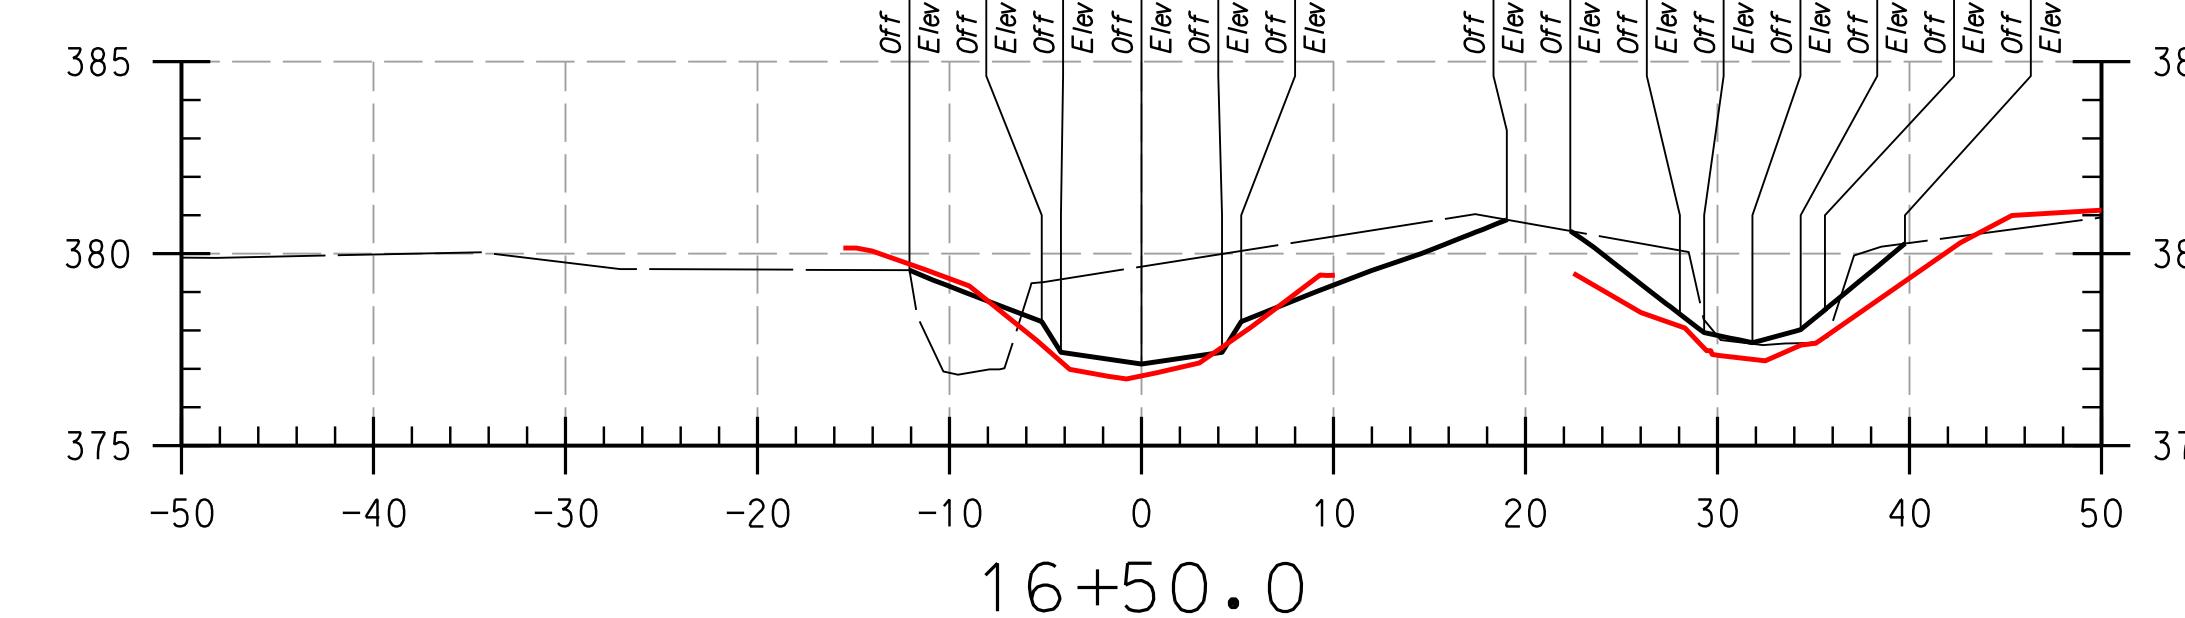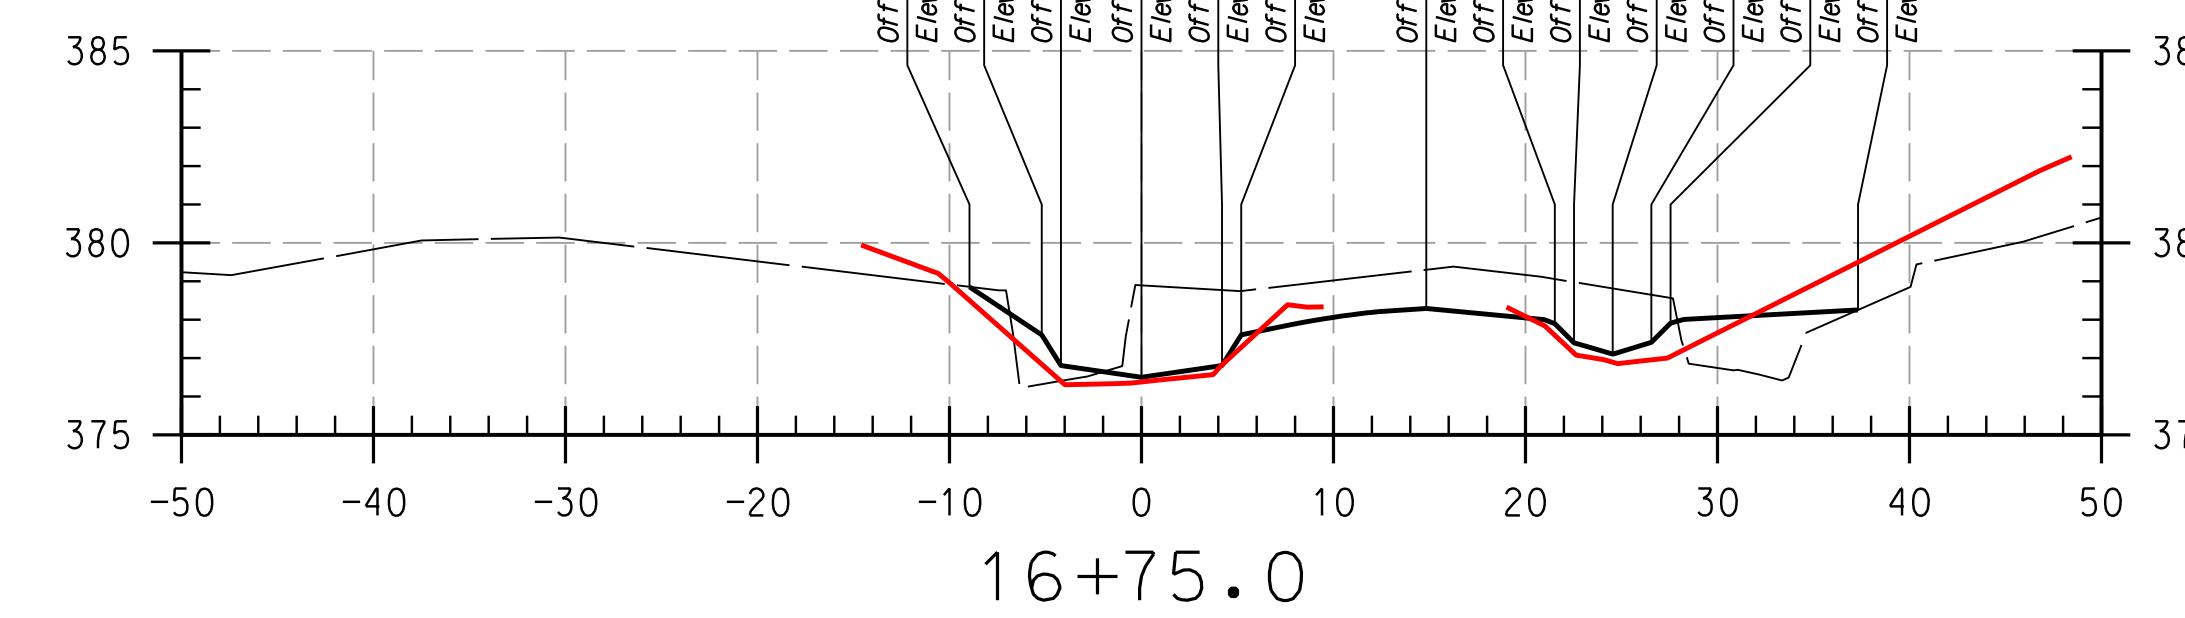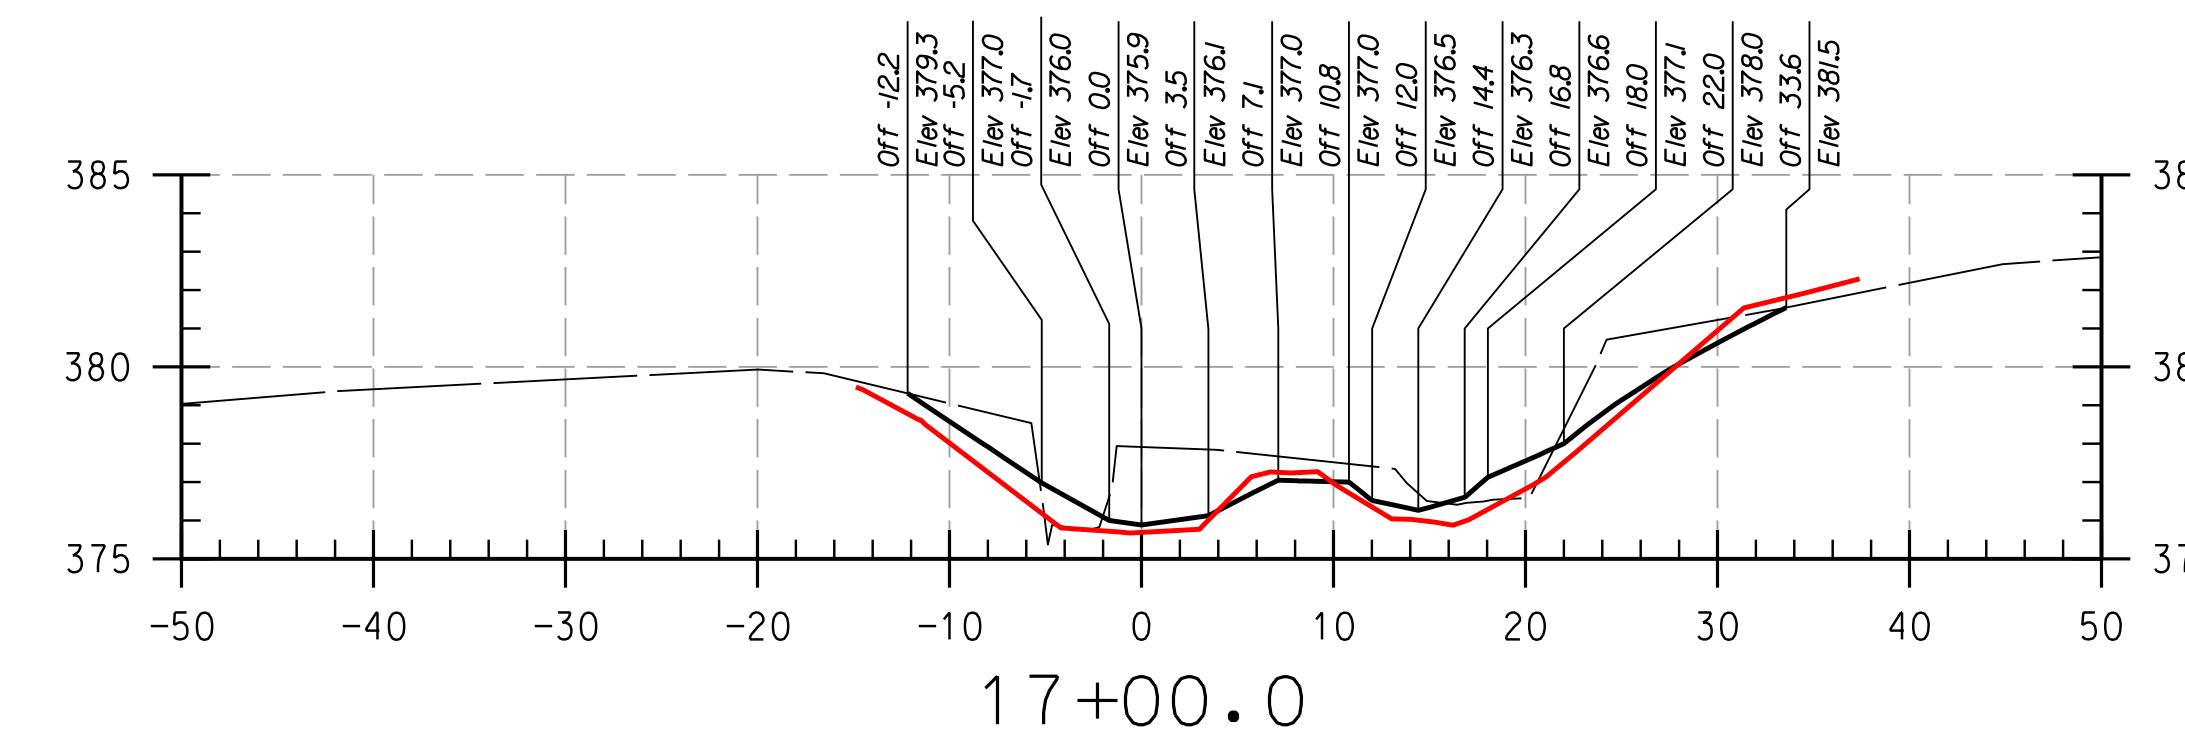

REACH 2

LEGEND

NOTE:
UTILITIES SHOWN ON THESE PLANS HAVE BEEN
USING THE BEST AVAILABLE INFORMATION. HOW-
EVER, CONTRACTOR IS TO EXERCISE EXTREME CAUTION
EXCAVATING NEAR ANY UTILITIES. TEST PIT IF

14




THIS DEVELOPMENT IS APPROVED FOR SOIL EROSION AND SEDIMENT CONTROL
BY THE HOWARD SOIL CONSERVATION DISTRICT.

ROL

DEPARTMENT OF PUBLIC WORKS, HOWARD COUNTY, MD

1

1

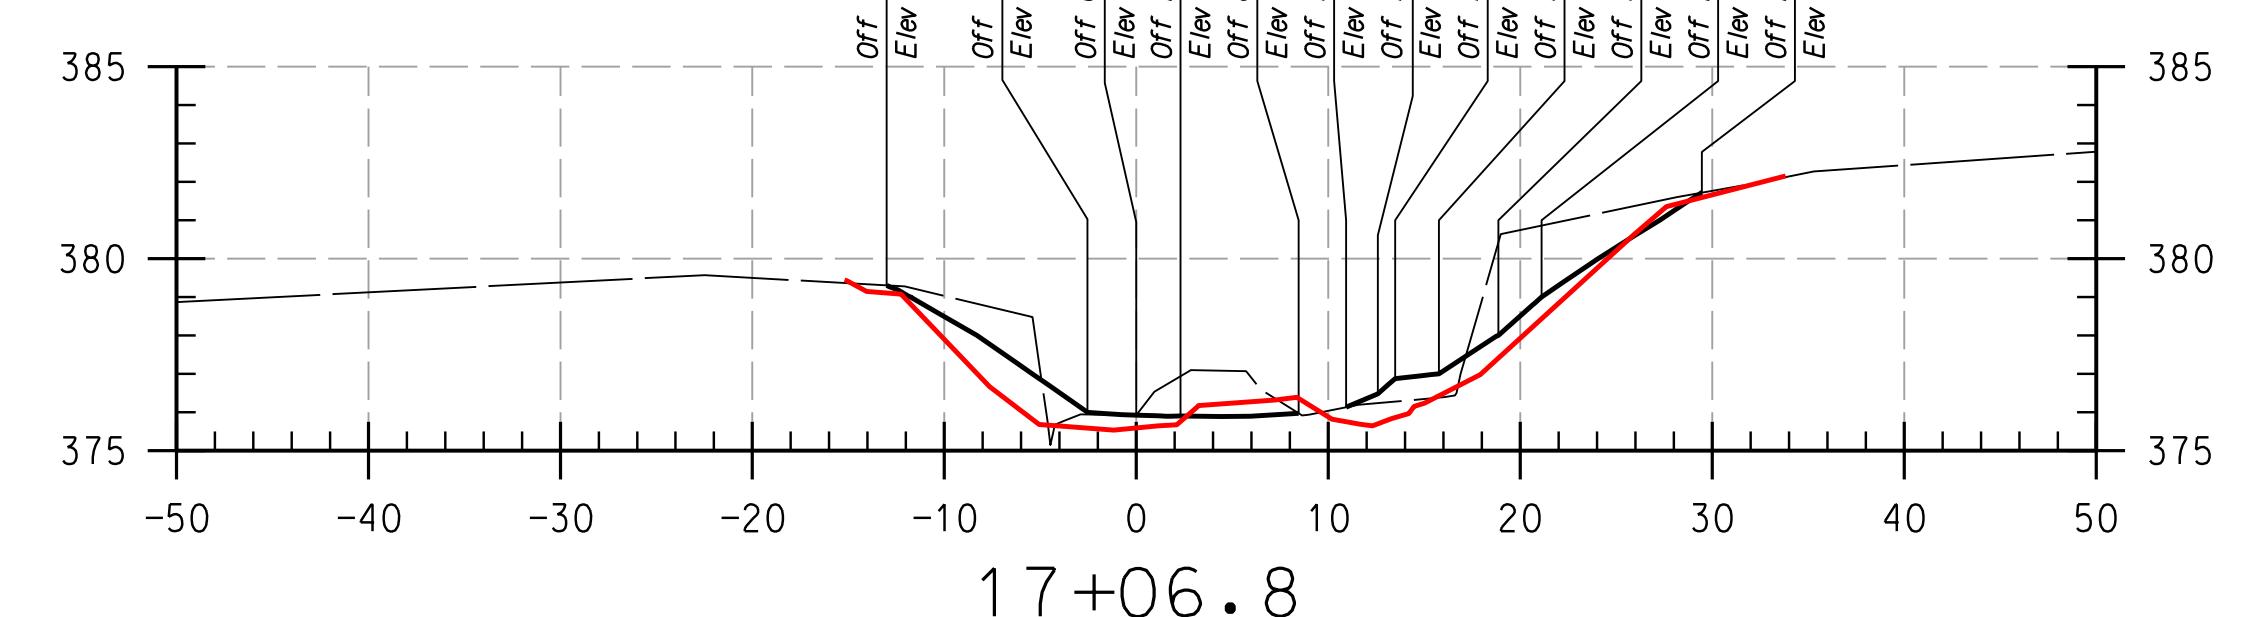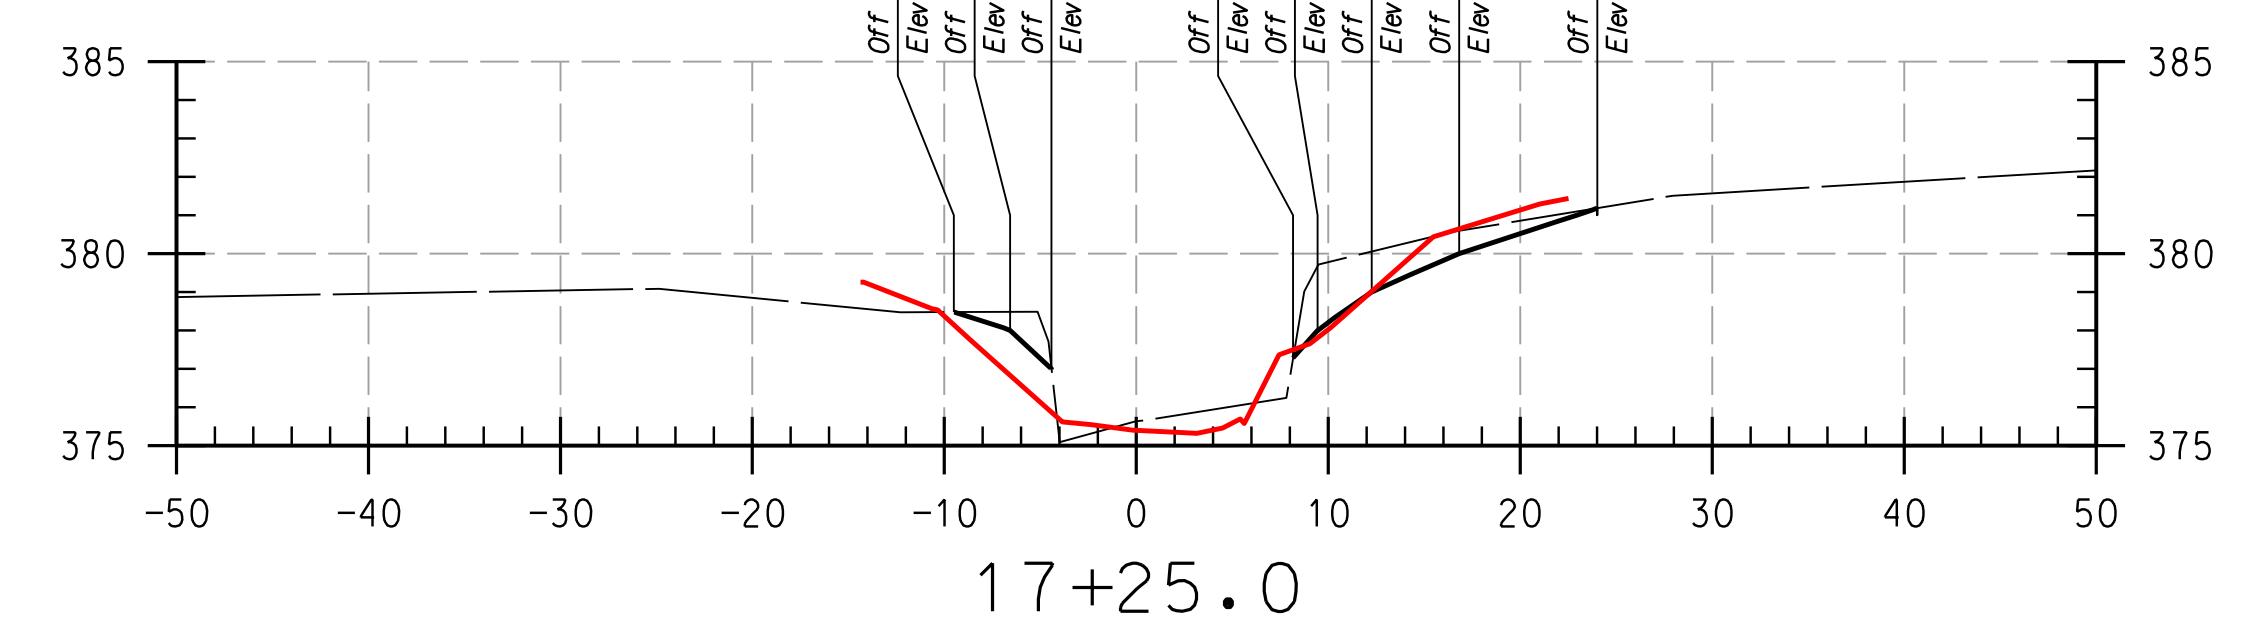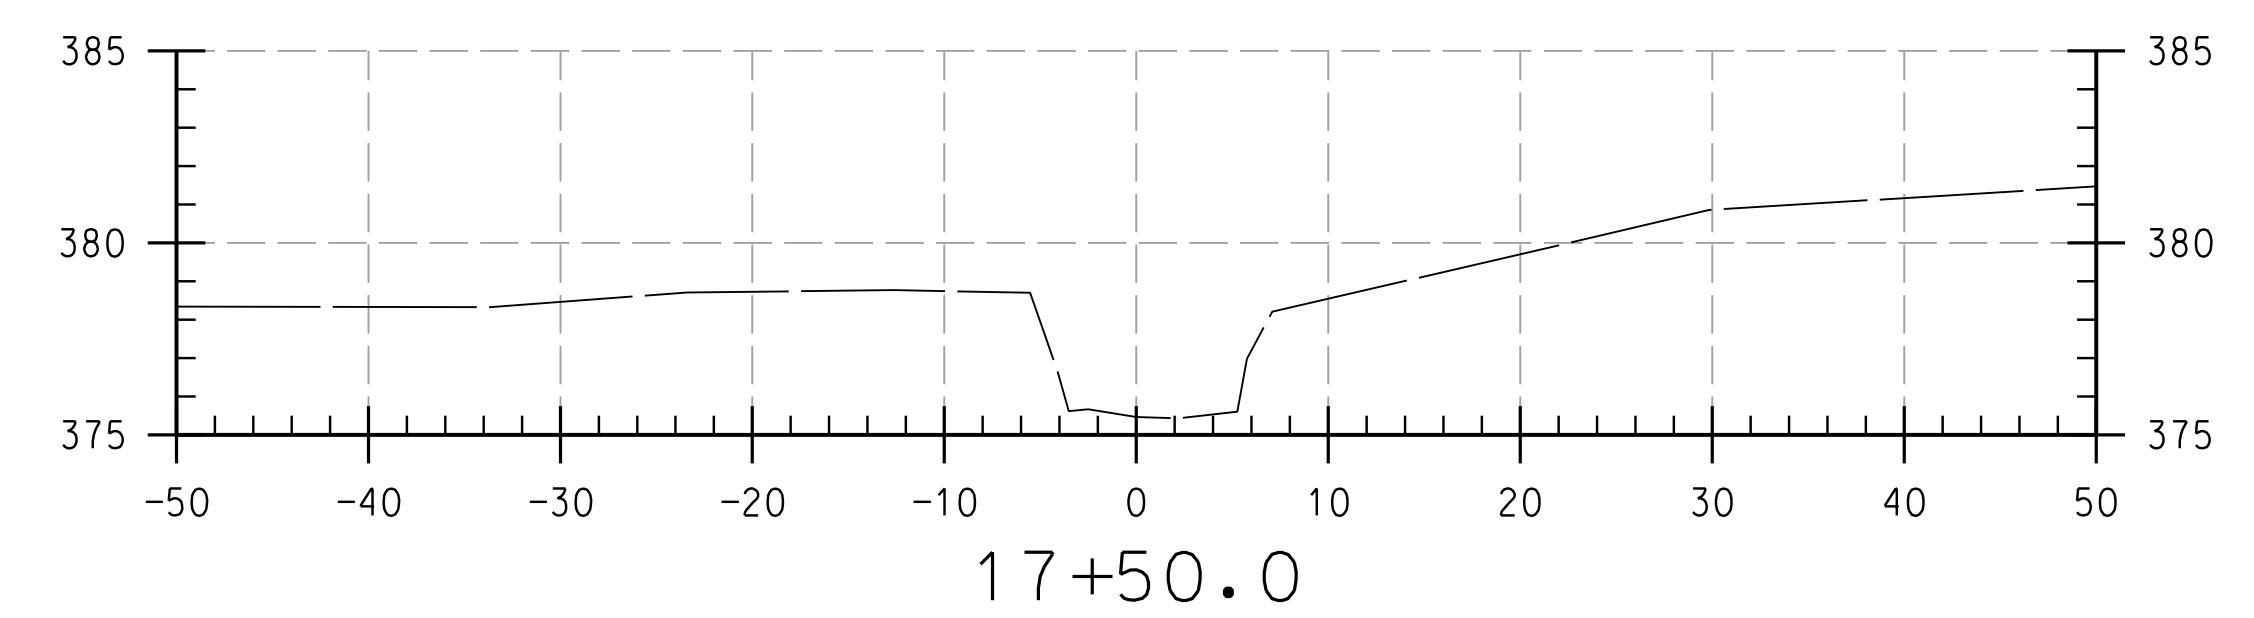

OWARD COMMUNITY COLLEGE
STREAM RESTORATION PROJECT
CAPITAL PROJECT D-1158
OWARD COUNTY DEPARTMENT OF PUBLIC WORKS
STORMWATER MANAGEMENT DIVISION
6751 COLUMBIA GATEWAY DRIVE
COLUMBIA, MD 21046
PARCELS 47, 81 TAX MAP 35, 36
POR, NT ELECTION DISTRICT 05 GRID/BLOCK 00

AS-BUILT CROSS SECTIONS

SCALE:	HOR: 1" = 10'
	VERT: 1" = 5'
DATE:	APRIL 2017
KCI JOB NO.:	17133314.83
CAPITAL PROJECT NO.:	D-1158
PERMIT ISSUE:	
CONSTRUCTION ISSUE:	

CS 30

SHEET NO.: 20 OF 27

KC FILE: M:\ 2013 \ 1713334.83\

936 RIDGEBROOK ROAD
SPARKS, MARYLAND 21152
TELEPHONE: (410) 316-7800
FAX: (410) 316-7818
www.kci.com



KCI
TECHNOLOGIES



HOWARD COMMUNITY COLLEGE
STREAM RESTORATION PROJECT
CAPITAL PROJECT D-1158
HOWARD COUNTY DEPARTMENT OF PUBLIC WORKS
STORMWATER MANAGEMENT DIVISION
6751 COLUMBIA GATEWAY DRIVE
COLUMBIA, MD 21046
PARCELS 47 & 48, TAX MAP 35-36
GRID BLOCK 0006
ZONING: R-1, ELECTION DISTRICT 06

AS-BUILT CROSS SECTIONS





SCALE: HOR: 1" - 10'
DATE: APRIL 2017
VERT: 1" - 5'
KC JOB NO.: 17133314.83
CAPITAL PROJECT NO.: D-1158
PERMIT ISSUE:
CONSTRUCTION ISSUE:

CS-21

SHEET NO.: 21 OF 27

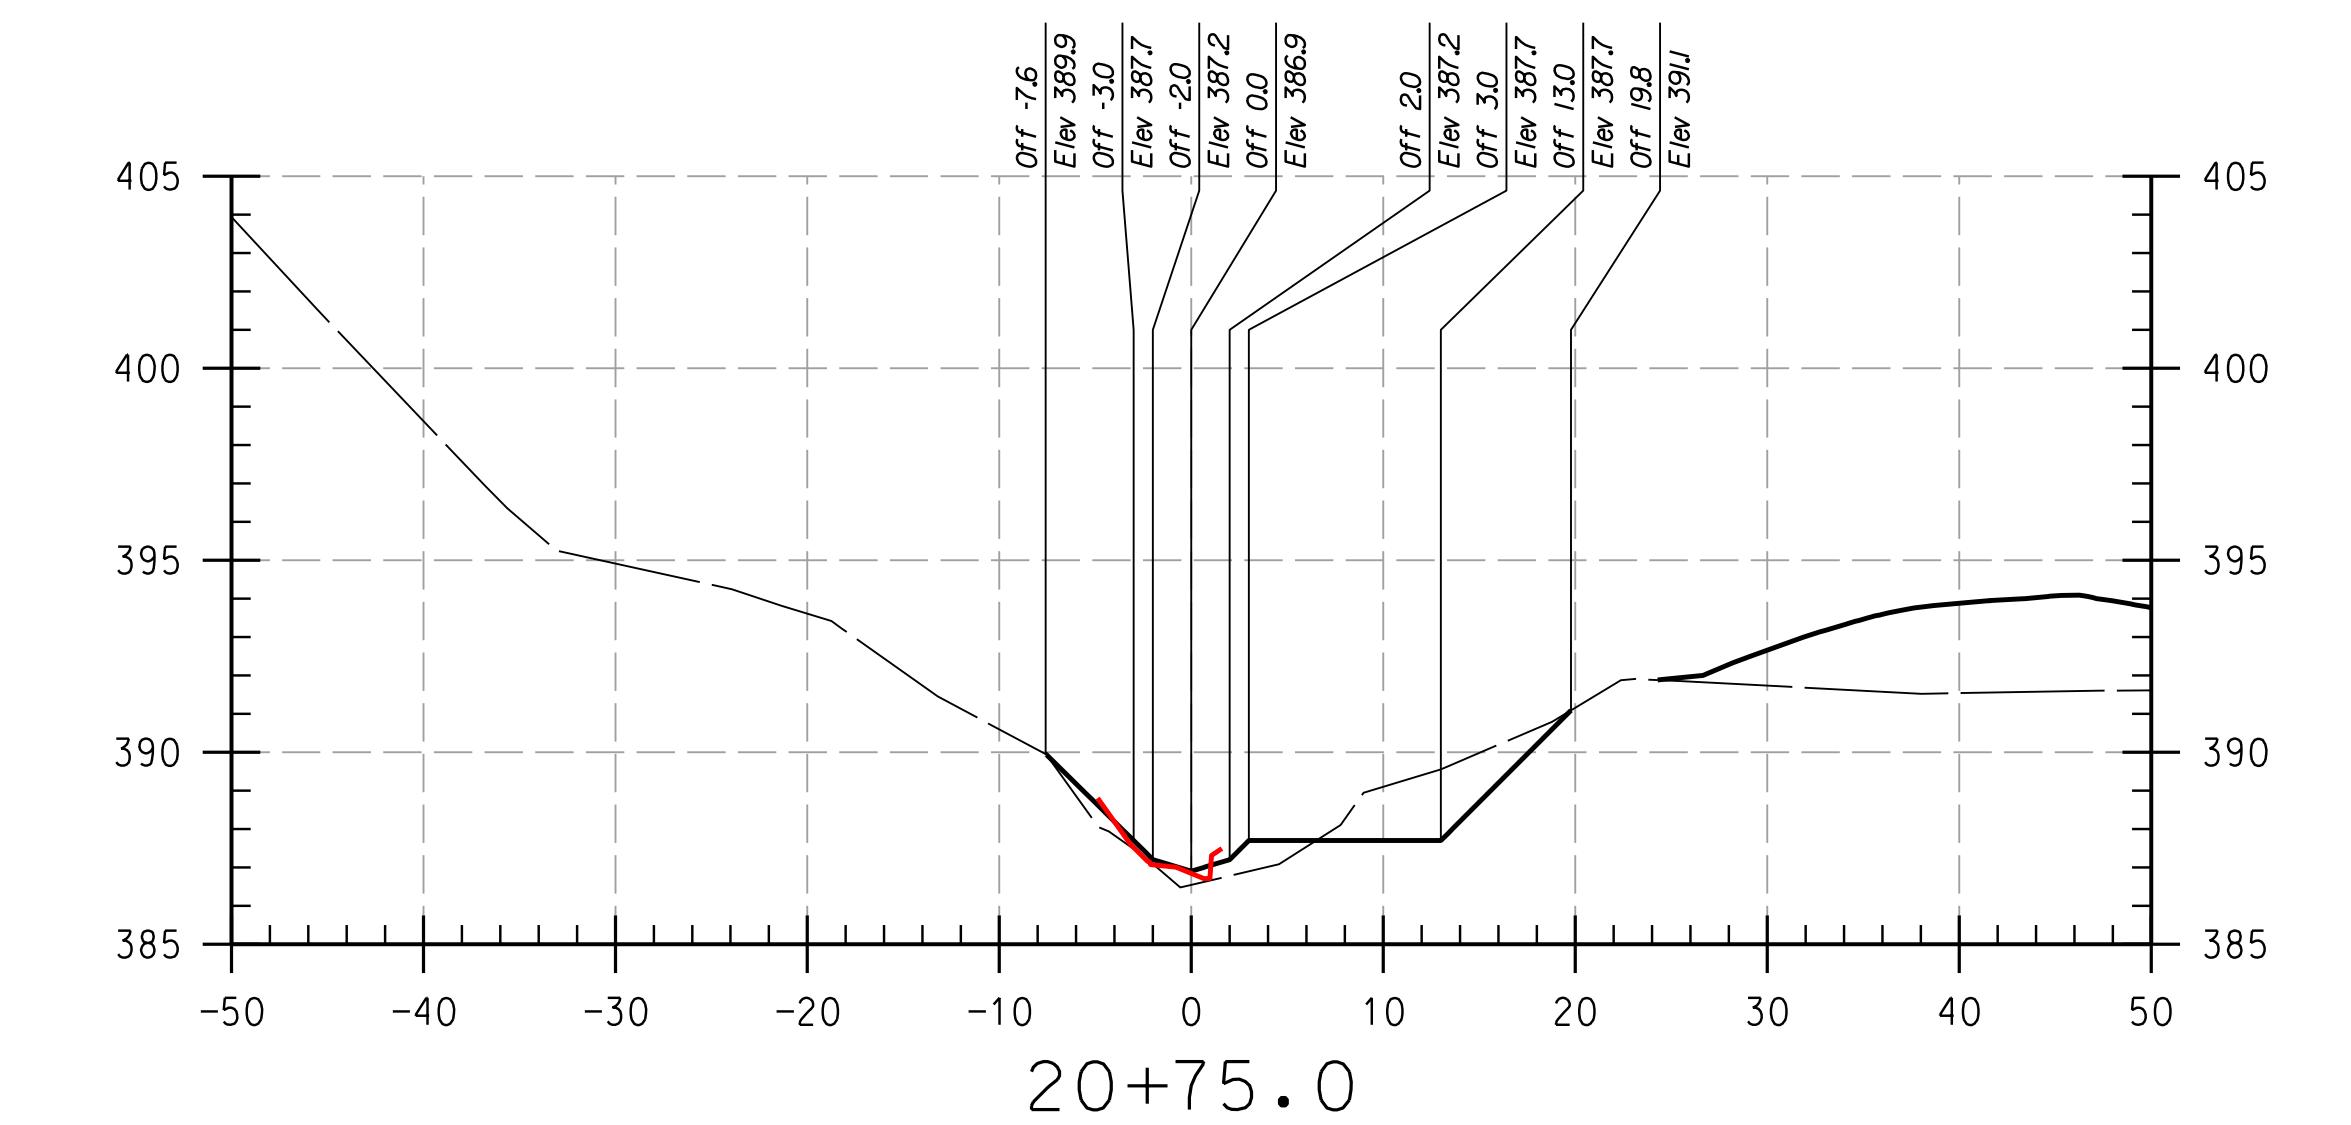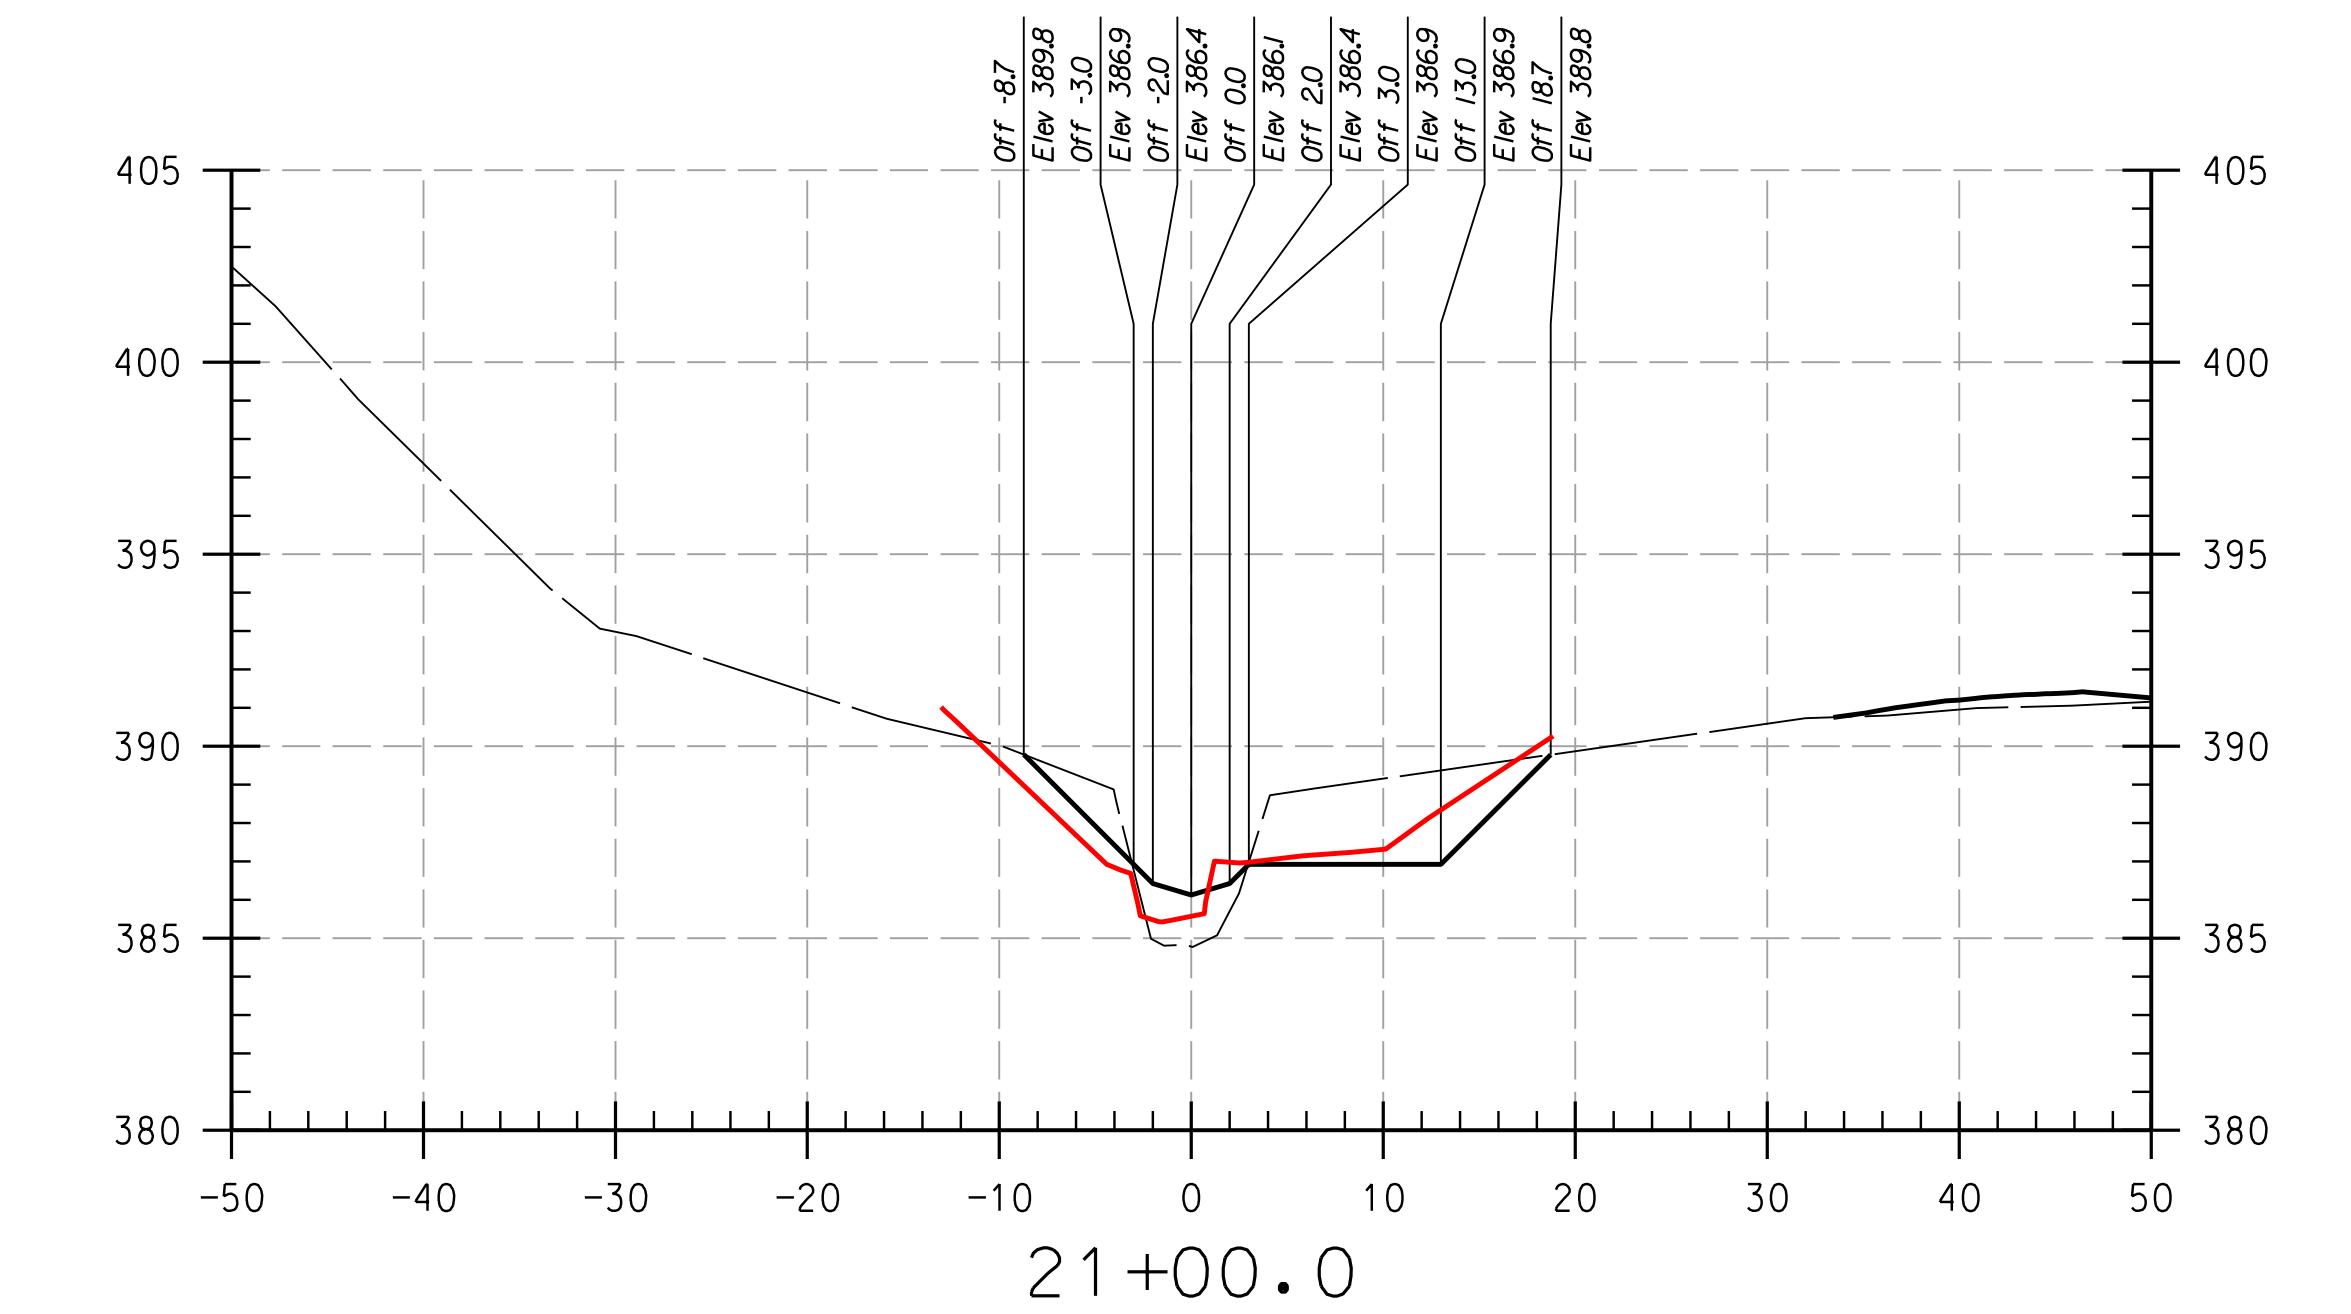

REACH 3

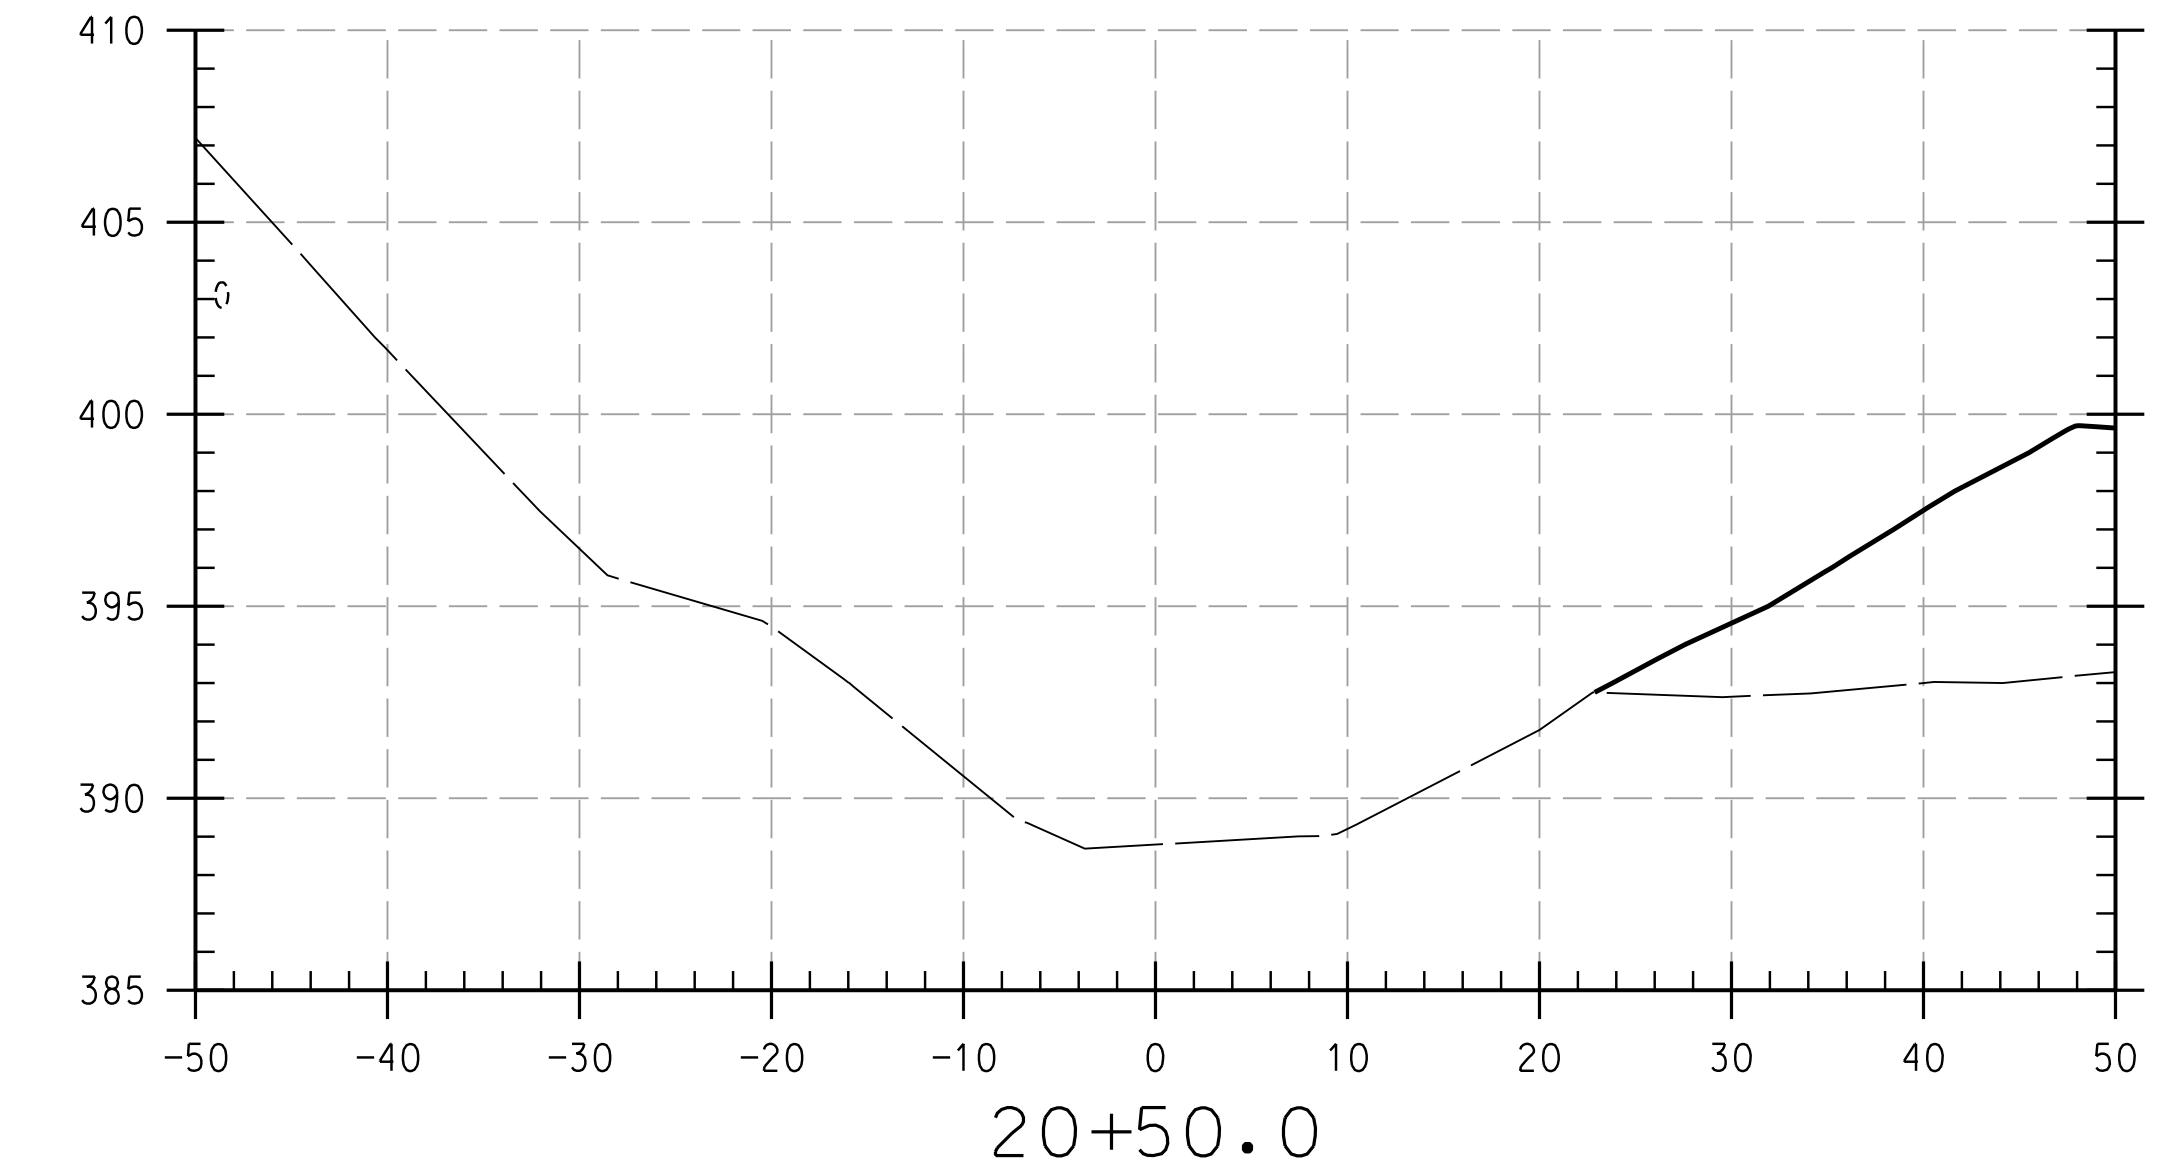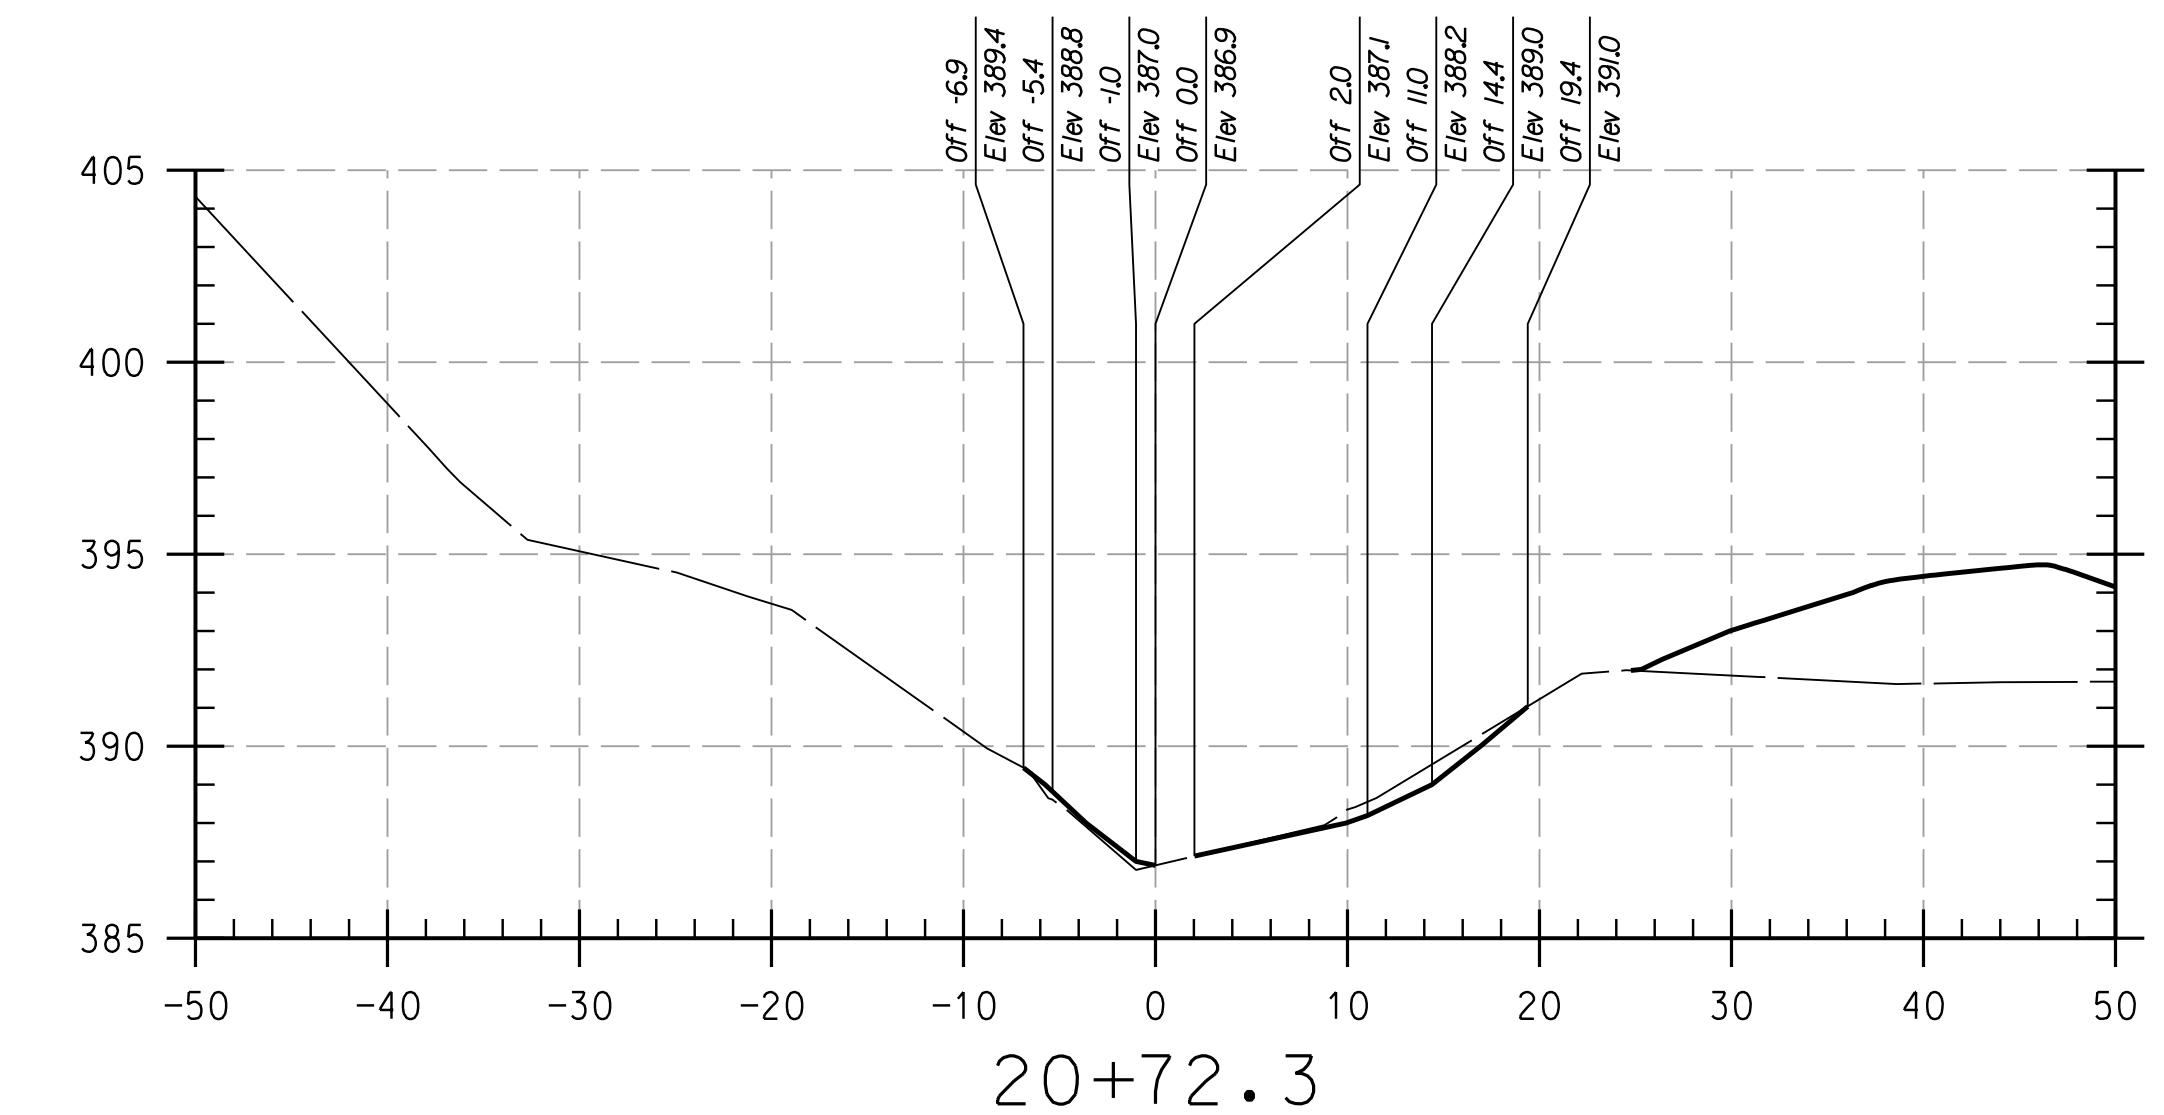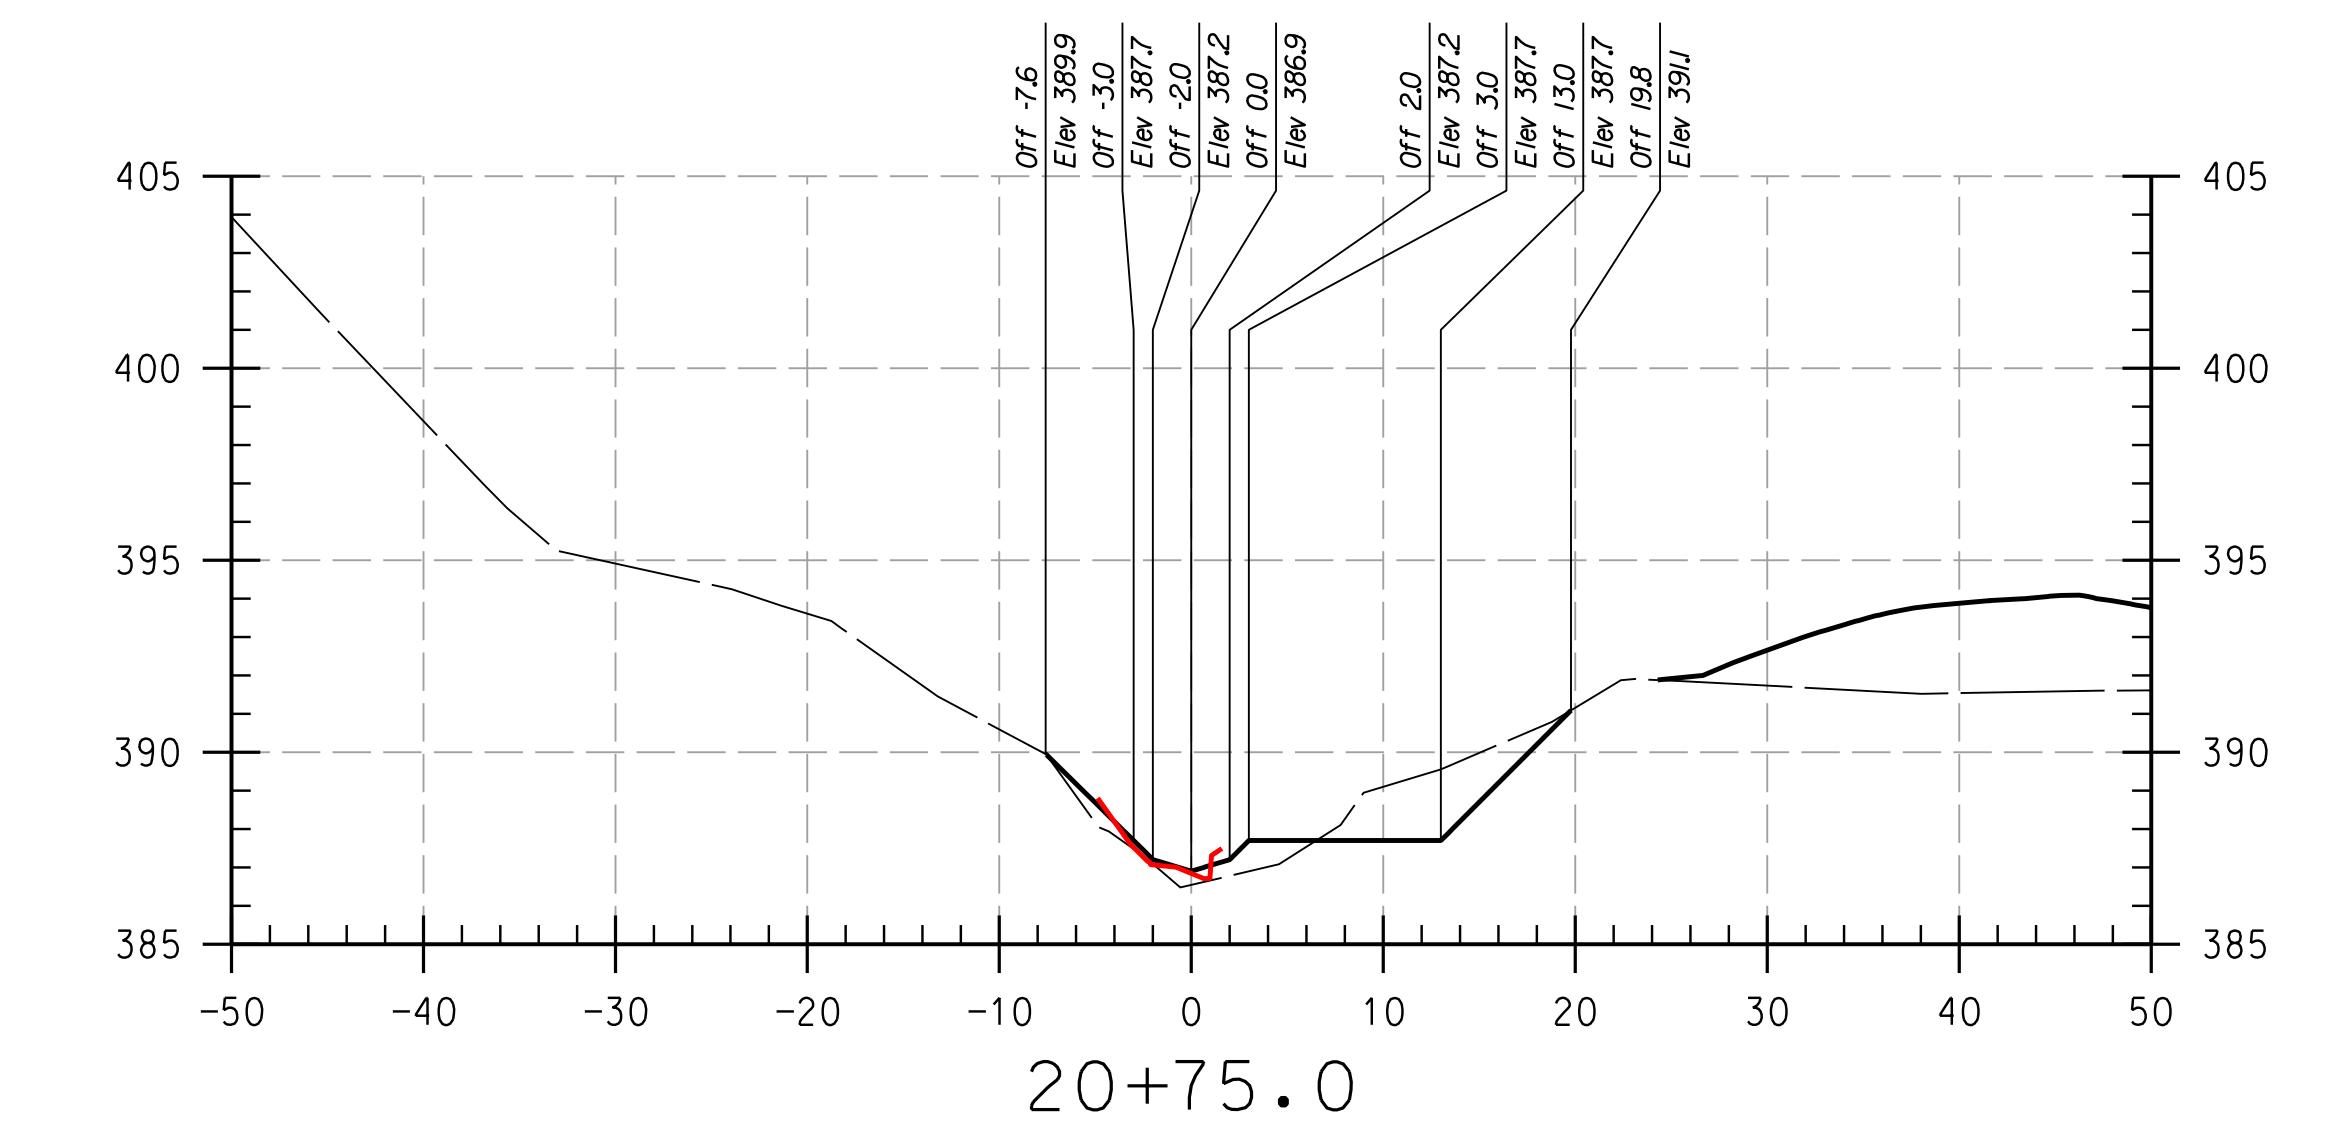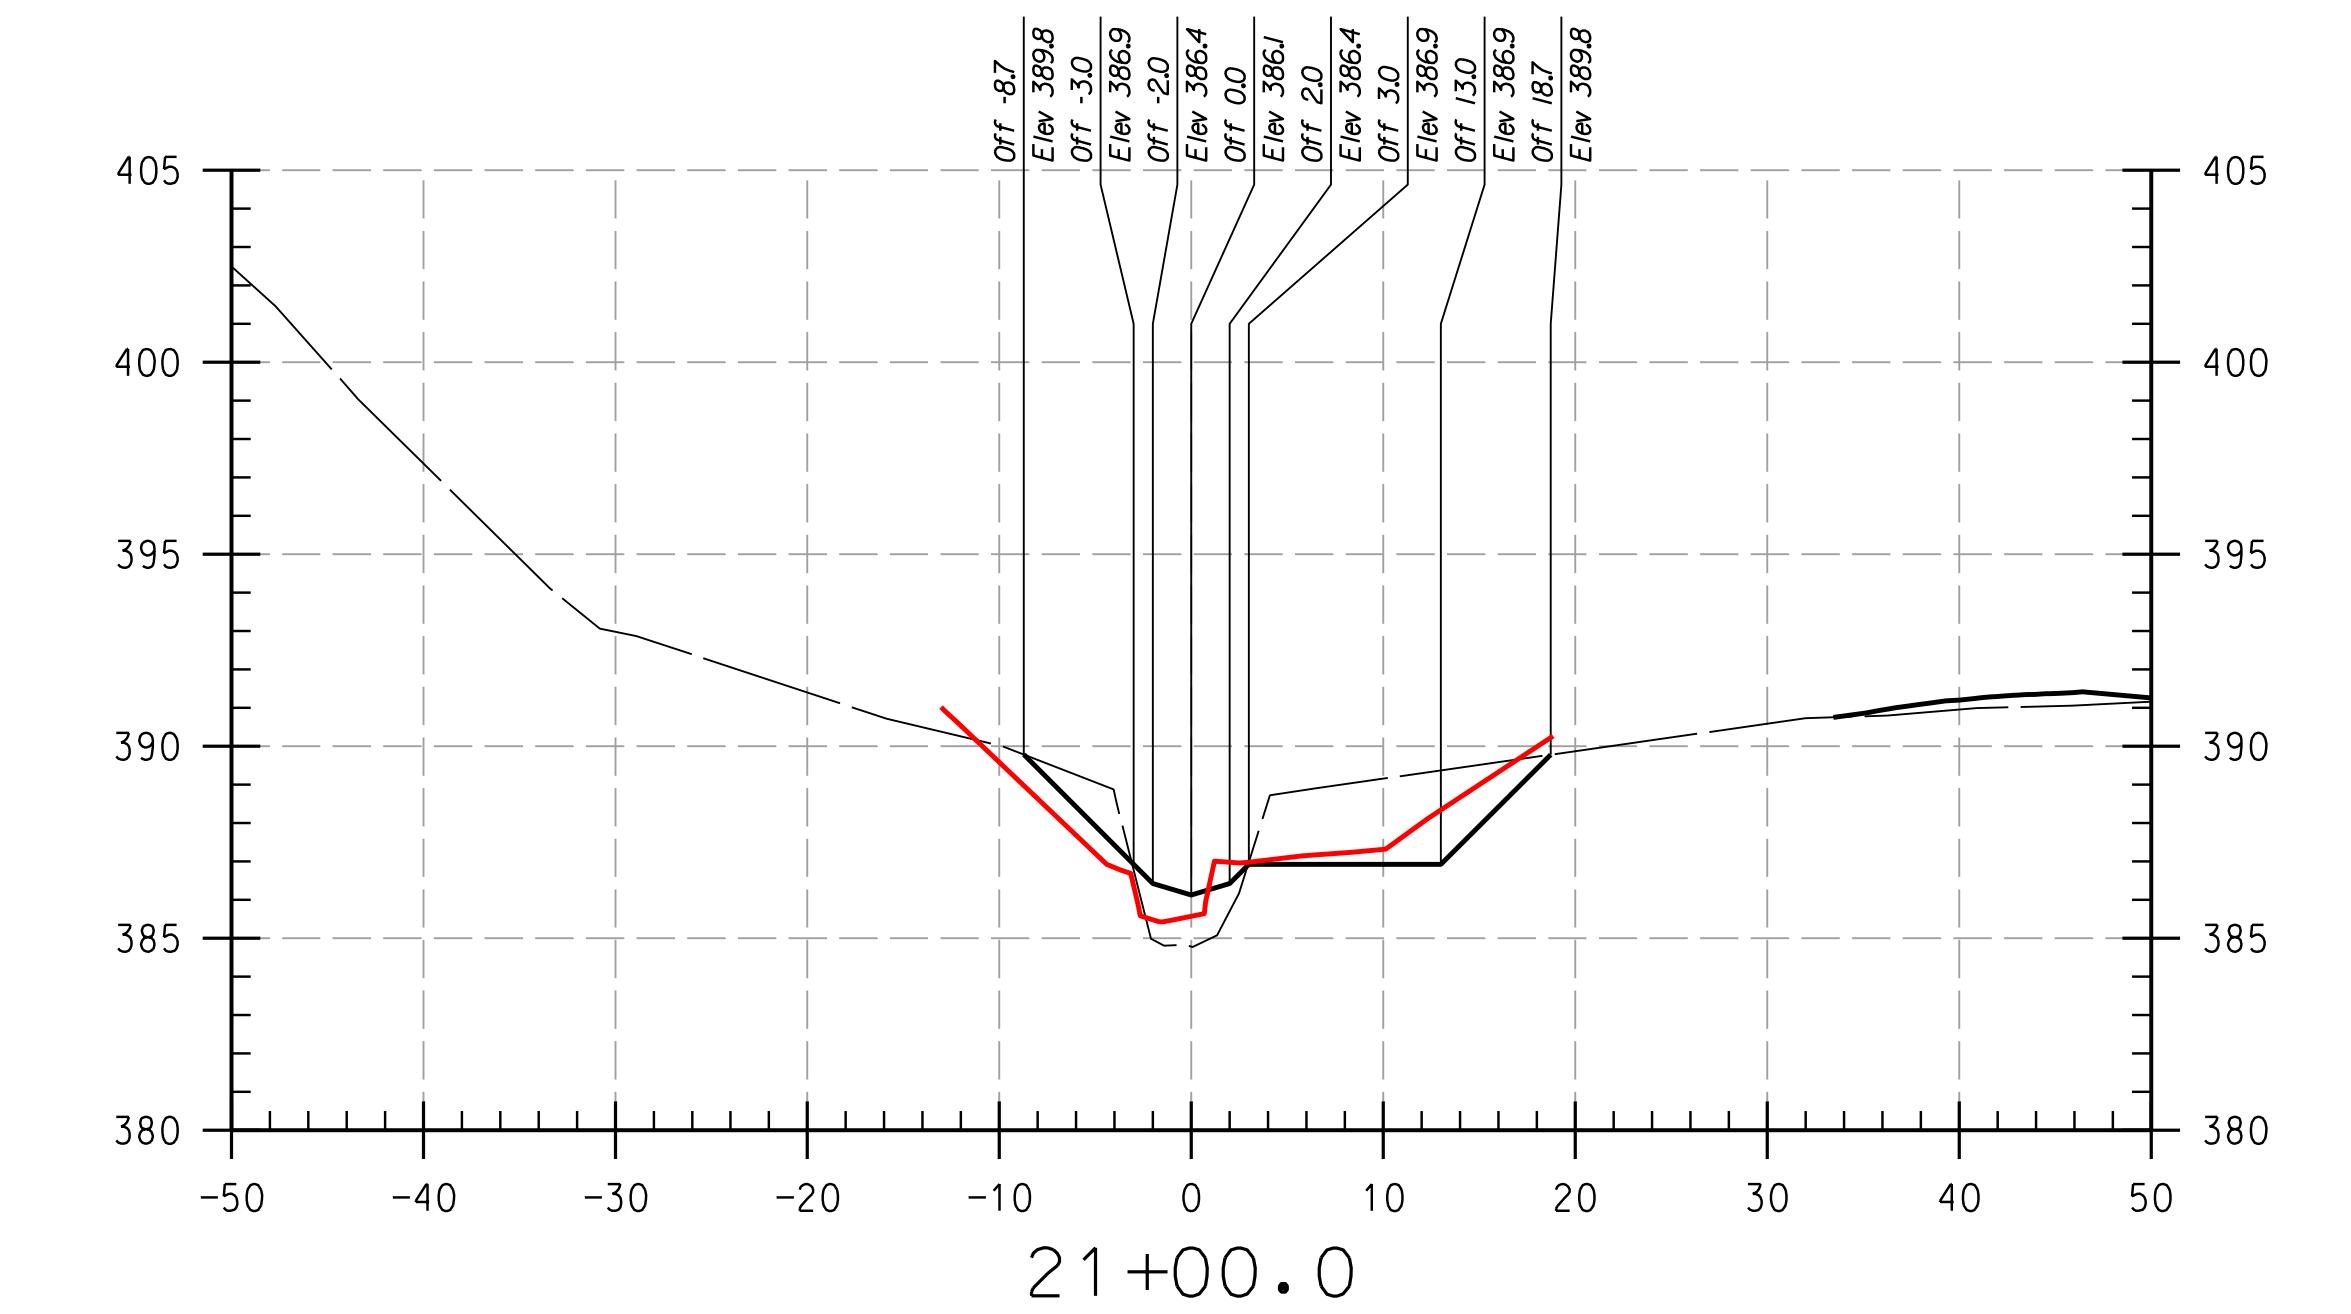

LEGEND
EXISTING GRADE _____
PROPOSED GRADE _____
AS-BUILT GRADE —

NOTES:
UTILITIES SHOWN ON THESE PLANS HAVE BEEN LOCATED
USING SURVEY AND DRILLING METHODS. THE
CONTRACTOR IS TO EXERCISE EXTREME CAUTION WHEN
EXCAVATING NEAR ANY UTILITIES TEST PIT IF REQUIRED.

PLOTTED 12:28 PM on Monday, April 24, 2017
BY: Dmarr
FILE: C:\CAD_Files\Howard CC\DXS-2001-Howard CC As-Built.dwg

PROFESSIONAL CERTIFICATION, I HEREBY
CERTIFY THAT THESE DOCUMENTS WERE
PLOTTED OR APPROVED BY ME AND THAT
I AM A DULY LICENSED PROFESSIONAL
ENGINEER UNDER THE LAWS OF THE STATE
OF MARYLAND, LICENSE NO. 3831,
EXPIRATION DATE: JANUARY 06, 2018

THIS DEVELOPMENT IS APPROVED FOR SOIL EROSION AND SEDIMENT CONTROL
BY THE HOWARD SOIL CONSERVATION DISTRICT.

HOWARD SCD DATE

DEPARTMENT OF PUBLIC WORKS, HOWARD COUNTY, MD
CHIEF, BUREAU OF ENVIRONMENTAL SERVICES

DATE

PLOTTED 12:28 PM on Monday, April 24, 2017
FILE: C:\CAD\Files\Howard CC\DXS-2001 Howard CC As-Built.dwg

PROFESSIONAL CERTIFICATION, I HEREBY
CERTIFY THAT THESE DOCUMENTS WERE
PLOTTED OR APPROVED BY ME AND THAT
I AM A DULY LICENSED PROFESSIONAL
ENGINEER UNDER THE LAWS OF THE STATE
OF MARYLAND, LICENSE NO. 38311,
EXPIRATION DATE: JANUARY 06, 2018





LEGEND		
EXISTING GRADE	_____	
PROPOSED GRADE	_____	
AS-BUILT GRADE	RED	

NOTES:
UTILITIES SHOWN ON THESE PLANS HAVE BEEN LOCATED
USING SURVEY DATA PROVIDED BY THE CONTRACTOR.
THE CONTRACTOR IS TO EXERCISE EXTREME CAUTION WHEN
EXCAVATING NEAR ANY UTILITIES TEST PIT IF REQUIRED.

THIS DEVELOPMENT IS APPROVED FOR SOIL EROSION AND SEDIMENT CONTROL
BY THE HOWARD SOIL CONSERVATION DISTRICT.

HOWARD SCD DATE

DEPARTMENT OF PUBLIC WORKS, HOWARD COUNTY, MD
CHIEF, BUREAU OF ENVIRONMENTAL SERVICES DATE

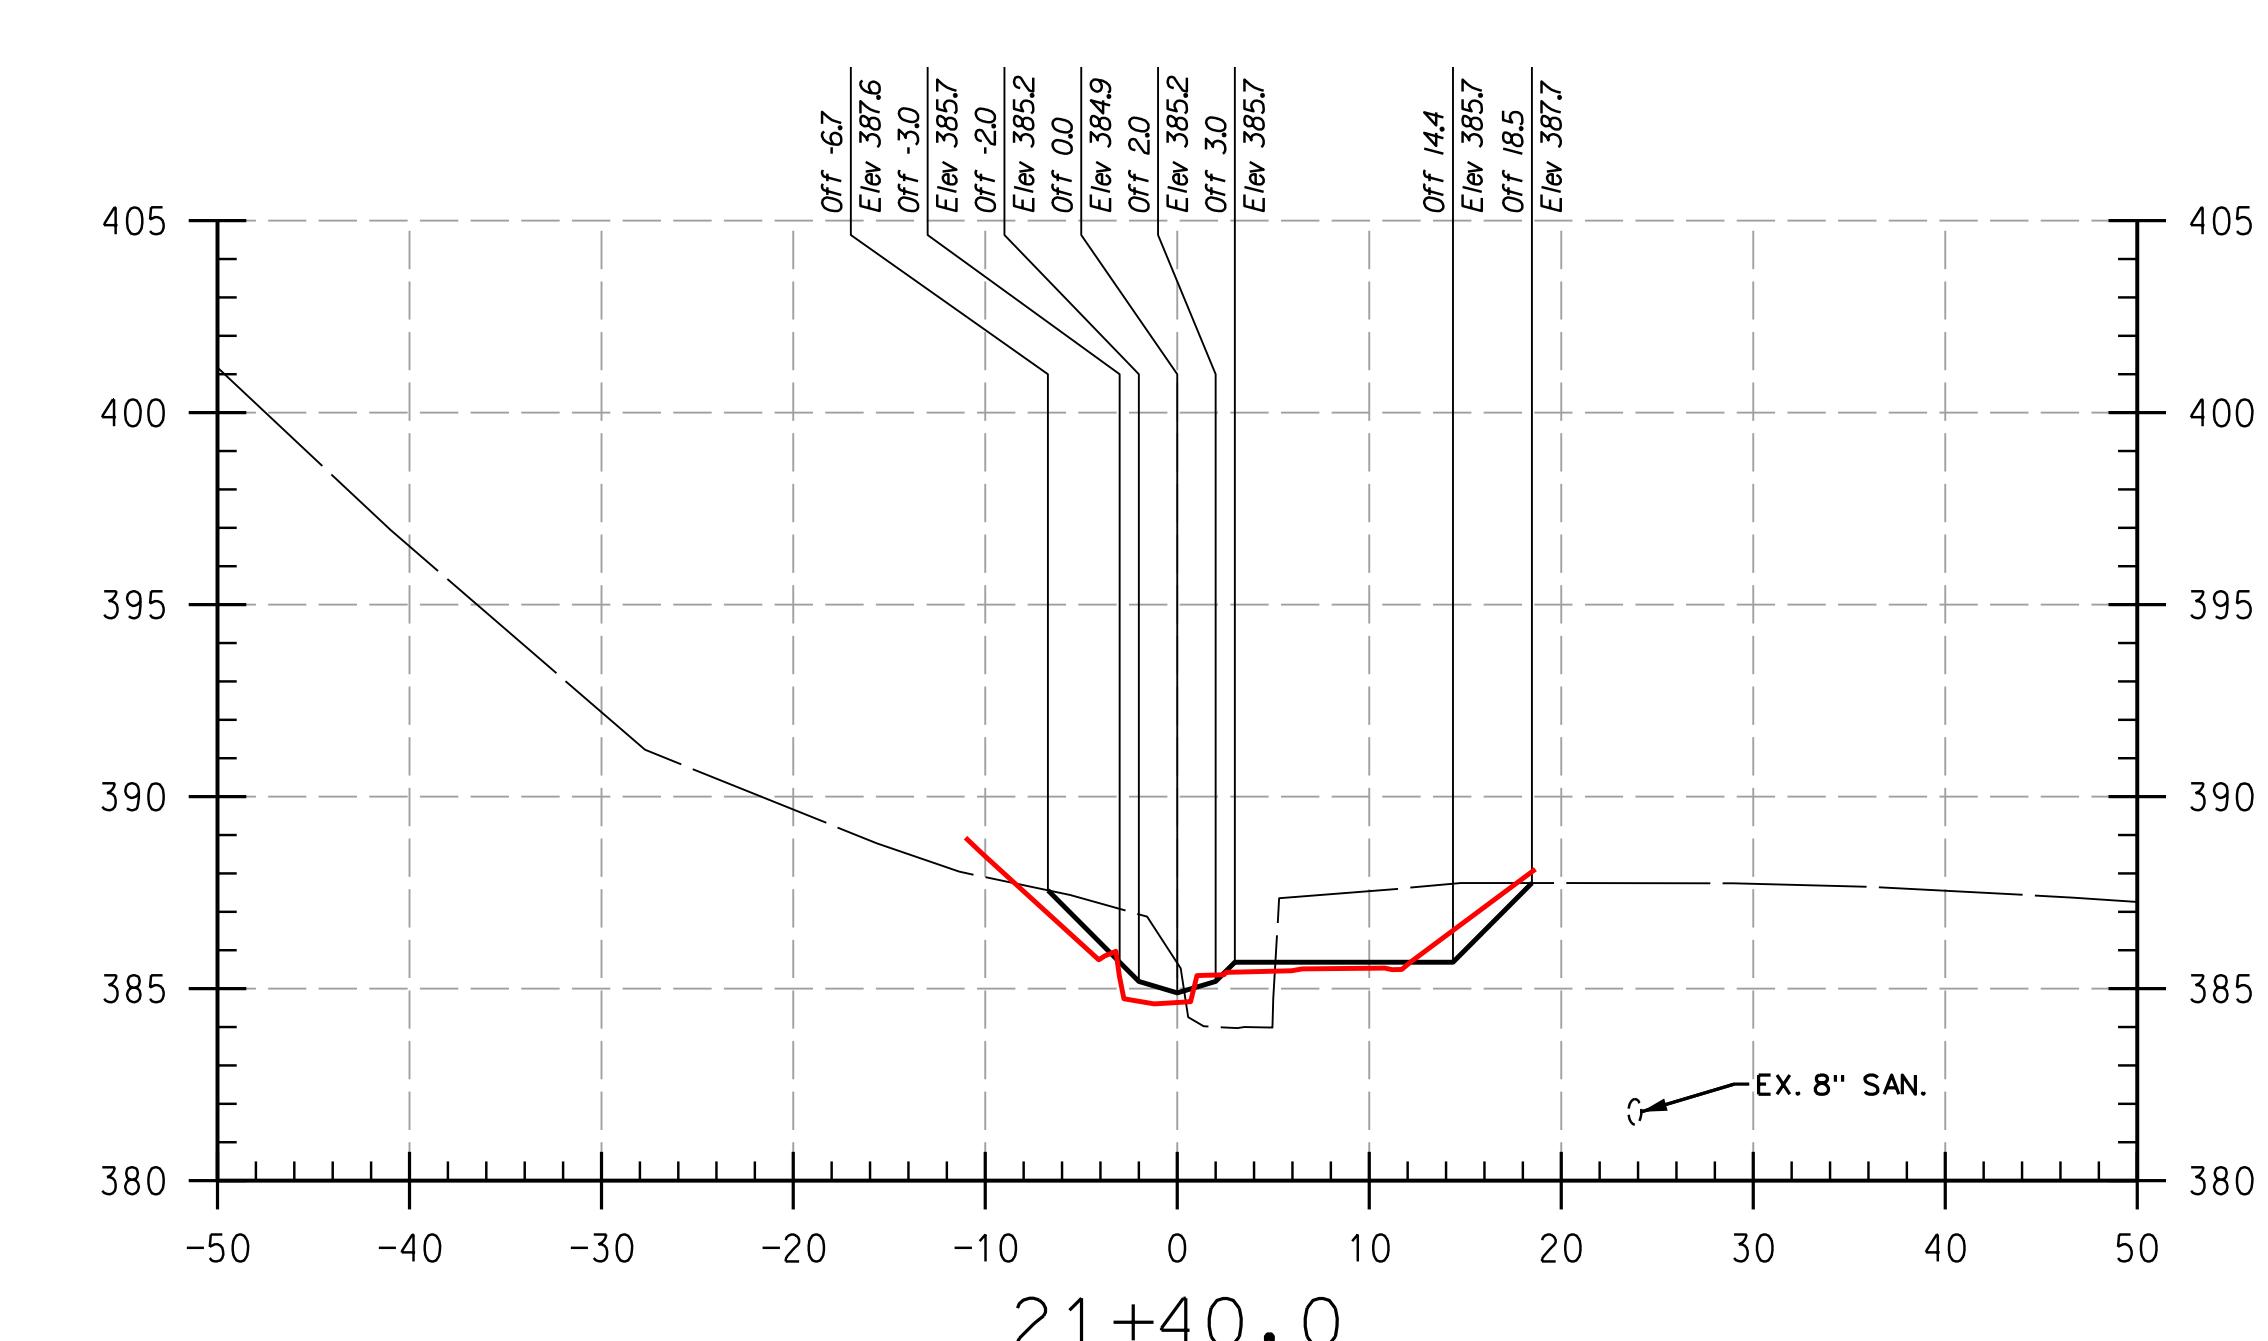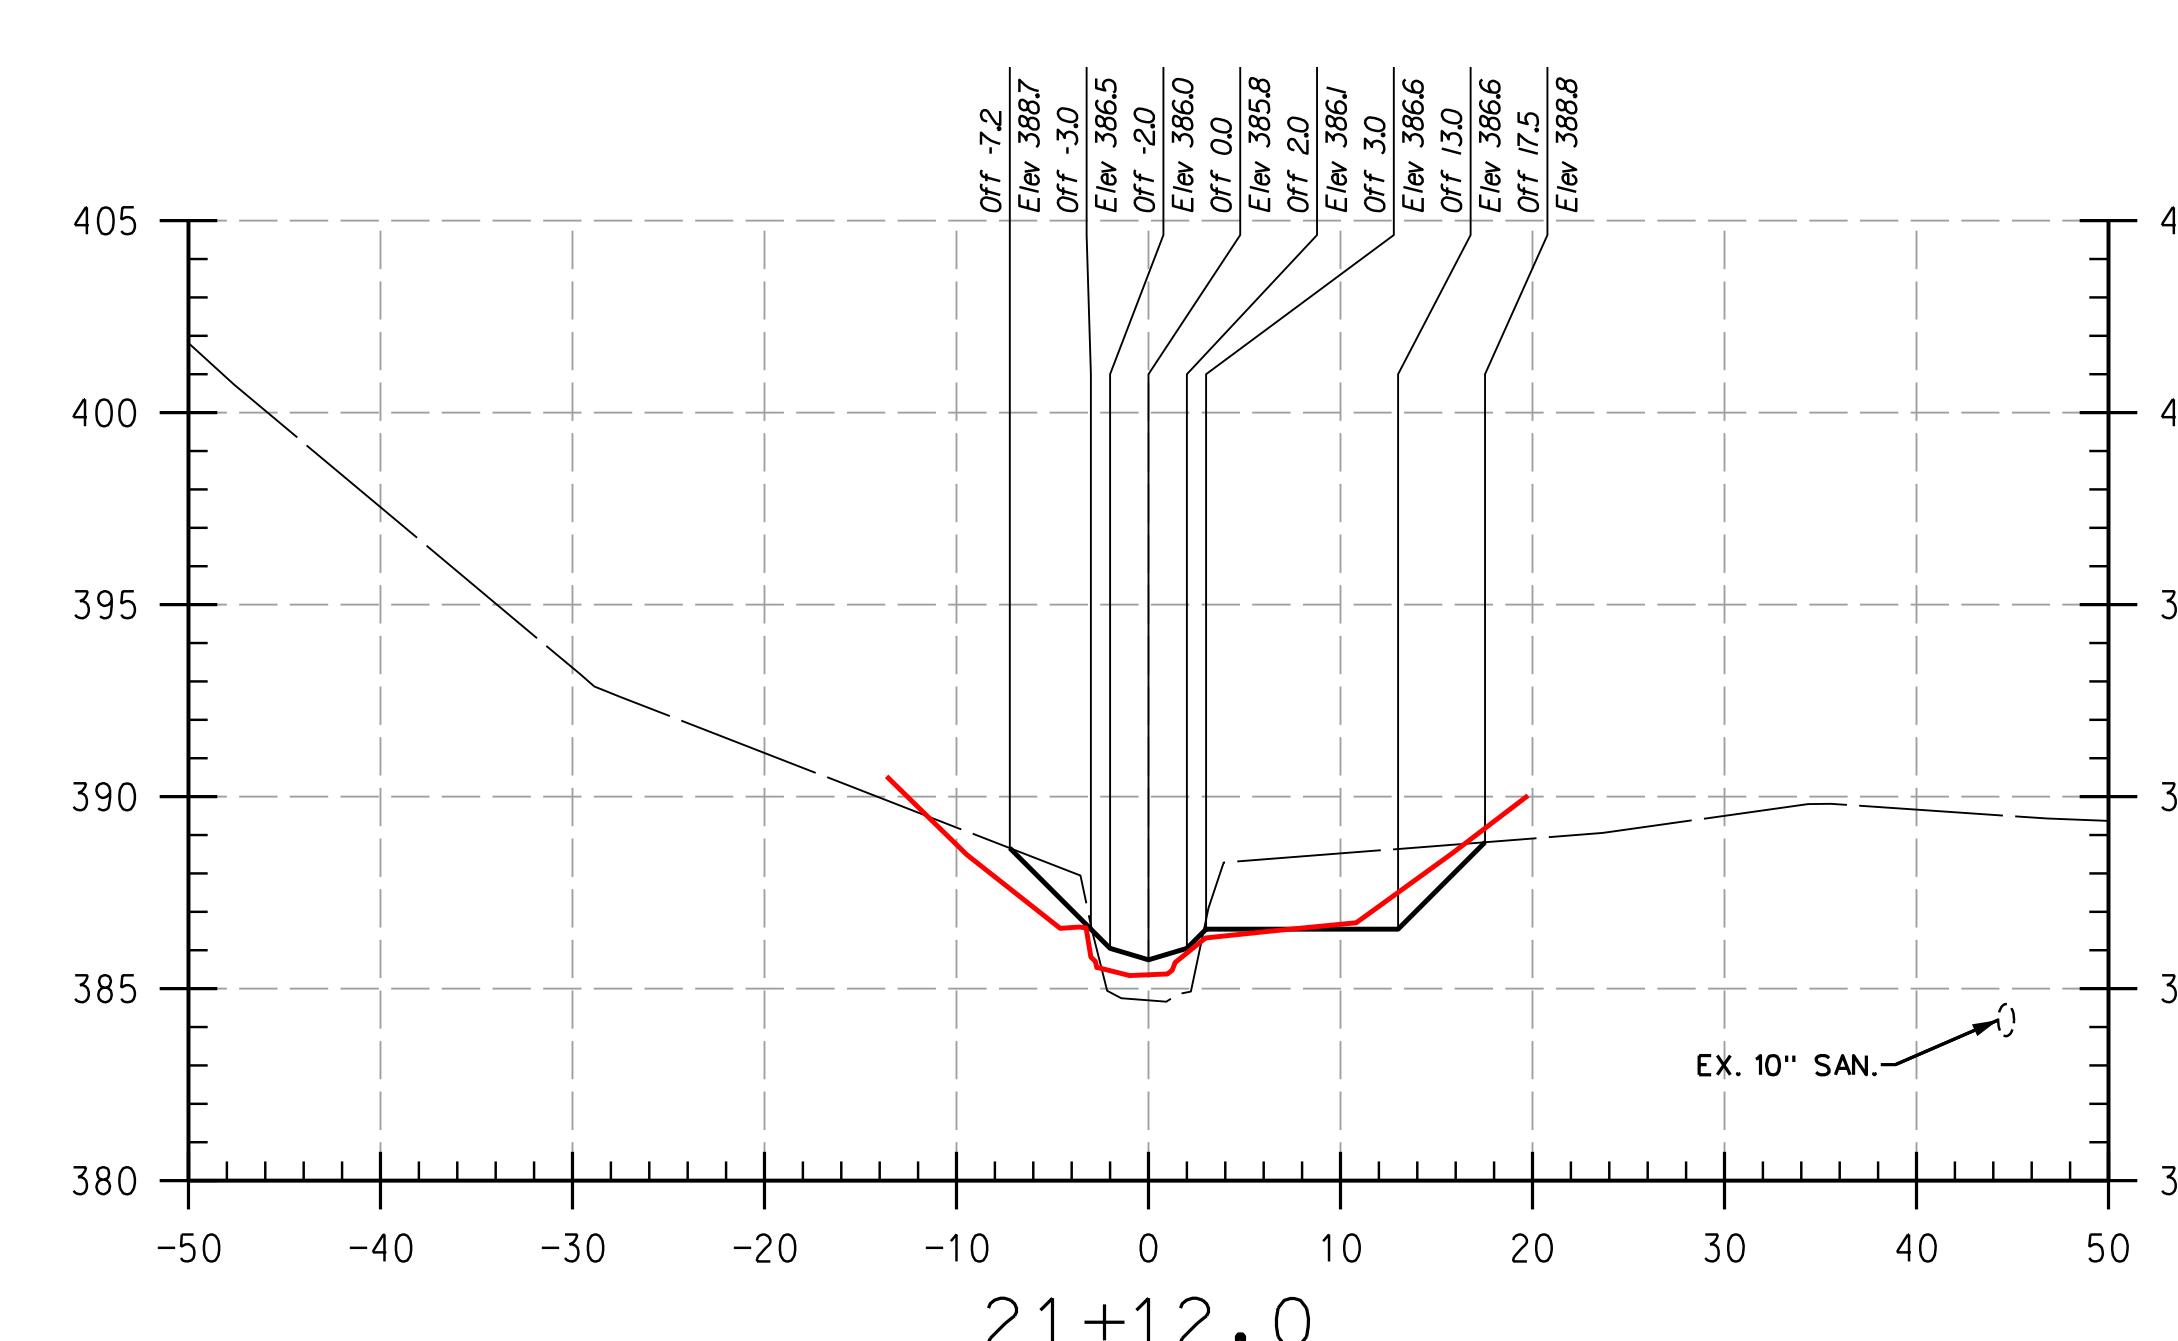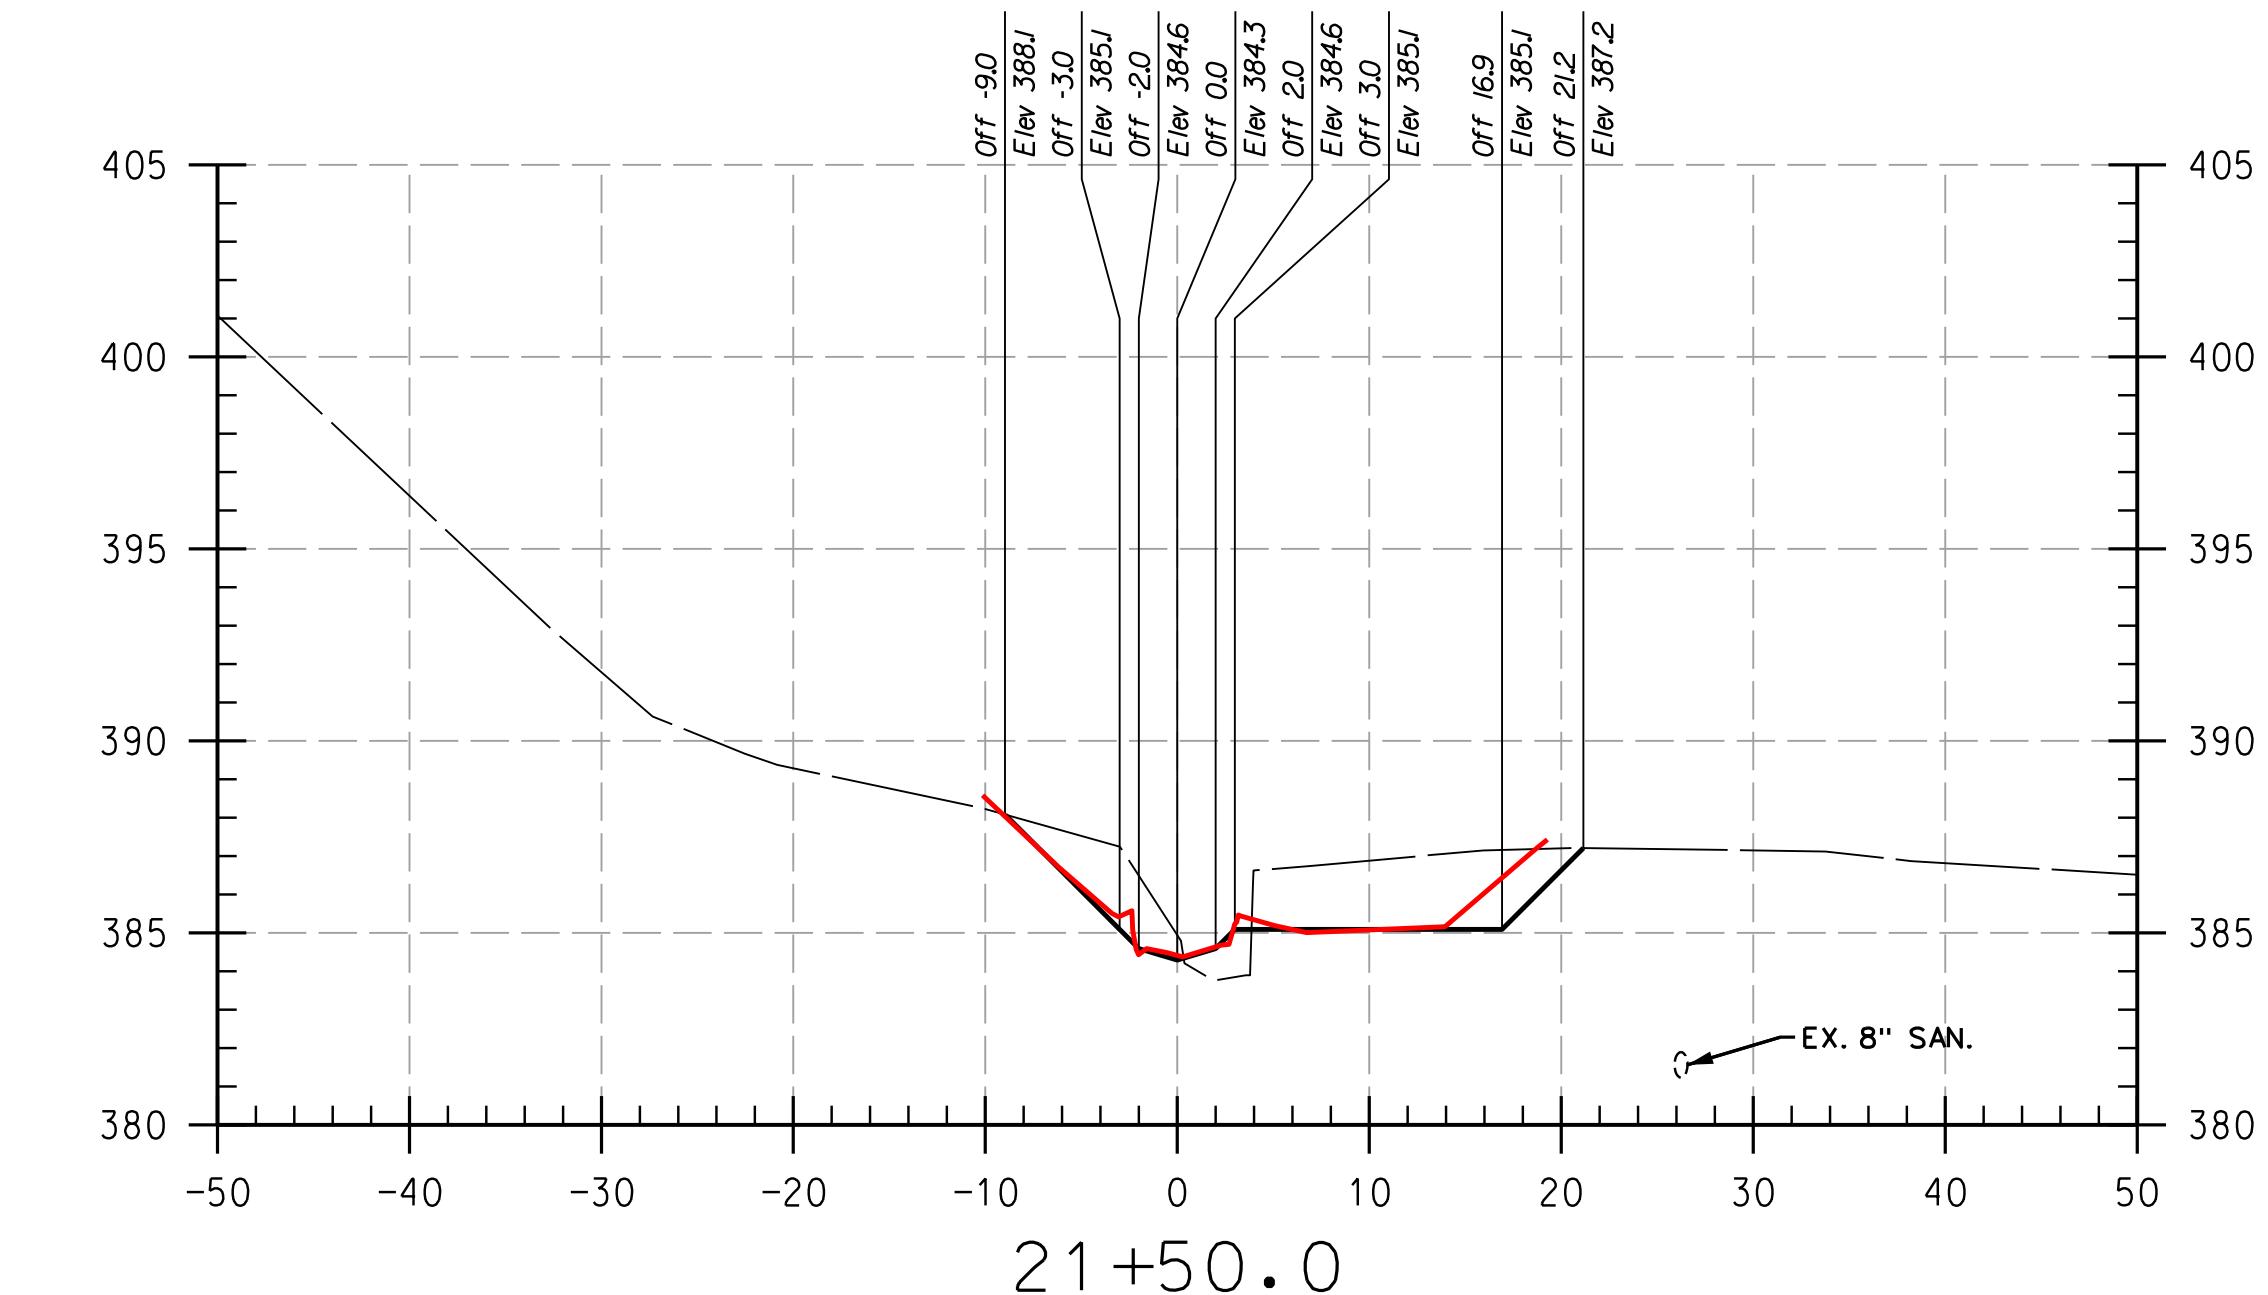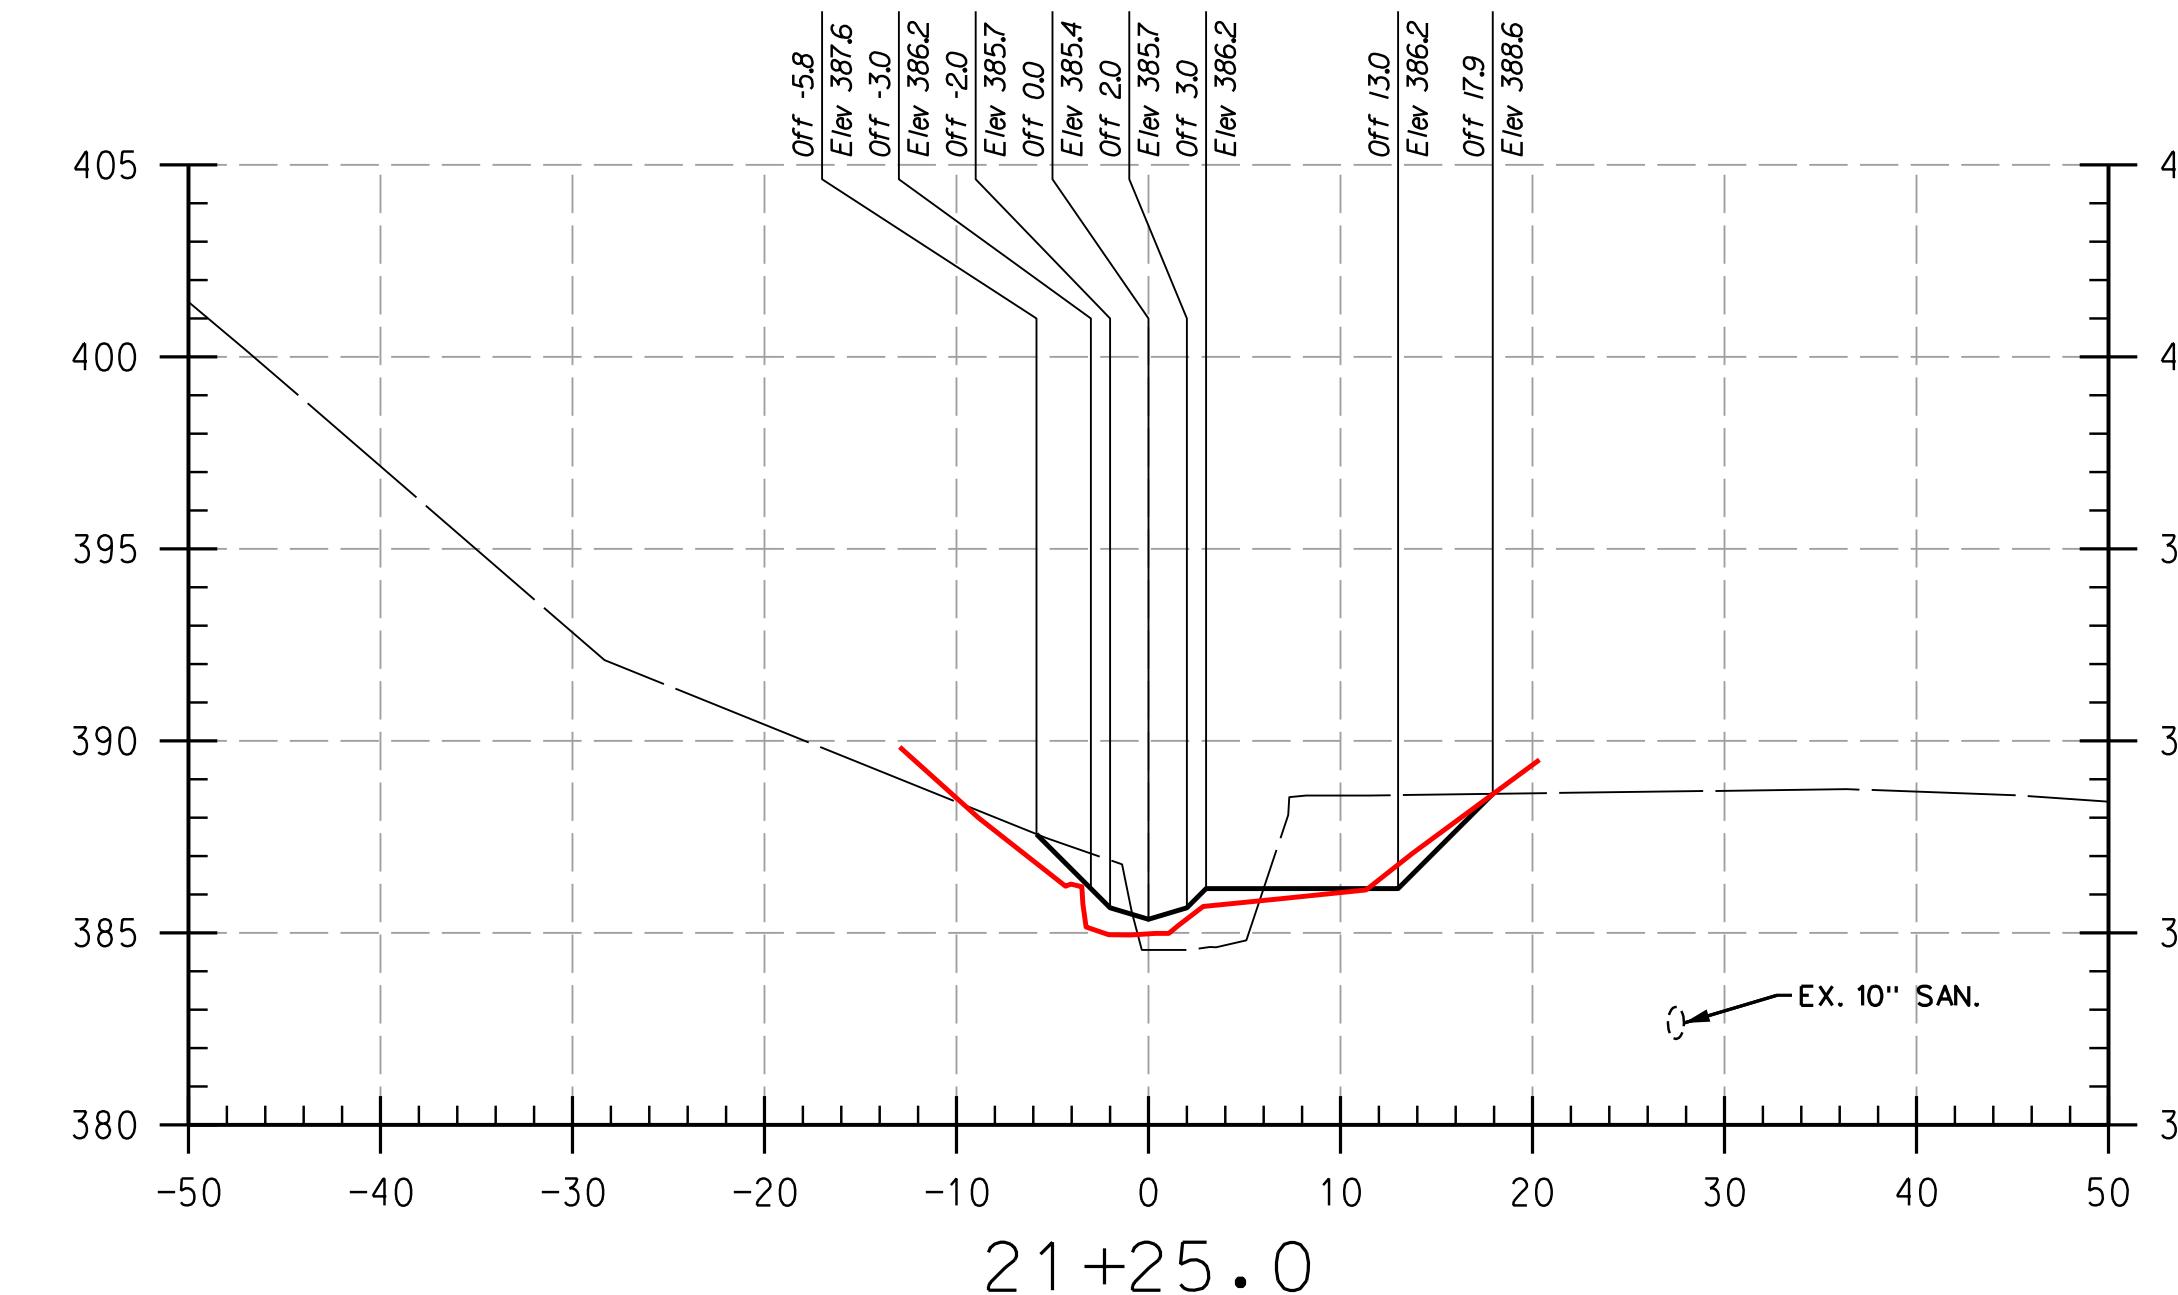

REACH 3

HOWARD COMMUNITY COLLEGE
STREAM RESTORATION PROJECT
CAPITAL PROJECT D-1158
HOWARD COUNTY DEPARTMENT OF PUBLIC WORKS
STORMWATER MANAGEMENT DIVISION
6751 COLUMBIA GATEWAY DRIVE
COLUMBIA, MD 21046
PARCELS 47, 81, TAX MAP 35, 36
ZONING: POR, NT, ELECTION DISTRICT 06
GRID BLOCK 0006


AS-BUILT CROSS SECTIONS

SCALE: HOR: 1" = 10'
VERT: 1" = 5'
DATE: APRIL 2017
KCI JOB NO.: 17133314.83
CAPITAL PROJECT NO.: D-1158
PERMIT ISSUE:
CONSTRUCTION ISSUE:


CS-22

SHEET NO.: 22 OF 27


936 RIDGEBROOK ROAD
SPARKS, MARYLAND 21152
TELEPHONE: (410) 316-7800
FAX: (410) 316-7818
www.kci.com

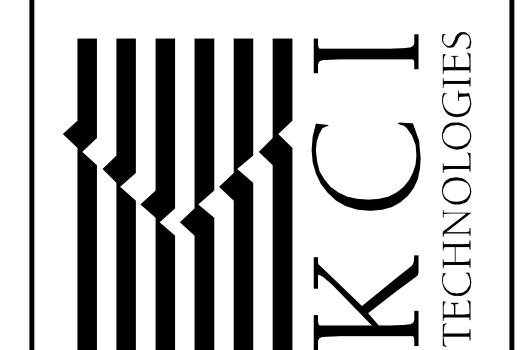

KC FILE: M:\2013\17133314.83\

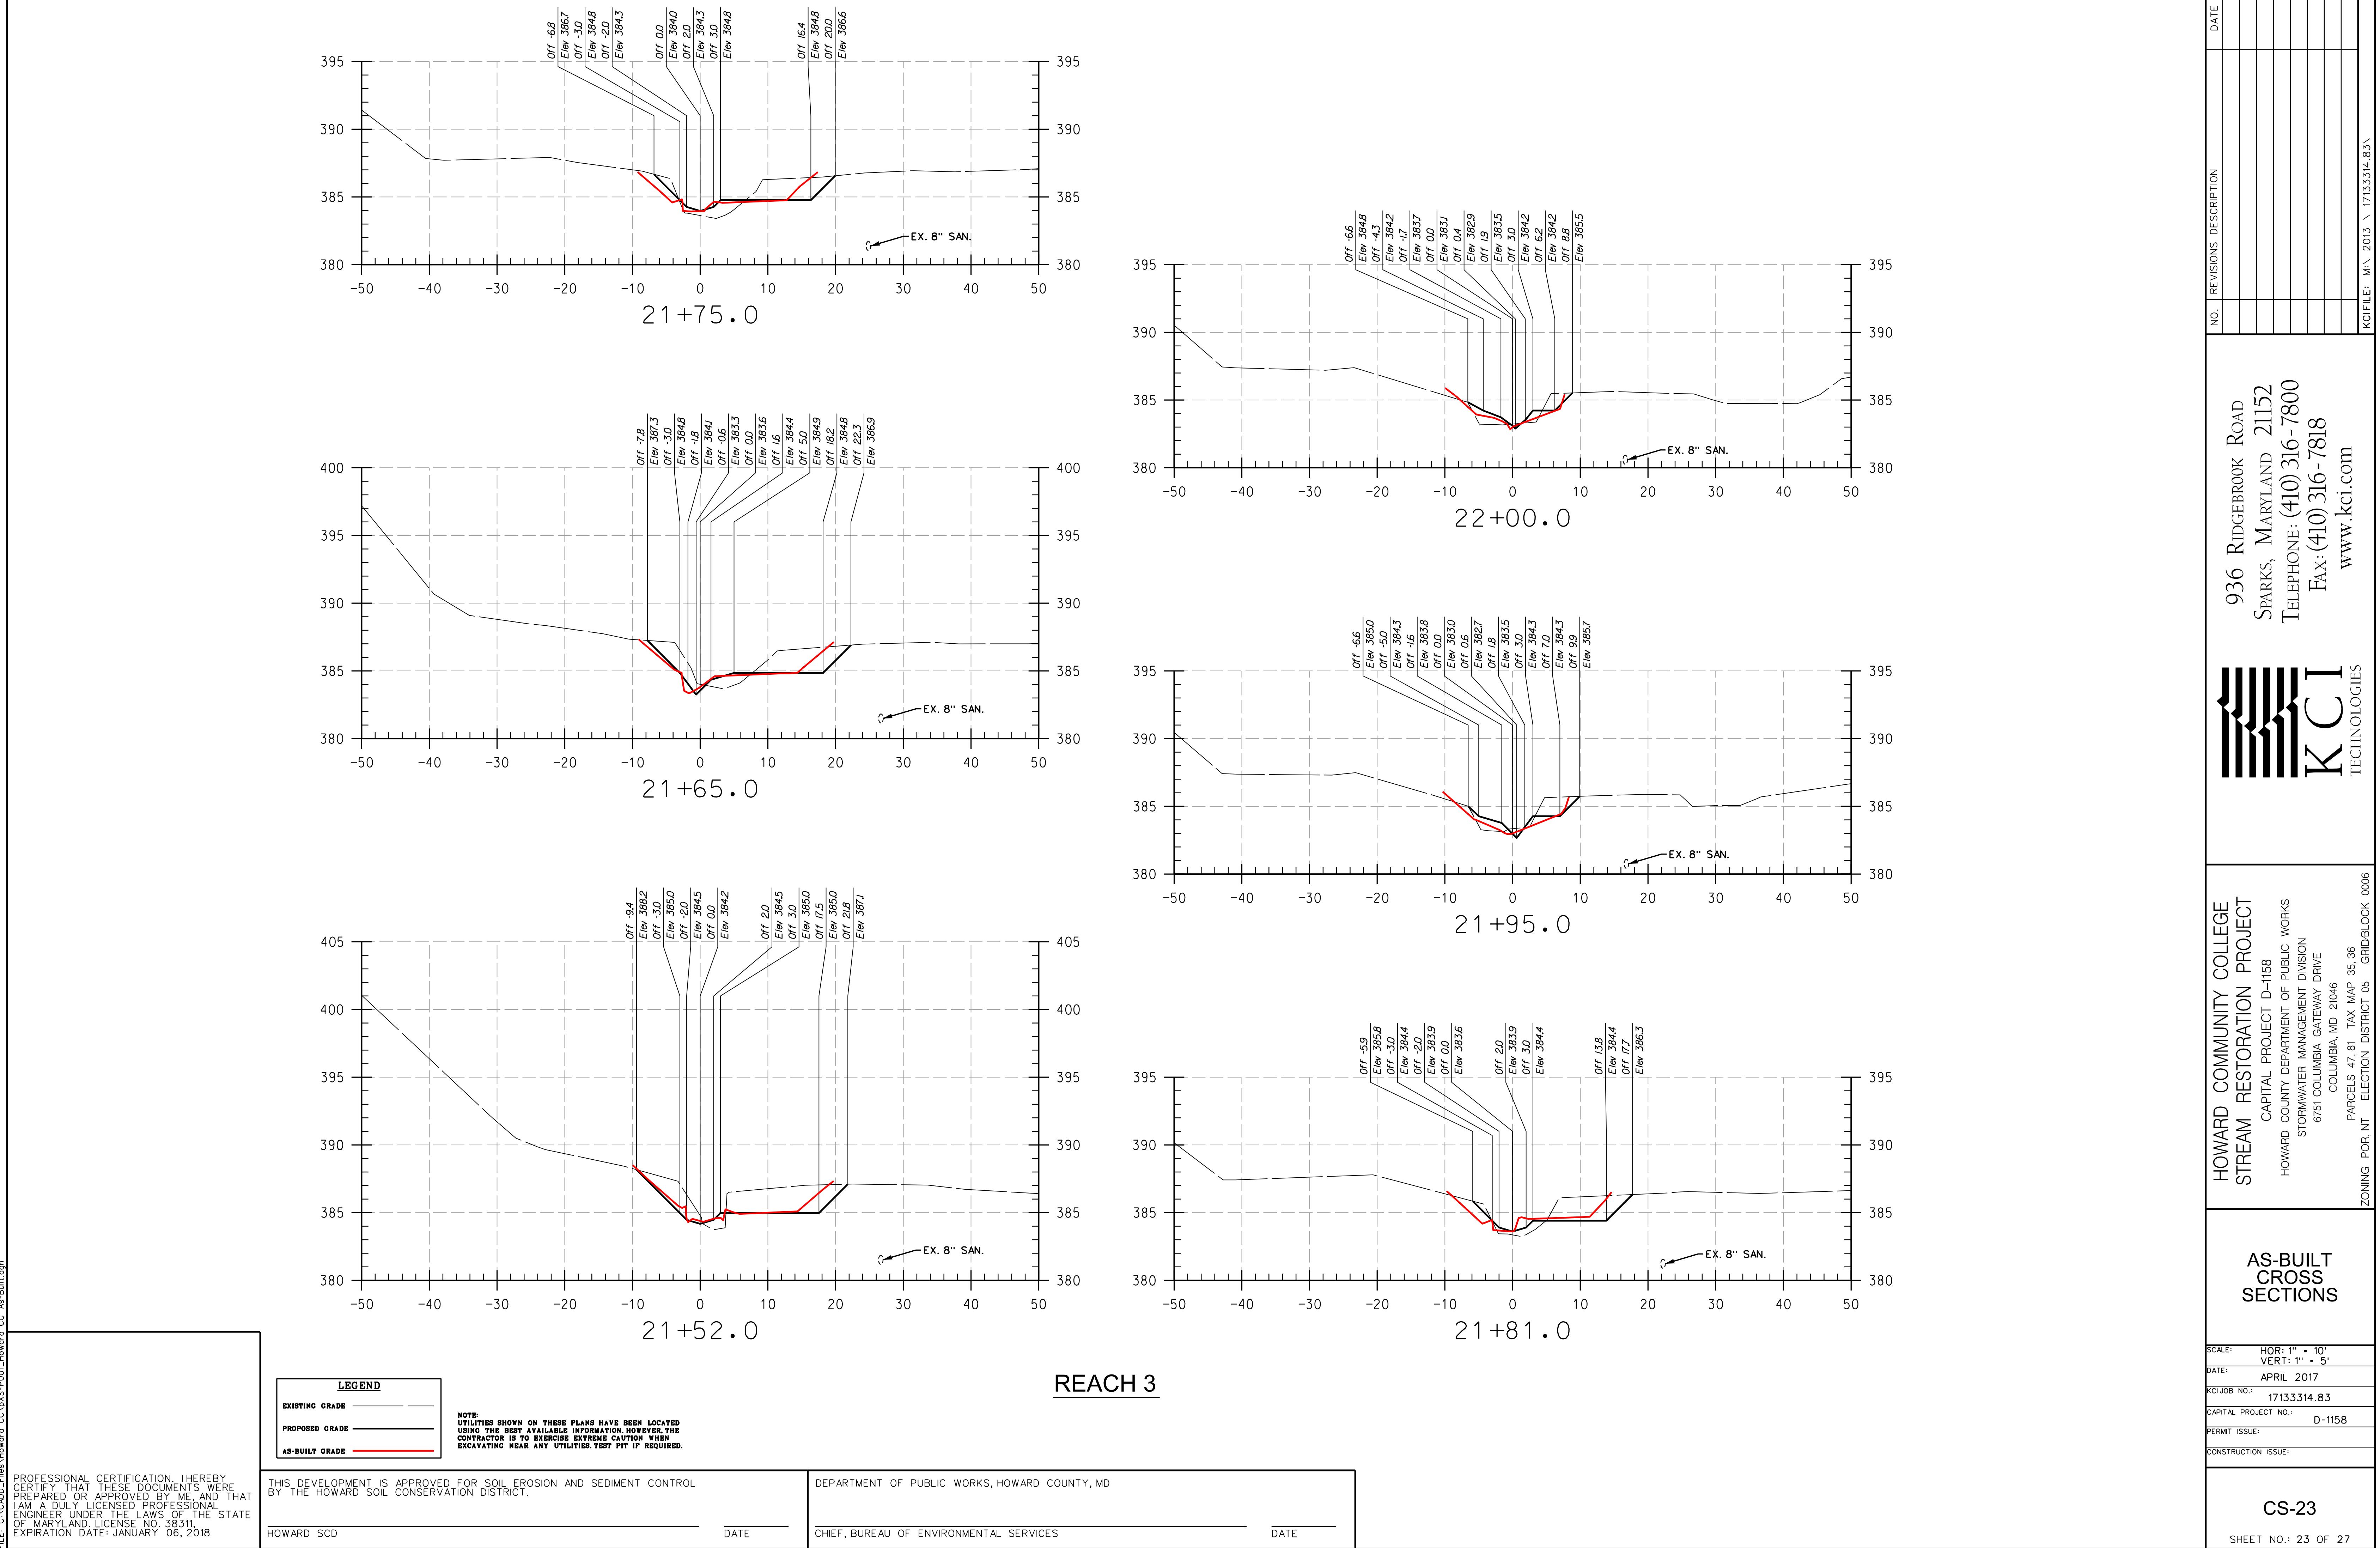

936 RIDGEBROOK ROAD
SPARKS, MARYLAND 21152
TELEPHONE: (410) 316-7800
FAX: (410) 316-7818
www.kci.com

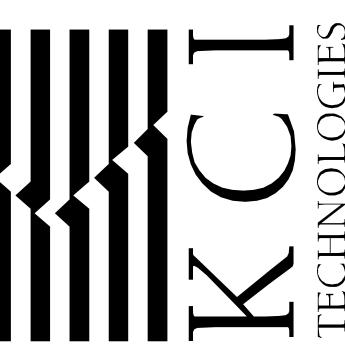KCI
TECHNOLOGIES





HOWARD COMMUNITY COLLEGE
STREAM RESTORATION PROJECT
CAPITAL PROJECT D-1158
HOWARD COUNTY DEPARTMENT OF PUBLIC WORKS
STORMWATER MANAGEMENT DIVISION
6751 COLUMBIA GATEWAY DRIVE
COLUMBIA, MD 21046
PARCELS 47, 81, TAX MAP 35, 36
GRID BLOCK 0006
ZONING POR, NT, ELECTION DISTRICT 06

AS-BUILT CROSS SECTIONS

SCALE: HOR: 1" - 10'
VERT: 1" - 5'
DATE: APRIL 2017
KC JOB NO: 17133314.83
CAPITAL PROJECT NO: D-1158
PERMIT ISSUE:
CONSTRUCTION ISSUE:

CS-24

SHEET NO.: 24 OF 27

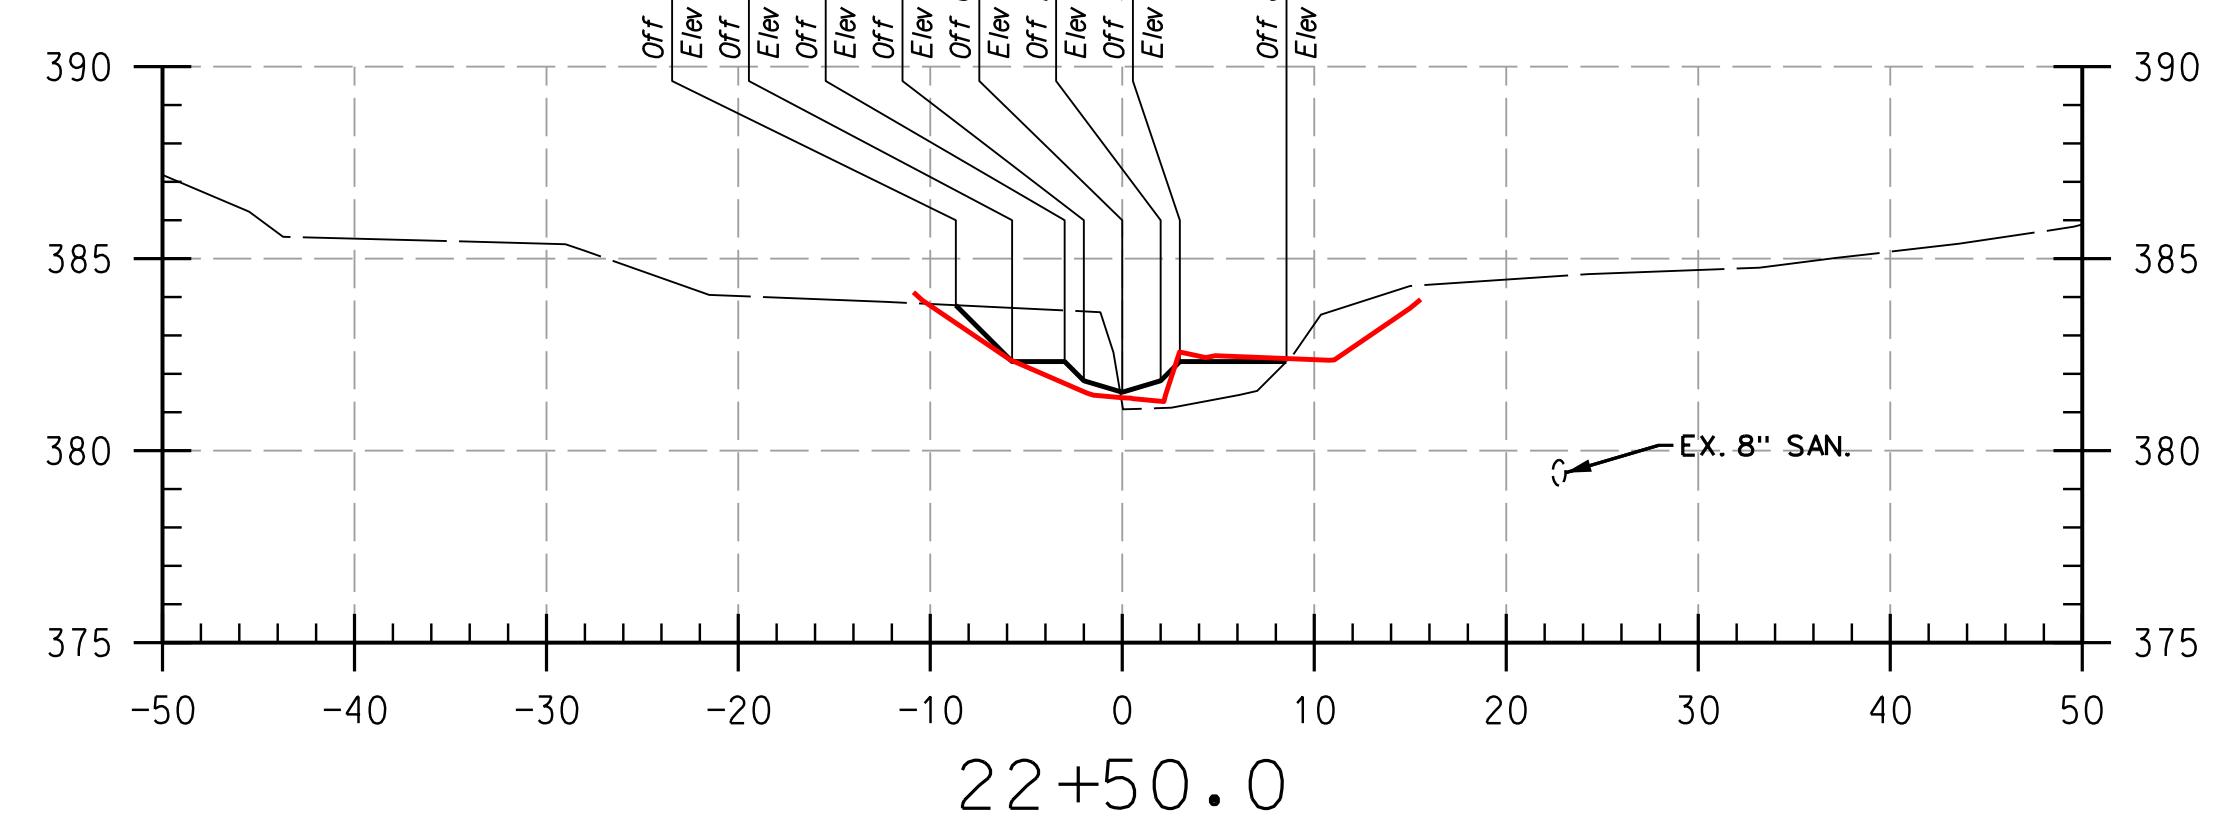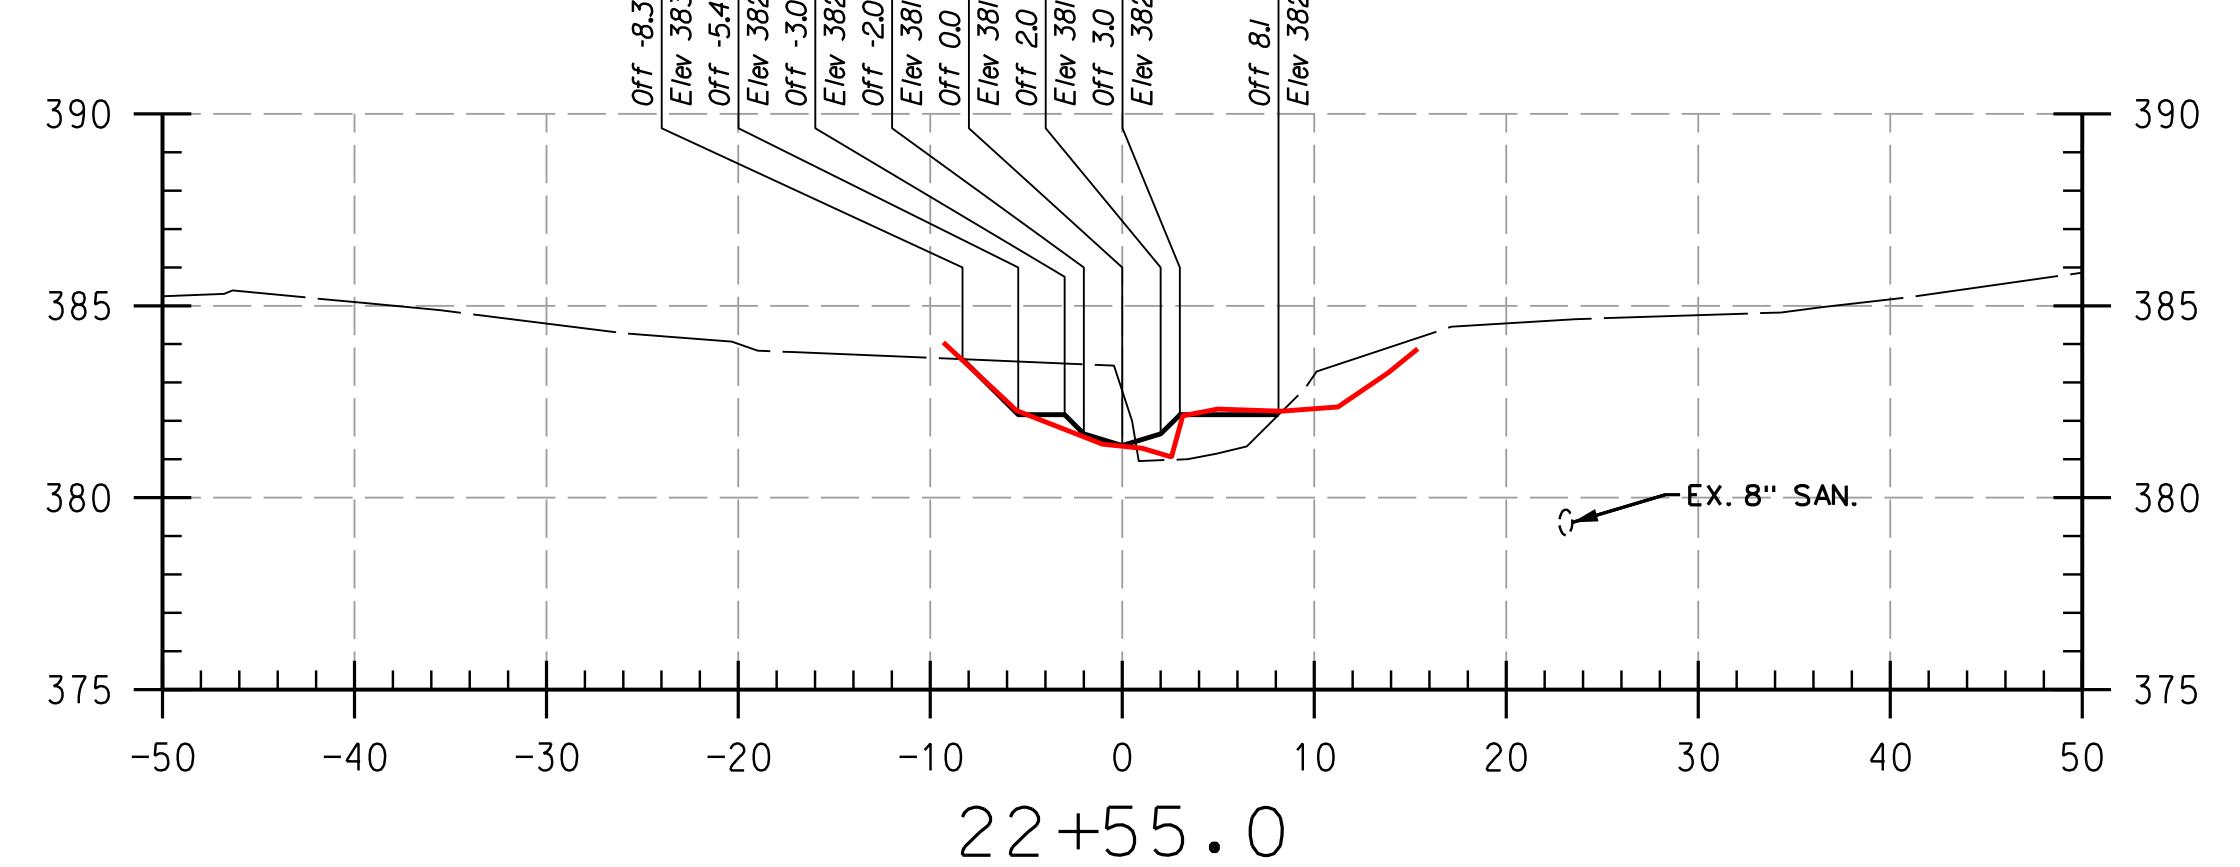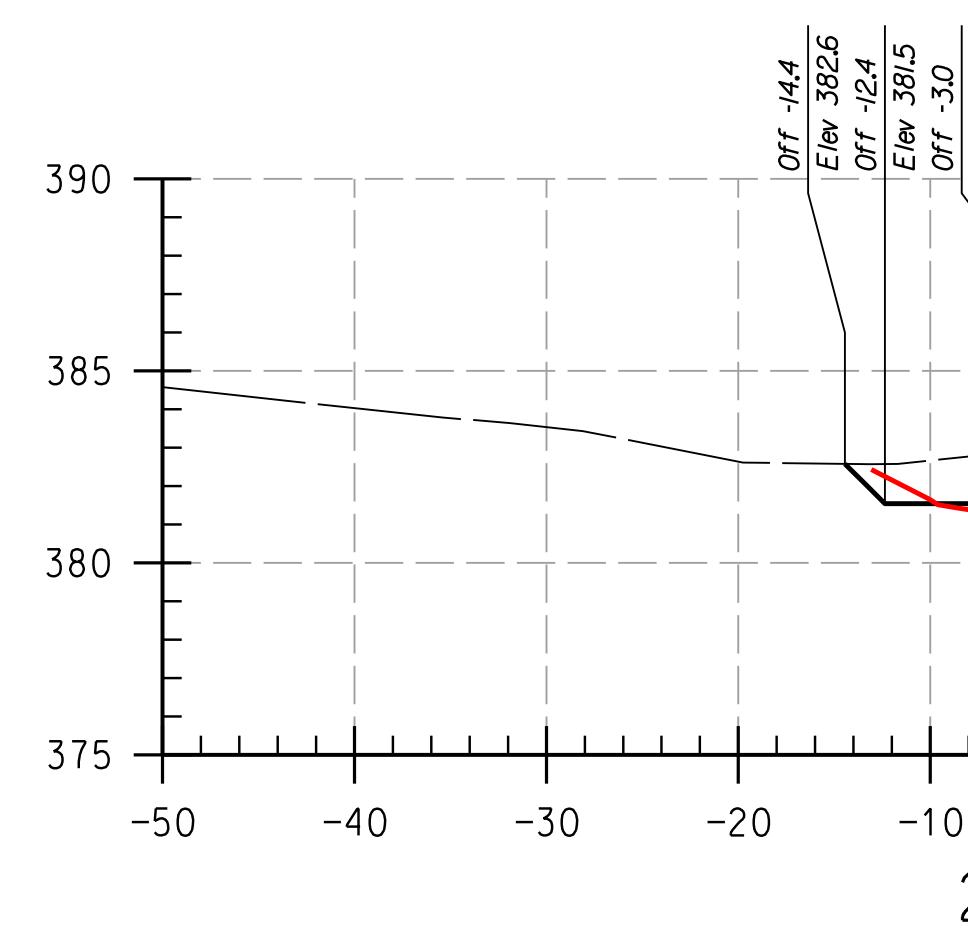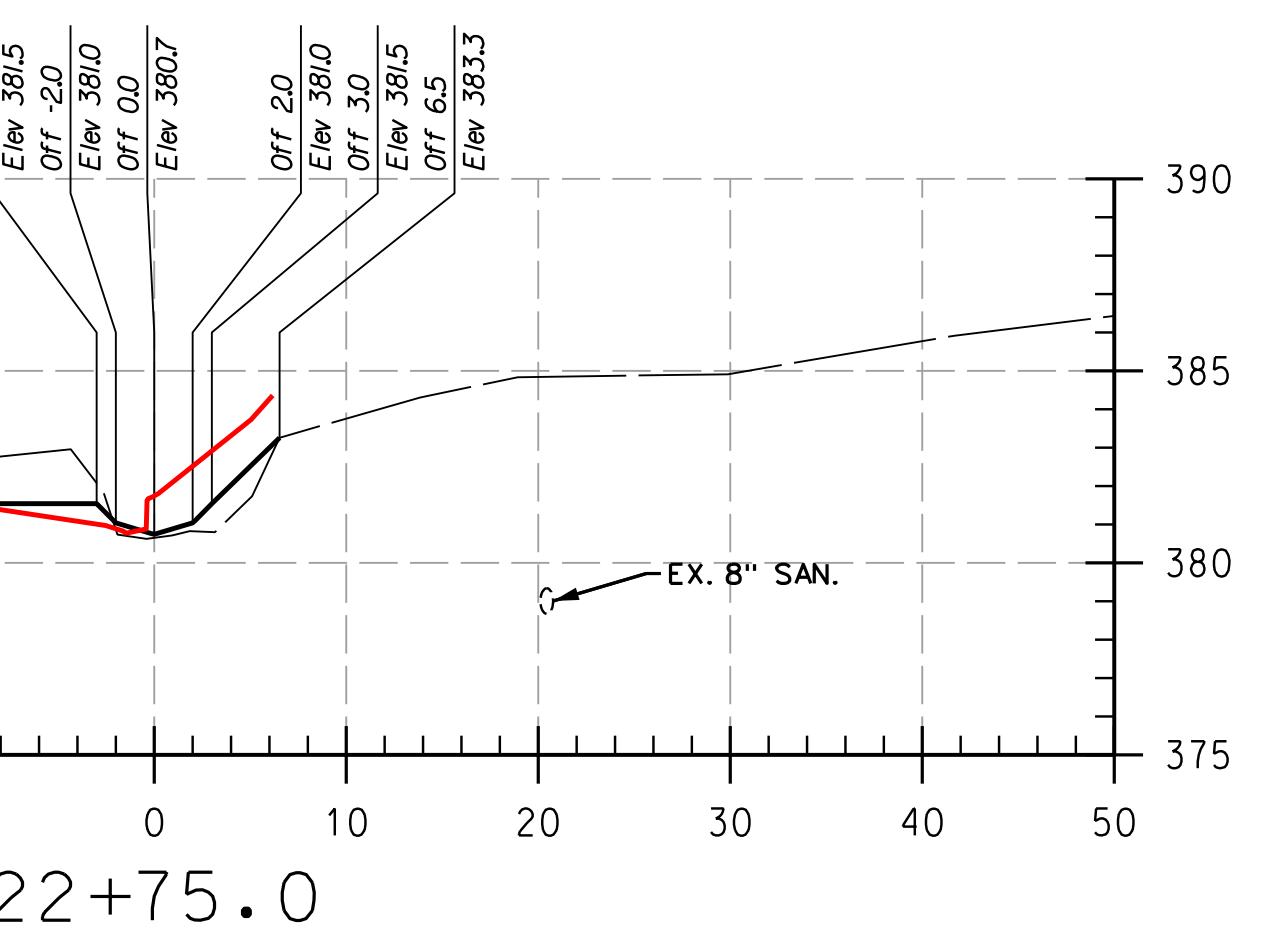

REACH 3

LEGEND
EXISTING GRADE _____
PROPOSED GRADE _____
AS-BUILT GRADE _____

NOTES:
UTILITIES SHOWN ON THESE PLANS HAVE BEEN LOCATED
USING SURVEY AND FIELD DATA. THE CONTRACTOR IS TO EXERCISE EXTREME CAUTION WHEN
EXCAVATING NEAR ANY UTILITIES TEST PIT IF REQUIRED.

PLOTTED 12:28 PM on Monday, April 24, 2017
FILE: C:\CAD_Files\Howard CC\DXS-2001 Howard CC As-Built.dwg

PROFESSIONAL CERTIFICATION, I HEREBY
CERTIFY THAT THESE DOCUMENTS WERE
PREPARED OR APPROVED BY ME AND THAT
I AM A DULY LICENSED PROFESSIONAL
ENGINEER UNDER THE LAWS OF THE STATE
OF MARYLAND, LICENSE NO. 3831,
EXPIRATION DATE: JANUARY 06, 2018

THIS DEVELOPMENT IS APPROVED FOR SOIL EROSION AND SEDIMENT CONTROL
BY THE HOWARD SOIL CONSERVATION DISTRICT.


HOWARD SCD DATE

DEPARTMENT OF PUBLIC WORKS, HOWARD COUNTY, MD
CHIEF, BUREAU OF ENVIRONMENTAL SERVICES

DATE

PLOTTED 12:28 PM on Monday, April 24, 2017
 BY: Dmarr FILE: Howard CC-0x5-2001-Howard CC As-Built.dwg
 FILE: C:\CAD\Files\Howard CC-0x5-2001-Howard CC As-Built.dwg

PROFESSIONAL CERTIFICATION, I HEREBY CERTIFY THAT THESE DOCUMENTS WERE PREPARED OR APPROVED BY ME AND THAT I AM A DULY LICENSED PROFESSIONAL ENGINEER UNDER THE LAWS OF THE STATE OF MARYLAND, LICENSE NO. 38311, EXPIRATION DATE: JANUARY 06, 2018

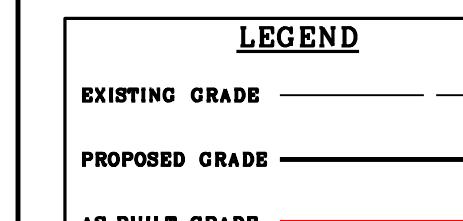

NOTES:
 UTILITIES SHOWN ON THESE PLANS HAVE BEEN LOCATED USING SURVEY DATA PROVIDED BY THE CONTRACTOR.
 THE CONTRACTOR IS TO EXERCISE EXTREME CAUTION WHEN EXCAVATING NEAR ANY UTILITIES TEST PIT IF REQUIRED.








THIS DEVELOPMENT IS APPROVED FOR SOIL EROSION AND SEDIMENT CONTROL
 BY THE HOWARD SOIL CONSERVATION DISTRICT.

HOWARD SCD

DATE

DEPARTMENT OF PUBLIC WORKS, HOWARD COUNTY, MD
 CHIEF, BUREAU OF ENVIRONMENTAL SERVICES

REACH 3

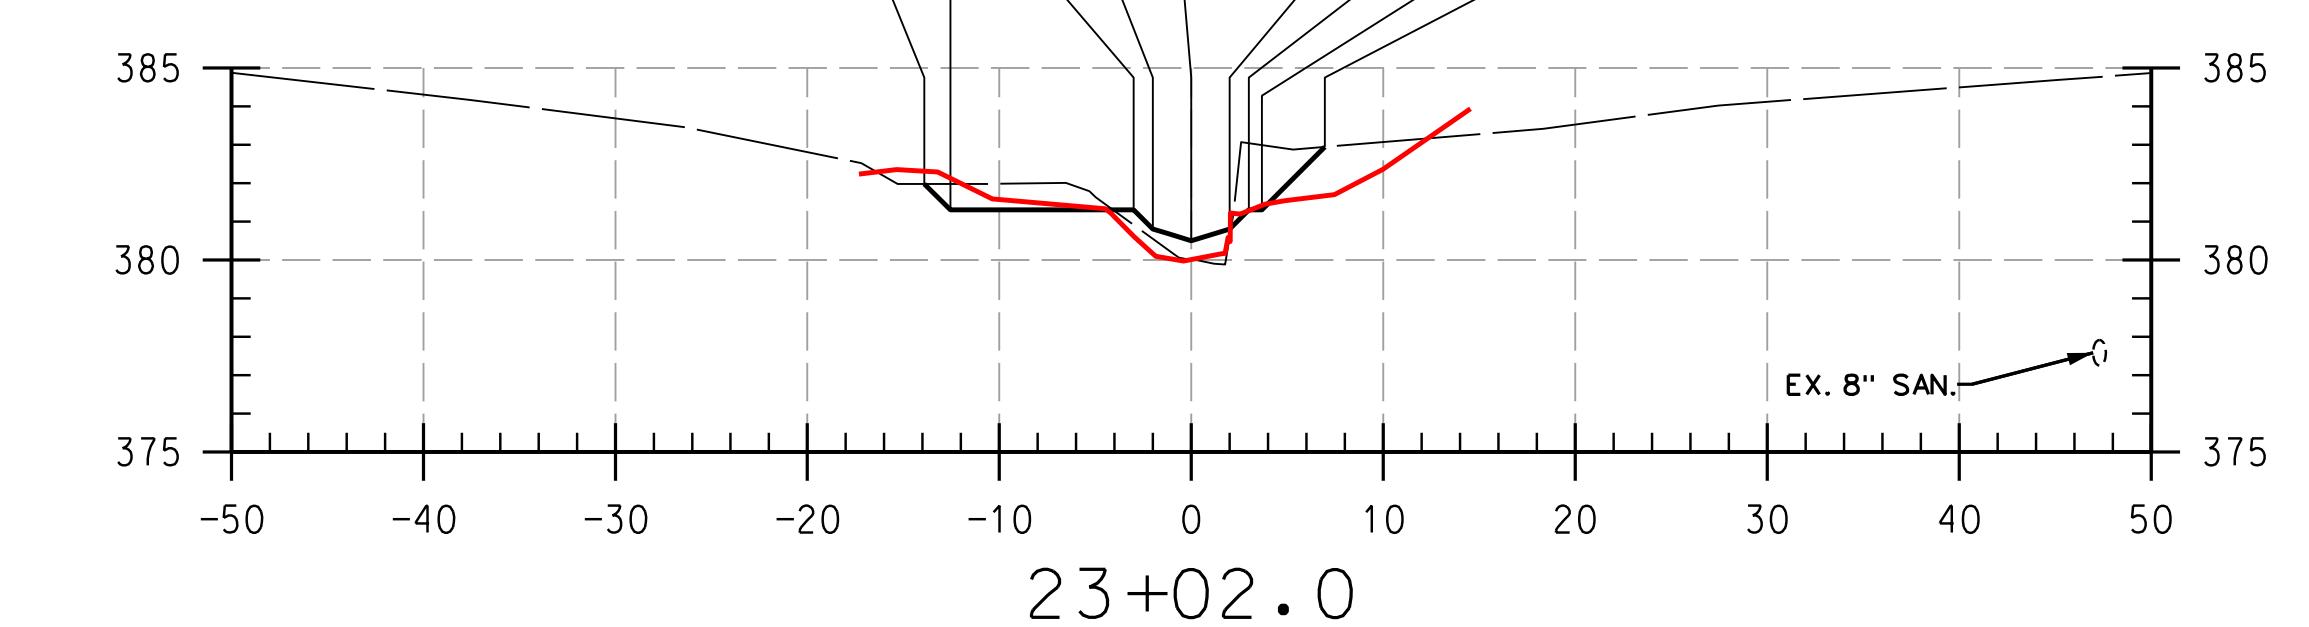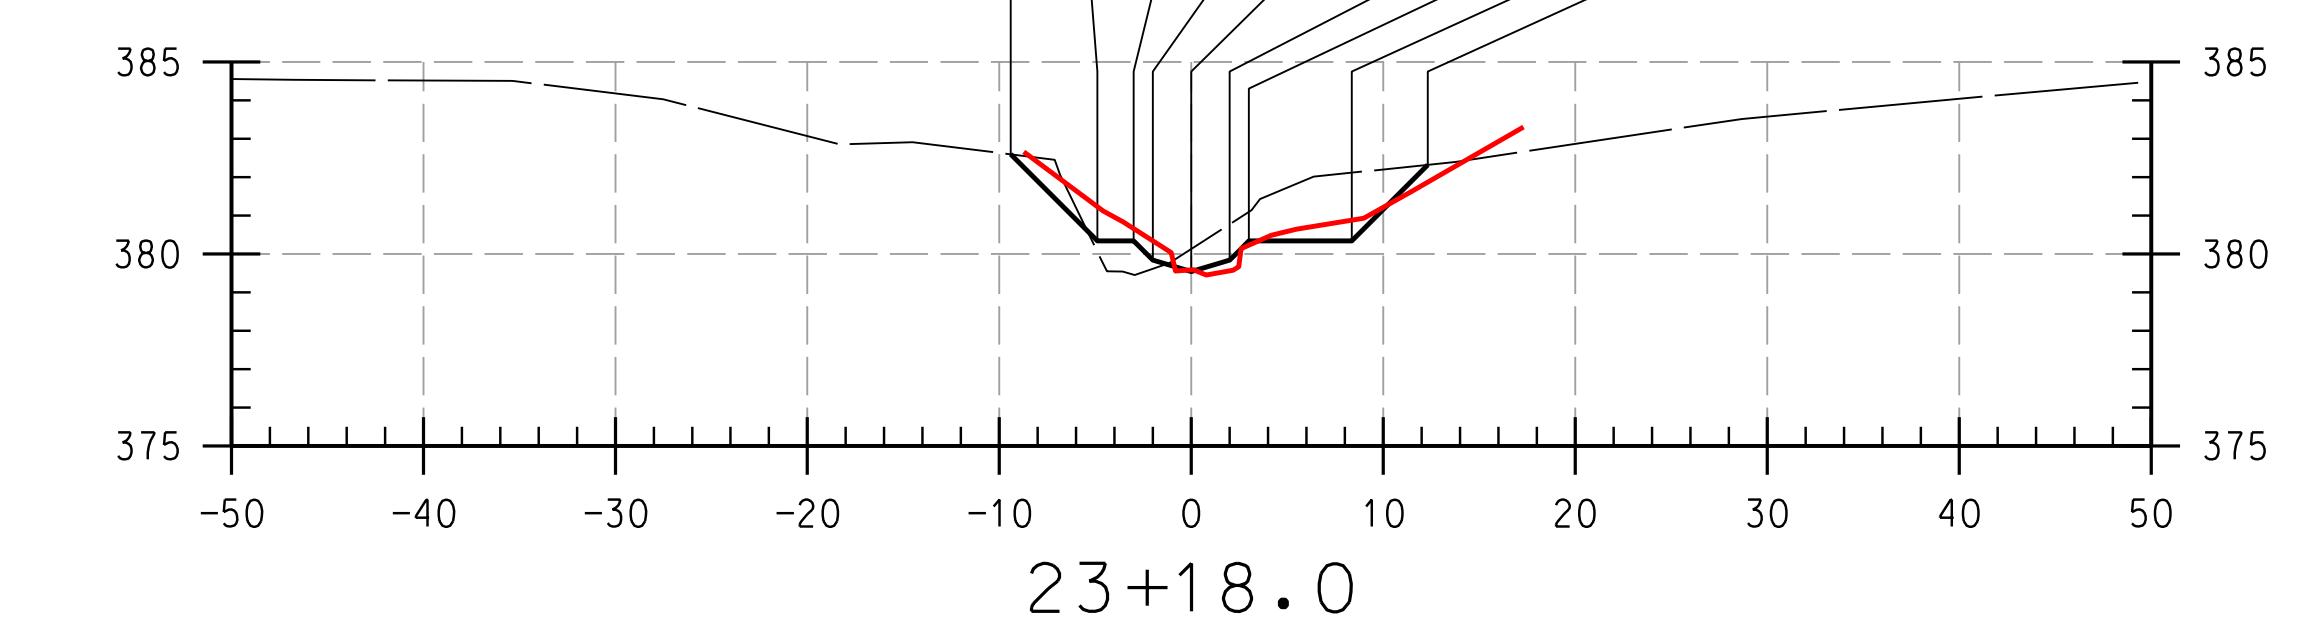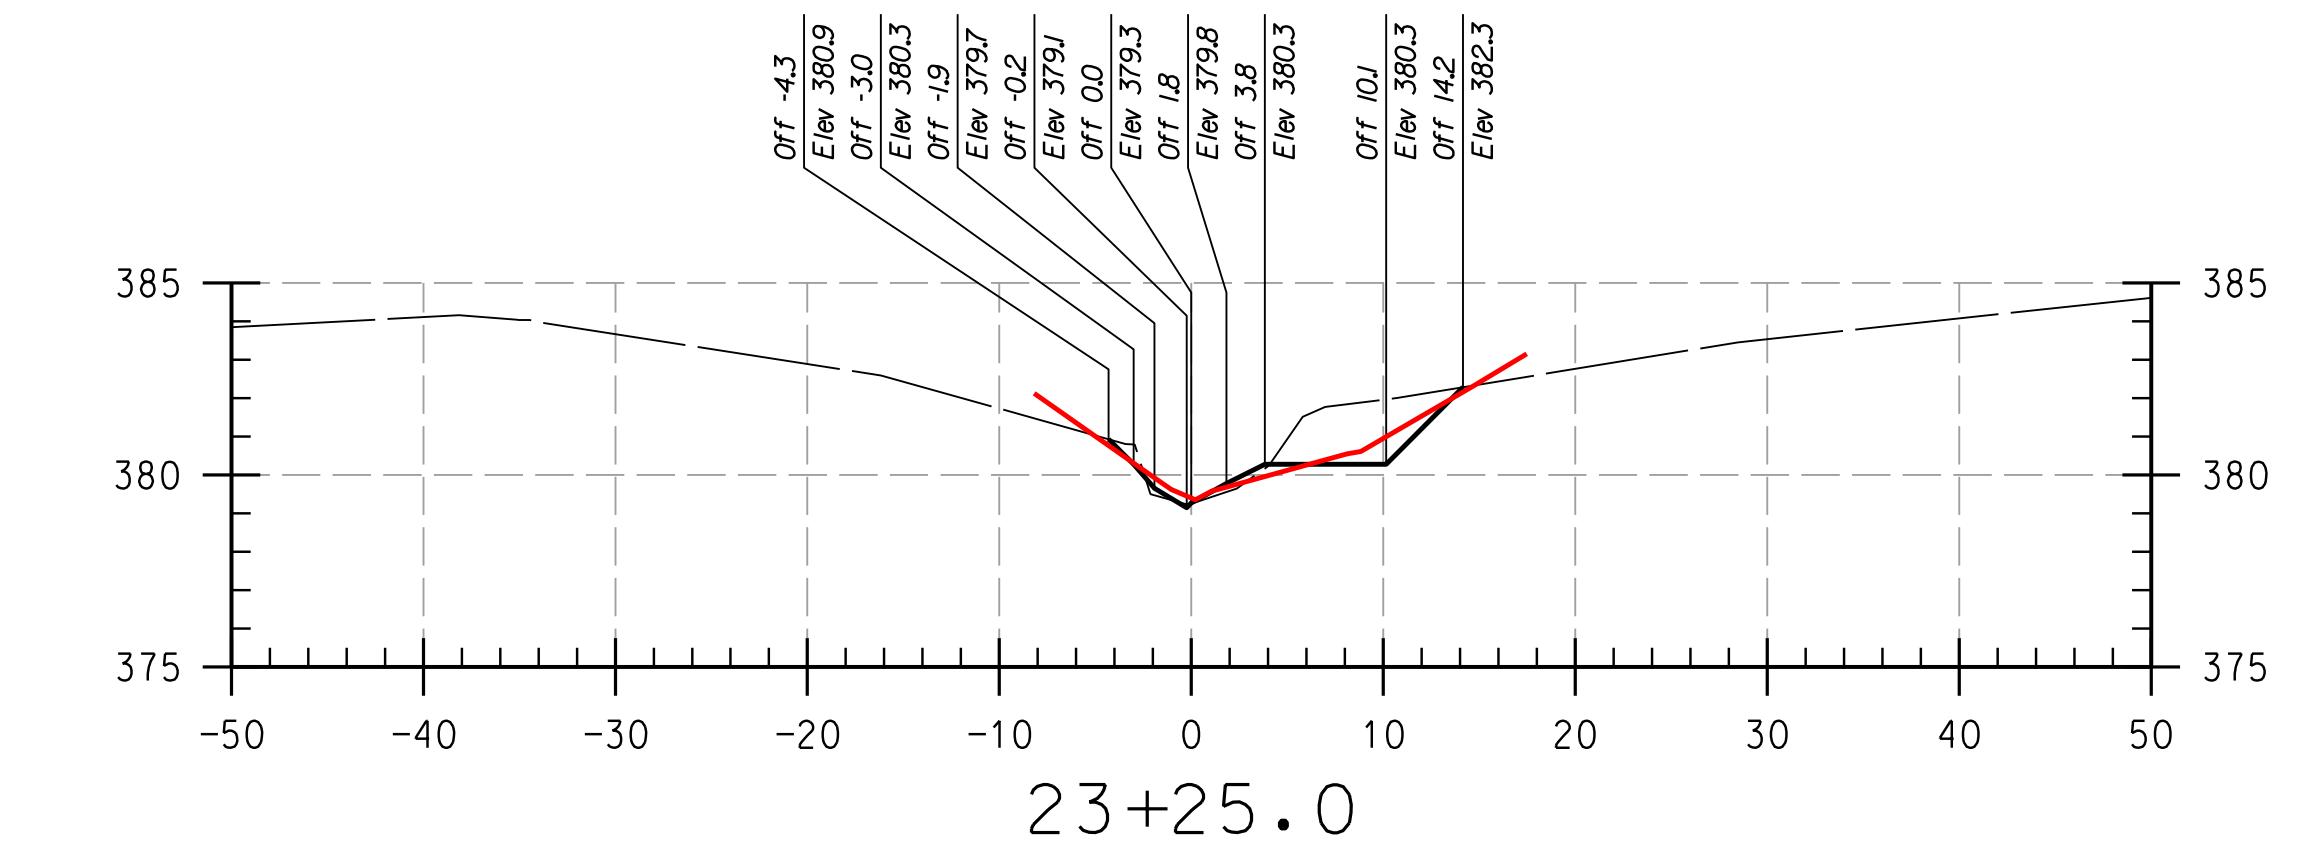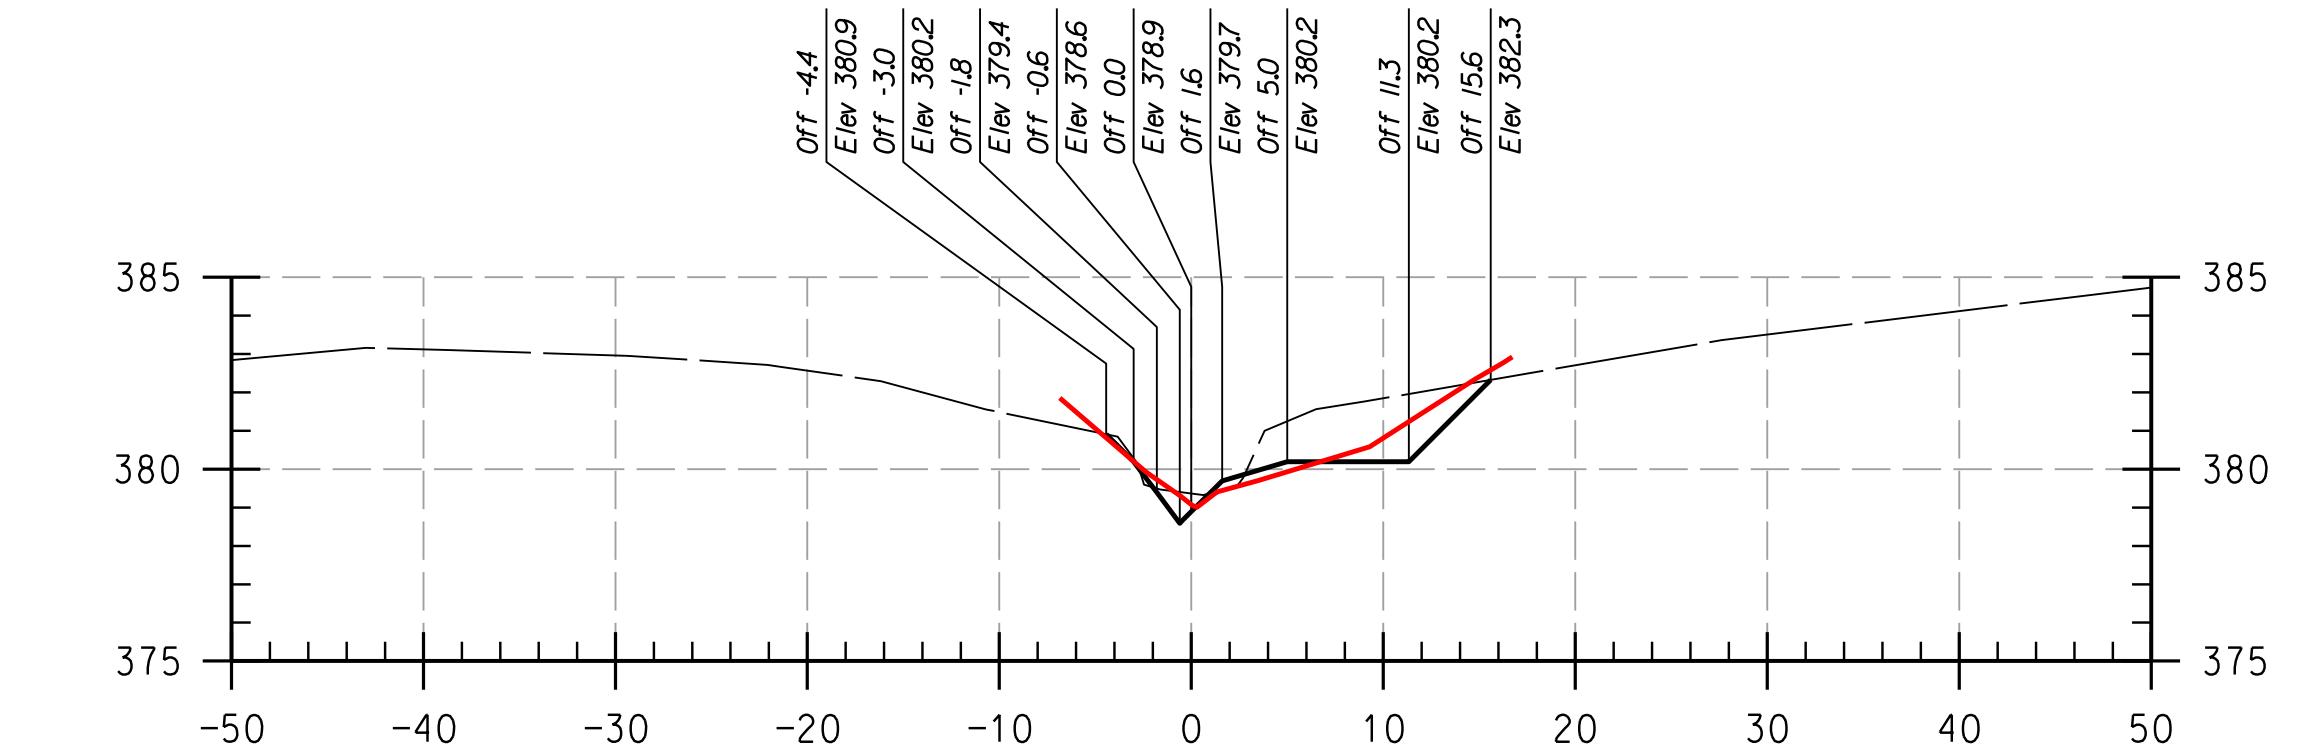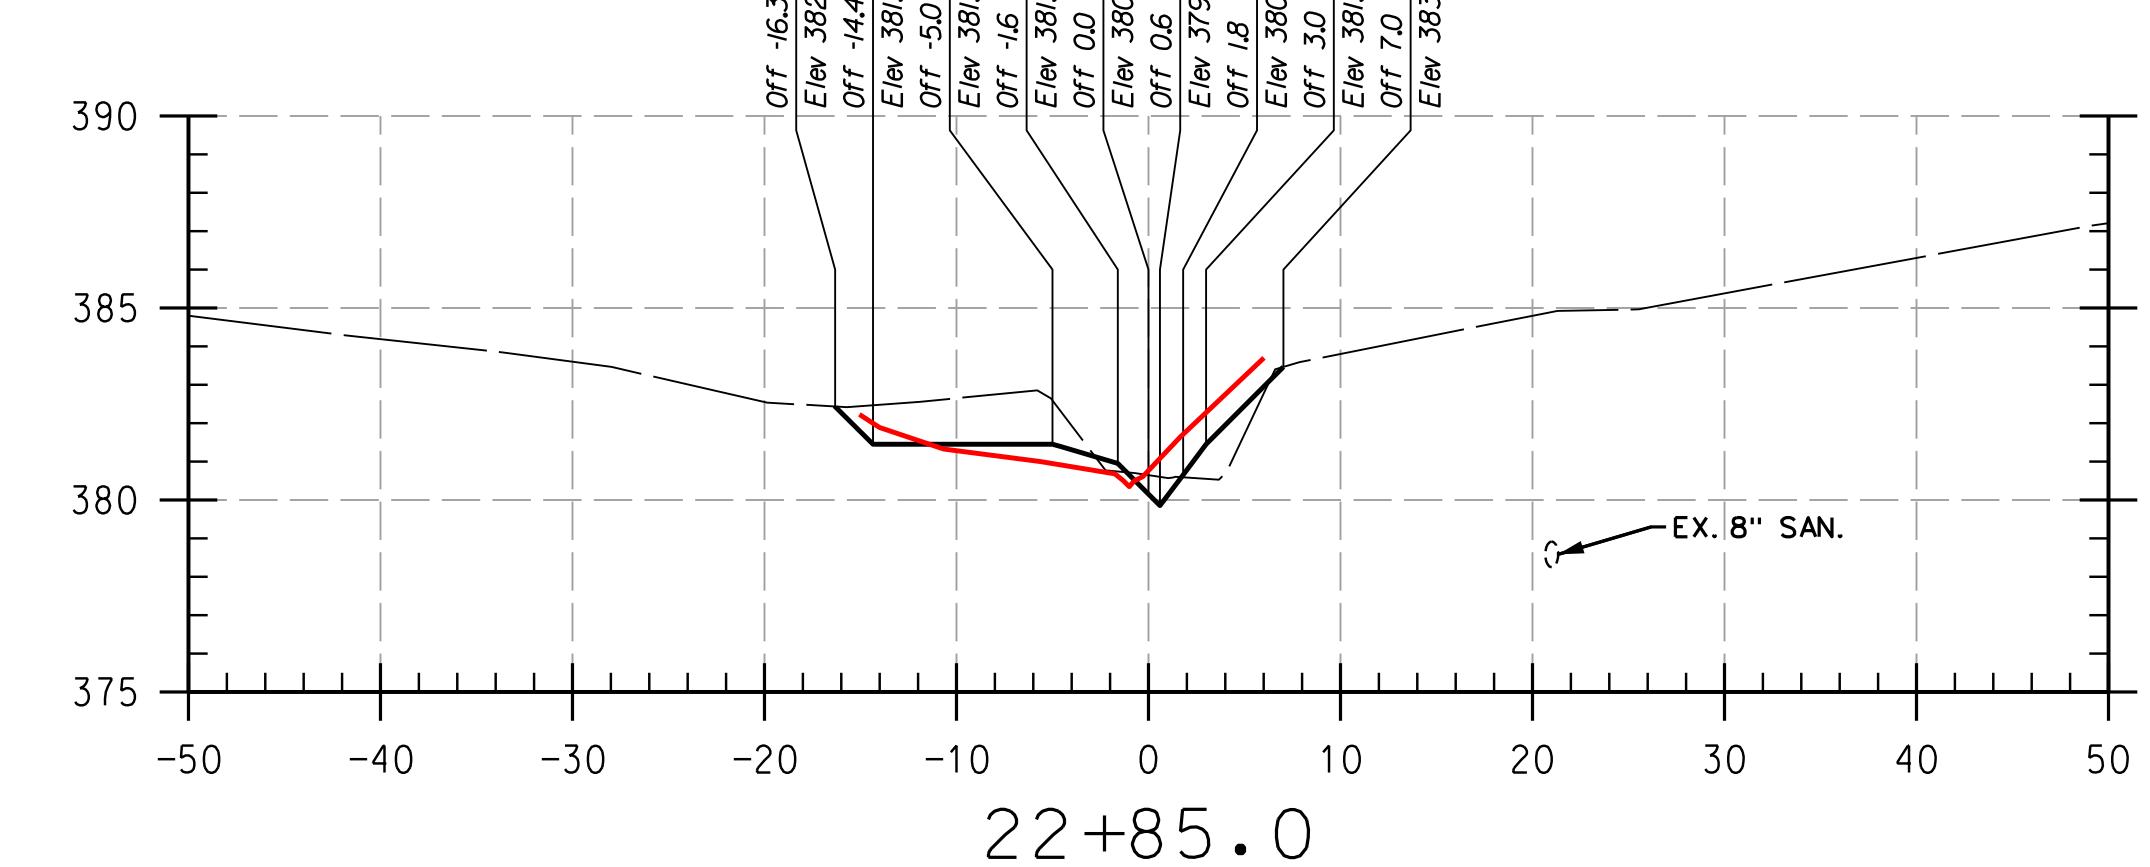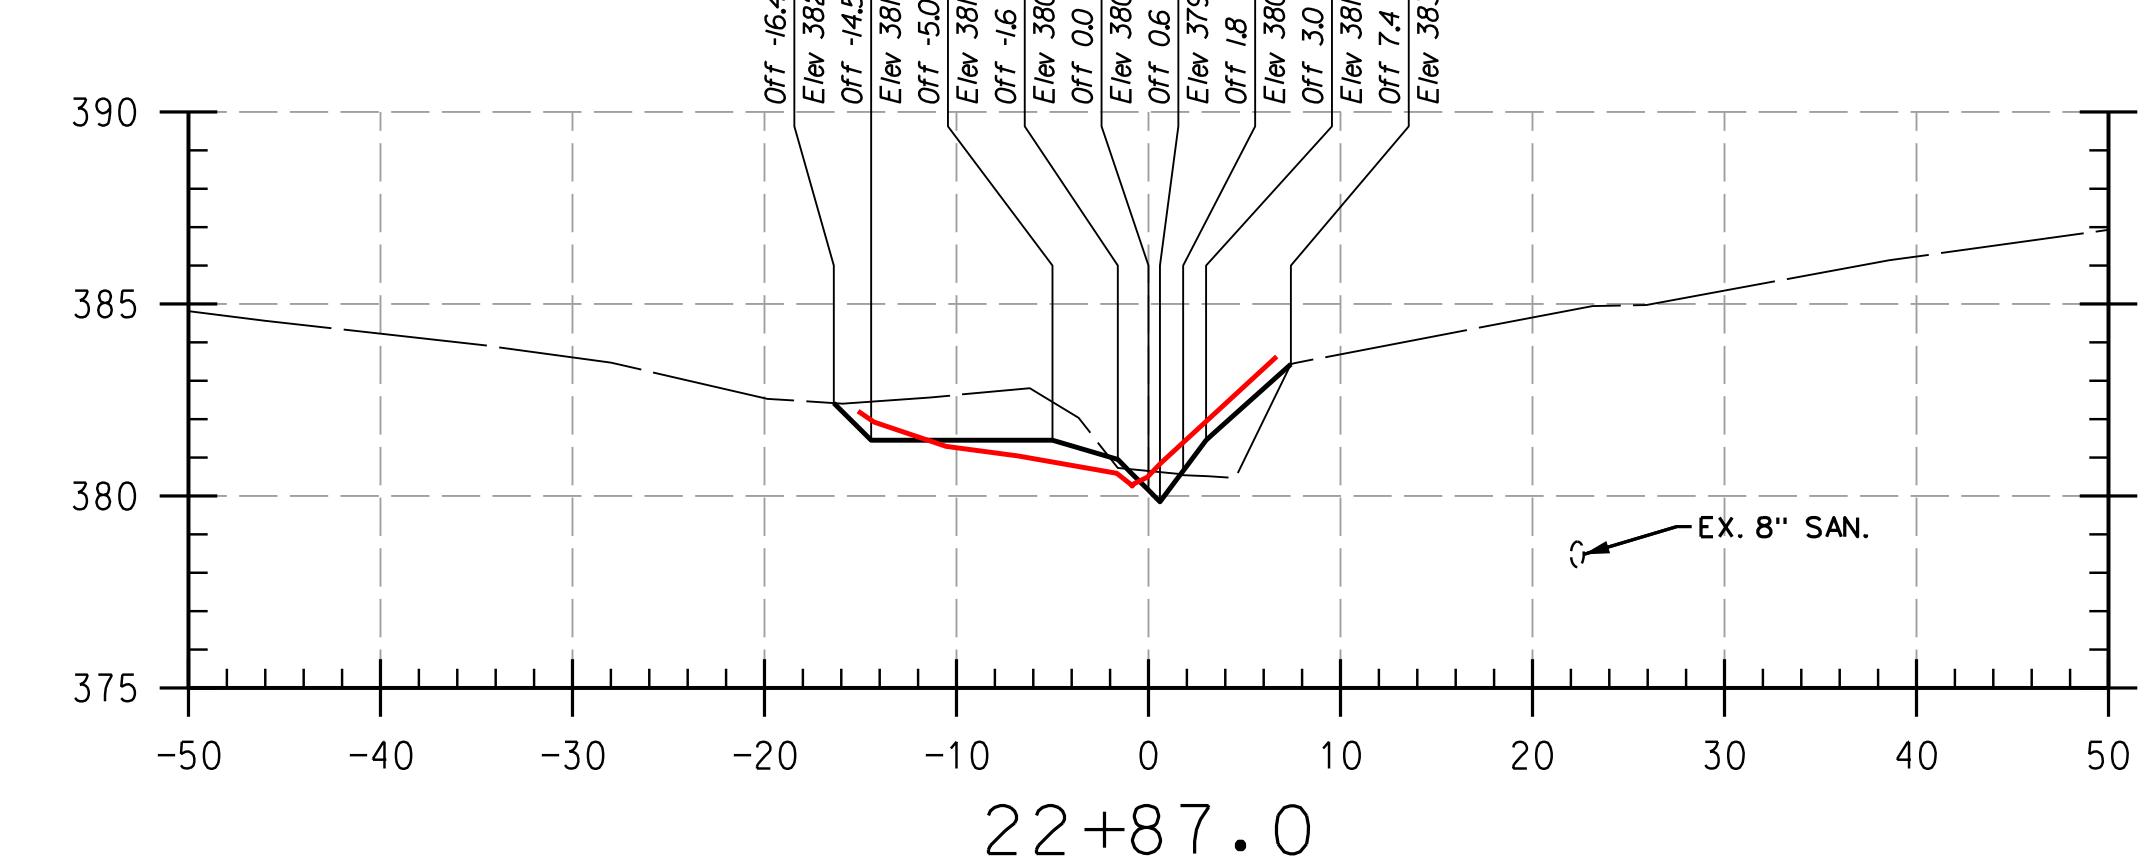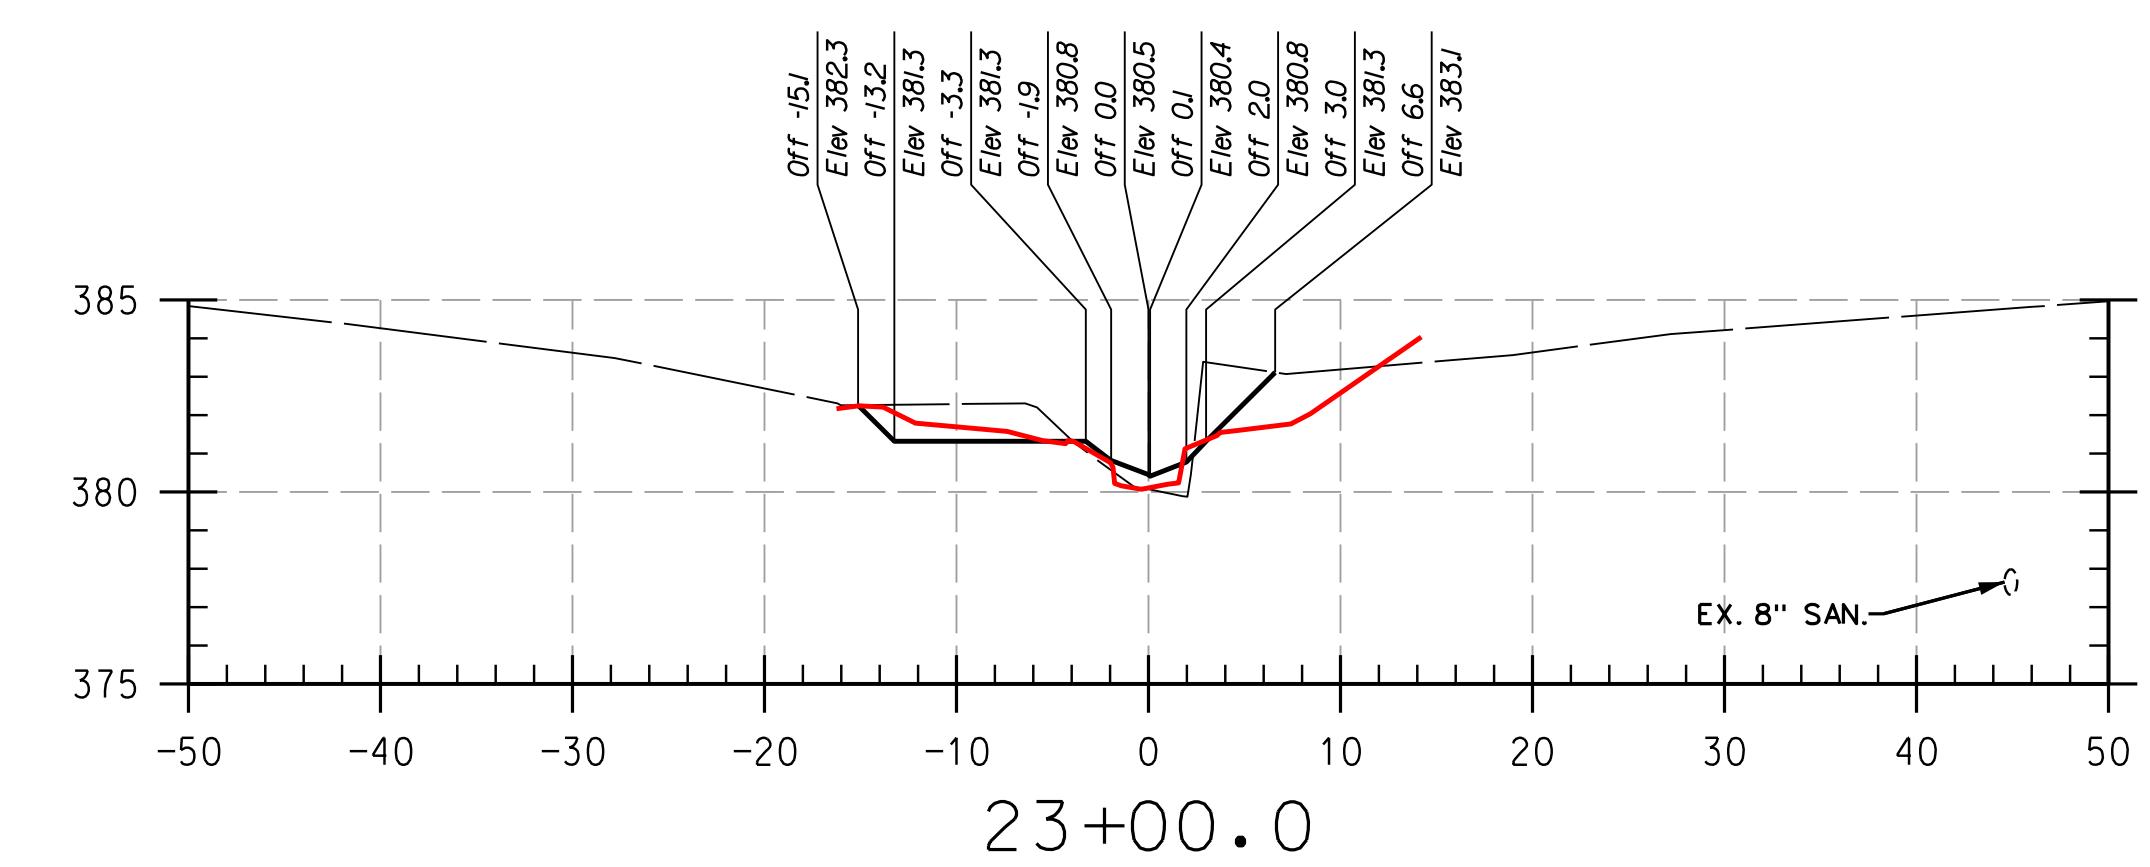

HOWARD COMMUNITY COLLEGE
 STREAM RESTORATION PROJECT
 CAPITAL PROJECT D-1158
 HOWARD COUNTY DEPARTMENT OF PUBLIC WORKS
 STORMWATER MANAGEMENT DIVISION
 6751 COLUMBIA GATEWAY DRIVE
 COLUMBIA, MD 21046
 PARCELS: 47, 81, TAX MAP: 35, 36
 ZONING: POR, NT, ELECTION DISTRICT 06
 GRID/BLOCK: 0006


AS-BUILT CROSS SECTIONS


SCALE: HOR: 1" = 10'
 VERT: 1" = 5'
 DATE: APRIL 2017
 KCJOB NO.: 17133314.83
 CAPITAL PROJECT NO.: D-1158
 PERMIT ISSUE:
 CONSTRUCTION ISSUE:

CS-25

SHEET NO.: 25 OF 27

936 RIDGEBROOK ROAD
 SPARKS, MARYLAND 21152
 TELEPHONE: (410) 316-7800
 FAX: (410) 316-7818
 www.kci.com

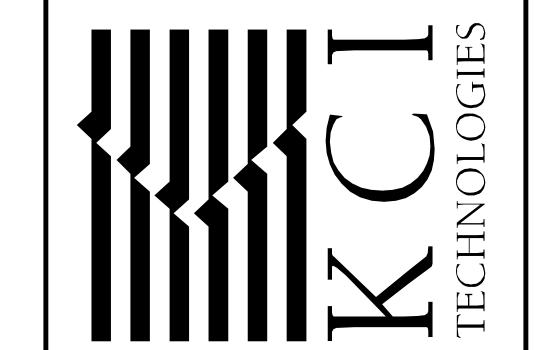

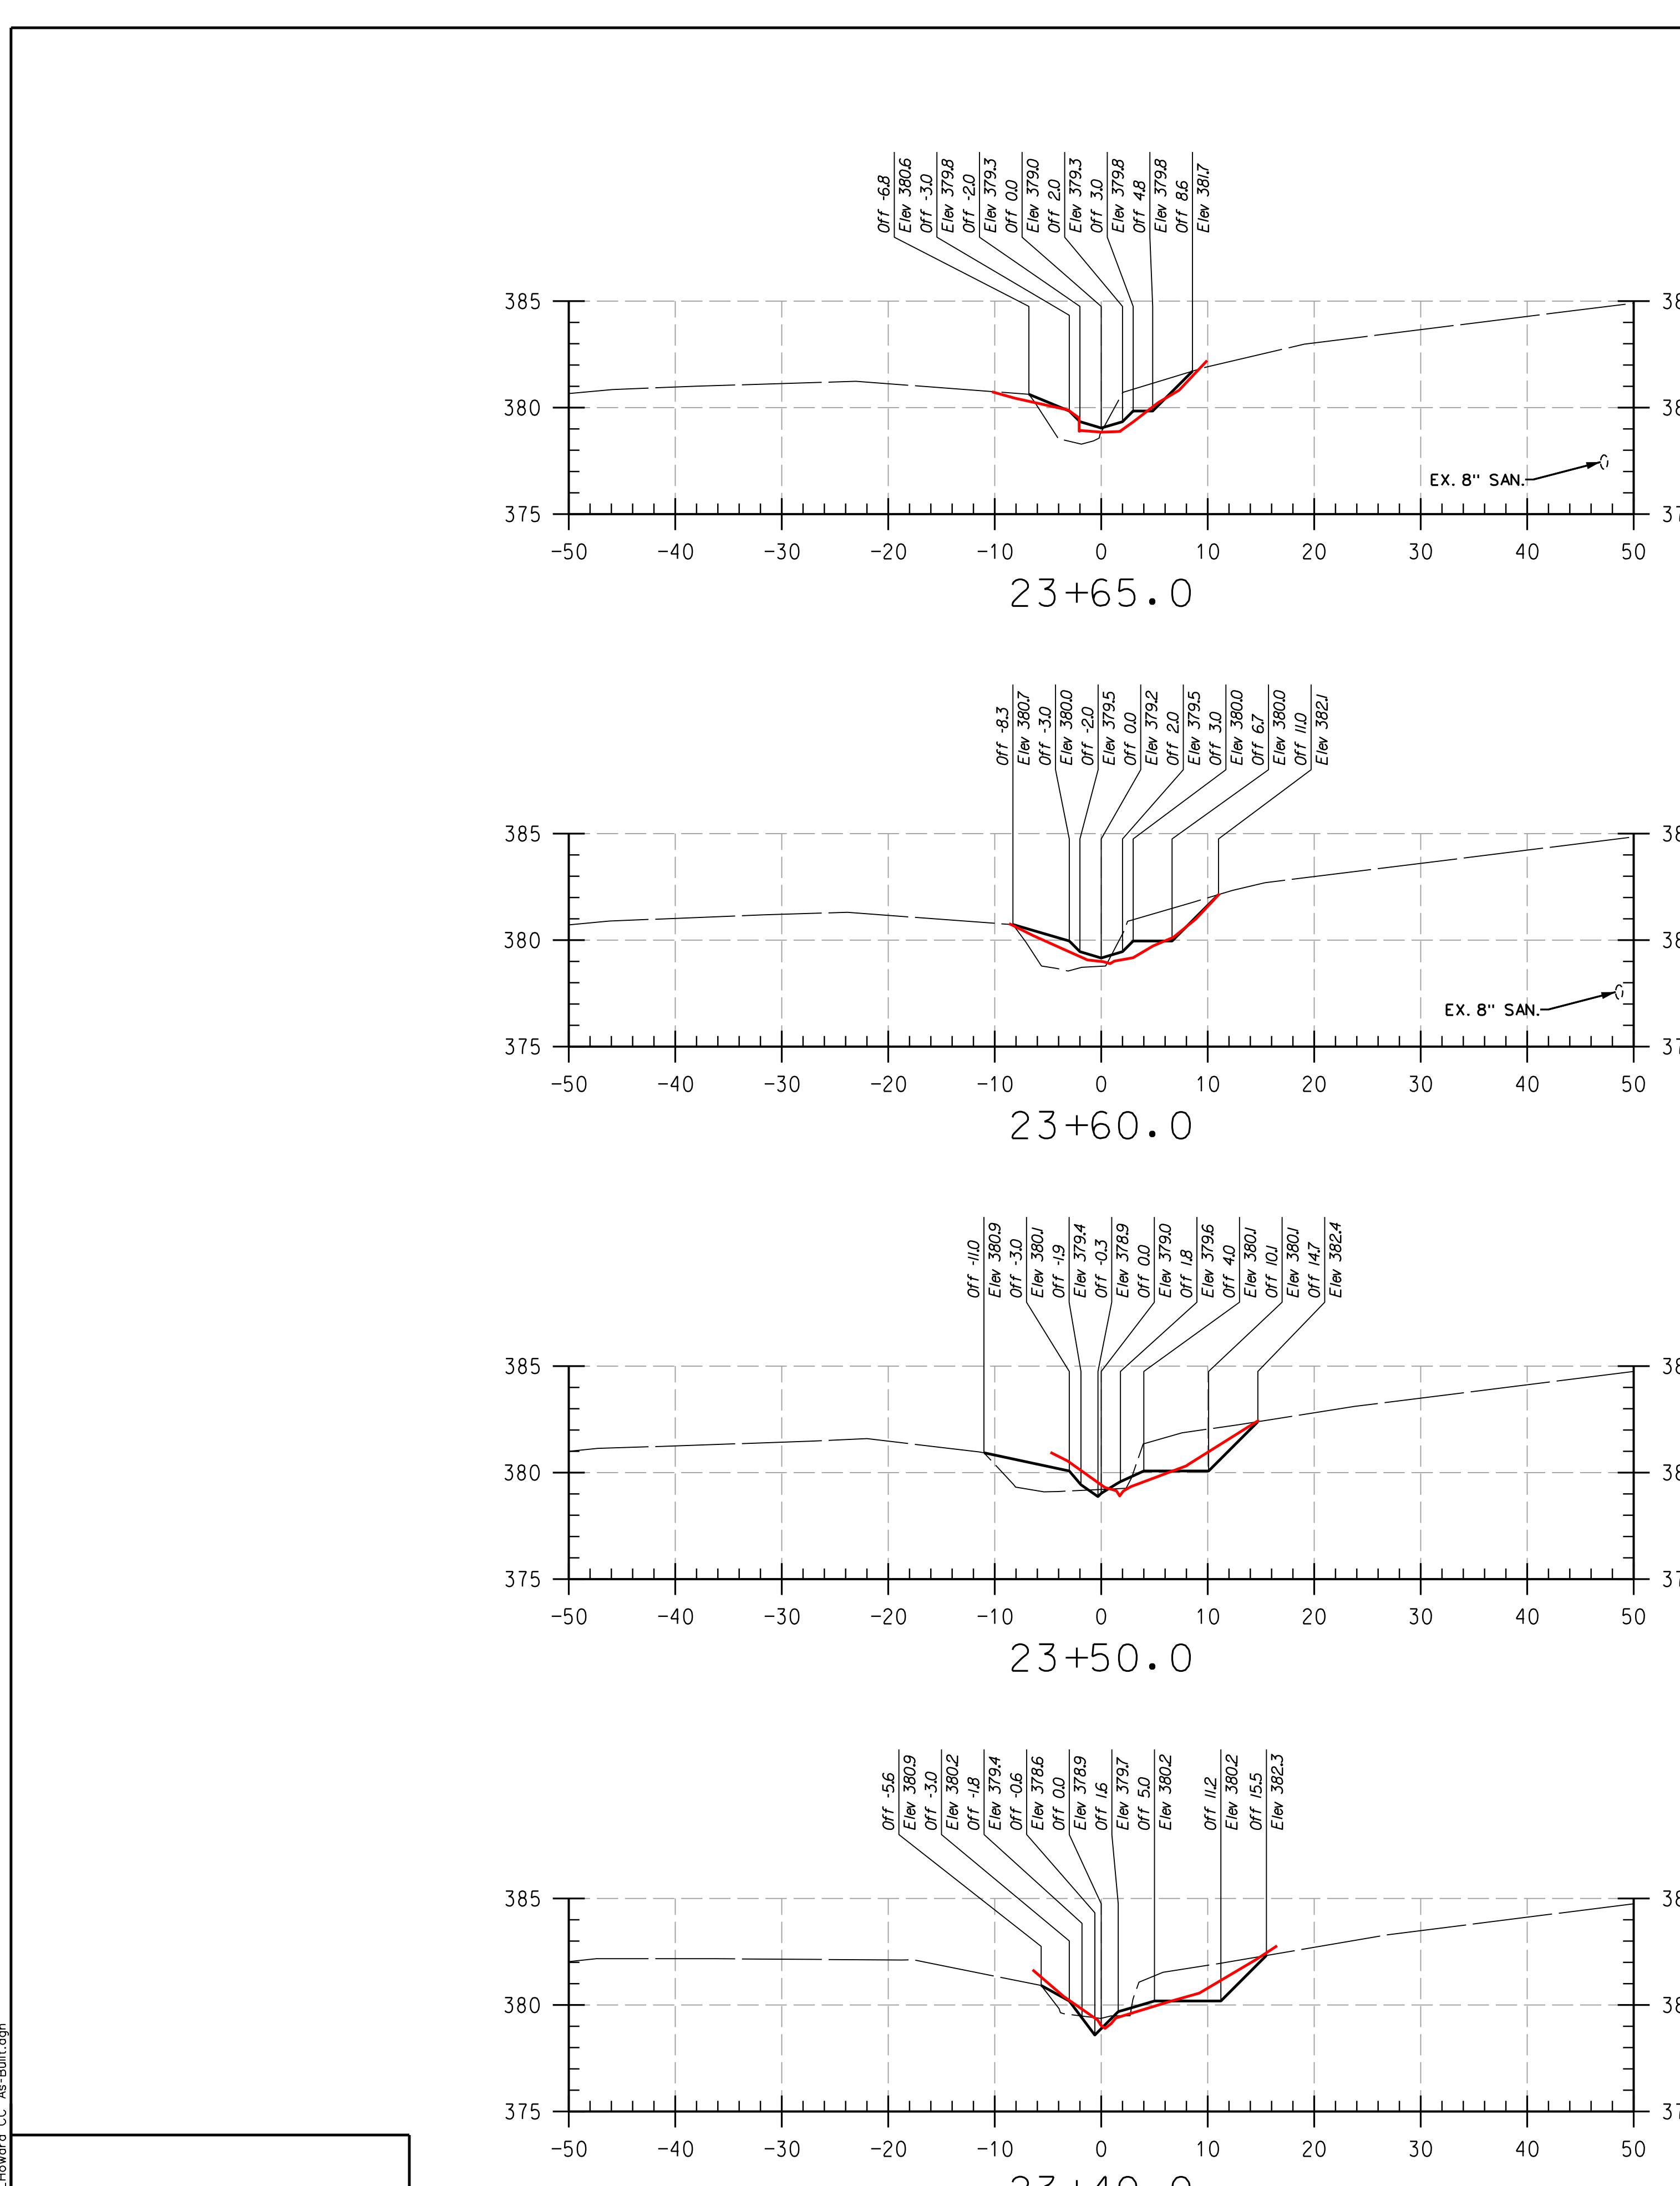

REACH 3

LEGEND	
EXISTING GRADE	—
PROPOSED GRADE	—
AS-BUILT GRADE	—

NOTES:
 UTILITIES SHOWN ON THESE PLANS HAVE BEEN LOCATED
 USING SURVEY DATA AND ARE NOT DRAWN TO SCALE.
 THE CONTRACTOR IS TO EXERCISE EXTREME CAUTION WHEN
 EXCAVATING NEAR ANY UTILITIES TEST PIT IF REQUIRED.

THIS DEVELOPMENT IS APPROVED FOR SOIL EROSION AND SEDIMENT CONTROL
 BY THE HOWARD SOIL CONSERVATION DISTRICT.


HOWARD SCD

DATE

DEPARTMENT OF PUBLIC WORKS, HOWARD COUNTY, MD


DATE

CHIEF, BUREAU OF ENVIRONMENTAL SERVICES

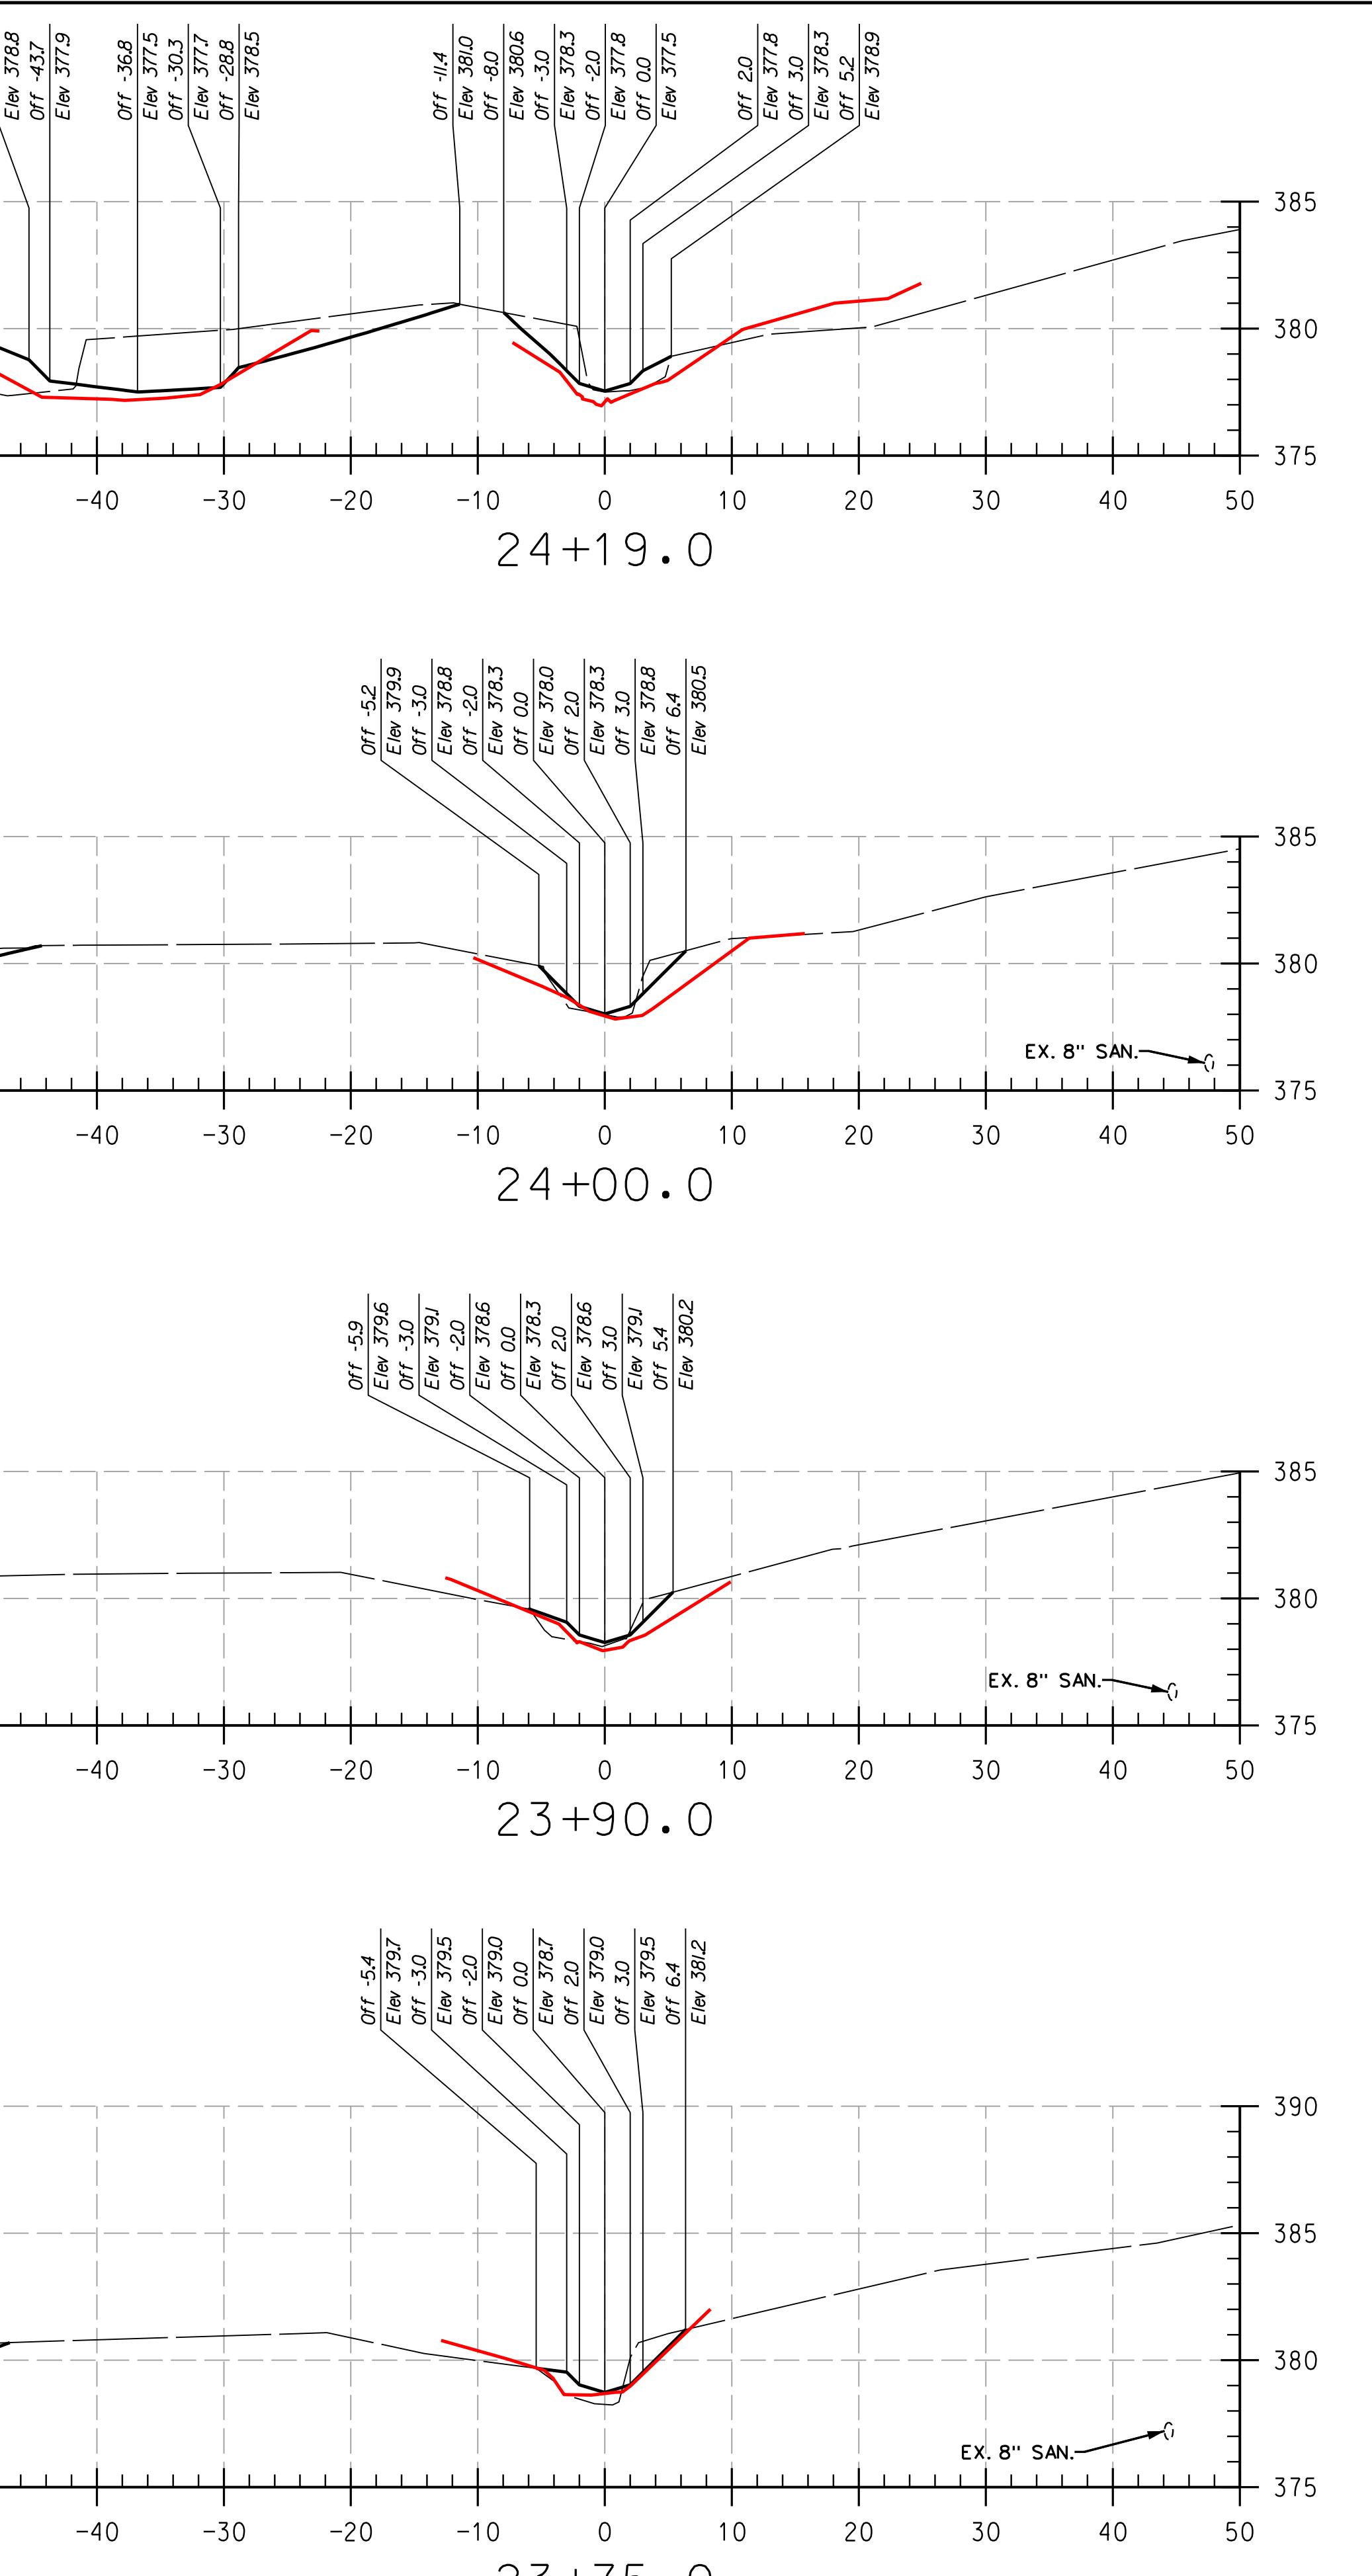

HOWARD COMMUNITY COLLEGE
 STREAM RESTORATION PROJECT
 CAPITAL PROJECT D-1158
 HOWARD COUNTY DEPARTMENT OF PUBLIC WORKS
 STORMWATER MANAGEMENT DIVISION
 6751 COLUMBIA GATEWAY DRIVE
 COLUMBIA, MD 21046
 PARCELS: 47, 81, TAX MAP: 35, 36
 GRID BLOCK: 0006
 ZONING: POR, NT, ELECTION DISTRICT 06

936 RIDGEBROOK ROAD
 SPARKS, MARYLAND 21152
 TELEPHONE: (410) 316-7800
 FAX: (410) 316-7818
 www.kci.com

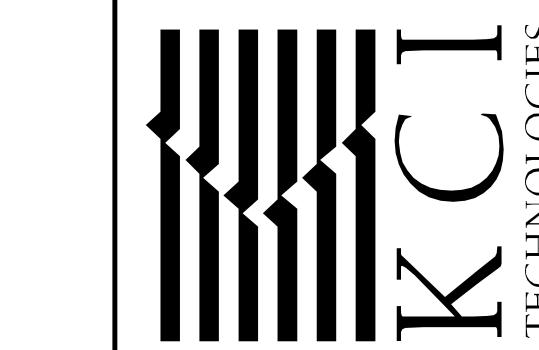

AS-BUILT CROSS SECTIONS


SCALE: HOR: 1" = 10'
 VERT: 1" = 5'
 DATE: APRIL 2017
 KCI JOB NO.: 17133314.83
 CAPITAL PROJECT NO.: D-1158
 PERMIT ISSUE:
 CONSTRUCTION ISSUE:

CS-26

SHEET NO.: 26 OF 27

KC FILE: M:\2013\17133314.83\

NO. REVISIONS DESCRIPTION DATE

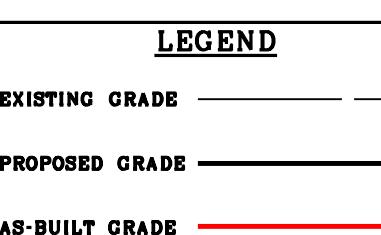

NOTES:
 UTILITIES SHOWN ON THESE PLANS HAVE BEEN LOCATED
 USING SURVEY AND DRILLING METHODS. THE
 CONTRACTOR IS TO EXERCISE EXTREME CAUTION WHEN
 EXCAVATING NEAR ANY UTILITIES TEST PIT IF REQUIRED.

PROFESSIONAL CERTIFICATION, I HEREBY
 CERTIFY THAT THESE DOCUMENTS WERE
 PREPARED OR APPROVED BY ME AND THAT
 I AM A DULY LICENSED PROFESSIONAL
 ENGINEER UNDER THE LAWS OF THE STATE
 OF MARYLAND, LICENSE NO. 38311,
 EXPIRATION DATE: JANUARY 06, 2018

THIS DEVELOPMENT IS APPROVED FOR SOIL EROSION AND SEDIMENT CONTROL
 BY THE HOWARD SOIL CONSERVATION DISTRICT.

HOWARD SCD DATE

DEPARTMENT OF PUBLIC WORKS, HOWARD COUNTY, MD
 CHIEF, BUREAU OF ENVIRONMENTAL SERVICES DATE

REACH 3

