GENERAL NOTES

PART I

1. APPROXIMATE LOCATIONS OF EXISTING MAINS ARE SHOWN. THE CONTRACTOR SHALL TAKE ALL NECESSARY PRECAUTIONS TO PROTECT EXISTING MAINS AND SERVICES AND MAINTAIN UNINTERRUPTED SERVICE. ANY DAMAGE INCURRED SHALL BE REPAIRED IMMEDIATELY TO THE SATISFACTION OF THE ENGINEER AT THE CONTRACTOR'S EXPENSE.

2. TOPOGRAPHIC FIELD SURVEYS WERE PERFORMED IN MARCH, 2022 BY BENCHMARK ENGINEERING, INC

3. HORIZONTAL AND VERTICAL SURVEY CONTROLS:

THE COORDINATES SHOWN ON THE DRAWINGS ARE BASED ON MARYLAND STATE REFERENCE SYSTEM NAD '83/'91 AS PROJECTED BY HOWARD COUNTY GEODETIC CONTROL STATIONS NO. 35G2 AND NO. 35GA. ALL VERTICAL CONTROLS ARE BASED ON NAVD '88. VERTICAL CONTROLS PROVIDED ON THE DRAWINGS

4. ALL PIPE ELEVATIONS SHOWN ARE INVERT ELEVATIONS UNLESS OTHERWISE NOTED ON THE PLANS. 5. CLEAR ALL UTILITIES BY A MINIMUM OF 12 INCHES. CLEAR ALL POLES BY 5'-0" MINIMUM OR TUNNEL AS REQUIRED UNLESS OTHERWISE NOTED. THE OWNER HAS CONTACTED THE UTILITY COMPANIES AND HAS MADE ARRANGEMENTS FOR BRACING OF POLES AS SHOWN ON THE DRAWINGS IN THE EVENT THE CONTRACTOR'S WORK REQUIRES THE BRACING OF ADDITIONAL POLES, ANY COST INCURRED BY THE OWNER FOR THE BRACING OF ADDITIONAL POLES OR DAMAGES SHALL BE DEDUCTED FROM MONIES OWED THE CONTRACTOR. THE CONTRACTOR SHALL COORDINATE WITH THE UTILITY COMPANIES TO SCHEDULE THE BRACING OF THE POLES.

5. FOR DETAILS NOT SHOWN ON THE DRAWING, AND FOR MATERIALS AND CONSTRUCTION METHODS, USE HOWARD COUNTY DESIGN MANUAL VOLUME IV, STANDARD SPECIFICATIONS AND DETAILS FOR CONSTRUCTION (LATEST EDITION). THE CONTRACTOR SHALL HAVE A COPY OF VOLUME IV ON THE JOB 7. WHERE TEST PITS HAVE BEEN MADE ON EXISTING UTILITIES, THEY ARE NOTED BY THE SYMBOL AT THE LOCATIONS OF THE TEST PITS. A NOTE OR NOTES CONTAINING THE RESULTS OF THE TEST PIT OR PITS IS INCLUDED ON THE DRAWINGS. EXISTING UTILITIES IN THE VICINITY OF THE PROPOSED WORK FOR WHICH TEST PITS HAVE NOT BEEN DUG SHALL BE LOCATED BY THE CONTRACTOR TWO WEEKS IN ADVANCE OF CONSTRUCTION OPERATIONS AT HIS OWN EXPENSE.

8. THE CONTRACTOR SHALL NOTIFY THE FOLLOWING UTILITY COMPANIES OR AGENCIES AT LEAST FIVE WORKING DAYS BEFORE STARTING WORK SHOWN ON THESE PLANS:

.410-637-8713 BGE (EMERGENCY). ...410-685-0123 COLONIAL PIPELINE MISS UTILITY... STATE HIGHWAY ADMINISTRATION. .410 - 531 - 553

TREES AND SHRUBS ARE TO BE PROTECTED FROM DAMAGE TO THE MAXIMUM EXTENT, TREES AND SHRUBS LOCATED WITHIN THE CONSTRUCTION STRIP ARE NOT TO BE REMOVED OR DAMAGED BY THE

10. THE CONTRACTOR SHALL REMOVE TREES, STUMPS AND ROOTS ALONG LINE OF EXCAVATION. PAYMENT FOR SUCH REMOVAL SHALL BE INCLUDED IN THE UNIT PRICE BID FOR CONSTRUCTION OF

11. THE CONTRACTOR SHALL NOTIFY THE BUREAU OF HIGHWAYS, HOWARD COUNTY, AT (410)-313-7450 AT LEAST FIVE WORKING DAYS BEFORE OPEN CUTTING OR BORING/JACKING OF ANY COUNTY ROAD FOR LAYING WATER/SEWER MAINS OR HOUSE CONNECTIONS. THE APPROVAL OF THESE DRAWINGS WILL CONSTITUTE COMPLIANCE WITH DPW REQUIREMENTS PER SECTION 18.114(a) OF THE HOWARD COUNTY CODE.

PART II WATER

1. ALL WATER MAINS TO BE PVC C-900 DR-18 UNLESS OTHERWISE NOTED.

ALL WATER MAINS SHALL HAVE A MINIMUM OF 3'-6" OF COVER UNLESS OTHERWISE 3. VALVES ADJACENT TO TEES SHALL BE STRAPPED TO TEES.

4. ALL FITTINGS SHALL BE BUTTRESSED OR ANCHORED WITH CONCRETE IN ACCORDANCE WITH STANDARD DETAILS UNLESS OTHERWISE PROVIDED FOR ON THE DRAWINGS. 5. FIRE HYDRANTS SHALL BE SET TO THE BURY LINE ELEVATIONS SHOWN ON THE DRAWINGS. ALL FIRE HYDRANTS SHALL BE INSTALLED IN ACCORDANCE WITH THE STANDARD DETAILS. THE SOIL AROUND THE FIRE HYDRANT SHALL BE COMPACTED IN ACCORDANCE WITH SECTION 1000 AND

SECTION 1005 OF THE STANDARD SPECIFICATIONS. 3. THE CONTRACTOR SHALL NOT OPERATE ANY WATER MAIN VALVES ON THE EXISTING WATER SYSTEM. 7. TRACER WIRE AND CONTINUITY TEST STATIONS SHALL BE INSTALLED ON ALL DIP AND PVC WATER MAINS IN ACCORDANCE WITH THE HOWARD COUNTY DESIGN MANUAL.

8. FOR PVC WATER MAINS, ALL RECORDS FOR THE QUALITY CONTROL AND QUALIFICATION TEST REQUIREMENTS NOTED IN SECTION 5.1 OF THE AWWA STANDARD C900 FOR PVC PRESSURE PIPE SHALL BE SUBMITTED WITH THE PIPE MATERIAL CERTIFICATIONS OR SHOP DRAWINGS PRIOR TO APPROVAL OF THE MATERIAL FOR USE. THE TEST RECORDS SHALL BE FOR THE PIPE TO BE INSTALLED UNDER THIS CONTRACT. ALL PVC PIPE SHALL CONTAIN MARKINGS TO ALLOW CROSS REFERENCING OF THE PIPE SUPPLIED TO THE TEST RECORDS RECEIVED.

9. UNLESS OTHERWISE NOTED ON THE PLANS OR IN THE SPECIFICATIONS SACRIFICIAL ANODES SHALL BE INSTALLED ON ALL VALVES AND METALLIC FITTINGS USED WITH PVC WATER MAINS IN ACCORDANCE WITH VOLUME IV, STANDARD SPECIFICATIONS AND DETAILS FOR CONSTRUCTION. SEVENTEEN POUND MAGNESIUM ANODES SHALL BE INSTALLED ON ALL VALVES AND DUCTILE IRON FITTINGS INCLUDING RESTRAINTS AND HARNESSES. TWELVE (12) POUND ZINC ANODES SHALL BE INSTALLED ON ALL STAINLESS STEEL FITTINGS AND SADDLES USED WITH PVC MAINS. ALL "TEES" USED WITH PVC

MAINS SHALL BE DUCTILE IRON. 10. PROPER ASSEMBLY OF GASKETED PVC PIPE JOINTS: THE MANUFACTURER'S INSERTION LINE OF GASKETED PVC PIPE JOINTS INDICATES THE MAXIMUM DEPTH OF INSERTION OF THE SPIGOT INTO THE BELL. AFTER ASSEMBLY OF THE JOINT, THE INSERTIONLINE SHALL REMAIN VISIBLE. DUAL INSERTION LINES ON GASKETED PVC PIPE INDICATE HE MAXIMUM AND MINIMUM DEPTH OF INSERTION OF THE SPIGOT INTO THE BELL. THE CONTRACTOR SHALL NOT OVER INSERT OR OVER HOME THE SPIGOT INTO

11. ALL CHANGES IN HORIZONTAL AND VERTICAL DIRECTION OF PVC WATER PIPE SHALL BE MADE WITH STANDARD BENDS, 5-DEGREE SWEEPS OR HIGH DEFLECTION (HD) COUPLINGS. NO BENDING OF THE PIPE OR DEFLECTING OF PVC PIPE JOINTS IS PERMITTED. WHERE HIGH DEFLECTION COUPLINGS OR 5-DEGREE SWEEPS ARE PERMITTED, THE CONTRACTOR SHALL PROVIDE ONE FULL PIPE LENGTH (20-FOOT LONG) ON EITHER SIDE OF THE HIGH DEFLECTION COUPLING OR 5-DEGREE SWEEP. THE CONTRACTOR SHALL USE A VIBRATORY PLATE COMPACTOR OR OTHER APPROVED MEANS TO THOROUGHLY COMPACT THE #57 STONE ON BOTH SIDES OF THE HIGH DEFLECTION COUPLING OR 5-DEGREE SWEEP, TAKING CARE NOT TO USE COMPACTION EQUIPMENT DIRECTLY OVER THE FITTING.

PVC HIGH DEFLECTION COUPLINGS SHALL BE LIMITED TO A TOTAL DEFLECTION OF 3-DEGREES (1 } DEGREE ON EITHER END OF THE COUPLING), SHALL BE RATED FOR A MINIMUM 200 PSI MEETING THE REQUIREMENTS OF AWWA C900, SHALL HAVE A MINIMUM LAY LENGTH OF 9-INCHES AND SHALL HAVE CENTER STOPS. PVC HIGH DEFLECTION COUPLINGS SHALL BE CERTAINTEED PVC HIGH DEFLECTION (HD) STOP COUPLINGS OR EQUAL.

5-DEGREE SWEEPS SHALL BE BELL BY SPIGOT, RATED FOR A MINIMUM 225 PSI, DR18 MEETING THE REQUIREMENTS OF AWWA C900 AND SHALL BE MULTI FITTINGS (IPEX) BLUE BRUTE DR18 OR EQUAL. 12. WHEN PVC HIGH DEFLECTION COUPLINGS OR PVC 5-DEGREE SWEEPS ARE USED TO FACILITATE CHANGES IN HORIZONTAL OR VERTICAL ALIGNMENTS OF AWWA C-900 PVC PIPELINES, THE CONTRACTOR SHALL INSTALL DEVICESFOR THE PREVENTION OF OVER-INSERTION OF THE PVC PIPE SPIGOTS OR PLAIN ENDS INTO THE PUSH ON BELL JOINT ON BOTH SIDES OF THE HIGH DEFLECTION COUPLINGS AND 5 DEGREE SWEEPS. BELL STOPS SHALL BE PLACED AT THE PROPER INSERTION LINE FOR THE FITTING. THE BELL STOP SHALL BE MANUFACTURED OF DUCTILE IRON AND INCORPORATE AN EXPANSION RETENTION SPRING TO ALLOW FOR PIPE EXPANSION AND CONTRACTION. THE BELL STOPS SHALL BE SERIES 5000 MEGA-STOP, AS MANUFACTURED BY EBAA IRON, INC. OR APPROVED EQUAL.

13. ALL WATER HOUSE CONNECTIONS ARE TO BE 1.5" WITH 1" METER. SINGLE WHC'S SHALL COMPLY WITH W-3.28 AND TWIN WHC'S SHALL COMPLY WITH W-3.32.

PART III SEWER

1. ALL SEWER MAINS SHALL BE D.I.P. OR P.V.C. UNLESS OTHERWISE NOTED.

2. ALL MANHOLES SHALL BE 4'-0" INSIDE DIAMETER UNLESS OTHERWISE NOTED.

3. FORCE MAINS SHALL BE PVC ONLY. 4. MANHOLES SHOWN WITH 12" AND 16" WALLS ARE FOR BRICK MANHOLES ONLY. 5. MANHOLES DESIGNATED W.T. IN PLAN AND PROFILE SHALL HAVE WATERTIGHT FRAME AND COVER, STANDARD DETAIL G5.52. WHERE WATERTIGHT MANHOLE FRAMES AND COVERS ARE USED, SET TOP OF FRAME 1'-6" ABOVE FINISHED GRADE UNLESS OTHERWISE NOTED ON THE DRAWINGS.


THIS PLAN IS APPROVED FOR SOIL EROSION AND SEDIMENT

IOWARD SOIL CONSERVATION DISTRICT

6. HOUSE(S) WITH THE SYMBOL "C.N.S." INDICATES THAT CELLAR CANNOT BE SERVED.

SEDIMENT CONTROL MEASURES FOR THIS CONTRACT WILL BE IMPLEMENTED IN ACCORDANCE WITH SECTION 308 OF THE HOWARD COUNTY STANDARD SPECIFICATIONS AND AS PER SDP-24-017

TROTTER'S RETREAT-PHASE 2 PUBLIC WATER AND SEWER DRAWINGS CONTRACT NO. 34-5244-D

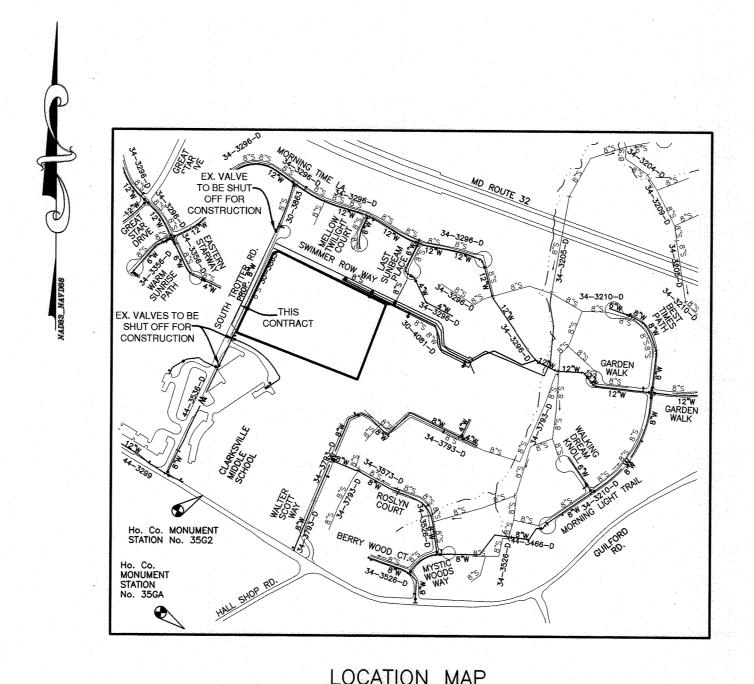

TYPE OF BUILDING:_	SINGLE FAMILY DETAC
NUMBER OF UNITS: .	
NUMBER OF SHC'S:	
NUMBER OF WHC'S:	
	MIDDLE PATU
TREATMENT PLANT _	LITTLE PATUXENT
	630 \

	SHEET INDEX	
NO.	DESCRIPTION	
1	TITLE SHEET	
2	PLAN AND PROFILE	
	TEMPORARY WATER SERVICE	

ADDRESS WATER CONTRACT # 6535 S. TROTTER ROAD 44-3536-D


DESIGN MANUAL WAIVER DMV2-24-002 TO VOLUME II SECTION 4.3.B.3.b TO WAIVE CELLAR SERVICE VIA GRAVITY TO UNITS 17 thru 25 HAS BEEN GRANTED BY THE HOWARD COUNTY DPW DATED AUGUST 31, 2023.

NOTES:

1. ALL WATER HOUSE CONNECTIONS ARE TO BE 1.5" WITH A 1" METER (OUTSIDE SETTING), PER DETAIL W-3.28.

2. ALL TWIN WHC'S SHALL COMPLY WITH W-3.32


3. THESE PROPERTIES WERE INCORPORATED INTO THE METROPOLITAN DISTRICT ON MAY 1, 2023.

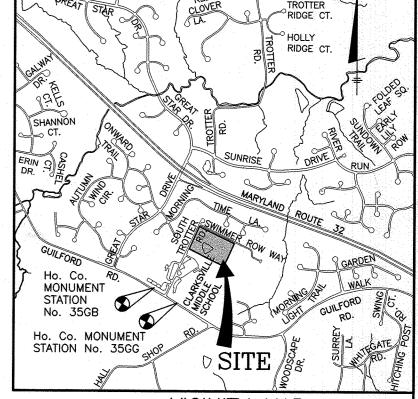

VICINITY MAP

BENCH MARKS-(NAD'83) 365GG EL.477.962 DISC SET ON TOP OF CONCRETE COLUMN GILFORD ROAD NEAR TROTTER ROAD. N 554358.875 E 1333834.183 35GB EL.464.651 DISC SET ON TOP OF CONCRETE COLUMN CORNER GUILFORD ROAD AND TROTTER N 554740.098 E 1333317.635

LEGEND

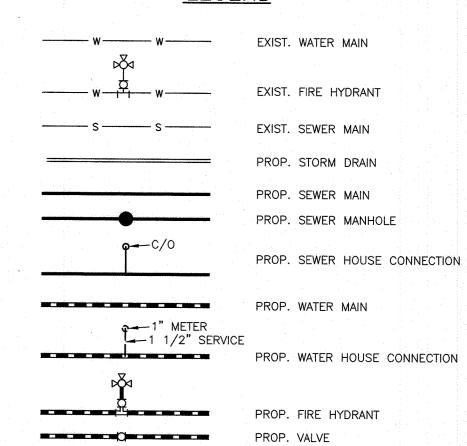

CONTROL BY THE HOWARD SOIL CONSERVATION DISTRICT.

QUANTITIES AS-BUILT **QUANTITIES** ITEMS ESTIMATED QUANTITIES TYPE MANUF./SUPPLIER 8" PVC C900 DR-18 WATER 6" FIRE HYDRANT, TEE, & VALVE 1 EA 1.5" COPPER WHO 4 EA 4" PVC SHC 168 LF NAME OF UTILITY CONTRACTOR: SURVEY AND DRAFTING DIVISION AS-BUILT DATE:

> OWNER/DEVELOPER: SOUTH TROTTER LLC 9693 GERWIG LANE, SUITE L COLUMBIA, MD 21046 410-792-2565

Professional Certification. I hereby certify that these documents were prepared or approved by me, and that I am a duly licensed professional engineer under the laws of the State of Maryland, License No. 28376, Expiration Date: 1-1-2025.

DEPARTMENT OF PLANNING AND ZONING

BENCHMARK ● ENGINEERS ▲ LAND SURVEYORS ▲ PLANNERS ENGINEERING, INC. 3300 N. RIDGE ROAD A SUITE 140 A ELLICOTT CITY, MARYLAND 21043 (P) 410-465-6105 (F) 410-465-6644



DES:	AAM/JCO				 -			
-								EINIAI
DRAFT:	: AAM/JCO							FINAL
					-	-		PUBLIC WATER AND SEWER
CHK:	AAM					-		PLANS
DATE:	AUG							
DAIL.	2024	BY	NO.		REVISIONS		DATE	600 SCALE MAP #16 BLOCK:11&17

TROTTER'S RETREAT-PHASE 2 SCOTT PROPERTY, LOTS 1 AND 2 6479 & 6485 SOUTH TROTTER ROAD

TAX MAP: 35 - GRID: 20 - PARCEL: 338 8 - ZONED: R-20 - ELECTION DISTRICT NO. 53 CONTRACT NO. 34-5244-D

AS SHOWN SHEET NO. 1 OF 2

SCALE:


DEPARTMENT OF PUBLIC WORKS


HOWARD COUNTY, MARYLAND

HOWARD COUNTY, MARYLAND

WWW.BEI-CIVILENGINEERING.COM

		-	WATER	LINE DATA	A CHART			
APPURTENA		ATERLINE STATION		LOCATION			COMMENT	
1/8 HB	0	+04	N 5555	521.49 E 13	33889.24			
1/8 HB)+41	N 5555	556.21 E 13	33876.40			
8"X6" TEE FOR	R FH 3	+80	N 5558	365.90 E 13	34015.42			
	WATER	SERVICE	AS-BUIL	T LOCATION	N TABLE			
LOT	ADDRESS		OCATION DIME	NSION #1	LOCATIO	n dimension	#2	
	S. TROTTER ROAD							
	S. TROTTER ROAD		·	<u> </u>	4	· · · · · · · · · · · · · · · · · · ·		
	S. TROTTER ROAD				1			
	S. TROTTER ROAD S. TROTTER ROAD					-,		
	S. TROTTER ROAD		 					
	S. TROTTER ROAD			::	 	 	· .	
	S. TROTTER ROAD		··········			····		
24 6475 25 6471 SEQUENCI	s. TROTTER ROAD s. TROTTER ROAD E OF CONS	TRUCTIO					STALLATI	ION:
24 6475 25 6471 SEQUENCE	S. TROTTER ROAD S. TROTTER ROAD E OF CONS	TRUCTION TEMPO	RARY SE	RVICE INT			STALLATI	ION:
24 6475 25 6471 SEQUENCI	S. TROTTER ROAD S. TROTTER ROAD E OF CONS	TRUCTION TEMPO	RARY SE	RVICE INT			STALLATI	ION:
24 6475 25 6471 SEQUENCE	S. TROTTER ROAD S. TROTTER ROAD E OF CONS ADDRESS OF	TRUCTION TEMPORAS INDIC	RARY SE	RVICE INT	ERRUPTIO	N.		ION:
24 6475 25 6471 SEQUENCE 1. NOTIFY A 2. SHUT OF	S. TROTTER ROAD S. TROTTER ROAD E OF CONS ADDRESS OF F VALVES EXISTING OF	TRUCTION TEMPORE AS INDICE CAP AND	RARY SE ATED ON BUTTRES	RVICE INT I PLAN. SS AND I	ERRUPTIO	N. AN CONN	IECTION.	ION:
24 6475 25 6471 SEQUENCE 1. NOTIFY A 2. SHUT OF 3. REMOVE	S. TROTTER ROAD S. TROTTER ROAD E OF CONS ADDRESS OF F VALVES EXISTING OF	TRUCTION TEMPORE AS INDICE CAP AND	RARY SE ATED ON BUTTRES	RVICE INT I PLAN. SS AND I	ERRUPTIO	N. AN CONN	IECTION.	ION:
24 6475 25 6471 SEQUENCE 1. NOTIFY A 2. SHUT OF 3. REMOVE	S. TROTTER ROAD S. TROTTER ROAD E OF CONS ADDRESS OF F VALVES EXISTING OF	TRUCTION TEMPORE AS INDICE CAP AND	RARY SE ATED ON BUTTRES	RVICE INT I PLAN. SS AND I	ERRUPTIO	N. AN CONN	IECTION.	ION:
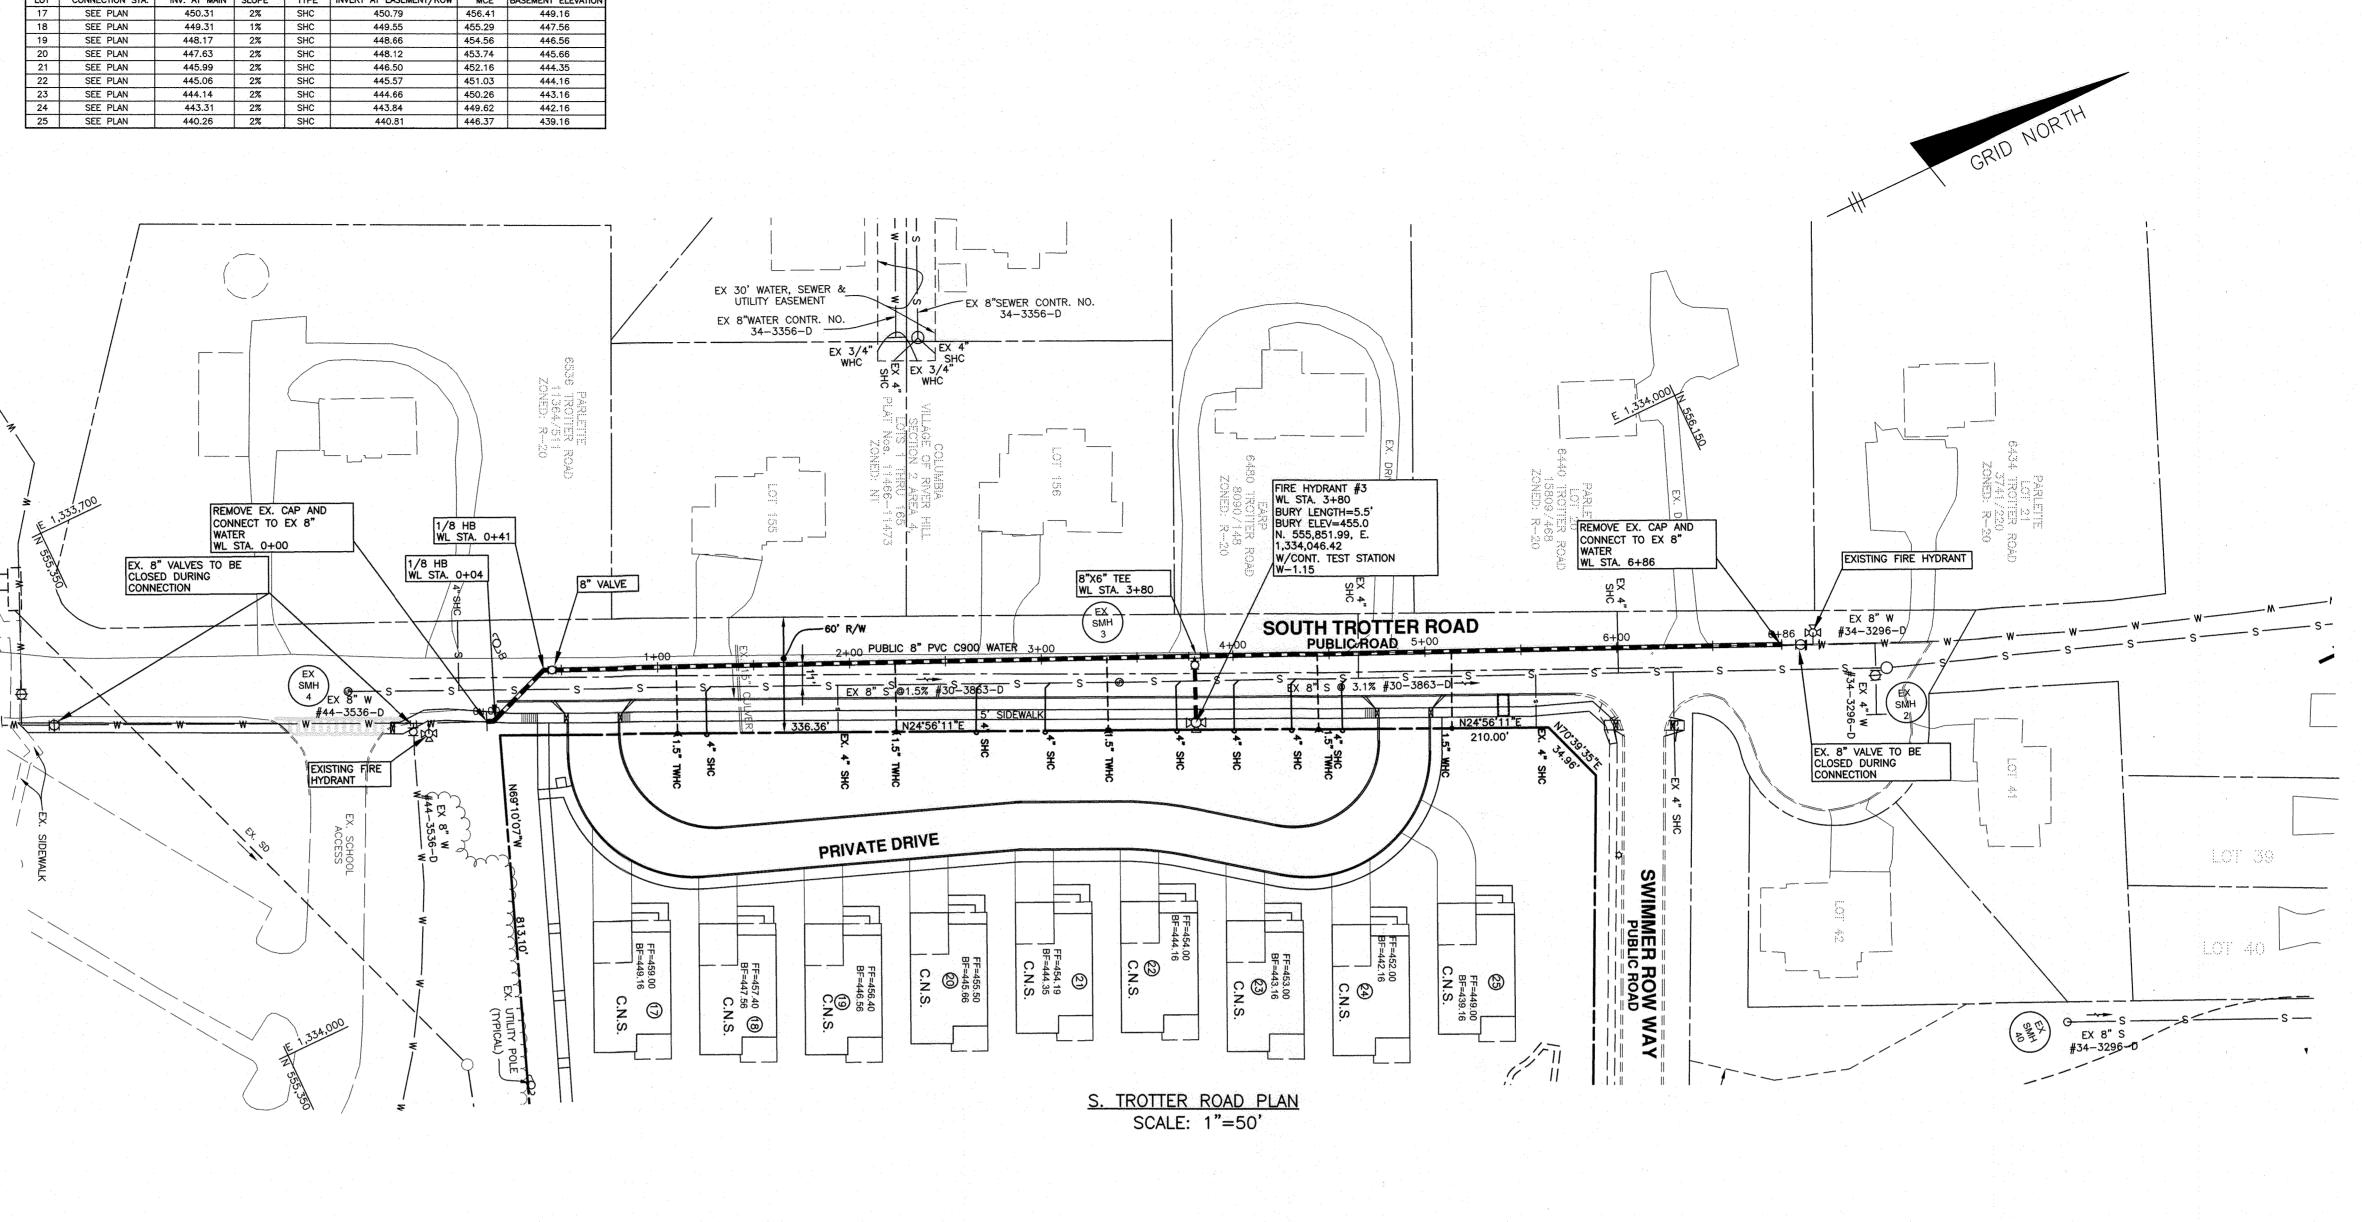

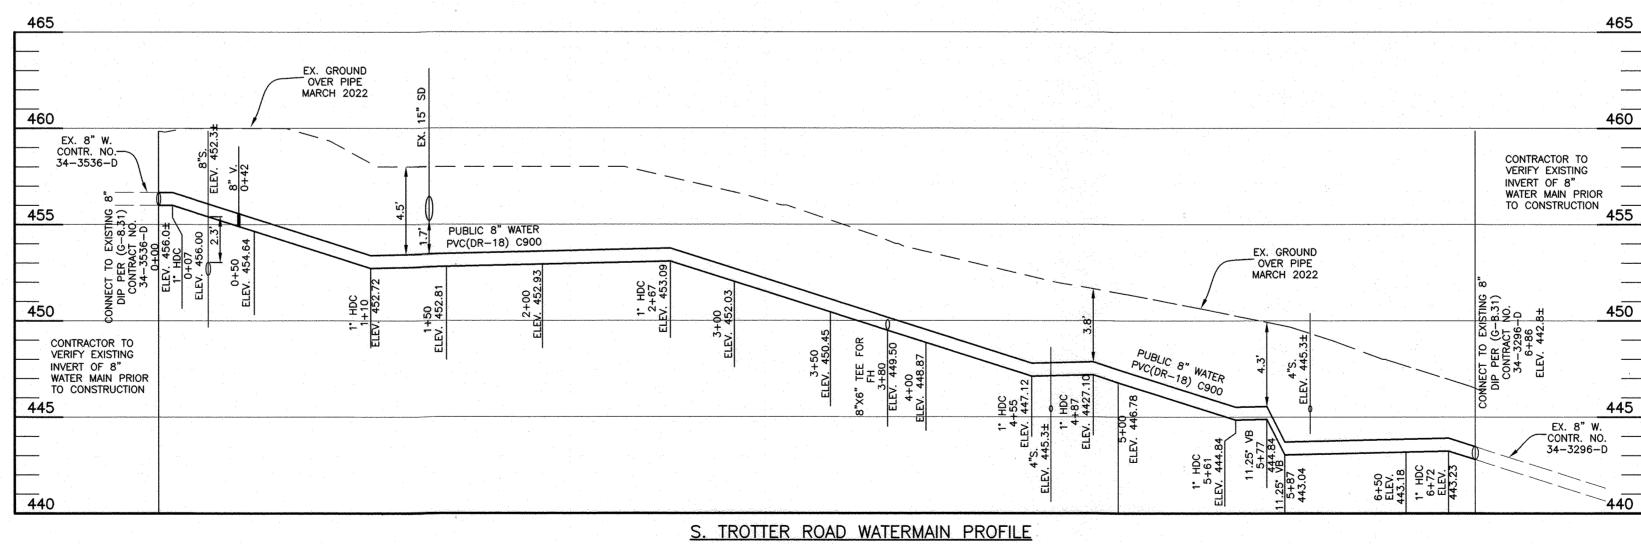

SCALE: 1"=50' HORIZ., 1"=5' VERT.

Professional Certification. I hereby certify that these documents were prepared or approved by me, and that I am a duly licensed professional engineer under the laws of the State of Maryland, License No. 28376, Expiration Date: 1-1-2025.

1 inch = 50 ft.

OWNER/DEVELOPER: SOUTH TROTTER LLC 9693 GERWIG LANE, SUITE L COLUMBIA, MD 21046 410-792-2565

DEPARTMENT OF PUBLIC WORKS HOWARD COUNTY, MARYLAND

DEPARTMENT OF PLANNING AND ZONING HOWARD COUNTY, MARYLAND

BENCHMARK ENGINEERS ▲ LAND SURVEYORS ▲ PLANNERS ENGINEERING, INC 3300 N. RIDGE ROAD ▲ SUITE 140 ▲ ELLICOTT CITY, MARYLAND 21043 (P) 410-465-6105 (F) 410-465-6644 WWW.BEI-CIVILENGINEERING.COM

SEWER HOUSE CONNECTION CHART

PROFILE PROFILE	OF MARY CE A. MI 28376 SONAL EN	WEER ON THE
PROTES	28376 S/ONAL EN	NIN SER
	manually.	

ATE: AUG 2024	BY	NO.	REVISIONS		DATE	600 SCALE MAP #16 BLOCK:11&
ATT. 1110 0004						
HK: AAM] PLAN
RAFT: AAM/JCO						PUBLIC WATER AND SEWER
					-	FINAL
S: AAM/JCO				1.		

TROTTER'S RETREAT-PHASE 2 A RESUBDIVISION OF SCOTT PROPERTY, LOTS 1 AND 2

6479 & 6485 SOUTH TROTTER ROAD TAX MAP: 35 - GRID: 20 - PARCEL: 338 8 - ZONED: R-20 - ELECTION DISTRICT NO. 53 $CONTRACT\ NO.\ 34-5244-D$

BLOCK:11&17

AS SHOWN SHEET NO. 2 OF 2

SCALE: