

## HOWARD COUNTY DEPARTMENT OF PUBLIC WORKS

CAPITAL PROJECT NO. S-6698 CONTRACT NO. 10-5070

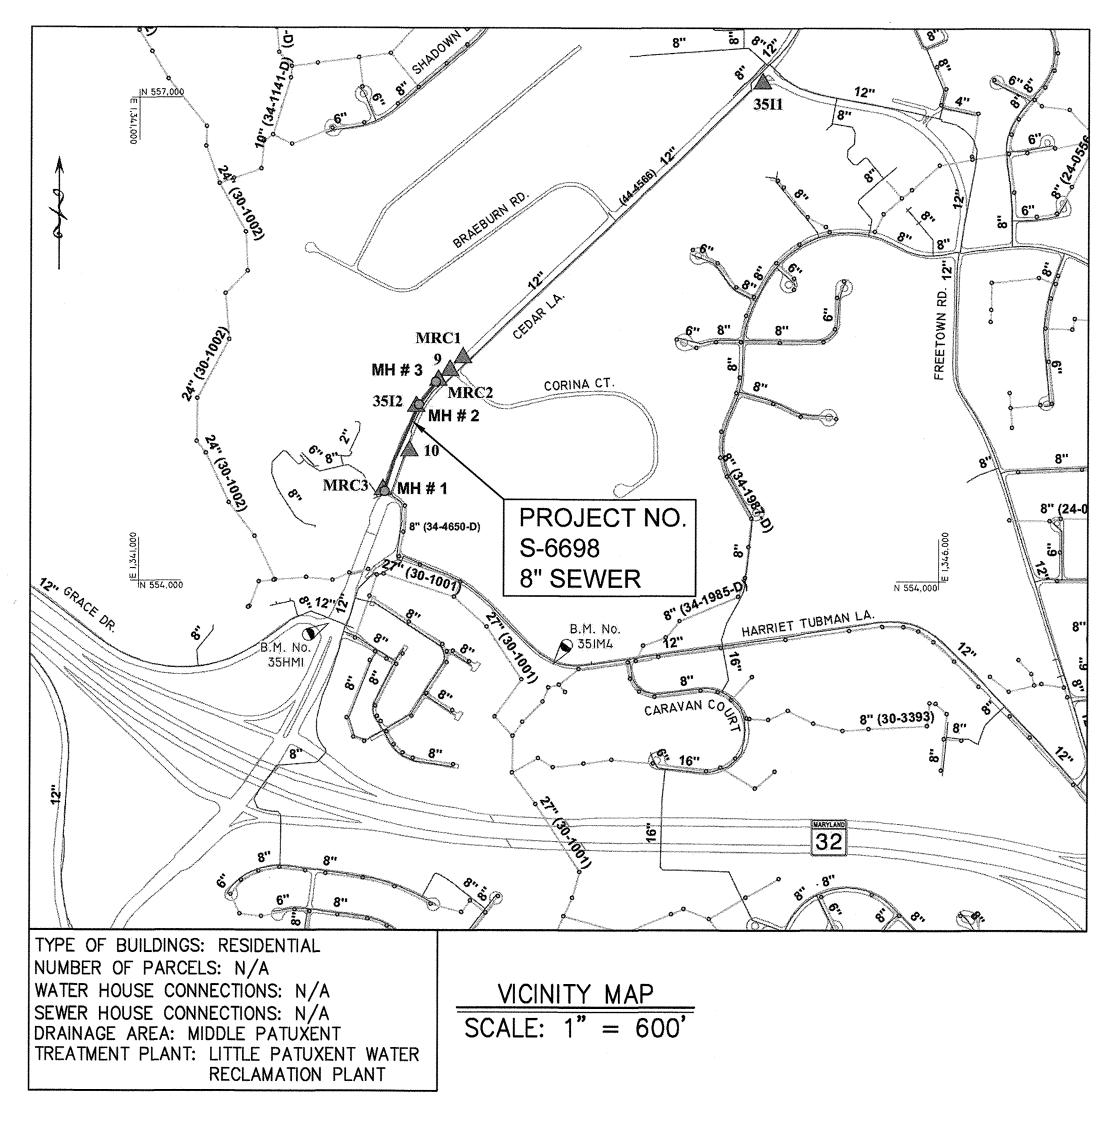

PROJECT PURPOSE: THE OWNERS OF 6610 CEDAR LANE AND 6636 CEDAR LANE REQUESTED TO HOWARD COUNTY THAT PUBLIC SEWER SERVICE BE EXTENDED TO THEIR PROPERTIES. SINCE THESE PROPERTIES ARE ELIGIBLE FOR PUBLIC SEWER SERVICE, HOWARD COUNTY WILL CONSTRUCT THIS SEWER EXTENSION. FUTURE EXTENSIONS MAY BE BUILT TO CONNECT ADDITIONAL PROPERTIES THAT ARE CURRENTLY UNDEVELOPED OR SERVED BY SEPTIC SYSTEMS TO THE PUBLIC SEWER SYSTEM. THESE PROPERTIES ARE LOCATED ALONG CEDAR LANE, CORINA COURT AND BRAEBURN ROAD.

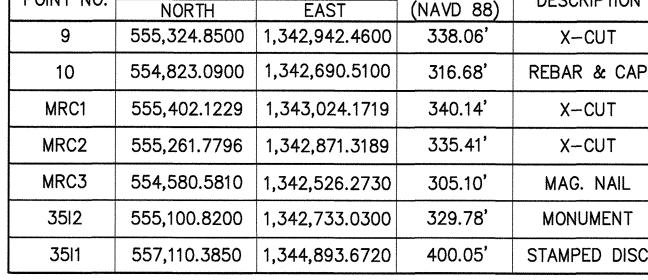

RESTORATION SCHEDULE				
LOCATION	DISTANCE	TYPE		
CEDAR LANE	720'	HMA PAVEMENT		

INDEX OF SHEETS

### SHEET DESCRIPTION

GENERAL - TITLE SHEET

HSCD STANDARD NOTES, ABBREVIATIONS AND LEGEND CEDAR LANE 8" SEWER PLAN & PROFILE

EROSION AND SEDIMENT CONTROL PLAN AND PAVEMENT RESTORATION MAINTENANCE OF TRAFFIC PLAN, GENERAL NOTES AND MDSHA STANDARDS

DEC 11, 2018 1"=2,000' JUNE 29, 2018

PROJECT NO. S-6698 CONTRACT NO. 10-5070

CEDAR LANE SEWER EXTENSION

AME OF UTILITY CONTRACTOR:	UTILIT	IES UNLIN	11760				
RVEY AND DRAFTING DIVISION AS-BUILT DATE: 12-11-2018							
ITEM	ESTIMATED QUANTITY		AS-BUILT				
		QUANTITY	TYPE	MANUFACTURER/SUPPLIER			
8" PVC SEWER	715 LF	725	SOR-35	FERGUSON			
48" MANHOLE	3 EA	3	CONCRETE	ATLANTIC			
8" x 4" WYE BRANCH	2 EA	2.	PVC	FERGUSON			
4" SHC	50 LF	77	SDR- 35	NOTE: INCLUDES STANDPIPES FERGUSON			
CLEANOUT	2 EA	2	garrine	HORNE CONCRETE			

48" MANHOLE 3 EA		3	CONCRETE	ATLANTIC	
8" x 4"	WYE BRANCH	2 EA	2.	PVC	FERGUSON
4	4" SHC	50 LF	77	SDR-35	NOTE: INCLUDES STAND FERGUSON
CLEANOUT 2 EA			2	gazeria.	HORNE CONCRETE
	SUR	VEY CONTR	OL		
OINT NO. COORDINATES  NORTH EAST			ELEVATION (NAVD 88		J
9	555,324.8500 1,342,942.4600		338.06	X-CUT	
40	EE 4 007 0000	1 740 600 5100	740.00	DEDAR & CA	

3 EA	<u> </u>	CONCRETE	AILANIIC	
2 EA	2	PVC	FERGUSON	
50 LF	77	SDR- 35	NOTE: INCLUDES STANDPIPES FERGUSON	
2 EA	2	gusta	HORNE CONCRETE	
		,		
SURVEY CONTROL				
	2 EA 50 LF 2 EA	2 EA 2 50 LF 77 2 EA 2	2 EA 2 PVC 50 LF 77 SDR-35 2 EA 2 -	

# Expiration: 03/31/2019

Map Copyright (c) ADC The Map People, 800-829-627 Permit Use Number 21003214

LOCATION MAP SCALE: 1" = 2000'

# QUANTITIES

POINT NO.	COORDINATES NORTH EAST		ELEVATION (NAVD 88)	DESCRIPTION	
9	NORTH		338.06	V OUT	
9	555,324.8500	1,342,942.4600	336.06	X-CUT	
10	554,823.0900	1,342,690.5100	316.68'	REBAR & CAP	
MRC1	555,402.1229	1,343,024.1719	340.14'	X-CUT	
MRC2	555,261.7796	1,342,871.3189	335.41'	X-CUT	
MRC3	554,580.5810	1,342,526.2730	305.10'	MAG. NAIL	
3512	555,100.8200	1,342,733.0300	329.78'	MONUMENT	
3511	557,110.3850	1,344,893.6720	400.05'	STAMPED DISC	

RESTORATION SCHEDULE					
LOCATION	DISTANCE	TYPE			
CEDAR LANE	720'	HMA PAVEMENT			

### THE DOWNSTREAM SIDE OF THE TRENCH. ALL SOIL SHALL BE STORED ON THE UPHILL SIDE OF THE TRENCH.

BY THE DEVELOPER:

CHIEF, BUREAU OF UTILITIES

I/WE CERTIFY THAT ALL DEVELOPMENT AND CONSTRUCTION WILL BE DONE ACCORDING TO THIS PLAN, AND THAT ANY RESPONSIBLE PERSONNEL INVOLVED IN THE CONSTRUCTION PROJECT WILL HAVE A CERTIFICATE OF ATTENDANCE AT A DEPARTMENT OF THE ENVIRONMENT APPROVED TRAINING PROGRAM FOR THE CONTROL OF SEDIMENT AND EROSION BEFORE BEGINNING THE PROJECT. I ALSO AUTHORIZE PERIODIC ON-SITE INSPECTIONS BY THE HOWARD SOIL CONSERVATION DISTRICT.

DPW requirements per Section 18.114(a) of the Howard County Code.

based on the lines and grades shown on the contract drawings.

DEVELOPER

### BY THE ENGINEER


THAT THIS PLAN FOR EROSION AND SEDIMENT CONTROL REPRESENTS A PRACTICAL AND WORKABLE PLAN BASED ON MY PERSONAL KNOWLEDGE OF THE SITE CONDITIONS AND THAT IT WAS PREPARED IN ACCORDANCE WITH THE REQUIREMENTS OF THE HOWARD SOIL CONSERVATION DISTRICT.

7-12-2018 DATE

7-05-2018

PROFESSIONAL CERTIFICATION: I HEREBY CERTIFY THAT THESE DOCUMENTS WERE PREPARED OR APPROVED BY ME, AND THAT I AM A DULY LICENSED PROFESSIONAL ENGINEER UNDER THE LAWS OF THE STATE OF MARYLAND,

LICENSE NO. 200456, EXPIRATION DATE 9-3-2019RUMMEL, KLEPPER & KAHL, LLF

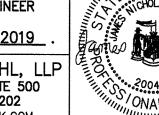

OF MARLINI		JNK	٠.	,,,,	
Concholas of The Control of the Cont		······································	EFG		AS-B
OF MAPLING	DRN:	SCP		7.	
	CHK:	JNK			
0. 200456 .	DATE:				
""IIIIIIIIIIIIIII"	6-2	5-2018			

REVISION 12-11-2

TITLE SHEET

SHEET NO. 1 OF 5

SCALE

AS SHOWN

DEPARTMENT OF PUBLIC WORKS HOWARD COUNTY, MARYLAND

**GENERAL NOTES** 

Approximate locations of existing utilities are shown. The Contractor shall take all necessary precautions to protect existing utilities and services and maintain uninterrupted service. Any damage incurred shall be

repaired immediately to the satisfaction of the Engineer by the Contractor at the Contractor's expense.

Maryland State Reference System NAD 83/91A and NAVD88 as projected by Howard County Geodetic

Control Station 3511 (Stamped disc in island intersection Cedar Lane and Freetown Road) and Howard County Benchmarks 35HM1 (Box cut on island curb intersection Cedar Lane and Grace Drive, Elevation

291.738) and 35IM4 (3/4" rebar 84.4' east of BGE Pole 108565, 4.5' south of Harriet Tubman Lane

5. Clear all utilities by a minimum of 12". Clear all BGE utility poles by 5'-0" minimum. The Owner has

contacted BGE and made arrangements for the bracing of poles if so required as indicated on the

Contractor. The Contractor shall coordinate with BGE to schedule the bracing of the utility poles. 6. For details not shown on the drawings or described in the contract documents and for materials and

for Construction (Latest Edition). The Contractor shall have a copy of Volume IV on the job.

All existing utilities shall be test pitted/located as necessary and in advance of the proposed

the Contractor two (2) weeks in advance of construction operations at his own expense.

drawings. In the event the Contractor's work requires the bracing of additional poles, any cost incurred by the Owner for the bracing of additional poles or damages shall be deducted from money owed the

construction methods, use Howard County Design Manual Volume IV, Standard Specifications and Details

construction, in order to properly make all required utility crossings and/or connections. Any discrepancies

or utility conflicts shall be immediately reported to the Engineer. Where test pits have been made on

utilities in the vicinity of the proposed work for which test pits have not been dug shall be located by

1-800-252-1133

1-800-257-7777

1-800-743-0033/410-224-9210

410-637-8713

800-685-0123 410-313-4900

410-313-6728

410-313-6470

410-313-2300

existing utilities, they are noted by the symbol at the location of the test pit. A note or notes containing the results of the test pit or pits is included on the drawings or specifications. Existing

8. Contractor shall notify the following utility companies or agencies at least five (5) working days before

9. The Contractor shall notify the Howard County Bureau of Highways at 410-313-7450 at least five

working days before any open cut or boring/jacking operation in any County road for constructing any

The Contractor shall provide all necessary lines, grades and elevations. Cut Sheets shall be prepared

EROSION AND SEDIMENT CONTROL NARRATIVE

THIS PROJECT INVOLVES THE INSTALLATION OF A NEW SANITARY SEWER LINE, LOCATED ALMOST ENTIRELY UNDERNEATH AN EXISTING ROAD WAY. A SMALL PORTION OF THE WORK INVOLVES CONNECTING LATERAL

LINES TO THE SEWER, WHICH WILL BE OVER PERVIOUS SURFACE. THE WORK IS TO BE COMPLETED USING

SHOULD ONLY OPEN THE AMOUNT OF TRENCH THAT CAN BE BACKFILLED AND STABILIZED IN ONE DAY. IF

THE TRENCH IS TO BE OPEN FOR LONGER THAN ONE DAY, THE CONTRACTOR SHALL PLACE SILT FENCE ON

SAME-DAY STABILIZATION AS THE PRIMARY FORM OF EROSION AND SEDIMENT CONTROL. THE CONTRACTOR

water/sewer mains or house connections. The approval of these drawings will constitute compliance with

Horizontal and Vertical Survey Controls: The coordinates shown on the drawings are based on

All pipe elevations shown are invert elevations unless otherwise noted on the plans.

Topographic field surveys were performed in July 2017 by RK&K.

pavement edge and 14.8' west of guardrail, Elevation 265.395)

starting work shown on these plans:

Howard County Public Schools

(If during school times).

Environmental Services...

Howard County Bureau of

Howard County Emergency Communications/911 Center...

BGE - Contractor Services.....

BGE- Emergency .....

BALTIMORE, MARYLAND 21202

600' SCALE MAP NO. 35

FINAL (100%)

BLOCK NO. 17

**ELECTION DISTRICT NO. 5** 

HOWARD COUNTY, MARYLAND

AS-BUILT

MILES PER HOUR

PLAIN END

PROPOSED

POINT ON LINE

OVERHEAD UTILITIES

POINT OF CURVATURE

POINT OF INTERSECTION

POINT OF REVERSE CURVE

POINT OF TANGENCY

VERTICAL CURVATURE

POUNDS PER SQUARE INCH

POLYVINYL CHLORIDE OR POINT OF

POINT OF VERTICAL INTERSECTION

POINT OF VERTICAL TANGENCY

REINFORCED CONCRETE PIPE

SANITARY SEWER, SOUTH

UNDERGROUND UTILITIES

WATER (POTABLE), WEST

WATER HOUSE CONNECTION

STAINLESS STEEL

VERTICAL BEND

STATION

STANDARD

VERTICAL

SEWER HOUSE CONNECTION

POINT OF CONTINUOUS CURVE

ОН

PC

POL

PSI

**RCP** 

S.S.

STA.

STD.

UG

VB

VERT.

PROP.

SANITARY SEWER SANITARY SEWER MANHOLE PRESTRESSED CONCRETE CYLINDER PIPE BORING VACUUM TEST HOLE LIMITS OF DISTURBANCE

SANITARY SEWER

WATER

GAS

FENCE

**GUARDRAIL** 

**BENCKMARK** 

GAS METER

PROPERTY LINE

STORM DRAIN

SANITARY SEWER MANHOLE

WATER FIRE HYDRANT

STORM DRAIN INLET

OVERHEAD ELECTRIC

UNDERGROUND CABLE

CONTOURS (SURVEY, 1-FT)

CONTOURS (GIS, 2-FT)

TREE LINE OR WOODS

TRAVERSE CONTROL

UNDERGROUND ELECTRIC

UNDERGROUND FIBEROPTIC

LEGEND

**EXISTING** EX 8" S. CONTRACT NO. 34-4650 ---------- DHE----- DHE-----\_\_\_\_\_ UGE \_\_\_\_ -----FD-----------FD-------

A

BM 35I2

S

**PROPOSED** 8" S HOWARD SOIL CONSERVATION DISTRICT (HSCD) STANDARD SEDIMENT CONTROL NOTES

1. A PRECONSTRUCTION MEETING MUST OCCUR WITH THE HOWARD COUNTY DEPARTMENT OF PUBLIC WORKS, CONSTRUCTION INSPECTION DIVISION (CID), 410-313-1855 AFTER THE FUTURE LOD AND PROTECTED AREAS ARE MARKED CLEARLY IN THE FIELD. A MINIMUM OF 48 HOURS NOTICE TO CID MUST BE GIVEN AT THE FOLLOWING STAGES: PRIOR TO THE START OF EACH DISTURBANCE

• UPON COMPLETION OF THE INSTALLATION OF PERIMETER EROSION AND SEDIMENT CONTROLS, BUT BEFORE PROCEEDING WITH ANY OTHER EARTH DISTURBANCE OR GRADING

PRIOR TO THE START OF ANOTHER PHASE OF CONSTRUCTION OR OPENING OF ANOTHER GRADING UNIT.

PRIOR TO THE REMOVAL OR MODIFICATION OF SEDIMENT CONTROL PRACTICES.

OTHER BUILDING OR GRADING INSPECTION APPROVALS MAY NOT BE AUTHORIZED UNTIL THIS INITIAL APPROVAL BY THE INSPECTION AGENCY IS MADE. OTHER RELATED STATE AND FEDERAL PERMITS SHALL BE REFERENCED. TO ENSURE COORDINATION AND TO AVOID CONFLICTS WITH THIS PLAN.

- 2. ALL VEGETATIVE AND STRUCTURAL PRACTICES ARE TO BE INSTALLED ACCORDING TO THE PROVISIONS OF THIS PLAN AND ARE TO BE IN CONFORMANCE WITH THE MOST CURRENT MARYLAND STANDARDS AND SPECIFICATIONS FOR SOIL EROSION AND SEDIMENT CONTROL AND REVISIONS THERETO.
- 3. FOLLOWING INITIAL SOIL DISTURBANCE OR RE-DISTURBANCE, PERMANENT OR TEMPORARY STABILIZATION SHALL BE COMPLETED WITHIN: A) 3 CALENDAR DAYS FOR ALL PERIMETER SEDIMENT CONTROL STRUCTURES, DIKES, PERIMETER SLOPES AND ALL SLOPES GREATER THAN 3:1, B) 7 DAYS AS TO ALL OTHER DISTURBED OR GRADED AREAS ON THE PROJECT SITE.
- 4. ALL DISTURBED AREAS MUST BE STABILIZED WITHIN THE TIME PERIOD SPECIFIED ABOVE IN ACCORDANCE WITH THE 2011 MARYLAND STANDARDS AND SPECIFICATIONS FOR SOIL EROSION AND SEDIMENT CONTROL FOR PERMANENT SEEDING (SEC. B-4-5), TEMPORARY SEEDING (SEC. B-4-4) AND MULCHING (SEC. B-4-3). TEMPORARY STABILIZATION WITH MULCH ALONE CAN ONLY BE APPLIED BETWEEN THE FALL AND SPRING SEEDING DATES IF THE GROUND IS FROZEN. INCREMENTAL STABILIZATION (SEC. B-4-1) SPECIFICATIONS SHALL BE ENFORCED IN AREAS WITH > 15' OF CUT AND/OR FILL. STOCKPILES (SEC. B-4-8) IN EXCESS OF 20 FT. MUST BE BENCHED WITH STABLE OUTLET. ALL CONCENTRATED FLOW, STEEP SLOPE, AND HIGHLY ERODIBLE AREAS SHALL RECEIVE SOIL STABILIZATION MATTING (SEC. B-4-6).
- 5. ALL SEDIMENT CONTROL STRUCTURES ARE TO REMAIN IN PLACE AND ARE TO BE MAINTAINED IN OPERATIVE CONDITION UNTIL PERMISSION FOR THEIR REMOVAL HAS BEEN OBTAINED FROM THE HOWARD COUNTY SEDIMENT CONTROL INSPECTOR.
- 6. SITE ANALYSIS:

AREA DISTURBED: . . . . . . . . . . . . . . . . 0.19 ACRES AREA TO BE ROOFED OR PAVED: . . . . . . . . . . . . . . . . . 0.19 ACRES AREA TO BE VEGETATIVELY STABILIZED: . . . . . . . . . . . . . 0.00 ACRES OFFSITE WASTE/BORROW AREA LOCATION: . . . . . TO BE DETERMINED BY CONTRACTOR

- 7. ANY SEDIMENT CONTROL PRACTICE WHICH IS DISTURBED BY GRADING ACTIVITY FOR PLACEMENT OF UTILITIES MUST BE REPAIRED ON THE SAME DAY OF DISTURBANCE.
- 8. ADDITIONAL SEDIMENT CONTROL MUST BE PROVIDED, IF DEEMED NECESSARY BY THE HOWARD COUNTY SEDIMENT CONTROL INSPECTOR. THE SITE AND ALL CONTROLS SHALL BE INSPECTED BY THE CONTRACTOR WEEKLY. AND THE NEXT DAY AFTER EACH RAIN EVENT, A WRITTEN REPORT BY THE CONTRACTOR, MADE AVAILABLE UPON REQUEST, IS PART OF EVERY INSPECTION AND SHOULD INCLUDE: INSPECTION DATE
  - INSPECTION TYPE (ROUTINE, PRE-STORM EVENT, DURING RAIN EVENT)
  - NAME AND TITLE OF INSPECTOR
  - WEATHER INFORMATION (CURRENT CONDITIONS AS WELL AS TIME AND AMOUNT OF LAST RECORDED PRECIPITATION)
  - BRIEF DESCRIPTION OF PROJECT'S STATUS (E.G., PERCENT COMPLETE) AND/OR CURRENT ACTIVITIES
- EVIDENCE OF SEDIMENT DISCHARGES
- IDENTIFICATION OF SEDIMENT CONTROLS THAT REQUIRE MAINTENANCE
- IDENTIFICATION OF MISSING OR IMPROPERLY INSTALLED SEDIMENT CONTROLS COMPLIANCE STATUS REGARDING THE SEQUENCE OF CONSTRUCTION AND STABILIZATION REQUIREMENTS
- PHOTOGRAPHS
- MONITORING/SAMPLING
- MAINTENANCE AND/OR CORRECTIVE ACTION PERFORMED
- OTHER INSPECTION ITEMS AS REQUIRED BY THE GENERAL PERMIT FOR STORM ASSOCIATED WITH CONSTRUCTION ACTIVITIES (NPDES.
- 9. TRENCHES FOR THE CONSTRUCTION OF UTILITIES IS LIMITED TO THREE PIPE LENGTHS OR THAT WHICH SHALL BE BACKFILLED AND STABILIZED BY THE END OF EACH WORK DAY, WHICHEVER IS SHORTER.
- 10. ANY MAJOR CHANGES OR REVISIONS ON THE PLAN OR SEQUENCE OF CONSTRUCTION MUST BE REVIEWED AND APPROVED BY THE HSCD PRIOR TO PROCEEDING WITH CONSTRUCTION. MINOR REVISIONS MAY ALLOWED BY THE CID PER LIST OF HSCD-APPROVED FIELD CHANGES.
- 11. DISTURBANCE SHALL NOT OCCUR OUTSIDE THE LOD. A PROJECT IS TO BE SEQUENCED SO THAT GRADING ACTIVITIES BEGIN ON ONE GRADING UNIT (MAXIMUM ACREAGE OF 20 AC. PER GRADING UNIT) AT A TIME. WORK MAY PROCEED TO A SUBSEQUENT GRADING UNIT WHEN AT LEAST 50 PERCENT OF THE DISTURBED AREA IN THE PRÉCEDING GRADING UNIT HAS BEEN STABILIZED AND APPROVED BY THE CID. UNLESS OTHERWISE SPECIFIED AND APPROVED BY THE CID, NO MORE THAN 30 ACRES CUMULATIVELY MAY BE DISTURBED AT A GIVEN TIME.
- 12. WASH WATER FROM ANY EQUIPMENT. VEHICLES, WHEELS, PAVEMENT, AND OTHER SOURCES MUST BE TREATED IN A SEDIMENT BASIN OR OTHER APPROVED WASHOUT STRUCTURE.
- 13. TOPSOIL SHALL BE STOCKPILED AND PRESERVED ON-SITE FOR REDISTRIBUTION ONTO FINAL GRADE.
- 14. ALL SILT FENCE AND SUPER SILT FENCE SHALL BE PLACED ON-THE-CONTOUR, AND BE IMBRICATED AT 25' MINIMUM INTERVALS, WITH LOWER ANDS CURLED UPHILL BY 2' IN ELEVATION.
- 15. STREAM CHANNELS MUST NOT BE DISTURBED DURING THE FOLLOWING RESTRICTED TIME PERIODS (INCLUSIVE):
- USE I AND IP MARCH 1- JUNE 15
- USE III AND IIIP OCTOBER 1- APRIL 30
- USE IV MARCH 1 MAY 31

600' SCALE MAP NO. 35

16. A COPY OF THIS PLAN, THE 2011 MARYLAND STANDARDS AND SPECIFICATIONS FOR SOIL EROSION AND SEDIMENT CONTROL, AND ASSOCIATED PERMITS SHALL BE ON-SITE AND AVAILABLE WHEN THE SITE IS ACTIVE.

DEPARTMENT OF PUBLIC WORKS HOWARD COUNTY, MARYLAND

DATE

DIRECTØR OF PUBLIC WORKS

mald Cemple 1/5/2018

CHIEF, BUREAU OF UTILITIES / / DATE


Momas E. Butter 7/5/18 CHIEF, BUREAU OF ENGINEERING CHIEF. UTILITY DESIGN DIVISION WD

PROFESSIONAL CERTIFICATION: I HEREBY CERTIFY THAT THESE DOCUMENTS WERE PREPARED OR APPROVED BY ME, AND THAT I AM A DULY LICENSED PROFESSIONAL ENGINEER UNDER THE LAWS OF THE STATE OF MARYLAND. LICENSE NO. 200456 , EXPIRATION DATE 9-3-2019RUMMEL, KLEPPER & KAHL, LLP

700 EAST PRATT STREET, SUITE 500

BALTIMORE, MARYLAND 21202

(410) 728-2900 WWW.RKK.COM

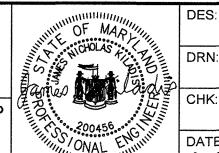

Manager 1	DES: JNK	BY	NO.	REVISION	DATE
7	DDM				
8:3 E	DRN: SCP				
Lagran	CHK: "				
	JNK				
Melini	DATE:				
'''''	DATE: 6-25-2018				

FINAL (100%) HSCD STANDARD NOTES,

ABBREVIATIONS AND LEGEND

PROJECT NO. S-6698 CONTRACT NO. 10-5070

CEDAR LANE SEWER EXTENSION


SHEET NO.

AS SHOWN

SCALE

2 OF 5

JUNE 25, 2018

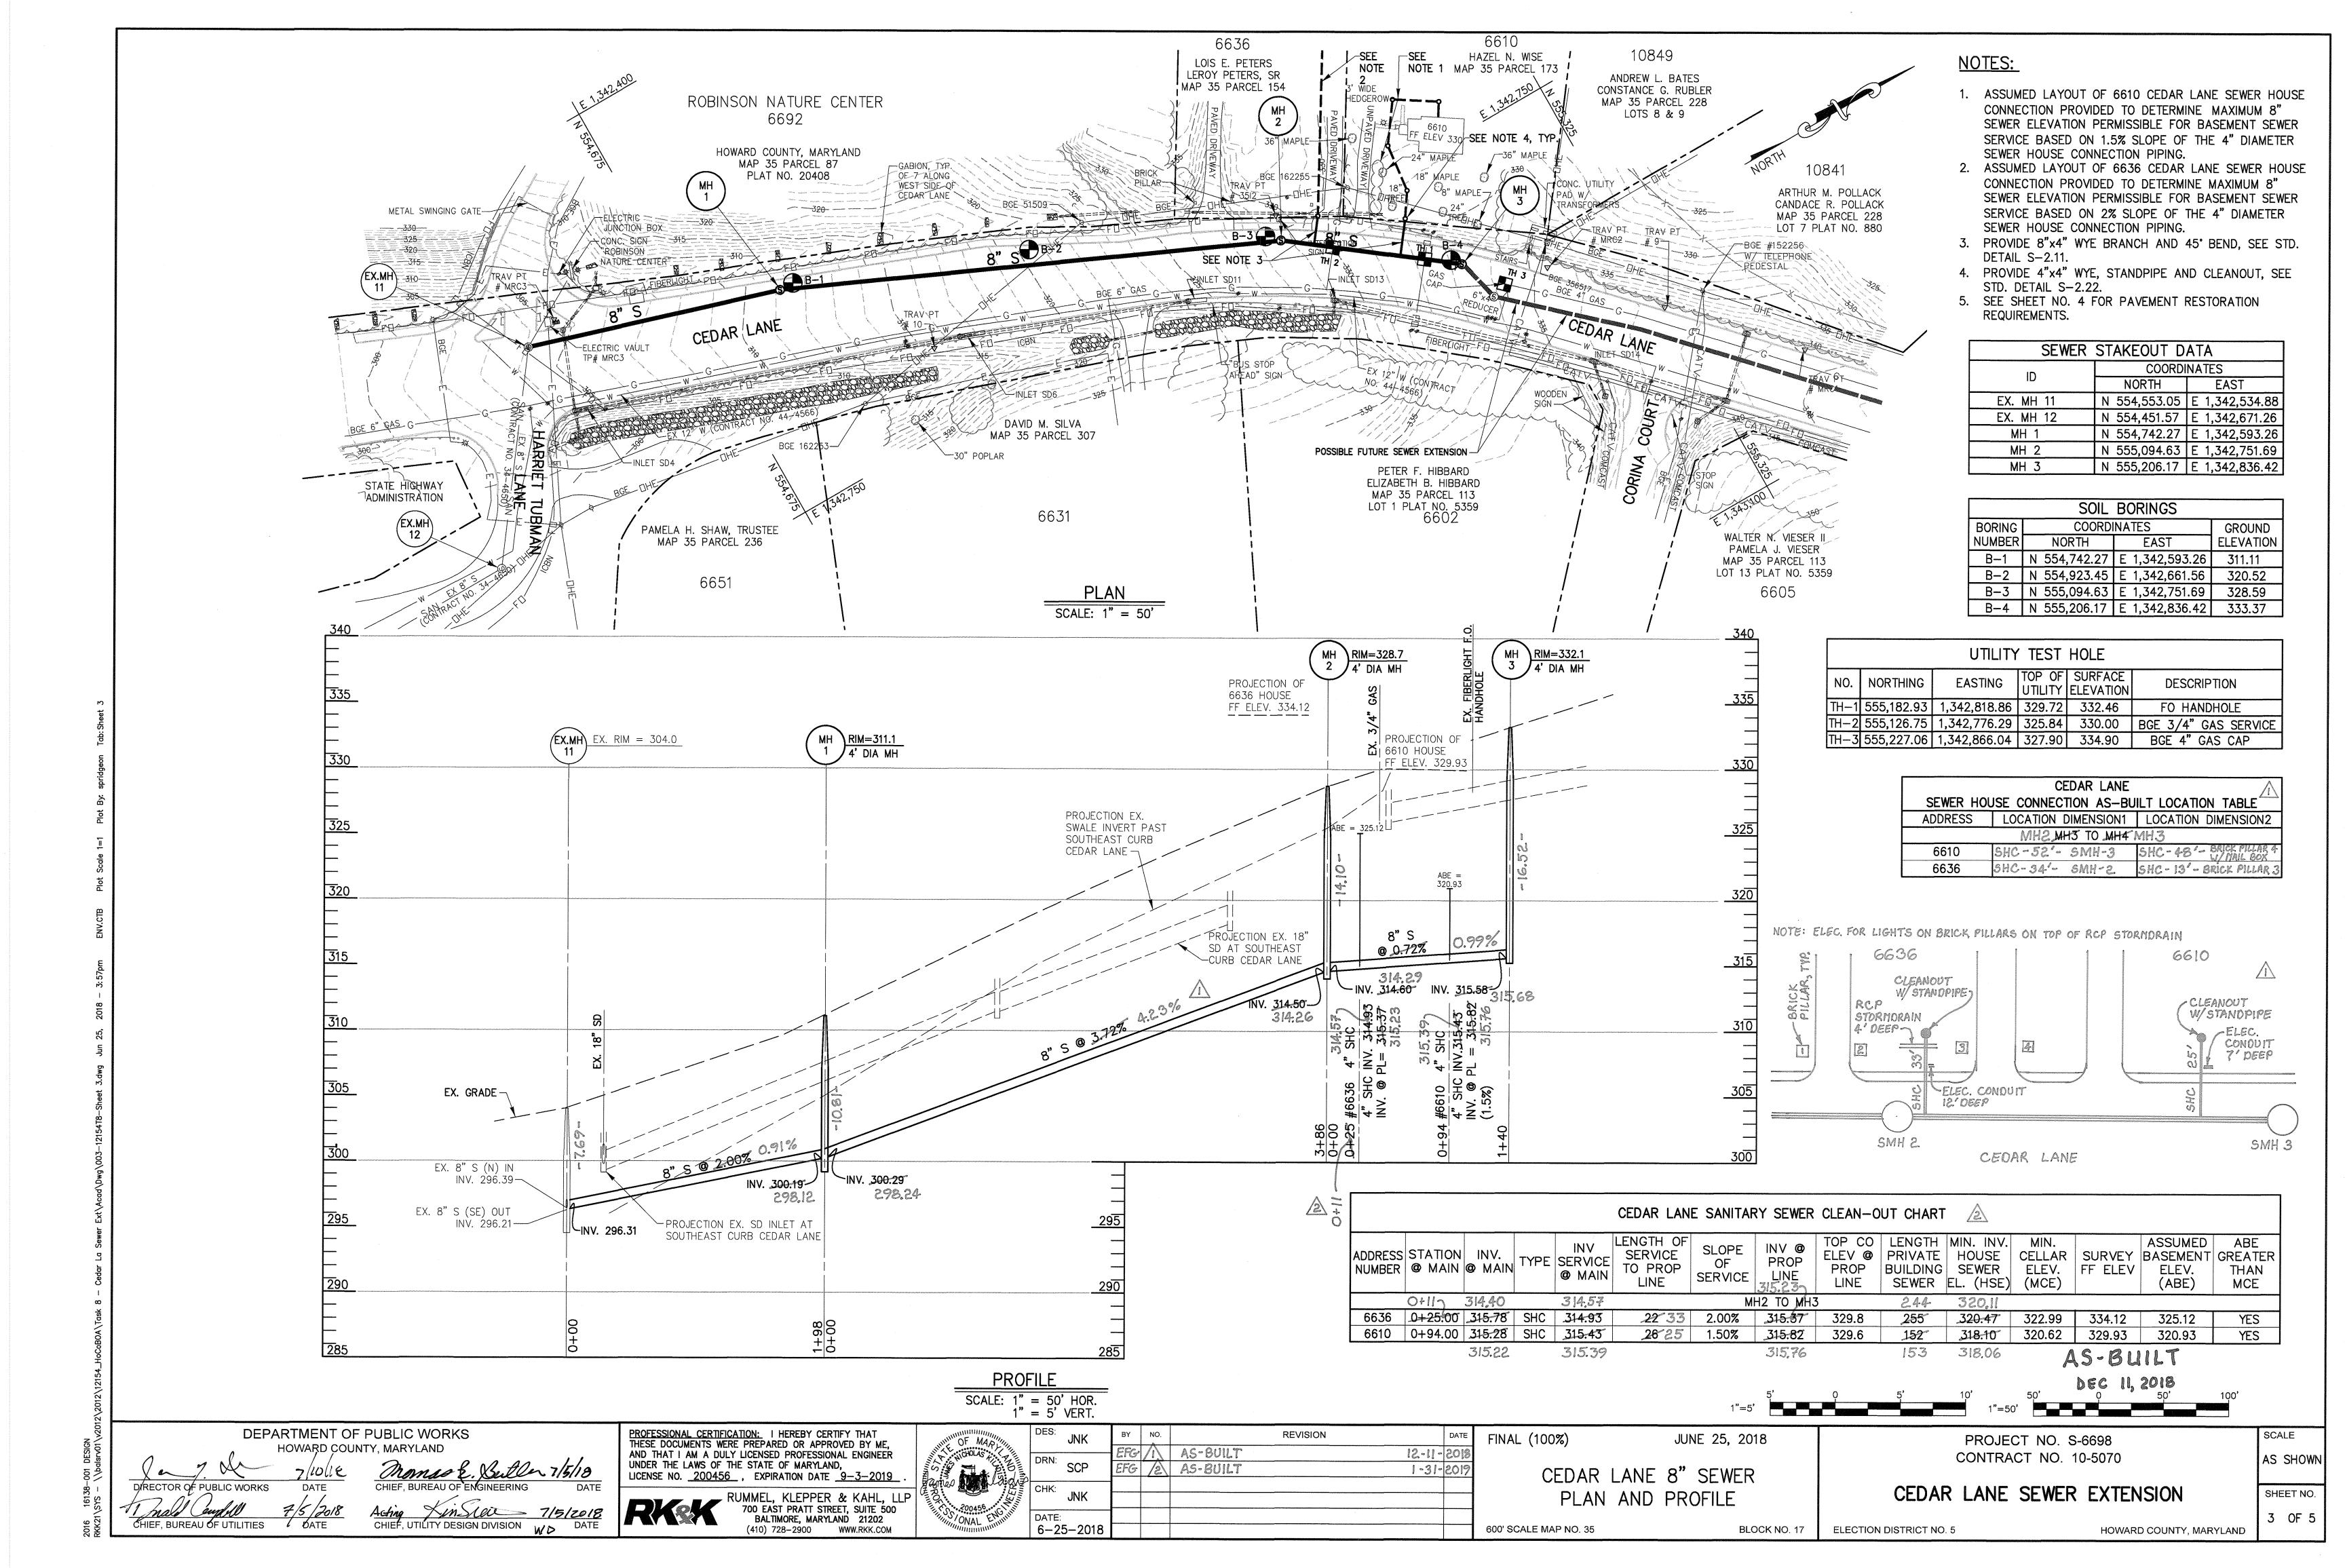

### SEQUENCE OF OPERATION

- 1. Howard County will schedule the Pre-construction Meeting. Notify the Howard County Construction Division (1-410-313-3800) at least 48 hours before commencing work. Work may not commence until the permittee or the responsible personnel have met on site with the County Sediment and Erosion Control Inspector to review the approved plans.
- 2. Contractor shall locate and procure all staging and stockpiling areas which shall be approved by the Project Inspector/Manager
- 3. With the approval of the County Sediment and Erosion Control Inspector, clear and grub the site.
- 4. Perform the following sequence for each day of utility construction operations:
- a. Excavate and install sanitary sewer and appurtenances. Place backfill and compact. Contractor should open only that section of trench that can be backfilled and stabilized each day. If trench must remain open longer than one day, silt fence shall be placed below (downslope of) the trench.
- b. Place spoil on uphill side of trench.
- c. Place topsoil, fine grade, seed and apply mulch to disturbed area.
- d. All roadways (Public & Private) are to be swept free of dirt and debris.
- e. Any sediment laden water resulting from dewatering operations shall be discharged through a portable sediment tank which will not be measured for payment but shall be considered incidental to project construction
- 5. Direct all water pumped during trench dewatering operations to an approved portable sediment tank. Clean out tank when one—third (1/3) filled with silt. Haul sediment to a Howard County approved site.
- 6. No excavated material shall be placed in the ditch adjacent to the existing roadway. The Contractor shall take precautions to prevent the disturbance of existing vegetated areas to the extent possible. Any existing vegetated areas disturbed as a result of the contractor's work operations shall be stabilized by the end of the work day.
- 7. Trenching is not to exceed that which can be backfilled and stabilized at the end of each working day. Stabilize the top of all trenches by the end of each work day. All excess stockpiled soil remaining after refilling of the trench shall be removed from the surface and hauled from the site by the end of the working day. The Contractor shall be responsible for obtaining all permits for his off—site stockpile areas. The Contractor shall also adequately clean all dirt and mud off the roadways by the end of each working day.
- 8. Stabilize any remaining disturbed areas as required, and complete permanent pavement restoration in accordance with the detail and notes on this sheet.
- Remove any remaining sediment controls after prior approval from Howard County Inspections and Permits Division. Fine grade and stabilize area formerly occupied by perimeter controls.

# 10" HMA PAVEMENT TRENCH REPAIR. (HOWARD COUNTY PAVING SECTION P-5, MINOR ARTERIAL ROADWAY) -2'-0" GRADED AGGREGATE BASE (GAB)-

### DETAIL - PERMANENT PAVEMENT RESTORATION SCALE: 1" = 2' - 0"

- 6" THICKNESS SUPERPAVE ASPHALT MIX BASE COURSE 19.0 MM, PG 64-22S, LEVEL 3 4-
- 2" MINIMUM THICKNESS SUPERPAVE ASPHALT MIX INTERMEDIATE COURSE 12.5 MM, PG 64-22S, LEVEL 3 4
- 2" THICKNESS SUPERPAVE ASPHALT MIX SURFACE COURSE 12.5 MM, PG 70-22, LEVEL 3 PG 76-22, LEVEL 2

### PAVEMENT RESTORATION NOTES


- CEDAR LANE IS A MINOR ARTERIAL ROADWAY WITH A FLEXIBLE PAVEMENT SURFACE. REFER TO STANDARD DETAILS G-4.01 AND R-2.02 FOR RESTORATION OF THE ROADWAY AFTER THE SEWER EXTENSION IS COMPLETE.
- 2. IN LOCATIONS SUCH AS AT THE THREE NEW MANHOLES, IF THE REMAINING EXISTING PAVEMENT BETWEEN THE PERMANENT PAVEMENT RESTORATION AND THE CURB IS LESS THAN 4 FEET WIDE, THE RESIDUAL PAVEMENT SHALL BE REMOVED IN ITS ENTIRETY AND REPLACED.

AS-BUILT DEC 11, 2018

DEPARTMENT OF PUBLIC WORKS HOWARD, COUNTY, MARYLAND

PROFESSIONAL CERTIFICATION: I HEREBY CERTIFY THAT THESE DOCUMENTS WERE PREPARED OR APPROVED BY ME, AND THAT I AM A DULY LICENSED PROFESSIONAL ENGINEER UNDER THE LAWS OF THE STATE OF MARYLAND, LICENSE NO. 200456, EXPIRATION DATE 9-3-2019.

(410) 728-2900 WWW.RKK.COM

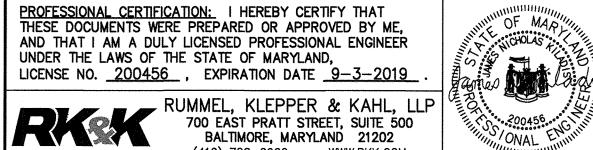

REVISION FG / AS-BUILT 3103-11-51 6-25-2018

FINAL (100%) JUNE 25, 2018 EROSION AND SEDIMENT CONTROL PLAN AND PAVEMENT RESTORATION

600' SCALE MAP NO. 35

PROJECT NO. S-6698 CONTRACT NO. 10-5070

CEDAR LANE SEWER EXTENSION

**ELECTION DISTRICT NO. 5** 

BLOCK NO. 17

CHIEF, BUREAU OF VIILITIES

SHEET NO. 4 OF 5 HOWARD COUNTY, MARYLAND

SCALE

AS SHOWN

TEMPORARY TRAFFIC CONTROL TYPICAL APPLICATION

IMPORTANT: THIS DRAWING SHALL BE USED IN

THERE SHALL BE A MINIMUM OF SEVEN CHANNELIZING DEVICES IN THE SHOULDER TAPER.

ADDITIONAL. ADJACENT LANE CLOSURES WHEN THE POSSIBILITY OF UNPLANNED TRAVELWAY ENCROACHMENTS EXISTS.

ARROW PANEL

SPECIFICATION CATEGORY CODE ITEMS

CHANNELIZING DEVICES

DIRECTION OF TRAFFI

NHOM QVOH QND OND OND 15 MIN-12 HRS. OR DAYTIME APPLICATIONS)

ROAD WORK 1/2 MILE

DIRECTOR - OFFICE OF TRAFFIC AND SAFETY

COMBINATION WITH THE GENERAL SHOTES MD 104.00-01 - MD 104.00-18 AND STANDARD DETAILS MD 104.01-01 - MD 104.01-81

OPTIONAL FOR 15 MIN-12 HRS. OR DAYTIME

OVER 12 HRS. OR NIGHTTIME USE

LANE CLOSED

EQL/LESS THAN 40 MPH

A FIELD INSPECTION OF TRAFFIC CONTROL DEVICES. CONTACT THE TRAFFIC DIVISION AT (410) 313-2430.


- ALL CONSTRUCTION AND MATERIALS FOR THE TRAFFIC CONTROL DEVICES SHALL BE IN ACCORDANCE WITH THE STANDARDS CONTAINED IN THE LATEST EDITION OF THE STATE OF MARYLAND MANUAL ON UNIFORM TRAFFIC CONTROL DEVICES.
- THE SIGNS DEPICTED ON THIS PLAN ARE FOR THE CEDAR LANE SEWER EXTENSION NORTH OF PROPOSED MANHOLE 1. THE SIGNS MARKED WITH AN ASTERISK ARE NOT REQUIRED FOR THE SEWER EXTENSION BETWEEN HARRIET TUBMAN DRIVE AND PROPOSED MANHOLE 1.
- 4. REFLECTORIZED CHANNELIZING DEVICES SHALL BE USED AT NIGHT ALONG THE CONSTRUCTION AREA.
- PAVEMENT DISRUPTIONS OF ONE INCH (1") OR GREATER SHALL BE RAMPED WITH A BEVELED EDGE OF FOUR HORIZONTAL TO ONE VERTICAL (4:1).
- THE CONTRACTOR SHALL BACKFILL THE TRENCH IMMEDIATELY AFTER THE INSTALLATION OF A SECTION OF PIPE. IF STEEL PLATES ARE TO BE USED, APPROPRIATE SIGNING WILL BE REQUIRED. STEEL PLATES MUST BE PINNED. STEEL PLATES ON ALL COUNTY ROADWAYS MUST BE RECESSED, AS MUST ALL STEEL PLATES TO BE PLACED FOR MORE THAN 24 HOURS BETWEEN DECEMBER 1st AND MARCH 15th. THE CONTRACTOR SHALL NOT LEAVE AN OPEN TRENCH UNATTENDED.
- CONTRACTOR SHALL INSTALL "CAUTION STEEL PLATES AHEAD" SIGNS W8-8(4) IN ADVANCE OF STEEL PLATE BRIDGING.
- ALL TEMPORARY SIGNS THAT DO NOT APPLY WHEN ROAD IS OPEN SHALL BE COVERED OR REMOVED, OR TURNED AWAY.
- 9. CHANNELIZING DEVICES SHALL BE REMOVED AT THE END OF EACH SHIFT.
- 10. ALL TRAFFIC CONTROL DEVICES SHALL BE KEPT IN THEIR PROPER POSITION AT ALL TIMES AND SHALL BE REPAIRED. REPLACED OR CLEANED AS NECESSARY TO PRESERVE THEIR APPEARANCE AND CONTINUITY.
- 11. ACCESS SHALL BE PROVIDED TO ALL EXISTING DRIVEWAYS AT ALL TIMES UNLESS COVERED BY THE APPROVED TRAFFIC CONTROL PLAN. CONTRACTOR SHALL COORDINATE ALL DRIVEWAY CONSTRUCTION WITH THE PROPERTY OWNER. ALL CONES AND FLAGMEN SHALL BE MOVED ACCORDINGLY AS CONSTRUCTION PROGRESSES.
- 12. ALL CONSTRUCTION SIGNING SHALL BE IN ACCORDANCE WITH THE TYPICAL SIGN PLACEMENT SHOWN ON THESE PLANS AND SHALL NOT OBSTRUCT EXISTING TRAFFIC CONTROL DEVICES.
- 13. ANY CHANGES TO THE MAINTENANCE OF TRAFFIC SHALL BE SUBMITTED TO THE TRAFFIC ENGINEERING DIVISION FOR REVIEW AND APPROVAL. REQUESTS FOR DETOURS AND ROAD CLOSURES SHALL BE SUBMITTED TO THE TRAFFIC DIVISION AT 410-313-2430 5 DAYS IN ADVANCE WITH A DETOUR PLAN FOR APPROVAL.
- . CONSTRUCTION & WORKER'S VEHICLES SHALL NOT BE PARKED IN A MANNER THAT WILL IMPEDE TRAFFIC OR IMPAIR SIGHT DISTANCE. THESE VEHICLES SHOULD BE PARKED OFF-STREET ON THE CONSTRUCTION SITE OR ON A SIDE STREET NOT UNDER CONSTRUCTION.
- 5. FLAGGERS SHALL BE CERTIFIED AND SHALL HAVE THEIR CERTIFIED FLAGGER CARD WITH THEM AT ALL TIMES DURING FLAGGING OPERATIONS.
- 16. CONTRACTOR WORK HOURS WITH LANE CLOSURES ARE RESTRICTED TO 9AM TO 3PM MONDAY THROUGH FRIDAY. WORK REQUEST ANY OTHER TIME MUST BE SUBMITTED TO THE TRAFFIC DIVISION AT LEAST 48 HOURS IN ADVANCE.
- 17. CONTRACTOR'S TRAFFIC MANAGER MUST HAVE A MDSHA TEMPORARY TRAFFIC CONTROL MANAGER'S TRAINING COURSE CARD




DEPARTMENT OF PUBLIC WORKS HOWARD COUNTY, MARYLAND (Lc 7. Ommas E. Dutle 1/5/18 DIRECTO'R OF PUBLIC WORKS CHIEF, BUREAU OF UTILITIES

PROFESSIONAL CERTIFICATION: I HEREBY CERTIFY THAT THESE DOCUMENTS WERE PREPARED OR APPROVED BY ME, AND THAT I AM A DULY LICENSED PROFESSIONAL ENGINEER UNDER THE LAWS OF THE STATE OF MARYLAND, LICENSE NO. 200456 , EXPIRATION DATE 9-3-2019

RUMMEL, KLEPPER & KAHL, LLP
700 EAST PRATT STREET, SUITE 500
BALTIMORE MARKET (410) 728-2900 WWW.RKK.COM

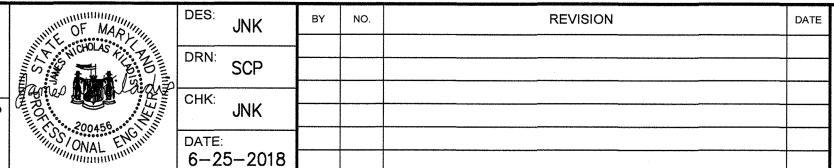

STANDARD NO.

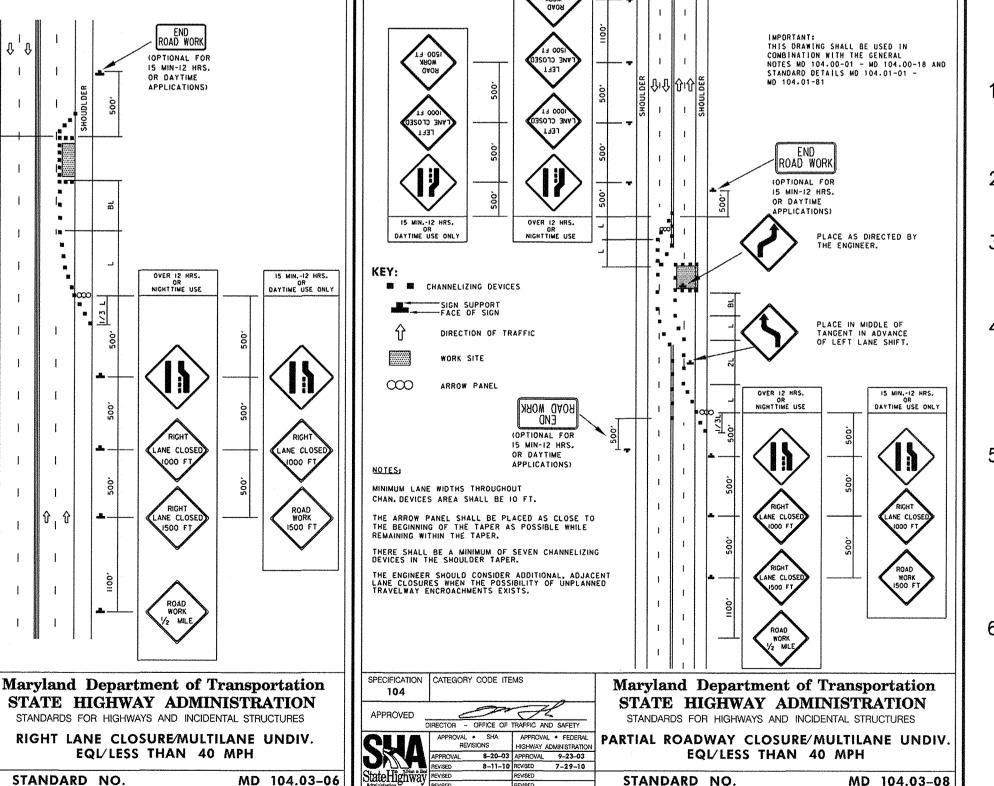

FINAL (100%)

600' SCALE MAP NO. 35

MD 104.03-08

BLOCK NO. 17

**ELECTION DISTRICT NO. 5** 

JUNE 25, 2018

MAINTENANCE OF TRAFFIC PLAN,

GENERAL NOTES AND MDSHA

**STANDARDS** 

TEMPORARY TRAFFIC CONTROL TYPICAL APPLICATION

### MAINTENANCE OF TRAFFIC AND SEQUENCE OF CONSTRUCTION

- THE CEDAR LANE SEWER EXTENSION INSTALLATION WILL PROCEED NORTHERLY FROM HARRIET TUBMAN DRIVE TOWARD CORINA COURT.
- 2. THE CONTRACTOR WILL USE A 100-FOOT LONG "FLOATING" WORK ZONE TO COMPLETE THE SEWER CONSTRUCTION.
- 3. CEDAR LANE IS GENERALLY 5 LANES WIDE WITH A CENTER LEFT LANE BETWEEN THE MIDDLE PATUXENT RIVER BRIDGE AND BRAEBURN ROAD.
- 4. FOR THE SEWER EXTENSION BETWEEN HARRIET TUBMAN LANE AND PROPOSED MANHOLE 1, NORTHBOUND CEDAR LANE TRAFFIC SHALL NOT BE AFFECTED. AND THE TEMPORARY TRAFFIC CONTROL APPLICATION SHALL CONFORM TO MDSHA STANDARD NO. 104.03-06 SHOWN ON THIS SHEET.
- FOR THE SEWER EXTENSION NORTH OF PROPOSED MANHOLE 1. ONE 10-FOOT WIDE MINIMUM TRAVEL LANE IN EACH DIRECTION SHALL BE MAINTAINED ALONG THE EAST SIDE OF CEDAR LANE THROUGH THE WORK ZONE USING CHANNELIZING DEVICES. THE TEMPORARY TRAFFIC CONTROL APPLICATION SHALL CONFORM TO MDSHA STANDARD No. 104-03-08 SHOWN ON THIS SHEET.
- PLACE PORTABLE VARIABLE MESSAGE SIGNS (PVMS) 10 DAYS PRIOR TO THE START OF CONSTRUCTION. THE SOUTHBOUND SIGN SHALL BE PLACED IMMEDIATELY NORTH OF THE CORINA COURT INTERSECTION. THE NORTHBOUND SIGN SHALL BE PLACED IMMEDIATELY SOUTH OF THE HARRIET TUBMAN LANE INTERSECTION. HOWARD COUNTY WILL DETERMINE THE MESSAGES TO BE PLACED ON THE PVMS.



PROJECT NO. S-6698 CONTRACT NO. 10-5070

CEDAR LANE SEWER EXTENSION

HOWARD COUNTY, MARYLAND

SCALE

AS SHOWN

SHEET NO.

5 OF 5