GENERAL NOTES

- APPROXIMATE LOCATIONS OF EXISTING MAINS ARE SHOWN. THE CONTRACTOR SHALL TAKE ALL NECESSARY PRECAUTIONS TO PROTECT EXISTING MAINS AND SERVICES AND MAINTAIN UNINTERRUPTED SERVICE. ANY DAMAGE INCURRED SHALL BE REPAIRED IMMEDIATELY TO THE
- SATISFACTION OF THE ENGINEER AT THE CONTRACTOR'S EXPENSE. TOPOGRAPHIC FIELD SURVEYS WERE PERFORMED ON OCTOBER 2011 BY SHANABERGER AND LANE THE COORDINATES ON THE DRAWINGS ARE BASED ON THE MARYLAND STATE REFERENCE SYSTEM NAD '83/91' AS PROJECTED BY HOWARD COUNTY GEODETIC CONTROL STATIONS NO.16IB AND NO.
- 4. ALL VERTICAL CONTROLS ARE BASED ON NAVD '88. VERTICAL CONTROLS PROVIDED ON THE DRAWINGS ARE CONCRETE MONUMENTS.
- 5. ALL PIPE ELEVATIONS SHOWN ARE INVERT ELEVATIONS UNLESS OTHERWISE NOTED ON THE PLANS CLEAR ALL UTILITIES BY A MINIMUM OF 12 INCHES. CLEAR ALL POLES BY 5'-0" MINIMUM OR TUNNEL AS REQUIRED UNLESS OTHERWISE NOTED. THE OWNER HAS CONTACTED THE UTILITY COMPANIES AND HAS MADE ARRANGEMENTS FOR BRACING OF POLES AS SHOWN ON THE DRAWINGS. IN THE EVENT THE CONTRACTOR'S WORK REQUIRES THE BRACING OF ADDITIONAL POLES, ANY COST INCURRED BY THE OWNER FOR THE BRACING OF ADDITIONAL POLES OR DAMAGES SHALL BE DEDUCTED FROM MONIES OWED BY THE CONTRACTOR. THE CONTRACTOR SHALL COORDINATE
- WITH THE UTILITY COMPANIES TO SCHEDULE THE BRACING OF THE POLES. 7. ALL WATER HOUSE CONNECTIONS SHALL BE FOR INSIDE METER SETTING UNLESS OTHERWISE
- NOTED ON PLANS OR IN SPECIFICATIONS. 8. FOR SPRINKLER SYSTEM FOR ALL TOWN HOMES OR MULTI-FAMILY DWELLING UNITS SHOULD HAVE A MINIMUM OF 1' CONNECTION WITH A 3/4" METER.
- 9. FOR DETAILS NOT SHOWN ON THE DRAWING, AND FOR MATERIALS AND CONSTRUCTION METHODS, USE HOWARD COUNTY DESIGN MANUAL, VOLUME IV, STANDARD SPECIFICATIONS AND DETAILS FOR CONSTRUCTION (LATEST EDITION). THE CONTRACTOR SHALL HAVE A COPY OF VOLUME IV ON THE
- 10. WHERE TEST PITS HAVE BEEN MADE ON EXISTING UTILITIES, THEY ARE NOTED BY THE SYMBOL & AT THE LOCATIONS OF THE TEST PITS. A NOTE OR NOTES CONTAINING THE RESULTS OF THE TEST PIT OR PITS IN INCLUDED ON THE DRAWINGS. EXISTING UTILITIES IN THE VICINITY OF THE PROPOSED WORK FOR WHICH TEST PITS HAVE NOT BEEN DUG SHALL BE LOCATED BY THE CONTRACTOR TWO
- WEEKS IN ADVANCE OF CONSTRUCTION OPERATIONS AT HIS OWN EXPENSE. 11. THE CONTRACTOR SHALL NOTIFY THE FOLLOWING UTILITY COMPANIES OR AGENCIES AT LEAST FIVE WORKING DAYS BEFORE STARTING WORK SHOWN ON THESE PLANS:

BGE (CONSTRUCTION SERVICES) BGE (EMERGENCY)

410-685-1400

COLONIAL PIPELINE COMPANY MISS UTILITY STATE HIGHWAY ADMINISTRATION 410-531-5533 1-800-743-0033 / 410-224-9210

- 12. TREES AND SHRUBS ARE TO BE PROTECTED FROM DAMAGE TO THE MAXIMUM EXTENT. TREES AND SHRUBS LOCATED WITHIN THE CONSTRUCTION STRIP ARE NOT TO BE REMOVED OR DAMAGED BY
- 13. THE CONTRACTOR SHALL REMOVE TREES, STUMPS, AND ROOTS ALONG THE LINE OF EXCAVATION. PAYMENT FOR SUCH REMOVAL SHALL BE INCLUDED IN THE UNIT PRICE BID FOR CONSTRUCTION OF
- 14. THE CONTRACTOR SHALL NOTIFY THE BUREAU OF HIGHWAYS, HOWARD COUNTY, AT (410)313-7450 AT LEAST 5 WORKING DAYS BEFORE OPEN CUTTING OR BORING/JACKING OF ANY COUNTY ROAD FOR LAYING WATER/SEWER MAINS OR HOUSE CONNECTIONS. THE APPROVAL OF THESE DRAWINGS WILL CONSTITUTE COMPLIANCE WITH DPW REQUIREMENTS PER SECTION 18.114(a) OF THE HOWARD


STANDARD WATER MAIN GENERAL NOTES

- ALL WATER MAINS TO BE D.I.P. CLASS 54 UNLESS OTHERWISE NOTED.
- TOPS OF ALL WATER MAINS TO HAVE A MINIMUM OF 3'-6" OF COVER UNLESS NOTED OTHERWISE. VALVES ADJACENT TO TEES SHALL BE STRAPPED TO TEES.
- 4. ALL FITTING SHALL BE BUTTRESSED OR ANCHORED WITH CONCRETE IN ACCORDANCE WITH THE STANDARD DETAILS UNLESS OTHERWISE PROVIDED FOR ON THE DRAWINGS. FIRE HYDRANTS SHALL BE SET TO THE BURY LINE ELEVATIONS SHOWN ON THE DRAWINGS. ALL FIRE
- HYDRANTS SHALL BE RESTRAINED AND BUTTRESSED WITH CONCRETE IN ACCORDANCE WITH THE STANDARD DETAILS. THE SOIL AROUND THE FIRE HYDRANT SHALL BE COMPACTED IN ACCORDANCE WITH SECTION 1000 AND 1005 OF THE STANDARD SPECIFICATIONS. THE CONTRACTOR SHALL NOT OPERATE ANY WATER MAIN VALVES ON THE EXISTING WATER SYSTEM.
- TRACER WIRE AND CONTINUITY TEST STATIONS SHALL BE INSTALLED ON ALL DIP AND PVC WATER MAINS IN ACCORDANCE WITH THE HOWARD COUNTY DESIGN MANUAL FOR PVC WATER MAINS ALL RECORDS FOR THE QUALITY CONTROL AND QUALIFICATIONS TEST REQUIREMENTS NOTED IN SECTION 5.1 OF THE AWWA STANDARD C900 FOR PVC PRESSURE PIPES
- APPROVAL OF THE MATERIAL FOR USE THE TEST RECORDS SHALL BE FOR THE PIPE TO BE INSTALLED UNDER THIS CONTRACT. ALL PVC PIPE SHALL CONTAIN MARKINGS TO ALLOW CROSS REFERENCING OF THE PIPE SUPPLIED TO THE TEST RECORDS RECEIVED. UNLESS OTHERWISE NOTED ON THE PLANS OR IN THE SPECIFICATIONS, SACRIFICIAL ANODES SHALL BE INSTALLED ON ALL VALVES AND METALLIC FITTINGS USED WITH PVC WATER MAINS IN
- ACCORDANCE WITH VOLUME IV STANDARD SPECIFICATIONS AND DETAILS FOR CONSTRUCTION. 1 POUND MAGNESIUM ANODES SHALL BE INSTALLED ON ALL VALVES AND DUCTILE IRON FITTING INCLUDING RESTRAINTS AND HARNESSES. 12 POUND ZINC ANODES SHALL BE INSTALLED ON ALL STAINLESS STEEL FITTINGS AND SADDLES USED WITH PVC MAINS. ALL "TEES" USED WITH PVC MAINS
- 10. PROPER ASSEMBLY OF GASKETED PVC PIPE JOINTS: THE MANUFACTURER'S INSERTION LINE OF GASKETED PVC PIPE JOINTS INDICATES THE MAXIMUM DEPTH OF INSERTION OF THE SPIGOT INTO THE BELL. AFTER ASSEMBLY OF THE JOINT, THE INSERTION LINE SHALL REMAIN VISIBLE. DUAL INSERTION LINES ON GASKETED PVC PIPE INDICATE THE MAXIMUM AND MINIMUM DEPTH OF INSERTION OF THE SPIGOT INTO THE BELL. THE CONTRACTOR SHALL NOT OVER INSERT OR OVER HOME THE SPIGOT INTO THE BELL OF THE PVC PIPE.
- 11. ALL CHANGES IN HORIZONTAL OR VERTICAL DIRECTION OF PVC WATER PIPE SHALL BE MADE WITH STANDARD BENDS, 5-DEGREE SWEEPS OR HIGH DEFLECTION (HD) COUPLINGS. NO BENDING OF THE PIPE OR DEFLECTION OF PVC PIPE JOINTS IN PERMITTED. WHERE HIGH DEFLECTION COUPLINGS OR 5-DEGREE SWEEPS ARE PERMITTED, THE CONTRACTOR SHALL PROVIDE ONE FULL PIPE LENGTH (20-FOOT LONG) ON EITHER SIDE OF THE HIGH DEFLECTION COUPLING OR 5-DEGREE SWEEP. THE CONTRACTOR SHALL USE A VIBRATORY PLATE COMPACTOR OR OTHER APPROVED MEANS TO THOROUGHLY COMPACT THE #57 STONE ON BOTH SIDES OF THE HIGH DEFECTION COUPLING OR 5-DEGREE SWEEP, TAKING CARE NOT TO USE COMPACTION EQUIPMENT DIRECTLY OVER THE FITTING. PVC HIGH DEFLECTION COUPLINGS SHALL BE LIMITED TO A TOTAL DEFLECTION OF 3-DEGREES (1-1/2 DEGREE ON EITHER END OF THE COUPLING), SHALL BE RATED FOR A MINIMUM 200 PSI MEETING THE REQUIREMENTS OF AWWA C900, SHALL HAVE A MINIMUM LENGTH OF 9-INCHES AND SHALL HAVE CENTER STOPS. PVC HIGH DEFLECTION COUPLINGS SHALL BE CERTAINTEED PVC HIGH DEFLECTION (HD) STOP COUPLINGS OR EQUAL
- WHEN PVC HIGH DEFLECTION COUPLINGS OR PVC 5-DEGREE SWEEPS ARE USED TO FACILITATE CHANGES IN HORIZONTAL OR VERTICAL ALIGNMENTS OF AWWA C-900 PVC PIPELINES, THE CONTRACTOR SHALL INSTALL DEVICES FOR THE PREVENTION OF OVER-INSERTION OF THE PVC PIPE SPIGOTS OR PLAIN ENDS INTO THE PUSH ON BELL JOINT ON BOTH SIDES OF THE HIGH DEFLECTION COUPLINGS AND 5-DEGRED SWEEPS. BELL STOPS SHALL BE PLACED AT THE PROPER INSERTION LINE FOR THE FITTING. THE BELL STOP SHALL BE MANUFACTURED OF DUCTILE IRON AND INCORPORATES AN EXPANSION RETENTION SPRING TO ALLOW FOR PIPE EXPANSION AND CONTRACTION. THE BELLS STOPS SHALL BE SERIES 5000 MEGA-STOP AS MANUFACTURED BY EBAA IRON, INC., OR APPROVED


PUBLIC WATER PLAN

WATERLOO FIRE STATION

CONTRACT NO. 44-5037-D

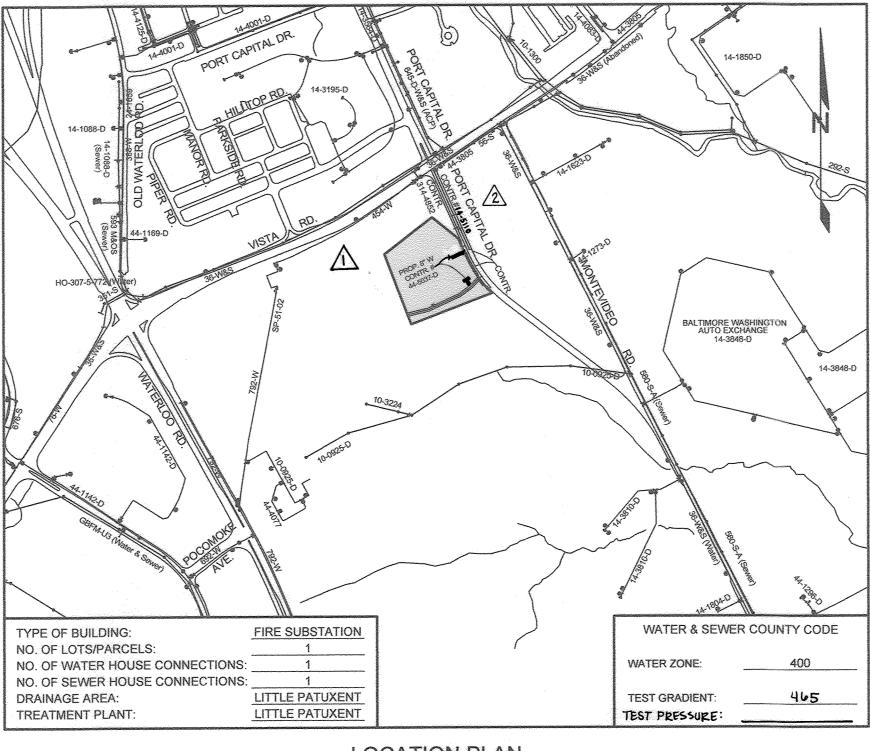


LOCATION PLAN

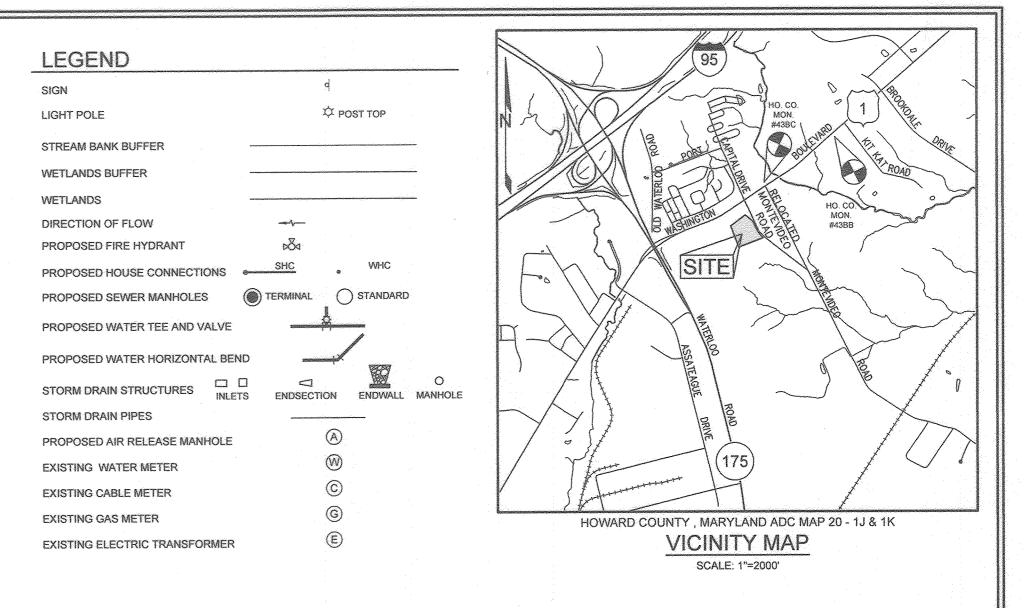

BENCHMARKS				
NUMBER	NORTHING	EASTING	ELEVATION	DESCRIPTION
43BC	549,592.106	1,375,466.623	214.07	SOUTH SIDE OF US ROUTE 1 AND MONTEVIDEO ROAD INTERSECTION
43BB	550,534.212	1,376,905.353	208.97	EAST SIDE OF US ROUTE 1 AND 320 FEET SOUTH OF KIT KAT ROAD

	SHEET	INDEX	
SHEET NO.		DESCRIPTION	
1		COVER SHEET	
2	FINAL PUBLIC	WATER PLAN AN	ID PROFILES

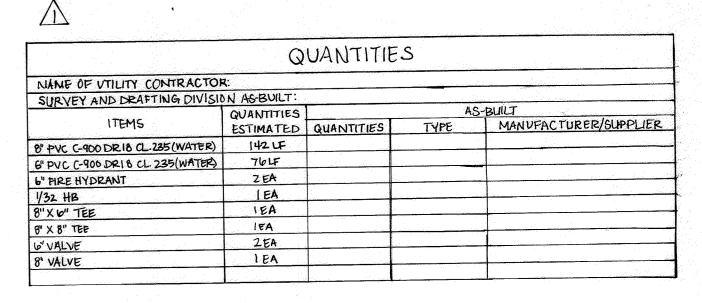

OWNER/DEVELOPER

HOWARD COUNTY MARYLAND C/O MICHAEL KAMINETZ, P.E. 9250 BENDIX ROAD, COLUMBIA, MARYLAND 21045 410.313.5781 MKAMINETZ@HOWARDCOUNTYMD.GOV

WATERLOO FIRE STATION

SHOWN

SHEET NO.

1 OF 3

SCALE:

TAX MAP 43 GRID 9

PARCEL 745 HOWARD COUNTY, MARYLAND 1ST ELECTION DISTRICT

SEDIMENT CONTROL MEASURES WILL BE IMPLEMENTED IN ACCORDANCE WITH SECTION 308 OF THE STANDARD SPECIFICATIONS AND WITH ROAD CONSTRUCTION PLANS SDP-18-014 THIS DEVELOPMENT IS APPROVED FOR SOIL EROSION AND SEDIMENT CONTROL BY THE HOWARD SOIL CONSERVATION DISTRICT.

DEPARTMENT OF PUBLIC WORKS HOWARD COUNTY, MARYLAND

CHIEF, BUREAU OF UTILITIES

DEPARTMENT OF PLANNING AND ZONING

HOWARD COUNTY, MARYLAND

 ■ ENGINEERING GROUP, LLC 11130 Dovedale Court, Suite 200 Marriottsville, Maryland 21104 Phone: 443.325.5076

Fax: 410.696.2022

Email: info@sillengineering.com Civil Engineering for Land Developmen



DRAWN BY: RA CHECKED BY: PS PROFESSIONAL CERTIFICATION: I HEREBY CERTIFY THAT THESE DOCUMENTS WERE PREPARED OR APPROVED BY ME, AND THAT I AM A DULY LICENSED PROFESSIONAL ENGINEER UNDER THE LAWS OF THE STATE OF MARYLAND, LICENSE NO. 32025, EXPIRATION DATE: JUNE 20, 2021

DESIGNED BY: PS


REVISE CONTRACT#IN LOCATION PLAN REVISE BUILDING, PUBLIC WATER, PARKING, AND PRNATE UTILITY LINES DESCRIPTION REVISIONS


600' SCALE MAP NO. 43

COVER SHEET

BLOCK NO. 9

CONTRACT NO. 44-5037-D

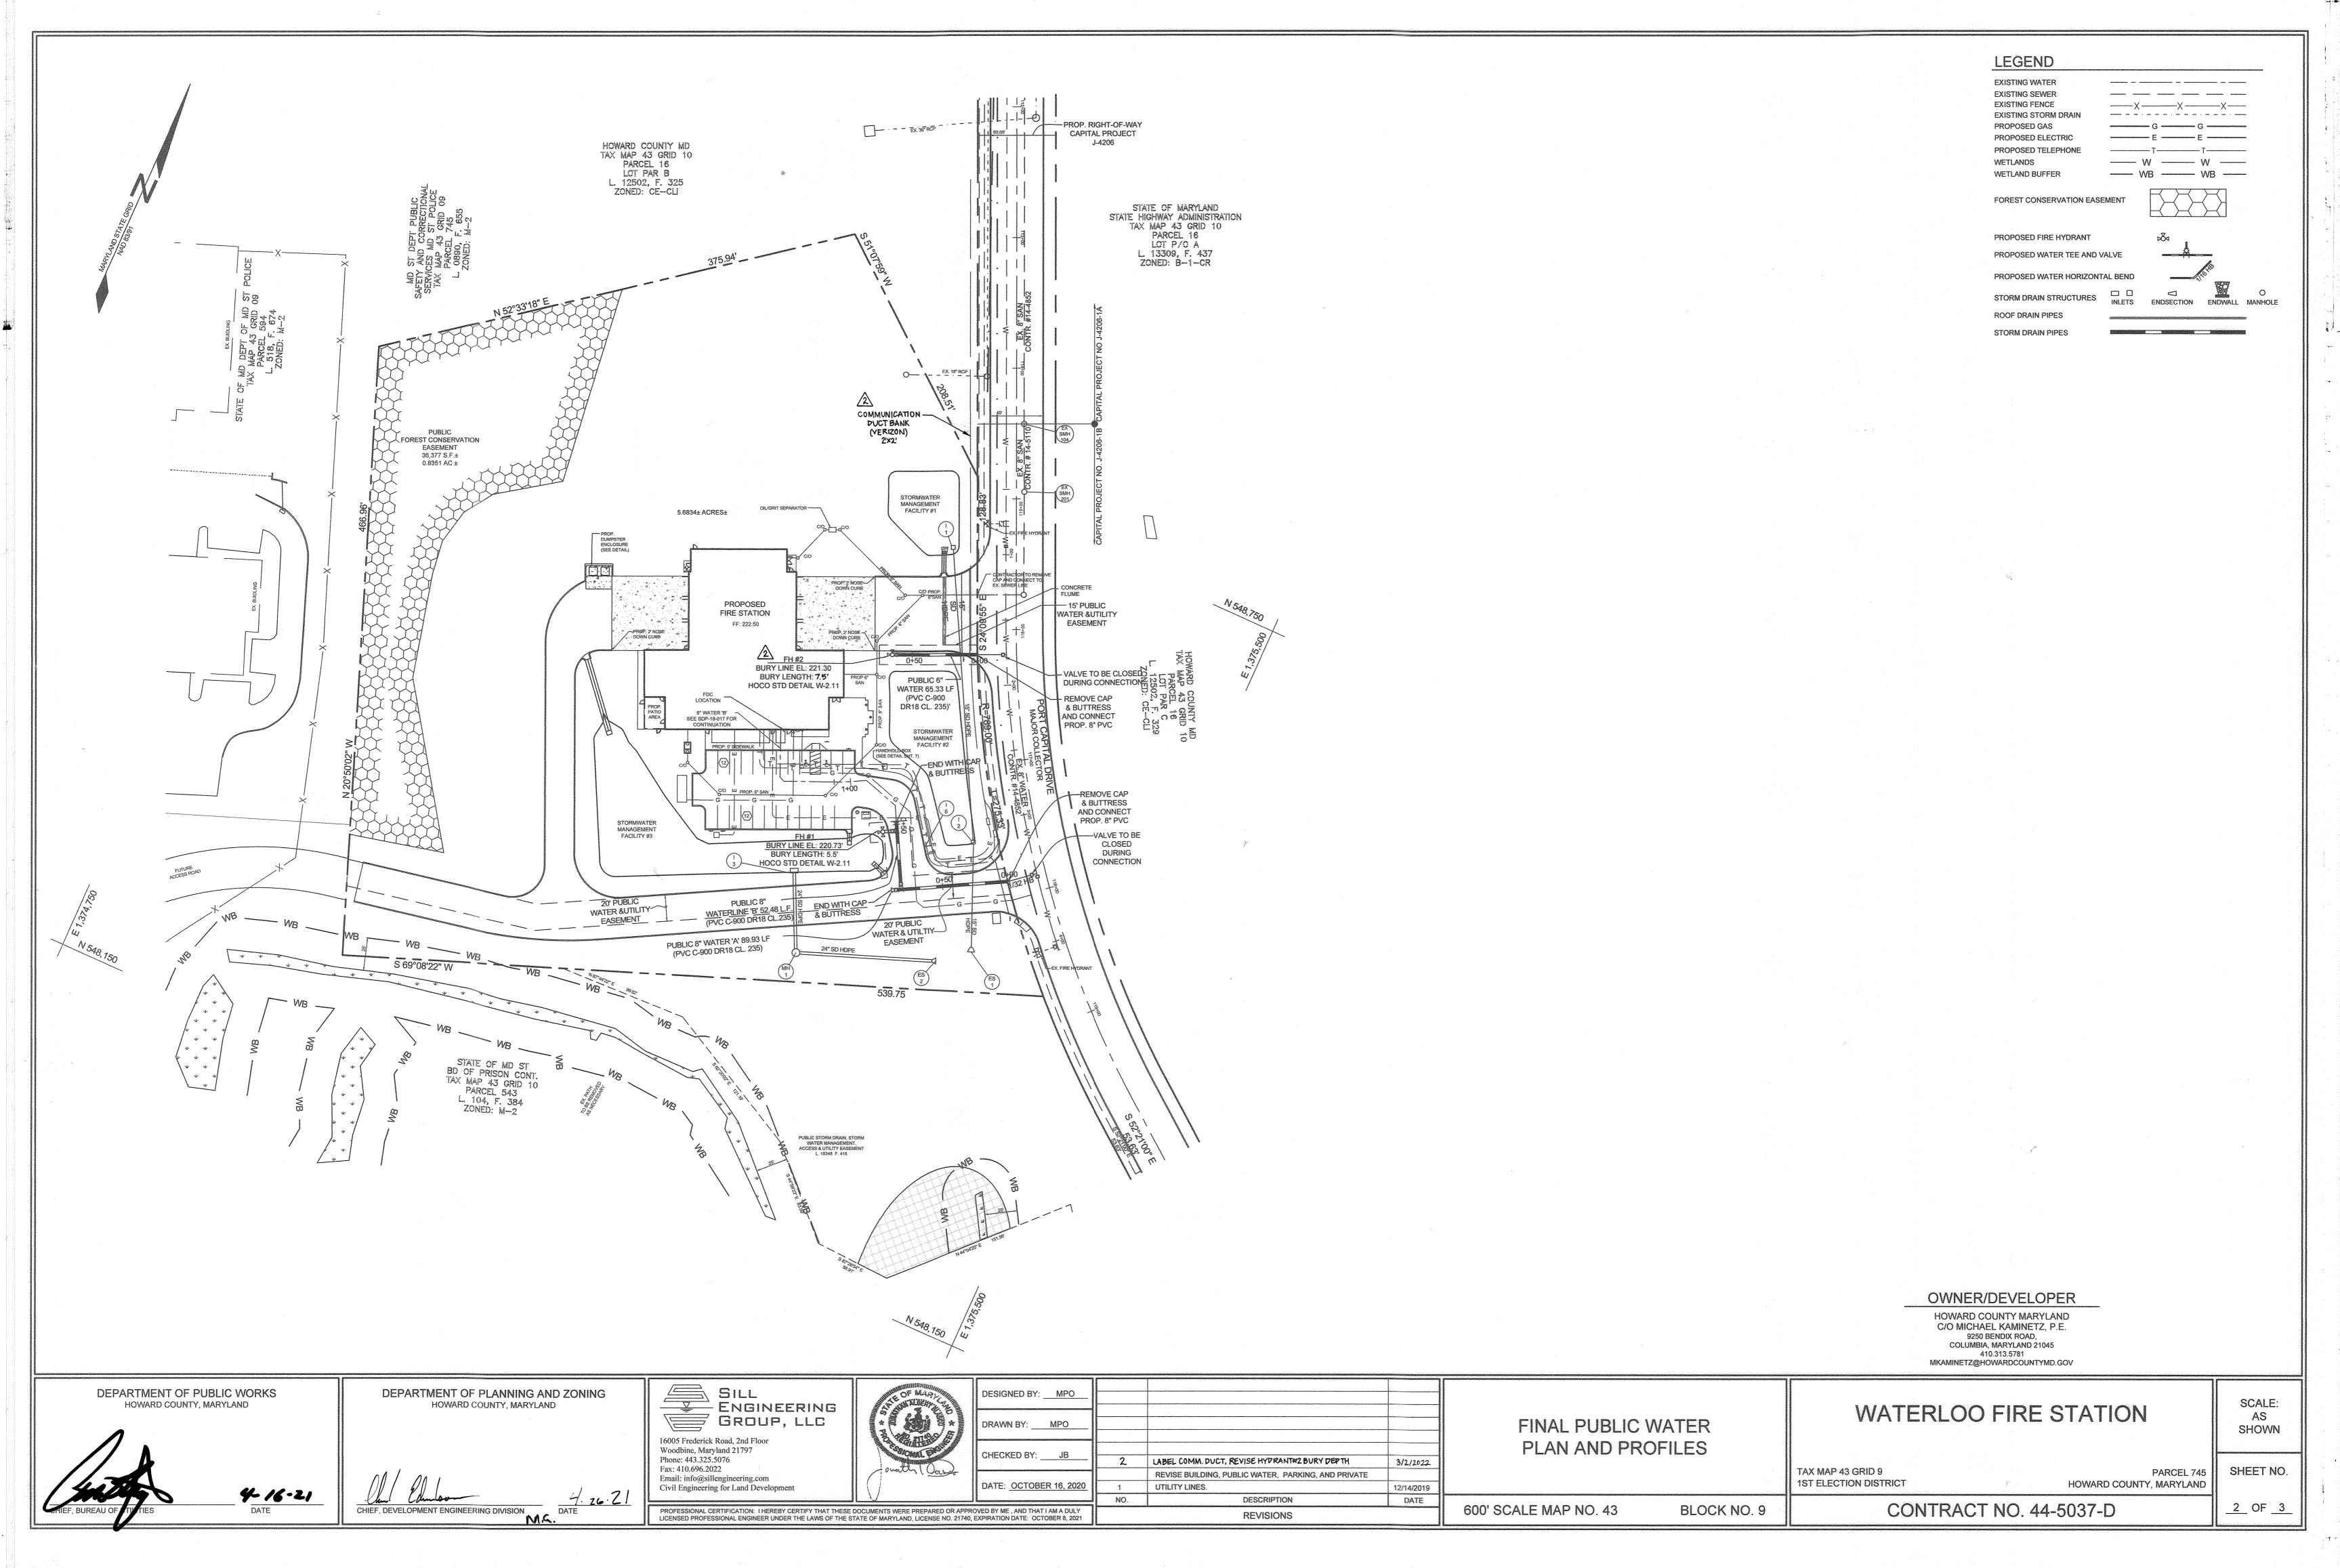


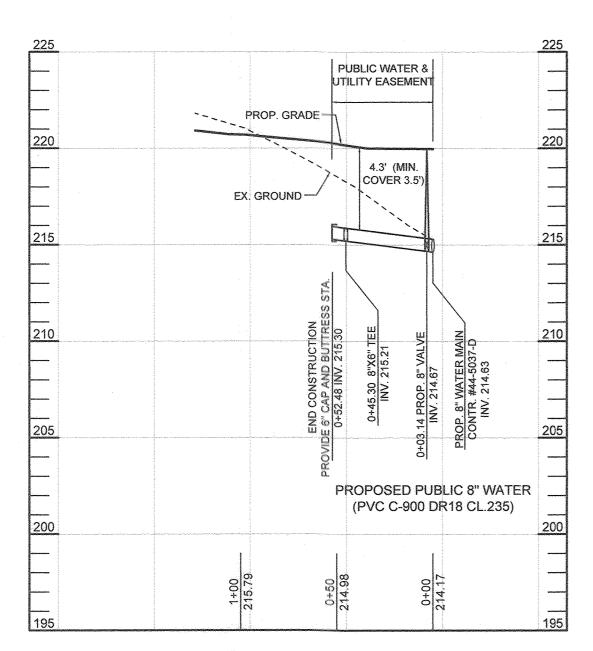

WATER MAIN 'B' PROFILE


SCALE: HORIZONTAL: 1"=50' VERTICAL: 1"=5'

STATION	TYPE	LOCATION	INV.
0+03.14	8" VALVE	N 548,455.68 E 1,375,319.30	214.67
0+47.48	FIRE HYDRANT TEE	N 548,494.69 E 1,375,298.23	215.23
0+52.48	6" CAP AND BUTTRESS	N 548,499.00 E 1,375,296.00	215.30

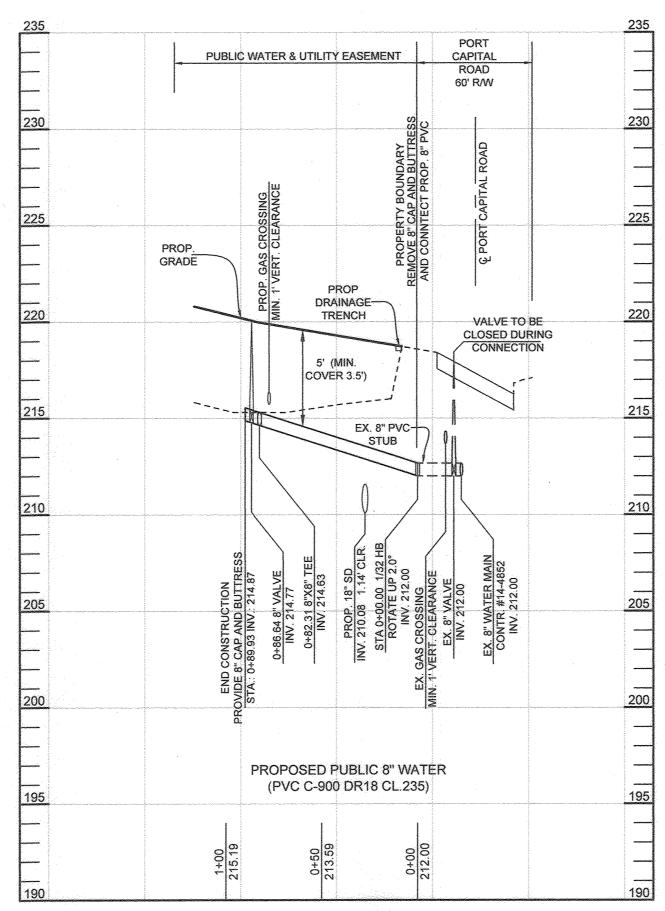

WATER MAIN 'A' PROFILE SCALE: HORIZONTAL: 1"=50' VERTICAL: 1"=5'

WATER MAIN 'A' FITTING CHART				
STATION	TYPE	LOCATION	INV.	
0+00.00	1/32 HORIZONTAL BEND	N 548,492.00 E 1,375,393.20	212.00	
0+82.31	8"X8" TEE	N 548,452.92 E 1,375,320.78	214.63	
0+86.64	8" VALVE	N 548,450.97 E 1,375,317.21	214.77	
0+89.93	8" CAP AND BUTTRESS	N 548,449.26 E 1,375,314.07	214.87	

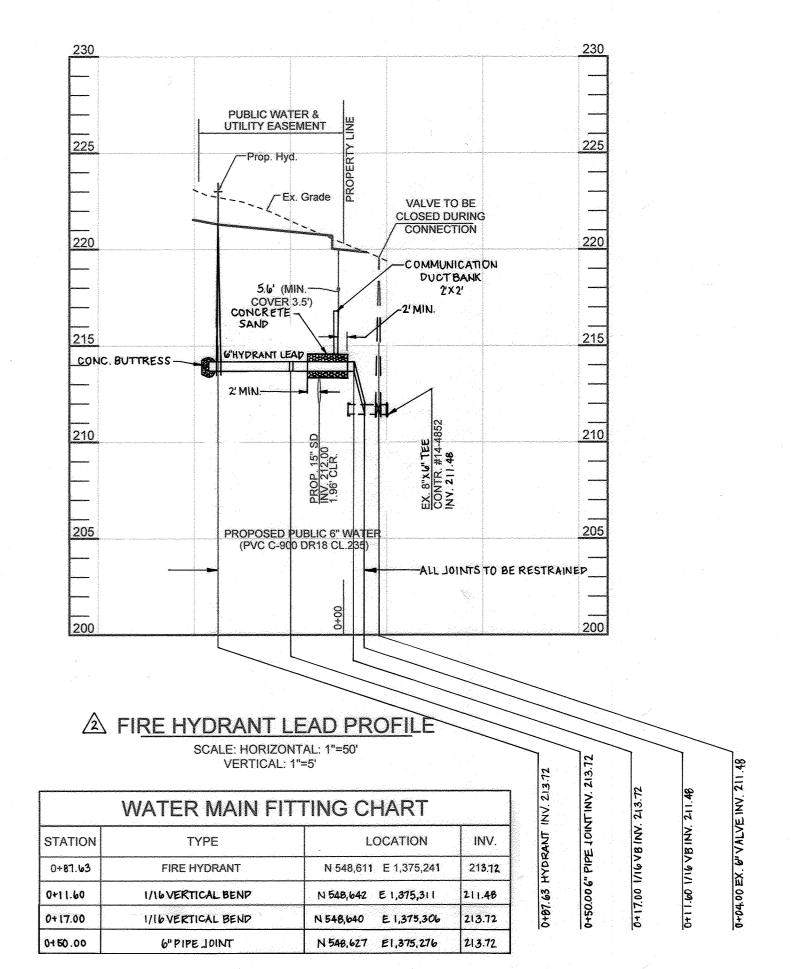

OWNER/DEVELOPER

HOWARD COUNTY MARYLAND C/O MICHAEL KAMINETZ, P.E. 9250 BENDIX ROAD, COLUMBIA, MARYLAND 21045 410.313.5781

MKAMINETZ@HOWARDCOUNTYMD.GOV

DEPARTMENT OF PUBLIC WORKS
HOWARD COUNTY, MARYLAND

CHIEF, BUREAU OF UTIL

Y-16-Z/DATE

4. 26 · Z1

DEPARTMENT OF PLANNING AND ZONING HOWARD COUNTY, MARYLAND

SILL ENGINEERING	Orath Oard	DESIGNED BY: MPO				
GROUP, LLC		DRAWN BY: MPO				
16005 Frederick Road, 2nd Floor Woodbine, Maryland 21797 Phone: 443.325.5076		CHECKED BY: JB	2	REVISE HYDRANT PROFILE	3/2/2022	
Fax: 410.696.2022 Email: info@sillengineering.com				REVISE BUILDING, PUBLIC WATER, PARKING, AND PRIVATE		
Civil Engineering for Land Development		DATE: OCTOBER 16, 2020	1	UTILITY LINES.	12/14/2019	
			NO.	DESCRIPTION	DATE	
PROFESSIONAL CERTIFICATION: 1 HEREBY CERTIFY THAT THESE DOCUMENTS WERE PREPARED OR APPROVED BY ME, AND THAT I AM A DULY LICENSED PROFESSIONAL ENGINEER UNDER THE LAWS OF THE STATE OF MARYLAND, LICENSE NO. 21740, EXPIRATION DATE: OCTOBER 8, 2021				REVISIONS		

FINAL PUBLIC WATER PLAN AND PROFILES

BLOCK NO. 9

600' SCALE MAP NO. 43

WATERLOO FIRE STATION

SCALE: AS SHOWN

SHEET NO.

TAX MAP 43 GRID 9 PARCEL 745 HOWARD COUNTY, MARYLAND **1ST ELECTION DISTRICT**

3 OF _3_ **CONTRACT NO. 44-5037-D**