

HOWARD COUNTY, MARYLAND

PATAPSCO INTERCEPTOR RELOCATION AND BLOEDE DAM REMOVAL

BONNIE BRANCH INTERCEPTOR SIPHON REPLACEMENT

CAPITAL PROJECT S-6282 CONTRACT NO. 10-4948

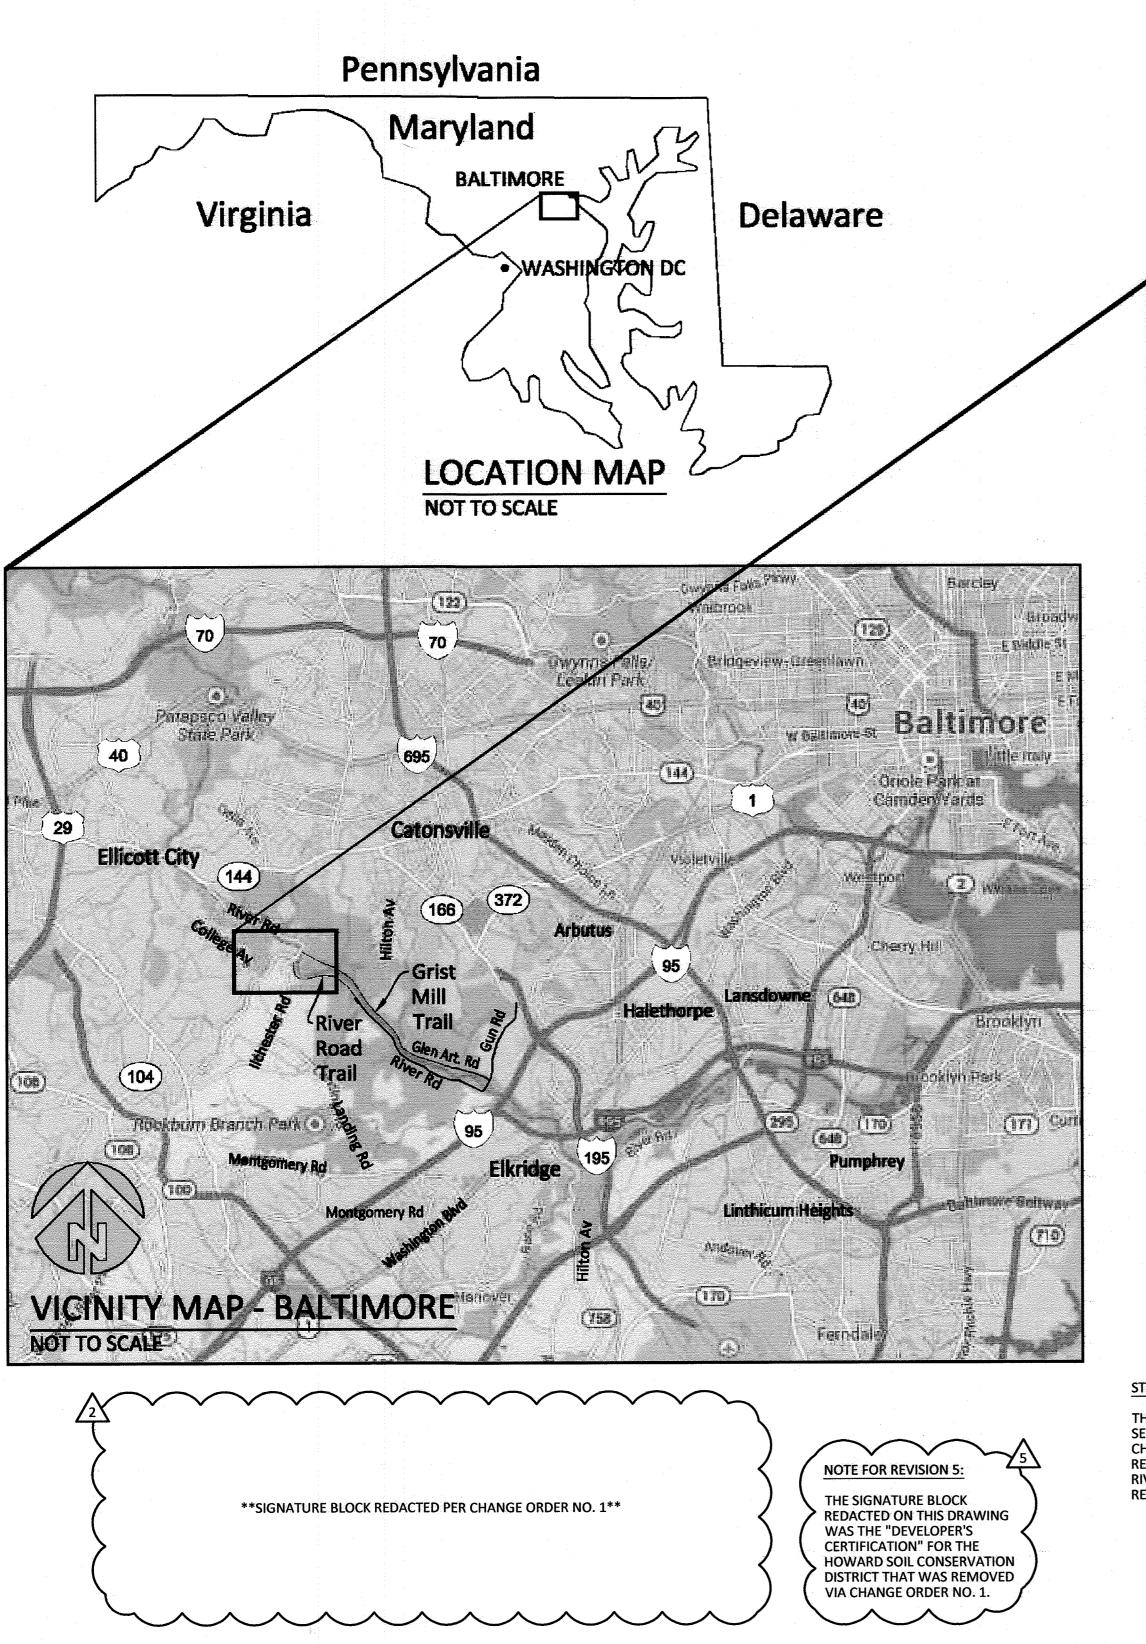

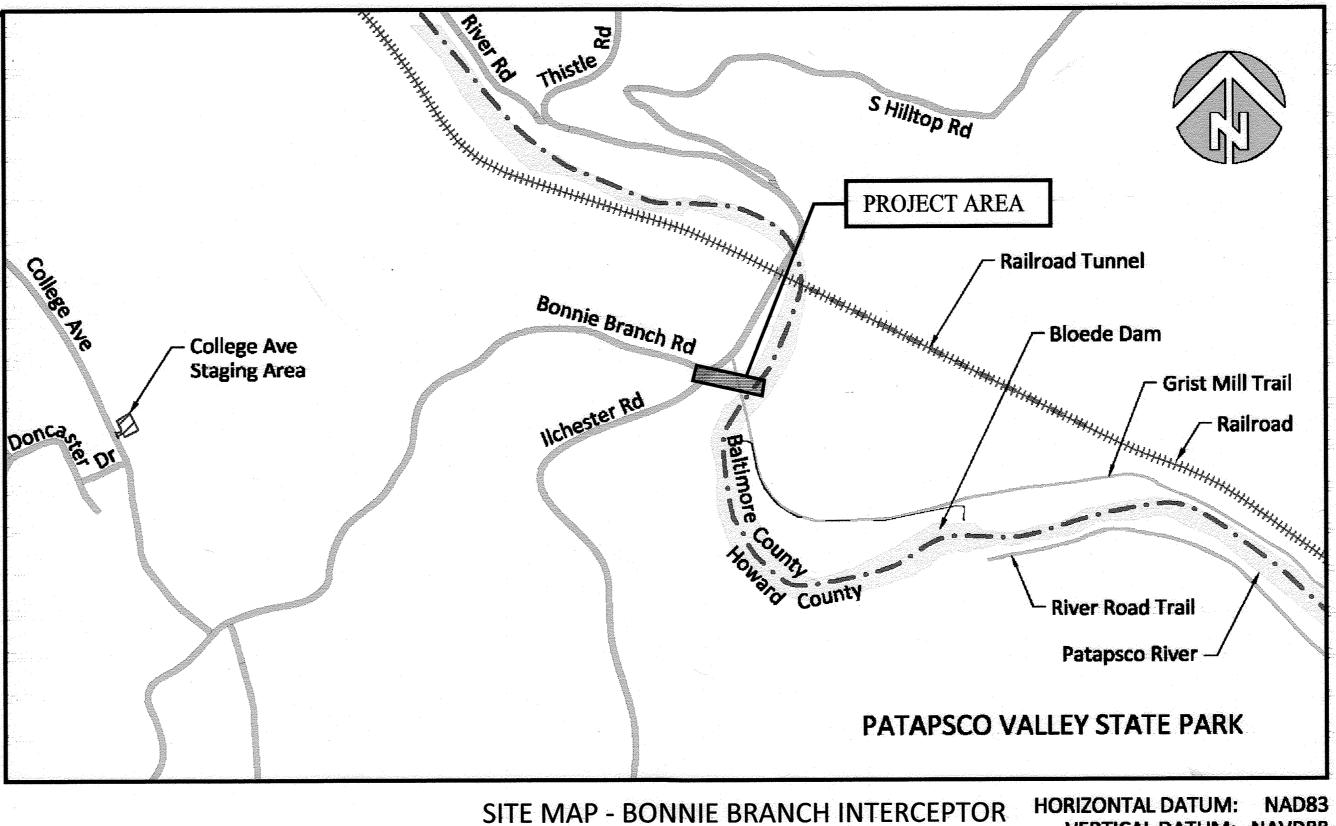

STATEMENT OF PROJECT PURPOSE:

THIS PROJECT IS TO REPLACE THE ENTIRE 12-INCH SEWER INTERCEPTOR SIPHON RIVER TO PERMIT CHANNEL EROSION TO OCCUR WHICH WILL RESULT FROM THE REMOVAL OF BLOEDE DAM.

"SEDIMENT CONTROL MEASURES FOR THIS CONTRACT WILL BE IMPLEMENTED IN **VOLUME IV: STANDARD SPECIFICATIONS AND DETAILS FOR CONSTRUCTION AS SHOWN** ON THESE PLANS AND ON DRAWINGS ESC-1 THROUGH ESC-24 OF THE PATAPSCO INTERCEPTOR RELOCATION AND BLOEDE DAM REMOVAL DRAWINGS.

GENERAL NOTES:

- .410-313-4900 COLONIAL PIPELINE

SEWER NOTES:

- 1. ALL SEWER MAINS SHALL BE D.I.P. OR P.V.C. UNLESS OTHERWISE NOTED
- 2. ALL MANHOLES SHALL BE 4'-0" INSIDE DIAMETER UNLESS OTHERWISE
- 3. FORCE MAINS SHALL BE D.I.P. ONLY.
- 4. MANHOLES SHOWN WITH 12" AND 16" WALLS ARE FOR BRICK MANHOLES
- 5. MANHOLES DESIGNATED W.T. IN PLAN AND PROFILE SHALL HAVE WATERTIGHT FRAME AND COVER, STANDARD DETAIL G5.52. WHERE WATERTIGHT MANHOLE FRAMES AND COVERS ARE USED, SET TOP OF
- 6. HOUSE(S) WITH THE SYMBOL "C.N.S." INDICATES THAT THE CELLAR

BILL OF MATERIALS

ITEM	UNIT	ESTIMATE	AS-BUILT	MANUFACTURER
12" DIP, CLASS 54 RJ	LF	278	279	USPIPE
12" RJ DIP 22.5° BEND	EA	9	7	US PIPE
12" RJ DIP 11.25° BEND	EA	2	3	US PIPE
12" RJ DIP TEE	EA	1	1	US PIPE
VAULT FRAME AND COVER	EA	1		
LINE STOP	EA	1	1	
YALE CLOSURE	EA		1	
NAME OF UTILITY CONTRACT	TOR: KIEW	w/FERGU	SON W	ATERWORKS
		C	НЕСКВОХ	
			<u> Amerikan mendilah dia dia dia dia dia dia dia dia dia dia</u>	A CONTRACTOR OF THE CONTRACTOR

AS-BUILT DATE | 12/2019

AS-BUILT DATE 12/31/2014

NO CHANGES IN REVISIONS 1, 3


1" = 1000'

DEPARTMENT OF PUBLIC WORKS HOWARD COUNTY, MARYLAND

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HAZEN AND SAWYER 1 SOUTH STREET, SUITE 1150; BALTIMORE, MD 21202

PROFESSIONAL CERTIFICATION HEREBY CERTIFY THAT THESE DOCUMENTS WERE PREPARED OF APPROVED BY ME, AND THAT I AM A DULY LICENSED PROFESSIONAL ENGINEER UNDER THE LAWS OF THE STATE OF MARYLAND, LICENSE NO. 35295, EXPIRATION DATE 01/06/2018 SIGNED: Gry

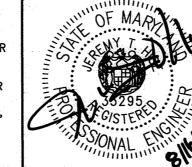

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	4	REVISION PER MDE COMMENTS	1/2017	J
TH	2	CHANGE ORDER NO. 1	5/2016	J
PPROVED	NO.	ISSUED FOR	DATE	. E

GENERAL COVER SHEET

VERTICAL DATUM: NAVD88

PATAPSCO INTERCEPTOR RELOCATION AND BLOEDE DAM REMOVAL **CAPITAL PROJECT NUMBER S-6282 CONTRACT NUMBER 10-4948**

NUMBER HSG-1 SCALE **AS SHOWN** 2ND ELECTION DISTRICT HOWARD COUNTY, MARYLAND SHEET 64 OF 106

AUGUST 201

SITE LEGEND

EXISTING ——LOD—— LIMITS OF DISTURBANCE STABILIZED CONSTRUCTION **ENTRANCE** SOIL BORING LOCATION CONTOUR ———— PROPERTY LINE **PAVEMENT** ─── GUARDRAIL **ROAD SIGN** OHE OVERHEAD ELECTRIC LINE **ELECTRIC POLE** —SD—— **STORM DRAIN PIPING** SANITARY SEWER PIPING **SANITARY SEWER MANHOLE** —— 2YR —— 2-YEAR STORM WATER LEVEL -----10YR----- 10-YEAR STORM WATER LEVEL ----100YR---- 100-YEAR STORM WATER LEVEL ∧⁴²⁴³⁶ **SURVEY TRAVERSE POINT**

GENERAL NOTES FOR THE BONNIE BRANCH SEWER RELOCATION DRAWINGS ONLY (HSG, HSR, HSC, & HST SERIES DRAWINGS):

- 1. ALL CONSTRUCTION SHALL BE IN ACCORDANCE WITH THE LATEST STANDARDS AND SPECIFICATIONS OF HOWARD COUNTY PLUS MSHA STANDARDS AND SPECIFICATIONS IF APPLICABLE.
- 2. THE CONTRACTOR SHALL NOTIFY THE HOWARD COUNTY DEPARTMENT OF PUBLIC WORKS/BUREAU OF ENGINEERING/CONSTRUCTION INSPECTION DIVISION AT (410) 313-1880 AT LEAST FIVE (5) WORKING DAYS PRIOR TO START OF WORK.
- 3. THE CONTRACTOR SHALL NOTIFY "MISS UTILITY" AT 1-800-257-7777 AT LEAST 48 HOURS PRIOR TO ANY EXCAVATION WORKING BEING DONE. IF MISS UTILITY DOES NOT RESPOND, THE CONTRACTOR SHALL BE REQUIRED TO CONTACT AND CONTRACT A PRIVATE UTILITY LOCATOR COMPANY 48 HOURS PRIOR TO BEGINNING GRADING OR DEMOLITION ACTIVITIES.
- 4. THE SURVEY INFORMATION DATED SEPTEMBER 2013 WAS PROVIDED BY INTERFLUVE, INC. THE HORIZONTAL DATUM IS REFERENCED TO MARYLAND STATE PLANE (NAD 83/91) AND THE VERTICAL DATUM IS REFERENCED TO NAVD 88.
- 5. EXISTING UTILITIES SHOWN MUST BE FIELD VERIFIED BY THE CONTRACTOR PRIOR TO START OF ANY DEMOLITION AND CONSTRUCTION.
- 6. THE ENTIRE PROJECT AREA IS LOCATED IN THE 100 YEAR FLOODPLAIN. FLOOD ELEVATIONS HAVE BEEN PROVIDED ON THE SITE PLANS FOR THE VARIOUS
- 7. OFF SITE DISPOSAL OF EXCESS MATERIAL SHALL BE TO AN APPROVED AND PROPERLY PERMITTED SITE.
- 8. THE CONTRACTOR SHALL LOCATE AND PROTECT ALL EXISTING FACILITIES, STRUCTURES AND UTILITIES FROM DAMAGE UNLESS OTHERWISE NOTED TO BE REMOVED/DEMOLISHED.
- 9. IT SHALL BE THE RESPONSIBILITY OF THE CONTRACTOR TO REMOVE AND LEGALLY DISPOSE OF ANY AND ALL DEMOLISHED/DELETERIOUS MATERIALS AT A PROPERLY PERMITTED DISPOSAL SITE.
- 10. POSITIVE DRAINAGE SHALL BE MAINTAINED AT ALL TIMES. PONDING OF WATER SHALL NOT BE PERMITTED. ALL PONDING WATER SHALL BE FILTERED THROUGH A PORTABLE SEDIMENT TANK PRIOR TO DISCHARGE INTO THE PUBLIC STORM SEWER SYSTEM.
- 11. SURFACED STREET AND PARKING AREAS SHALL BE MAINTAINED IN A CLEAN CONDITION FREE OF MUD AND DUST AT ALL TIMES. ADEQUATE MEANS SHALL BE PROVIDED TO CLEAN TRUCKS AND EQUIPMENT.
- 12. IN-RIVER WORK ASSOCIATED WITH BONNIE BRANCH SEWER CONSTRUCTION SHALL OCCUR DURING PATAPSCO RIVER LOW FLOW PERIODS TO THE MAXIMUM EXTENT FEASIBLE TO MINIMIZE RIVER DIVERSION AND DEWATERING

TRAVERSE STATION	EASTING	NORTHING	ELEV.	DESCRIPTION
170	1379843.04	575435.07	77.90	ROD/STAKE
171	1379948.79	575472.53	88.88	ROD/STAKE
421	1378813.99	576083.95	75.23	ROD/STAKE
422	1379009.21	576112.95	100.94	ROD/STAKE
423	1379031.99	575939.45	99.85	ROD/STAKE
424	1379054.66	575694.67	79.44	ROD/STAKE
425	1379247.99	575468.30	80.16	ROD/STAKE
426	1379438.38	575481.61	79.73	ROD/STAKE
427	1379687.26	575573.48	80.68	ROD/STAKE
428	1379979.79	575556.07	76.55	ROD/STAKE
937	1378798.59	576084.57	82.52	ROD/STAKE
42435	1379686.15	575729.33	98.42	ROD/STAKE
42436	1379400.10	575719.56	99.78	ROD/STAKE
42437	1379205.84	575766.43	100.54	ROD/STAKE

SURVEY CONTROL DATA

INDEX OF BONNIE BRANCH SEWER RELOCATION DRAWINGS:

"SEDIMENT CONTROL MEASURES FOR THIS CONTRACT WILL BE IMPLEMENTED IN

ACCORDANCE WITH SECTION 308 OF THE HOWARD COUNTY DESIGN MANUAL -**VOLUME IV: STANDARD SPECIFICATIONS AND DETAILS FOR CONSTRUCTION AS SHOWN**

ON THESE PLANS AND ON DRAWINGS ESC-1 THROUGH ESC-24 OF THE PATAPSCO

INTERCEPTOR RELOCATION AND BLOEDE DAM REMOVAL DRAWINGS."

SHEET NO.	DWG NO.	DESCRIPTION
HSG SERIES		
64	HSG-1	COVER SHEET
65	HSG-2	SYMBOLS, NOTES, AND ABBREVIATIONS
66	HSG-3	ACCESS PLAN
67	HSG-4	ACCESS ROAD SECTIONS
68	HSG-5	BONNIE BRANCH SEWER RECORD DRAWINGS (FOR INFORMATION ONLY)
69	HSG-6	BONNIE BRANCH SEWER RECORD DRAWINGS (FOR INFORMATION ONLY)
70	HSG-7	PEDESTRIAN BRIDGE RECORD DRAWINGS (FOR INFORMATION ONLY)
71	HSG-8	PEDESTRIAN BRIDGE RECORD DRAWINGS (FOR INFORMATION ONLY)
HSR SERIES		
72	HSR-1	CLEARING AND GRUBBING PLAN
HSC SERIES		
73	HSC-1	BONNIE BRANCH SIPHON PLAN
74	HSC-2	BONNIE BRANCH BYPASS PLAN
75	HSC-3	DETAILS
76	HSC-4	DETAILS
HST SERIES		
77	HST-1	TRAFFIC CONTROL PLAN
-		
\		

GENERAL SEDIMENT CONTROL NOTES:

THE FOLLOWING NOTES SHALL APPLY TO WORK ON THE BONNIE BRANCH SIPHON. WHERE REQUIREMENTS ARE CONTRADICTORY WITH WHAT IS SHOWN ON DRAWINGS ESC-1 THROUGH ESC-11 OF THE PATAPSCO INTERCEPTOR AND BLOEDE DAM REMOVAL DRAWINGS, THE MORE STRINGENT REQUIREMENT SHALL APPLY. CONTRACT SHALL NOTE THAT THE MARYLAND DEPARTMENT OF THE ENVIRONMENT IS IN CHARGE OF REVIEWING AND APPROVING SEDIMENT CONTROL MEASURES.

- 1. FOR UTILITY INSTALLATIONS, ALL DISTURBED AREAS SHALL BE STABILIZED THE SAME DAY. IF UNFORESEEN CONDITIONS REQUIRE THAT AN EXCAVATION MUST REMAIN OPEN BEYOND THE WORK DAY, THE FOLLOWING PROVISIONS MUST BE FOLLOWED:
- 1.1. TEMPORARY SILT FENCE SHALL BE PLACED IMMEDIATELY DOWNSTREAM OF ANY AREA INTENDED TO REMAIN DISTURBED FOR MORE THAN ONE DAY, AND
- 1.2. ANY PILES OF EXCAVATION SPOILS MATERIALS MUST BE SECURELY COVERED TO ENSURE THAT SEDIMENTS ARE NOT TRANSPORTED FROM THE PILE.
- 2. PAVEMENTS ADJACENT TO THE EXCAVATION MUST REMAIN SEDIMENT FREE. CONTRACTOR SHALL PLACE PLASTIC SHEETING BENEATH THE EXCAVATED MATERIAL PILES, AND SWEEP PAVEMENTS CLEAN OF SEDIMENTS AS REQUIRED.
- 3. A STABILIZED CONSTRUCTION ENTRANCE SHALL BE PROVIDED AT THE DIRECTION OF THE SEDIMENT AND EROSION CONTROL INSPECTOR.
- 4. ALL SPOILS FROM THE EXCAVATION ARE TO BE PLACED ON THE UPHILL SIDE OF THE TRENCH.

STANDARD SEDIMENT CONTROPNOTES:

THE FOLLOWING NOTES SHALL APPLY TO WORK ON THE BONNIE BRANCH SIPHON. WHERE REQUIREMENTS ARE CONTRADICTORY WITH WHAT IS SHOWN ON DRAWINGS ESC-1 THROUGH ESC-24 OF THE PATAPSCO INTERCEPTOR AND BLOEDE DAM REMOVAL DRAWINGS, THE MORE STRINGENT REQUIREMENT SHALL APPLY. CONTRACT SHALL NOTE THAT THE MARYLAND DEPARTMENT OF THE ENVIRONMENT IS IN CHARGE OF REVIEWING AND APPROVING SEDIMENT CONTROL MEASURES.

- 1. A MINIMUM OF 48 HOURS NOTICE MUST BE GIVEN TO THE HOWARD COUNTY DEPARTMENT OF INSPECTIONS, LICENSES, AND PERMITS, SEDIMENT CONTROL DIVISION PRIOR TO THE START OF ANY CONSTRUCTION (410-313-1855).
- 2. ALL VEGETATIVE AND STRUCTURAL PRACTICES ARE TO BE INSTALLED ACCORDING TO THE PROVISION OF THIS PLAN AND ARE TO BE IN CONFORMANCE WITH THE 2011 MARYLAND STANDARDS AND SPECIFICATIONS FOR SOIL EROSION AND SEDIMENT CONTROL AND ALL REVISIONS THERETO.
- 3. FOLLOWING INITIAL SOIL DISTURBANCE OR RE-DISTURBANCE, PERMANENT OR TEMPORARY STABILIZATION SHALL BE COMPLETED WITHIN A) THREE (3) CALENDAR DAYS FOR ALL PERIMETER DIKES, SWALES, DITCHES, PERIMETER SLOPES AND ALL SLOPES GREATER THAN 3 HORIZONTAL TO 1 VERTICAL (3:1); AND B) SEVEN (7) CALENDAR DAYS AS TO ALL OTHER DISTURBED OR GRADED AREAS ON THE PROJECT SITE NOT UNDER ACTIVE GRADING.
- 4. ALL DISTURBED AREAS MUST BE STABILIZED WITHIN THE TIME PERIOD SPECIFIED ABOVE IN ACCORDANCE WITH THE 2011 MARYLAND STANDARDS AND SPECIFICATIONS FOR SOIL EROSION AND SEDIMENT CONTROL FOR PERMANENT SEEDING (SEC. B-4-5), TEMPORARY SEEDING (SEC. B-4-4) AND MULCHING (SEC. B-4-3). TEMPORARY STABILIZATION WITH MULCH ALONE CAN ONLY BE DONE WHEN RECOMMENDED SEEDING DATES DO NOT ALLOW FOR PROPER GERMINATION AND ESTABLISHMENT OF GRASSES.
- 5. ALL SEDIMENT CONTROL STRUCTURES ARE TO REMAIN IN PLACE AND ARE TO BE MAINTAINED IN OPERATIVE CONDITION UNTIL PERMISSION FOR REMOVAL HAS BEEN OBTAINED FROM THE HOWARD COUNTY SEDIMENT CONTROL INSPECTOR.
- 6. ANY SEDIMENT CONTROL PRACTICE THAT IS DISTURBED BY GRADING ACTIVITY FOR PLACEMENT OF UTILITIES MUST BE REPAIRED ON THE SAME DAY OF DISTURBANCE.
- 7. ADDITIONAL SEDIMENT CONTROL MUST BE PROVIDED, IF DEEMED NECESSARY BY THE SEDIMENT AND EROSION CONTROL INSPECTOR.
- 8. ON ALL SITES WITH DISTURBED AREAS IN EXCESS OF 2 ACRES, APPROVAL OF THE INSPECTION AGENCY SHALL BE REQUESTED UPON COMPLETION OF INSTALLATION OF PERIMETER EROSION AND SEDIMENT CONTROLS. BUT BEFORE PROCEEDING WITH ANY OTHER EARTH DISTURBANCE OR GRADING. OTHER BUILDING OR GRADING INSPECTION APPROVALS MAY NOT BE AUTHORIZED UNTIL THIS INITIAL APPROVAL BY THE INSPECTION AGENCY IS MADE.
- TRENCHES FOR THE CONSTRUCTION OF UTILITIES SHALL BE LIMITED TO THREE PIPE LENGTHS OR THAT WHICH SHALL BE BACK-FILLED AND STABILIZED AT THE END OF EACH WORKING DAY, WHICHEVER IS SHORTER.
- 10. ANY CHANGES OR REVISIONS TO THE SEQUENCE OF CONSTRUCTION MUST BE REVIEWED AND APPROVED BY THE PLAN APPROVAL AUTHORITY PRIOR TO PROCEEDING WITH CONSTRUCTION.
- 11. A PROJECT IS TO BE SEQUENCED SO THAT GRADING ACTIVITIES BEGIN ON ONE GRADING UNIT (MAXIMUM ACREAGE OF 20 AC. PER GRADING UNIT) AT A TIME. WORK MAY PROCEED TO A SUBSEQUENT GRADING UNIT WHEN AT LEAST 50 PERCENT OF THE DISTURBED AREA IN THE PRECEDING UNIT HAS BEEN STABILIZED AND APPROVED BY THE ENFORCEMENT AUTHORITY. UNLESS OTHERWISE SPECIFIED AND APPROVED BY THE APPROVAL AUTHORITY, NO MORE THAN 30 ACRES CUMULATIVELY MAY BE DISTURBED AT A GIVEN TIME.

ABBREVIATIONS

ALT	ALTERNATE	LF	LINEAR FEET
APPROX	APPROXIMATE	LOD	LIMITS OF DISTURBANCE
BLDG BLK	BUILDING BLOCK	MDE	MARYLAND DEPARTMENT OF THE ENVIRONMENT
BM BOC	BENCH MARK BACK OF CURB	MDOT	MARYLAND DEPARTMENT OF TRANSPORTATION
вот	воттом	MDSHA	MARYLAND STATE HIGHWAY ADMINISTRATION
CF	CUBIC FEET	MFR	MANUFACTURER
CI	CAST IRON	MH	MANHOLE
CIP	CAST IRON PIPE	MIN	MINIMUM
CL	CENTER LINE	MISC	MISCELLANEOUS
		IVIISC	MISCELLAMEOUS
CMP	CORRUGATED METAL PIPE		
CO	CLEANOUT	NTS	NOT TO SCALE
CONC	CONCRETE		
CY	CUBIC YARD	OD	OUTSIDE DIAMETER
DET DIA	DETAIL DIAMETER	PCCP	PRESTRESSED CONCRETE CYLINDER PIPE
Ø	DIAMETER	DVC	
DIM	DIMENSION	PVC	POLYVINYL CHLORIDE
	DUCTILE IRON PIPE	PG	PAGE
DIP			
DISCH	DISCHARGE	QTY	QUANTITY
DWG	DRAWING		
		RCP	REINFORCED CONCRETE PIPE
EA	EACH	REQD	REQUIRED
ELEV	ELEVATION	RSF	REINFORCED SILT FENCE
ELEC	ELECTRIC/ELECTRICAL		
EOP	EDGE OF PAVEMENT	R/W	RIGHT OF WAY
EQ	EQUAL		
		SCE	STABILIZED CONSTRUCTION
EQPT	EQUIPMENT		ENTRANCE
EX	EXISTING	SHC	SEWER HOUSE CONNECTION
		SF	SQUARE FEET
FEMA	FEDERAL EMERGENCY	SPEC	SPECIFICATION
	MANAGEMENT AGENCY	SS	SANITARY SEWER
FH	FIRE HYDRANT	SSMH	SANITARY SEWER MANHOLE
FM	FORCE MAIN		
FP	FLOOD PLAIN	STA	STATION
FT	FEET	STD	STANDARD
		TYP	TYPICAL
HDPE	HIGH DENSITY		
HOD	POLYETHYLENE	UG	UNDERGROUND
HOR	HORIZONTAL		
IN	INCH	VERT	VERTICAL
INV	INVERT		
(1.A.)A	HAA FIZI	W/	WITH
		w/o	WITHOUT
		WUS	WATERS OF THE US
		YD	YARD
		YR	YEAR

DETAILED SEQUENCE OF CONSTRUCTION:

REFER TO DRAWING DG-3 FOR DETAILED SEQUENCE OF CONSTRUCTION

AS-BUILT DATE 12/31/2019

NO CHANGES IN REVISIONS 1, 3

DEPARTMENT OF PUBLIC WORKS HOWARD COUNTY, MARYLAND

2/17/13 CHIEF UTILITY DESIGN DIVISON

HAZEN AND SAWYER

1 SOUTH STREET, SUITE 1150; BALTIMORE, MD 21202

410-539-7681

PROFESSIONAL CERTIFICATION I HEREBY CERTIFY THAT THESE DOCUMENTS WERE PREPARED OR APPROVED BY ME, AND THAT I AM A DULY LICENSED PROFESSIONAL ENGINEER UNDER THE LAWS OF THE STATE OF MARYLAND, LICENSE NO. 35295, EXPIRATION DATE 01/06/2018



DESIGNED	NH/MJB				
DRAWN	МЈВ	-			
CHECKED	JTH				
PROJ FNGR	JTH/	5	REVISION PER HOWARD COUNTY	8/2017	JTH
		4	REVISION PER MDE COMMENTS	1/2017	JTH
174		2	CHANGE ORDER NO. 1	5/2016	JTH
APPROVED		NO.	ISSUED FOR	DATE	BY
	CHECKED PROJ. ENGR.	DRAWN MJB CHECKED JTH PROJ. ENGR. JTH	DRAWN MJB CHECKED JTH PROJ. ENGR. JTH 5 4 2	DRAWN MJB CHECKED JTH PROJ. ENGR. JTH 5 REVISION PER HOWARD COUNTY 4 REVISION PER MDE COMMENTS 2 CHANGE ORDER NO. 1	DRAWN MJB CHECKED JTH PROJ. ENGR. JTH 5 REVISION PER HOWARD COUNTY 8/2017 4 REVISION PER MDE COMMENTS 1/2017 2 CHANGE ORDER NO. 1 5/2016

SYMBOLS, NOTES, AND **ABBREVIATIONS**


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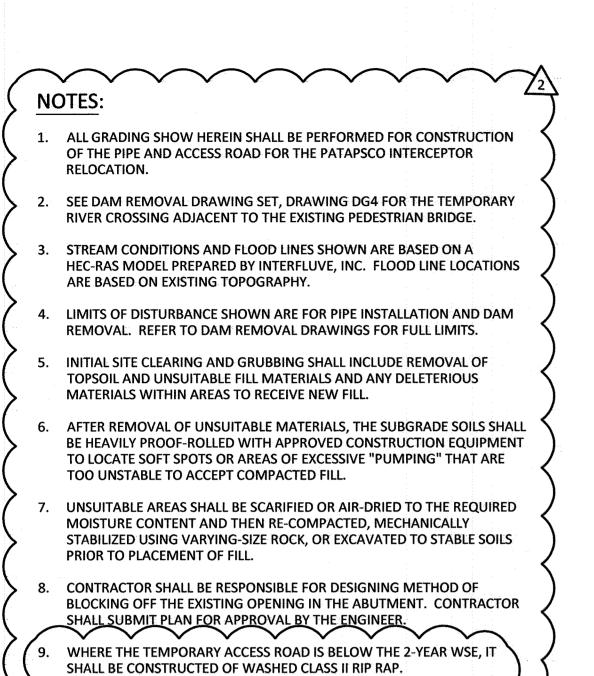
PATAPSCO INTERCEPTOR RELOCATION AND BLOEDE DAM REMOVAL **CAPITAL PROJECT NUMBER S-6282 CONTRACT NUMBER 10-4948** 2ND ELECTION DISTRICT HOWARD COUNTY, MARYLAND SHEET 65 OF 106

(AUGUST 201 NUMBER HSG-2

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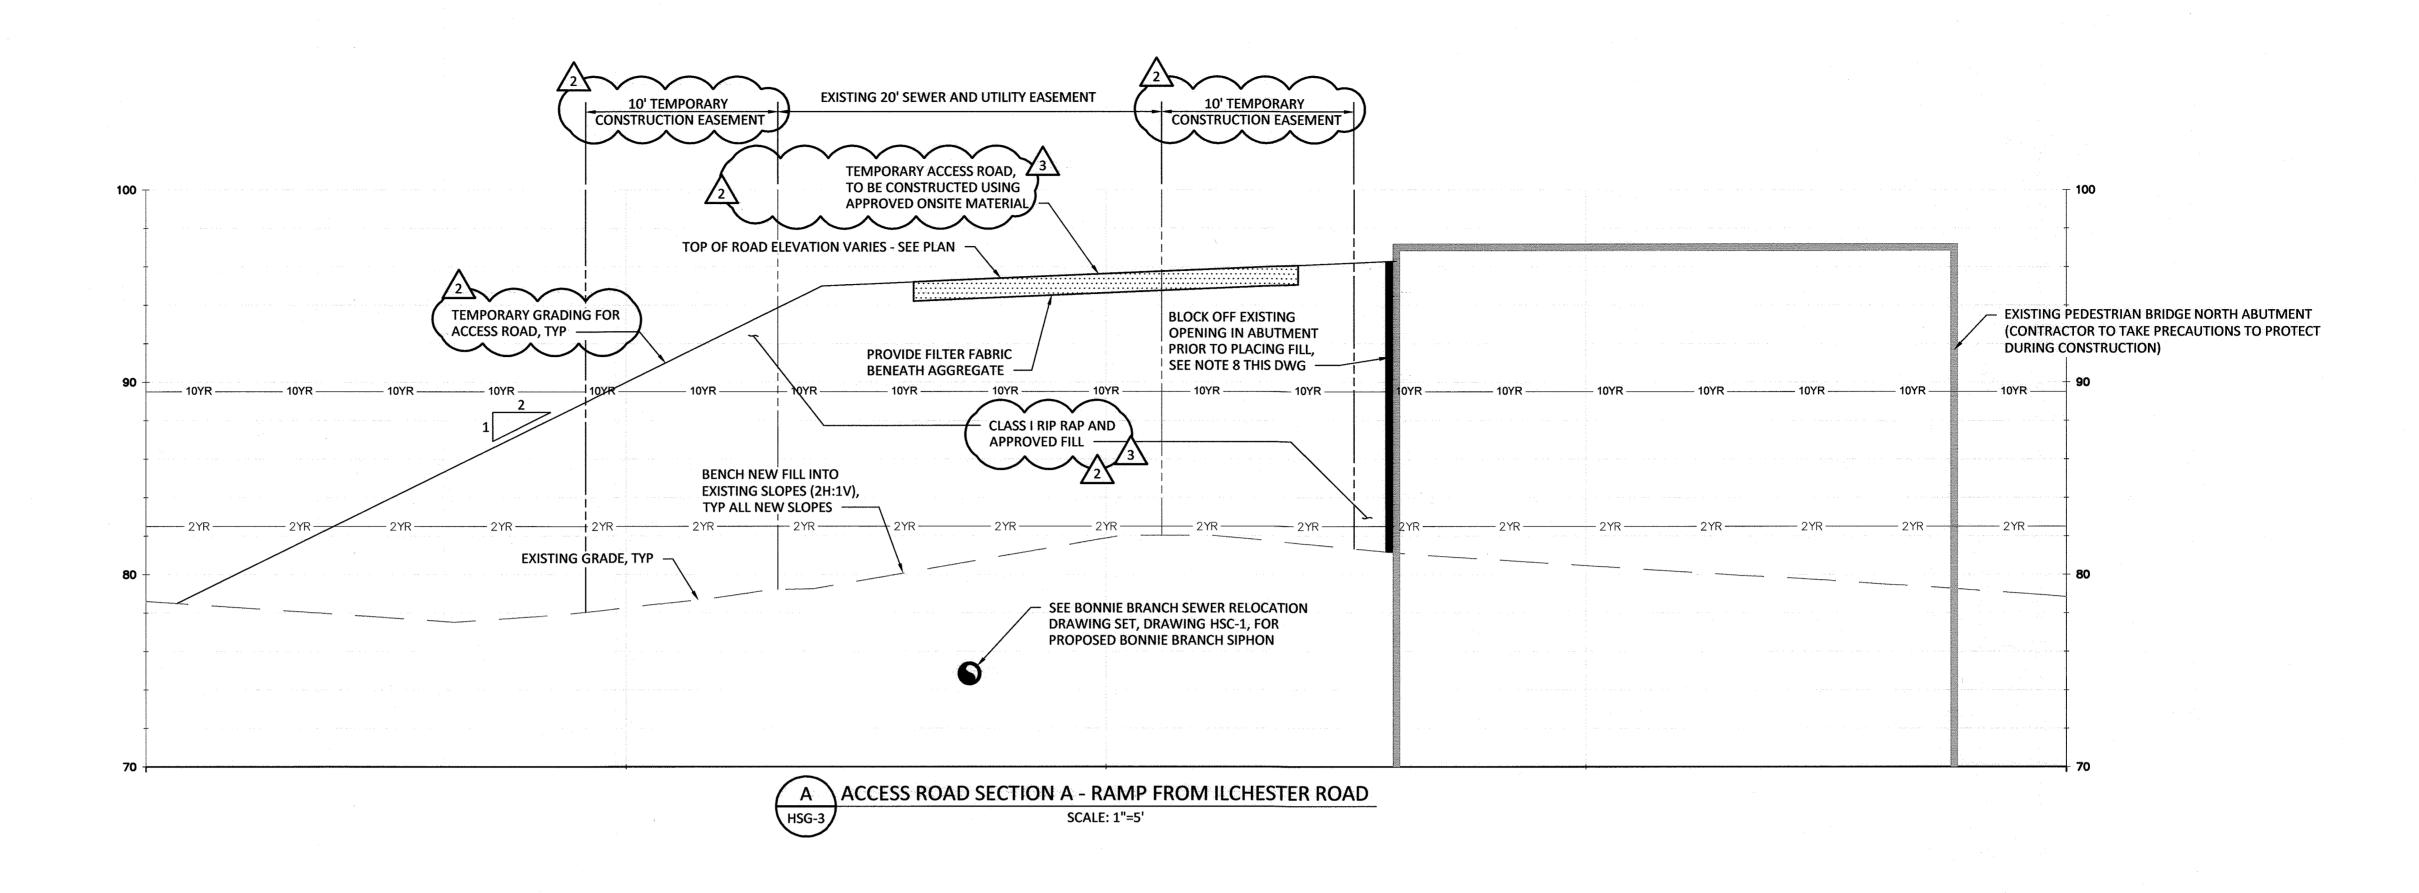
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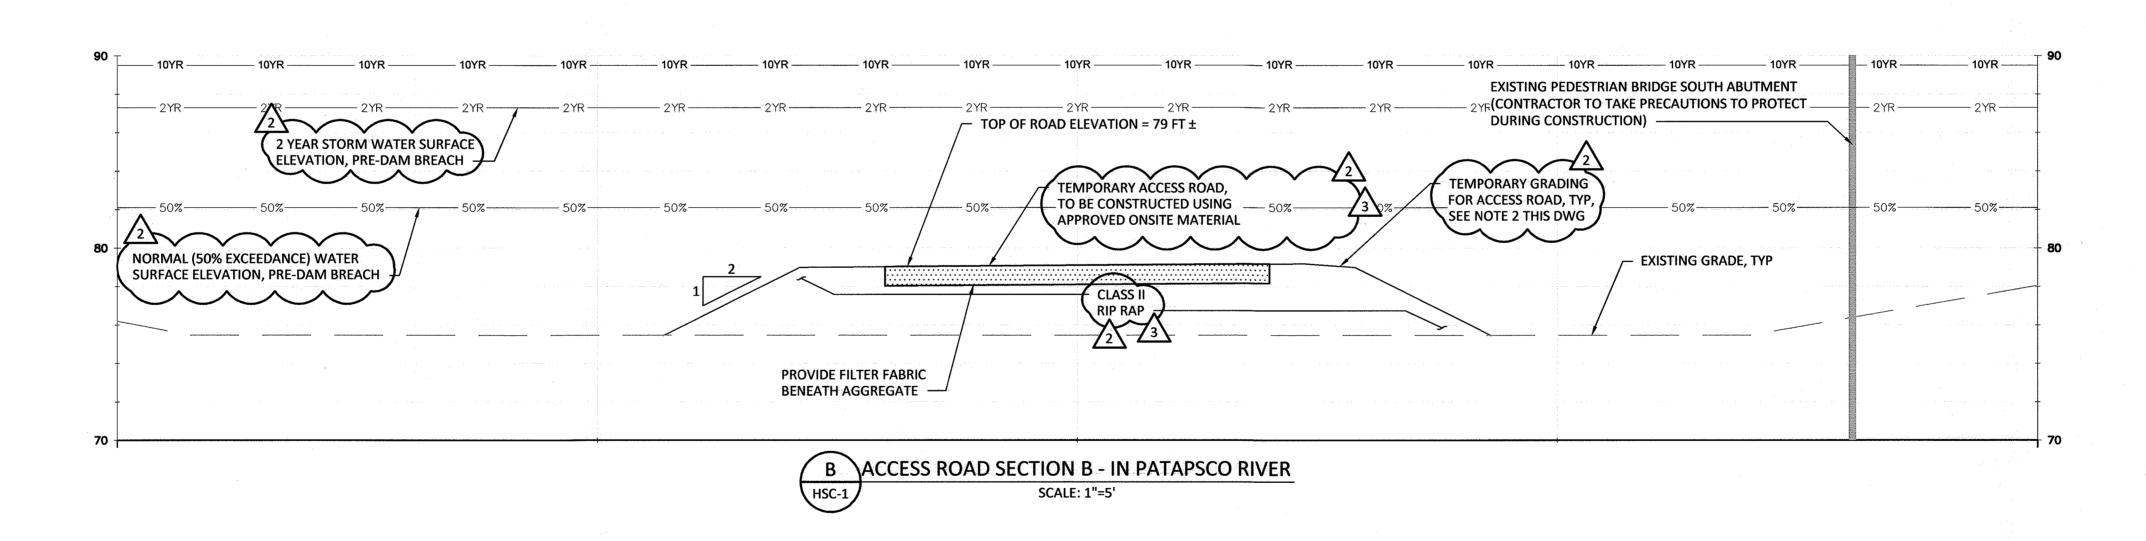




10. WHERE THE TEMPORARY ACCESS ROAD IS ABOVE THE 2-YEAR WSE, IT

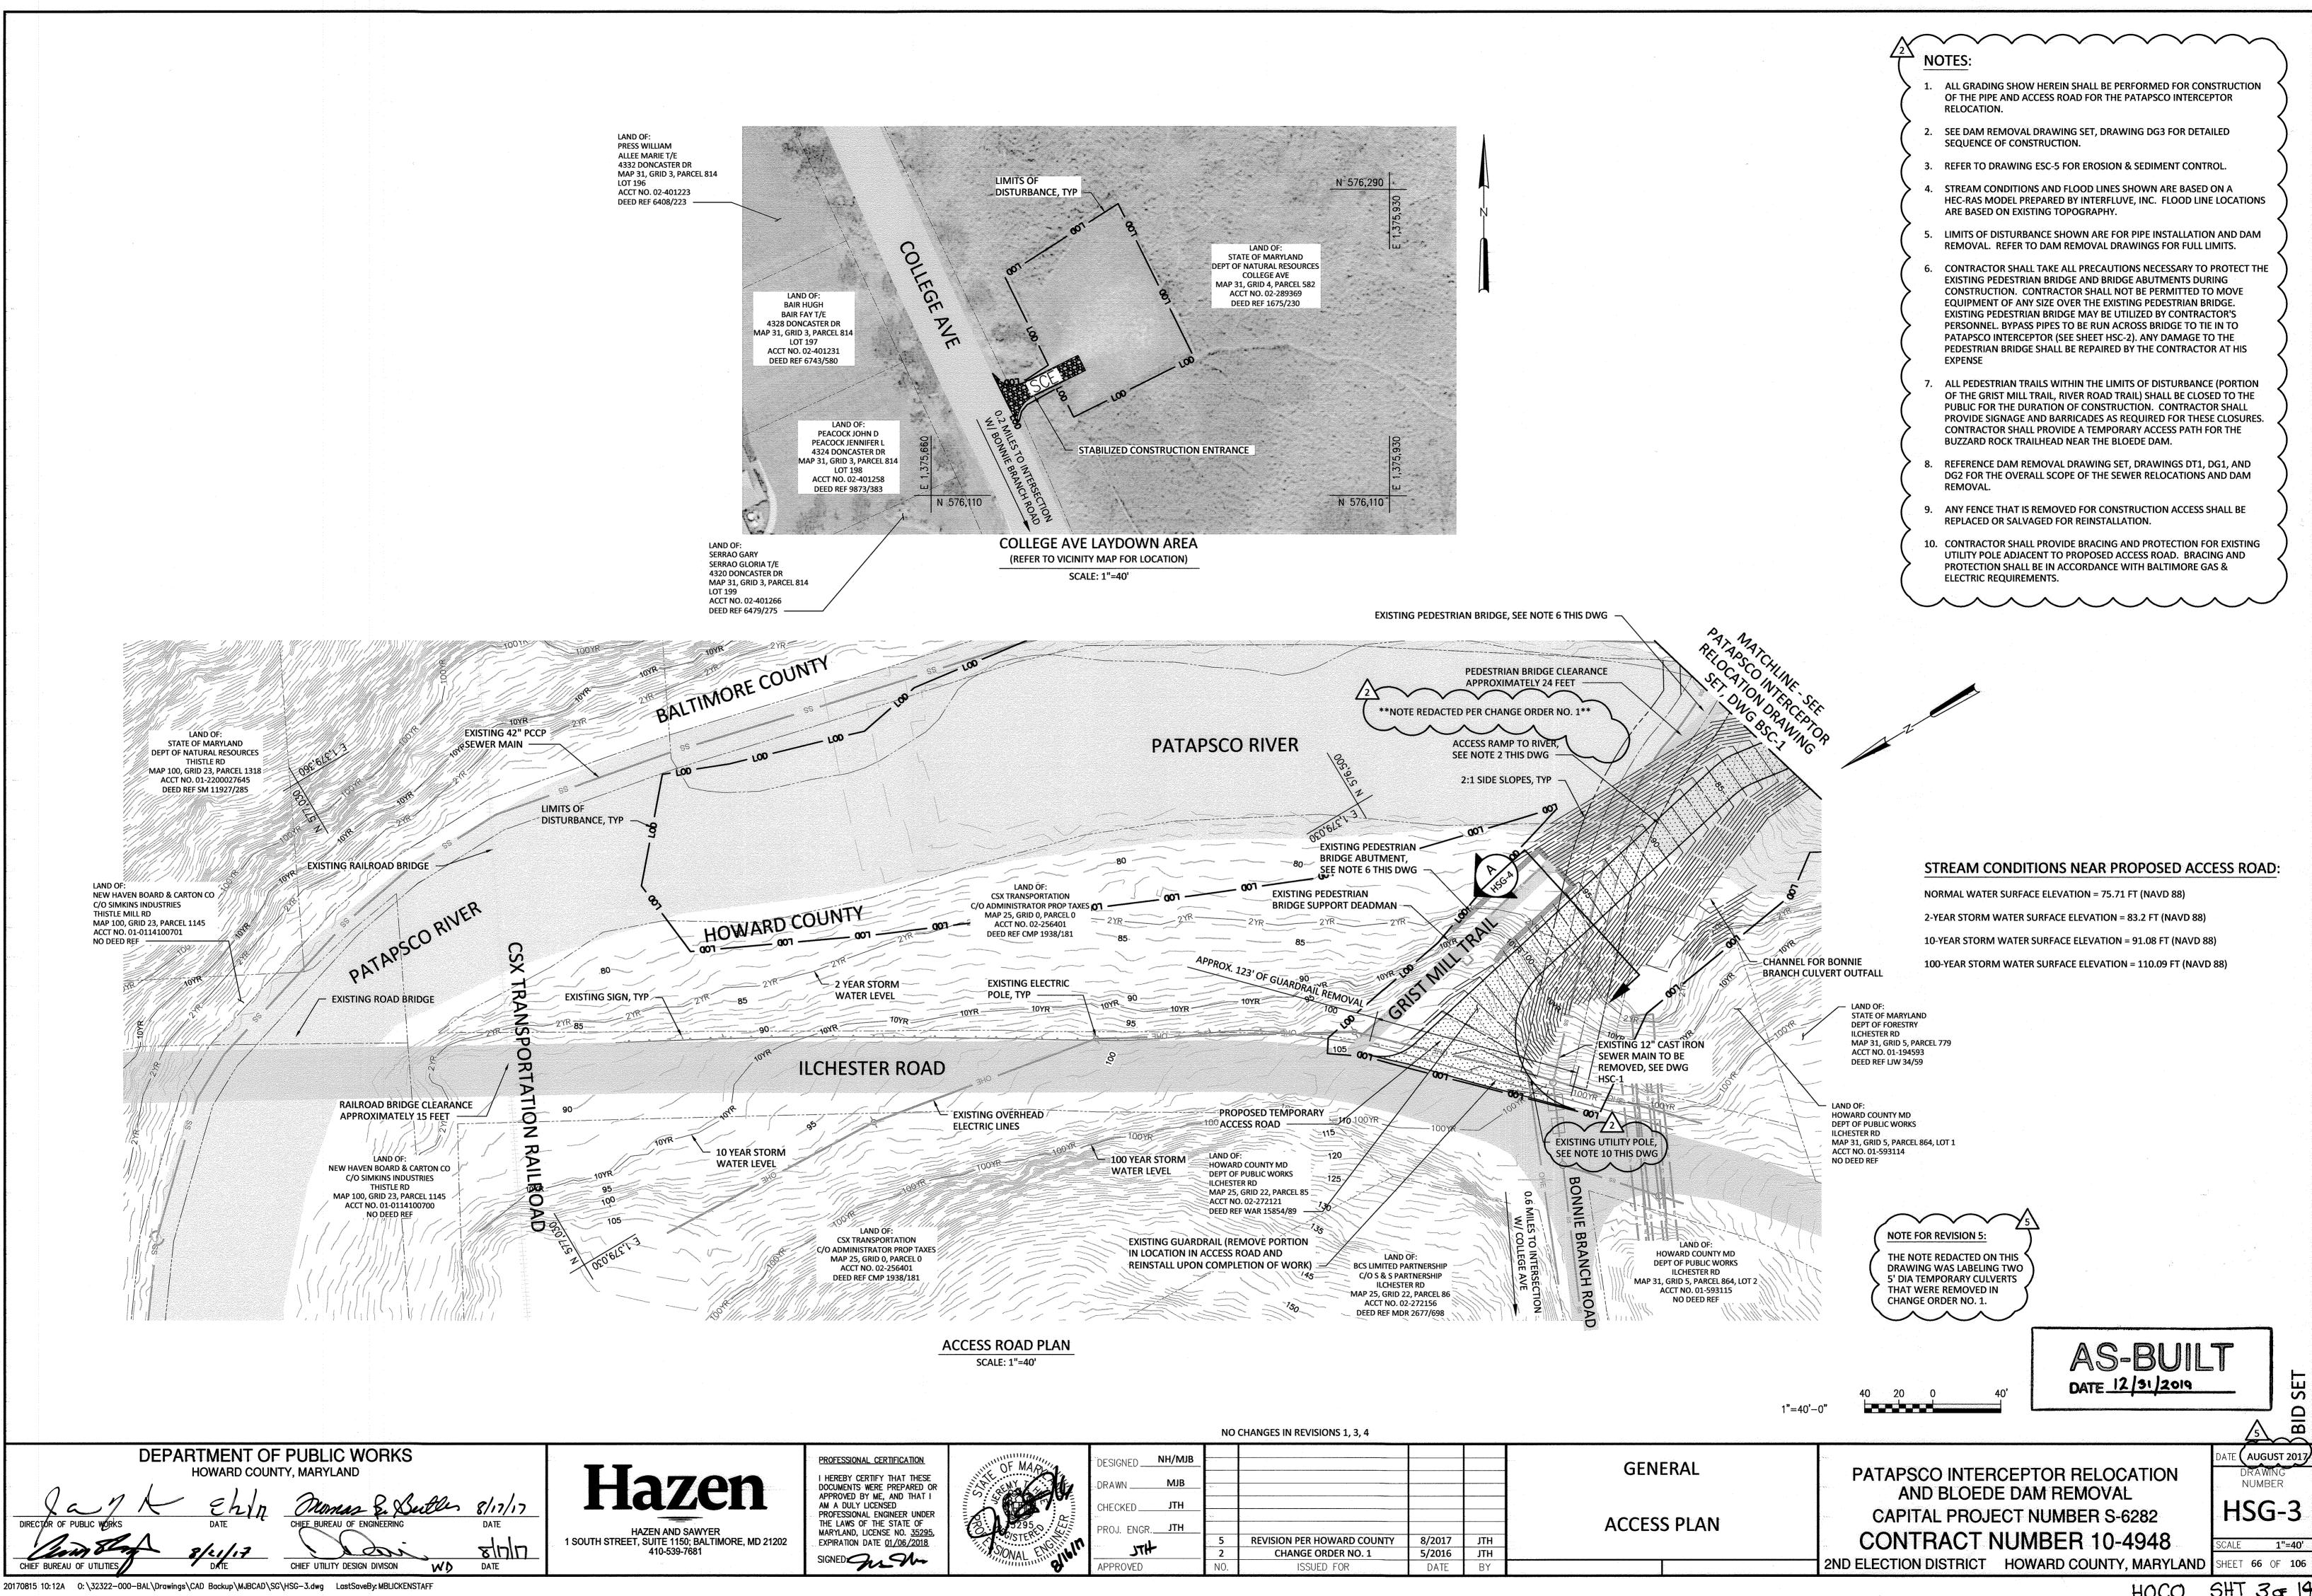SHALL BE CONSTRUCTION OF CLASS I RIP RAP AND APPROVED ONSITE







NO CHANGES IN REVISIONS 1, 4

DEPARTMENT OF PUBLIC WORKS HOWARD COUNTY, MARYLAND

2/17/17 CHIEF UTILITY DESIGN DIVISON

HAZEN AND SAWYER 1 SOUTH STREET, SUITE 1150; BALTIMORE, MD 21202 410-539-7681

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	DESIGNED	NH/MJB				
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111	PROJ. ENGR	JTH	5	REVISION PER HOWARD COUNTY	8/2017	JTH
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•	APPROVED		N0.	ISSUED FOR	DATE	BY

GENERAL ACCESS ROAD SECTIONS


PATAPSCO INTERCEPTOR RELOCATION AND BLOEDE DAM REMOVAL **CAPITAL PROJECT NUMBER S-6282 CONTRACT NUMBER 10-4948** 2ND ELECTION DISTRICT HOWARD COUNTY, MARYLAND SHEET 67 OF 106

ATE (AUGUST 201) NUMBER HSG-4

HOCO SHT 4 OF 14

NOTES:

- 1. RECORD DRAWINGS ARE SHOWN FOR INFORMATION ONLY.
- 2. ELEVATIONS SHOWN ON THIS DRAWING ARE BASED ON NGVD29 VERTICAL DATUM.

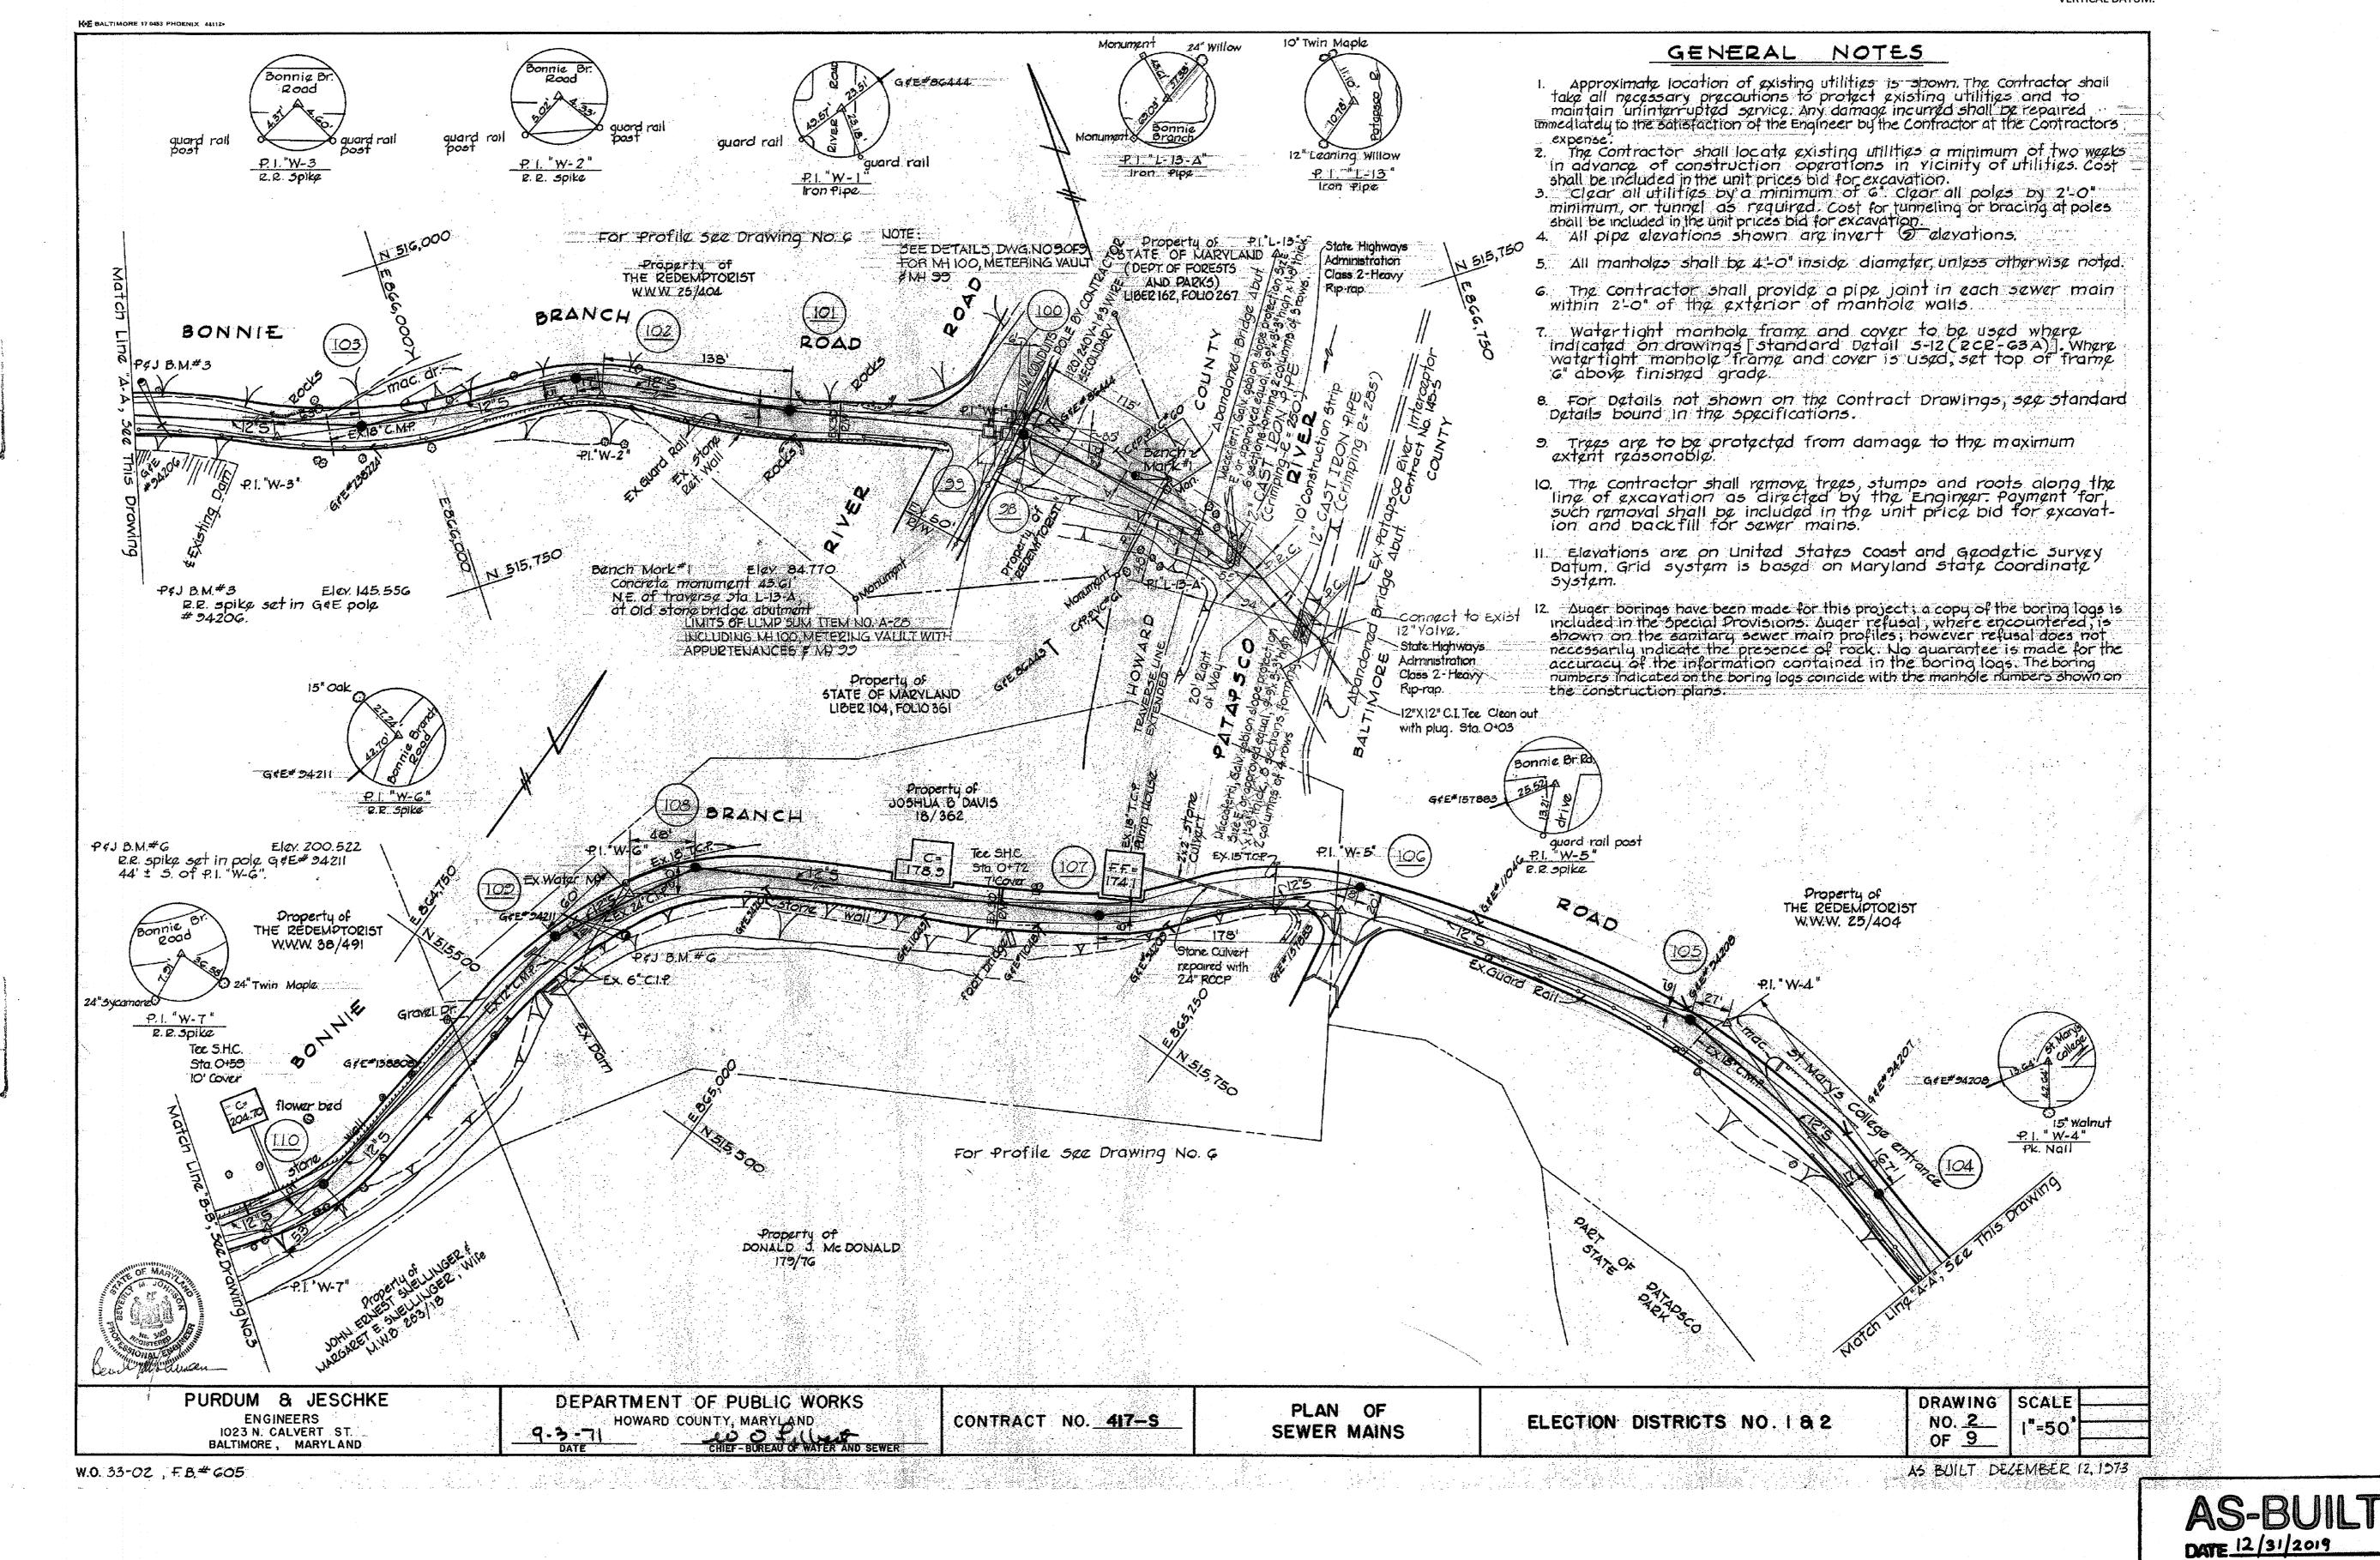

NO CHANGES IN REVISIONS 1, 2, 3, 4

DEPARTMENT OF PUBLIC WORKS HOWARD COUNTY, MARYLAND

HAZEN AND SAWYER 1 SOUTH STREET, SUITE 1150; BALTIMORE, MD 21202 410-539-7681

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DESIGNED NH/MJB					
DRAWN EP			-		
CHECKED JTH				-	
PROJ. ENGR. JTH				-	
111	5	REVISION PER HOWARD COUNTY	8/2017	JTH	
APPROVED	NO.	ISSUED FOR	DATE	BY	

GENERAL BONNIE BRANCH SEWER RECORD DRAWINGS (FOR **INFORMATION ONLY)**

PATAPSCO INTERCEPTOR RELOCATION AND BLOEDE DAM REMOVAL **CAPITAL PROJECT NUMBER S-6282 CONTRACT NUMBER 10-4948** 2ND ELECTION DISTRICT HOWARD COUNTY, MARYLAND SHEET 68 OF 106


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NOTES:

- 1. RECORD DRAWINGS ARE SHOWN FOR INFORMATION ONLY.
- 2. ELEVATIONS SHOWN ON THIS DRAWING ARE BASED ON NGVD29 VERTICAL DATUM.



DEPARTMENT OF PUBLIC WORKS HOWARD COUNTY, MARYLAND CHIEF UTILITY DESIGN DIVISON

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HAZEN AND SAWYER 1 SOUTH STREET, SUITE 1150; BALTIMORE, MD 21202 410-539-7681

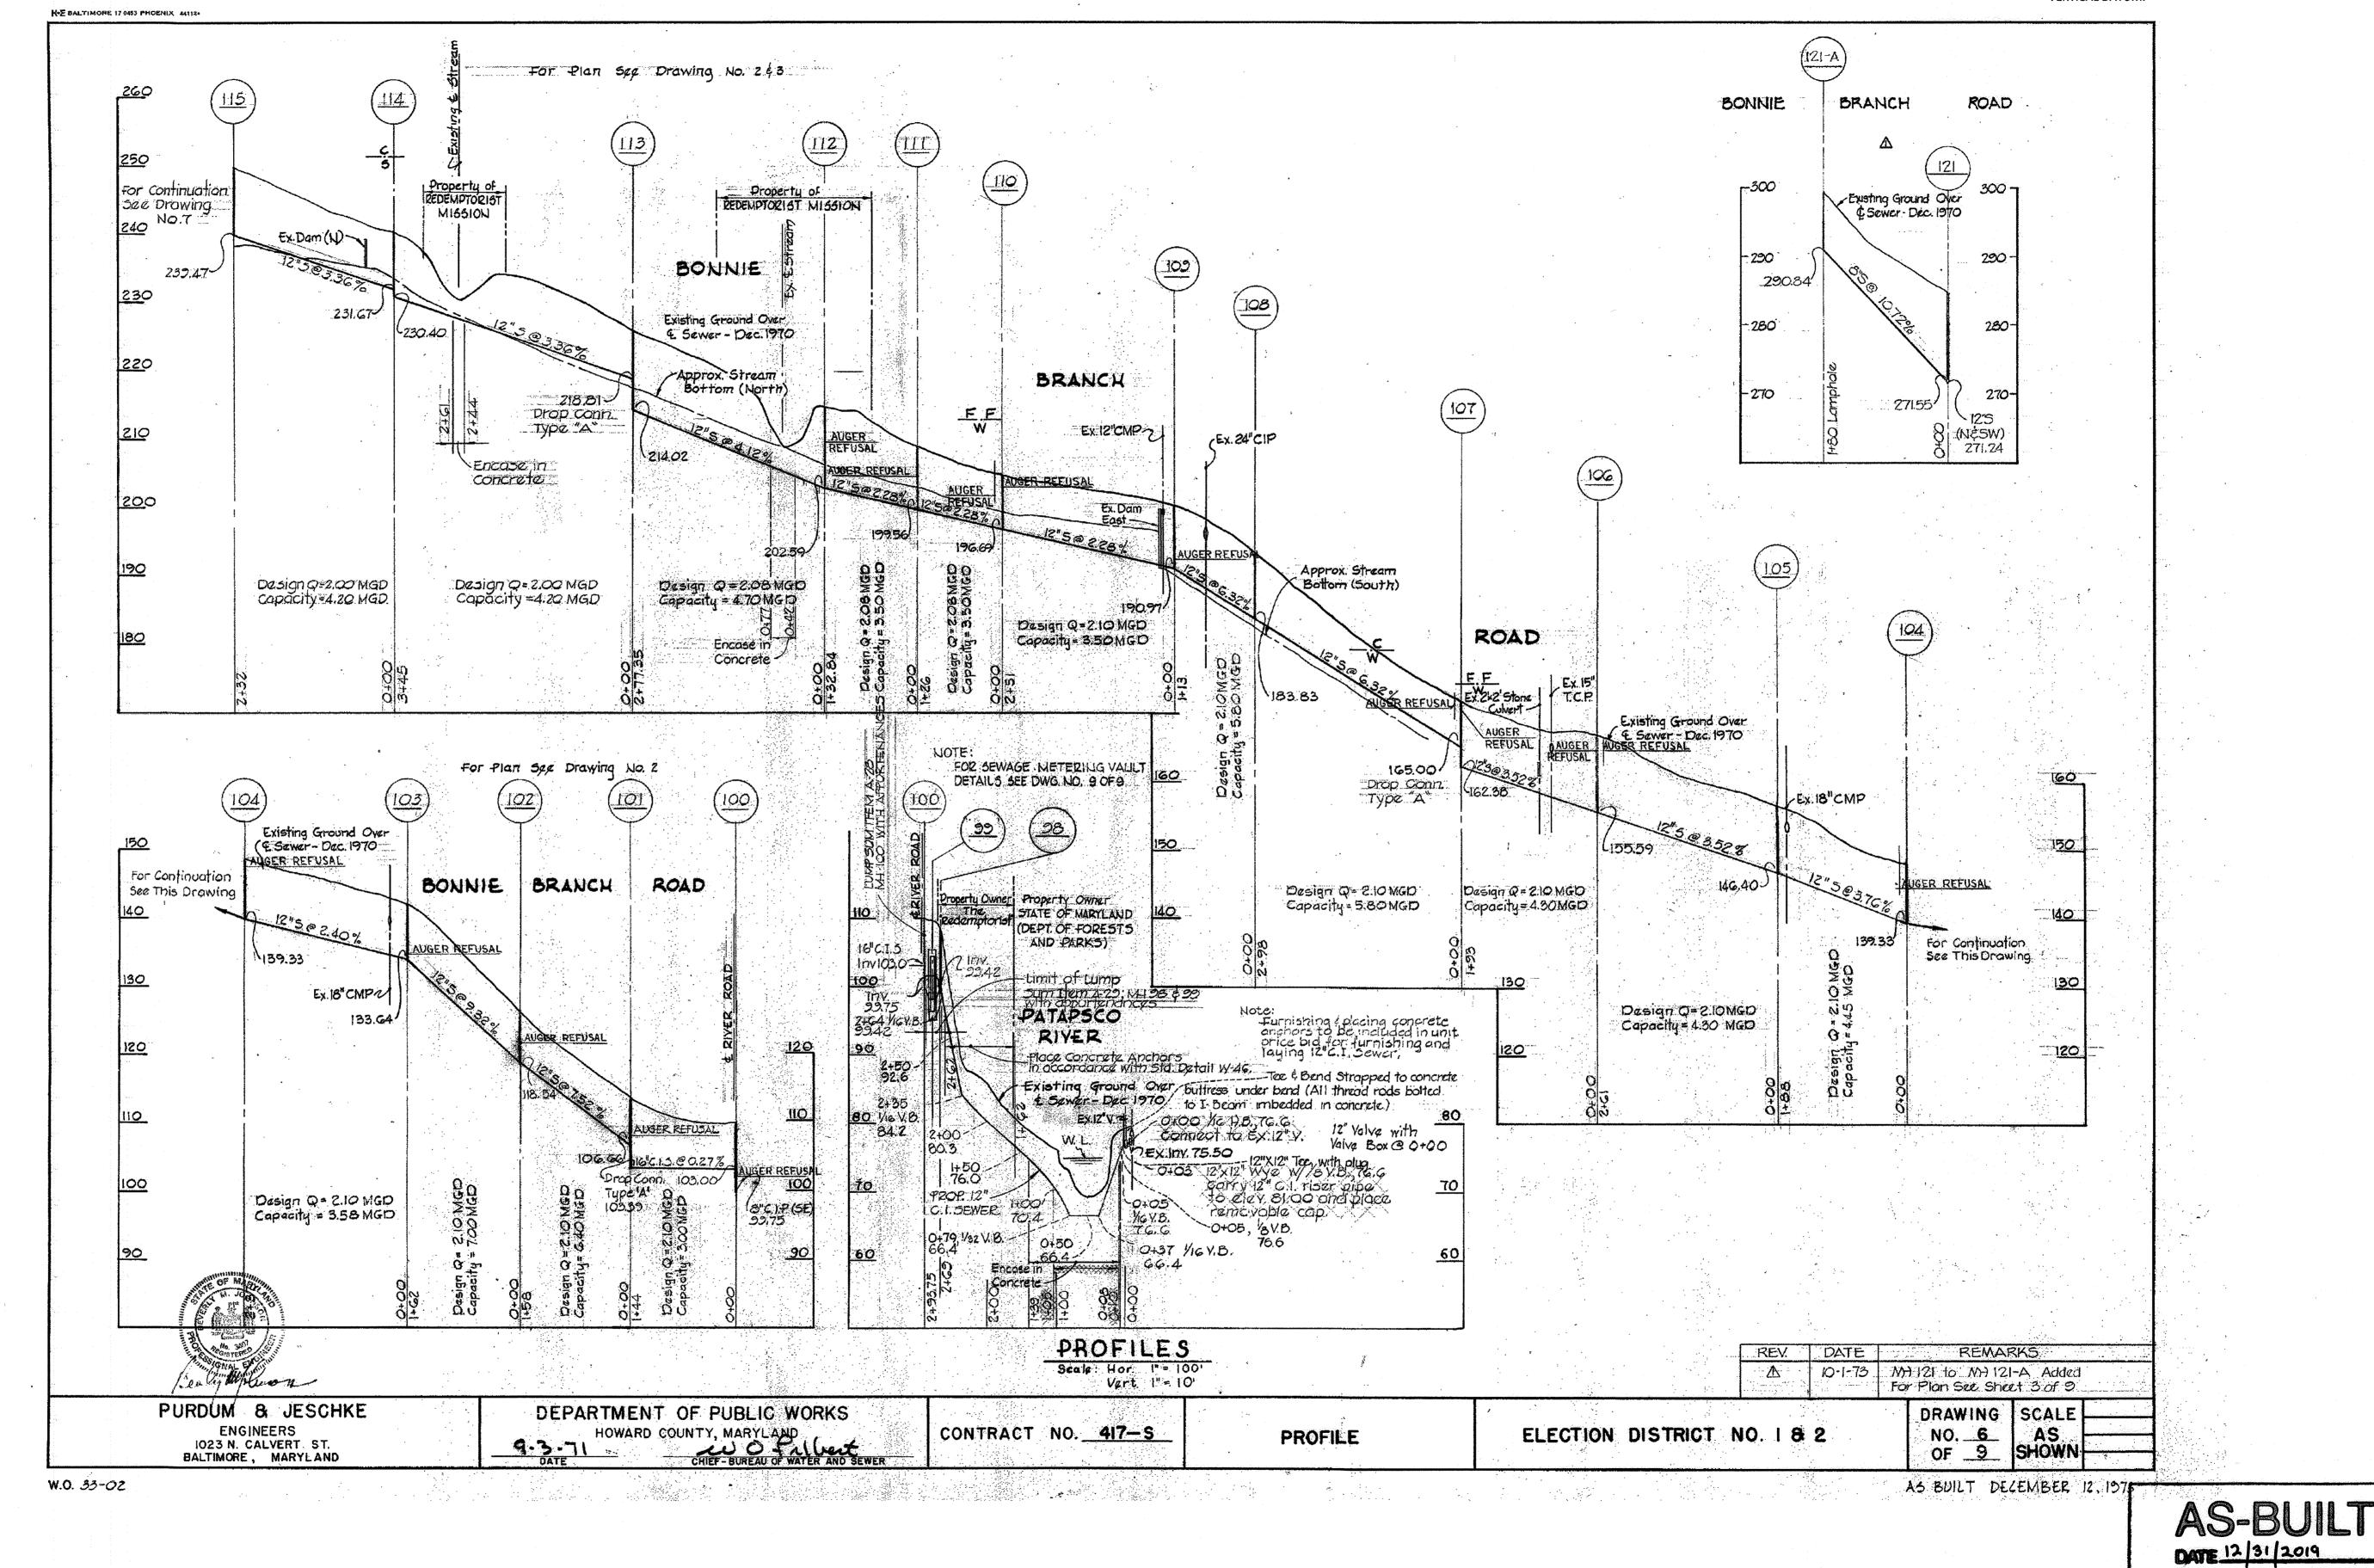PROFESSIONAL CERTIFICATION HEREBY CERTIFY THAT THESE DOCUMENTS WERE PREPARED OR APPROVED BY ME, AND THAT I AM A DULY LICENSED PROFESSIONAL ENGINEER UNDER THE LAWS OF THE STATE OF MARYLAND, LICENSE NO. 35295, EXPIRATION DATE <u>01/06/2018</u> SIGNED:

NH/MJE DESIGNED_ JTH CHECKED_ PROJ. ENGR. JTH 7415

REVISION PER HOWARD COUNTY 8/2017 JTH ISSUED FOR

NO CHANGES IN REVISIONS 1, 2, 3, 4


GENERAL BONNIE BRANCH SEWER RECORD DRAWINGS (FOR INFORMATION ONLY)

PATAPSCO INTERCEPTOR RELOCATION AND BLOEDE DAM REMOVAL **CAPITAL PROJECT NUMBER S-6282 CONTRACT NUMBER 10-4948** 2ND ELECTION DISTRICT HOWARD COUNTY, MARYLAND SHEET 69 OF 106


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SHT G OF 14



HOCO SHT 7 of 14

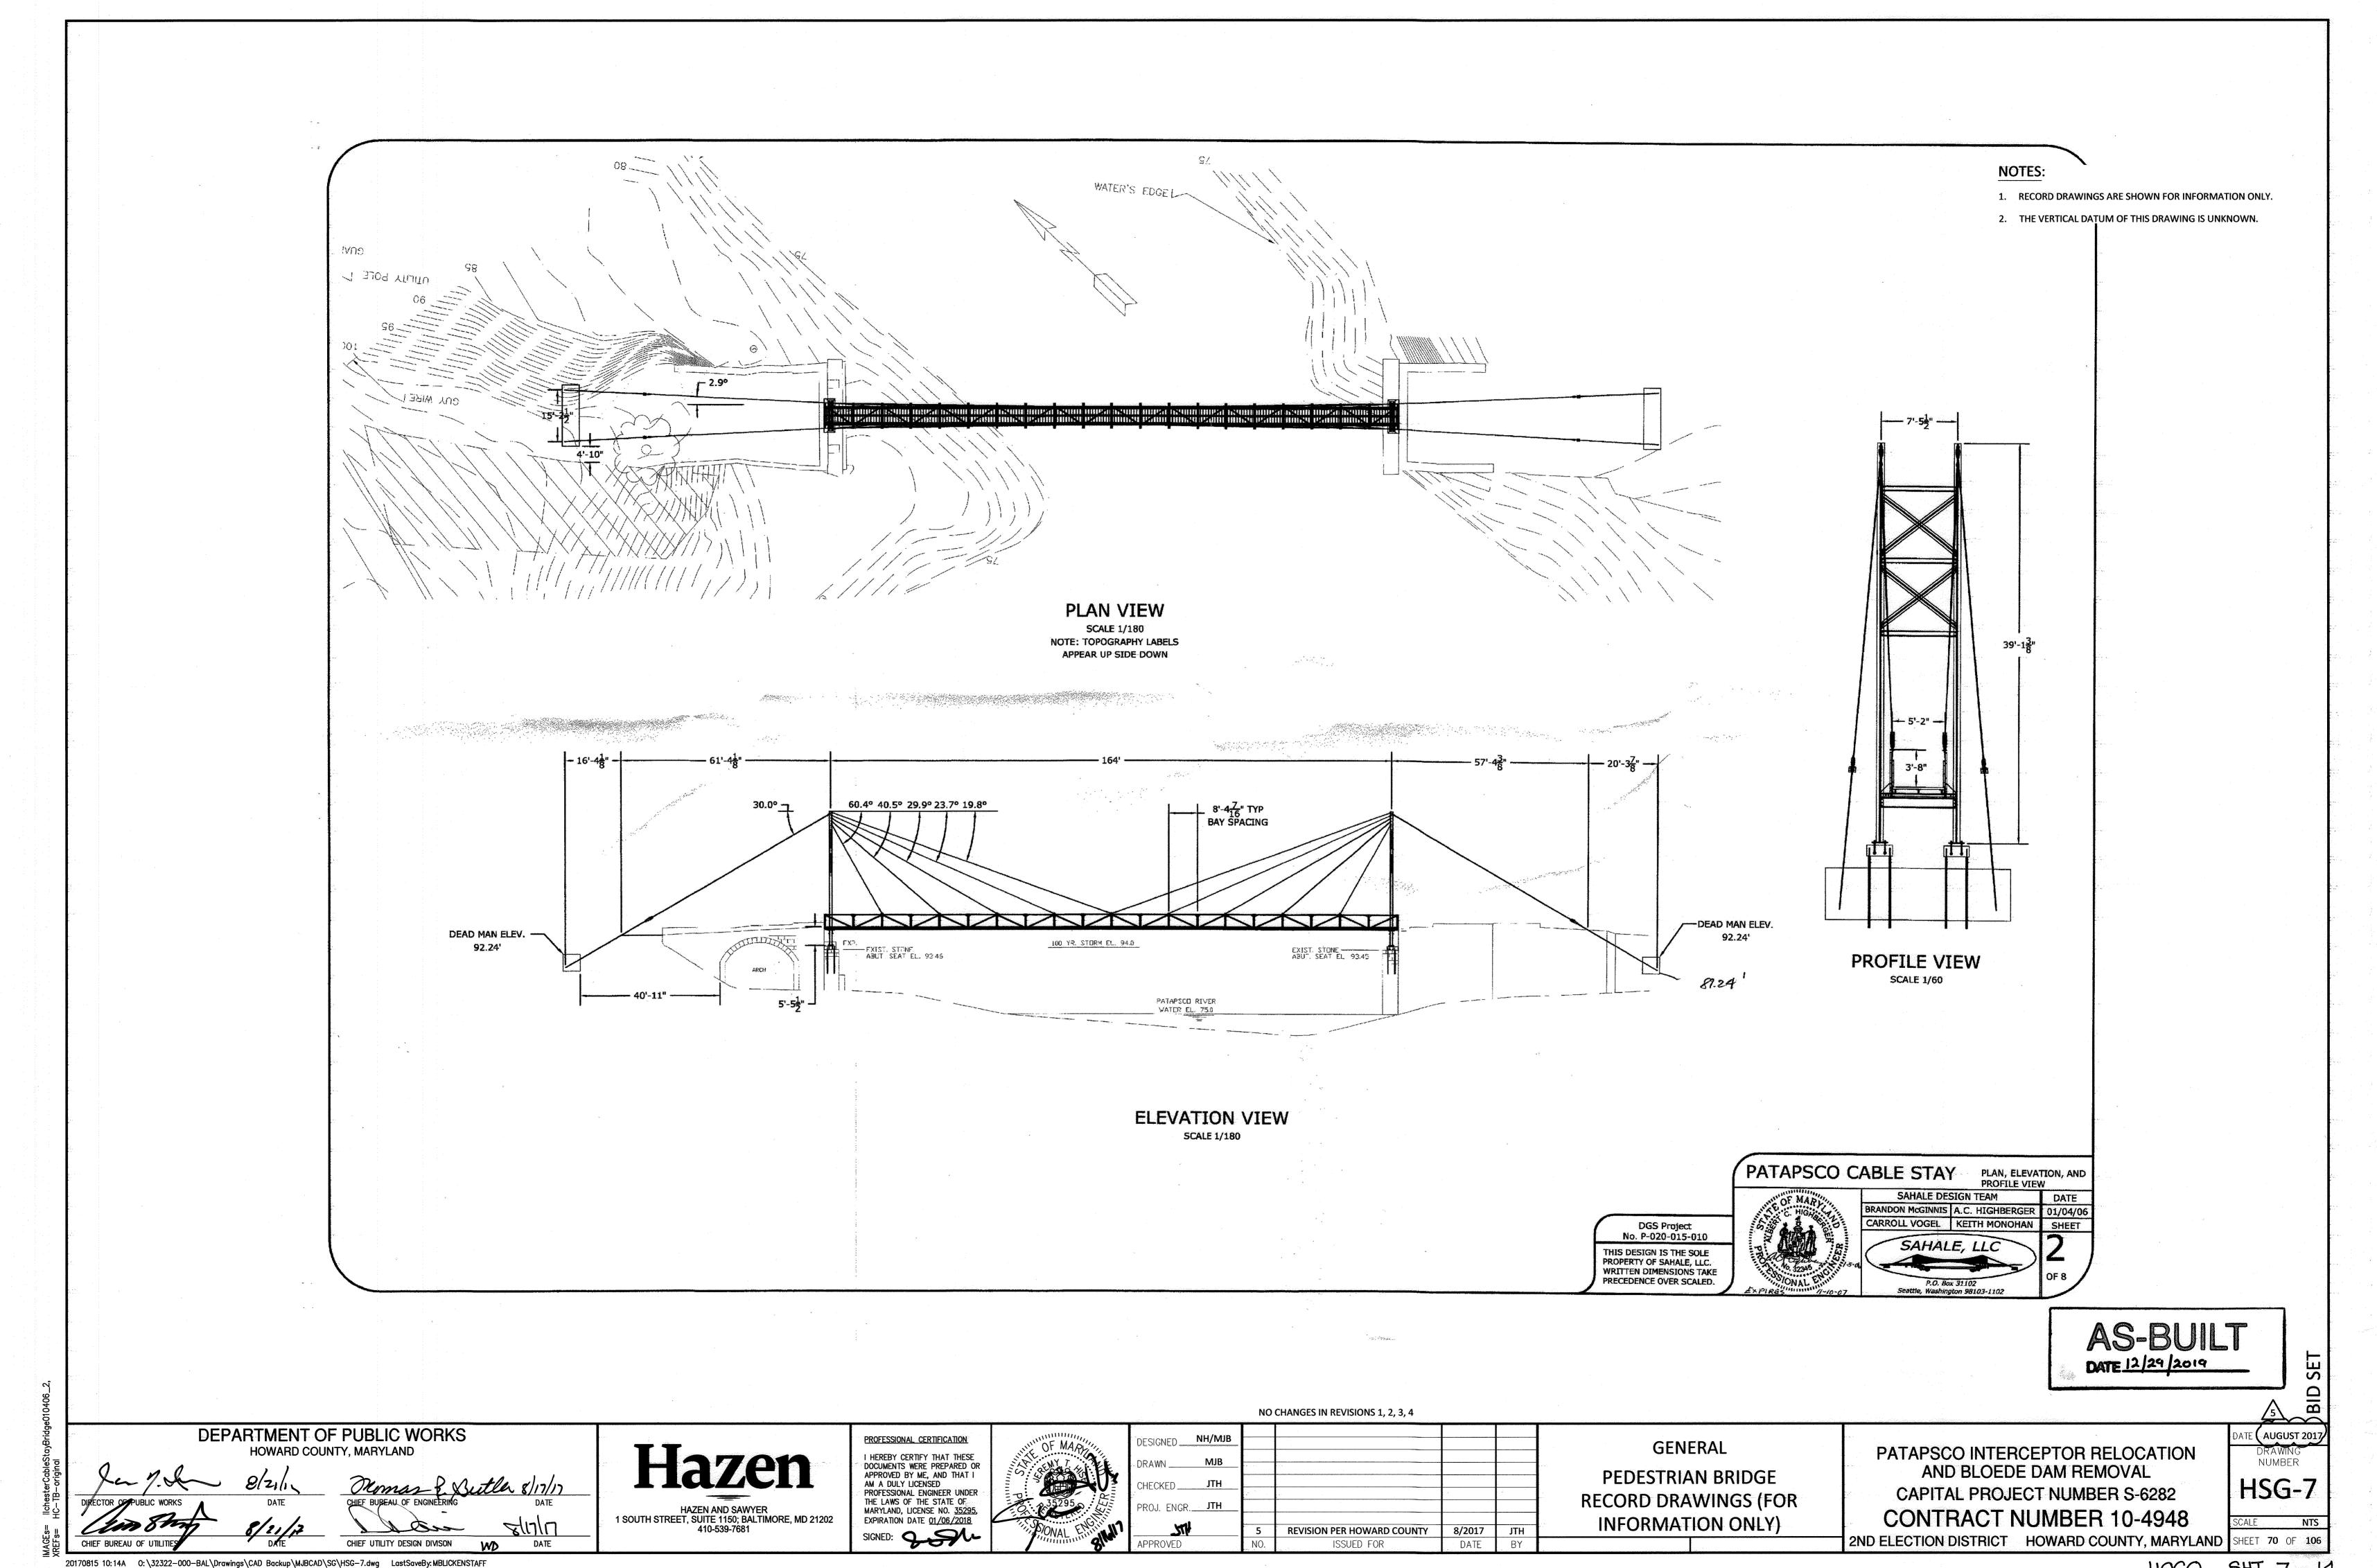

8/2017

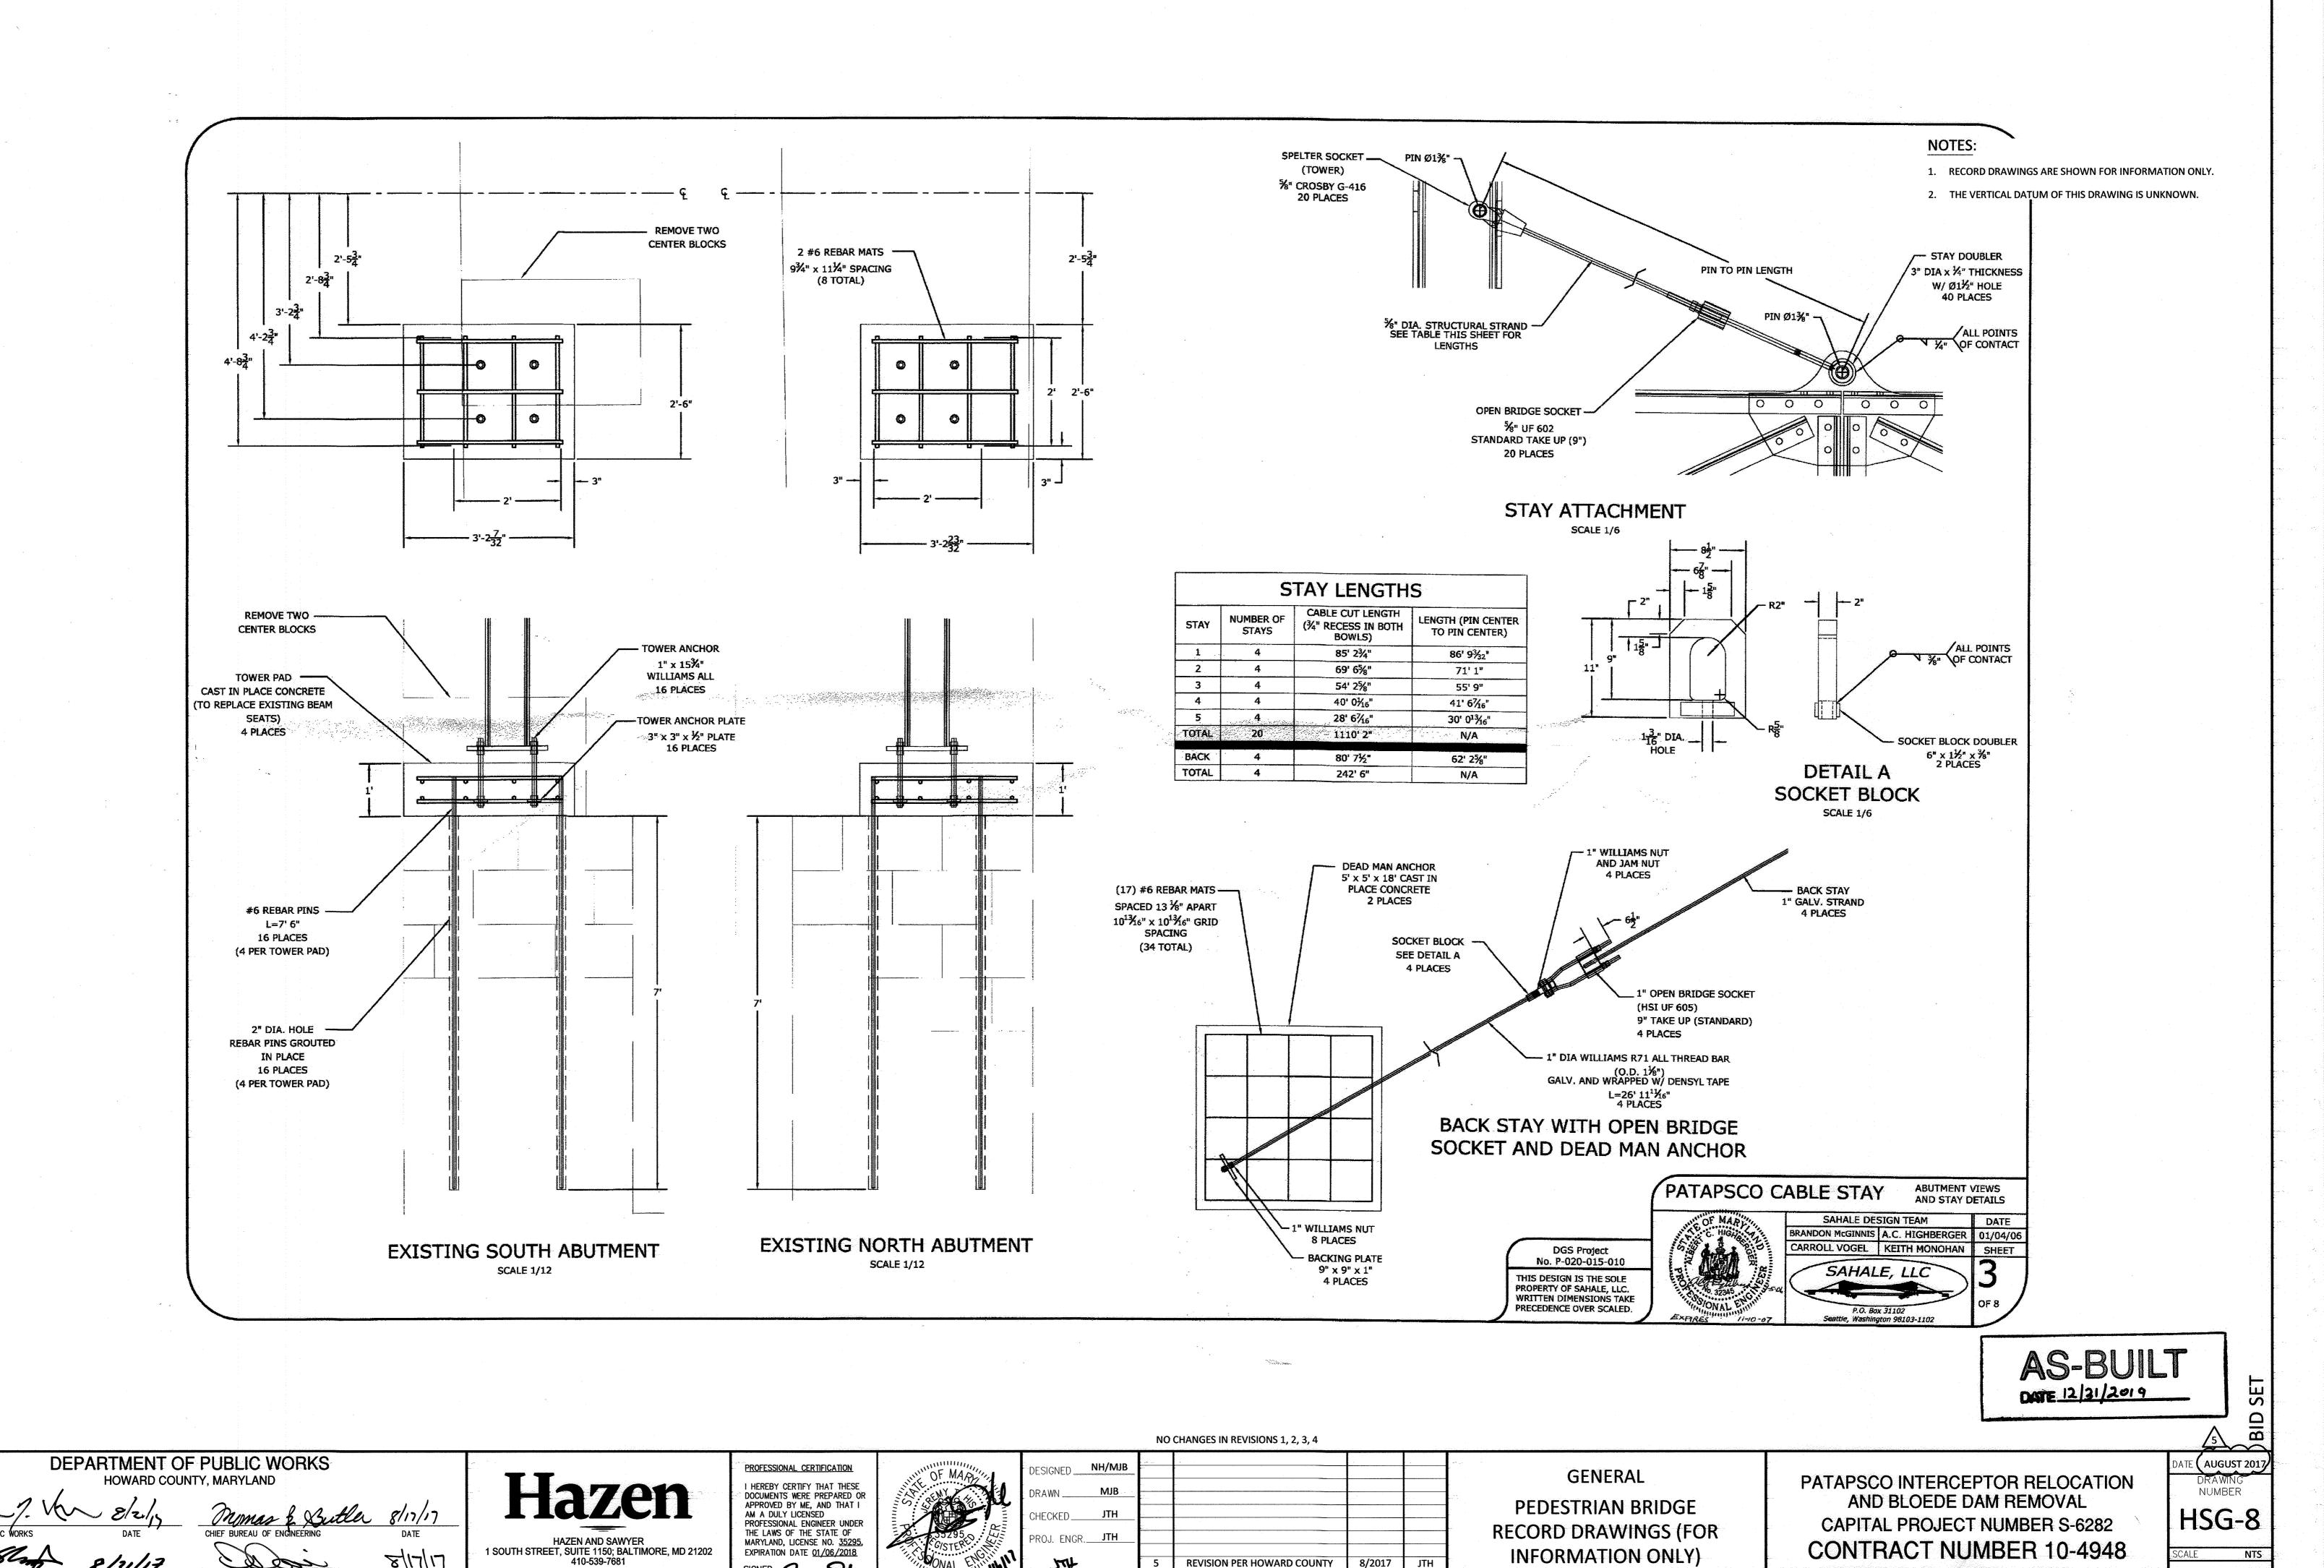DATE

REVISION PER HOWARD COUNTY

ISSUED FOR


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SHT 8 OF 14 HOCO

2ND ELECTION DISTRICT HOWARD COUNTY, MARYLAND SHEET 71 OF 106

NOTES:

1. LIMITS OF DISTURBANCE SHOWN ARE FOR PIPE INSTALLATION AND DAM REMOVAL. REFER TO DAM REMOVAL DRAWINGS FOR FULL LIMITS.

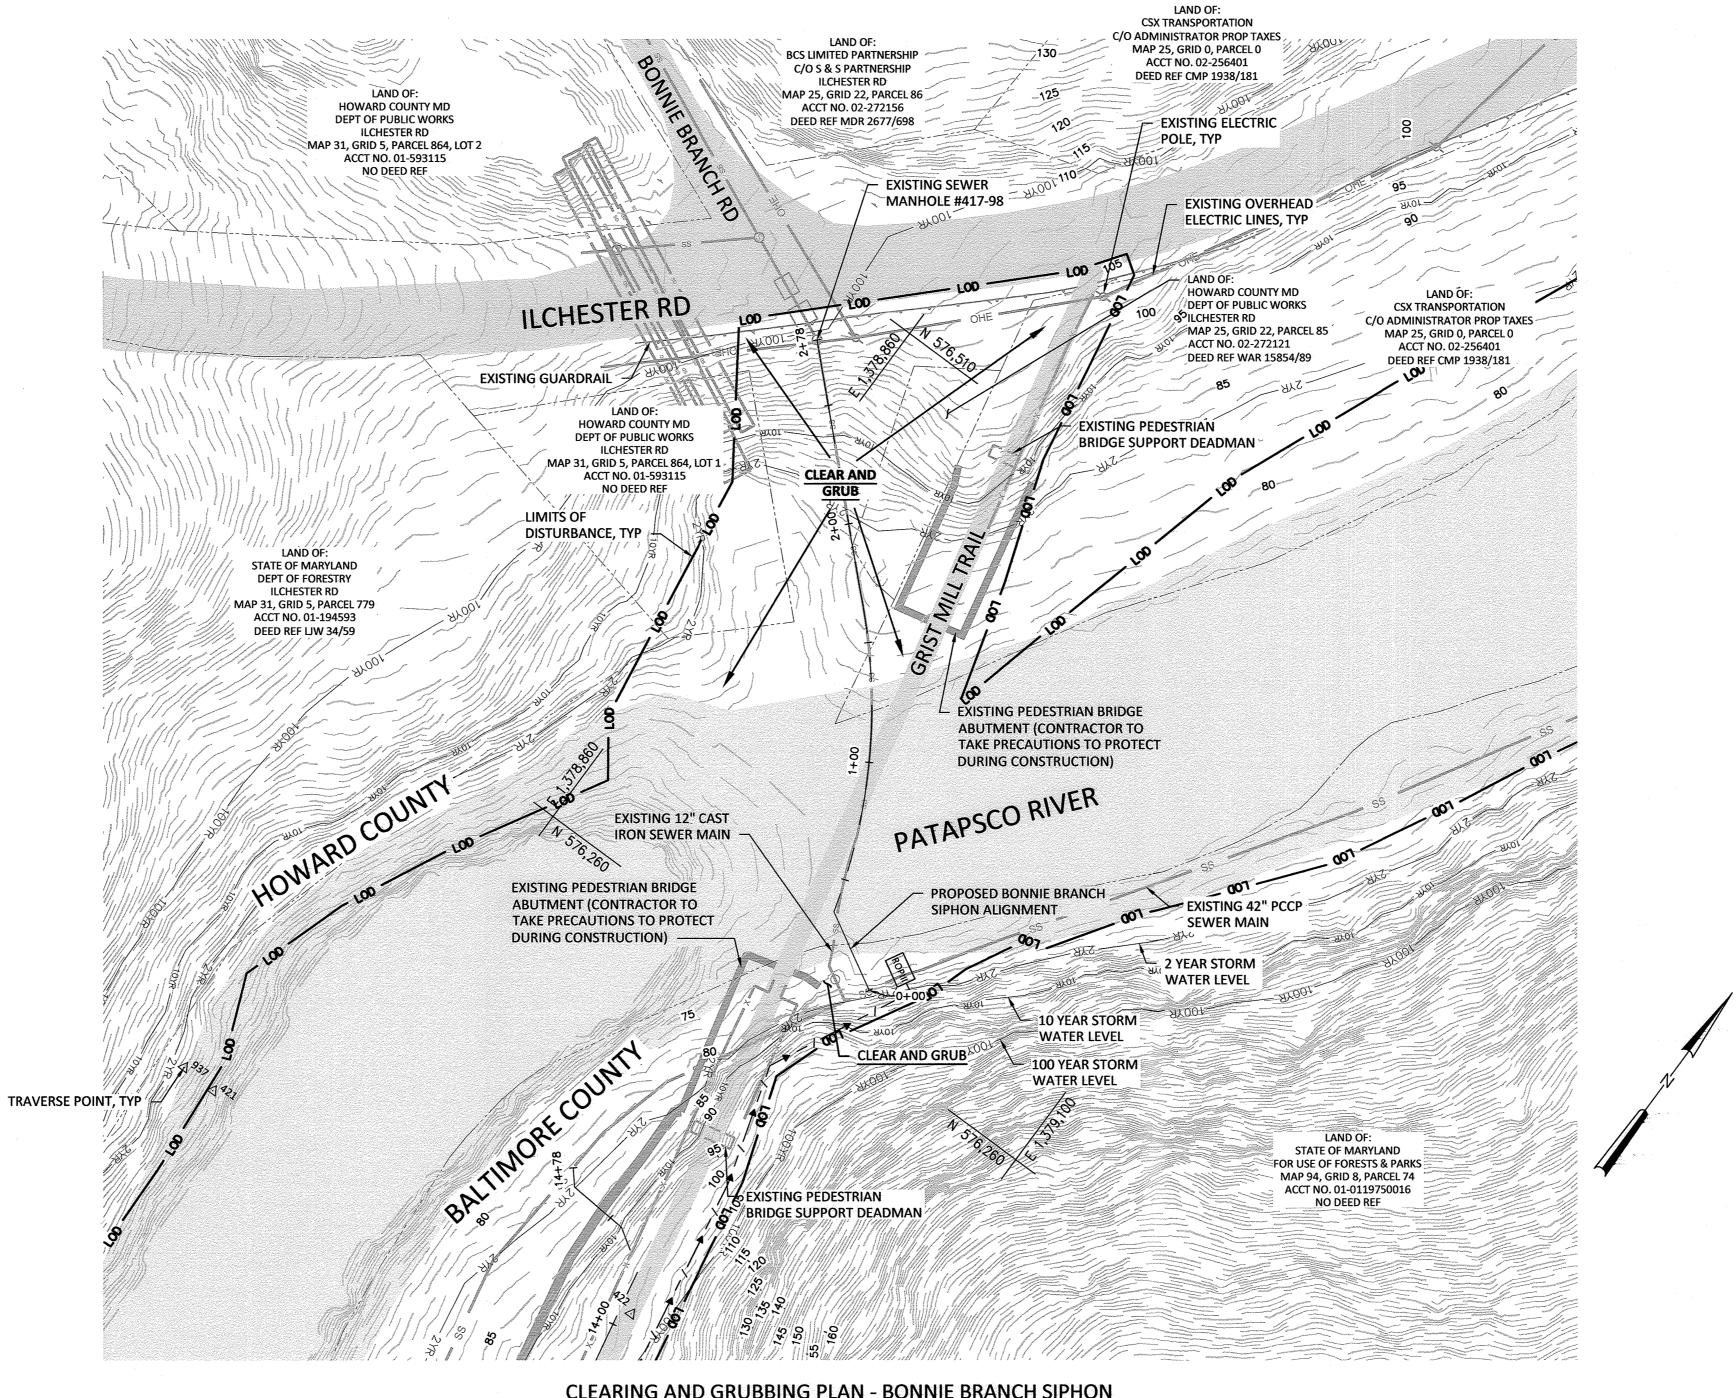

CLEARING AND GRUBBING PLAN - BONNIE BRANCH SIPHON SCALE: 1"=40'

> AS-BUILT DATE 12/31/2019 NO CHANGES IN REVISIONS 1, 2, 3, 4

DEPARTMENT OF PUBLIC WORKS HOWARD COUNTY, MARYLAND

211/17 WA DATE CHIEF UTILITY DESIGN DIVISON

HAZEN AND SAWYER 1 SOUTH STREET, SUITE 1150; BALTIMORE, MD 21202 410-539-7681

PROFESSIONAL CERTIFICATION I HEREBY CERTIFY THAT THESE DOCUMENTS WERE PREPARED OR APPROVED BY ME, AND THAT I AM A DULY LICENSED PROFESSIONAL ENGINEER UNDER THE LAWS OF THE STATE OF MARYLAND, LICENSE NO. 35295, EXPIRATION DATE 01/06/2018 SIGNED: 9xx90




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1	711	·	5	REVISION PER HOWARD COUNTY	8/2017	JTH	L
	APPROVED		NO.	ISSUED FOR	DATE	BY	

CIVIL **CLEARING AND GRUBBING PLAN**

PATAPSCO INTERCEPTOR RELOCATION AND BLOEDE DAM REMOVAL CAPITAL PROJECT NUMBER S-6282 CONTRACT NUMBER 10-4948 2ND ELECTION DISTRICT HOWARD COUNTY, MARYLAND SHEET 72 OF 106

DRAWING NUMBER HSR-1 SCALE **1"=40**'

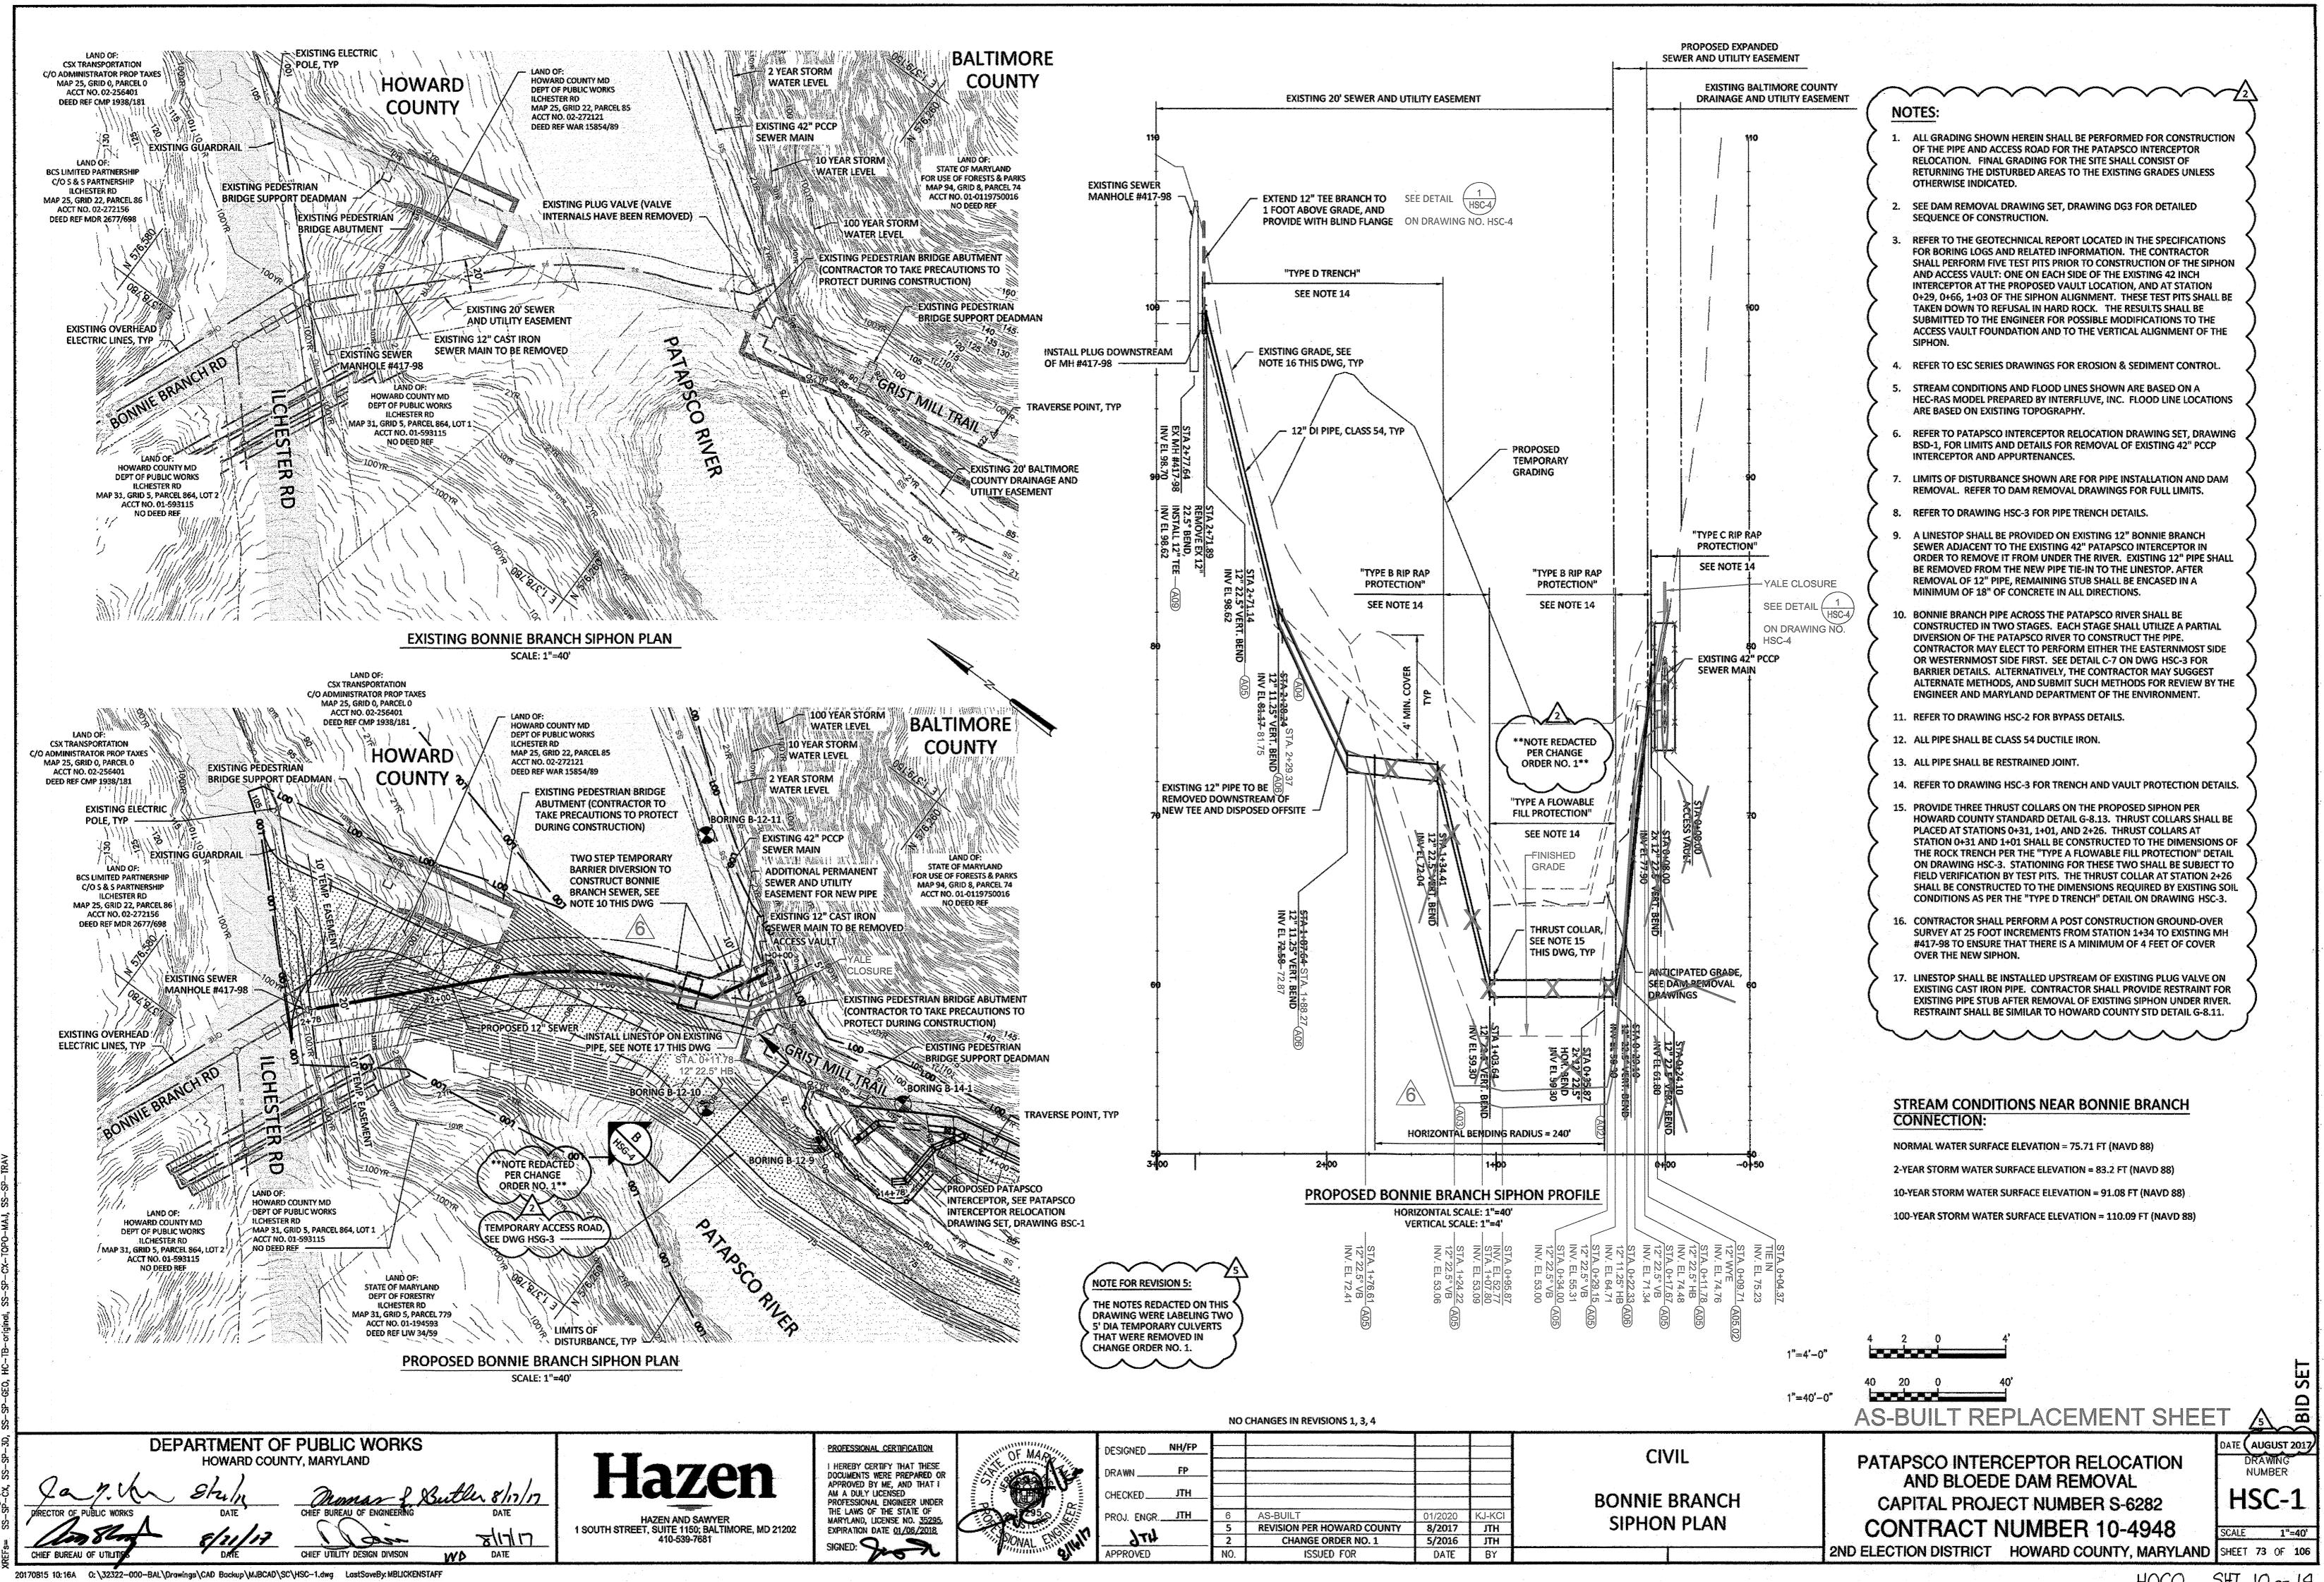

NOTES: 1. THE BYPASS PUMP PLAN SHOWN HEREON IS GENERAL AND SHALL BE USED FOR INFORMATIONAL PURPOSES ONLY. CONTRACTOR SHALL SUBMIT, FOR APPROVAL, A DETAILED BYPASS PLAN SIGNED AND SEAL BY A PROFESSIONAL ENGINEER REGISTERED IN THE STATE OF MARYLAND. 2. WHERE THE BYPASS ALIGNMENT IS RUNNING ALONG STEEP SLOPES OR AGAINST THE GRADE ALONG AN EMBANKMENT, THE CONTRACTOR SHALL SECURE THE BYPASS PIPING TO PROTECT IT DURING CONSTRUCTION. PIPE PROTECTION PLANS AND DETAILS SHALL BE SUBMITTED AS PART OF THE AFOREMENTIONED BYPASS PLAN. STREAM CONDITIONS NEAR BONNIE BRANCH **CONNECTION:** NORMAL WATER SURFACE ELEVATION = 75.71 FT (NAVD 88) 2-YEAR STORM WATER SURFACE ELEVATION = 83.2 FT (NAVD 88) 10-YEAR STORM WATER SURFACE ELEVATION = 91.08 FT (NAVD 88) 100-YEAR STORM WATER SURFACE ELEVATION = 110.09 FT (NAVD 88) **BONNIE BRANCH SEWER BYPASS CRITERIA:** MAXIMUM WET WEATHER FLOW = 4.4 MGD AVERAGE FLOW = 1.0 MGD NOTE: BYPASS PUMPING SYSTEM MUST BE MANNED 24 HOURS PER DAY, 7 DAYS A WEEK, FOR THE DURATION OF THE BYPASS PUMPING OPERATION.

NOTE FOR REVISION 5

THE NOTE REDACTED ON THIS

**NOTE REDACTED
PER CHANGE
ORDER NO. 1** DRAWING WAS LABELING BYPASS PIPE OPTION 2 THAT WAS REMOVED IN CHANGE ORDER NO. 1. PROPOSED BONNIE BRANCH BYPASS PLAN

STATE OF MARYLAND

FOR USE OF FORESTS & PARKS

MAP 94, GRID 8, PARCEL 74 ACCT NO. 01-0119750016 NO DEED REF

TRAVERSE POINT, TYP


PROPOSED PATAPSCO

INTERCEPTOR, SEE PATAPSCO

BYPASS OPTION 1: CONNECT TO NEW

ACCESS MH #2

INTERCEPTOR RELOCATION

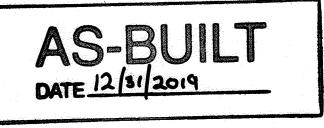

1"=40'-0"

DEPARTMENT OF PUBLIC WORKS HOWARD COUNTY, MARYLAND

ह्यागा CHIEF UTILITY DESIGN DIVISON WD

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HAZEN AND SAWYER 1 SOUTH STREET, SUITE 1150; BALTIMORE, MD 21202 410-539-7681

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APPROVED BY ME, AND THAT I
AM A DULY LICENSED PROFESSIONAL ENGINEER UNDER THE LAWS OF THE STATE OF MARYLAND, LICENSE NO. 35295, EXPIRATION DATE 01/06/2018

SIGNED:

CSX TRANSPORTATION

C/O ADMINISTRATOR PROP TAXES MAP 25, GRID 0, PARCEL 0

ACCT NO. 02-256401

DEED REF CMP 1938/181

EXISTING SEWER

MANHOLE #417-98

HOWARD COUNTY MD DEPT OF PUBLIC WORKS

ILCHESTER RD

MAP 31, GRID 5, PARCEL 864, LOT 1 ACCT NO. 01-593115 NO DEED REF

STATE OF MARYLAND

DEPT OF FORESTRY

ILCHESTER RD MAP 31, GRID 5, PARCEL 779

ACCT NO. 01-194593

DEED REF LJW 34/59

EXISTING PEDESTRIAN

EXISTING GUARDRAIL

BRIDGE SUPPORT DEADMAN

HESTER RD

HOWARD

CSX TRANSPORTATION

C/O ADMINISTRATOR PROP TAXES

MAP 25, GRID 0, PARCEL 0

ACCT NO. 02-256401

DEED REF CMP 1938/181

BCS LIMITED PARTNERSHIP

C/O S & S PARTNERSHIP ILCHESTER RD MAP 25, GRID 22, PARCEL 86 ACCT NO. 02-272156 DEED REF MDR 2677/698

EXISTING ELECTRIC

PARKING FOR BYPASS

EXISTING OVERHEAD

ELECTRIC LINES, TYP

HOWARD COUNTY MD DEPT OF PUBLIC WORKS ILCHESTER RD MAP 31, GRID 5, PARCEL 864, LOT 2 ACCT NO. 01-593115

PUMPS ALONG SHOULDER

HOWARD COUNTY MD DEPT OF PUBLIC WORKS

ACCT NO. 02-272121

DEED REF WAR 15854/89

MAP 25, GRID 22, PARCEL 85

 BYPASS PIPES TO BE RUN ACROSS BRIDGE TO TIE-IN TO PATAPSCO

INTERCEPTOR (ANY DAMAGE TO

THE CONTRACTOR AT HIS EXPENSE)

DURING CONSTRUCTION)

THE BRIDGE SHALL BE REPAIRED BY

EXISTING PEDESTRIAN BRIDGE

ABUTMENT (CONTRACTOR TO

EXISTING 12" CAST IRON

SEWER MAIN TO BE REMOVED

SCALE: 1"=40'

TAKE PRECAUTIONS TO PROTECT

ILCHESTER RD

PROPOSED 12" SEWER

TEMPORARY ACCESS ROAD, SEE DWG HSG-3

DISTURBANCE, TY



NH/MJB DESIGNED_ CHECKED_ PROJ. ENGR. JTH JTH 8/2017 **REVISION PER HOWARD COUNTY CHANGE ORDER NO. 1** 5/2016 JTH ISSUED FOR

NO CHANGES IN REVISIONS 1, 3, 4

100 YEAR STORM

10 YEAR STORM

EXISTING PEDESTRIAN BRIDGE ABUTMENT (CONTRACTOR TO TAKE PRECAUTIONS TO

EXISTING PEDESTRIAN

BORING B-14-1

BRIDGE SUPPORT DEADMAN

PROTECT DURING CONSTRUCTION)

WATER LEVEL

2 YEAR STORM

WATER LEVEL

EXISTING 42" PCCP

SEWER MAIN

BORING B-12-9

BONNIE BRANCH BYPASS PLAN

CIVIL

BALTIMORE


COUNTY

PATAPSCO INTERCEPTOR RELOCATION AND BLOEDE DAM REMOVAL **CAPITAL PROJECT NUMBER S-6282** CONTRACT NUMBER 10-4948

2ND ELECTION DISTRICT HOWARD COUNTY, MARYLAND SHEET 74 OF 106

AUGUST 2017 DRAWING NUMBER HSC-2


HOCO SHT 11 OF 14

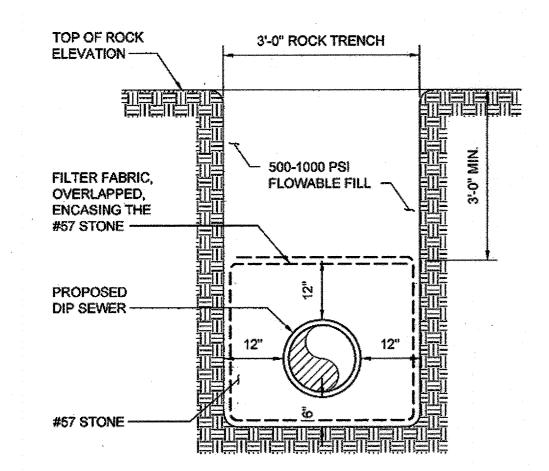


NOTES FOR "TYPE A FLOWABLE FILL PROTECTION":

- IT IS ANTICIPATED THAT THE PROPOSED 12" SIPHON WILL BE TRENCHED INTO BEDROCK WHERE "TYPE A FLOWABLE FILL PROTECTION" IS CALLED FOR. CONTRACTOR SHALL PERFORM THREE TEST PITS ALONG THE SIPHON ALIGNMENT AS STATED ON DRAWING HSC-1: ONE AT STATION 0+29, ONE AT STATION 1+03, AND ONE AT THE MIDPOINT STATION 0+66. CONTRACTOR SHALL PROVIDE THE TEST PIT DATA FOR REVIEW PRIOR TO COMMENCING WORK.
- IF THE TEST PIT DATA SHOWS THAT THE BEDROCK ELEVATION IS LOWER THAN APPROXIMATE ELEVATION 65.0, THE CONTRACTOR SHALL LOWER THE PIPE ELEVATION SUCH THAT THE CROWN OF THE PIPE WILL BE A MINIMUM OF 4 FEET INTO BEDROCK. THE VERTICAL ALIGNMENT WILL ADJUST FOR ANY CHANGES IN THE ELEVATION OF THE PIPE INVERTS AT THE LOWEST POINT.
- THE DUCTILE IRON SIPHON SHALL BE BURIED WITH DIMENSIONS AS SHOWN ABOVE. BACKFILL SHALL CONSIST OF #57 STONE, WRAPPED IN GEOTEXTILE, FROM 6" BELOW THE PIPE TO 12" ABOVE THE PIPE. #57 STONE SHALL BE THE FULL WIDTH OF THE TRENCH.
- ABOVE THE #57 STONE, FLOWABLE FILL SHALL BE PROVIDED. SEE THE HOWARD COUNTY SPECIAL PROVISIONS, PARAGRAPH 11 FOR REQUIREMENTS. THE TOP OF THE FLOWABLE FILL SHALL BE SET AT THE SAME ELEVATION AS THE TOP OF ROCK.

"TYPE A FLOWABLE FILL PROTECTION" DETAIL FOR BONNIE BRANCH SEWER CONNECTION NOT TO SCALE

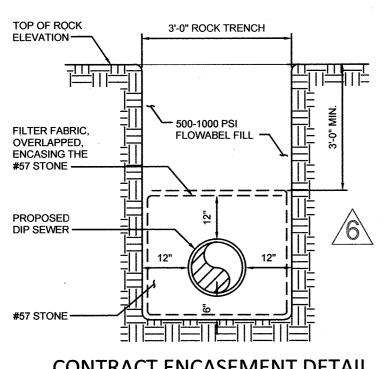


CONTRACT ENCASEMENT DETAIL INV. EL. 52 NOT TO SCALE

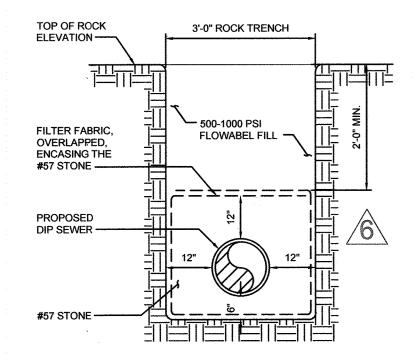

HOWARD COUNTY PROPOSAL OF 2' MIN. ENCASEMENT IN ROCK WITH CONCRETE FILL **REVISED INV. EL. 53**

NOT TO SCALE

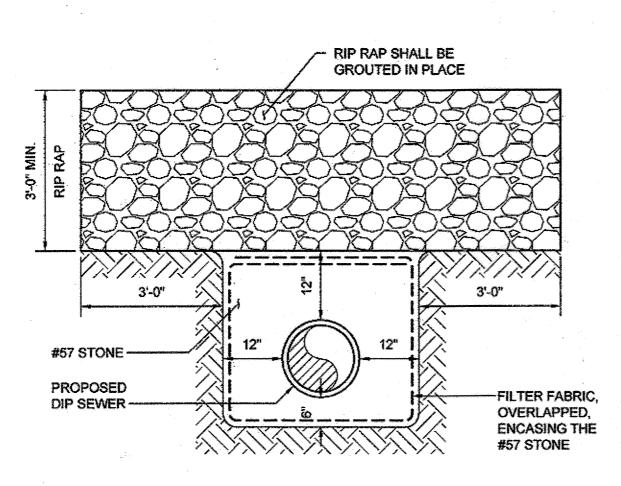


NOTES FOR "TYPE B RIP RAP PROTECTION":

- 1. THIS TYPE OF RIP RAP PROTECTION SHALL BE UTILIZED TO PROTECT THE PIPE IN THE STEEP PORTIONS OF THE TRENCH WITHIN THE BANKS OF THE RIVER AT NORMAL FLOW.
- 2. THE DUCTILE IRON SIPHON SHALL BE BURIED IN THE WITH DIMENSIONS SHOWN ABOVE BACKFILL SHALL CONSIST OF #57 STONE, WRAPPED IN GEOTEXTILE, FROM 6" BELOW THE PIPE TO 12" ABOVE THE PIPE. #57 STONE SHALL BE THE FULL WIDTH OF THE TRENCH.
- ABOVE THE #57 STONE, CLASS III RIP RAP GROUTED IN PLACE SHALL BE PROVIDED AT A MINIMUM DEPTH OF 3 FEET AND EXTENDING HORIZONTALLY 3 FEET BEYOND THE LIMITS OF THE #57 STONE, FOR A TOTAL WIDTH OF APPROXIMATELY 9 FEET.
- 4. THE TOP OF THE RIP RAP ELEVATION SHALL BE SET AT THE GRADE ELEVATION POST DAM REMOVAL. ONCE THE GROUTED RIP RAP IS INSTALLED, CONTRACTOR SHALL INSTALL RIVER BANK PROTECTION IN ACCORDANCE WITH THE RIVER BANK PROTECTION DETAIL ON THIS


NOTES FOR "TYPE C RIP RAP PROTECTION":

- THIS TYPE OF RIP RAP PROTECTION SHALL BE UTILIZED TO PROTECT THE PIPE WHERE IT ENTERS THE ACCESS VAULT AS WELL AS PROTECTING THE ACCESS VAULT FROM THE FORCES OF THE
- 2. A SMALL PORTION OF THE SIPHON NEAR THE VAULT WILL BE ABOVE EXISTING GRADE. IN THIS LOCATION, CONTRACTOR SHALL CONCRETE ENCASE THE PIPE A MINIMUM OF 12 INCHES ALL AROUND AND PROVIDE GROUTED RIP RAP ABOVE AND ON ALL EXPOSED SIDES OF THE CONCRETE, AS WELL AS SURROUNDING THE PROPOSED ACCESS VAULT FOR A DISTANCE OF APPROXIMATELY 10 FEET. AROUND THE ACCESS VAULT, THE RIP RAP SHALL BE TAPERED FROM THE TOP OF THE VAULT TO EXISTING GRADE AS APPROPRIATE. RIP RAP SIZE SHALL BE A MIXTURE OF CLASS II AND CLASS III RIP RAP ARRANGED IN A PATTERN TO BEST PROTECT THE EXPOSED SIPHON AND ACCESS VAULT.

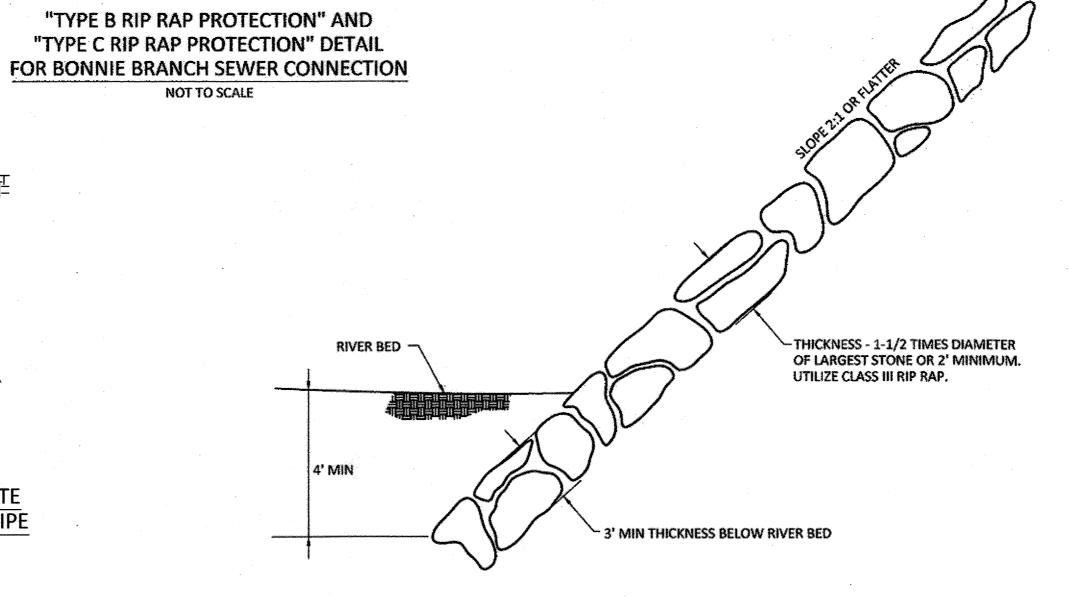


NOTE: RIVER BANK PROTECTION SHALL EXTEND A MINIMUM OF 6 FEET BOTH UPSTREAM AND DOWNSTREAM OF THE PROPOSED SIPHON ALIGNMENT, FOR A TOTAL LENGTH OF 12 FEET MEASURED ALONG THE DIRECTION OF RIVER FLOW.

> RIVER BANK PROTECTION DETAIL **NOT TO SCALE**

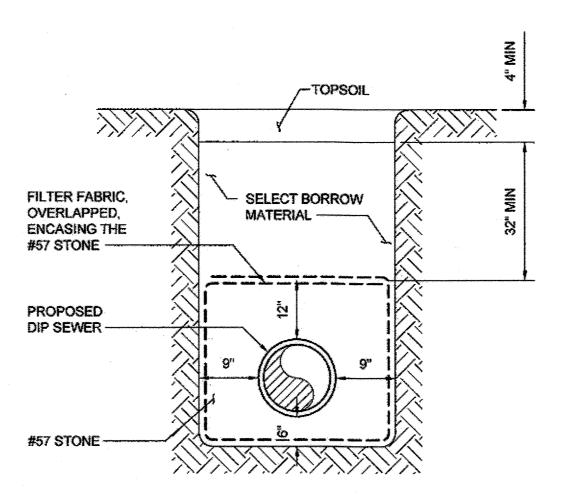

"TYPE D TRENCH" DETAIL FOR BONNIE BRANCH SEWER CONNECTION NOT TO SCALE

RIVER BANK-

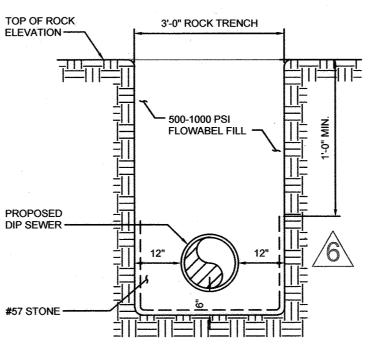

1' MIN. ENCASEMENT IN CONCRETE WITHOUT #57 STONE **REVISED INV. EL. 55**

NOT TO SCALE

AS-BUILT REPLACEMENT SHEET NO CHANGES IN REVISIONS 1, 2, 3, 4

CIVIL

DETAILS

PATAPSCO INTERCEPTOR RELOCATION AND BLOEDE DAM REMOVAL **CAPITAL PROJECT NUMBER S-6282**

STANDARD SYMBOL

TBD

WORK AREA

MARYLAND DEPARTMENT OF ENVIRONMENT WATER MANAGEMENT ADMINISTRATION

DETAIL C-7 TEMPORARY BARRIER DIVERSION

CHANNEL DIVERSION

≥ 45% OF EXISTING

CHANNEL WIDTH

IMPERMEABLE SHEETING

BETWEEN SANDBAGS AND CONCRETE BARRIER

AS NEEDED FOR LEVELING

FOR SANDBAGS USE MATERIALS THAT ARE RESISTANT TO ULTRA-VIOLET RADIATION, TEARING, AND

3. USE 10 MIL OR THICKER, UV RESISTANT, IMPERMEABLE SHEETING OR OTHER APPROVED MATERIAL

4. ESTABLISH TOP ELEVATION AT H/2 + 1 FOOT FOR PROJECTS OF DURATION LESS THAN 2 WEEKS OR

6. PLACE IMPERMEABLE SHEETING SUCH THAT UPGRADE PORTION OVERLAPS DOWNGRADE PORTION BY A

7. USE SANDBAG BASE FOR LEVELING AND TO ESTABLISH MINIMUM TOP ELEVATION OF THE BARRIER AS REQUIRED.

8. DISPOSE OF ALL EXCAVATED MATERIALS IN AN APPROVED DISPOSAL AREA OUTSIDE OF THE 100-YEAR FLOODPLAIN.

9. DEWATER WORK AREA USING AN APPROVED EROSION AND SEDIMENT CONTROL PRACTICE AS SPECIFIED

MARYLAND STANDARDS AND SPECIFICATIONS FOR SOIL EROSION AND SEDIMENT CONTROL

C.22

TEMPORARY RIVER CONSTRUCTION DETAIL FOR BONNIE BRANCH SEWER CONNECTION - MDE DETAIL C-7

10. KEEP ABUTMENTS BETWEEN CONCRETE BARRIERS WATER TIGHT. REPLACE SANDBAGS AND IMPERMEABLE SHEETING IF TORN.

PROVIDE SANDBAGS

PUNCTURE AND WOVEN TIGHTLY ENOUGH TO PREVENT LEAKAGE OF FILL MATERIAL.

2. USE BARRIER MADE OF CONCRETE OR OTHER APPROVED MATERIAL.

5. INSTALL DIVERSION STRUCTURE FROM UPGRADE TO DOWNGRADE.

THAT IS IMPERMEABLE AND RESISTANT TO PUNCTURING AND TEARING.

WORK AREA

CONSTRUCTION SPECIFICATIONS

AS SPECIFIED ON APPROVED PLAN.

MINIMUM OF 18 INCHES.

U.S. DEPARTMENT OF AGRICULTURE NATURAL RESOURCES CONSERVATION SERVICE

ATE (AUGUST 201 NUMBER HSC-3

CONTRACT NUMBER 10-4948 2ND ELECTION DISTRICT. HOWARD COUNTY, MARYLAND SHEET 75 OF 106

DEPARTMENT OF PUBLIC WORKS HOWARD COUNTY, MARYLAND

CHIEF UTILITY DESIGN DIVISON WD

TOP OF ROCK

3'-0" ROCK TRENCH

500-1000 PSI

2' MIN. ENCASEMENT IN CONCRETE WITHOUT #57 STONE ON TOP OF PIPE

REVISED INV. EL. 54

NOT TO SCALE

FLOWABEL FILL -

HAZEN AND SAWYER


1 SOUTH STREET, SUITE 1150; BALTIMORE, MD 21202 410-539-7681


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NH/MJB DESIGNED_ CHECKED_ PROJ. ENGR. JTH REVISION PER HOWARD COUNTY 8/2017 JTH ISSUED FOR DATE

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TRAFFIC CONTROL PLAN NOTES:

- 1. EXACT LOCATION OF ALL SIGNS SHALL BE COORDINATED WITH THE ENGINEER.
- 2. ALL WORK ZONE VEHICLES WHEN ENTERING/EXITING THE WORK AREA OR OPERATING WITHIN THE WORK ZONE SHALL DISPLAY FLASHING WARNING LIGHTS AS SPECIFIED IN MARYLAND SHA STANDARDS 104.01-18A AND B.
- 3. A PORTION OF THE EXISTING GUARDRAIL WILL NEED TO BE REMOVED FOR CONSTRUCTION ACCESS. CONTRACTOR SHALL PROVIDE THE PROPER NUMBER AND ARRANGEMENT OF SAND FILLED CRASH CUSHIONS AS PER MARYLAND SHA STANDARD 104.01-71 FOR 40MPH TO PROTECT THE ENDS OF THE GUARDRAIL FROM TRAFFIC.
- 4. ALL TEMPORARY SIGNS SHALL BE COVERED OR TURNED AWAY FROM TRAFFIC DURING NON-WORKING HOURS UNLESS OTHERWISE NOTED.
- 5. DURING WORK HOURS WHEN FLAGGER IS PRESENT, FLAGGER SIGN SHALL BE DISPLAYED IN THIS LOCATION. DURING ALL OTHER HOURS, SHOULDER WORK SIGN SHALL BE DISPLAYED IN THIS LOCATION.

SYMBOL LEGEND

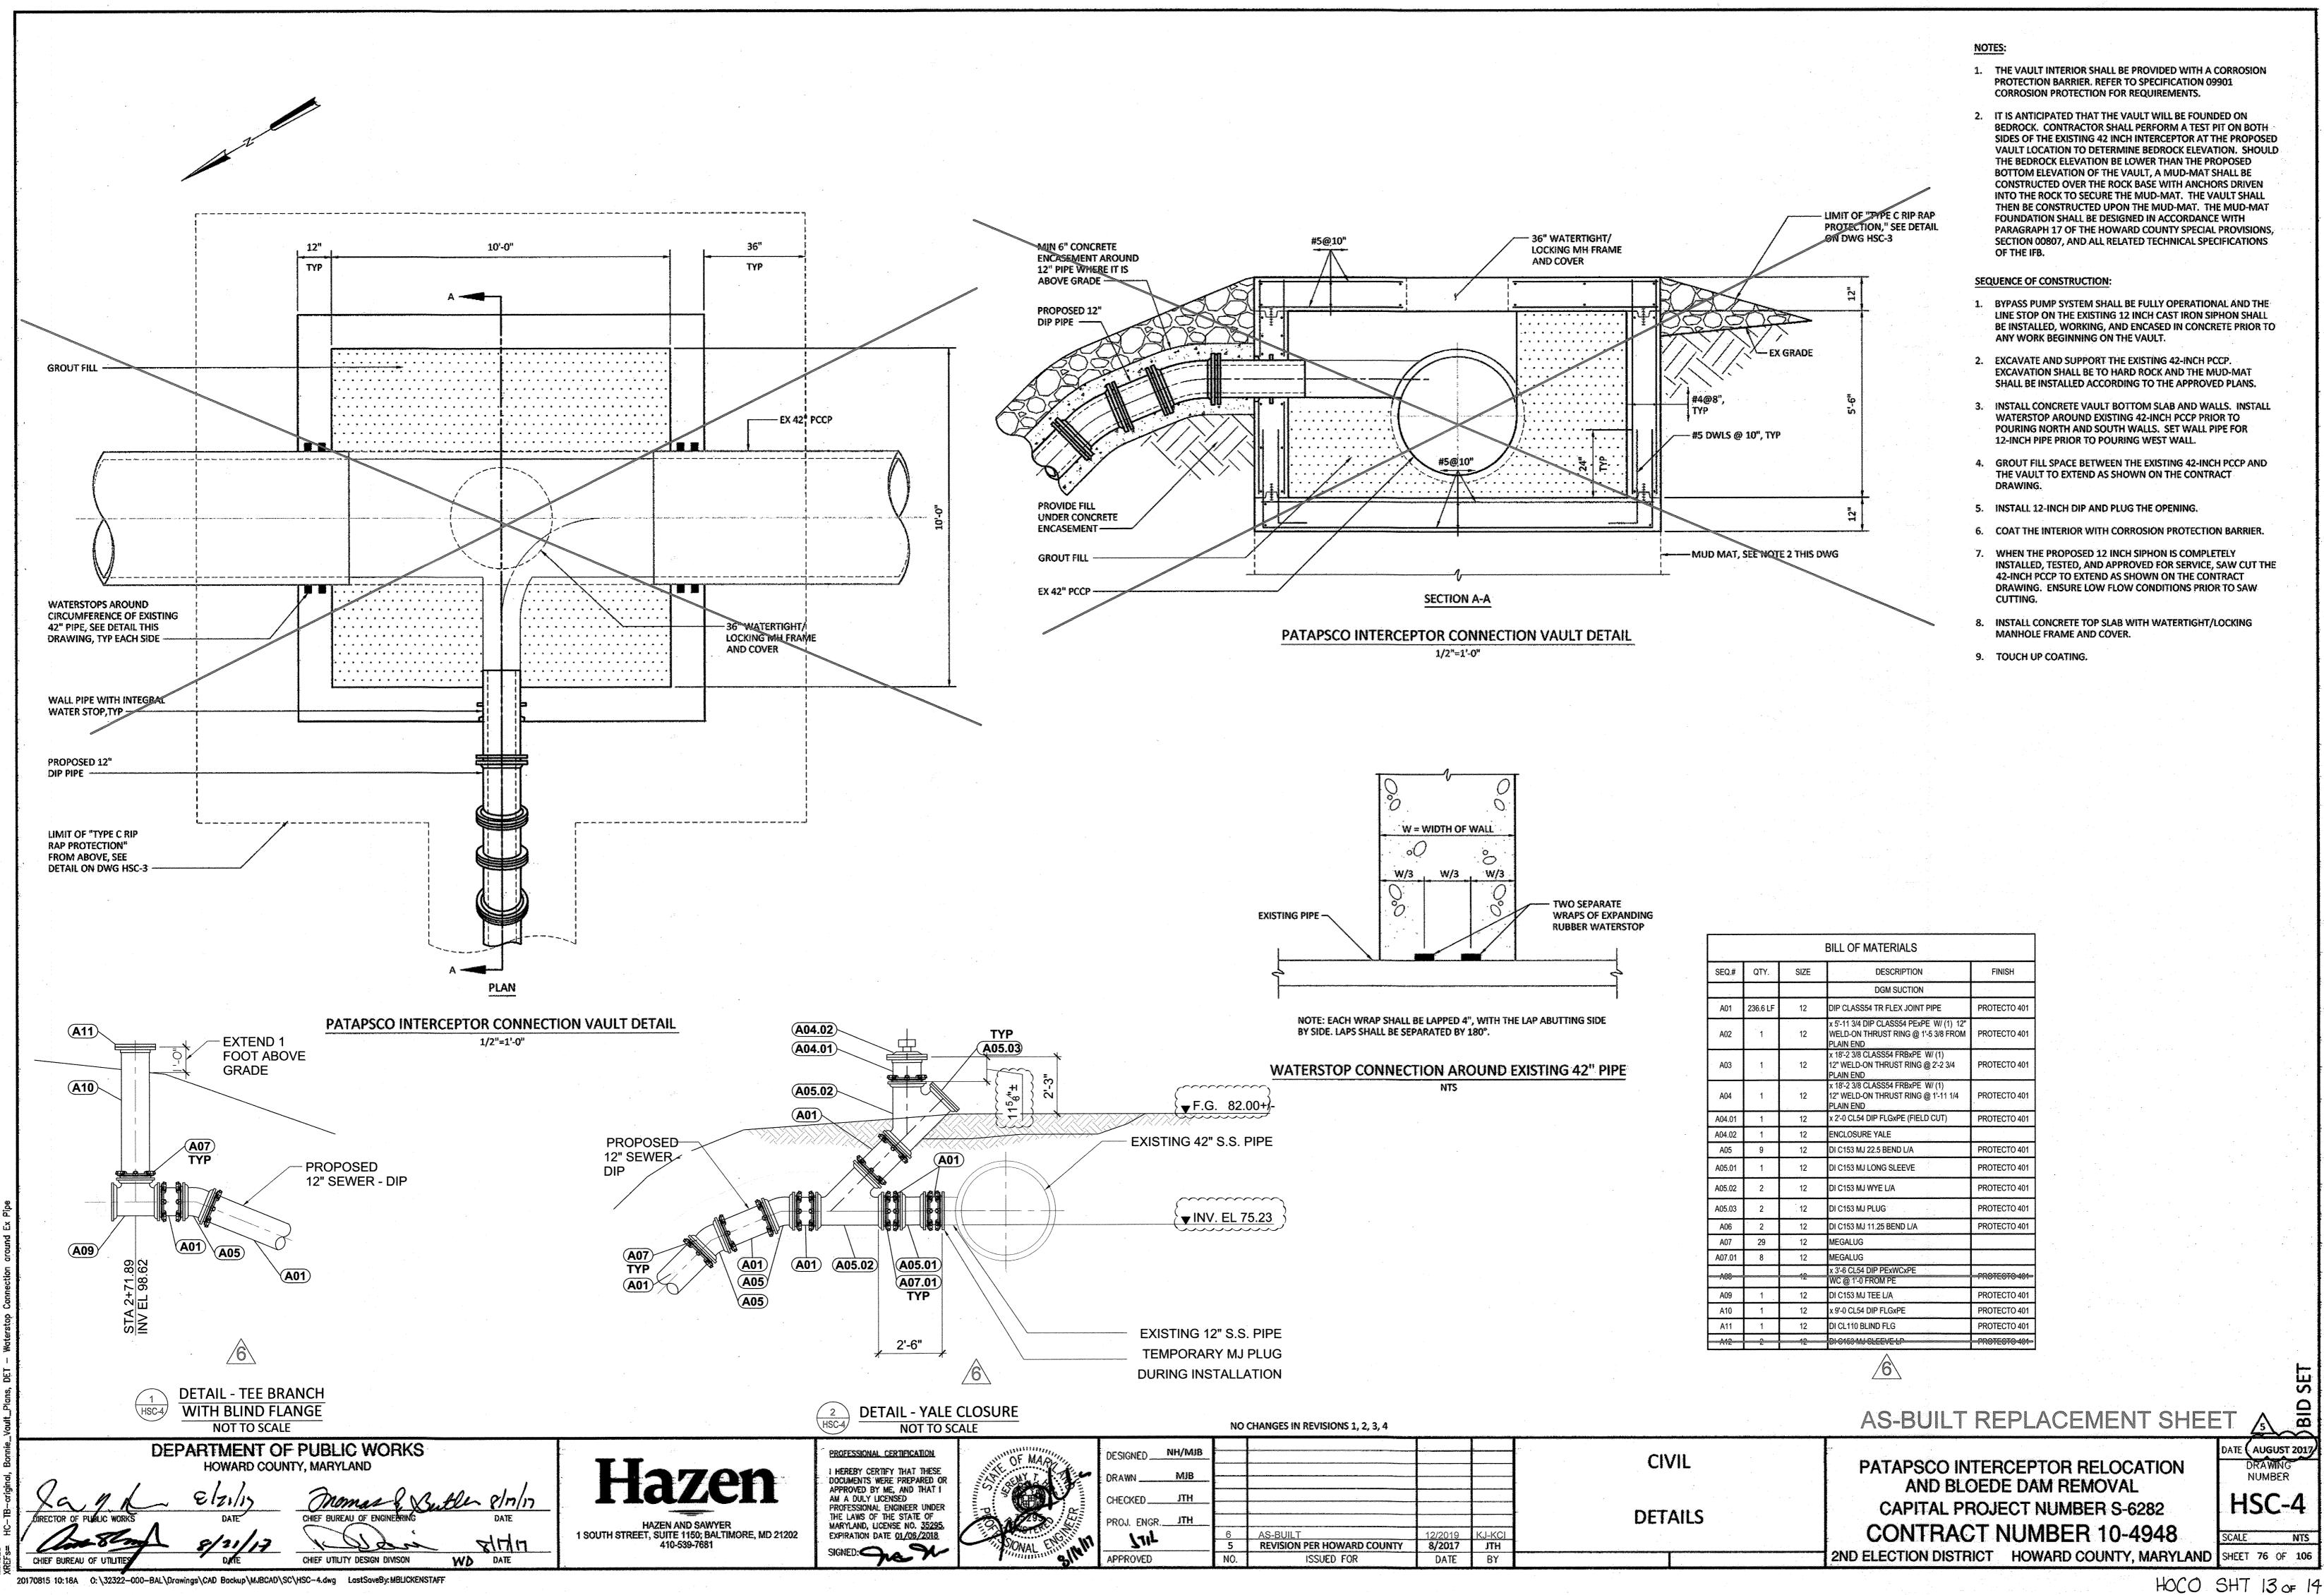SIGN

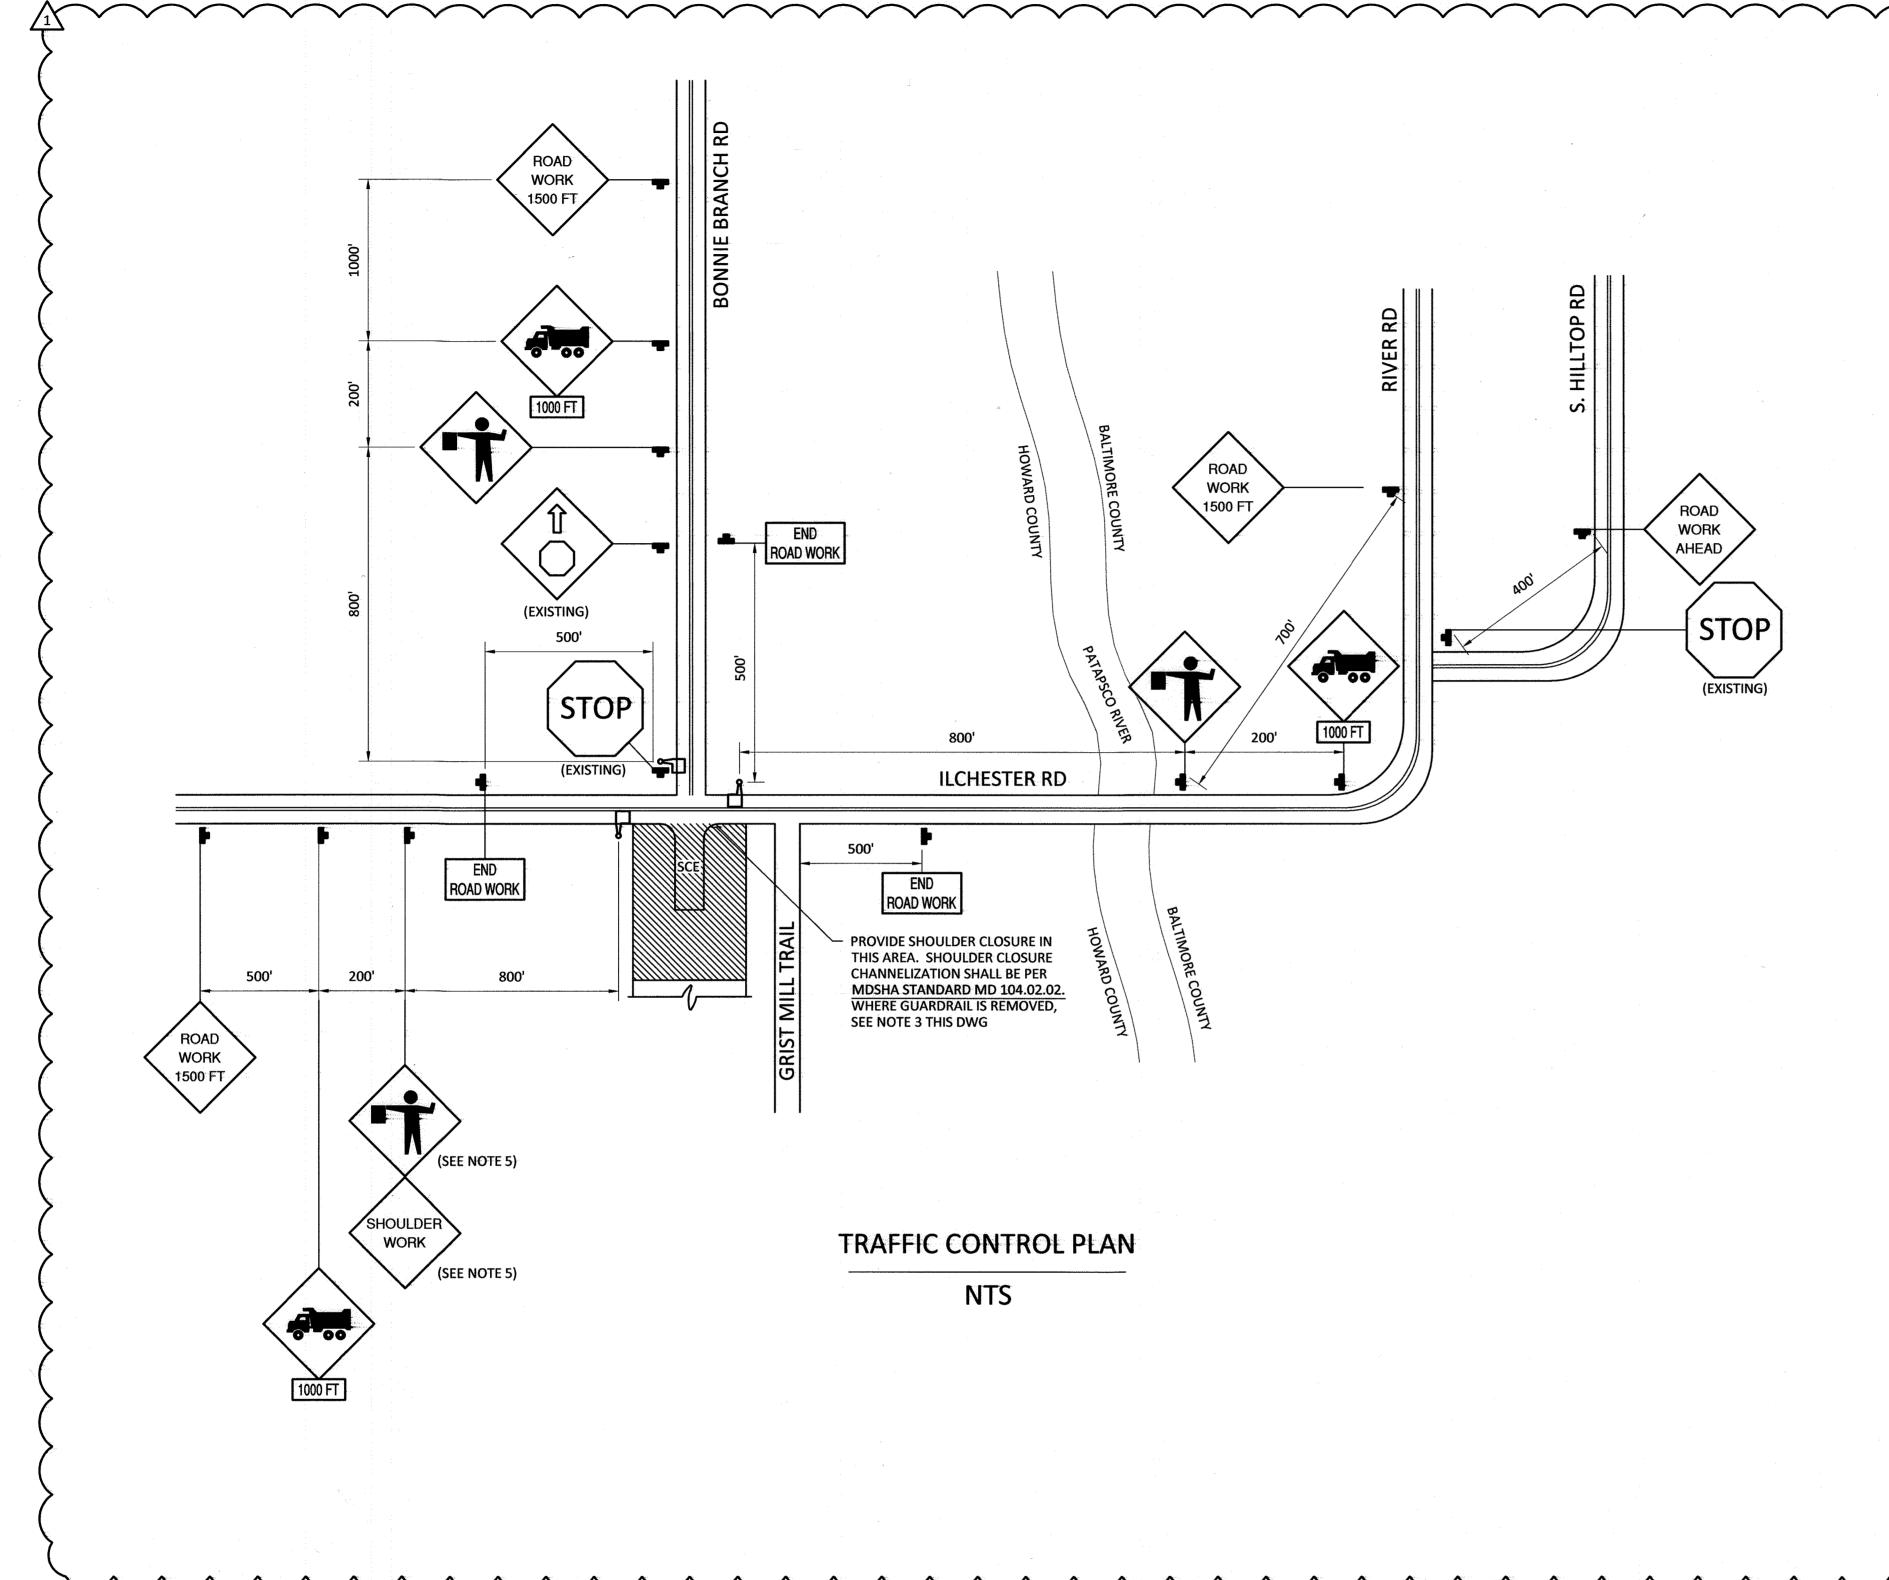
BARRICADE

WORK AREA

FLAGGER

SIGN LEGEND

SIGN	MDSHA SIGN NO.
	W11-10(1)
	W20-7a
ROAD WORK 1500 FT	W20-1(1)
END ROAD WORK	G20-2(1)
SHOULDER	W21-5(1)

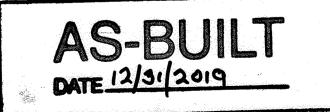


DEPARTMENT OF PUBLIC WORKS

HOWARD COUNTY, MARYLAND

HAZEN AND SAWYER 1 SOUTH STREET, SUITE 1150; BALTIMORE, MD 21202 410-539-7681

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	DESIGNED	NH/MJB	<u> </u>				
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1			5	REVISION PER HOWARD COUNTY	8/2017	JTH	
1611,	714		1	ADDENDUM NO. 3	5/2016	JTH	L
11-	APPROVED	Odnovnicenski prima se se kolonica	NO.	ISSUED FOR	DATE	BY	
-							-

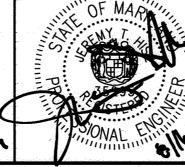NO CHANGES IN REVISIONS 2, 3, 4

TRAFFIC CONTROL

TRAFFIC CONTROL PLAN

PATAPSCO INTERCEPTOR RELOCATION AND BLOEDE DAM REMOVAL **CAPITAL PROJECT NUMBER S-6282 CONTRACT NUMBER 10-4948**

ATE AUGUST 201 DRAWING NUMBER HST-1 2ND ELECTION DISTRICT HOWARD COUNTY, MARYLAND SHEET 77 OF 106