

BENCHMARK INFORMATION

B.M.#1 - HOWARD COUNTY CONTROL STATION #25A1 - HORIZONTAL - NAD '83) (LOCATED IN THE CUL-DE-SAC OF RIDGE ROAD. APPROX. 11.3' FROM THE STREET SIGN AND 3.5' FROM FACE OF CURB) N 586557.549

1366847.100 ELEVATION = 396.354 - VERTICAL - (NAVD '08)

B.M.#2 - HOWARD COUNTY CONTROL STATION #25A2 - HORIZONTAL - (NAD '83) (LOCATED ALONG THE EAST SIDE OF ROGERS AVE., SOUTH OF OAK WEST DRIVE. APPROX. 6.2' FROM A SEWER MANHOLE, 16.1' OFF EDGE OF SIDEWALK AND 12' FROM END OF CURB) N 507502.730 £ 1366556.370

ELEVATION = 348.159 - VERTICAL - (NAVD '88)

Pí	SIVATE	WELL	&	PRIVATE	SEPTIC	SYSTEM (CHART
PARCEL NO.	A	DDRE55		OW	NER .	ABANDON WELL	ABANDON SEPTIC
0013	3530 C	HURCH ROA	ND	CHARLES	T. LACEY	N/A	YE5

WATER METERS WILL NOT BE RELEASED BY HOWARD COUNTY TO ANY NEW BUILDING UNTIL THE EXISTING WELLS AND SEPTIC SYSTEMS HAVE BEEN ABANDONED IN ACCORDANCE WITH HOWARD COUNTY HEALTH DEPARTMENT REGULATIONS AND THE EXISTING BUILDINGS, WHICH ARE TO REMAIN, ARE CONNECTED TO THE PUBLIC SEWER AND WATER MAINS.

DEVELOPER'S CERTIFICATION

" I/WE HEREBY CERTIFY THAT ALL DEVELOPMENT AND CONSTRUCTION WILL BE DONE ACCORDING TO THIS PLAN OF DEVELOPMENT AND PLAN FOR EROSION AND SEDIMENT CONTROL AND THAT ALL RESPONSIBLE PERSONNEL INVOLVED IN THE CONSTRUCTION PROJECT WILL HAVE A CERTIFICATE OF ATTENDANCE AT THE DEPARTMENT OF THE ENVIRONMENT APPROVED TRAINING PROGRAM FOR THE CONTROL OF SEDIMENT AND EROSION BEFORE BEGINNING THE PROJECT. I ALSO AUTHORIZE PERIODIC ON-SITE INSPECTION BY THE HOWARD SOIL CONSERVATION DISTRICT OR THEIR AUTHORIZED AGENTS, AS ARE DEEMED NECESSARY."

TE:A ERACTICAL AND WORKABLE PLAN BASED ON MY USE OF THE SITE CONDITIONS AND THAT IT WAS CONNECT WITH THE REQUIREMENTS OF THE HOWARD SOIL

SEDIMENT CONTROL MEASURES FOR THIS CONTRACT WILL BE IMPLEMENTED IN ACCORDANCE WITH SECTION 300 OF THE HOWARD COUNTY DESIGN MANUAL - VOLUME IV: STANDARD SPECIFICATIONS AND DETAILS FOR CONSTRUCTION AND AS SHOWN ON THE ROAD CONSTRUCTION PLAN, F-21-015

THIS DEVELOPMENT IS APPROVED FOR EROSION AND SEDIMENT CONTROL BY HOWARD SOIL CONSERVATION DISTRICT.

5YMBOL	DESCRIPTION
	EX. WATER MAIN
	ex. Sewer main
0	EX. SEWER MANHOLE
	EX. SEWER, WATER & UTILITY EASEMENT
[#]	EX. FIRE HYDRANT
•	EX. VALVE
	PROP. WATER MAIN
	PROP. SEWER MAIN
	PROP. SEWER MANHOLE
	PROP. SEWER, WATER & UTILITY EASEMENT
	PROP. WHC
	PROP. SHC
	PROP. FIRE HYDRANT
•	PROP. VALVE
C.N.5.	CELLAR CAN NOT BE SERVED

NO. OF SEWER HOUSE CONNECTIONS:


PATAP5CO

PATAPSCO WASTEWATER TREATMENT PLANT

CITY OF BALTIMORE

SEWER SHED:

TREATMENT PLANT: _

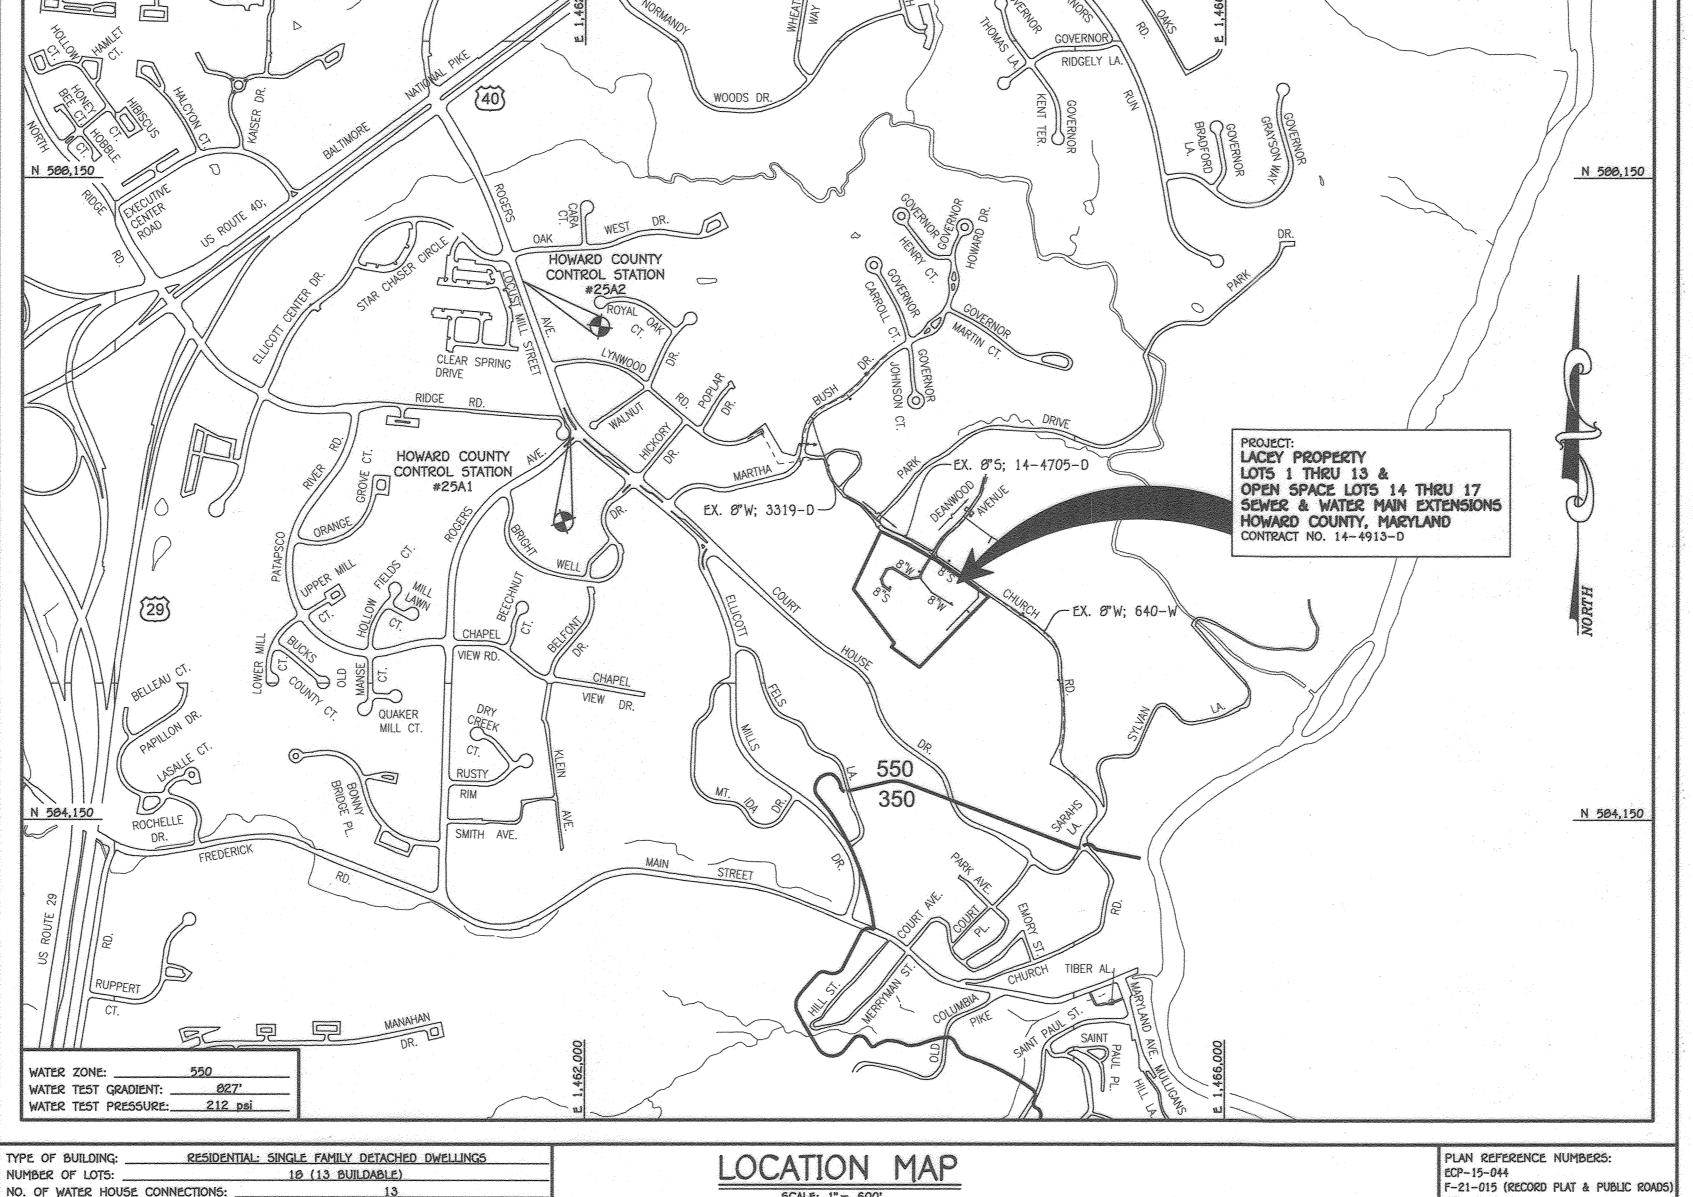

WAIVER NOTE: DMV2-21-014

BY LETTER DATED JANUARY 20, 2022, MR. DANIEL DAVIS, DIVISION CHIEF. UTILITY DESIGN DIVISION; APPROVED THE FOLLOWING; A. GRAVITY SEWER SERVICE TO ONLY THE FIRST FLOOR OF THE

5P-15-013

PROPOSED RESIDENTIAL DWELLINGS ON LOTS 12 & 13. 8. INSTALLATION OF THE SEWER HOUSE CONNECTIONS AT A SLOPE OF 1.00% FOR LOTS 9, 10 & 11.

C. ENCROACHMENT BY THE FOOTER OF THE PROPOSED RETAINING WALL. INTO THE 10' STRUCTURE SET-BACK OF THE PUBLIC WATER & UTILITY EASEMENT; WM 5TA. 2+26 TO WM 5TA. 3+26; WATERLINE 'A'. SEE WAIVER DMV2-21-014 FOR FURTHER DETAIL.

CONTRACT NO. 14-4913-D LACEY PROPERTY LOTS 1 THRU OPEN SPACE LOTS 14 SEWER & WATER MAIN EXTENSIONS HOWARD COUNTY, MARYLAND

LAND HOLDINGS, LLC B. JAMES GREENFIELD 6420 AUTUMN SKY WAY COLUMBIA, MD 21044 (443) 324-4732

OWNERS CHARLES T. LACEY, 5R., KARLOS LACEY AND CHARLES T. LACEY, JR. CO-TRUSTEES, LACEY FAMILY REVOCABLE TRUST 1235 WILD ROSE COURT MARRIOTTSVILLE, MARYLAND 21104

(410) 489-0333 ENSIONS

ANNE ARUNDEL COUNTY ADC MAP: 21 BLOCK: B-7

. APPROXIMATE LOCATIONS OF EXISTING MAINS ARE SHOWN. THE CONTRACTOR SHALL TAKE ALL NECESSARY PRECAUTIONS TO PROTECT EXISTING MAINS AND SERVICES AND MAINTAIN UNINTERRUPTED SERVICE. ANY DAMAGE INCURRED SHALL BE REPAIRED IMMEDIATELY TO THE SATISFACTION OF THE ENGINEER AT THE CONTRACTOR'S EXPENSE

3. HORIZONTAL AND VERTICAL SURVEY CONTROLS: THE COORDINATES SHOWN ON THE DRAWINGS ARE BASED ON MARYLAND STATE REFERENCE SYSTEM NAD '83/91' AS PROJECTED BY HOWARD COUNTY GEODETIC CONTROL STATIONS NO. 25A1 & NO. 25A2.

2. TOPOGRAPHIC FIELD SURVEYS WERE PERFORMED ON OR ABOUT APRIL, 2013 BY FISHER, COLLINS & CARTER, INC.

ALL VERTICAL CONTROLS ARE BASED ON NAVD '66. VERTICAL CONTROLS PROVIDED ON THE DRAWINGS. 4. ALL PIPE ELEVATIONS SHOWN ARE INVERT ELEVATIONS UNLESS OTHERWISE NOTED ON THE PLANS. 5. CLEAR ALL UTILITIES BY A MINIMUM OF 12 INCHES. CLEAR ALL POLES BY 5'-0" MINIMUM OR TUNNEL AS REQUIRED UNLESS OTHERWISE NOTED. THE OWNER HAS CONTACTED THE UTILITY COMPANIES AND HAS MADE ARRANGEMENTS FOR BRACING OF POLES AS SHOWN ON THE DRAWINGS. IN THE EVENT THE CONTRACTOR'S WORK REQUIRES BRACING OF ADDITIONAL POLES, ANY COST INCURRED BY THE OWNER FOR THE BRACING OF THE ADDITIONAL POLES OR DAMAGES SHALL BE DEDUCTED FROM MONIES

6. FOR DETAILS NOT SHOWN ON THE DRAWINGS, AND FOR MATERIALS AND CONSTRUCTION METHODS, USE HOWARD COUNTY DESIGN MANUAL, VOLUME IV, STANDARD SPECIFICATIONS AND DETAILS FOR CONSTRUCTION (LATEST EDITION). THE CONTRACTOR SHALL

. Where test pits have been made on existing utilities, they are noted by the symbol. 🚯 at the locations of the TEST PITS. A NOTE OR NOTES CONTAINING THE RESULTS OF THE TEST PIT OR PITS IS INCLUDED ON THE DRAWINGS. EXISTING

OWED THE CONTRACTOR. THE CONTRACTOR SHALL COORDINATE WITH THE UTILITY COMPANIES TO SCHEDULE THE BRACING OF

JTILITIES IN THE VICINITY OF THE PROPOSED WORK FOR WHICH TEST PITS HAVE NOT BEEN DUG SHALL BE LOCATED BY THE CONTRACTOR TWO WEEKS IN ADVANCE OF CONSTRUCTION OPERATIONS AT HIS OWN EXPENS 8. THE CONTRACTOR SHALL NOTIFY THE FOLLOWING UTILITY COMPANIES OR AGENCIES AT LEAST FIVE WORKING DAYS BEFORE

STARTING WORK SHOWN ON THESE PLANS: . 410-313-4900

9 TREES AND SHRUBS ARE TO BE PROTECTED FROM DAMAGE TO THE MAXIMUM EXTENT. TREES AND SHRUBS LOCATED WITHIN THE CONSTRUCTION STRIP ARE NOT TO BE REMOVED OR DAMAGED BY THE CONTRACTOR. 10. CONTRACTOR SHALL REMOVE TREES, STUMPS AND ROOTS ALONG THE LINE OF EXCAVATION. PAYMENT FOR SUCH REMOVAL

SHALL BE INCLUDED IN THE UNIT PRICE BID FOR THE CONSTRUCTION OF THE MAIN. 11. THE CONTRACTOR SHALL NOTIFY THE BUREAU OF HIGHWAYS, HOWARD COUNTY, AT (410)-313-7450 AT LEAST FIVE WORKING DAYS BEFORE OPEN CUTTING OR BORING/JACKING OF ANY COUNTY ROAD FOR LAYING WATER/SEWER MAINS OR HOUSE CONNECTIONS. THE APPROVAL OF THESE DRAWINGS WILL CONSTITUTE COMPLIANCE WITH DPW REQUIREMENTS PER SECTION 18.114(a) OF THE HOWARD

PART 8: WATER MAIN GENERAL NOTES

1. ALL WATER MAINS SHALL BE AWWA C900 PVC; DR-18.

2. TOPS OF ALL WATER MAINS SHALL HAVE A MINIMUM OF 3'-6" OF COVER UNLESS OTHERWISE NOTED. 3. VALVES ADJACENT TO TEES SHALL BE STRAPPED TO TEES.

4. ALL FITTINGS SHALL BE BUTTRESSED OR ANCHORED WITH CONCRETE IN ACCORDANCE WITH STANDARD DETAILS UNLESS OTHERWISE 5. FIRE HYDRANTS SHALL BE SET TO THE BURY LINE ELEVATIONS SHOWN ON THE DRAWINGS. ALL FIRE HYDRANTS SHALL BE

INSTALLED IN ACCORDANCE WITH STANDARD DETAILS. THE SOIL AROUND THE FIRE HYDRANT SHALL BE COMPACTED IN

ACCORDANCE WITH SECTION 1000 AND SECTION 1005 OF THE STANDARD SPECIFICATIONS. 6. THE CONTRACTOR SHALL NOT OPERATE ANY WATER MAIN VALVES ON THE EXISTING WATER SYSTEM.

7. TRACER WIRE AND CONTINUITY TEST STATIONS SHALL BE INSTALLED ON ALL D.I.P. AND PVC WATER MAINS IN ACCORDANCE WITH HOWARD COUNTY DESIGN MANUAL

8. FOR PVC WATER MAINS, ALL RECORDS FOR THE QUALITY CONTROL AND QUALIFICATION TEST REQUIREMENTS NOTED IN SECTION 5.1 OF THE AWWA STANDARD C900 FOR PVC PRESSURE PIPE SHALL BE SUBMITTED WITH THE PIPE MATERIAL CERTIFICATIONS OR SHOP DRAWINGS PRIOR TO APPROVAL OF THE MATERIAL FOR USE. THE TEST RECORDS SHALL BE FOR THE PIPE TO BE INSTALLED UNDER THIS CONTRACT. ALL PVC PIPE SHALL CONTAIN MARKINGS TO ALLOW CROSS REFERENCING OF

THE PIPE SUPPLIED TO THE TEST RECORDS RECEIVED. 9. UNLESS OTHERWISE NOTED ON THE PLANS OR IN THE SPECIFICATIONS, SEVENTEEN (17) POUND SACRIFICIAL ANODES SHALL BE INSTALLED ON ALL VALVES AND METALLIC FITTINGS USED WITH PVC WATER MAINS IN ACCORDANCE WITH VOLUME IV, STANDARD SPECIFICATIONS AND DETAILS FOR CONSTRUCTION, MAGNESIUM ANODES SHALL BE INSTALLED ON ALL VALVES AND DUCTILE IRON FITTINGS INCLUDING

RESTRAINTS AND HARNESSES. ZINC ANODES SHALL BE INSTALLED ON ALL STAINLESS STEEL FITTINGS AND SADDLES USED WITH PVC MAINS, ALL "TEES" USED WITH PVC MAINS SHALL BE DUCTILE IRON.

10. PROPER ASSEMBLY OF GASKETED PVC PIPE JOINTS: THE MANUFACTURER'S INSERTION LINE OF GASKETED PVC PIPE JOINTS INDICATES THE MAXIMUM DEPTH OF INSERTION OF THE SPIGOT INTO THE BELL AFTER ASSEMBLY OF THE JOINT, THE INSERTION LINE SHALL

REMAIN VISIBLE. DUAL INSERTION LINES ON GASKETED PVC PIPE INDICATE THE MAXIMUM AND MINIMUM DEPTH OF INSERTION OF THE SPIGOT INTO THE BELL. THE CONTRACTOR SHALL NOT OVER INSERT OR OVER HOME THE SPIGOT INTO THE BELL OF PVC PIPE. 11. ALL CHANGES IN HORIZONTAL OR VERTICAL DIRECTION OF PVC WATER PIPE SHALL BE MADE WITH STANDARD BENDS, 5-DEGREE SWEEPS OR HIGH DEFLECTION(HD) COUPLINGS. NO BENDING OF THE PIPE OR DEFLECTING OF PVC PIPE JOINTS IS PERMITTED. WHERE HIGH DEFLECTION COUPLINGS OR 5-DEGREE SWEEPS ARE PERMITTED, THE CONTRACTOR SHALL PROVIDE ONE FULL PIPE LENGTH (20 FOOT LONG) ON EITHER SIDE OF THE HIGH DEFLECTION COUPLING OR 5-DEGREE SWEEP, TAKING CARE NOT TO USE COMPACTION

PVC HIGH DEFLECTION COUPLINGS SHALL BE LIMITED TO A TOTAL OF 3-DEGREES (1 1-DEGREE ON EITHER END OF THE COUPLING), SHALL BE RATED FOR A MINIMUM 200 PSI MEETING THE REQUIREMENTS OF AWWA C900, SHALL HAVE A MINIMUM LAY LENGTH OF 9-INCHES AND SHALL HAVE CENTER STOPS. PVC HIGH DEFLECTION COUPLINGS SHALL BE CERTAINTEED PVC HIGH DEFLECTION (HD)

FIVE DEGREE SWEEPS SHALL BE BELL BY SPIGOT, RATED FOR A MINIMUM 225 PSI, DR-10 MEETING THE REQUIREMENTS OF AWWA C900 AND SHALL BE MULTI FITTINGS (IPEX) BLUE BRUTE DR-18 OR EQUAL.

12. WHEN PVC HIGH DEFLECTION COUPLINGS OR PVC 5-DEGREE SWEEPS ARE USED TO FACILITATE CHANGES IN HORIZONTAL OR VERTICAL ALIGNMENTS OF AWAY COOP PVC PIPELINES, THE CONTRACTOR SHALL INSERT DEVICES FOR THE PREVENTION OF OVER-INSERTION OF THE PVC PIPE SPIGOTS OR PLAIN ENDS INTO THE PUSH ON BELL JOINT ON BOTH SIDES OF THE HIGH DEFLECTION COUPLINGS AND 5-DEGREE SWEEPS. BELL STOPS SHALL BE PLACED AT THE PROPER INSERTION LINE FOR THE FITTING. THE BELL STOP SHALL BE

MANUFACTURED OF DUCTILE IRON AND INCORPORATE AN EXPANSION RETENTION SPRING TO ALLOW FOR PIPE EXPANSION AND CONTRACTION. THE BELL STOPS SHALL BE SERIES 5000 MEGA-STOP, AS MANUFACTURED BY EBAA IRON, INC. OR APPROVED EQUAL. 13. TO ACCOMMODATE A SPRINKLER SYSTEM, ALL RESIDENTIAL DWELLING UNITS SHALL HAVE A 1-1/2" WATER HOUSE CONNECTION WITH A 1" OUTSIDE METER SETTING, STD. DET. W-3.20.


PART C: <u>SEWER MAIN GENERAL NOTES</u>

1. ALL SEWER MAINS SHALL BE D.I.P. OR P.V.C. UNLESS OTHERWISE NOTED.

2. ALL MANHOLES SHALL BE 4'-0" INSIDE DIAMETER UNLESS OTHERWISE NOTED. . FORCE MAINS SHALL BE D.I.P. ONLY.

4. MANHOLES SHOWN WITH 12" AND 16" WALLS ARE FOR BRICK MANHOLES ONLY.
5. MANHOLES DESIGNATED W.T. IN PLAN AND PROFILE SHALL HAVE WATERTIGHT FRAME AND COVER, STANDARD DETAIL G5.52. WHERE WATERTIGHT MANHOLE FRAMES AND COVERS ARE USED, SET TOP OF FRAME 1'-6" ABOVE FINISHED GRADE UNLESS

OTHERWISE NOTED ON THE DRAWINGS. 6. HOUSE(5) WITH THE SYMBOL "C.N.S." INDICATES THAT CELLAR CANNOT BE SERVED.

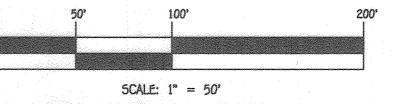

CONTRACT NO. 14-4913-D LACEY PROPERTY LOTS 1 THRU 13 & OPEN SPACE LOTS 14 THRU 17 SEWER & WATER MAIN EXTENSIONS HOWARD COUNTY, MARYLAND


DEPARTMENT OF PUBLIC WORKS HOWARD COUNTY, MARYLAND

DEPARTMENT OF PLANNING AND ZONING HOWARD COUNTY, MARYLAND

DULY LICENSED PROFESSIONAL ENGINEER UNDER THE LAWS OF THE STATE OF MARYLAND. LICENSE NO. 20748 EXPIRATION DATE IS 2/22/25. FISHER, COLLINS & CARTER, INC. CIVIL ENGINEERING CONSULTANTS & LAND SURVEYORS inial soliare office park — 10272 baltimore national piki ELLICOTT CITY, MARYLAND 21042

HEREBY CERTIFY THAT THESE DOCUMENTS WERE

PREPARED OR APPROVED BY ME, AND THAT I AM A

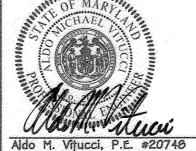

DESIGNED BY :					
J.C.L.					SEWER & WATER MAIN EXTER
DRAWN BY : J.C.L.					TITLE SHEET
CHECKED BY : A.M.V.					600' SCALE MAP NO25 BLOCK NO
DATE :					F.C.C. WORK ORDER NO. 08035
AUGU5T, 2023	BY	NO.	REVISION	DATE	FILE NAME : SEWER & WATER MAIN EXTENSION

LACEY PROPERTY LOTS 1 THRU 13 & OPEN SPACE LOTS 14 THRU 17 SEWER & WATER MAIN EXTENSIONS CONTRACT NO. 14-4913-D

SECOND ELECTION DISTRICT


HOWARD COUNTY, MARYLAND


5CALE **5HOWN**

SHEET 1 of 5

CHIEF. DEVELOPMENT ENGINEERING DIVISION M. 6

ON PLAN

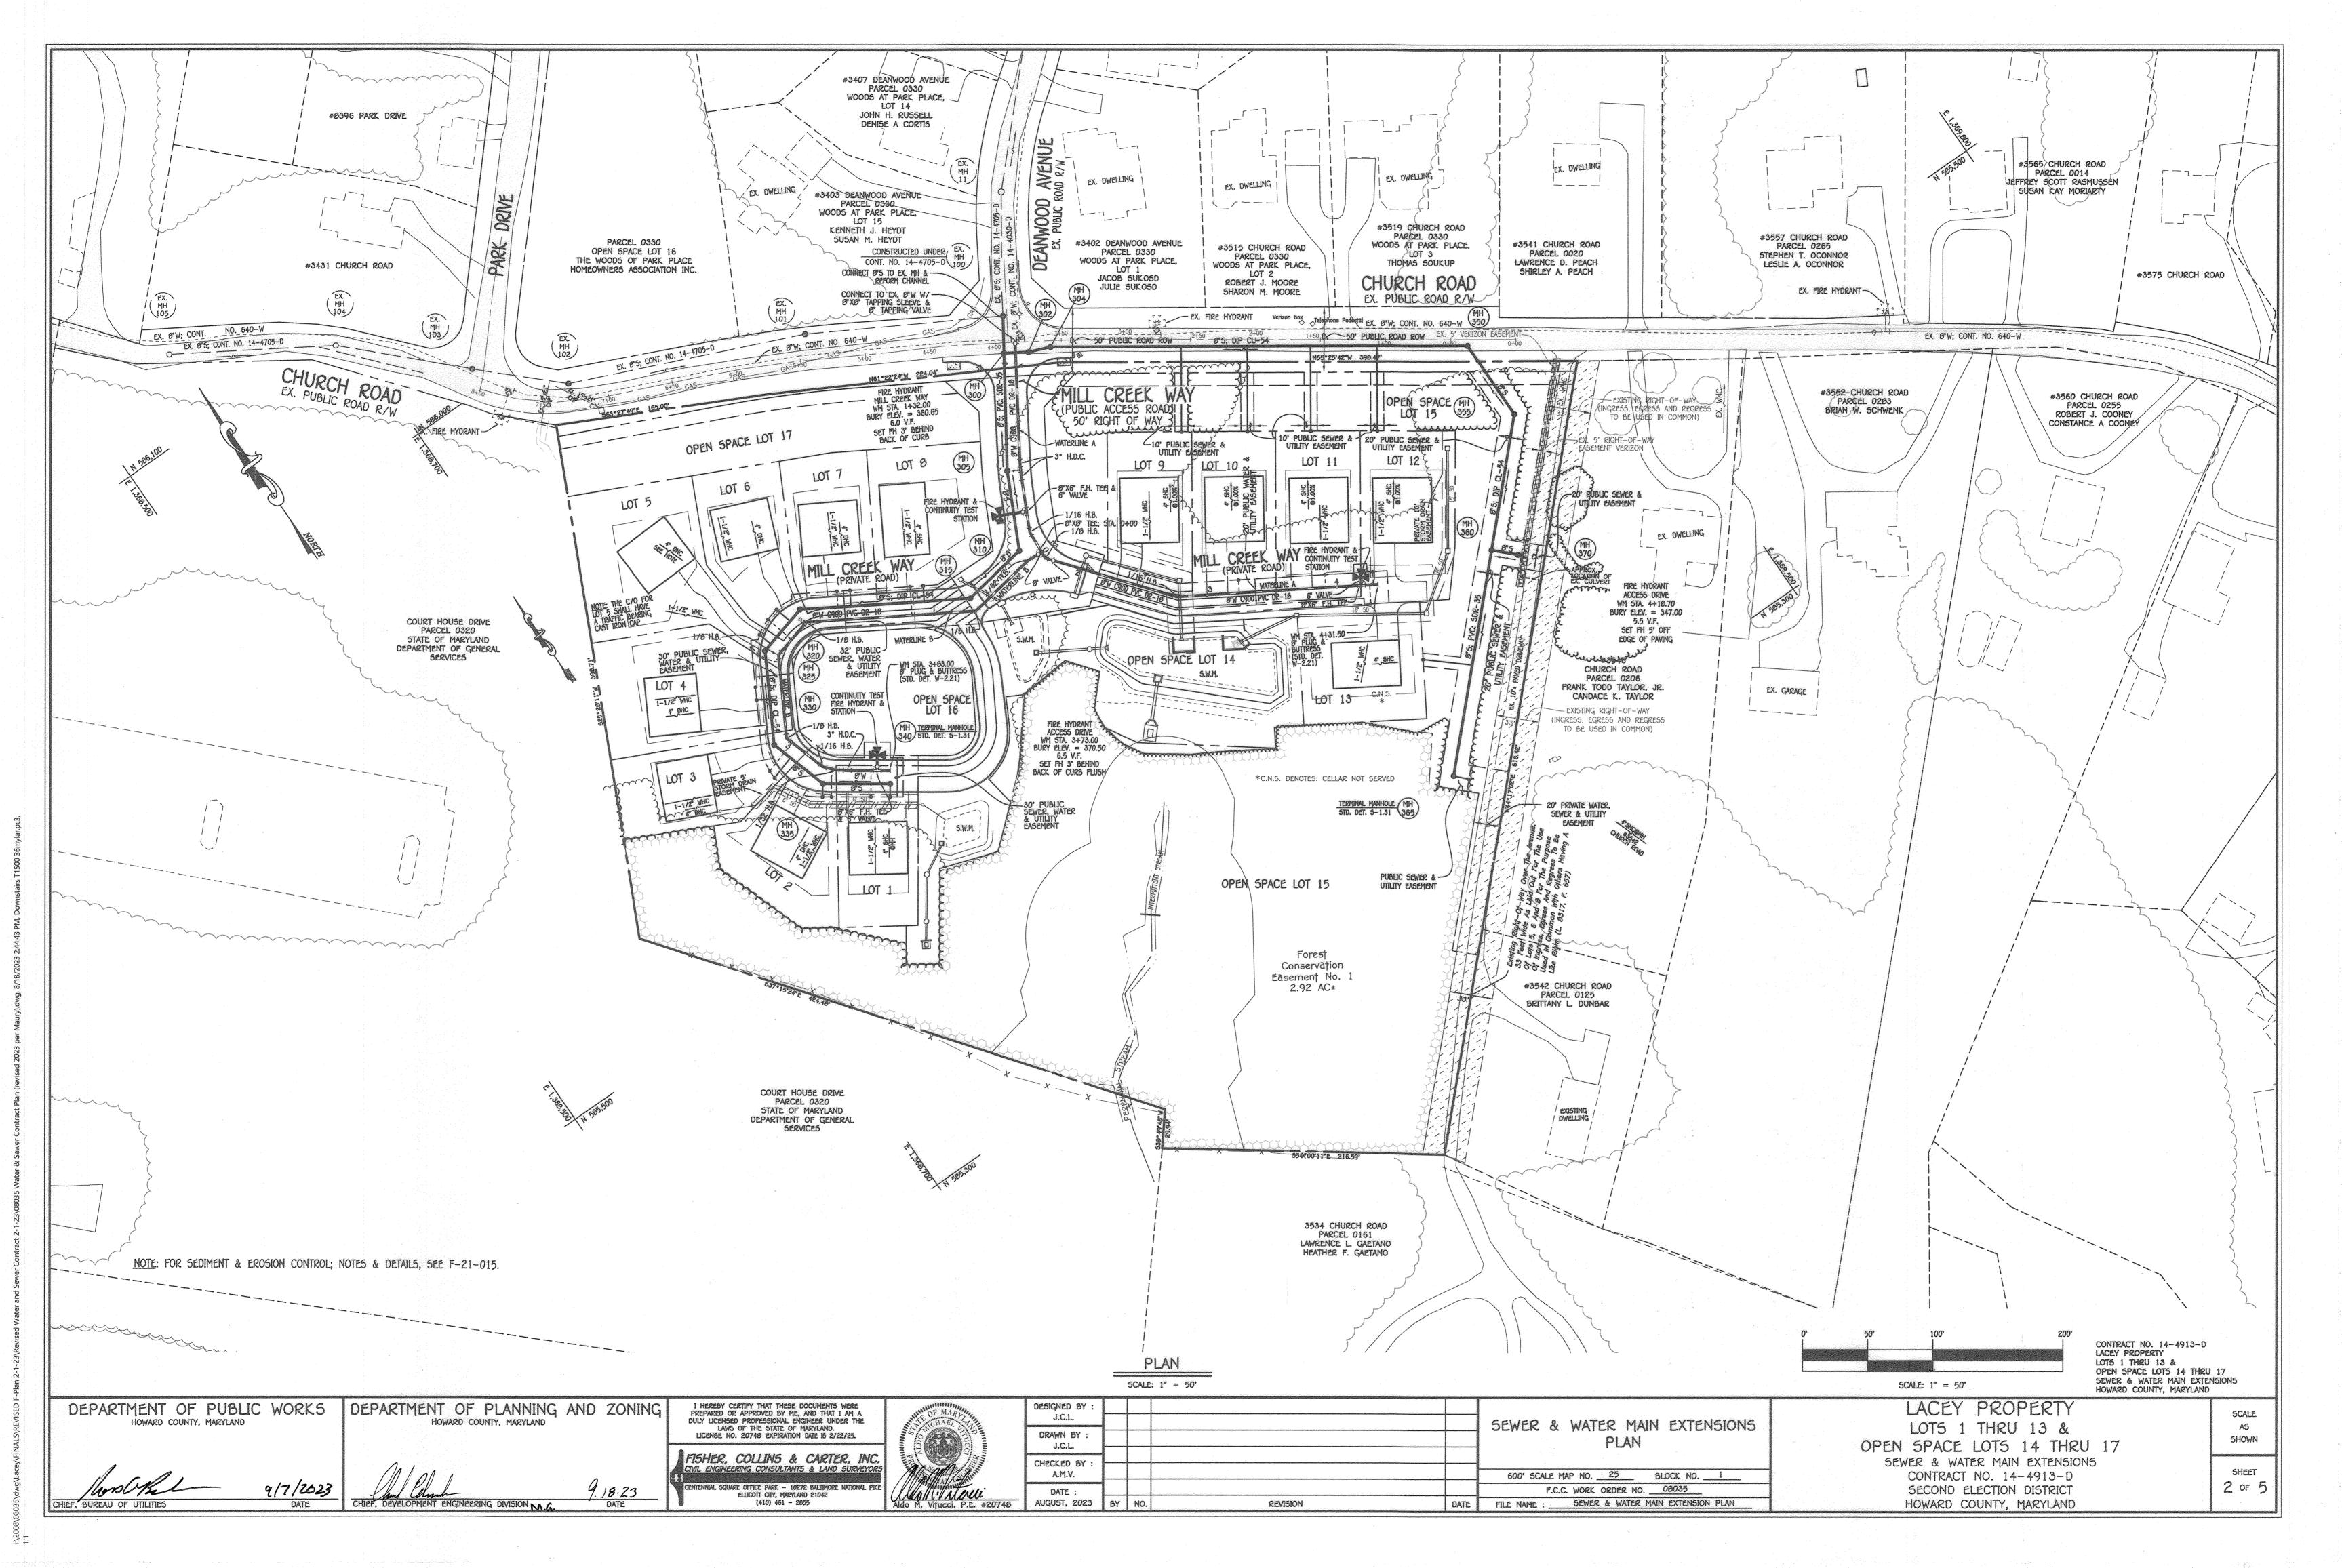

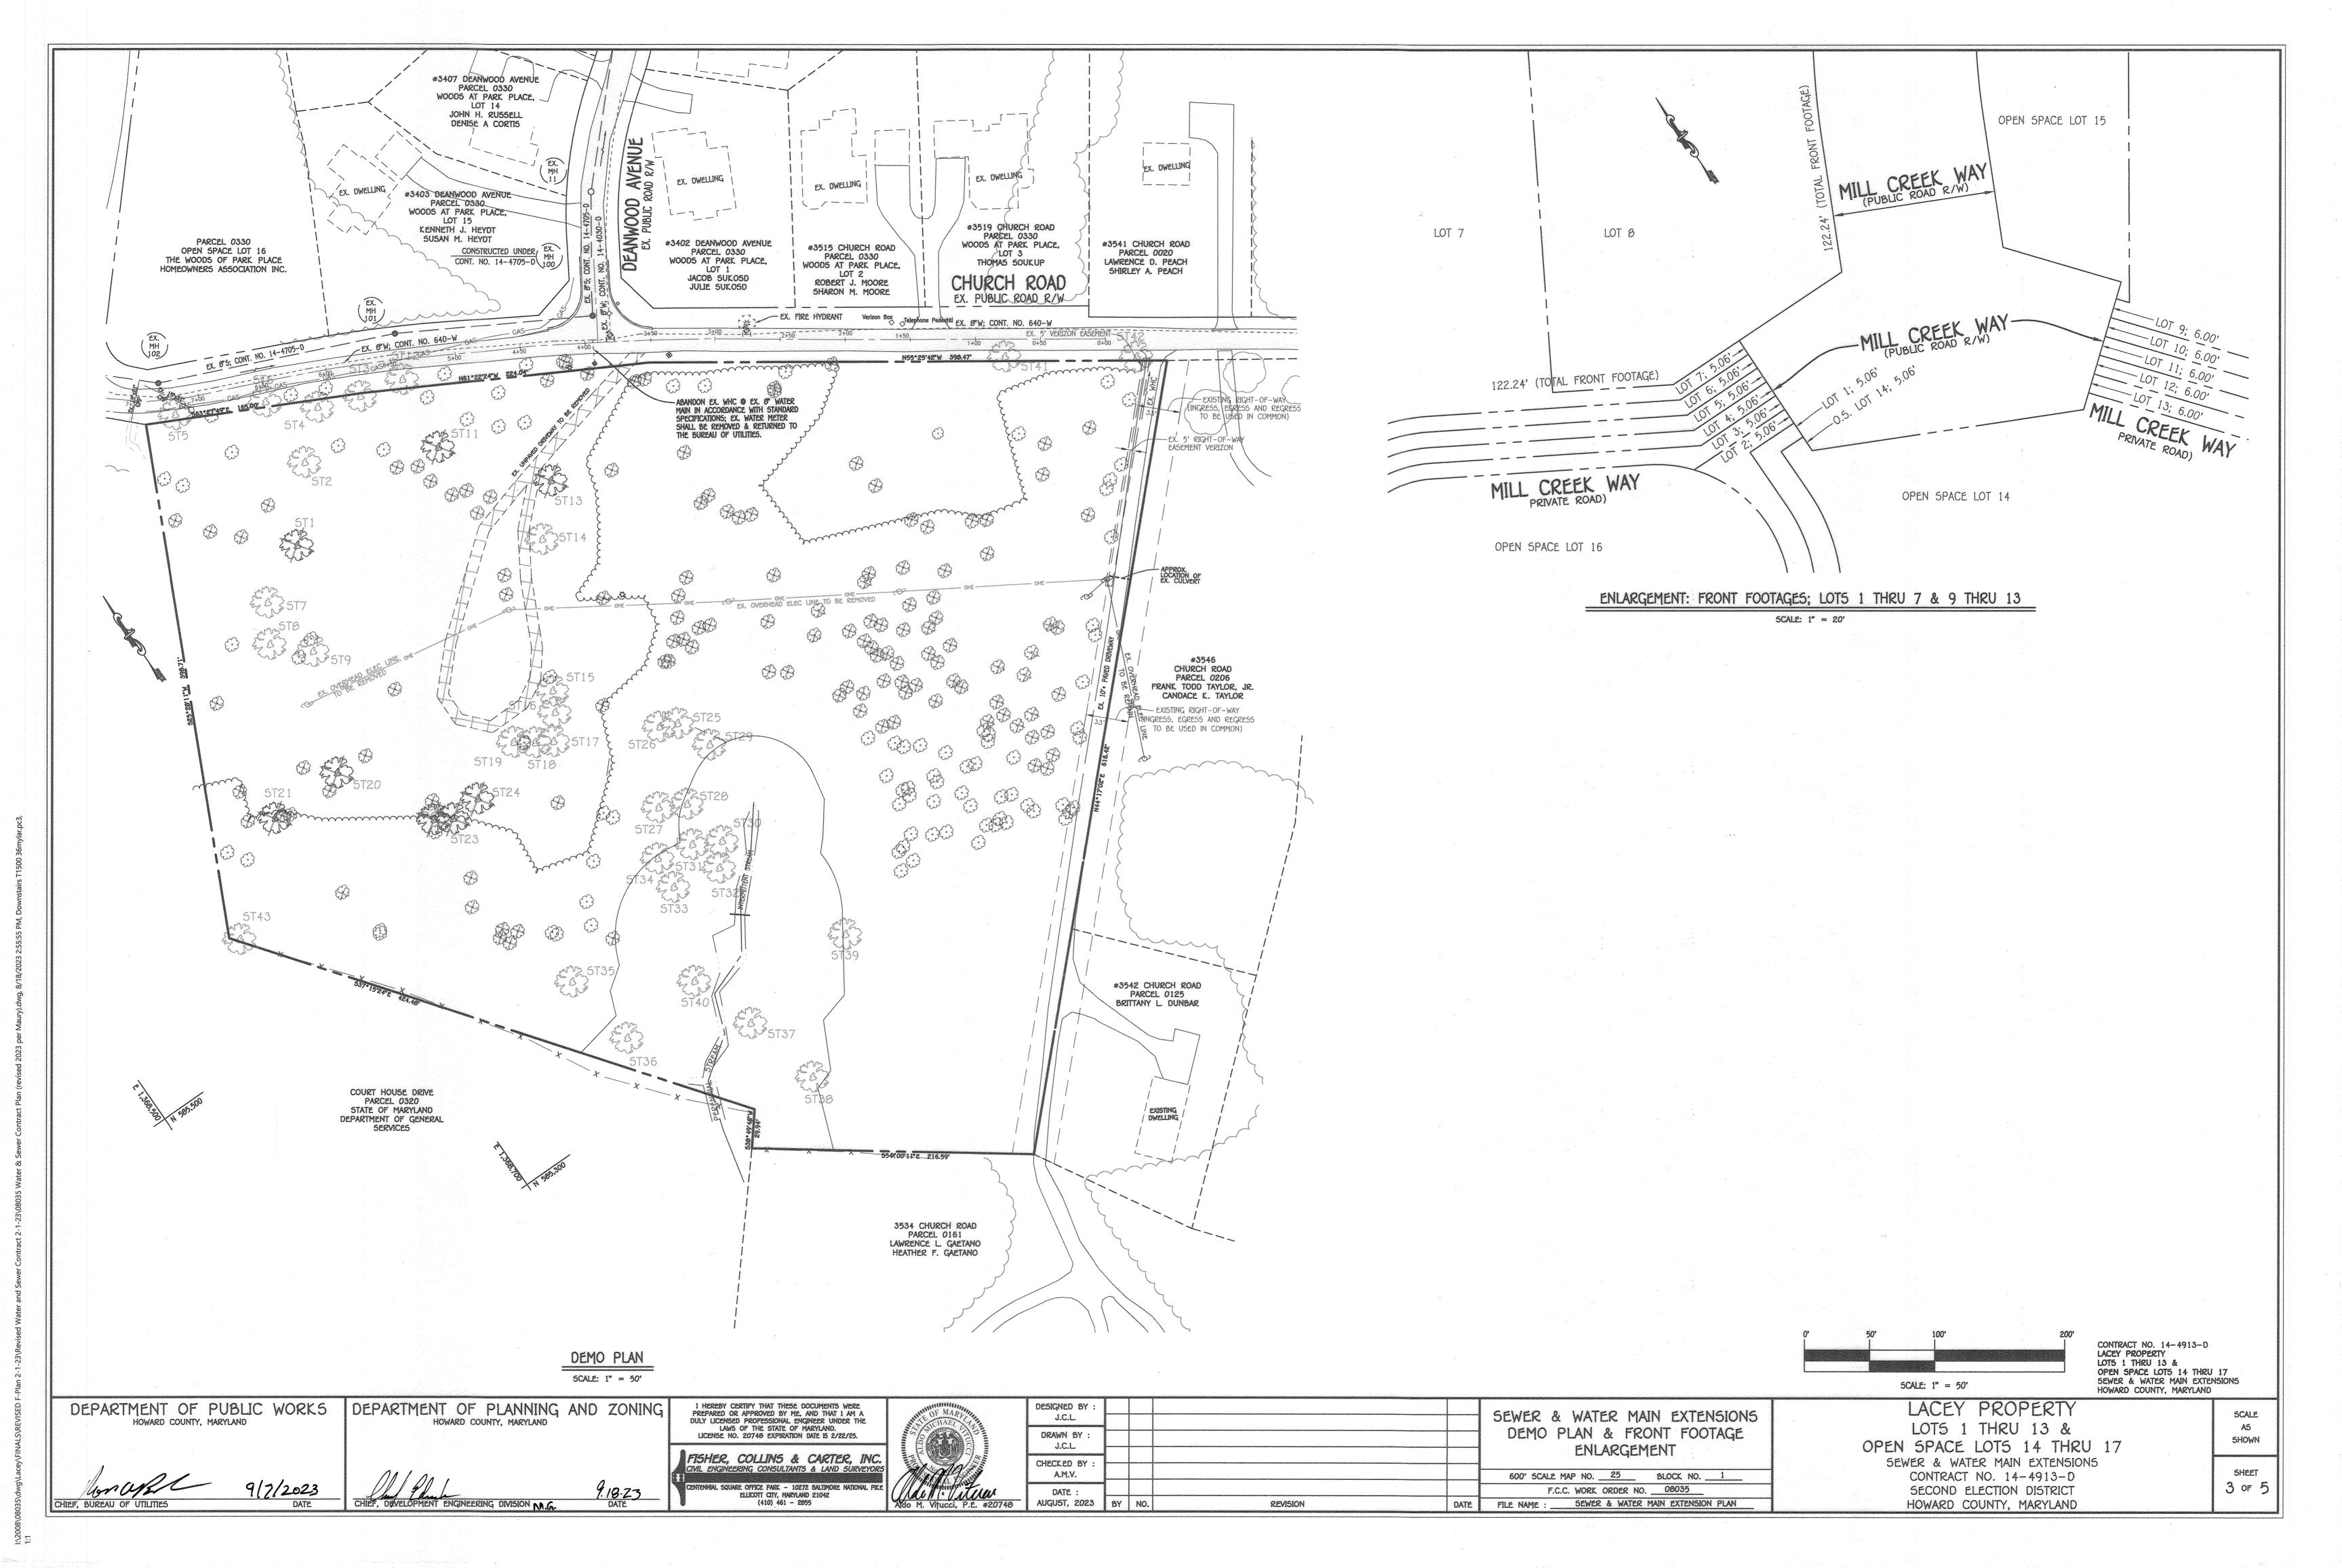

8" WATER MAIN (WATERLINE B): LOTS 1 THRU 8

WATER MAIN TABULATION CHART							
W.M. STA. APPURTENANCE NORTHING EASTING							
	8" WATER MAIN (WATERLINE	8): LOTS 1 THRU 0					
0+00.00 = 1+65.96	8"X8" TEE	585652.49	1369041.75				
0+03.00	8" VALVE	585652.70	1369030.76				
0+11.82	1/32 H.B.	585653.30	1369029.96				
0+67.00	1/0 H.B. (ROTATE 4.67° UP)	585644.30	1368974.70				
1+32.00	Ø"X6" F.H. TEE	585684.78	1369050.00				
1+98.25	1/8 H.B.	505711.65	1360062.90				
2+31.34	1/8 H.B. (ROTATE 4.67° DOWN)	505703.15	1360031.00				
2+95.34	1/8 H.B.	585647.24	1368799.84				
3+30.64	1/16 H.B.	585613.46	1360010.05				
3+40.64	1/32 H.B. (ROTATE 3.30° DOWN)	585605.90	1360016.61				
3+49.91	3° H.D.C.	585600.22	1360023.94				
3+73.00	Ø"X6" F.H. TEE	505507.11	1360042.81				
3+83.00	0" PLUG & BUTTRESS	585581.38	1368850.99				

. do agranos			
WATER	MAIN	NO	res

- 1. ALL WATER MAINS SHALL BE AWWA C900 PVC PIPE; DR-18.
 2. ALL PIPE BEDDING, TRACER WIRE, LOCATING TAPE AND OTHER APPURTENANCES SHALL BE IN ACCORDANCE WITH THE HOWARD COUNTY DESIGN MANUAL, VOLUME IV - WATER AND SEWER STANDARDS FOR AWWA C900 PVC WATER PIPE INSTALLATION.
- DEFLECTION COUPLINGS SHALL BE CERTAIN-TEED PVC HIGH DEFLECTION COUPLINGS. 4. ALL WATER HOUSE CONNECTIONS AND TAPS SHALL BE PERFORMED USING A SADDLE.

380	LACEY PROPERTY; LOTS 9 THRU 13	MILL CREEK WAY CHURCH ROAD	380
si iran isti da ana ana ana ana ana ana ana ana ana	(20' PUBLIC WATER & UTILITY EASEMENT)	(50° PUBLIC ROAD R/W) (EX. 50° PUBLIC ROAD R/V	w)
375			375
370		RIGHT OF WAY STA. 0+05.74 8"W@8"5 INV. = 345.24	370
365		EX. PAVING	365
360	WM 5TA. 2+79.01 &"W@16"50 (F-21-015) INV. = 335.41	CONC. CURB & GLTER WW STA. 2400.69 WM STA. 2400.69 9'-015 1NV. = 351.72 0+00.00 CONNECT TO EX. 8"W 0+00.00 CONNECT TO EX. 8"W	360
355	CONTRACT	0+00.00 CONNECT TO EX. 8"W W/ 8"X8" TAPPING SLEEVE 361.02± 0+03.00 8" TAPPING VALVE 361.02	355
350	위 PROP. GRADE (F-21-015)	1+00 356.30 0+10.00 1+04.59 3° V.D.C. (DOWN)	350
345	WATER MAIN	1+32.00 8"X6" F.H. TEE 354.63 1+47.96 1/16 H.B. ROTATE H.B. 1.56° (DOWN) 353.79	345
340	5 4+31.50 ELEV.339.00	345.66 1+50 353.63 1+65.96 = 0+00.00	340
335	## 150 ## PLUG & BUTTRESS STD. DET. W-2.21 342.47 ## 156° (UP) 343.53 ## 156° (UP) 343.53 ## 34.31 ##	352.35 1+71.22 1/0 H.B. 351.94 1+77.76 6' VALVE 351.42 2+00 349.65	335
330	4+10.70 3° V.C.D. (UP) 3° V.C.D. (UP) 3° V.C.D. (UP) 339.69 339.69 TOP OF RETAINING WALL FOOTER AT ENCROACHMENTS—		330
325		SEE THIS SHEET FOR CONTINUATION OF 8"W: WATERLINE 'B'; LOTS 1 THRU 8	325
320	PROFILE SCALE: HORZ.: 1" = 50' VERT.: 1" = 5'	SEE WATER MAIN NOTES THIS SHEET (ADJACENT)	320

8" WATER MAIN (WATERLINE A): LOTS 9 THRU 13

W	ATER MAIN TABI	ULATION CHA	RT
W.M. STA.	APPURTENANCE	NORTHING	EASTING
	8" WATER MAIN (WATERLINE	A): LOTS 9 THRU 13	
0+00.00	8"X8" TAPPING SLEEVE	505797.94	1369117.70
0+03.00	8" TAPPING VALVE	585795.41	1369116.09
0+10.00	3° V.D.C.	585789.50	1369112.34
0+94.60	3° H.D.C.	585718.10	1369066.95
1+04.59	3° H.D.C.	585709.39	1369062.07
1+32.00	Ø"X6" F.H. TEE	505604.70	1369050.00
1+47.96	1/16 H.B.	505670.45	1369042.98
1+65.96 = 0+00.00	er xer tee	585652.49	1369041.75
1+71.22	1/0 H.B.	585647.24	1369041.39
1+77.76	8" VALVE	505642.15	1369045.50
2+76.69	1/16 H.B.	505565.15	1369107.61
3+50.00	3° V.D.C.	585526.87	1369169.69
3+70.50	3° V.D.C.	585512.31	1369194.63
4+18.70	9"X6" F.H. TEE	585491.40	1369229.06
4+31.50	8" PLUG & BUTTRESS	585484.75	1369239.92


WATER HOUSE CONNECTION AS-BUILT LOCATION TABLE						
LOT NUMBER	ADDRESS	LOCATION DIMENSION 1	LOCATION DIMENSION 2			
1 1	3728 MILL CREEK WAY					
2	3724 MILL CREEK WAY					
3	3720 MILL CREEK WAY					
4	3716 MILL CREEK WAY					
5	3712 MILL CREEK WAY					
6	3708 MILL CREEK WAY					
7	3704 MILL CREEK WAY					
8	3700 MILL CREEK WAY					
9	3701 MILL CREEK WAY					
10	3705 MILL CREEK WAY					
11	3709 MILL CREEK WAY					
12	3713 MILL CREEK WAY					
13	3717 MILL CREEK WAY					

DEPARTMENT OF PUBLIC WORKS
HOWARD COUNTY, MARYLAND DEPARTMENT OF PLANNING AND ZONING HOWARD COUNTY, MARYLAND


9/7/2023

I HEREBY CERTIFY THAT THESE DOCUMENTS WERE PREPARED OR APPROVED BY ME, AND THAT I AM A DULY LICENSED PROFESSIONAL ENGINEER UNDER THE LAWS OF THE STATE OF MARYLAND.

LICENSE NO. 20748 EXPIRATION DATE IS 2/22/25. FISHER, COLLINS & CARTER, INC.
CIVIL ENGINEERING CONSULTANTS & LAND SURVEYORS

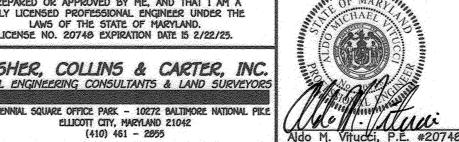

20748	AUGUST, 2023	BY	NO.	REVISION	DATE	FILE NAME : SEWER & WATER MAIN EXTENSION PLAN
ci	DATE :					F.C.C. WORK ORDER NO. 08035
	CHECKED BY : A.M.V.					600' SCALE MAP NO. 25 BLOCK NO. 1
	J.C.L.					PROFILES, CHARTS, NOTES & TABLE
	DRAWN BY :					WATER MAIN EXTENSIONS
	DESIGNED BY : J.C.L.					WATER MAIN EXTENSIONS

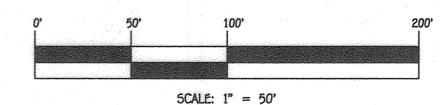


CONTRACT NO. 14-4913-D
LACEY PROPERTY
LOTS 1 THRU 13 &
OPEN SPACE LOTS 14 THRU 17
SEWER & WATER MAIN EXTENSIONS
HOWARD COUNTY, MARYLAND

LACEY PROPERTY LOTS 1 THRU 13 & OPEN SPACE LOTS 14 THRU 17 SEWER & WATER MAIN EXTENSIONS CONTRACT NO. 14-4913-D SECOND ELECTION DISTRICT

HOWARD COUNTY, MARYLAND

SCALE **SHOWN** 4 of 5

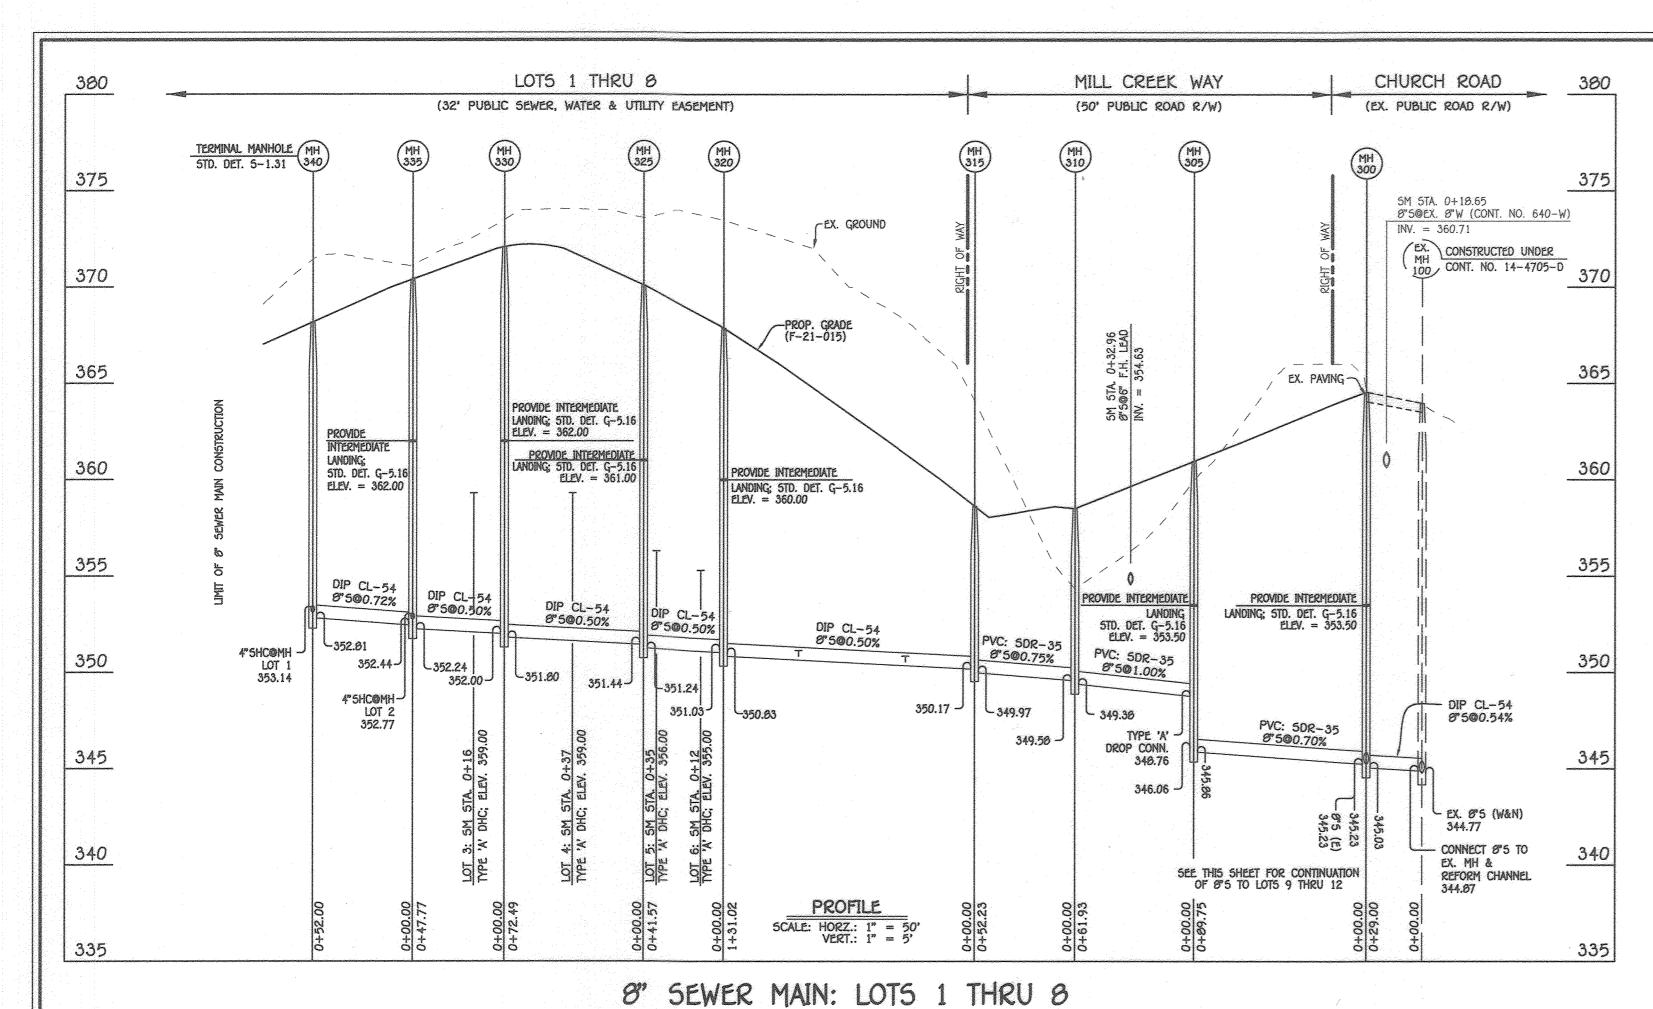


	SEWER	R HOUSE	CONNECTI	ON CH	ART	
STATION	LOT	ELEVATION AT MAIN	ELEVATION AT EDGE OF ESMT.	M.C.E.	8.E.	F.F.
		MH	315 TO MH 320			
0+36 RT.	8	350.60	350.92	355.56	358.50	368.50
0+92 RT.	7	350.96	351.20	355.76	361.50	371.50
		MH	320 TO MH 325			
0+12 RT.	6	355.00 (DHC)	355.26	360.14	362.20	372.20
0+35 RT.	5	356.00 (DHC)	356.20	361.50	362.70	372.70
		MH	325 TO MH 330			
0+37 RT.	4	359.00 (DHC)	359.20	363.88	366.50	376.50
		MH	330 TO MH 335			
0+16 RT.	3	359.00 (DHC)	359.40	364.20	366.50	376.50
		MH	335 TO MH 340			
@MH 335 RT.	2	352.77	352.93	357.27	362.40	372.40
@MH 340 RT.	1	353.14	353.30	357.64	361.40	371.40


SEWER HOUSE CONNECTION AS-BUILT LOCATION TABLE								
LOT NUMBER	ADDRESS	LOCATION DIMENSION 1	LOCATION DIMENSION 2					
1 1	3728 MILL CREEK WAY	1						
2	3724 MILL CREEK WAY							
3	3720 MILL CREEK WAY							
4	3716 MILL CREEK WAY							
5	3712 MILL CREEK WAY							
6	3700 MILL CREEK WAY							
7	3704 MILL CREEK WAY							
8	3700 MILL CREEK WAY							
9	3701 MILL CREEK WAY							
10	3705 MILL CREEK WAY							
11	3709 MILL CREEK WAY							
12	3713 MILL CREEK WAY							
13	3717 MILL CREEK WAY							


370 365 360 PROBE PROPERTY OF STATE			
375 380 380 380 380 380 380 380 38			
365 366 CL. PANNS; PROME PROPERTY: PR	375 MH 300 MH MH 302 304 9		37
365 360 PROMISE INTERMENTALE INVENTED STATE	370 361.08 ¥ 99.60		37
PROMISE INTERPRENATE JAMES STD. DET. C-516 LIMBING STD. DET. C-516 L			_3(
355	PROVIDE INTERMEDIATE	PROVIDE INTERMEDIATE	36
350 8 9 9 0.50% DIP CL-54 6'5@0.50% DIP CL-54 6'5 Ell Clark BO CL-54 B	355 ELEV. = 355.00 LANDING; STD. DET. G-5.16 ELEV. = 355.00	ELEV. = 359.00 LANDING: STD. DET. G-5.16 ELEV. = 358.00	3
DIP CL-54	350 b ²	#5@0.50% PVC: 5DR-35	_3
345.03 340 345.23- 8'5 (5) PROFILE 5EE THIS SHEET FOR CONTINUATION OF \$\text{G}\$ TO PARCEL 0206 SCALE: HORZ.: 1" = 50" VERT.: 1" = 5"	DIP CL-54 #5@0.50% T T T T SS 355 55 88		34
	345.03 340 345.23 PROFILE 5CALE: HORZ.: 1" =	" = 50' ' = 5'	34
8" SEWER MAIN: LOTS 9 THRU 13	345.23 00 00 00 00 00 00 00 00 00 00 00 00 00	3+20.00 0+00.00 0+00.00 1+75.20	resument y sees sold superior sold sold sold sold sold sold sold sold

M	ANHOLE TAB	ULATION CHA	ART
NO.	NORTHING	EASTING	RIM ELEVATION
302	585784.23	1369120.70	365.60
304	585777.74	1369136.91	365.69
350	585596.06	1369400.54	370.91
355	585532.45	1369400.25	369.00
360	585456.88	1369326.54	358.90
365	505331.43	1369204.19	363.30
370	585442.43	1369341.36	362.45

	SEWER	HOUSE	CONNECTI	ON CHA	RT	
STATION	LOT	ELEVATION AT MAIN	ELEVATION AT EDGE OF ESMT.	M.C.E.	8.E.	F.F.
		МН	304 TO MH 350			
1+00 RT.	9 (1.00%)	346.45	347.10	350.66	354.55	364.55
1+51 RT.	10 (1.00%)	346.70	347.35	350.79	351.00	361.00
2+00 RT.	11 (1.00%)	346.95	347.60	350.99	351.00	361.00
2+51 RT.	12 (1.00%)	347.20	347.85	351.30	351.50	361.50
		MH	360 TO MH 365			
0+89 RT.	13 (1.00%)	349.14	349.51	352.66 *	342.70	352.70
@MH 365 LT.	#3542 CHURCH RO.	349.65	350.11	-	-	_

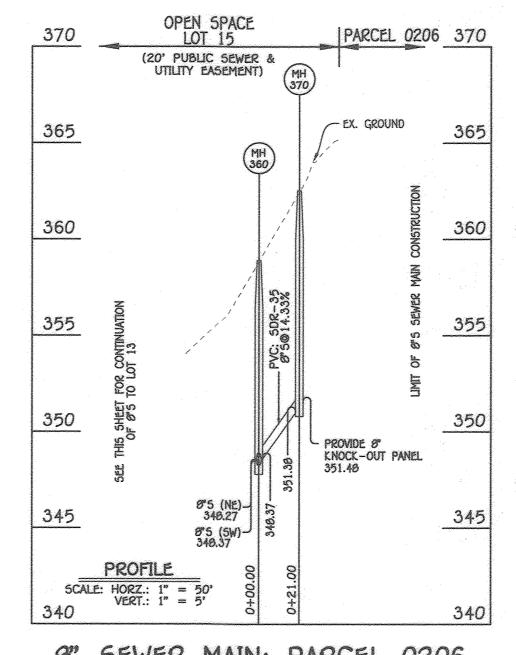

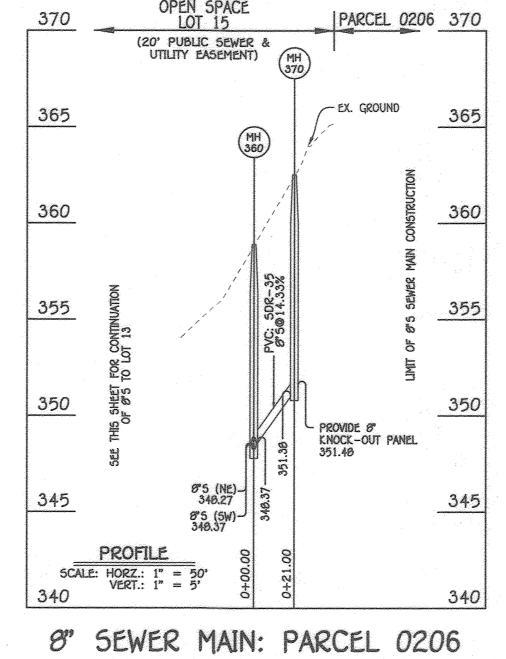

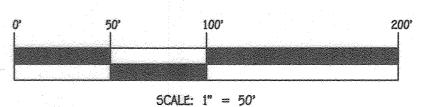

CONTRACT NO. 14-4913-D LACEY PROPERTY
LOTS 1 THRU 13 &
OPEN SPACE LOTS 14 THRU 17
SEWER & WATER MAIN EXTENSIONS
HOWARD COUNTY, MARYLAND

DEPARTMENT OF PUBLIC WORKS HOWARD COUNTY, MARYLAND

9/7/2023

MANHOLE TABULATION CHART

565794.22 1369104.60

1369055.53

1369028.28

1368976.72

1368864.51

1368824.34

1368789.04

1368802.86

1360045.30

RIM ELEVATION

360.96

350.50

358.63

367.97

370.10

372.10

370.40

368.70

NORTHING

585718.78

505663.17

585654.76

585722.40

585711.72

505640.41

585602.69

505573.20

305

310

315 320

325

330

335

340

NOTE: SET MH RIMS FLUSH W/PROPOSED GRADE.

DEPARTMENT OF PLANNING AND ZONING HOWARD COUNTY, MARYLAND

I HEREBY CERTIFY THAT THESE DOCUMENTS WERE PREPARED OR APPROVED BY ME, AND THAT I AM A DULY LICENSED PROFESSIONAL ENGINEER UNDER THE LAWS OF THE STATE OF MARYLAND.

LICENSE NO. 20740 EXPIRATION DATE IS 2/22/25. FISHER, COLLINS & CARTER, INC. CIVIL ENGINEERING CONSULTANTS & LAND SURVEYORS ennial square office park – 10272 Baltimore National Pike ELLICOTT CTY, MARYLAND 21042 (410) 461 - 2955

	MARKE OF	MARL	Marie Valley	
0,10		HAEL	4	
"AAAAAAAAAAAAAA				
		MA		
	Koll	11:1/	LUU' .E. #20748	-

		Name and Address of the Owner, where	-			
CONTRACTOR CONTRACTOR	DESIGNED BY : J.C.L.					
dependentes	U.U.L.					SEWER MAIN EXTENSIONS
SIMBINITIES	DRAWN BY:					PROFILES, CHARTS & TABLE
AND DESCRIPTION OF THE PERSON	J.C.L.					PRUTILLY, CHARTS & TABLE
Statement	CHECKED BY :					
depositivamento	A.M.V.					600' SCALE MAP NO. 25 BLOCK NO. 1
Sizeotowa	DATE :					F.C.C. WORK ORDER NO. 08035
- Operations	AUGU5T, 2023	BY	NO.	REVISION	DATE	FILE NAME : SEWER & WATER MAIN EXTENSION PLAN

LACEY PROPERTY LOTS 1 THRU 13 & OPEN SPACE LOTS 14 THRU 17 SEWER & WATER MAIN EXTENSIONS CONTRACT NO. 14-4913-D SECOND ELECTION DISTRICT HOWARD COUNTY, MARYLAND

5CALE **SHOWN** 5 of 5