QUANTITIES AS-BUILT QUANTITIES ITEMS **ESTIMATED** TYPE MANUF./SUPPLIER QUANTITIES FLUSHING CONNECTIONS 3.00" LOW PRESSURE LATERAL PIPE 1,003 2.0" LOW PRESSURE SEWER SEWER 4,332 4" PVC SEWER 386 MANHOLE 3000 GALLON SEPTIC TANK SIMPLEX GRINDER PUMP DUPLEX GRINDER PUMP 2 1/16 HB 1/8 HB 7 de MONITORING WELL CONC. VAULT w/CONDUCTING ROD 6700 GALLON DOSE TANK 3 DOSE PUMPS AIR RELEASE VALVE 4500 GALLON BIO-MICROBICS TANK 1824 3' WIDE TRENCH NAME OF UTILITY CONTRACTOR:

EXISTING STRUCTURE PROPOSED STRUCTURE SEWAGE DISPOSAL AREA PROPOSED WELL BOX LOW PRESSURE SEWER (LPS) DRAINFIELD DIVIDE SEPTIC TRENCH CONTINUITY TEST STATION FOREST CONSERVATION EASEMENT 20% AND GREATER SLOPES 25% AND GREATER SLOPES

SURVEY AND DRAFTING DIVISION AS-BUILT DATE:

SHEET INDEX							
NO.	TITLE						
1	TITLE SHEET						
2	PLAN & PROFILE VIEW						
3	PLAN & PROFILE VIEW						
4	PLAN & PROFILE VIEW						
5	PLAN & PROFILE VIEW						
6	PERCOLATION TEST RESULTS						
7	CONSTRUCTION DETAILS, AND NOTES						
8	SITE PLAN AND PFD						
9	DRAINFIELD PLAN						
10	TREATMENT SYSTEM DETAIL						
11	DISTRIBUTION DETAILS						

SEDIMENT CONTROL MEASURES FOR THIS CONTRACT WILL BE IMPLEMENTED IN ACCORDANCE WITH SECTION 308 OF THE HOWARD COUNTY STANDARD SPECIFICATIONS AND AS PER F-19-014.

APPROVED FOR PRIVATE WATER AND SHARED SEPTIC SYSTEM FOR LOTS 16, 21-25, & NON-BUILDABLE PRESERVATION PARCEL B, AND PRIVATE WATER & SEWER FOR LOTS 1-15, 17-20 & 26-36, BUILDABLE PRESERVATION PARCEL D. NON-BUILDABLE PRESERVATION PARCELS A, B, C & E-I

THIS PLAN IS APPROVED FOR SOIL EROSION AND SEDIMENT

CONTROL BY THE HOWARD SOIL CONSERVATION DISTRICT.

FENCE LINE

DEPARTMENT OF PUBLIC WORKS HOWARD COUNTY, MARYLAND

HOWARD COUNTY, MARYLAND

OWNED AND MAINTAINED

DEPARTMENT OF PLANNING AND ZONING

ON LOTS 16, 21-25 SHALL BE FIVE (5).

**MAXIMUM NUMBER OF BEDROOMS FOR EACH HOUSE

**ALL SEWAGE GRINDER PUMPS ARE TO BE PUBLICLY

BENCHMARK ENGINEERS ▲ LAND SURVEYORS ▲ PLANNERS ENGINEERING, INC.

8480 BALTIMORE NATIONAL PIKE ▲ SUITE 315 ELLICOTT CITY, MARYLAND 21043 FAX: 410-465-6644

Professional Certification. I hereby certify that


these documents were prepared or approved by

me, and that I am a duly licensed professional

engineer under the laws of the State of Maryland,

License No. 45577, Expiration Date: 06-08-2020.

KINGS FOREST FINAL PUBLIC SHARED SEPTIC PLANS CONTRACT NO. 50-4866-D

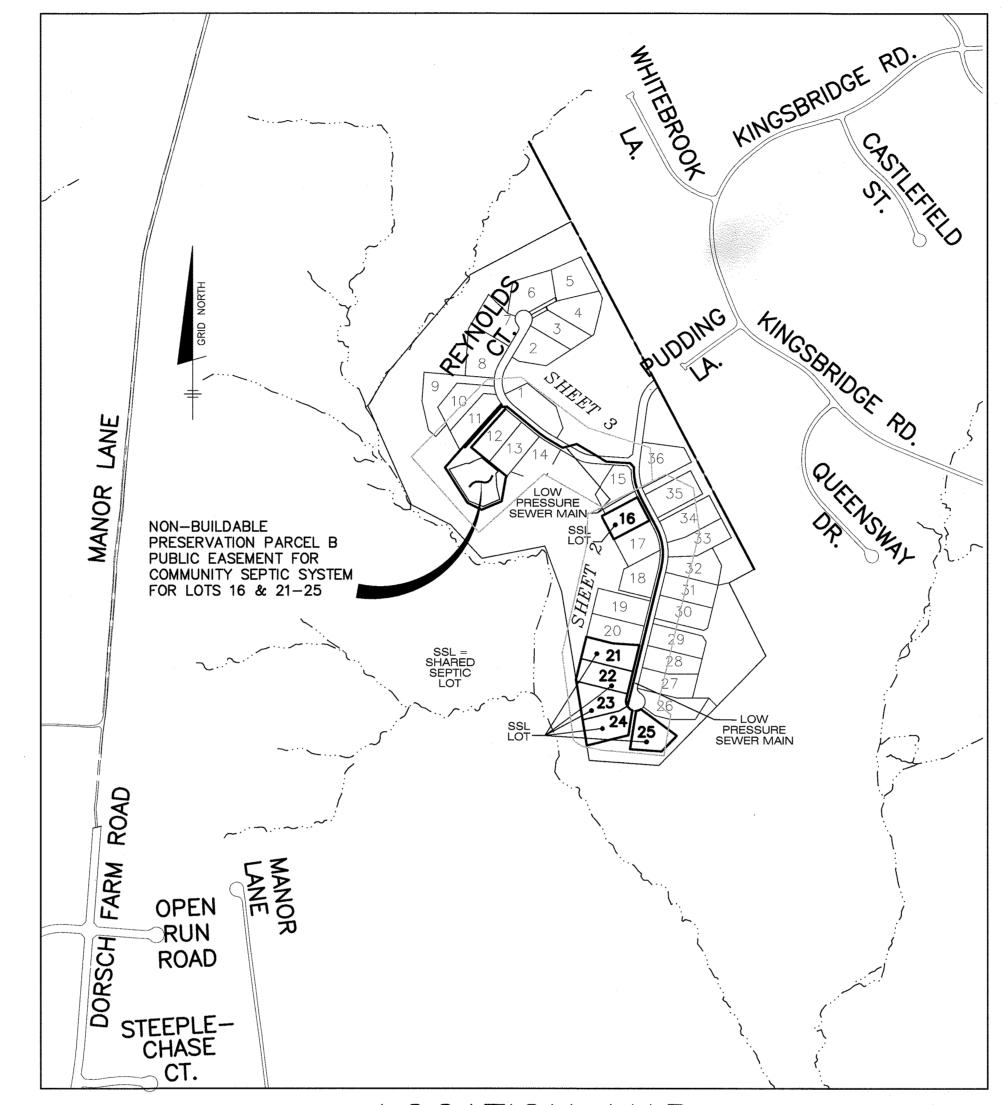

LOCATION MAP SCALE: 1" = 600'ADC MAP PAGE: 26, GRID: D2

TYPE OF BUILDING: NO. OF LOTS/PARCELS/UNITS: NUMBER OF SHC'S: NUMBER OF WHC'S:_ DRAINAGE AREA WATER ZONE: TEST GRADIENT:

OWNERS:

NATALIE ZIEGLER

4288 MANOR LANE

ELLICOTT CITY, MARYLAND 21042

BY NO.

DESIGN: JC

JONATHAN IAN SCHWARTZ,

JESSICA AND SOPHIE ZIEGLER

C/O SOPHIE ZIEGLER

SAN FRANCISCO, CA 94110

212-877-8697

730 DOLORES STREET

REVISIONS

DEVELOPER:

TOLL BROS., INC.

7164 COLUMBIA GATEWAY DRIVE

SUITE 230

410-381-3263

COLUMBIA, MD 21046

SHARED SEPTIC SYSTEM NOTES: 1. WELLS ON THE LOTS SURROUNDING THE COMMON SHARED SEPTIC AREAS

SHALL BE TESTED FOR BACKGROUND LEVELS OF CONTAMINANTS TO BE SPECIFIED BY THE DEPARTMENT OF PUBLIC WORKS PRIOR TO PUTTING THE SHARED SEPTIC SYSTEM IN SERVICE.

2. THE BUILDER SHALL INSTALL BACKFLOW PREVENTER AND RELIEF VENT ON THE SEWER SERVICE AT THE HOUSE, AT THE TIME OF THE HOUSE CONSTRUCTION OR AS REQUIRED BY THE PLUMBING INSPECTOR.

3. INSTALLATION OF GRINDER PUMPS AND APPURTENANCES, AND THE 4" PVC SEWER HOUSE CONNECTIONS (SHC) SHALL BE THE RESPONSIBILITY OF THE

SHALL BE SOLVENT WELDED EXCEPT PORTIONS WITHIN 50 FEET OF A WELL, IN THOSE INSTANCES THE SEWER SHALL BE HDPEP SDR11. A 6 GAUGE TRACER WIRE SHALL BE WRAPPED AROUND OR ATTACHED TO THE PVC PIPE

SEPTIC TANKS SHALL BE VACUUM OR WATER TESTED ON—SITE BY THE MANUFACTURER. SEPTIC TANK SHOP DRAWINGS FROM THE MANUFACTURER SHOULD BE SUBMITTED TO THE HOWARD COUNTY ENVIRONMENTAL HEALTH DEPARTMENT PRIOR TO ISSUANCE OF SHARED SEPTIC SYSTEM PERMIT

6. ALL PRESSURE SEWER IS TO BE PRESSURE TESTED ACCORDING TO THE HOWARD COUNTY DEPARTMENT OF PUBLIC WORKS STANDARDS AND

7. THE CONTRACTOR SHALL NOTIFY HOWARD CO. HEALTH DEPARTMENT AT 410-313-1771 AT LEAST FIVE (5) WORKING DAYS BEFORE ANY PRESSURE TEST OF PRESSURE SEWERS, AND ANY SEPTIC TANKS VACUUM OR WATER TESTING IS PERFORMED.

8. OBSERVATION WELLS TO BE INSTALLED AFTER TRENCH INSTALLATION

9. LOTS WITH "CELLAR NOT SERVICED VIA GRAVITY" IS INDICATED, EJECTOR PUMPS LOCATED INSIDE THE BASEMENT ARE REQUIRED IN ORDER TO

SERVICE THE CELLAR, FIRST FLOOR SERVICE IS PROVIDED BY GRAVITY TRENCH REQUIREMENTS, SEPTIC PRETREATMENT, AND TANK CAPACITY IS OUTLINED ON HYDRO—TERRA DESIGN ON SHEETS 9—14.


DMW2 19-015

TITLE SHEET

DATE 600 SCALE MAP No.: 23 BLOCK: 23 200 SCALE MAP No.

DESIGN MANUAL WAIVER DESCRIPTIONS 1. ON APRIL 12, 2019 THE DEPUTY DIRECTOR OF THE DEPARTMENT OF PUBLIC WORKS APPROVED A DESIGN MANUAL WAIVER TO DESIGN MANUAL VOLUME II, SECTIONS 4.3.B.3.b.4, 4.5.B.2 AND 4.5.E WHICH REQUIRES ALL SEWER HOUSE CONNECTIONS TO BE INSTALLED AT THE REQUIRED DEPTHS TO PROVIDE GRAVITY SERVICE TO THE CELLAR OF EACH LOT. THE APPROVAL OF THIS WAIVER ALLOWS LOTS 22 AND 34 TO PROVIDE AN EJECTOR PUMP FOR BASEMENT

2. THIS DESIGN MANUAL WAIVER WAS EXPANDED TO INCLUDE A WAIVER OF SECTION 5.4.B.5 FOR THE SEPARATION DISTANCE BETWEEN A STRUCTURE AND A PUBLIC SEWER EASEMENT WHICH WAS APPROVED BY A REVISED APPROVAL LETTER DATED JULY 5, 2019. THE APPROVAL OF THIS WAIVER ALLOWS THE EASEMENT SETBACK REQUIREMENT TO 1.3' AND 4.0' IN TWO SPECIFIED LOCATIONS OF THE STREAM CROSSING WINGWALL FOOTERS.

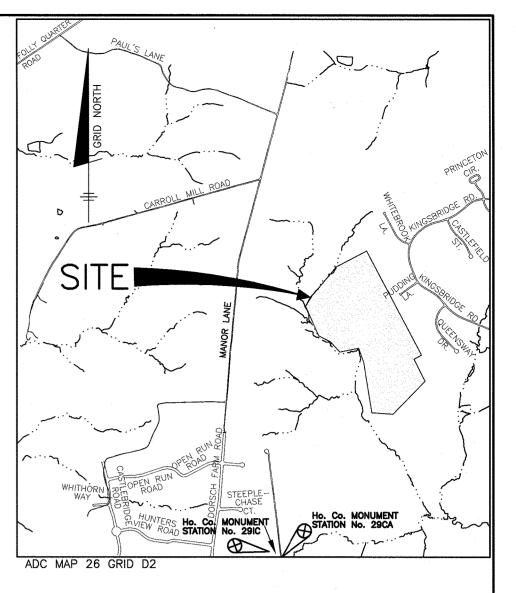

VICINITY MAP

NOTE: ALL JOINTS AND CONNECTIONS LOCATED WITHIN STRUCTURAL FILL AREAS SHALL BE MECHANICALLY RESTRAINED IN ACCORDANCE WITH HOWARD COUNTY DESIGN MANUAL, VOLUME IV, STANDARD SPECIFICATIONS AND DETAILS FOR CONSTRUCTION (LATEST EDITION)

GENERAL NOTES

I. APPROXIMATE LOCATIONS OF EXISTING MAINS ARE SHOWN. THE CONTRACTOR SHALL TAKE ALL NECESSARY PRECAUTIONS TO PROTECT EXISTING MAINS AND SERVICES AND MAINTAIN UNINTERRUPTED SERVICE. ANY DAMAGE INCURRED SHALL BE REPAIRED IMMEDIATELY TO THE SATISFACTION OF THE ENGINEER AT THE CONTRACTOR'S EXPENSE.

2. TOPOGRAPHIC FIELD SURVEYS WERE PERFORMED IN MAY, 2007 BY SILL, ADCOCK & ASSOCIATES AND IN FEBRUARY, 2003 BY BENCHMARK ENGINEERING, INC.

3. HORIZONTAL AND VERTICAL SURVEY CONTROLS:

THE COORDINATES SHOWN ON THE DRAWINGS ARE BASED ON MARYLAND STATE REFERENCE SYSTEM NAD '83/'91 AS PROJECTED BY HOWARD COUNTY GEODETIC CONTROL STATIONS NO.

CONTROLS ARE BASED ON NAVD '88. VERTICAL CONTROLS PROVIDED ON THE DRAWINGS ARE 50BA AND 0015. 4. ALL PIPE ELEVATIONS SHOWN ARE INVERT ELEVATIONS UNLESS OTHERWISE NOTED ON

5. CLEAR ALL UTILITIES BY A MINIMUM OF 12 INCHES. CLEAR ALL POLES BY 5'-0" MINIMUM OR TUNNEL AS REQUIRED UNLESS OTHERWISE NOTED. THE OWNER HAS CONTACTED THE UTILITY COMPANIES AND HAS MADE ARRANGEMENTS FOR BRACING OF POLES AS SHOWN ON THE DRAWINGS. IN THE EVENT THE CONTRACTOR'S WORK REQUIRES THE BRACING OF ADDITIONAL POLES, ANY COST INCURRED BY THE OWNER FOR THE BRACING OF ADDITIONAL POLES OR DAMAGES SHALL BE DEDUCTED FROM MONIES OWED THE CONTRACTOR. THE CONTRACTOR SHALL COORDINATE WITH THE UTILITY COMPANIES TO SCHEDULE THE BRACING

6. FOR DETAILS NOT SHOWN ON THE DRAWING, AND FOR MATERIALS AND CONSTRUCTION METHODS, USE HOWARD COUNTY DESIGN MANUAL VOLUME IV, STANDARD SPECIFICATIONS AND DETAILS FOR CONSTRUCTION (LATEST EDITION). THE CONTRACTOR SHALL HAVE A COPY OF VOLUME IV ON THE JOB.

7. WHERE TEST PITS HAVE BEEN MADE ON EXISTING UTILITIES, THEY ARE NOTED BY THE SYMBOL AT THE LOCATIONS OF THE TEST PITS. A NOTE OR NOTES CONTAINING THE RESULTS OF THE TEST PIT OR PITS IS INCLUDED ON THE DRAWINGS. EXISTING UTILITIES IN THE VICINITY OF THE PROPOSED WORK FOR WHICH TEST PITS HAVE NOT BEEN DUG SHALL BE LOCATED BY THE CONTRACTOR TWO WEEKS IN ADVANCE OF CONSTRUCTION OPERATIONS AT HIS OWN EXPENSE.

8. THE CONTRACTOR SHALL NOTIFY THE FOLLOWING UTILITY COMPANIES OR AGENCIES AT LEAST FIVE WORKING DAYS BEFORE STARTING WORK SHOWN ON THESE PLANS:

AT&T	1-800-252-1133
BGE (CONTRACTOR SERVICES)	410-637-8713
BGE (EMERGENCY)	410-685-0123
	410-313-4900
	410-795-1390
MISS UTILITY	1-800-257-7777
	410-531-5533
VERIZON	1-800-743-0033/410-224-9210

9. TREES AND SHRUBS ARE TO BE PROTECTED FROM DAMAGE TO THE MAXIMUM EXTENT. TREES AND SHRUBS LOCATED WITHIN THE CONSTRUCTION STRIP ARE NOT TO BE REMOVED OR DAMAGED BY THE CONTRACTOR.

10. THE CONTRACTOR SHALL REMOVE TREES, STUMPS AND ROOTS ALONG LINE OF EXCAVATION. PAYMENT FOR SUCH REMOVAL SHALL BE INCLUDED IN THE UNIT PRICE BID FOR CONSTRUCTION OF THE MAIN.

11. THE CONTRACTOR SHALL NOTIFY THE BUREAU OF HIGHWAYS, HOWARD COUNTY, AT (410)-313-7450 AT LEAST FIVE WORKING DAYS BEFORE OPEN CUTTING OR BORING/JACKING OF ANY COUNTY ROAD FOR LAYING WATER/SEWER MAINS OR HOUSE CONNECTIONS. THE APPROVAL OF THESE DRAWINGS WILL CONSTITUTE COMPLIANCE WITH DPW REQUIREMENTS PER SECTION 18.114(a) OF THE HOWARD COUNTY CODE.

PART III SEWER

1. ALL SEWER MAINS SHALL BE D.I.P. OR P.V.C. UNLESS OTHERWISE NOTED.

2. ALL MANHOLES SHALL BE 4'-0" INSIDE DIAMETER UNLESS OTHERWISE NOTED.

3. LOW PRESSURE SEWERS SHALL BE SDR 21 OR HDPE EQUIVALENT.

4. MANHOLES SHOWN WITH 12" AND 16" WALLS ARE FOR BRICK MANHOLES ONLY. 5. MANHOLES DESIGNATED W.T. IN PLAN AND PROFILE SHALL HAVE WATERTIGHT FRAME AND COVER, STANDARD DETAIL G5.52. WHERE WATERTIGHT MANHOLE FRAMES AND COVERS ARE USED, SET TOP OF FRAME 1'-6" ABOVE FINISHED GRADE UNLESS OTHERWISE NOTED ON

6. HOUSE(S) WITH THE SYMBOL "C.N.S." INDICATES THAT CELLAR CANNOT BE SERVED. 7. THE DEVELOPER SHALL PROVIDE ONE SPARE GRINDER PUMP TO THE BUREAU OF UTILITIES UPON DEDICATION OF THE SHARED SEPTIC SYSTEM TO THE COUNTY.

KINGS FOREST FINAL PUBLIC SHARED SEPTIC SYSTEM PLANS

LOTS 16, 21 thru 25 and


NON-BUILDABLE PRESERVATION PARCEL 'B'


TAX MAP: 23 - BLOCK: 23 - PARCEL: 148 - ZONED: RC-DEO - ELECTION DISTRICT: 2 CONTRACT NO. 50-4866-D


SHEET NO. 1 OF 11


SCALE:


AS SHOWN

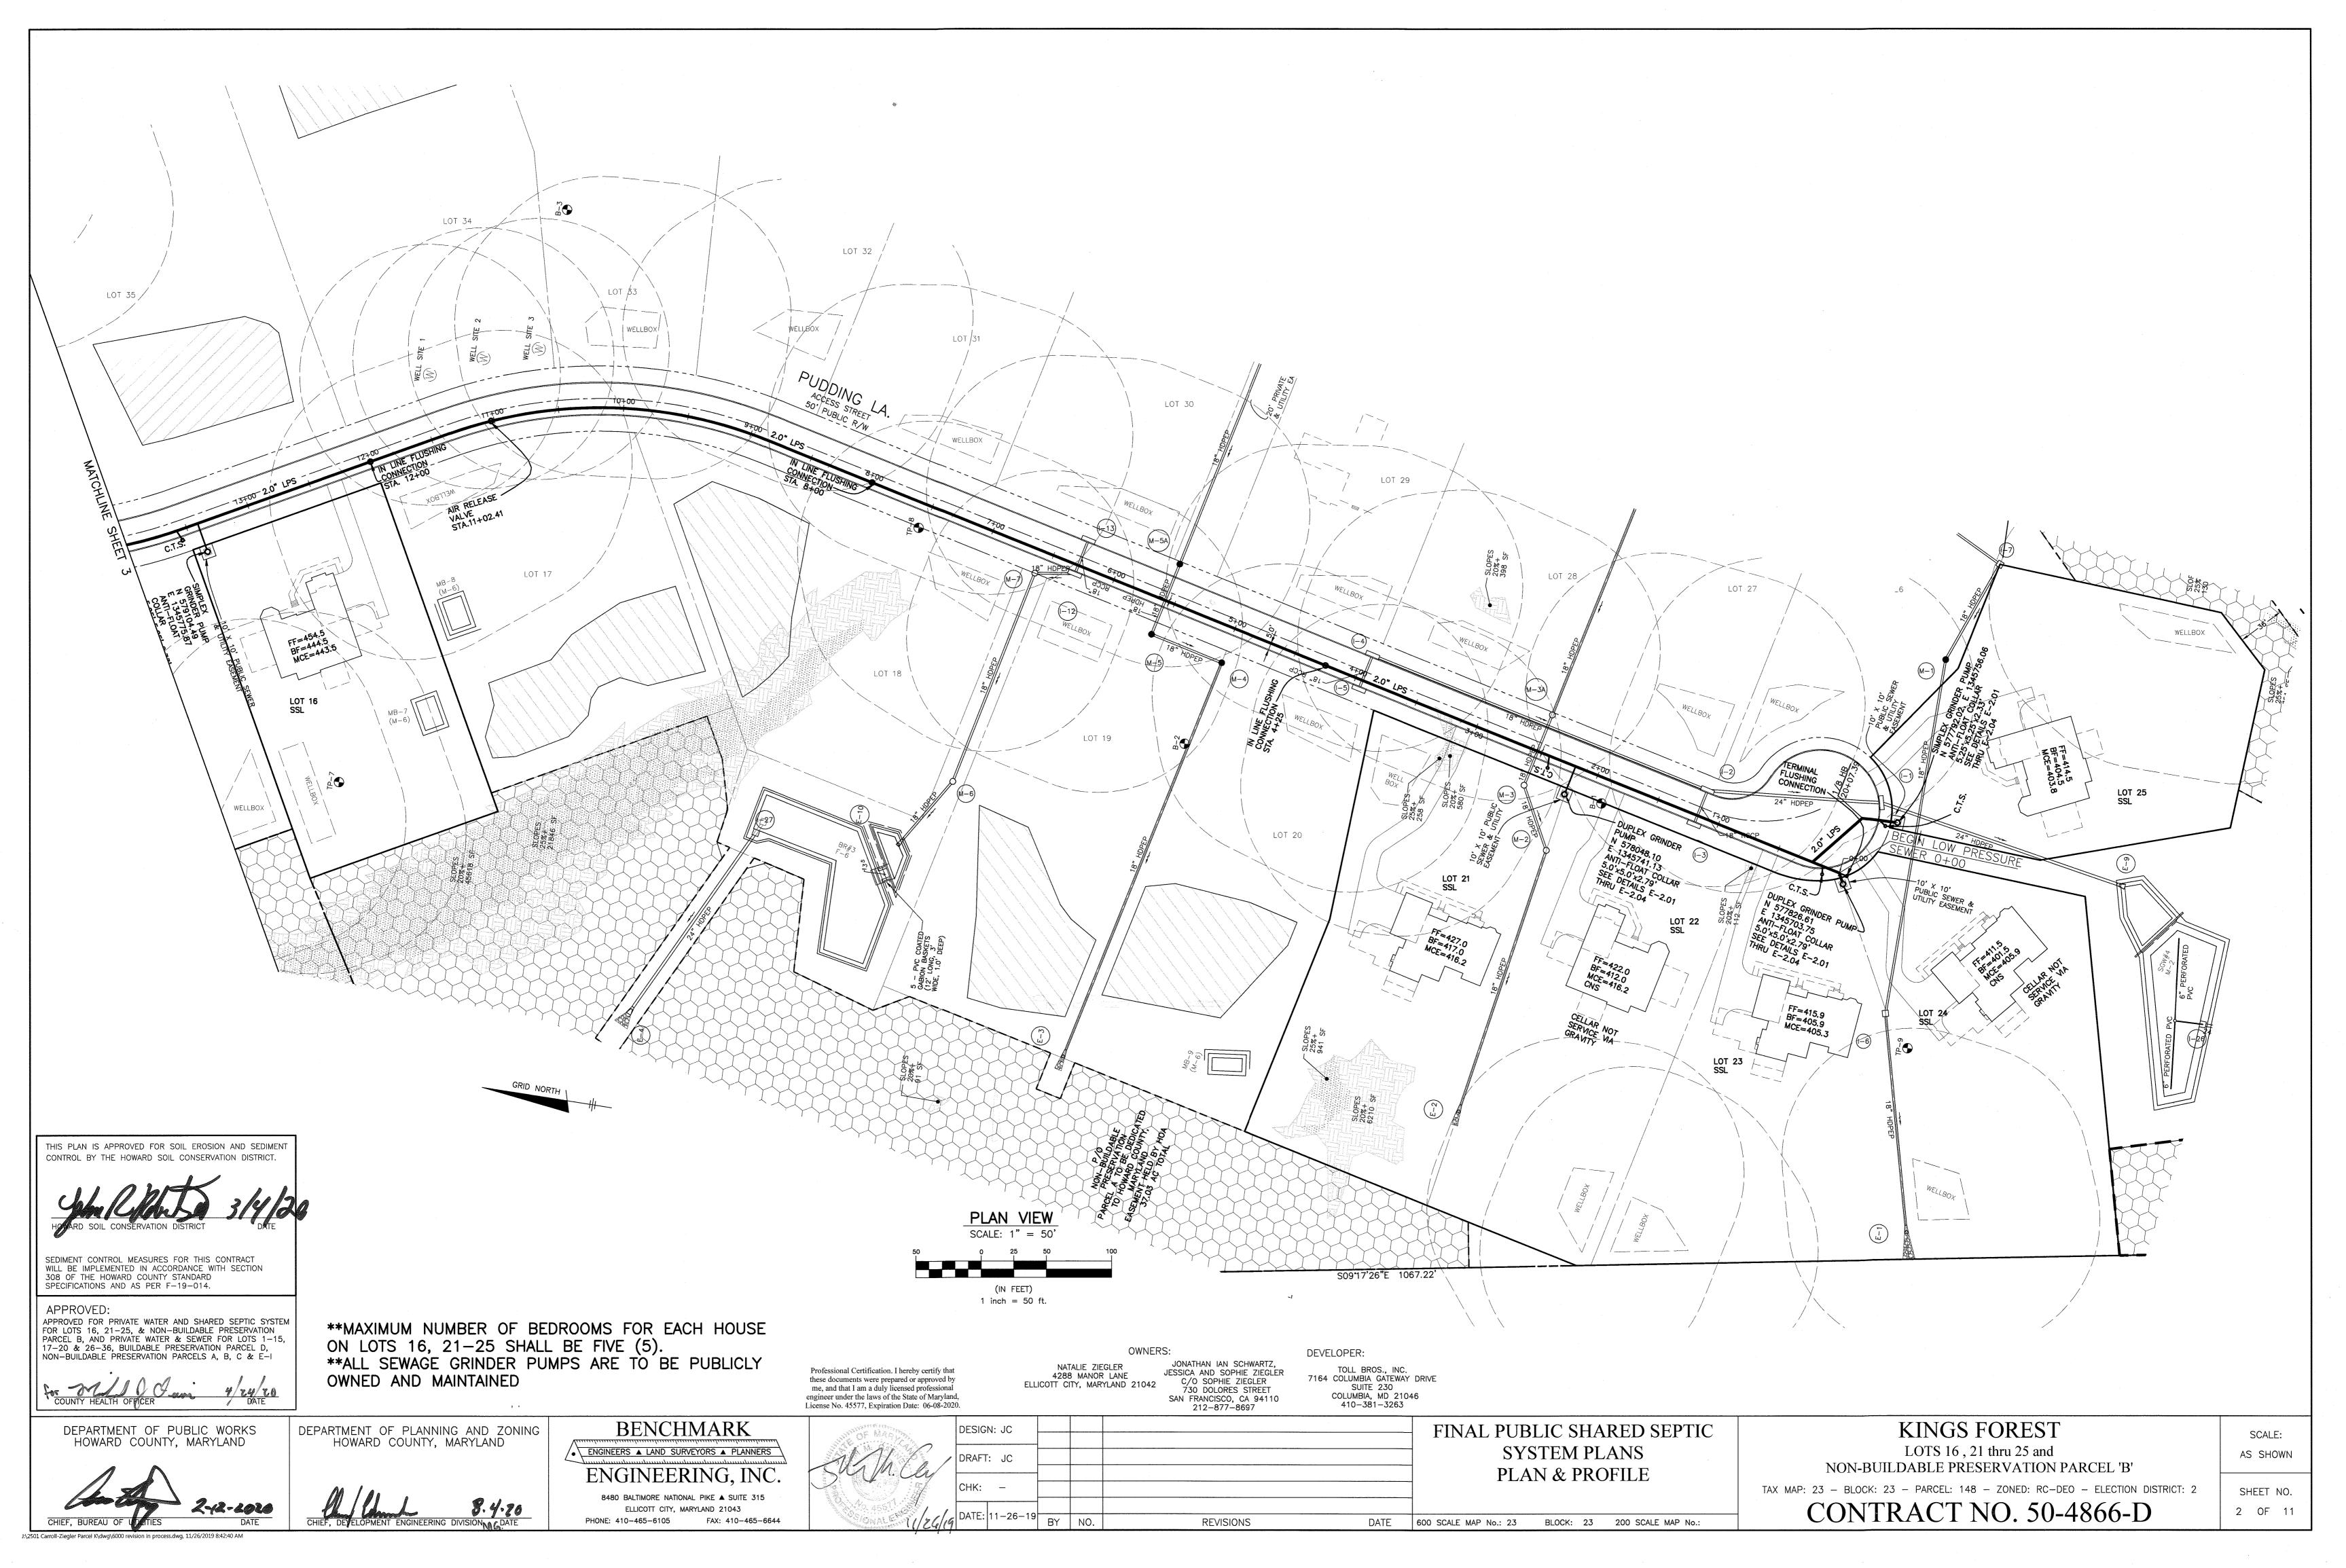

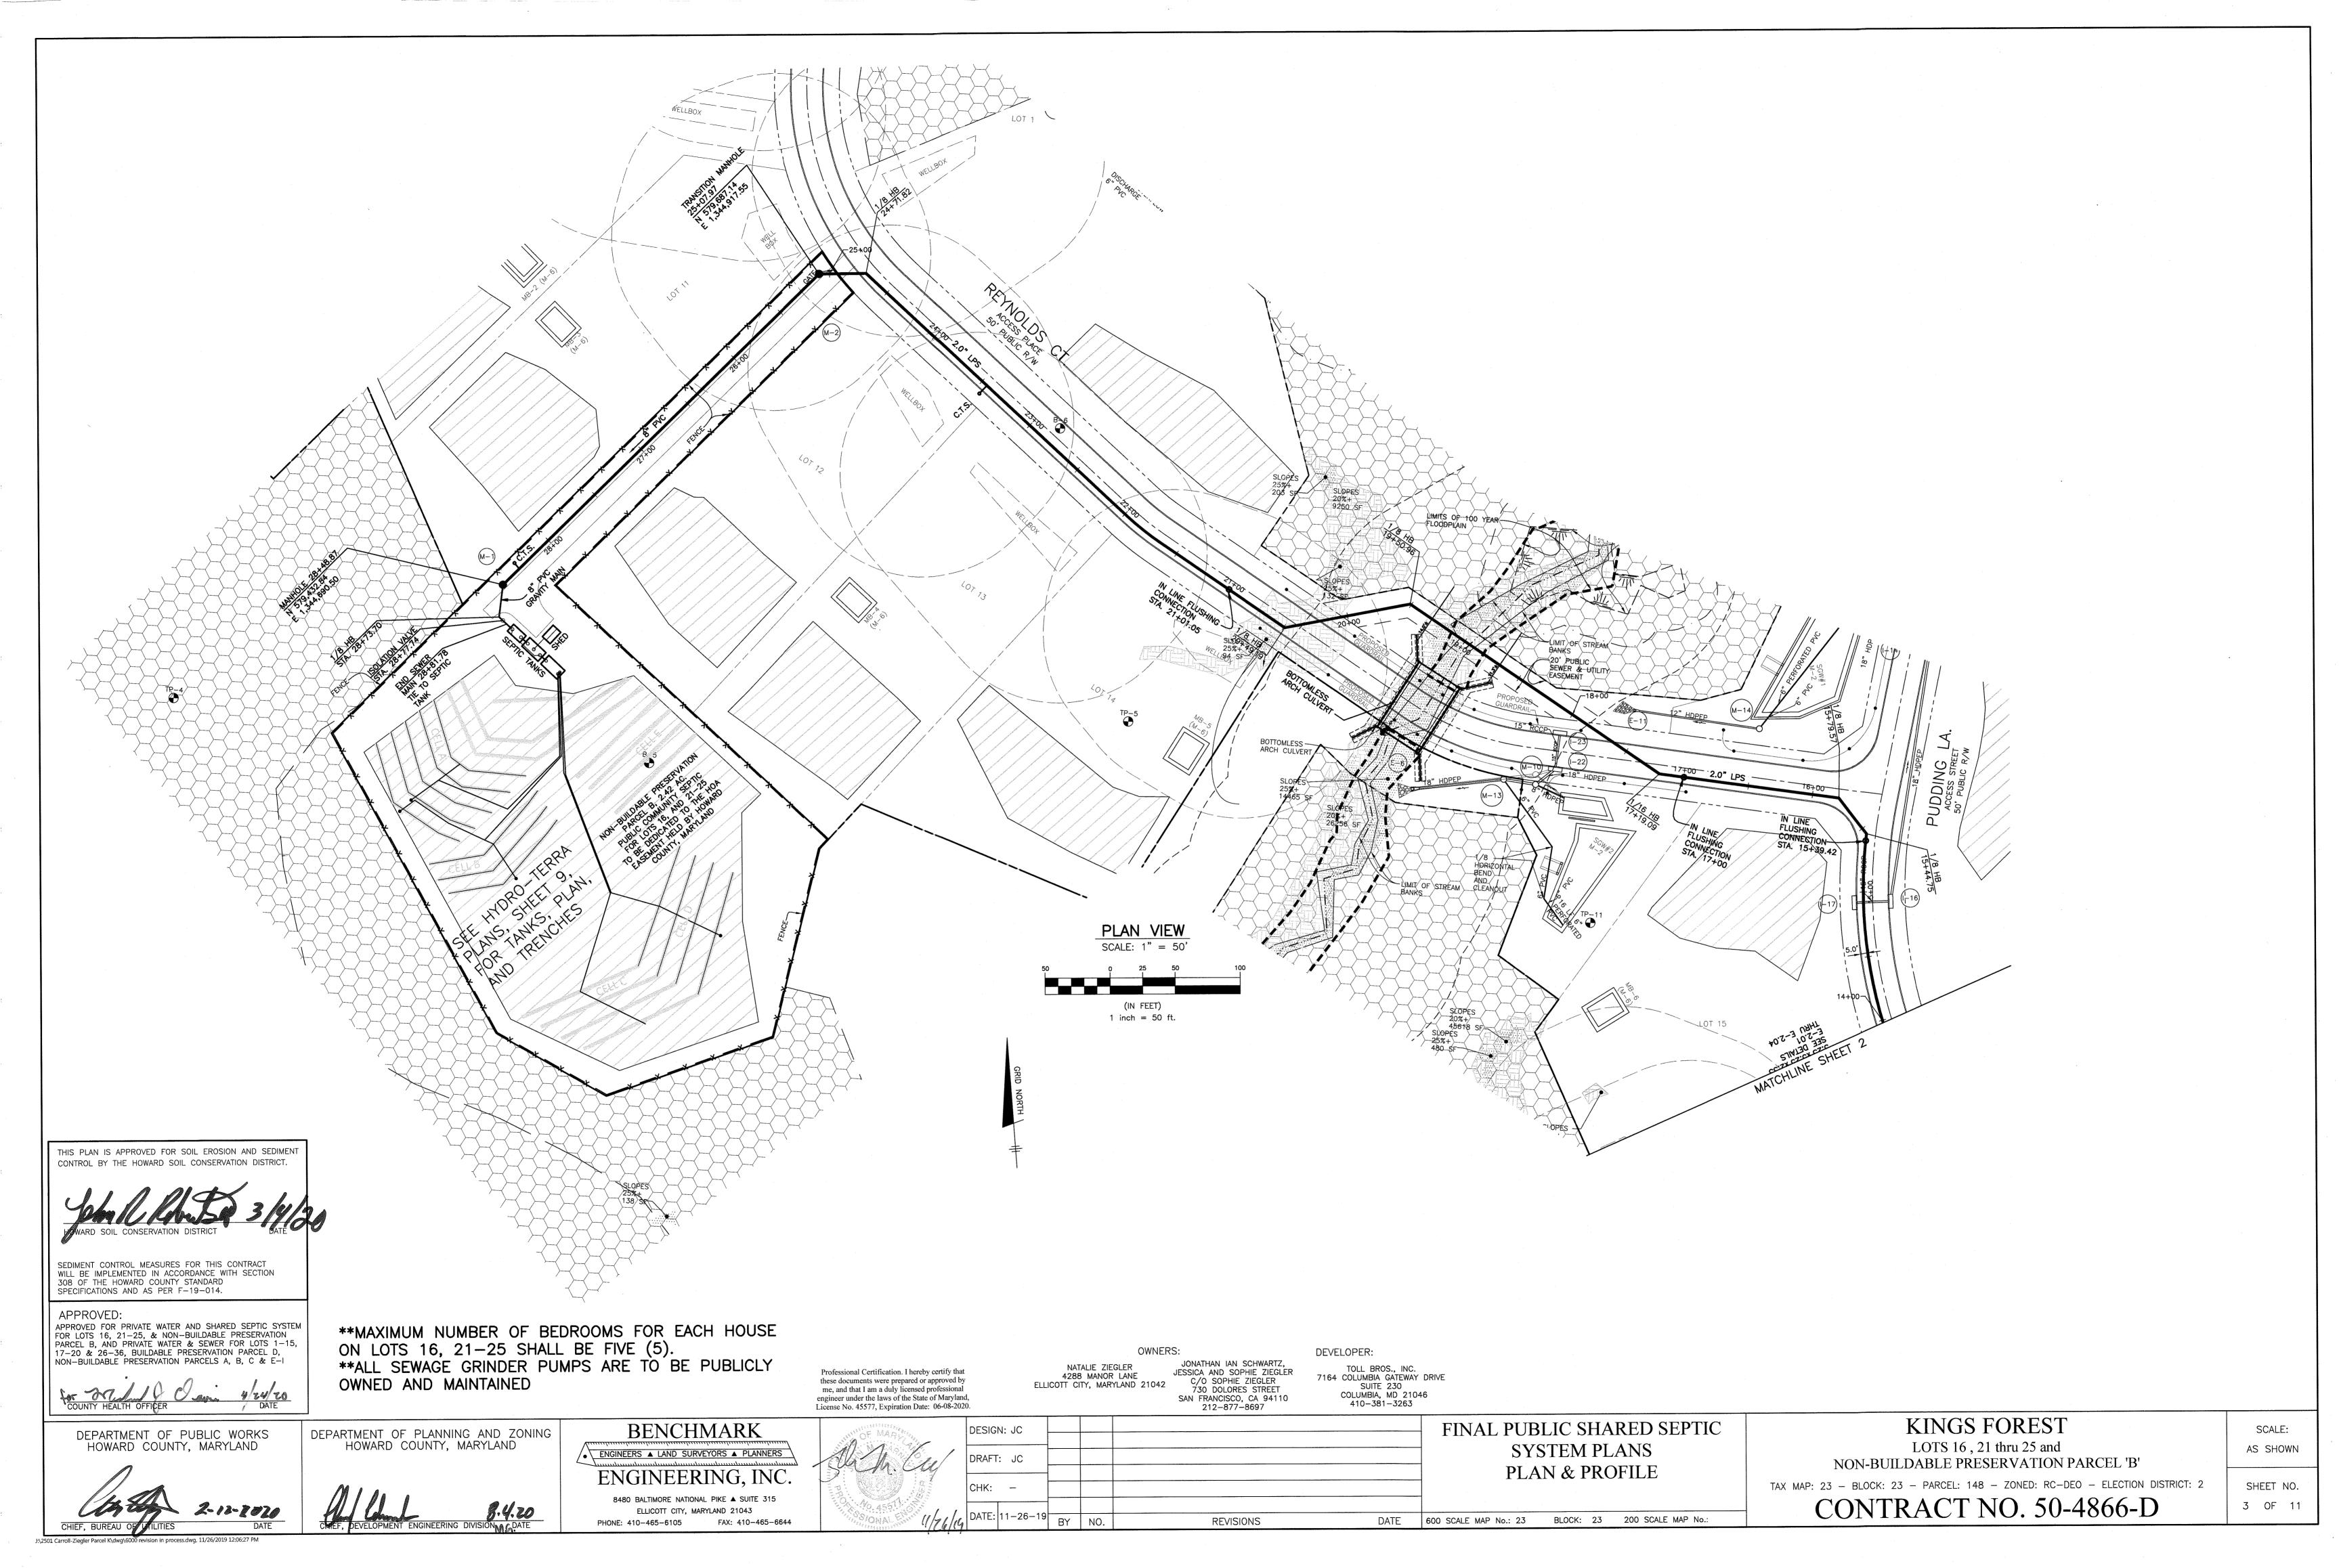

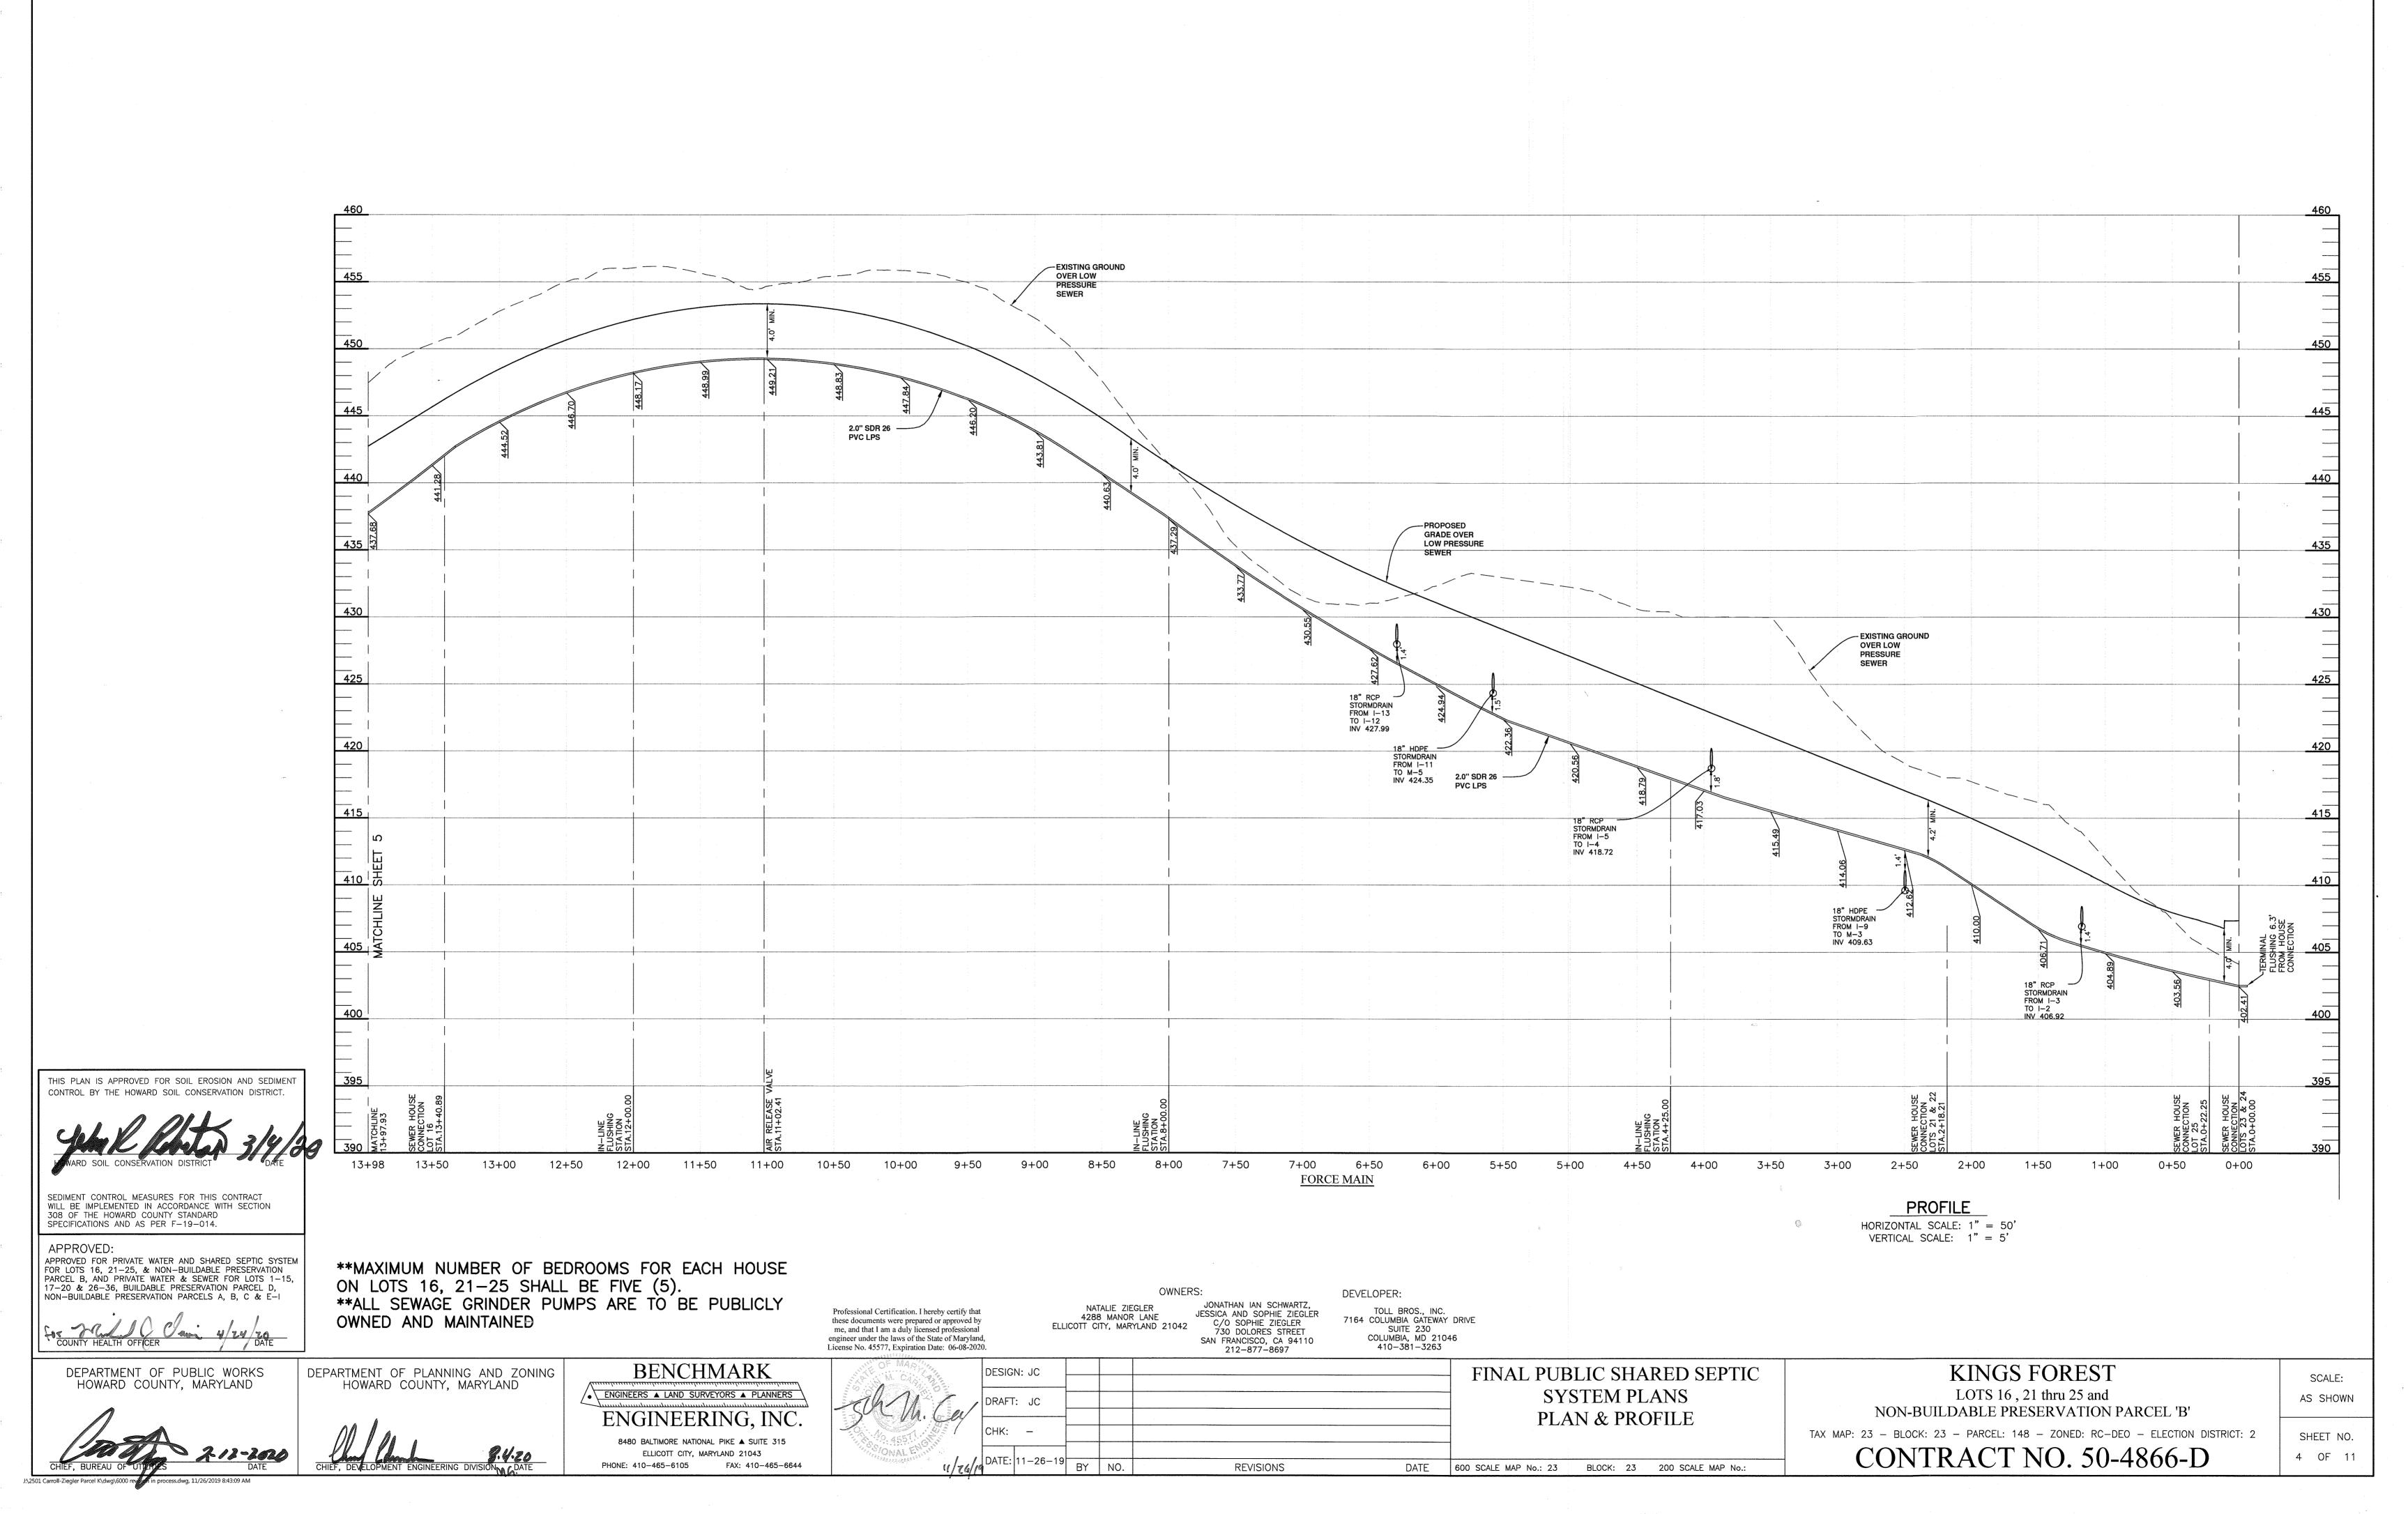

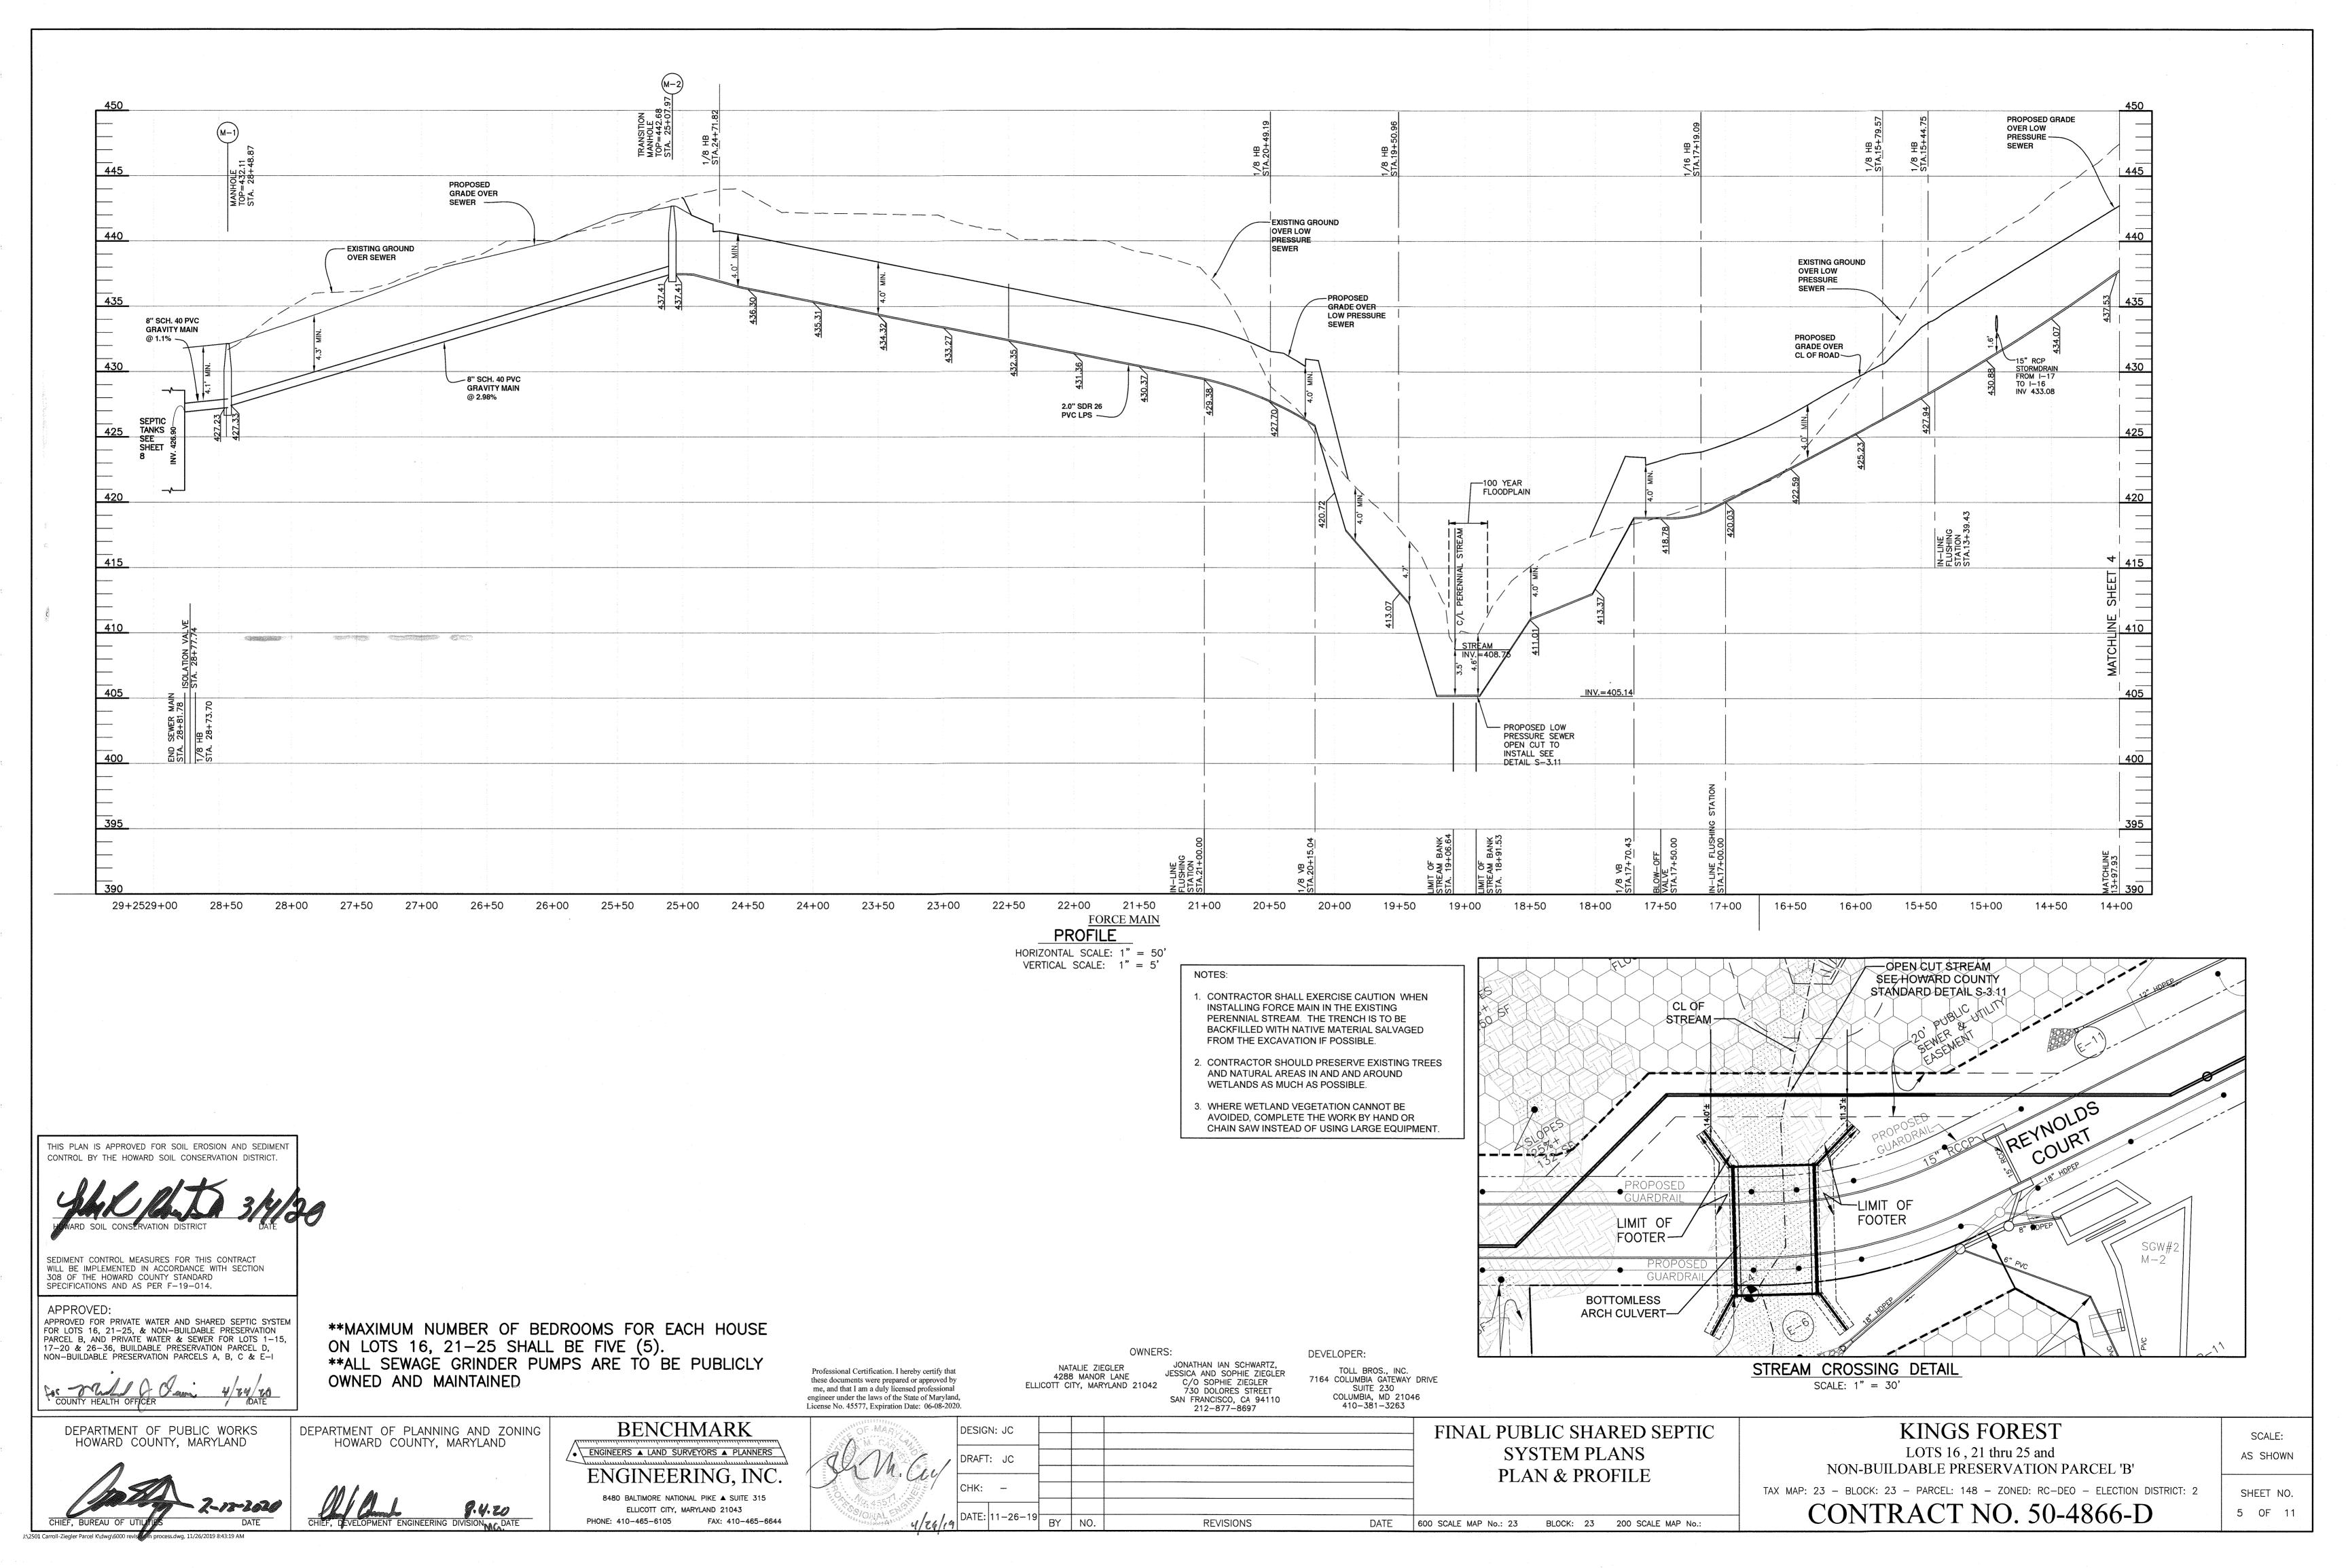

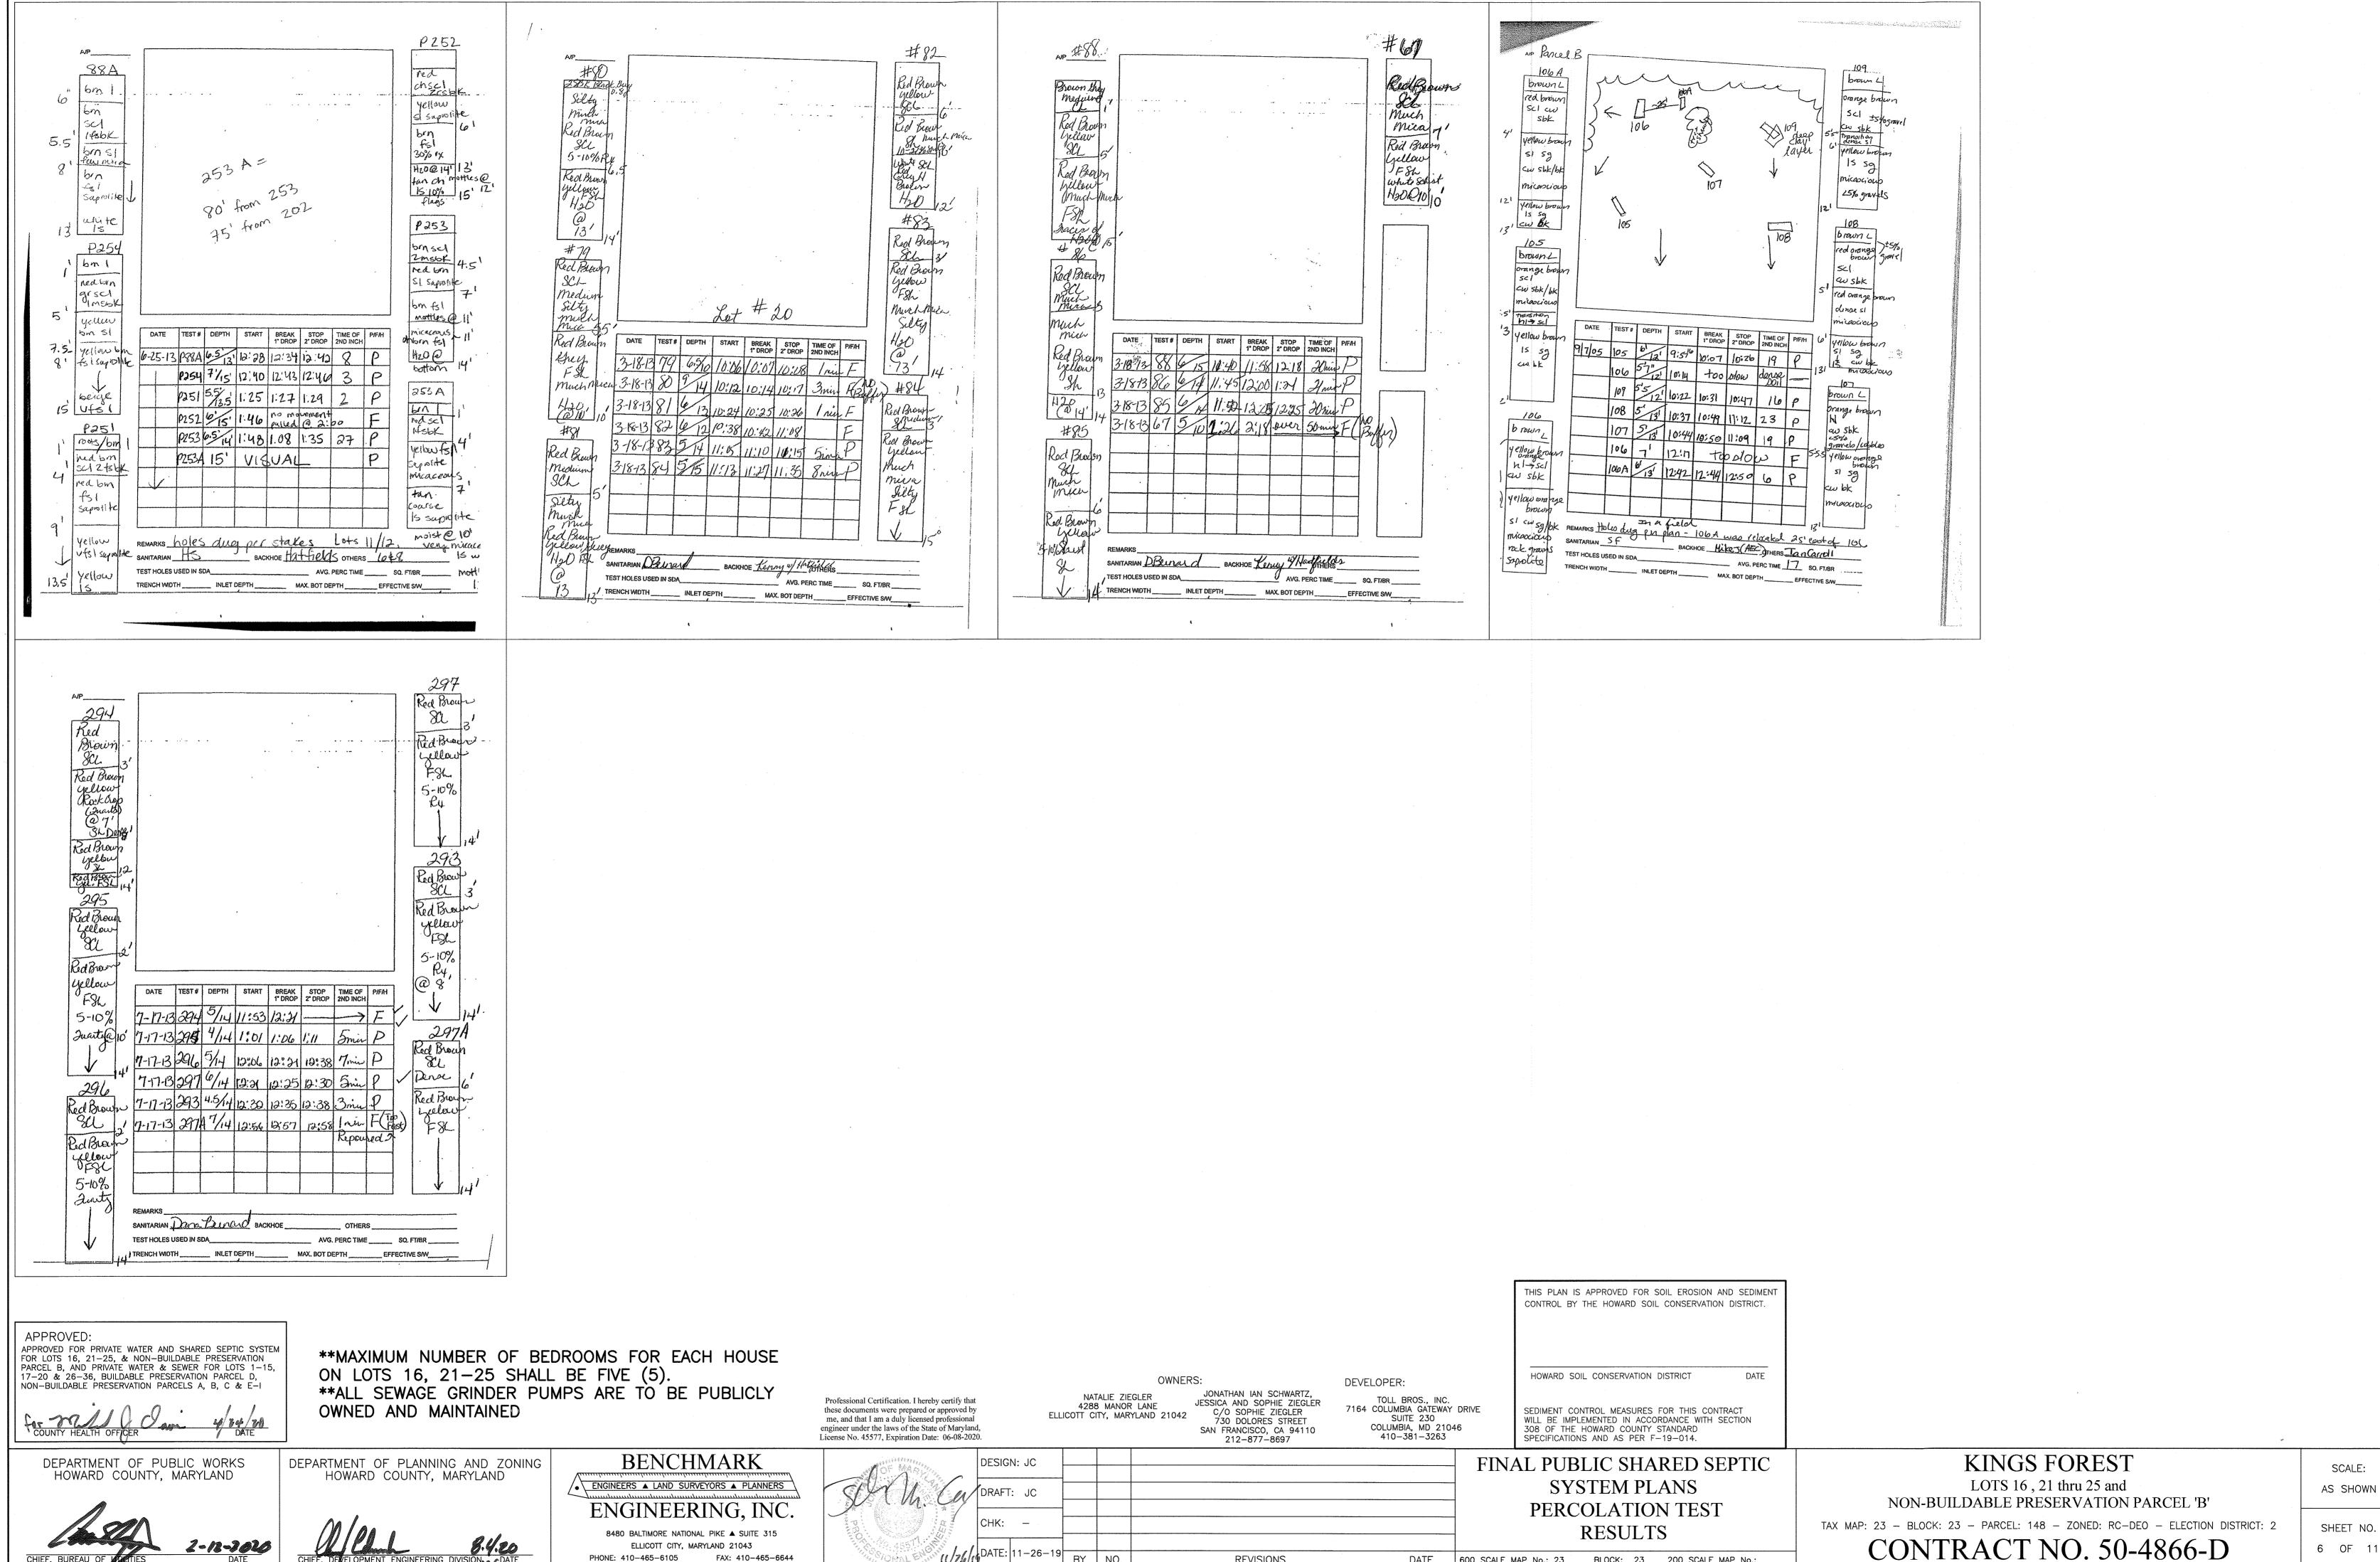

ELLICOTT CITY, MARYLAND 21043

11/26/14 DATE: 11-26-15


BY NO.


REVISIONS

DATE 600 SCALE MAP No.: 23

BLOCK: 23 200 SCALE MAP No.:


6 OF 11

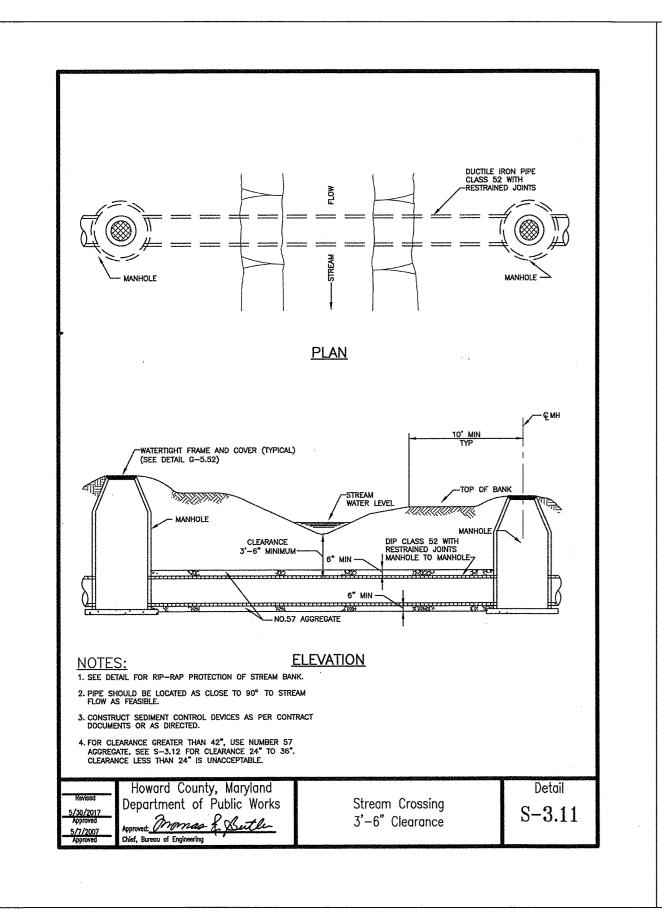

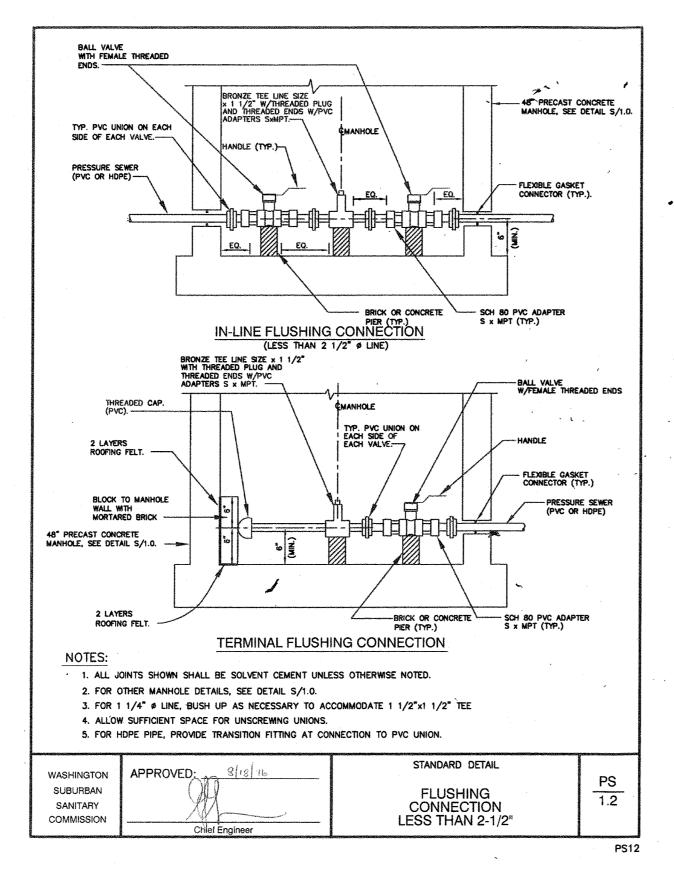


ENVIRONMENT ONE GRINDER PUMP DATA TABLE										
LOTS	TOP ELEV.	GRINDER PUMP BASIN BOTTOM ELEV.	DEPTH	INLET ELEV.	DISCHARGE ELEV.	ANTI-FLOAT VOLUME	ANTI-FLOAT DIMENSIONS	REMARKS		
16	446.8	436.8	10.00' (120")	440.9	444.3	44.27 C.F.	5.25'x5.25'x2.33'	HO. CO. STANDARD SIMPLEX		
21 & 22	418.1	408.1	10.00' (120")	412.0	415.6	45.34 C.F.	5.0'x5.0'x2.79'	HO. CO. STANDARD DUPLEX		
23 & 24	408.0	398.0	10.00' (120")	402.0	405.5	45.34 C.F.	5.0'x5.0'x2.79'	HO. CO. STANDARD DUPLEX		
25	406.5	396.5	10.00' (120")	400.0	404.0	44.27 C.F.	5.25'x5.25'x2.33'	HO. CO. STANDARD SIMPLEX		


NOTE: SEE MANUFACTURER'S MANUAL FOR GRINDER PUMP INSTALLATION REQUIREMENT, PROCEDURE, AND ELECTRICAL CONNECTION.

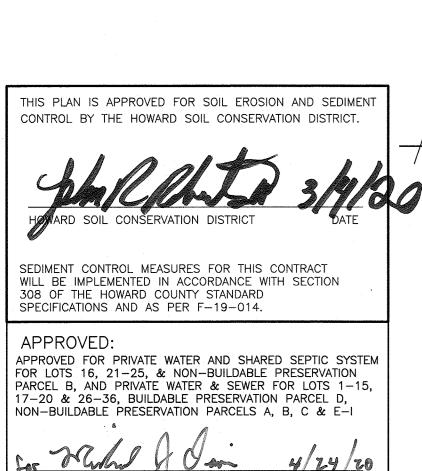


DEPARTMENT OF PUBLIC WORKS

HOWARD COUNTY, MARYLAND

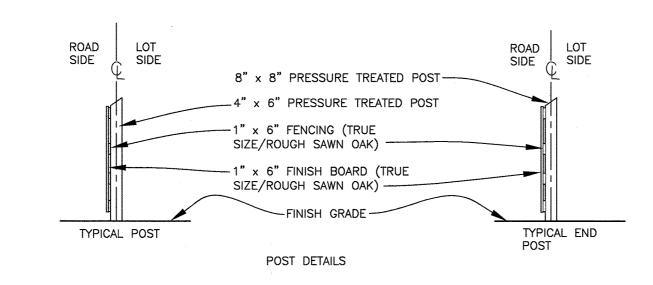

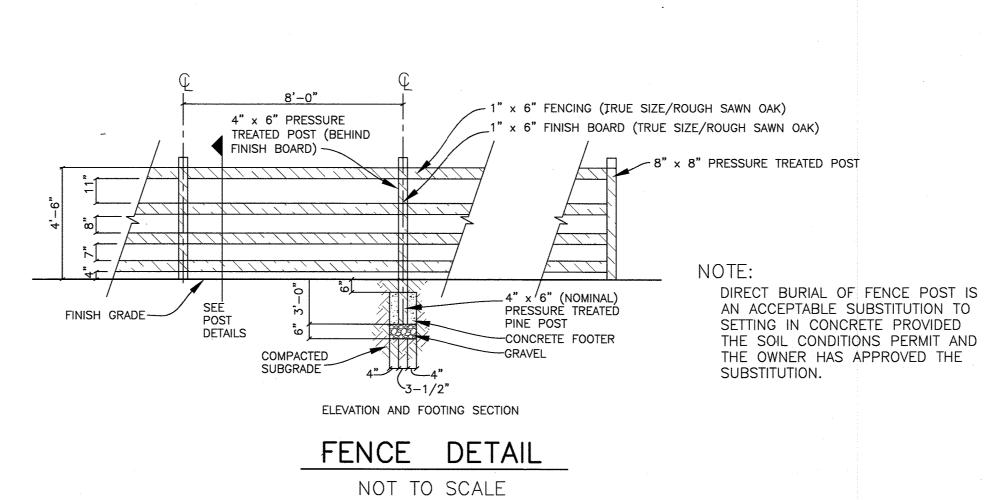

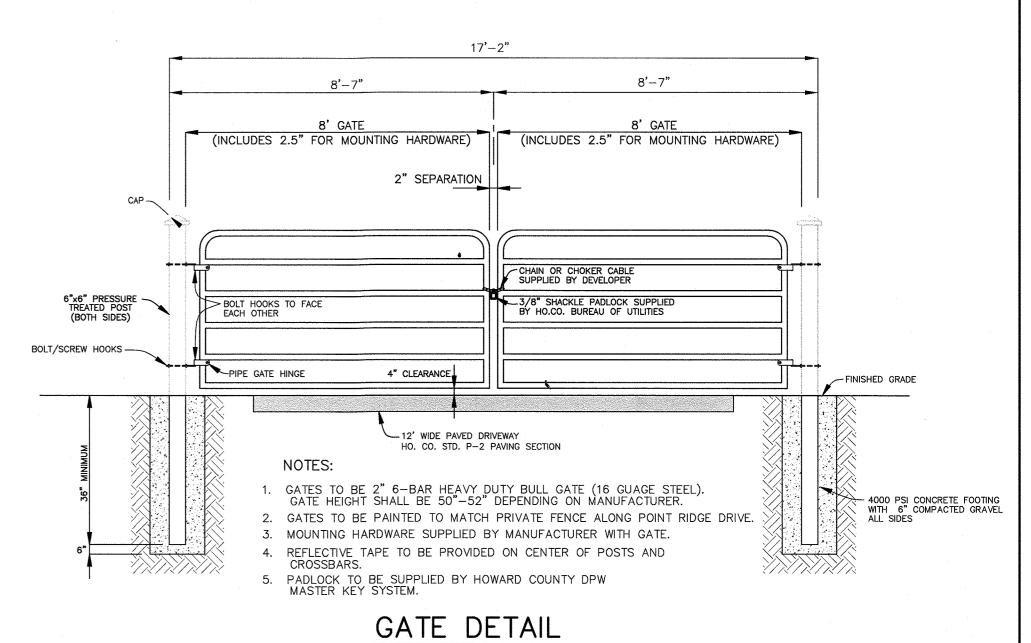

NOT TO SCALE

**MAXIMUM NUMBER OF BEDROOMS FOR EACH HOUSE ON LOTS 16, 21-25 SHALL BE FIVE (5). **ALL SEWAGE GRINDER PUMPS ARE TO BE PUBLICLY OWNED AND MAINTAINED

Professional Certification. I hereby certify that these documents were prepared or approved by me, and that I am a duly licensed professional engineer under the laws of the State of Maryland, License No. 45577, Expiration Date: 06-08-2020.

JONATHAN IAN SCHWARTZ, JESSICA AND SOPHIE ZIEGLER 4288 MANOR LANE ELLICOTT CITY, MARYLAND 21042 C/O SOPHIE ZIEGLER 730 DOLORES STREET SAN FRANCISCO, CA 94110 212-877-8697

DEVELOPER: TOLL BROS., INC.
7164 COLUMBIA GATEWAY DRIVE
SUITE 230 COLUMBIA, MD 21046 410-381-3263

DEPARTMENT OF PLANNING AND ZONING HOWARD COUNTY, MARYLAND

BENCHMARK ● ENGINEERS ▲ LAND SURVEYORS ▲ PLANNERS ENGINEERING, INC.

8480 BALTIMORE NATIONAL PIKE ▲ SUITE 315

ELLICOTT CITY, MARYLAND 21043

FAX: 410-465-6644

DESIGN: JC **REVISIONS** DATE 600 SCALE MAP No.: 23 BLOCK: 23 200 SCALE MAP No.

NATALIE ZIEGLER


FINAL PUBLIC SHARED SEPTIC SYSTEM PLANS CONSTRUCTION DETAILS, AND NOTES

KINGS FOREST LOTS 16, 21 thru 25 and NON-BUILDABLE PRESERVATION PARCEL 'B' TAX MAP: 23 - BLOCK: 23 - PARCEL: 148 - ZONED: RC-DEO - ELECTION DISTRICT: 2 CONTRACT NO. 50-4866-D

AS SHOWN SHEET NO. 7 OF 11

SCALE:

GENERAL NOTES: 1. CONSTRUCTION SHALL CONFORM TO ALL LOCAL, COUNTY, AND STATE GUIDELINES, INCLUDING HOWARD COUNTY BUILDING CODES AND RECOMMENDED STANDARDS FOR WASTEWATER SYSTEMS: DISCREPANCIES SHALL BE REFERRED TO ENGINEER. 2. CONTRACTOR SHALL NOTIFY MISS UTILITY OF MARYLAND (800-257-7777) AT LEAST 7 DAYS PRIOR TO STARTING WORK. 3. SITE MAPPING AND TOPOGRAPHY IS BASED UPON DRAWINGS RECEIVED FROM BENCHMARK ENGINEERING (PROJECT# 2501; SENT 6/26/2018) 4. ALL PIPE ELEVATIONS ARE INVERT ELEVATIONS UNLESS OTHERWISE NOTED. 5. ALL HOME WATER TREATMENT UNIT BACKWASH SYSTEMS SHALL BE DEMAND-BASED. 6. APPROXIMATE LOCATIONS OF EXISTING UTILITIES ARE SHOWN: CONTRACTOR SHALL TAKE ALL NECESSARY PRECAUTIONS FOR PROTECTION; ANY DAMAGES SHALL BE REPAIRED IMMEDIATELY. 7. ALL TREES, STUMPS, AND ROOTS SHALL BE REMOVED IN FILL AND EXCAVATION AREAS. NO HEAVY TRAFFIC SHALL BE ALLOWED ON 60,000 SQ.FT. SEPTIC RESERVE AREA EXCEPT FOR TRENCH EXCAVATION AND CONSTRUCTION EQUIPMENT. TRACKED EQUIPMENT WHICH DISPERSES VEHICLE LOAD IS PREFERRED. 8. A COPY OF THE SEPTIC PERMIT APPROVAL SHALL BE KEPT WITH THE O&M MANUAL. OPERATION AND MAINTENANCE SHALL BE CONDUCTED IN ACCORDANCE WITH THE O&M MANUALS PROVIDED BY THE ENGINEER AND THE TREATMENT SYSTEM MANUFACTURER. 9. A PRE-CONSTRUCTION MEETING SHALL BE HELD WITH CONTRACTOR, HTG. MDE (410-537-3680), HCWARD COUNTY HEALTH DEPARTMENT AND BUREAU OF UTILITIES & CONSTRUCTION INSPECTIONS REPRESENTATIVES PRIOR TO STARTING WORK TO REVIEW DESIGN DOCUMENTS AND CONSTRUCTION REQUIREMENTS. 10. AN OPEN TRENCH INSPECTION SHALL BE CONDUCTED PRIOR TO FILI NG WITH GRAVEL. 11. THE DEVELOPER SHALL REFER TO COUNTY AND STATE GUIDELINES FOR TREATMENT PLANT AND MONITORING WELL SAMPLING AND REPORTING REQUIREMENTS. 12. SAMPLING OF WASTEWATER (INFLUENT TO AND EFFLUENT FRO 1 THE TREATMENT SYSTEM) SHALL BE CONDUCTED QUARTERLY FOR THE FIRST YEAR AFTER THE SYSTEM HAS REACHED 80% BUILD-OUT WITH RESULTS SEPORTING TO MDE, HOWARD COUNTY HEALTH DEPARTMENT, AND HOWARD COUNTY DEPARTMENT OF PUBLIC WORKS. THE SAMPLING PARAMETERS SHALL BE NITRATE, 5-DAY BIOCHEMICAL OXYGEN DEMAND (BOD5), TOTAL SUSPENDED SOLIDS (TSS), ALKALINITY, AND FATS, OILS AND GREASE (FOG). Manhole 13. LOT SALE AGREEMENT(S) SHALL SPECIFICALLY DISALLOW USE OF QUATERNARY AMMONIUM DISINFECTION AND CLEANING PRODUCTS ON THE PREMISES. IN ADDITION TO ANY RESTRICTIONS DETAILED IN THE TREATMENT SYSTEM MANUFACTURER'S Isolation Valve Wastewate ACCESS PLACE OPERATION AND MAINTENANCE MANUAL. SALE AGREEMENTS SHALL ALSO DISALLOW THE UTILIZATION OF GARBAGE ゑor PUBLIC R./W DISPOSALS/GRINDERS ON ALL SINKS DRAINING TO THE SHARED SEPTIC SYSTEM. 10 System 14. BASELINE GROUNDWATER QUALITY SHALL BE COMPLETED BY SAMPLING THE ON-SITE MONITORING WELLS PRIOR TO USE OF THE ON-SITE WASTEWATER SYSTEM, WITH LABORATORY ANALYSES FOR TOTAL AND FECAL COLIFORM, E. COLI, CHLORIDE, TOTAL DISSOLVED SOLIDS, NITRATE, PHOSPHORUS, AND FIELD pH. 15. THE DEVELOPER SHALL CONDUCT QUARTERLY MONITORING OF THE TREATED EFFLUENT DURING THE 12-MONTH PERIOD FOLLOWING 80% OCCUPANCY OF THE LOTS CONNECTED TO THE SHARED SYSTEM WITH RESULTS SUBMITTED TO HIGHD, MOE, AND DAW. THE SAMPLING AND ANALYSES SHALL BE IN ACCORDANCE WITH MDE GUIDANCE FOR PRE-TREATMENT SYSTEMS WITH GREATER THAN 1500 GPD CAPACITY. THIS INCLUDES GRAB SAMPLING EFFLUENT IN THE PUMP TANK WITH LABORATORY ANALYSES OF BOD, TSS, TOTAL NITROGEN (TKN, NITRATE, NITRATE). ALKALINITY, AND FOG. DO, PH, AND TEMPERATURE SHOULD BE FIELD TESTED AS CLOSE TO THE TREATMENT PLANT EFFLUENT PIPE AS POSSIBLE. IF THE EFFLUENT CONSISTENTLY EXCEEDS THE APPROVED DESIGN CRITERIA OR APPLICABLE RECULATORY LIMITS. THE DEVELOPER WILL NOTIFY HCHD, MDE, AND HCBU AND WILL MAKE THE NECESSARY ADJUSTMENTS OR REPAIRS TO THE SYSTEM WITH agency oversight followed by successful quarterly sampling for the subsequent 12-month PERIOD PRIOR TO DEDICATION OF THE SYSTEM TO HOWARD COUNTY DEPARTMENT OF PUBLIC WORKS. P&ID Key Notes part symbol material settling tank (2) 30"dia PE manholes concrete 4240 gal Biomicrobics MicroFAST 4.5 concrete treatment tank 6700 gal (3) 30"dia PE manholes dose tank concrete B1-B2 Spencer turbine, per TSM Grinder Pump 3-AA-PVC -P1-P5 dose pump Goulds pump WS10BHF coated steel Station (Typ.) 1.5-E-ECPVC varying lengths and depths Residence **SYMBOLS** 3-TW-PVC (TYP.) Lot 25 P&ID KEY NOTES Cell A 1.5-E-ECPVC Residence _____ — 2-TW-PVC - CONTROL BUILDING Lot 24 (Recirculation) NUMBER INDICATES A DETAIL, A LETTER INDICATES A SECTION. —Dosing Pumps Vent (typ.)_ Residence 8-WW-PVC T5 2-TW-PVC (TYP.) 4-WW-PVC -Lot 23 - .75-AA-PVC SHEET NUMBER ON WHICH THE DETAIL OR --- 4-WW-PVC Cell B SECTION IS DRAWN, OR THE SHEET Residence NUMBER FROM WHERE THE DETAIL OR Lot 22 SECTION IS REFERENCED. Use Projections SANITARY > 2" L.P.S. properties served Residence MicroFAST® INDICATES DETAIL 3,000 Gallon Lot 21 Isolationlow per bedroom (gpd) 150 4.5 BAT unit Transition-MDF (gpd) 4,500 Settling Tank Manhole Cell D ADF (gpd) 2,250 Cell C Residence Lot 16 INDICATES SECTION OR esign Wastewater Strength 6,700 Gallon PIPE IDENTIFIER: Influent Effluent WASTEWATER TREATMENT SYSTEM SCHEMATIC Dose Tank BOD (mg/L) 220 TSS (mg/L) 220 $\frac{4}{2}$ line symbol description Total Nitrogen (mg/L as N) 60 wastewater NO SCALE **MAXIMUM NUMBER OF BEDROOMS FOR EACH treated water **LEGEND SCHEMATIC NOTE:** -PIPE MATERIAL HOUSE ON LOTS 16, 21-25 SHALL BE FIVE (5). vent (to atmosphere) -PIPE FUNCTION ISOLATION VALVE ALL DISTRIBUTION/MANIFOLD PIPING **ALL SEWAGE GRINDER PUMPS ARE TO BE calculated values in italics polyethylene CellE IS IDENTIFIED AS 3-TW-PVC. ADF = average daily flow PUBLICLY OWNED AND MAINTAINED -NOMINAL PIPE SIZE (IN INCHES) electric power wire CONTROL VALVE LATERAL PIPING WITHIN TRENCHES IS MDF = maximum daily flow sch 40 polyvinyl chloride 2-TW-PVC, SEE DETAIL SHEET FOR FLOW ARROW nit rates from Howard County Well and Septic memo Nov 2014 drain waste vent polyvinyl chloride **APPROVED:** MORE INFORMATION. eatment system performance is contingent upon influent polyvinyl chloride electrical condui TO OR FROM OUTSIDE APPROVED FOR PRIVATE WATER AND SHARED SEPTIC SYSTEM FOR LOTS 16, 21-25, & NON-BUILDABLE astewater strength detailed here, in addition to adequate PROJECT LIMITS alkalinity; typical water temperature, pH and toxicity; and that PRESERVATION PARCEL B, AND PRIVATE WATER & SEWER FOR LOTS 1-15 & 26-36, BUILDABLE PRESERVATION PARCEL D, NON BUILDABLE PRESERVATION PARCELS A, C o more than 10% of the MDF is dosed to the treatment system **DEVELOPER:** er hour for 10 hours within a 24-hour period. PROFESSIONAL ENGINEER JONATHAN IAN SCHWARTZ. NATALIE ZIEGLER TOLL BROS., INC. JESSICA AND SOPHIE ZIEGLEF 4288 MANOR LANE 7164 COLUMBIA GATEWAY DRIVE C/O SOPHIE ZIEGLER Copyright 2019 Hydro-Terra Group, Inc. The contents of this plan are MARK J. MAZZOCHETTE, HEREBY CERTIFY THAT THES ELLICOTT CITY, MARYLAND 21042 USE PROJECTIONS SUITE 230 730 DOLORES STREET proprietary and shall not be copied, reproduced, transmitted or utilized OCUMENTS WERE PREPARED OR APPROVED BY ME. AN COLUMBIA, MD 21046 410-381-3263 AM A DULY LICENSED PROFESSIONAL ENGINEER U THE LAWS OF THE STATE OF MARYLAND, SAN FRANCISCO, CA 94110 in any way without written authorization from Hydro-Terra Group. Only 212-877-8697 approved, signed and sealed plans shall be used for construction KINGS FOREST FINAL PUBLIC SHARED SEPTIC DESIGN: MJM DEPARTMENT OF PUBLIC WORKS DEPARTMENT OF PLANNING AND ZONING Hydro-Terra Group SCALE: HOWARD COUNTY, MARYLAND HOWARD COUNTY, MARYLAND LOTS 16, 21 thru 25 and SYSTEM PLANS AS SHOWN 1106 Business Parkway South DRAFT: MDS GROUP NON-BUILDABLE PRESERVATION PARCEL 'B' estminster, Maryland 21157 SITE PLAN & PFD TAX MAP: 23 - BLOCK: 23 - PARCEL: 148 - ZONED: RC-DEO - ELECTION DISTRICT: 2 CHK: MDH SHEET NO. CONTRACT NO. 50-4866-D (410) 861-5467 (fax) 8 OF 11 NOVEMBER 2019 BY NO. **REVISIONS** DATE 600 SCALE MAP No.: 23 BLOCK: 23 200 SCALE MAP No. This drawing printed on: November 22, 2019

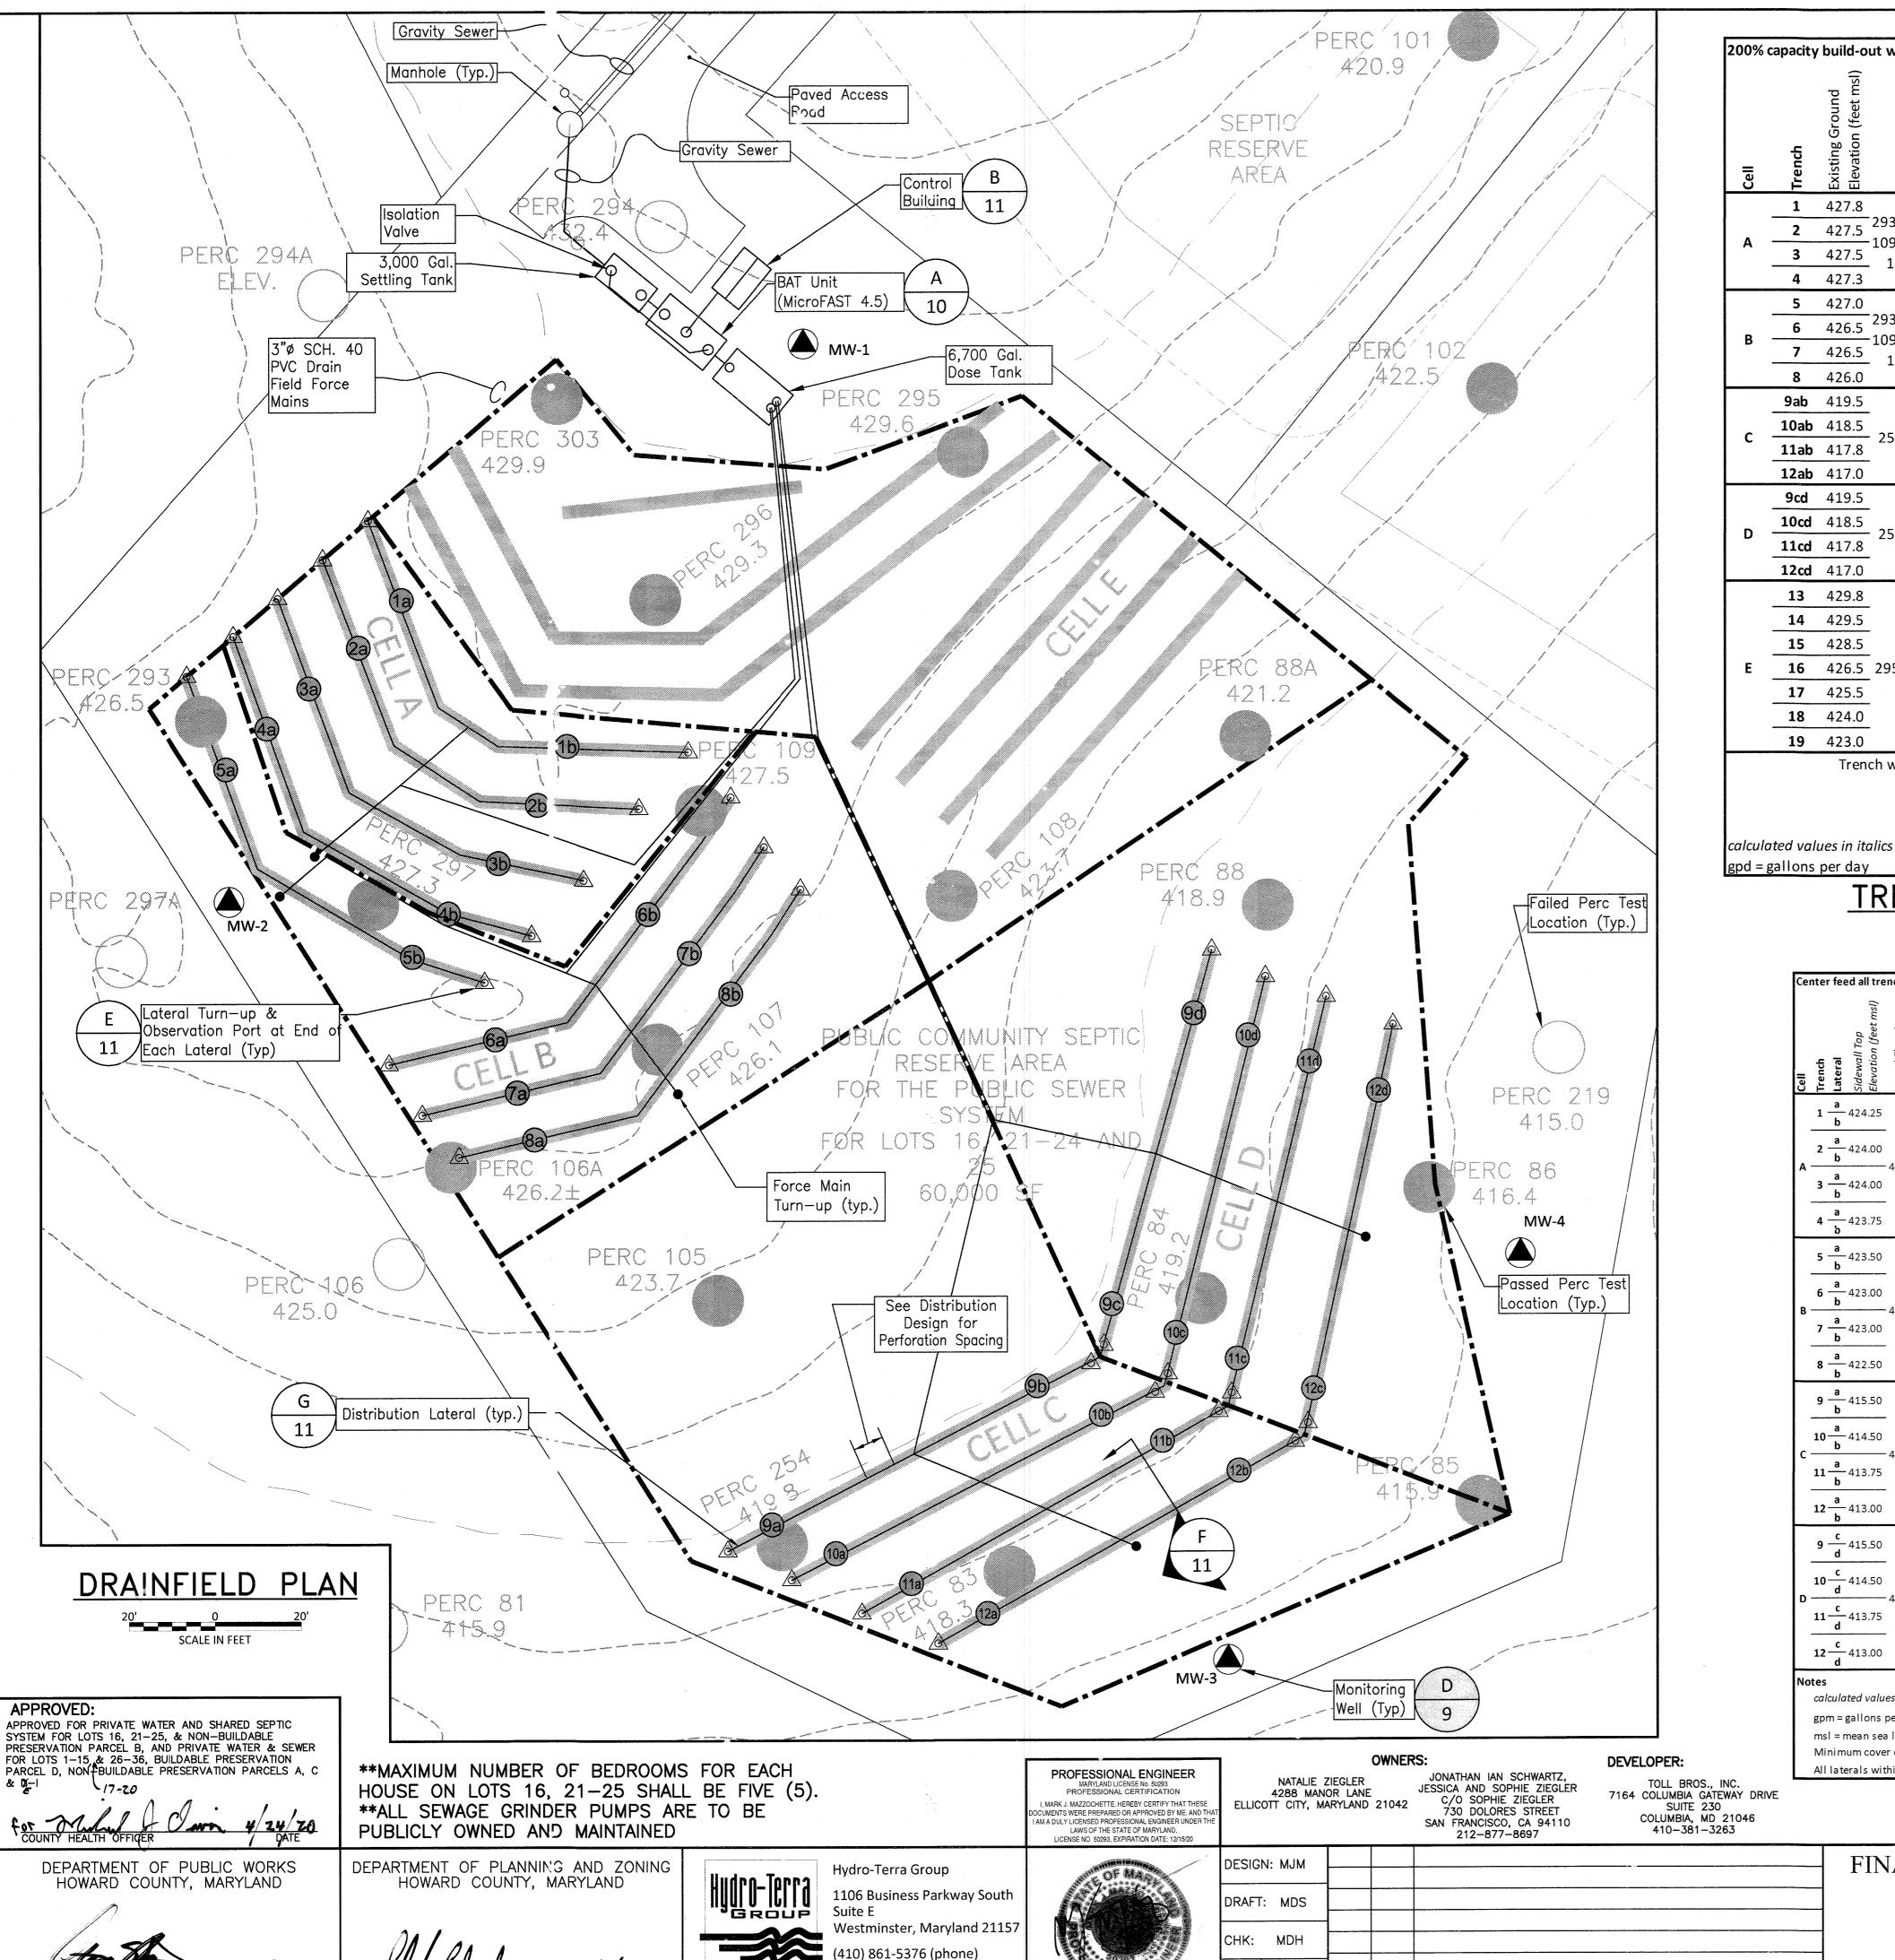

(410) 861-5467 (fax)


www.hydro-terra.com

DATE NOVEMBER

2019

BY NO.

REVISIONS

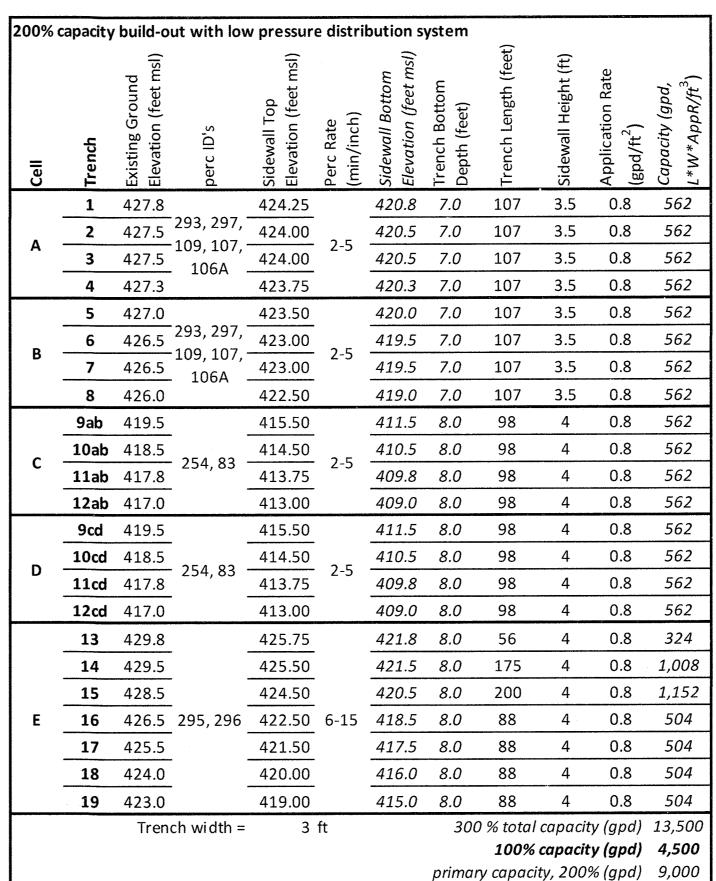

TRENCH FIELD DESIGN

msl = mean sea level in feet

laterals in each trench are at same elevation

reserve capacity, 100% (gpd) 4,500

nter feed all trenches with 50/50/50/50 design (200% service) 5/16 2.00 16.0 0.32 0.13 8 *6.66 49.9* 8 6.66 49.9 5/16 2.00 16.0 0.32 0.13 1.5 2 <u>a</u> 424.00 8 *6.66 49.9* 5/16 2.00 16.0 0.32 0.13 1.5 8 6.66 49.9 5/16 2.00 16.0 0.32 0.13 1.5 3 <u>a</u> 424.00 5/16 2.00 16.0 0.32 0.13 8 6.66 49.9 8 6.66 49.9 5/16 2.00 16.0 0.32 0.13 1.5 5/16 2.00 16.0 0.32 0.13 1.5 8 *6.66 49.9* 4 - 423.75 8 6.66 49.9 5/16 2.00 16.0 0.32 0.13 1.5 5/16 2.00 16.0 0.32 0.13 1.5 8 *6.66 49.9* 8 6.66 49.9 5/16 2.00 16.0 0.32 0.13 1.5 5/16 2.00 16.0 0.32 0.13 1.5 8 6.66 49.9 **6 a** 423.00 5/16 2.00 16.0 0.32 0.13 1.5 8 6.66 49.9 5/16 2.00 16.0 0.32 0.13 1.5 8 *6.66 49.9* 7 a 423.00 8 6.66 49.9 5/16 2.00 16.0 0.32 0.13 1.5 5/16 2.00 16.0 0.32 0.13 1.5 8 6.66 49.9 8 — 422.50 8 6.66 49.9 5/16 2.00 16.0 0.32 0.13 1.5 9 a 415.50 5/16 2.00 16.0 0.35 0.12 1.5 8 6.10 45.8 8 6.10 45.8 5/16 2.00 16.0 0.35 0.12 1.5 5/16 2.00 16.0 0.35 0.12 1.5 8 6.10 45.8 **10** - 414.50 8 6.10 45.8 5/16 2.00 16.0 0.35 0.12 1.5 5/16 2.00 16.0 0.35 0.12 1.5 8 6.10 45.8 11 a 413.75 8 6.10 45.8 5/16 2.00 16.0 0.35 0.12 1.5 5/16 2.00 16.0 0.35 0.12 1.5 8 6.10 45.8 12 a 413.00 8 6.10 45.8 5/16 2.00 16.0 0.35 0.12 1.5 5/16 2.00 16.0 0.35 0.12 1.5 8 6.10 45.8 8 6.10 45.8 4.00 4.00 $9 - \frac{c}{d} 415.50$ 5/16 2.00 16.0 0.35 0.12 1.5 5/16 2.00 16.0 0.35 0.12 1.5 8 6.10 45.8 **10** c 414.50 8 6.10 45.8 5/16 2.00 16.0 0.35 0.12 1.5 5/16 2.00 16.0 0.35 0.12 8 6.10 45.8 11 - 413.758 6.10 45.8 5/16 2.00 16.0 0.35 0.12 1.5 5/16 2.00 16.0 0.35 0.12 1.5 8 6.10 45.8 **12** c 413.00 8 6.10 45.8 5/16 2.00 16.0 0.35 0.12 1.5 calculated values in italics design distal head (feet)= 3.0 friction C factor for plastic pipe= 130 gpm = gallons per minute lateral inside diameter (2"dia sch40PVC, in)= 2.067 msl = mean sea level in feet

8"ø PROTECTOR PIPE — GRADE -----4"ø SCH 40 PVC WELL PIPE 8"ø HOLE -CEMENT / GROUT.-BENTONITE SEAL #2 WELL GRAVEL -20' 0.020" SLOTTED PVC WELL SCREEN **MONITORING WELL NOTE:** MONITORING WELLS SHALL BE DRILLED TO A MINIMUM DEPTH OF 15 FEET BELOW THE FIRST ENCOUNTER WITH GROUNDWATER MONITORING WELL

NOT TO SCALE

LOCKING CAP -

*All results recorded here are for passed perc testing locations within the septic reserve area 418.3 413.3 409.3 1.2 419.2 414.2 408.2 0.8 415.9 409.9 405.9 0.6 416.4 410.4 406.4 0.6 421.2 414.7 412.2 0.8 426.2 420.2 417.2 0.8 423.7 418.7 414.7 0.6 427.5 *422.0 419.5 0.6* 419.8 412.8 408.8 1.2 426.5 422.0 416.5 1.2 429.6 425.6 419.6 1.2 429.3 424.3 419.3 0.8 14.0 3 5 427.3 *421.3* 417.3 1.2 303 4.5 14.0 0.5 23 429.9 425.4 419.9 0.6

PERC TEST RESULTS

DISTRIBUTION DESIGN

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FINAL PUBLIC SHARED SEPTIC SYSTEM PLANS

Minimum cover over laterals shall be 18" to existing grade

600 SCALE MAP No.: 23

DRAINFIELD PLAN

BLOCK: 23 200 SCALE MAP No.:

KINGS FOREST

LOTS 16, 21 thru 25 and NON-BUILDABLE PRESERVATION PARCEL 'B' TAX MAP: 23 - BLOCK: 23 - PARCEL: 148 - ZONED: RC-DEO - ELECTION DISTRICT: 2

SHEET NO. 9 OF 11

SCALE:

AS SHOWN

CONTRACT NO. 50-4866-D This drawing printed on: November 22, 2019

