QUANTITIES AS-BUILT ITEMS QUANTITIES MANUFACTURER/SUPPLIER SMITH BLAIR 663 1 EA. 8"x 6" TS&VI SMITH BLAIR 2 EA. 143 LF 143 C900 NATIONAL PIPE FIRE HYDRANI 3 EA. A 423 MUELLER COMPANY 18" X 30" HORNE CONCRETE I EA. 663 SMITH BLAIR 8"C900 72L.F. 72' C900 NATIONAL PIPE NAME OF UTILITY CONTRACTOR: COMER SURVEY AND DRAFTING DIVISION AS-BUILT DATE: Water House Connection As-built Location Table Lot Number Address Location Dimension 1 Location Dimension 2 5700 Rowanberry Parcel A WATER MAIN GENERAL NOTES

- 1. All water mains shall be C900 PVC DR-14 unless otherwise noted.
- 2. Tops of all water mains shall have a minimum of 3'-6" of cover unless otherwise noted.
- 3. Valves adjacent to tees shall be strapped to tees.
- 4. All fittings shall be buttressed or anchored with concrete in accordance with Standard Details unless otherwise provided for on the drawings.
- 5. Fire hydrants shall be set to the bury line elevations shown on the drawings. All fire hydrants shall be installed in accordance with Standard Details. The soil around the fire hydrant shall be compacted in accordance with Section 1000 and Section 1005 of the Standard Specifications.
- 6. The contractor shall not operate any water main valves on the existing water system.
- Tracer wire and continuity test stations shall be installed on all DIP and PVC water mains in accordance with the Howard County Design Manual.
- 8. For PVC water mains, all records for the Quality Control and Qualification Test Requirements noted in Section 5.1 of the AWWA Standard C900 for PVC pressure pipe shall be submitted with the pipe material certifications or shop drawings prior to approval of the material for use. The test records shall be for the pipe to be installed under this contract. All PVC pipe shall contain markings to allow cross referencing of the pipe supplied to the test records received.
- 9. Unless otherwise noted on the plans or in the specifications, seventeen (17) pound sacrificial anodes shall be installed on all valves and metallic fittings used with PVC water mains m accordance with Volume IV Standard Specifications and Details for Construction. Magnesium anodes shall be installed on all valves and ductile iron fittings including restraints and harnesses. Zinc anodes shall be installed on all stainless steel fittings and saddles used with PVC mains. All "tees" used with PVC mains shall be ductile iron.
- 10. Proper Assembly of Gasketed PVC Pipe Joints: The manufacturer's insertion line of gasketed PVC pipe joints indicates the maximum depth of insertion of the spigot into the bell. After assembly of the joint, the insertion line shall remain visible. Dual insertion lines on aasketed PVC pipe indicate the maximum and minimum depth of insertion of the spigot into the bell. The contractor shall not over insert or over home the spigot into the bell of the PVC pipe.
- 11. All changes in horizontal or vertical direction of PVC water pipe shall be made with standard bends, 5-degree sweeps or high deflection (HD) couplings. No bending of the pipe or deflecting of PVC pipe joints is permitted: Where high defection couplings or 5-degree sweeps are permitted, the contractor shall provide one full pipe length (20—foot long) on either side of the high deflection coupling or 5-degree sweep. The contractor shall use a vibratory plate compactor or other approved means to thoroughly compact the #57 stone on both sides of the high defection coupling or 5—degree sweep, taking care not to use compaction equipment
- PVC high deflection couplings shall be limited to a total defection of 3-degrees (1 1/2degree on either end of the coupling), shall berated for a minimum 200 psi meeting the requirements of AWWA C900, shall have a minimum lay length of 9-inches and shall have center stops. PVC High deflection couplings shall be CertainTeed PVC
- High Deflection (HD) Stop Couplings or equal. Five degree sweeps shall be bell by spigot, rated for a minimum 225 psi; DR 18 meeting the requirements of AW WA C900 and shall be Multi Fittings (Ipex) Blue Brute DR18 or equal.
- 12. When PVC high deflection couplings or PVC 5-degree sweeps are used to facilitate changes in horizontal or vertical alignments of AW WA C-900 PVC pipelines, the contractor shall install devices for the prevention of over-insertion of the PVC pipe spigots or plain ends into the push on bell joint on both sides of the high deflection couplings and 5-degree sweeps. Bell stops shall be placed at the proper insertion line for the fitting. The bell stop shall be manufactured of ductile iron and incorporates an expansion retention spring to allow for pipe expansion and contraction. The bell stops shall be Series 5000 Mega-Stop, as

SEDIMENT CONTROL MEASURES WILL BE IMPLEMENTED IN ACCORDANCE WITH SECTION 308 OF THE STANDARD SPECIFICATIONS AND WITH SITE DEVELOPMENT PLANS SDP 14-075.

manufactured by EBAA Iron, Inc. or approved equal.

THIS DEVELOPMENT IS APPROVED FOR SOIL EROSION AND SEDIMENT CONTROL BY THE HOWARD SOIL CONSERVATION DISTRICT.


Note: No improvements shall be constructed or placed within the Public Water, Sewer and Utility Easements, which will impede or hinder access to the public water and sewer mains. Improvements such as air-conditioning units, fireplace chimneys, decks, fencing, foundation plantings and trees shall not be placed

Marriottsville, Maryland 21104

Phone: 443.325.5076

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# Elkridge Fire Station Parcel A Capital Project F-5964 Contract No. 14-4827 D

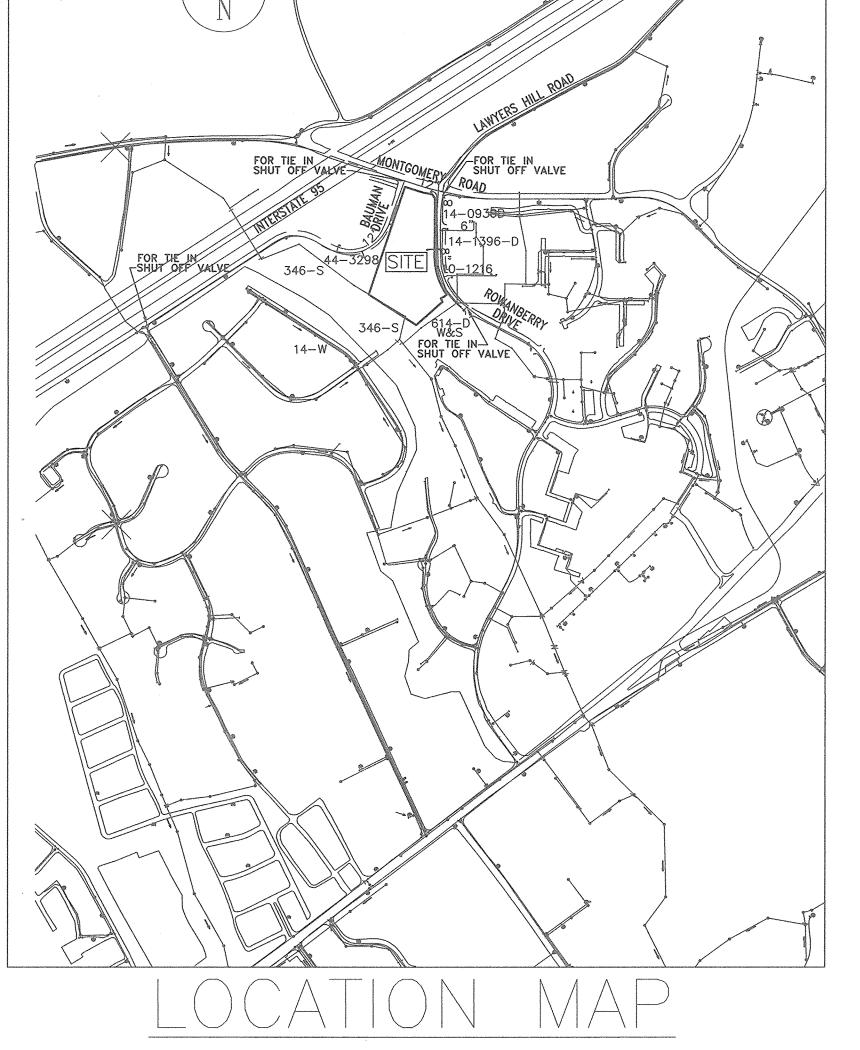


# SCALE :1"=600'

TYPE OF BUILDING: FIRE SUBSTATION NO. OF LOTS / PARCELS: NO. OF WATER HOUSE CONNECTIONS: NO. OF SEWER HOUSE CONNECTIONS: 1 EXISTING DRAINAGE AREA: <u>PATAPSCO</u> TREATMENT PLANT PATAPSCO WATER RECLAMATION PLANT ELKRIDGE, HOWARD COUNTY WATER ZONE

INSIDE WATER METERS TO BE USED

TEST GRADIENT

NOTE: EXISTING WATER CONNECTIONS FOR 3 HOUSES ORIGINALLY ON THE PROPERTY SHALL BE ABANDONED (2 HOUSES 6990 & 6994 MONTGOMERY ROAD HAVE BEEN RAZED BY HO.CO). SEWER HOUSE CONNECTION FOR HOUSE AT 5700 ROWANBERRY DRIVE SHALL BE ABANDONED. EXISTING SEWER CONNECTION SERVICING 6990 & 6994 MONTGOMERY ROAD SHALL BE UTILIZED BY FIRE STATION.

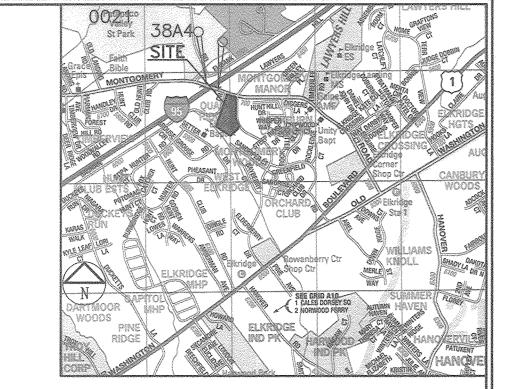

SCALE :1"=2,000' ADC MAP 4937-B7 & C7

#### BENCHMARK DESCRIPTIONS

The courses and coordinates shown hereon are based on the following Howard County monuments:

Elevation 223.372 562745.8233 1386542.0529 226.190



SHEET INDEX

SHEET NO. Cover Sheet Water Plan Water Profiles

HOWARD COUNTY, MARYLAND 9250 BENDIX ROAD COLUMBIA, MARYLAND 21045 CONTACT: MARK STROMDAHL 410-313-5757 mcstromdahl@HowardCountyMD.gov

## GENERAL NOTES

- 1. Approximate location of existing mains are shown. The contractor shall take all necessary precautions to protect existing mains and services and maintain uninterrupted service. Any damage incurred shall be repaired immediately to the satisfaction of the Engineer at the contractor's expense.
- 2. Topographic and Boundary surveys were performed in February 2013 by Shanaberger & Lane.
- 3. Horizontal and Vertical Survey Controls:

OWNER/DEVELOPER:

- The coordinates shown on the drawings are based on Maryland State Reference System NAD'83/91' as projected by Howard County Geodetic Control Stations No. 38A4 and No. 0021.
- All vertical controls are based on NAVD '88. Vertical controls provided on the drawings are based on Howard County Geodetic Control Stations No. 38A4 and No. 0021.
- 4. All pipe elevations shown are invert elevations unless otherwise noted on the plans,
- 5. Clear all utilities by a minimum of 12 inches. Clear all poles by 5'-0" minimum or tunnel as required unless otherwise noted. The owner has contacted the utility companies and has made arrangements for bracing of poles as shown on the drawings. In the event the contractor's work requires the bracing of additional poles, any cost incurred by the owner for the bracing of additional poles or damages shall be deducted from the monies owed by the contractor. The contractor shall coordinate with the utility companies to schedule the bracing of the poles.
- 6. For details not shown on the drawing, and for materials and construction methods, use Howard County Design Manual, Volume IV, Standard Specifications and Detials for Construction (Latest Edition). The contractor shall have a copy of
- 7. Where test pits have been made on existing utilities, they are noted by the symbol 🖥 at the locations of the test pits. A note or notes containing the results of the test pit or pits in included on the drawings. Existing utilities in the vicinity of the proposed work for which test pits have not been dug shall be located by the contractor two weeks in advance of construction operations at his own expense.
- 8. The contractor shall notify the following utility companies or agencies at least five working days before starting the work shown on these plans:

1-800-252-1133 410-637-8713 BGE(Contractor Services) 410-685-0123 BGE (Emergency) Bureau of Utilities 410-313-4900 Colonial Pipeline Co 410-795-1390 1-800-257-7777 Miss Utility 410-531-5533 State Highway Administration 1-800-743-0033

- 9. Trees and shrubs are to be protected from damage to the maximum extent. Trees and shrubs located within the construction strip are not to be removed or damaged by the contractor.
- 10. The contractor shall remove trees, stumps, and roots along the line of excavation. Payment for such removal shall be included in the unit price bid for construction of the main.
- 11. The contractor shall notify the Bureau of Highways, Howard County, at (410) 313—7450 at least five working days before open cutting or boring/jacking of any County road for laying water/sewer mains or house connections. The approval of these drawings will constitute compliance with DPW requirements per section 18.114(a) of the Howard County Code.

SITE ADDRESS: 5700 ROWENBERRY AVE. ELKRIDEGE. MARYLAND 21075

BID DOCUMENTS IFB #2016-12

DEPARTMENT OF PUBLIC WORKS HOWARD COUNTY, MARYLAND

DEPARTMENT OF PLANNING AND ZONING HOWARD COUNTY, MARYLAND

SILL <del>--¥-</del> Engineering GROUP, LLG 11130 Dovedale Court, Suite 200



DESIGNED BY: \_\_\_JLS\_ DRAWN BY: MPO CHECKED BY: PS NO DESCRIPTION **REVISIONS** 

REVISED **COVER SHEET** 

# **ELKRIDGE FIRE STATION** Capital Project F-5964

1ST ELECTION DISTRICT-Howard County, Maryland PARCEL A ZONING R-12, RA15

1 OF <u>3</u>

Fax: 410.696.2022 Email: info@sillengineering.com Civil Engineering for Land Development

**LEGEND** 

PROPOSED

Storm Drain

Light Poles

Concrete Walks

Electric U/G lines

Sanitary

DATE: <u>MAY 31, 2016</u> PROFESSIONAL CERTIFICATION: I HEREBY CERTIFY THAT THESE DOCUMENTS WERE PREPARED OR APPROVED BY ME, AND THAT I AM A DULY LICENSED PROFESSIONAL ENGINEER UNDER THE LAWS OF THE STATE OF MARYLAND, LICENSE NO. 32025, EXPIRATION DATE: JUNE 20, 2017

600' SCALE MAP NO. 1943

THE PURPOSE OF THIS REVISED WATER PLAN

IS TO DELETE THE 8" WATER & FH LINE C &

REVISED PLAN VIEW

BLOCK NO. B2


CONTRACT NO. 14-4827 D


SHEET NO.


SCALE:


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SHOWN



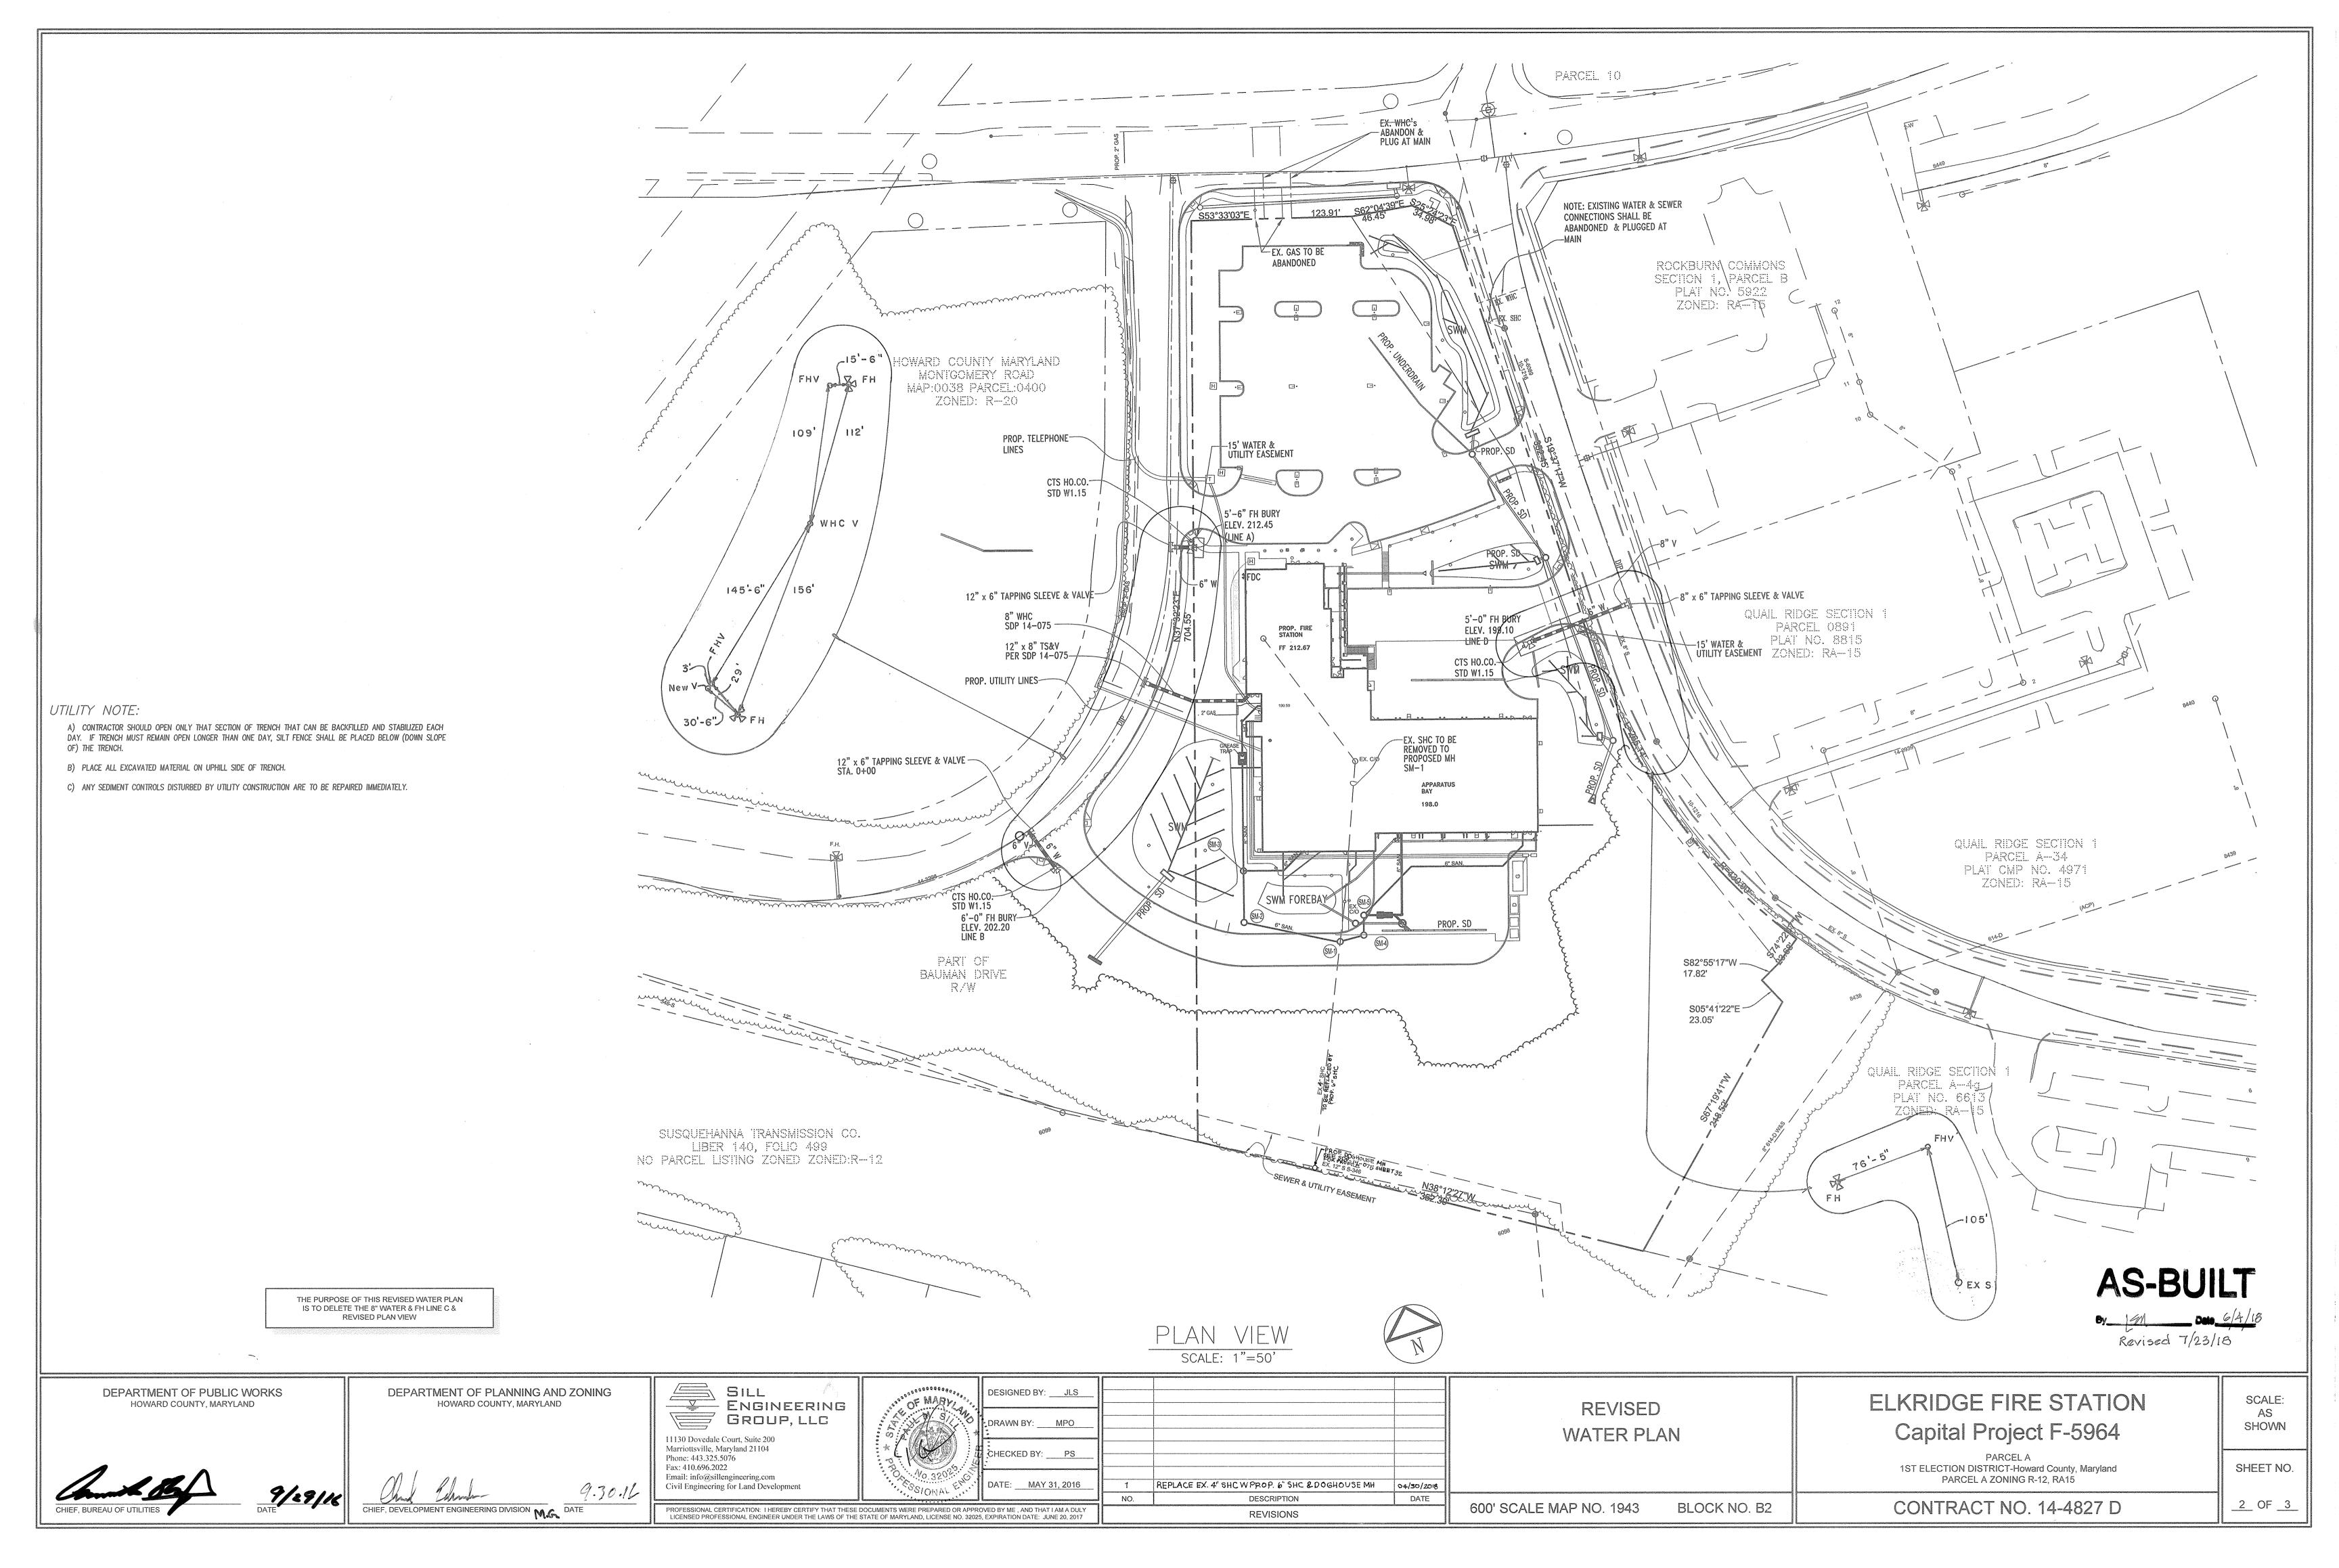

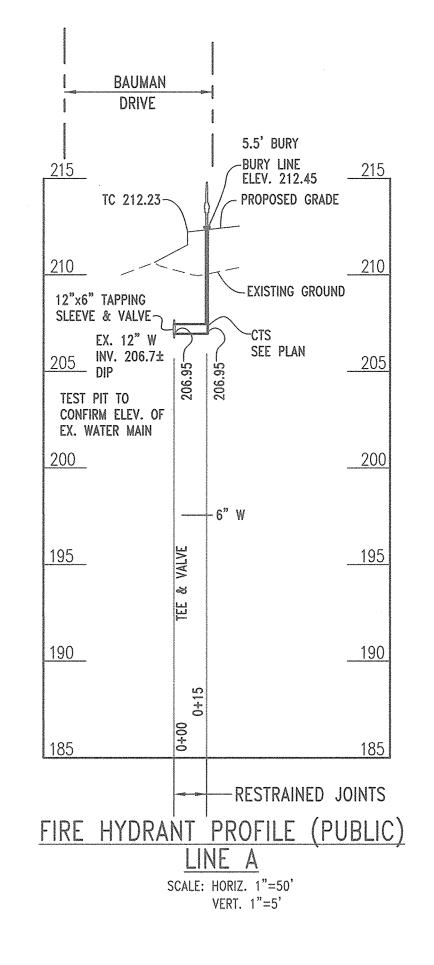

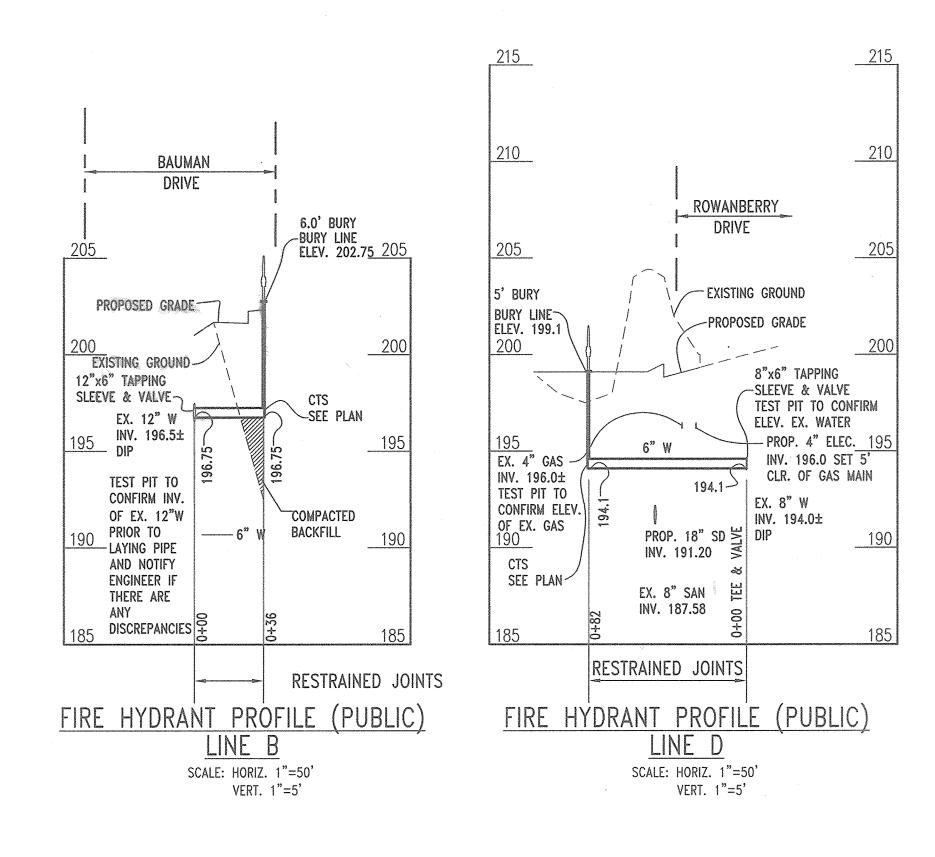

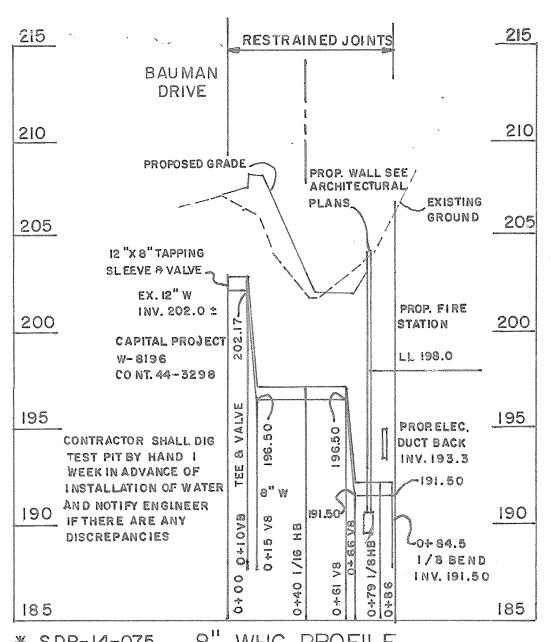8" WHC PROFILE \* SDP-14-075

THE PURPOSE OF THIS REVISED WATER PLAN IS TO DELETE THE 8" WATER & FH LINE C & REVISED PLAN VIEW



DEPARTMENT OF PUBLIC WORKS HOWARD COUNTY, MARYLAND

9/29/W DATE

HOWARD COUNTY, MARYLAND

DEPARTMENT OF PLANNING AND ZONING

CHIEF, DEVELOPMENT ENGINEERING DIVISION M.G. DATE 4.30.16



| SILL ENGINEERING                                                                                                                                                                                                                                  | 5000 MARY     | DESIGNED BY: JLS   |           |             |      |
|---------------------------------------------------------------------------------------------------------------------------------------------------------------------------------------------------------------------------------------------------|---------------|--------------------|-----------|-------------|------|
| GROUP, LLC                                                                                                                                                                                                                                        | A STATION     | DRAWN BY: MPO      |           |             |      |
| 11130 Dovedale Court, Suite 200<br>Marriottsville, Maryland 21104<br>Phone: 443.325.5076<br>Fax: 410.696.2022                                                                                                                                     | * 1           | CHECKED BY: PS     |           |             |      |
| Fax: 410.696.2022 Email: info@sillengineering.com Civil Engineering for Land Development                                                                                                                                                          | 5 No. 32020 G | DATE: MAY 31, 2016 | NO.       | DESCRIPTION | DATE |
| PROFESSIONAL CERTIFICATION: I HEREBY CERTIFY THAT THESE DOCUMENTS WERE PREPARED OR APPROVED BY ME, AND THAT I AM A DULY LICENSED PROFESSIONAL ENGINEER UNDER THE LAWS OF THE STATE OF MARYLAND, LICENSE NO. 32025, EXPIRATION DATE: JUNE 20, 2017 |               |                    | REVISIONS |             |      |

REVISED WATER PROFILES

600' SCALE MAP NO. 1943

ELKRIDGE FIRE STATION Capital Project F-5964

1ST ELECTION DISTRICT-Howard County, Maryland PARCEL A ZONING R-12, RA15

SHEET NO. <u>3</u> OF <u>3</u>

SCALE:

AS

SHOWN

CONTRACT NO. 14-4827 D BLOCK NO. B2