

PROPOSED PUBLIC WATER & PUBLIC SEWER MAIN CEDAR LANE SEWER MAIN EXTENSION 5th ELECTION DISTRICT, TAX MAP 35, GRID 17 HOWARD COUNTY, MARYLAND 21044

	QUAN	ITITIES		
ITEMS	QUANTITIES ESTIMATE	AS-BUILT		
		QUANTITIES	TYPE	MANUF/SUPPLIER
8" SEWER	640 L.F.	640 L.F.	PVC SDR-35	JM EAGLE
MANHOLES	4 EACH	4	PRE CAST CONC.	ATLANTIC CONCRETE PRODUCTS
			,	

SURVEY AND DRAFTING DIVISION AS BUILT DATE: 9/14/09

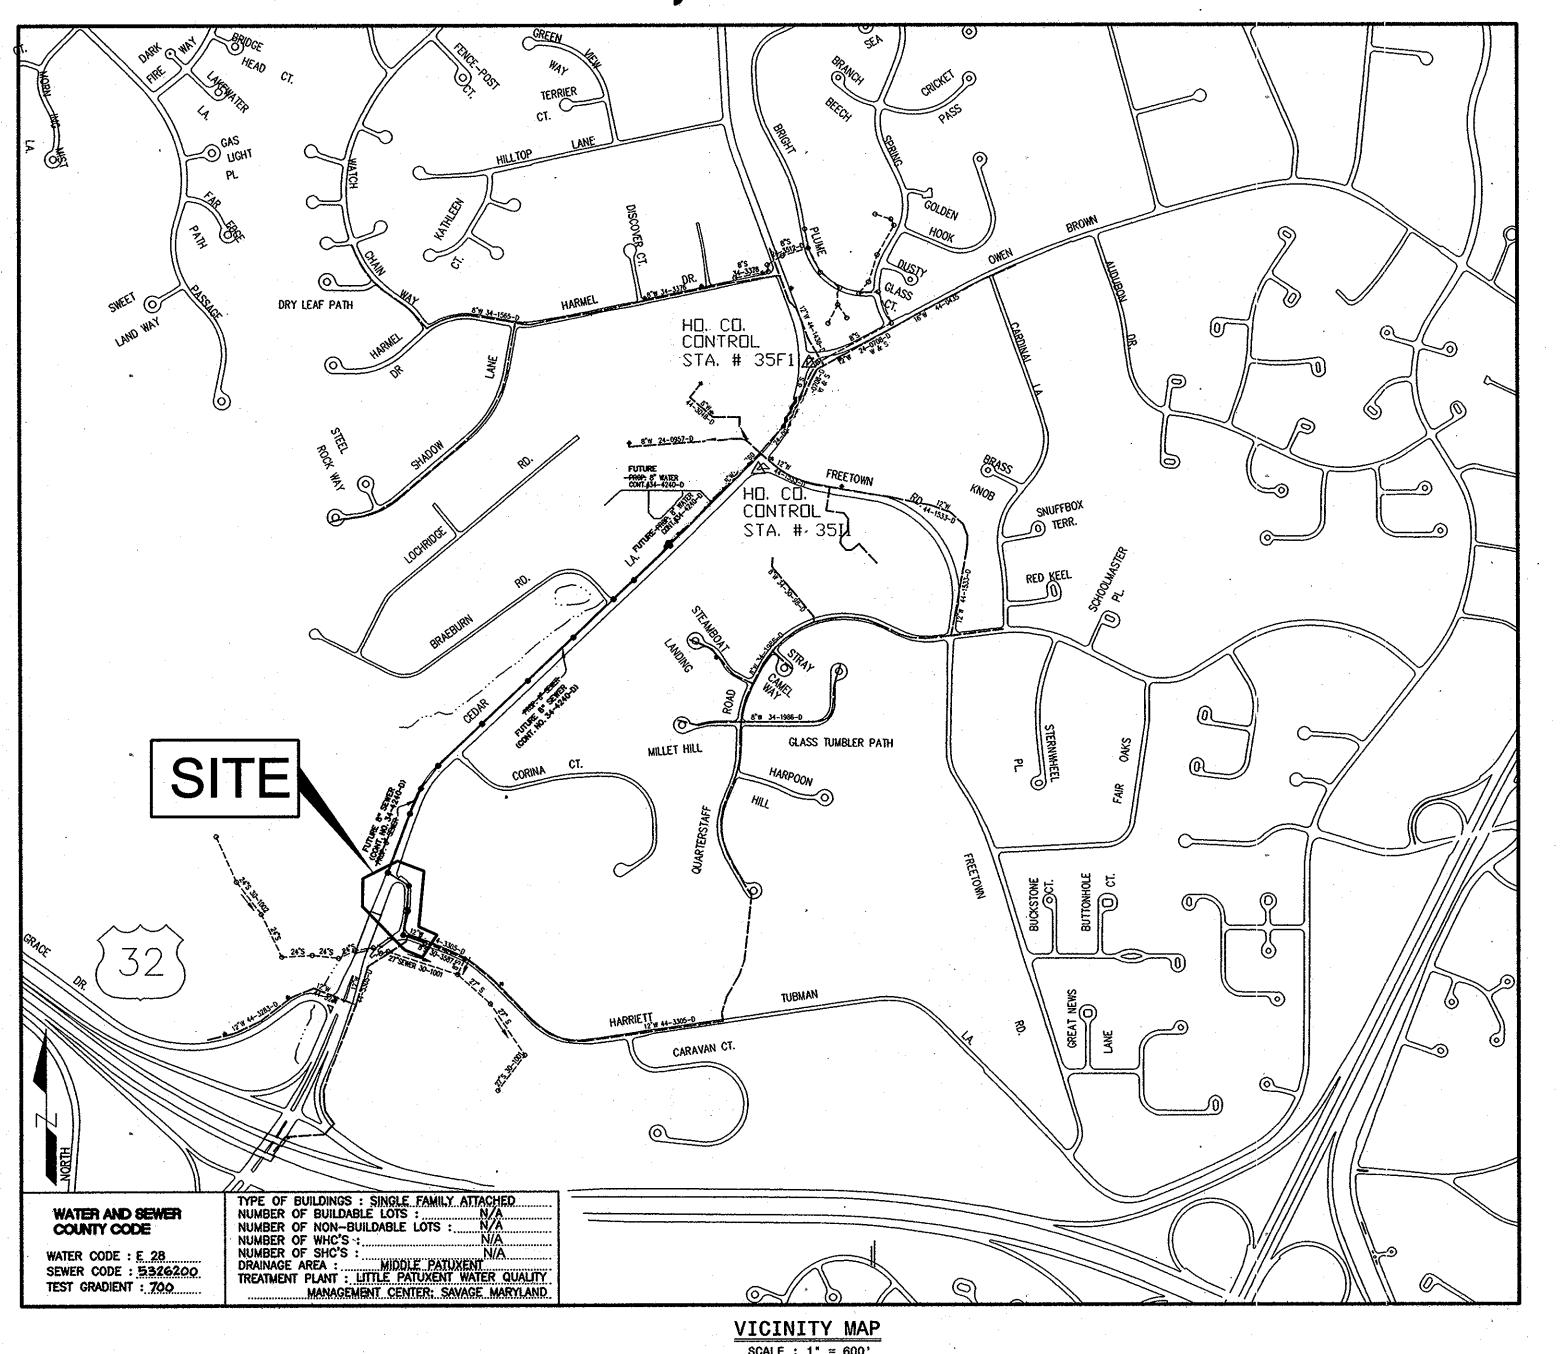

AS BUILT

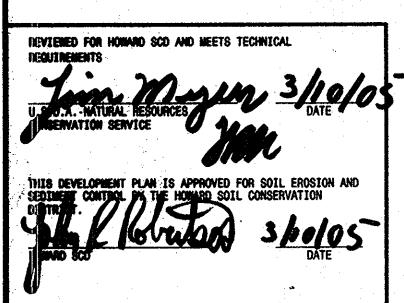

DEPARTMENT OF PUBLIC WORKS HOWARD COUNTY, MARYLAND

DEPARTMENT OF PLANNING AND ZONING HOWARD COUNTY. MARYLAND

American Land Development and Engineering, Inc.
10749 BIRMINGHAM WAY WOODSTOCK, MD. 21163 TEL. (410) 465-7903 FAX. (410) 465-3845

PREPARED BY :

DATE: 2-28-05 600' SCALE MAP No. 35 REVISIONS

COVER SHEET

BLOCK No. 17

CEDAR LANE SEWER MAIN EXTENSION

BUILDABLE BULK PARCEL "A" - UNITS 1 THRU 55 AND COMMUNITY CENTER PLANNED SENIOR COMMUNITY (PSC) - AGE RESTRICTED ADULT HOUSING A RESUBDIVISION OF PARCELS 224 AND 236 5th ELECTION DISTRICT, TAX MAP 35, GRID 17, HOWARD COUNTY, MD. 21044

CONTRACT NO.: 34-4650 CAPITAL PROJECT S-6272

SCALE : AS SHOWN

410-531-5533

410-850-4620

410-787-9068

1-800-257-7777

410-795-1390

410-313-4900

410-313-2640

SHEET NO.

GENERAL NOTES:

- 1. Approximate location of existing mains are shown. The contractor shall take all necessary precautions t protect existing mains and services and maintain uninterrupted supply. Any damage incurred shall be repaired immediately to the satisfaction of the Engineer at the Contractor's expense
- 3. All vertical controls are based on NAVD 88.
- has contacted the utility companies and has made arrangements for bracing of poles as shown on the drawings. In the event the contractor's work requires the bracing of additional poles, any cost incurred by the owner for bracing of additional poles or damages shall be deducted from monies owed the contractor. The contractor shall coordinate with the utility companies to schedule the bracing of the poles.
- 6. For details not shown on the drawings, and for materials and construction methods, use Howard County Design Manual, Volume IV, Standard Specifications and Detail for Construction (Latest Edition). The
- Where test pits have been made on existing utilities, they are noted by the symbol at the location of the test pit. A note or notes containing the results of the test pit or pits is included on the drawings. Existing utilities in the vicinity of the proposed work for which test pits have not been dug shall be located by the contractor two weeks in advance of construction operations at his own expense.

AT&T	
BGE Contractor Services	
BGE Under Ground Damage Control	
Bureau of Utilities	
Colonial Pipeline Company	410-795-1390
Miss Utility	
State Highway Administration	
A STATE OF THE STA	2 000 740 0000 1 440 004 0040

- 9. Trees and shrubs are to be protected from damage to maximum extent. Trees and shrubs located within the construction strip are not to be removed or damaged by the contractor.
- 11. The contractor shall notify the Bureau of Highways, Howard County at 410-313-2450 at least five (5) working days before any open cut of any County road or boring/jacking operation in County roads for laying water/ sewer mains or house connections. The approval of these drawings will constitute compliance with the DPW requirements per Section 18.114(a) of the Howard County Code.
- 12. All sewer mains shall be D.I.P or P.V.C. unless otherwise noted
- 13. All manholes shall be 4'-0" inside diameter unless otherwise noted
- 14. Force mains shall be D.I.P. only.
- 15. Manholes shown with 12° and 16° walls are for brick manholes only
- 16. Manholes designated W.T. in plan and profile shall have watertight frame and covers, Standard Detail 65.52. Where watertight frame and cover is used, set top of frame 1" - 6" above finished grade unless otherwise
- 17. House(s) with the symbol "C.N.S." indicates that cellar cannot be served.
- 18. All water mains to be D.I.P. Class 52 unless otherwise noted.
- Tops of all water mains to have a minimum of 3'-6" cover unless otherwise noted
- 21. All fittings shall be buttressed or anchored with concrete in accordance with the Standard Details unler otherwise provided for on the drawings.
- 22. Fire hydrants shall be set to the bury line elevations shown on the drawings. All fire hydrants shall be restrained and buttressed with concrete in accordance with the Standard Details. Soil around the fire

hydrant shall be compacted in accordance with Section 1000 and 1005 of the Standard Specifications.

- 23. The contractor shall not operate any water main valves on the existing water system.
- 24. All water house connections shall be for inside meter setting unless otherwise noted on plans or in
- 25. For sprinkler system for all townhomes or multi-family dwelling units will have a 1° connection with a 3/4" inside meters.

UTILITY NOTE

Notify "Miss Utility" at 1-800-257-7777 - 48 hours prior to doing

any excavation in this area.

The location of existing undergound utilities are shown in an approximate way only and have not been independently verified by the owner or its representative. The contractor shall determine the exact location of all existing utilities before commencing work, and agrees to be fully responsible for any and all damages which might be occasioned by the contractor's failure to exactly locate and preserve any and all underground utilities

CONTRACTOR SHALL NOTIFY THE FOLLOWING UTILITY

BEFORE STARTING WORK SHOWN ON THESE PLANS

STATE HIGHWAY ADMINISTRATION

BALTIMORE GAS & ELECTRIC CO.

BALTIMORE GAS & ELECTRIC CO. UNDERGROUND DAMAGE CONTROL

HOWARD COUNTY DEPT. OF PUBLIC WORKS

HO CO. ENVIRONMENTAL HEALTH DPT

CONTRACTOR SERVICES

COLONIAL PIPELINE CO

BUREAU OF UTILITIES

MISS UTILITY

COMPANIES OR AGENCIES AT LEAST FIVE WORKING DAYS

