SAVAGE QUARRY

HOWARD COUNTY, MARYLAND SEWER RELOCATION

CONTRACT NO. 24-4615-D

INDEX OF DRAWINGS

TITLE SHEET SHEET 1

SHEET 2

SEWER PLAN

SEWER PROFILE

SECTIONS AND DETAILS

GENERAL NOTES

- APPROXIMATE LOCATIONS OF EXISTING MAINS ARE SHOWN. THE CONTRACTOR SHALL TAKE ALL NECESSARY PRECAUTIONS TO PROTECT EXISTING MAINS AND SERVICES AND MAINTAIN UNINTERRUPTED SERVICE. ANY DAMAGE INCURRED SHALL BE REPAIRED IMMEDIATELY TO THE SATISFACTION OF THE ENGINEER AT THE CONTRACTOR'S EXPENSE.
- 2. TOPOGRAPHIC FIELD SURVEYS WERE PREFORMED ON OCTOBER 2008 BY CME ENGINEERING, LLC
- THE COORDINATES SHOWN ON THE DRAWINGS ARE BASED ON MARYLAND STATE REFERENCE SYSTEM NAD83(91) AS PROJECTED BY HOWARD COUNTY GEODETIC CONTROL STATIONS NO. 43GA AND NO. 43G6. ALL VERTICAL CONTROLS ARE BASED ON NGVD88. VERTICAL CONTROL PROVIDED ON THE DRAWINGS IS A REBAR AND CAP #55. N:481803.692.
- 4. ALL PIPE ELEVATIONS SHOWN ARE INVERT ELEVATIONS UNLESS OTHERWISE NOTED ON THE PLANS.
- CLEAR ALL UTILITIES BY A MINIMUM OF 12 INCHES. CLEAR ALL POLES BY 5'-0" MINIMUM OR TUNNEL AS REQUIRED UNLESS OTHERWISE NOTED. THE OWNER HAS CONTACTED THE UTILITY COMPANIES AND HAS MADE ARRANGEMENTS FOR BRACING OF POLES AS SHOWN ON THE DRAWINGS. IN THE EVENT THE CONTRACTOR'S WORK REQUIRES THE BRACING OF ADDITIONAL POLES, ANY COST INCURRED BY THE OWNER FOR THE BRACING OF ADDITIONAL POLES OR DAMAGES SHALL BE DEDUCTED FROM MONIES OWED THE CONTRACTOR. THE CONTRACTOR SHALL COORDINATE WITH THE UTILITY COMPANIES TO
- 6. FOR DETAILS NOT SHOWN ON THE DRAWING, AND FOR MATERIALS AND CONSTRUCTION METHODS, USE HOWARD COUNTY DESIGN MANUAL, VOLUME IV, STANDARD SPECIFICATIONS AND DETAILS FOR CONSTRUCTION (LATEST EDITION). THE CONTRACTOR SHALL HAVE A COPY OF VOLUME IV ON THE JOB.
- 7. WHERE TEST PITS HAVE BEEN MADE ON EXISTING UTILITIES, THEY ARE NOTED BY THE SYMBOL AT THE LOCATIONS OF THE TEST PITS. A NOTE OR NOTES CONTAINING THE RESULTS OF THE TEST PIT OR PITS IS INCLUDED ON THE DRAWINGS. EXISTING UTILITIES IN THE VICINITY OF PROPOSED WORK FOR WHICH TEST PITS HAVE NOT BEEN DUG SHALL BE LOCATED BY THE CONTRACTOR TWO WEEKS IN ADVANCE OF CONSTRUCTION OPERATIONS AT CONTRACTOR'S
- THE CONTRACTOR SHALL NOTIFY THE FOLLOWING UTILITY COMPANIES OR AGENCIES AT LEAST FIVE (5) WORKING DAYS BEFORE STARTING WORK SHOWN ON

BGE (CONSTRUCTION SERVICES)...410-850-4620

BGE (EMERGENCY). ..410-685-1400 BUREAU OF UTILITIES. ..410-313-4900

...410-795-1390 COLONIAL PIPELINE CO.. MISS UTILITY...

NOT TO BE REMOVED OR DAMAGED BY THE CONTRACTOR.


STATE HIGHWAY ADMINISTRATION......410-531-5533 ..800-743-0033/410-224-9210

TREES AND SHRUBS ARE TO PROTECTED FROM DAMAGE TO THE MAXIMUM EXTENT. TREES AND SHRUBS LOCATED WITHIN THE CONSTRUCTION STRIP ARE

- 10. THE CONTRACTOR SHALL REMOVE TREES, STUMPS, AND ROOTS ALONG THE LINE OF EXCAVATION. PAYMENT FOR SUCH REMOVAL SHALL BE INCLUDED IN
- 11. THE CONTRACTOR SHALL NOTIFY THE BUREAU OF HIGHWAYS, HOWARD COUNTY, AT 410-313-7450 AT LEAST FIVE WORKING DAYS BEFORE OPEN CUTTING OR BORING/JACKING OF ANY COUNTY ROAD FOR LAYING WATER/SEWER MAINS OR HOUSE CONNECTIONS. THE APPROVAL OF THESE DRAWINGS WILL CONSTITUTE COMPLIANCE WITH DPW REQUIREMENTS PER SECTION 18.114(a) OF THE HOWARD COUNTY CODE.
- 12. ALL SEWER MAINS SHALL BE RESTRAINED JOINT DUCTILE IRON PIPE CLASS 54, UNLESS OTHERWISE NOTED.
- 13. ALL MANHOLES SHALL BE 4'-0" INSIDE D. METER UNLESS OTHERWISE NOTED.
- 14. FORCE MAINS SHALL BE DUCTILE IRON PIFE ONLY.

HOWARD SOIL CONSERVATION DISTRICT

- 15. MANHOLES SHOWN WITH 12" AND 16" WALLS ARE FOR BRICK MANHOLES ONLY.
- 16. MANHOLES DESIGNATED W.T. IN PLAN AND PROFILE SHALL HAVE WATERTIGHT FRAME AND COVER, STANDARD DETAIL G5.52. WHERE WATERTIGHT MANHOLE FRAMES AND COVERS ARE USED, SET TOP OF FRAME 1'-6" ABOVE FINISHED GRADE UNLESS OTHERWISE NOTED ON THE DRAWINGS.
- 17. HOUSE(S) WITH THE SYMBOL (C.N.S.) INDICATES THAT THE CELLAR CANNOT BE SERVED.

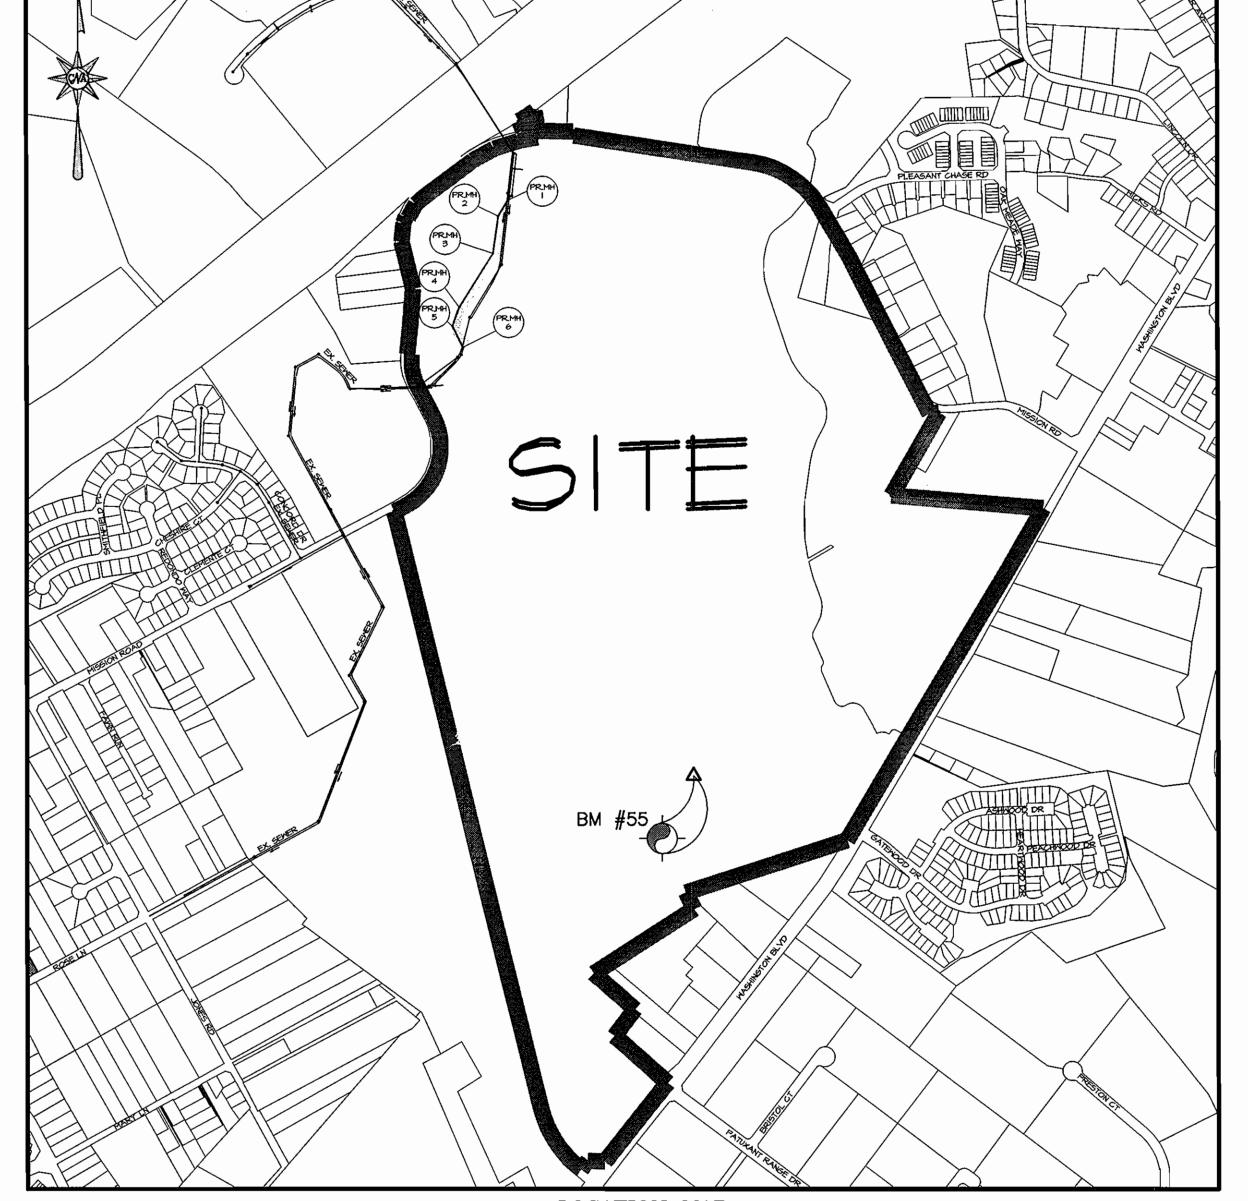

PROFESSIONAL CERTIFICATION: I HEREBY CERTIFY THAT THESE DOCUMENTS WERE PREPARED OR APPROVED BY ME. AND THAT I AM A DULY LICENSED PROFESSIONAL ENGINEER UNDER THE LAWS OF THE STATE OF MARYLAND, LICENSE NO. 13715, EXPIRATION DATE:11/17/2009.

DEPARTMENT OF PUBLIC WORKS HOWARD COUNTY, MARYLAND

HOWARD COUNTY, MARYLAND

PLAN PERMET NO. GP-04-11 ESTABLISHES EROSION AND SEDIMENT CONTROL

DEPARTMENT OF PLANNING & ZONING HOWARD COUNTY, MARYLAND





Civil Engineers Land Surveyors Landscape Architects Planners Geotechnical Engineers Environmental Engineers 1667 Knecht Avenue - Suite A Baltimore, Maryland 21227 Phone (410) 242-1549 Fax (410) 242-1745 E-mail: cnamail@cna-engineers.com



	Date:	Date	Revisions	
	3/3/09			
	Drawn By:			
	NJS			
	Design By:			1
	NJS Design By: NJS Review By:			1
	Keview by.			1

TITLE SHEET

600 SCALE MAP No. 43 BLOCK No. 19

SAVAGE QUARRY SEWER RELOCATION CONTRACT NO. 24-4615-D

6TH ELECTION DISTRICT HOWARD COUNTY, MARYLAND

Scale: AS SHOWN Job No: 05055 Sheet:

PERMITTED USE No. 20804125 **LEGEND** PROPERTY LINE UTILITY EASEMENT

EX. 2' CONTOUR

EX. 10' CONTOUR

PROP. 2' CONTOUR

PROP. 10' CONTOUR

EX. SANITARY SEWER

EX. SANITARY MANHOLE


PROP. SANITARY SEWER


PROP. SANITARY MANHOLE

BILL OF MATERIALS						
ITEM	QUANTITY	AS-BUILT QUANTITY				
SEWER						
16" RESTRAINED JOINT C-900 SEWER	1090 L.F.					
48" SANITARY MANHOLE	6 EA.					

SEQUENCE OF CONSTRUCTION

- CONTINUE THE BYPASS PUMPING OPERATION BETWEEN EXISTING MANHOLE 4395B AND EXISTING MANHOLE 4393A THAT IS CURRENTLY IN PLACE.
- CONSTRUCT THE PROPOSED RELOCATED SEWER MAIN AND MANHOLES. TIE INTO EXISTING MANHOLE 4395A INVERT OUT AND EXISTING MANHOLE 4394A INVERT IN, MATCHING THE
- 4. CONTRACTOR SHALL ENSURE A WATERTIGHT CONNECTION TO THE EXISTING MANHOLES USING THE EXISTING INTEGRALLY CAST RUBBER GASKET PROVIDED THEY ARE IN SERVICEABLE CONDITION. IF EXISTING GASKETS ARE MISSING OR DAMAGED, USE STAINLESS STEEL INTERNAL EXPANSION BAND AND EXTERNAL PIPE CLAMP SEALS IN ACCORDANCE WITH HOWARD COUNTY STANDARD SPECIFICATION SECTION 962, PARAGRAPH
- 5. CONTRACTOR SHALL PREFORM PIPE TESTING IN ACCORDANCE WITH HOWARD COUNTY STANDARD
- SPECIFICATIONS SECTION 1009.03.04-ACCEPTANCE TESTING. UPON SATISFACTORY TESTING AND INSPECTOR APPROVAL, CONTRACTOR SHALL REMOVE TEMPORARY PLUGS AND BYPASS PUMPING SYSTEM.

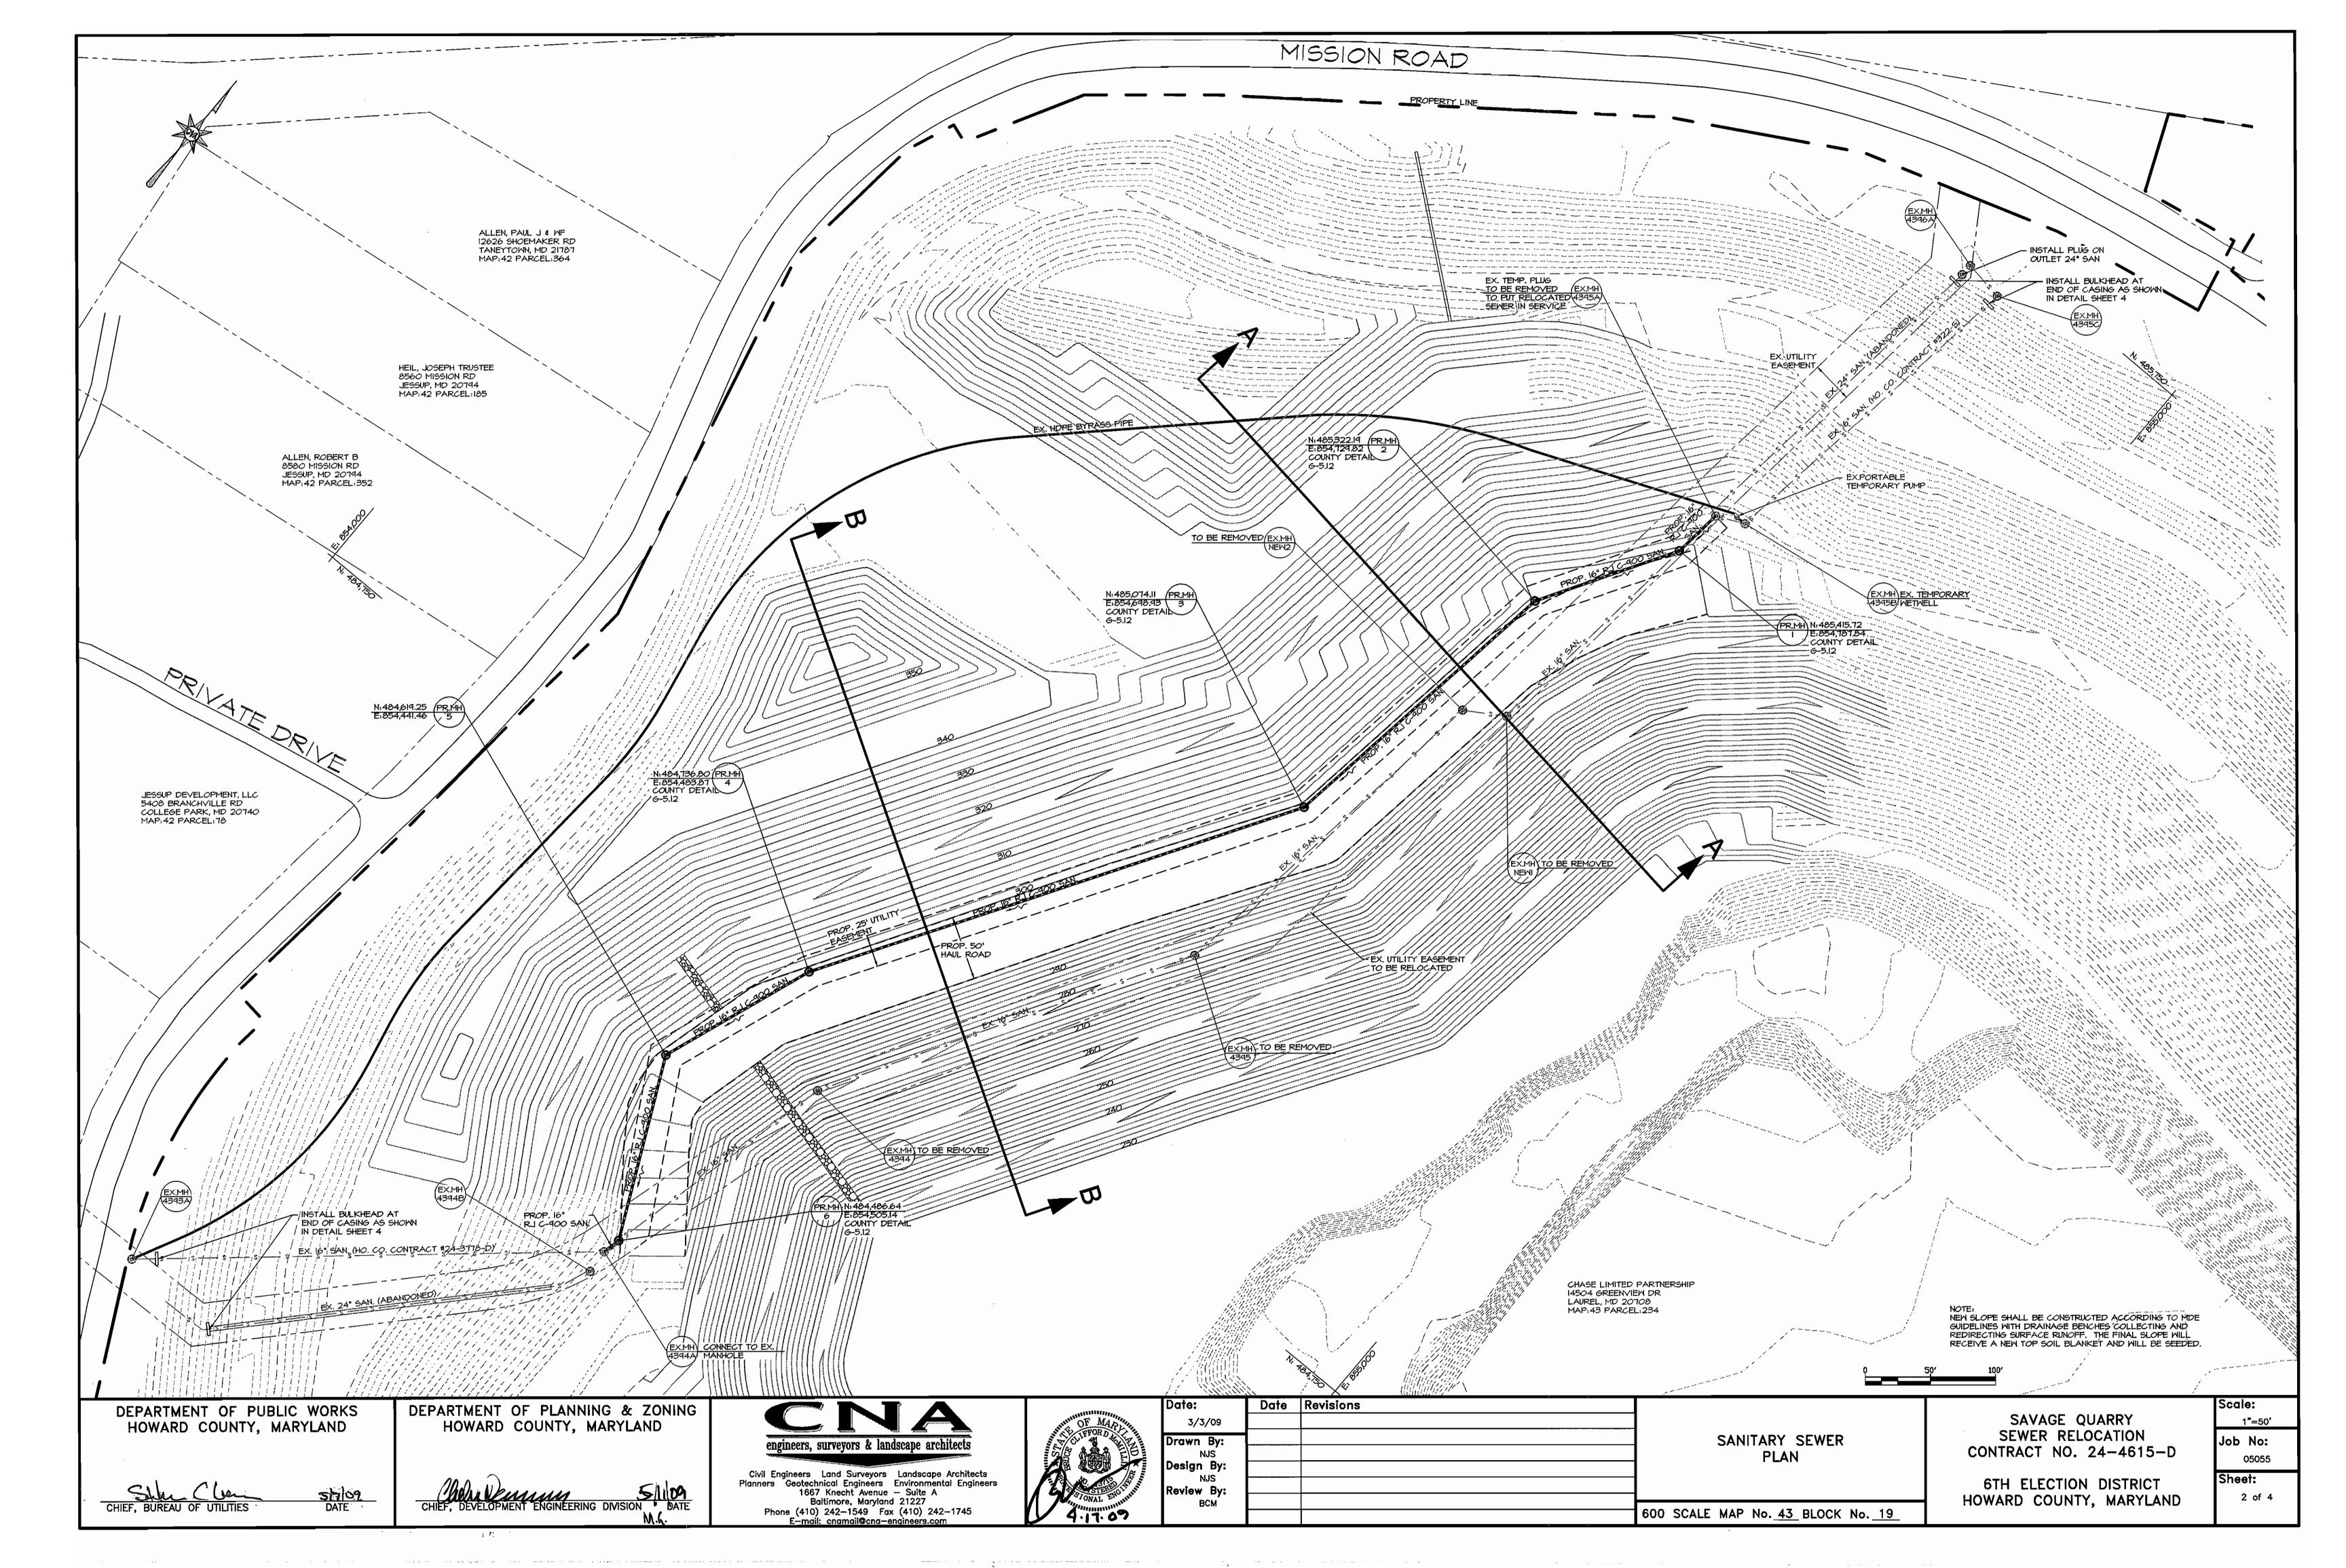

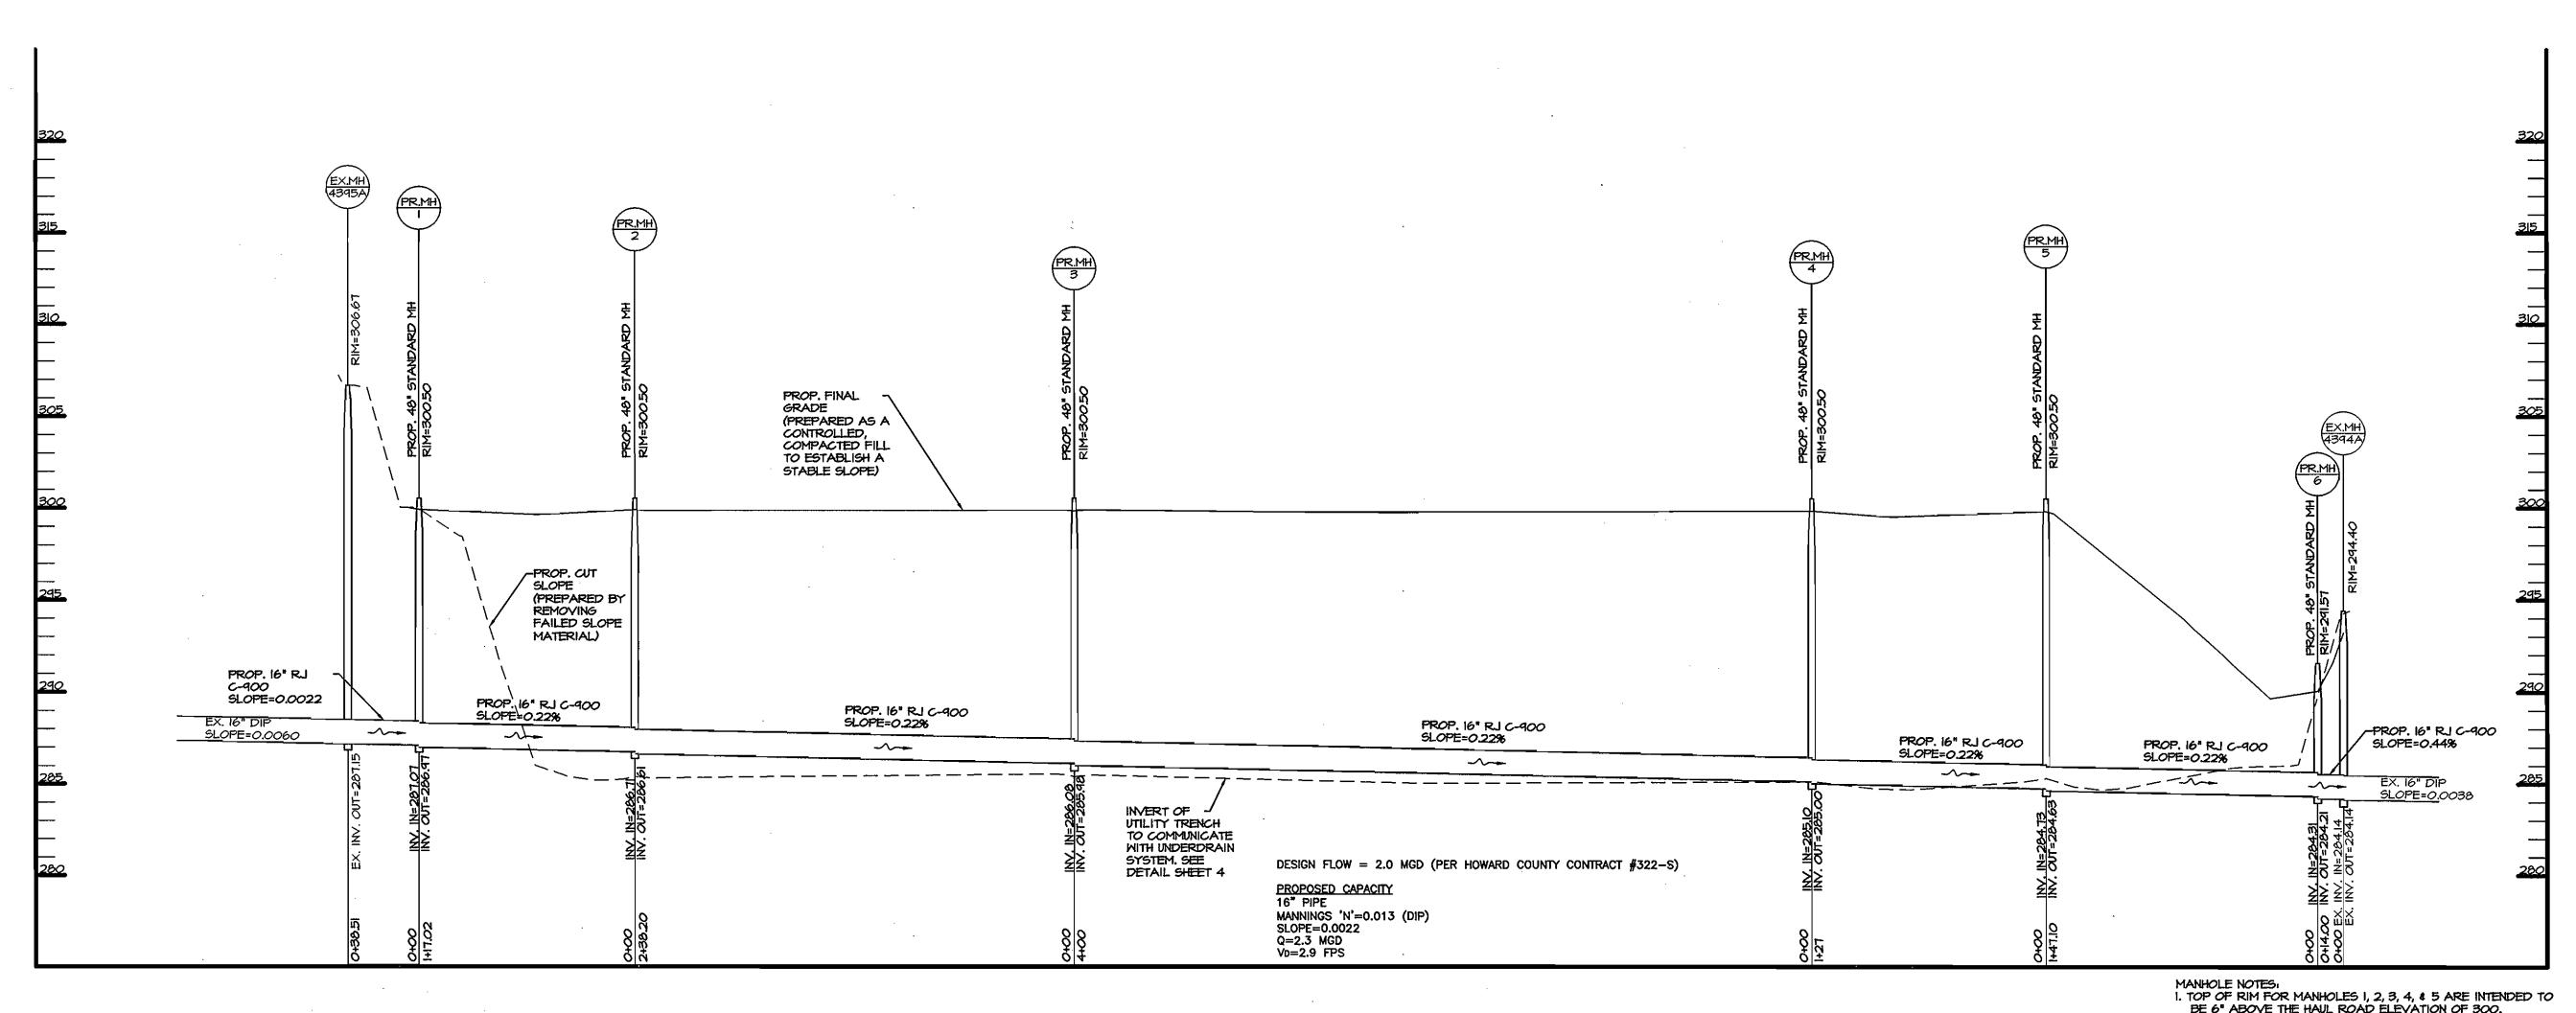

PROFILE
HORIZ: 1"=50'
VERT: 1"=5'

MANHOLE NOTES:

1. TOP OF RIM FOR MANHOLES I, 2, 3, 4, 4 5 ARE INTENDED TO BE 6" ABOVE THE HAUL ROAD ELEVATION OF 300.

2. MANHOLES I THROUGH 6 SHALL BE PAINTED SAFETY GREEN ABOVE FINISHED GRADE.

3. THE INTENT OF THE DESIGN IS TO MAINTAIN EXISTING ALIGNMENTS FOR TIE INS TO EXISTING MANHOLES. IF CONDITIONS IN THE FIELD REQUIRE ALIGNMENT ADJUSTMENTS, CONTRACTOR SHALL NOTIFY ENGINEER WELL IN ADVANCE OF THE TIE IN WORK.

DEPARTMENT OF PUBLIC WORKS HOWARD COUNTY, MARYLAND

Strice DATE

DEPARTMENT OF PLANNING & ZONING HOWARD COUNTY, MARYLAND







Date:	Date	Revisions	
3/3/09			
Drawn By:			
NJS			
Design By:			
NJS Review By:			
RCM			_

SANITARY SEWER PROFILE AND DETAILS


600 SCALE MAP No. 43 BLOCK No. 19

SAVAGE QUARRY SEWER RELOCATION CONTRACT NO. 24-4615-D

6TH ELECTION DISTRICT HOWARD COUNTY, MARYLAND

Scale: HORIZ: 1"=50' VERT: 1"=5' Job No: 05055 Sheet:

3 of 4

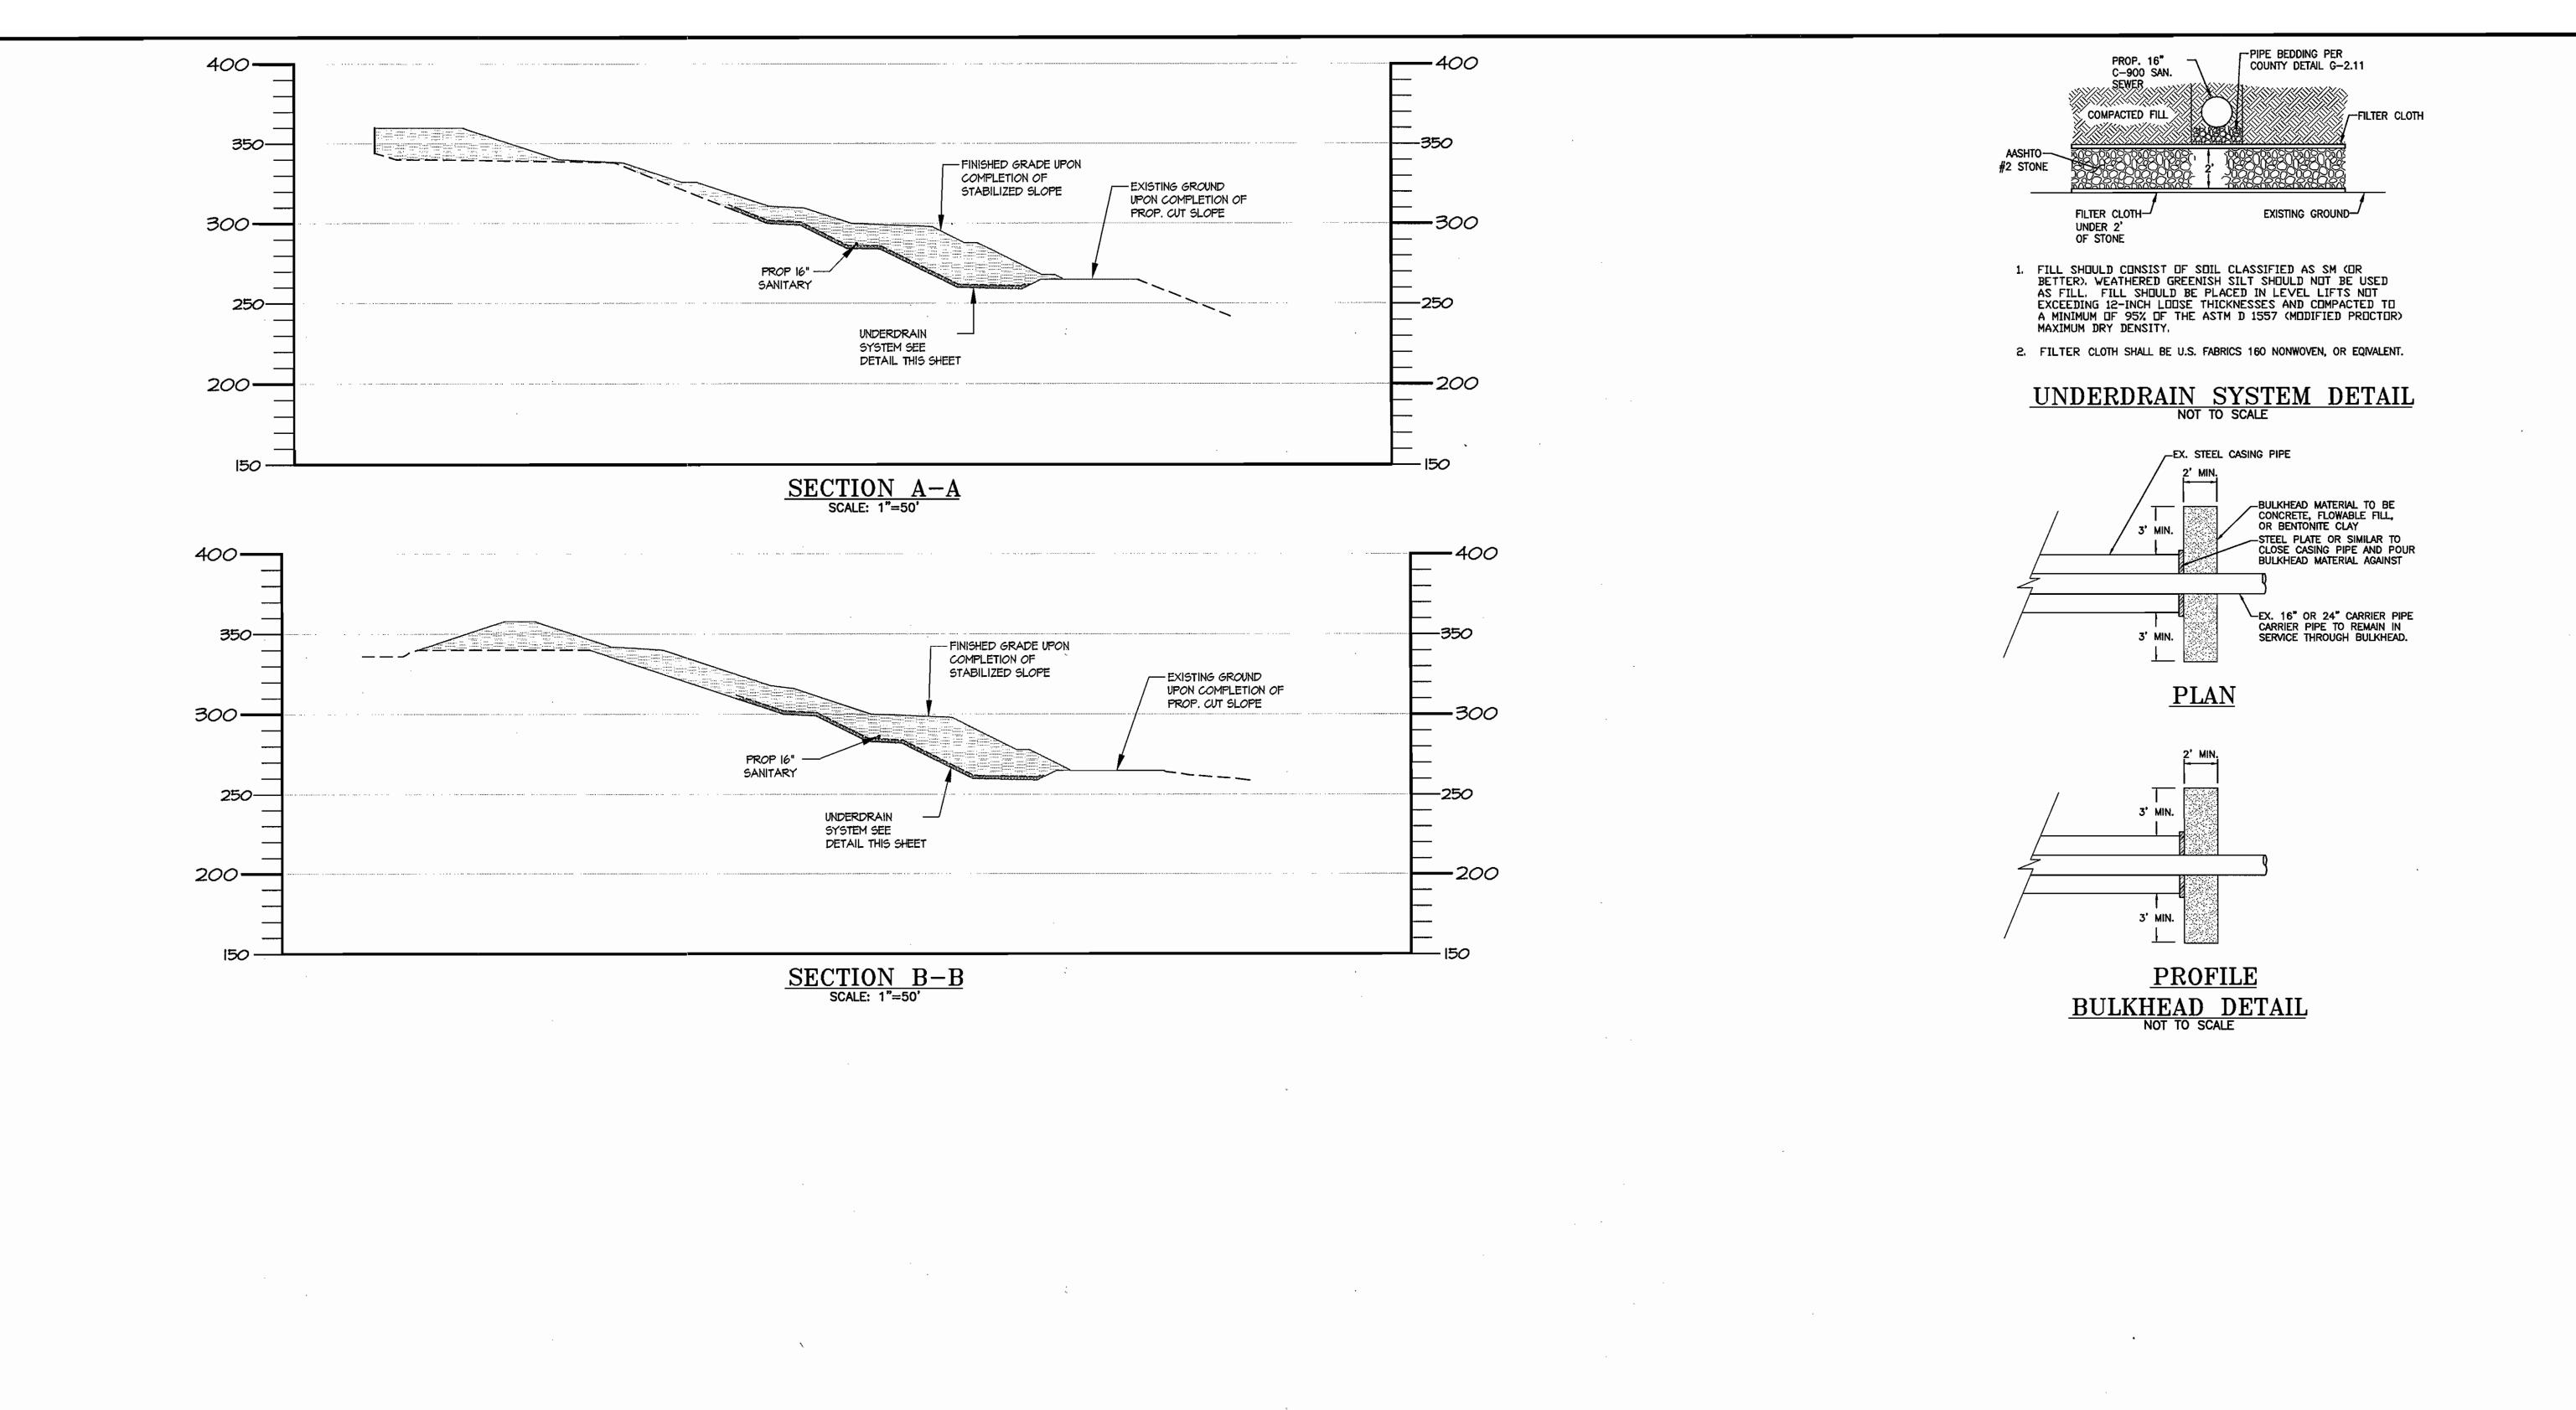

DEPARTMENT OF PUBLIC WORKS HOWARD COUNTY, MARYLAND

DEPARTMENT OF PLANNING & ZONING HOWARD COUNTY, MARYLAND







	Date:	Date	Revisions	
	3/3/09			
	Drawn By:			SANITARY SEWER
	NJS			PROFILE AND DETAILS
K E	Design By:			
, i	Review By:			
	ВСМ			
				600 SCALE MAP No. 43 BLOCK No. 19

SAVAGE QUARRY SEWER RELOCATION CONTRACT NO. 24-4615-D

6TH ELECTION DISTRICT HOWARD COUNTY, MARYLAND Job No: Sheet: 4 of 4

Scale: AS SHOWN