GENERAL NOTES

PART I - GENERAL

- 1. Approximate locations of existing mains are shown. The contractor shall take all necessary precautions to protect existing mains and services and maintain uninterrupted supply. Any damage incurred shall be repaired immediately to the satisfaction of the Engineer at the Contractor's expense.
- 2. The existing topography is based on a field run Topographic Survey prepared by FSH Associates in March 2007, with a 2 foot contour interval.
- 3. The coordinates shown on the drawings are based on Maryland State Reference System NAD 83/91 as projected by Howard County Geodetic Control Stations No.37HA and No. 0048. (see
- 4. All vertical controls are based on NAVD'88. Vertical controls provided on the drawings are 37HA and 0048 (see vicinity map).
- 5. All pipe elevations shown are invert elevations unless otherwise noted on the plans, 6. Clear all utilities by a minimum of 12 inches. Clear all poles by 5-0st minimum or tunnel as required unless otherwise noted. The owner has contacted the utility companies and has made arrangements for bracing of poles as shown on the drawings. In the event the contractor's work requires the bracing of additional poles, any cost incurred by the owner for the bracing of additional poles or damages shall be deducted from monies owned by the contractor. The contractor shall coordinate with the utility companies to schedule the bracing
- 7. For details not shown on the drawing, and for materials and construction methods, use Howard County Design Manual, Volume IV, Standard Specifications and Details for Construction (latest Edition). The contractor shall have a copy of Volume IV on the job
- 8. Where test pits have been made on existing utilities, they are noted by the symbol Hat the locations of the test pits. A note or notes containing the results of the test pits are included on the drawings. Existing utilities in the vicinity of the proposed work for which test pits have not been dug shall be located by the contractor two weeks in advance of construction operations at his own expense.
- 9. The contractor shall notify the following utility companies or agencies at least five working days before starting work shown on these plans:

BGE(Contruction Services) BGE(Emergency)
Bureau of Utilities
Colonial Pipeline Company

410.850.4620 410.685.1400 410.313.4900 410.795.1390 1.800.257.7777

State Highway Administration 10. Trees and shrubs are to be protected from damage to the maximum extent. Trees and shrubs located within the construction strip are not to be removed or damaged by the

11. The Contractor shall remove trees, stumps and roots along line of excavation. Payment for such removal shall be included in the unit price bid for the construction of the main.

12. The subject property is zoned "R-SC" per the 02/02/04 Comprehensive Zoning Plan. 13. The Contractor shall notify the Bureau of Highways, Howard County, at 410.313.7450 at least five working days before any open cutting or boring/jacking of any county road for laying water/sewer mains or house connections. The approval of these drawings will

constitute compliance with DPW requirements per Section 18.114(a) of the Howard County 14. Previous Howard County file numbers: S-03-15, F-02-54, WP-02-120, Plat #16263, Contr. #14-4004-D, Contr. #14-1331-D, F-89-14, Plat #8755.

PART II - WATER

- 1. All water mains to be D.I.P. Class 54 (C-900 PVC in corrosive Hot Spots
- only) unless otherwise noted.

 2. Tops of all water mains to have a minimum of 3-6" of cover unless otherwise noted.
- 3. Valves adjacent to tees shall be strapped to tees.
- 4. All fittings shall be buttressed or anchored with concrete in accordance with
- the Standard Details unless otherwise provided for on the drawings. 5. Fire Hydrants shall be set to the bury line elevations shown on the drawings. All Fire Hydrants shall be restrained and buttressed with concrete in accordance with Standard Details. The soil around Fire Hydrant shall be compacted in accordance with Section 1000
- and 1005 of the Standard Specifications. 6. The Contractor shall not operate any water main valves on the existing water system.
- 7. All water house connections shall be for inside meter settings unless otherwise noted on the plans or in specifications. 8. All water house connections shall copper.


PART III - SEWER


- 1. All sewer mains shall be D.I.P. or P.V.C. unless otherwise noted.
- 2. All manholes shall be 41-011 inside diameter unless otherwise noted.
- 3. Force mains shall be D.I.P. only. 4. Manholes shown with 12" and 16" walls are for brick manholes only
- Manholes designated W.T. in plan and profile shall have watertight frame \$ covers,
- Standard Detail G5.52. Where watertight manhole frame and cover is used, set top of frame I"-6" above finished grade unless otherwise noted on the drawings.
- 6. House(s) with the symbol "C.N.S." indicates that cellar cannot be served.

PUBLIC WATER AND SEWER FINAL PLANS

NOODCREST

BUILDABLE LOTS 1, 3, 4 \$ 5 AND OPEN SPACE LOTS 2 \$ 6 HOWARD COUNTY, MARYLAND CONTRACT NO.

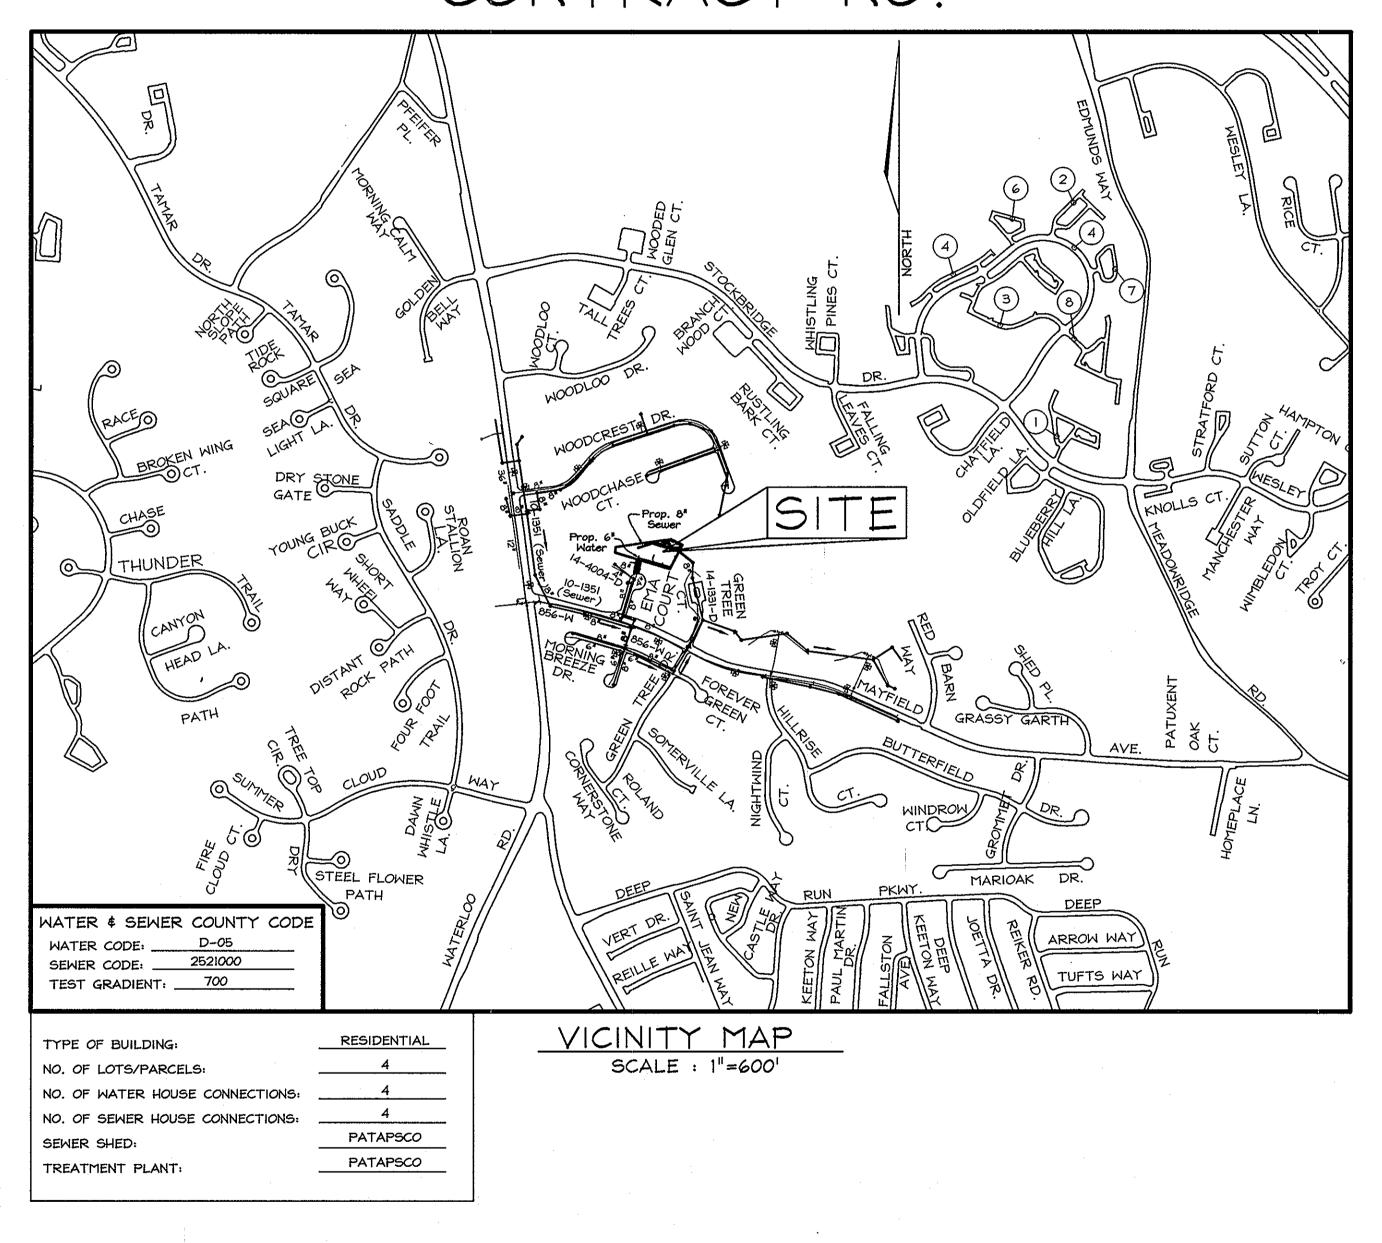

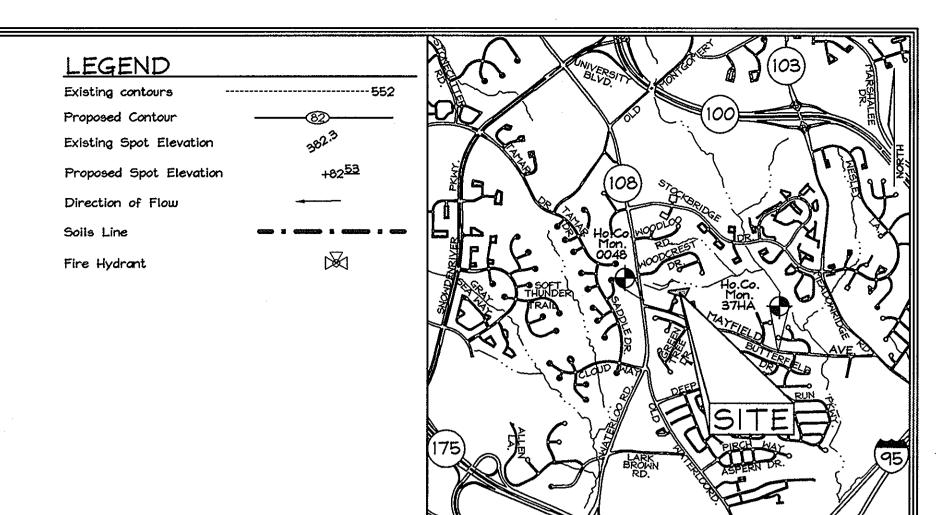

ADC 16 grid G9

BENCHMARKS

Howard County Monument 37HA

N 169,605.2003 E 418,633,2584 El.: 86,4864 (meters) N 556,446.3947 E 1,373,465.9485 Elev. 283.747 (feet)

Howard County Monument 0048

N 169,934.3700 E 417,778.6100 E1.: 106.0811 (meters) N 557,526.3456 E 1,370,661.9895 Elev. 348.034 (feet)

SHEET INDEX	
DESCRIPTION	SHEET No.
Water and Sewer Cover Sheet	1 of 2
Water and Sewer Plan and Profile Sheet	2 of 2

QUANTITIES NAME OF UTILITY CONTRACTOR SURVEY AND DRAFTING DIVISION AS-BUILT DATE : AS-BUILT QUANTITIES ITEMS ESTIMATED QUANTITIES MANUFACTURER/SUPPLIER TYPE ATLANTIC CONCRETE SEWER MANHOLES 3 Ea. 8" SEWER 3781 379 L.F PVC SDP35 JM EAGLE PIC SDP35 JM EAGLE 4" SHC 34 L.F. 280 L.F. GRIFFIN 6" WATER 50 L.F. READING/BRS I" WHC 60' TYPEK BRS 1-1/2" Drain 10 L.F. 12' TYPE K 6" CAP \$ BUTTRESS BRS 1 Ea. 1/4" HB 1 Ea. BRS BRS

SEDIMENT CONTROL MEASURES WILL BE IMPLEMENTED IN ACCORDANCE WITH SECTION 219 OF THE STANDARD SPECIFICATIONS AND WITH FINAL PLAT F-08-044

THIS DEVELOPMENT IS APPROVED FOR SOIL EROSION AND SEDIMENT CONTROL BY THE HOWARD COUNTY SOIL CONSERVATION DISTRICT.

REVIEWED FOR HOWARD COUNTY SOIL CONSERVATION DISTRICT AND MEETS DATE U.S. SOIL CONSERVATION DISTRICT

E-mail: info@fsheri.com

PROFESSIONAL CERTIFICATION hereby certify that these documents were prepared or approved by me, and that I am a duly licensed professional engineer under the laws of the State of Maryland. License No. #22418, Expiration Date: 07/29/09.

OWNER Chateau Homes, Inc. 5850 Walterloo Road Columbia, Maryland 21045 c/o Richard Azrael Tel: (410) 480-3699 DEVELOPER Azrael Glasser, Inc. 5850 Walterloo Road Columbia, Maryland 21045 c/o Richard Azrael Tel: (410) 480-3699

PARCEL 143

HOWARD COUNTY, MARYLAND

DEPARTMENT OF PUBLIC WORKS HOWARD COUNTY, MARYLAND

L CONSERVATION DISTRICT

DEPARTMENT OF PLANNING & ZONING HOWARD COUNTY, MARYLAND

DATE

FSH Associates Engineers Planners Surveyors 6339 Howard Lane, Elkridge, MD 21075 Tel:410-567-5200 Fax: 410-796-1562

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FINAL WATER AND SEWER COVER SHEET

600' SCALE MAP NO.: 37 BLOCK NO.: 14

TAX MAP 37

IST ELECTION DISTRICT

WOODCREST II


BUILDABLE LOTS 1, 3, 4 \$ 5 AND OPEN SPACE LOT 2 \$ 6


CONTRACT NO. 14-4528-D

SHOWN SHEET NO. 1 of 2

SCALE

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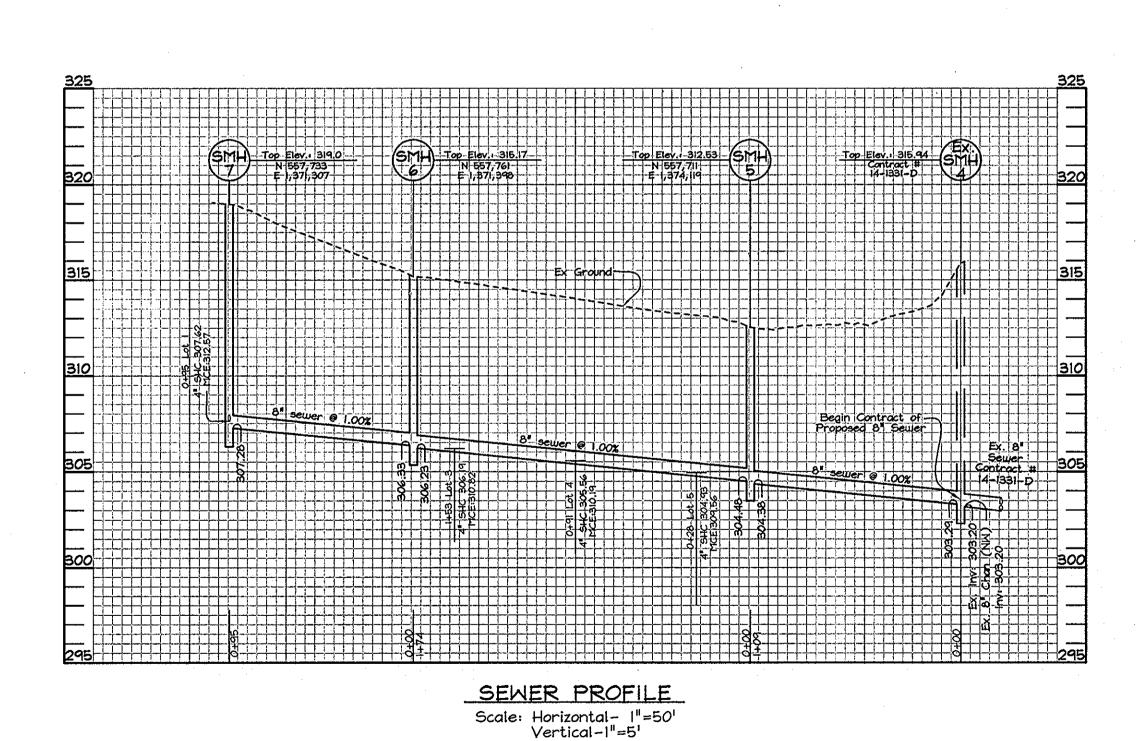


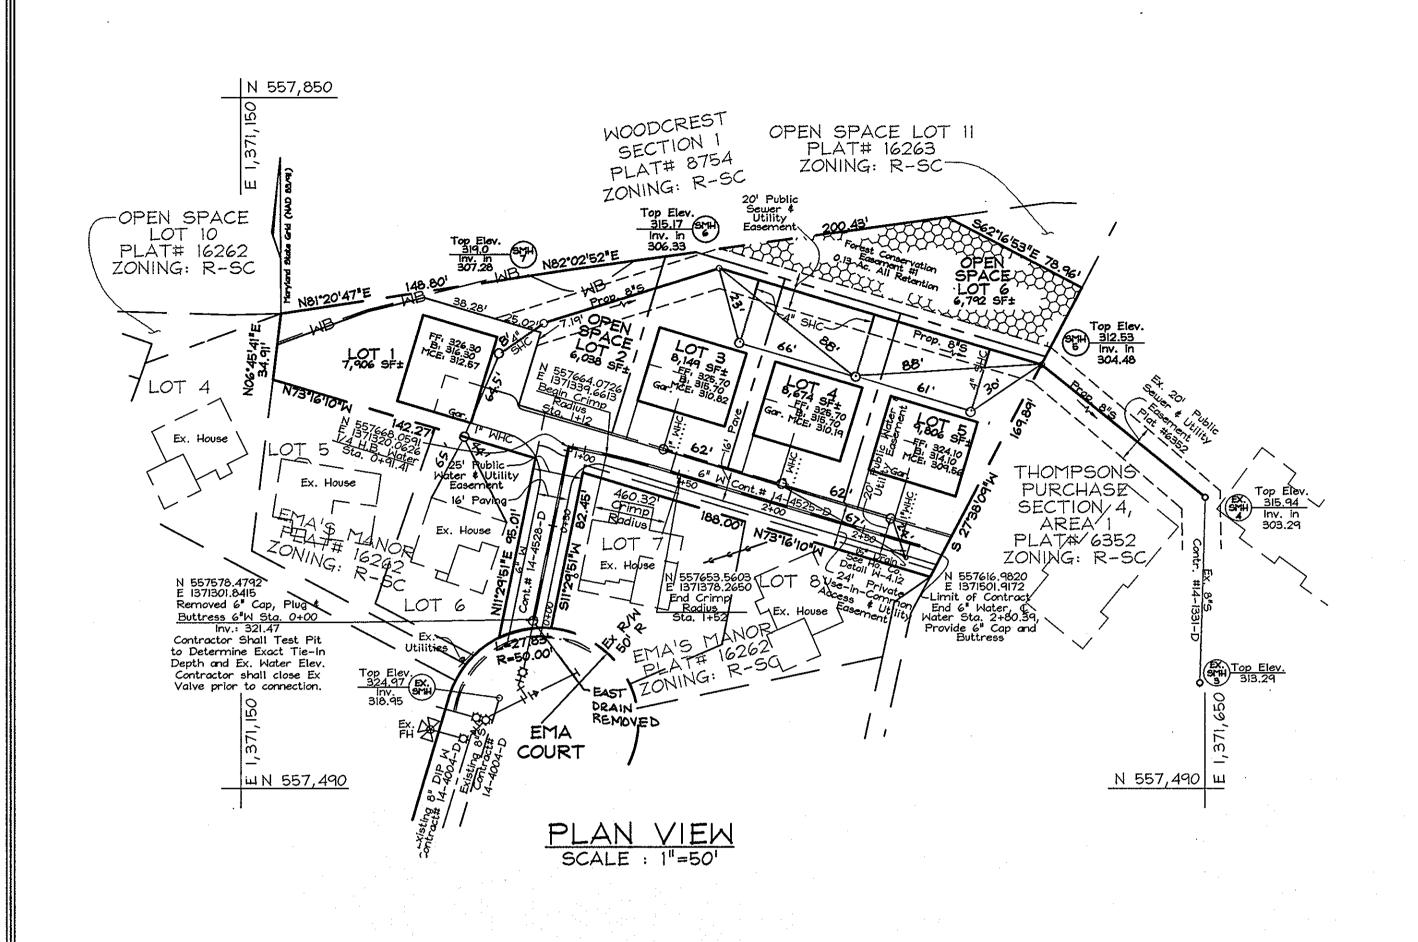

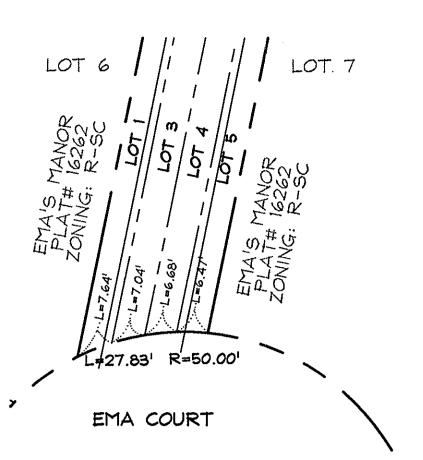FRONT FOOT DIMENSION

ENLARGEMENT DETAIL

SCALE : 1"=201



WATER PROFILE

Scale: Horizontal - 1"=50' Vertical - 1"=5'

ACTUAL CELLAR SHC Inv. @ 4" SHC Inv. @ Station CELLAR Lot No. Easement Line* 8" Sewer Main ELEVATION ELEVATION Lot 1 @ MH 7 4" SHC Inv.: 307.62 @ MH 7 FROM SMH 5 TO SMH 6 306.86 306.23 310.19 305,13 309.56 305.60

SEWER HOUSE CONNECTION CHART

* Note: All S.H.C.'s are on a 2.0% slope, from sewer main to easement line. All S.H.C.'s are on a 2.0% slope from easement line to rear B.R.L. (minimum cellar elevation), unless specified.

PROFESSIONAL CERTIFICATION I hereby certify that these documents were prepared or approved by me, and that I am a duly licensed professional engineer under the laws of the State of Maryland,

License No. #22418, Expiration Date: 07/29/09.

	SEWE	R MANHOLE	TABLE	
MH #	€ ROAD STATION ¢ € OFFSET	TOP MH ELEVATION	REMARKS	TYPE OF M.H.
- 5	N 557,711.05 E 1,371,565.42	312.53±	Yard MH	STD M.H. G-5.01
6	N 557,761.33 E 1,371,398.14	315.17±	Yard MH	STD M.H. G-5.01
7	N 557,732.78 E 1,371,307.19	319.0±	Yard MH	STD M.H. G-5.01
1				

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IST ELECTION DISTRICT

DEVELOPER Azrael Glasser, Inc. 5850 Walterloo Road Columbia, Maryland 21045 c/o Richard Azrael Tel: (410) 480-3699

DEPARTMENT OF PUBLIC WORKS HOWARD COUNTY, MARYLAND

DEPARTMENT OF PLANNING \$ ZONING HOWARD COUNTY, MARYLAND

FSH Associates
Engineers Planners Surveyors 6339 Howard Lane, Elkridge, MD 21075 Tel:410-567-5200 Fax: 410-796-1562

E-mail: info@fsheri.com

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DRAWN BY: AY					
20070 D1				•	WATER AND SEWER
CHECKED BY: ZYF				·	PLAN
	KCI	1	AS-BUILT REVISIONS	12.28.10	
DATE: Jan. 16, 2008	BY	NO.	REVISION	 DATE	600' SCALE MAP NO.: 37 BLOCK NO.:

WOODCREST II BUILDABLE LOTS 1, 3, 4 \$ 5 AND OPEN SPACE LOT 2 \$ 6

CONTRACT NO. 14-4528-D

TAX MAP 37

SHEET NO. 2 of 2 HOWARD COUNTY, MARYLAND

SCALE

AS

SHOWN

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