GENERAL NOTES

PART I

- 1. APPROXIMATE LOCATION OF EXISTING MAINS ARE SHOWN. THE CONTRACTOR SHALL TAKE ALL NECESSARY PRECAUTIONS TO PROTECT EXISTING MAINS AND SERVICES AND MAINTAIN UNINTERRUPTED SERVICE. ANY DAMAGE INCURRED SHALL BE REPAIRED IMMEDIATELY TO THE SATISFACTION OF THE ENGINEER AT THE
- 2. TOPOGRAPHIC FIELD SURVEYS WERE PERFORMED ON MAY 2001, BY POTOMAC AERIAL SURVEYS, INC...

ON CONCRETE STRUCTURES, ETC.)

- 3. HORIZONTAL AND VERTICAL SURVEY CONTROLS: THE COORDINATES SHOWN ON THE DRAWINGS ARE BASED ON MARYLAND STATE REFERENCE SYSTEM NAD '83/'91 AS PROJECTED BY HOWARD COUNTY GEODETIC CONTROL STATIONS NO. 2411, NO. 2413. ALL VERTICAL CONTROLS ARE BASED ON NAVD '88. VERTICAL CONTROL PROVIDED ON THE DRAWINGS ARE 2411 AND 2413. (ENGINEER/SURVEY FIRM SHALL. PROVIDE DESCRIPTION OF VERTICAL CONTROL POINTS, I.E., IRON BARS, CROSS CUTS
- 4. ALL PIPE ELEVATIONS SHOWN ARE INVERT ELEVATIONS UNLESS OTHERWISE NOTED.
- CLEAR ALL UTILITIES BY A MINIMUM OF 12 INCHES. CLEAR ALL POLES BY 5'-0" MINIMUM OR TUNNEL AS REQUIRED UNLESS OTHERWISE NOTED. THE OWNER HAS CONTACTED THE UTILITY COMPANIES AND HAS MADE ARRANGEMENTS FOR BRACING OF POLES AS SHOWN ON DRAWINGS. IN THE EVENT THE CONTRACTOR'S WORK REQUIRES THE BRACING OF ADDITIONAL POLES, ANY COST INCURRED BY THE OWNER FOR BRACING OF ADDITIONAL POLES OR DAMAGES SHALL BE DEDUCTED FROM MONIES OWED THE CONTRACTOR. THE CONTRACTOR SHALL COORDINATE WITH THE UTILITY COMPANIES TO SCHEDULE THE BRACING OF THE POLES.
- FOR DETAILS NOT SHOWN ON THE DRAWINGS, AND FOR MATERIALS AND CONSTRUCTION METHODS USE, HOWARD COUNTY DESIGN MANUAL, VOLUME IV, STANDARD SPECIFICATIONS AND DETAILS FOR CONSTRUCTION (LATEST EDITION). THE CONTRACTOR SHALL HAVE A COPY OF VOLUME IV ON THE JOB.
- WHERE TEST PITS HAVE BEEN MADE ON EXISTING UTILITIES, THEY ARE NOTED BY THE SYMBOL • AT THE LOCATION OF THE TEST PIT. A NOTES OR NOTES CONTAINING THE RESULTS OF THE TEST PIT OR PITS IS INCLUDED ON THE DRAWINGS. EXISTING UTILITIES IN THE VICINITY OF THE PROPOSED WORK FOR WHICH TEST PITS HAVE NOT BEEN DUG SHALL BE LOCATED BY THE CONTRACTOR TWO WEEKS IN ADVANCE OF CONSTRUCTION OPERATION
- THE CONTRACTOR SHALL NOTIFY THE FOLLOWING UTILITY COMPANIES OR AGENCIES AT LEAST FIVE WORKING DAYS BEFORE STARTING WORK SHOWN THESE PLANS: BGE (CONTRACTOR SERVICE)_ BGE (EMERGENCY)... COLONIAL PIPELINE CO ____ MISS UTILITY.... STATE HIGHWAY ADMINISTRATION_ ___410-531-5533 _1-800-743-0033/410-224-9210
- TREES AND SHRUBS ARE TO BE PROTECTED FROM DAMAGE TO THE MAXIMUM EXTENT. TREES AND SHRUBS LOCATED WITHIN THE CONSTRUCTION STRIP ARE NOT TO BE REMOVED OR DAMAGED BY THE CONTRACTOR
- 10. THE CONTRACTOR SHALL REMOVE TREES, STUMPS AND ROOTS ALONG THE LINE OF EXCAVATION. PAYMENT FOR SUCH REMOVAL SHALL BE INCLUDED IN THE UNIT PRICE BID FOR THE CONSTRUCTION OF THE MAIN.
- 11. THE CONTRACTOR SHALL NOTIFY THE BUREAU OF HIGHWAYS, HOWARD COUNTY, AT (410) 313-7450 AT LEAST FIVE WORKING DAYS BEFORE ANY OPEN CUTTING OR BORING/JACKING OF ANY COUNTY ROAD FOR LAYING WATER/SEWER MAINS OR HOUSE CONNECTIONS. THE APPROVAL OF THESE DRAWINGS WILL CONSTITUTE COMPLIANCE WITH DPW REQUIREMENTS PER SECTION 18.114(a) OF THE HOWARD COUNTY CODE.
- 12. ALL EXISTING WATER HOUSE AND SEWER HOUSE CONNECTIONS SHALL BE PROPERLY ABANDONED BY A LICENSED PROFESSIONAL.

TYPE OF BUILDING:	APARTMENT/ CONDO			
NO. OF UNITS:	135			
NO. OF WATER HOUSE CONNECTIONS:	6			
NO. OF SEWER HOUSE CONNECTIONS:	· <u> </u>			
DRAINAGE AREA:LITTL	LITTLE PATUXENT			
TREATMENT PLANT: LITTL	E PATUXENT			

SEDIMENT CONTROL MEASURES WILL BE IMPLEMENTED IN ACCORDANCE WITH SECTION 219 OF THE SPECIFICATIONS AND WITH SITE DEVELOPMENT PLAN SDP-06-005

HIS DEVELOPMENT IS APPROVED FOR SOIL EROSION AND SEDIMENT CONTROL BY THE HOWARD COUNTY SOIL CONSERVATION DISTRICT.

REVIEWED FOR HOWARD COUNTY SOIL CONSERVATION DISTRICT AND MEETS TECHNICAL REQUIREMENTS.

HOWARD COUNTY DEPARTMENT OF PUBLIC WORKS

8-21-06


PART II - WATER

- 1. ALL WATER MAINS TO BE D.I.P. CLASS 52 UNLESS OTHERWISE NOTED.
- 2. TOPS OF ALL WATER MAINS TO HAVE A MINIMUM OF 3'-6" COVER UNLESS OTHERWISE NOTED.
- 3. VALVES ADJACENT TO TEES SHALL BE STRAPPED TO TEES.
- 4. ALL FITTINGS SHALL BE BUTTRESSED OR ANCHORED WITH CONCRETE IN ACCORDANCE WITH THE STANDARD DETAILS UNLESS OTHERWISE PROVIDED
- 5. FIRE HYDRANTS SHALL BE SET TO THE BURY LINE ELEVATIONS SHOWN ON THE DRAWINGS. ALL FIRE HYDRANTS SHALL BE INSTALLED IN ACCORDANCE WITH STANDARD DETAILS. THE SOIL AROUND THE FIRE HYDRANT SHALL BE COMPACTED IN ACCORDANCE WITH SECTION 1000 AND 1005 OF THE STANDARD SPECIFICATIONS.
- 6. THE CONTRACTOR SHALL NOT OPERATE ANY WATER MAIN VALVES ON THE EXISTING WATER SYSTEM.

PART III - SEWER


- 1. ALL SEWER MAINS SHALL BE P.V.C UNLESS OTHERWISE NOTED.
- 2. ALL MANHOLES SHALL BE 4'-0" INSIDE DIAMETER UNLESS OTHERWISE NOTED.
- 3. FORCE MAINS SHALL BE D.I.P. ONLY. 4. MANHOLES SHOWN WITH 12" AND 16" WALLS ARE FOR BRICK MANHOLES ONLY.
- 5. MANHOLES DESIGNATED W.T. IN PLAN AND PROFILE SHALL HAVE WATERTIGHT FRAME AND COVER, STANDARD DETAIL G5.52. WHERE WATERTIGHT MANHOLE FRAME AND COVERS ARE USED, SET TOP OF FRAME 1'-6" ABOVE FINISHED GRADE UNLESS OTHERWISE NOTED ON THE DRAWINGS.
- 6. HOUSE(S) WITH THE SYMBOL "C.N.S." INDICATES THAT CELLAR CANNOT BE SERVED.

THE GATHERINGS AT JEFFERSON PLACE CONTRACT NO. 24-4351-D

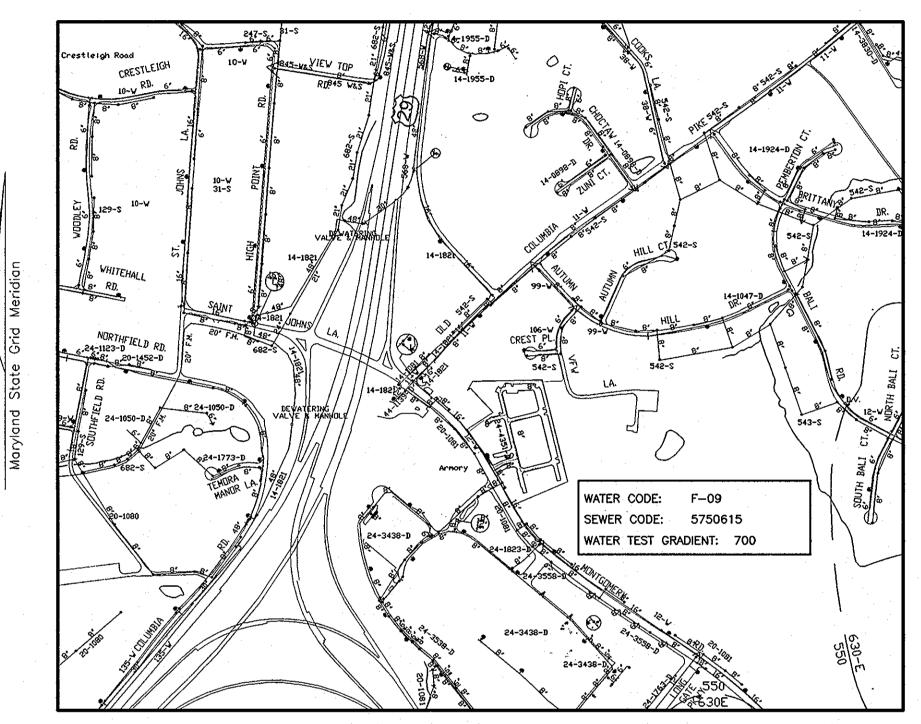

LOCATION PLAN SCALE: 1"=600'

BENCHMARKS							
NO.	NORTHING	EASTING	ELEVATION	TYPE			
2411	577298.654	1366075.133	437.80	CONC. MONUMENT			
2413	580648.904	1364974.471	404.81	CONC. MONUMENT			

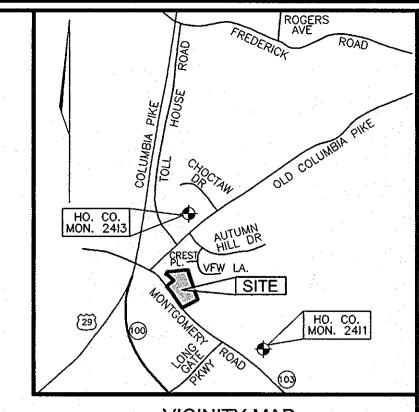

VICINITY MAP SCALE 1"= 2000'

,						
			· · · · · · · · · · · · · · · · · · ·			
	NAME OF UTILITY CONTRACTO					
	SURVEY AND DRAFTING DIVIS					
	ITEMS	QUANTITIES	AS-BU		Т	
	TIEWIS	ESTIMATED	QUANTITIES	TYPE	MANUFACTURE	R/SUPPLIER
	8" W. (DIP)	1535 LF	1540 LF		GRIFFIN PIPE	
	6" W. (DIP)	65 LF	65 LF		GRIFFIN PIPE	
	8"X6" FIREHYDRANT	3 EACH	3 EACH		KENNEDY	
	8"X6" FIREHYDRANT TEE & VALVE	3 EACH			KENNEDY	
	16"X8" TS & V	2 EACH	IEACH		FORD METER	L BOX
	8"X8" TEE	3 EACH	3 EACH		KENNEDY	
	8" VALVE	4 EACH	4 EACH		KENNEDY	
	8" CAP & BUTTRESS	2 EACH	2 EACH		HARCO	. <u>.</u>
	1/8 HB	6 EACH	GEACH		GRIFFIN	
	1/32 HB	3 EACH	3 EACH		GRIFFIN	:
	1/16 HB	1 EACH	1 EACH		GRIFFIN	· :
	8" SEWER MAIN	17 LF	17 LF		DIAMOND PL	-astics
	SEWER MANHOLES	2 EACH	2 EACH		ATLANTIC	

32 LF **32 LF**

244 LF 250 LF

DEVELOPER

BEAZER HOMES CORPORATION 8965 GUILFORD ROAD SUITE 290 COLUMBIA, MD 21046

(301) 621-8151

ROBERT H. VOGEL ENGINEERING, INC. ENGINEERS . SURVEYORS . PLANNERS 8407 MAIN STREET TEL: 410.461.7666 ELLICOTT CITY, MD 21043 FAX: 410.461.8961



	DESIGN BY: MY	·			
,	DEGICIA DI . MI				
	DRAWN BY: MY				
	CHECKED BY: RHV				
		KG	2	REVISE WHO SIZE AT CLUBHOUSE	11-04-10
3	DATE: 06.08.06		NÖ	REVISION	DATE
3	DATE: 06.08.06	BY	NO	REVISION	DA

FINAL WATER **CONSTRUCTION PLAN**

600' SCALE MAP NO. 24

6" WHC

TAX MAP 24 BLOCK NO. 24 2ND ELECTION DISTRICT BLOCK NO. 24

THE GATHERINGS AT JEFFERSON PLACE CONTRACT NO. 24-4351-D


PARCELS 318, 319, 320 & 731 HOWARD COUNTY, MARYLAND

SHOWN

1 OF 3

CAMBRIDEE LEE

FORD METER BOX

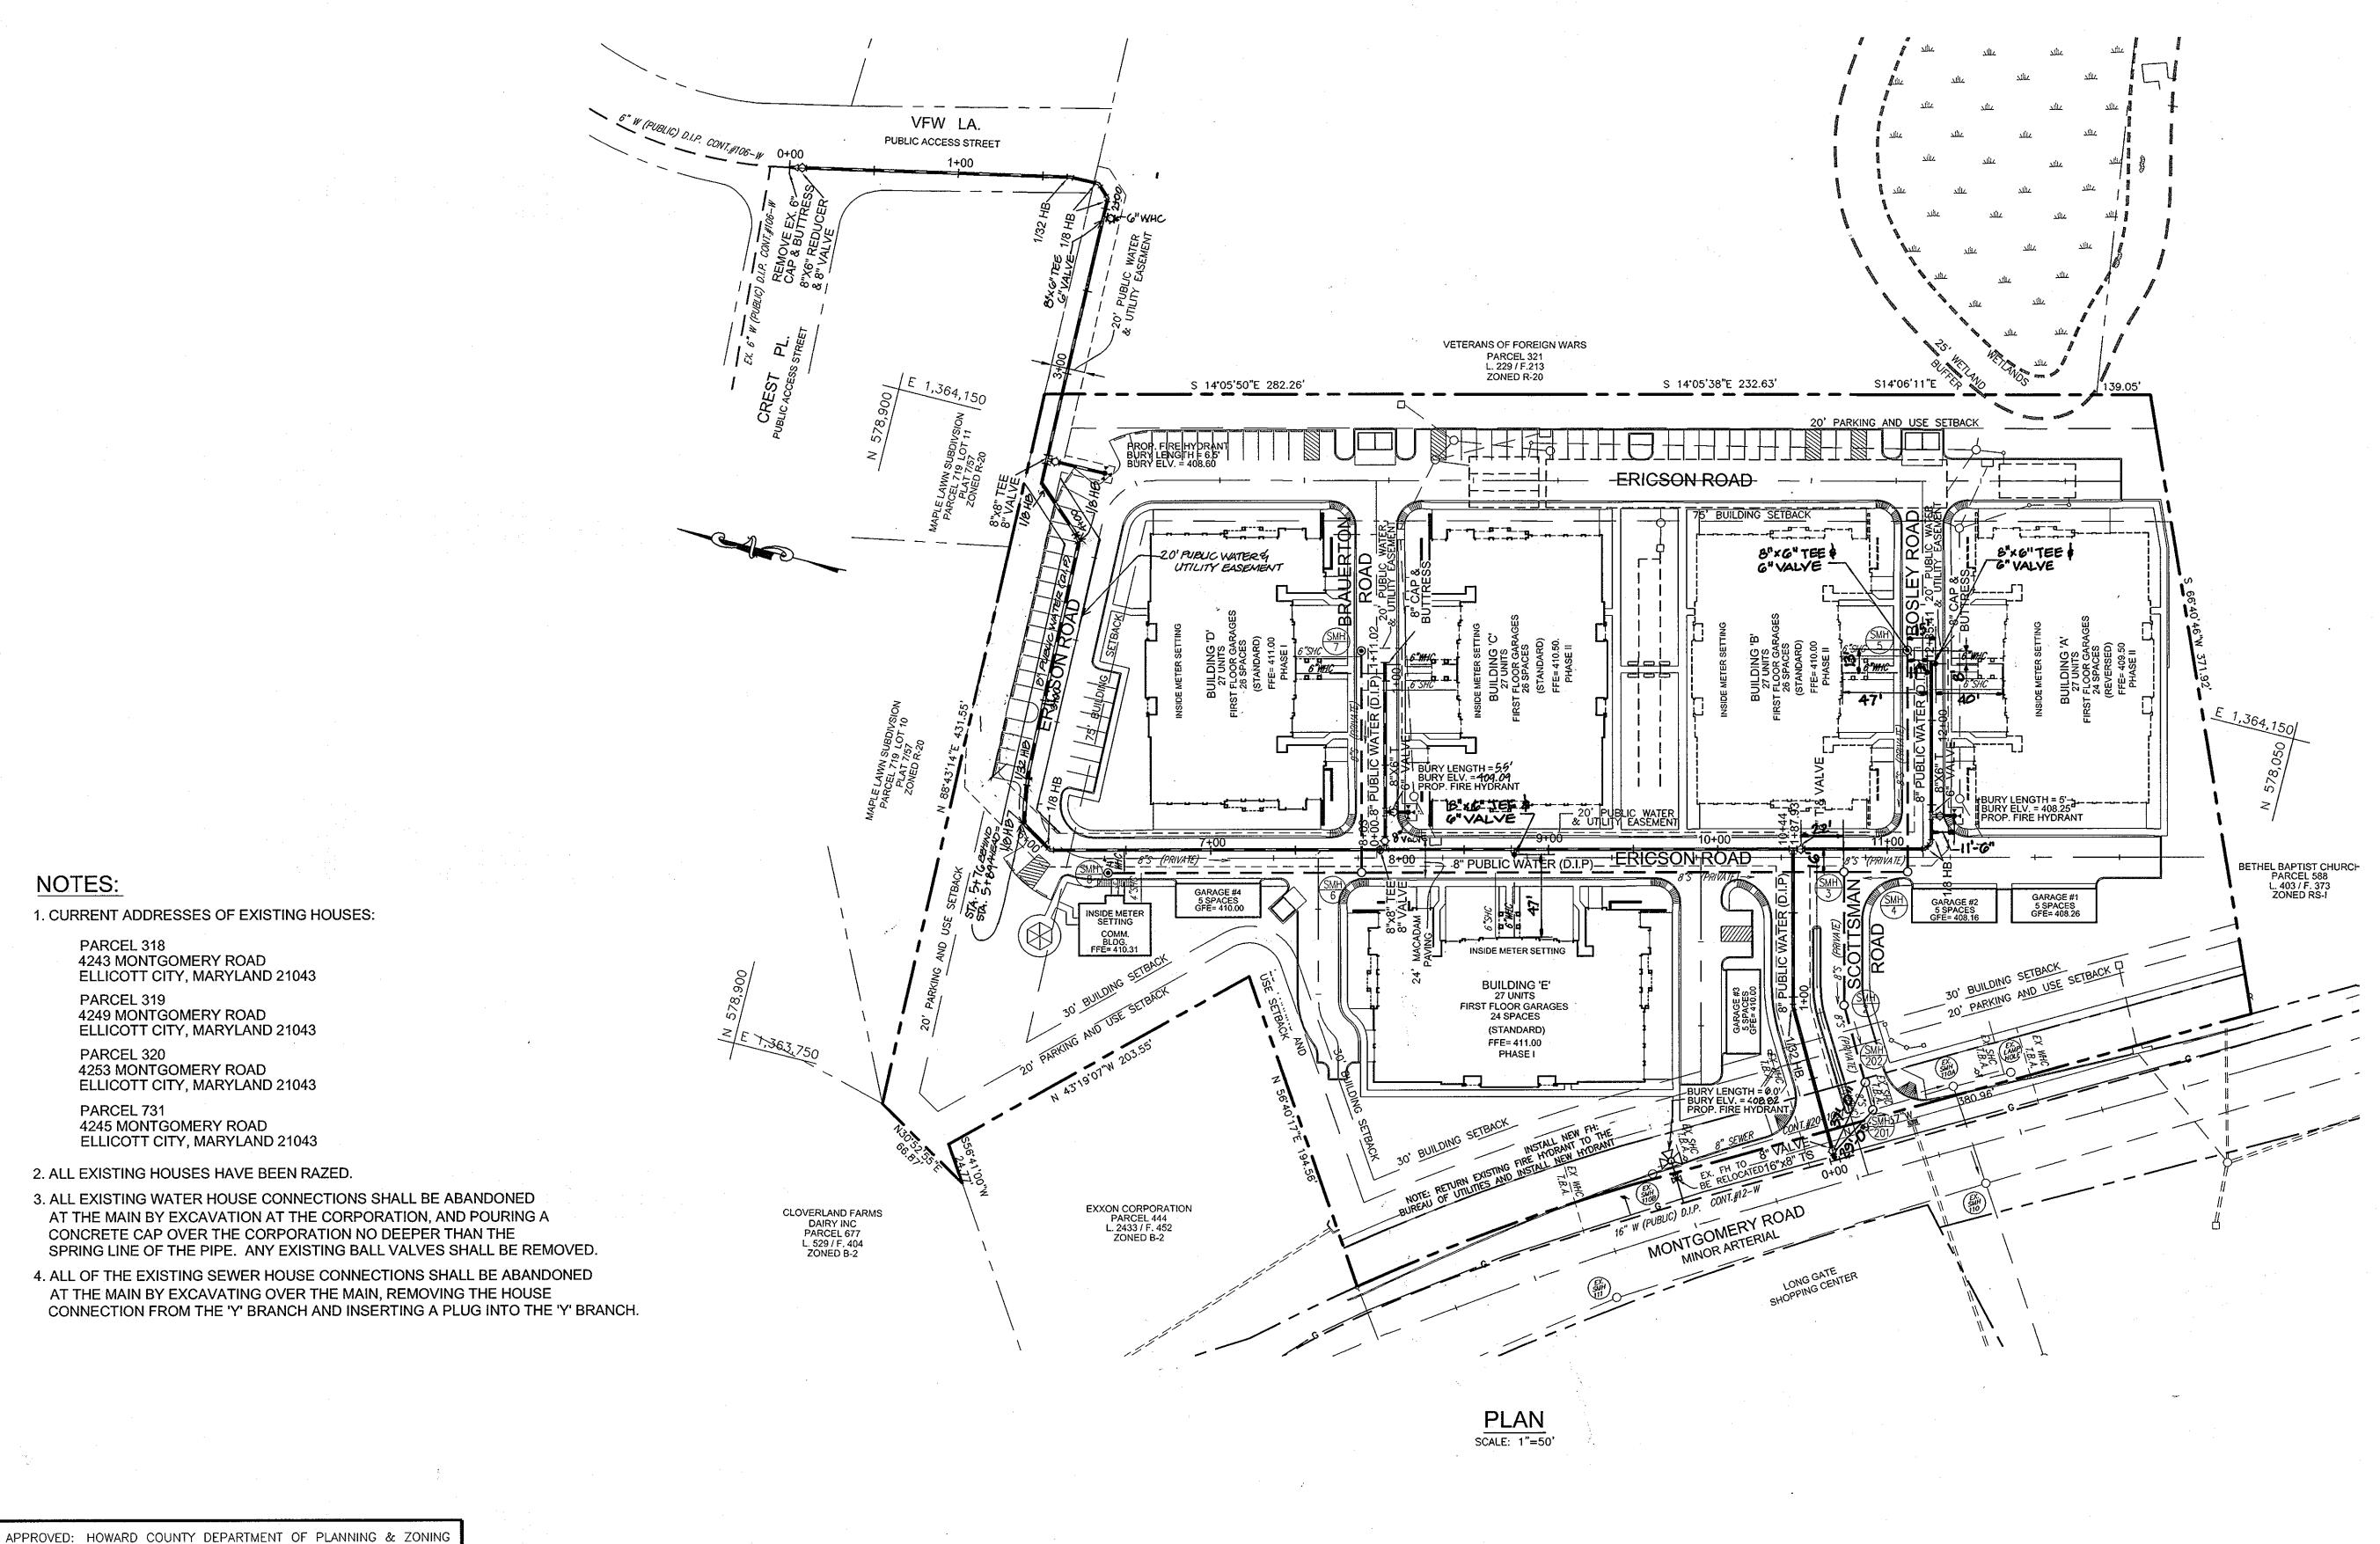



APPROVED: HOWARD COUNTY DEPARTMENT OF PUBLIC WORKS

CHIEF, BUREAU OF UTILITIES

8-1-06 DATE





oʻr	DESIGN BY: MY					
	DRAWN BY: MY					
	CHECKED BY: RHV	KG	2 ·	REVISE WHO SIZE AT CLUBHOUSE	11 _4 -10	
93	DATE: 06.08.06	i- ,	- /	REVISE LOCATION OF B'W AND RELOCATE ARE HYDRAN	T1/14/09	İ
		BY	NO	REVISION	DATE	

FINAL WATER CONSTRUCTION PLAN

BLOCK NO. 24

600' SCALE MAP NO. 24

CONTRACT NO. 24-4351-D


THE GATHERINGS AT JEFFERSON PLACE

SCALE AS SHOWN SHEET

2 OF 3

TAX MAP 24 BLOCK NO. 24 2ND ELECTION DISTRICT

PARCELS 318, 319, 320 & 731 HOWARD COUNTY, MARYLAND

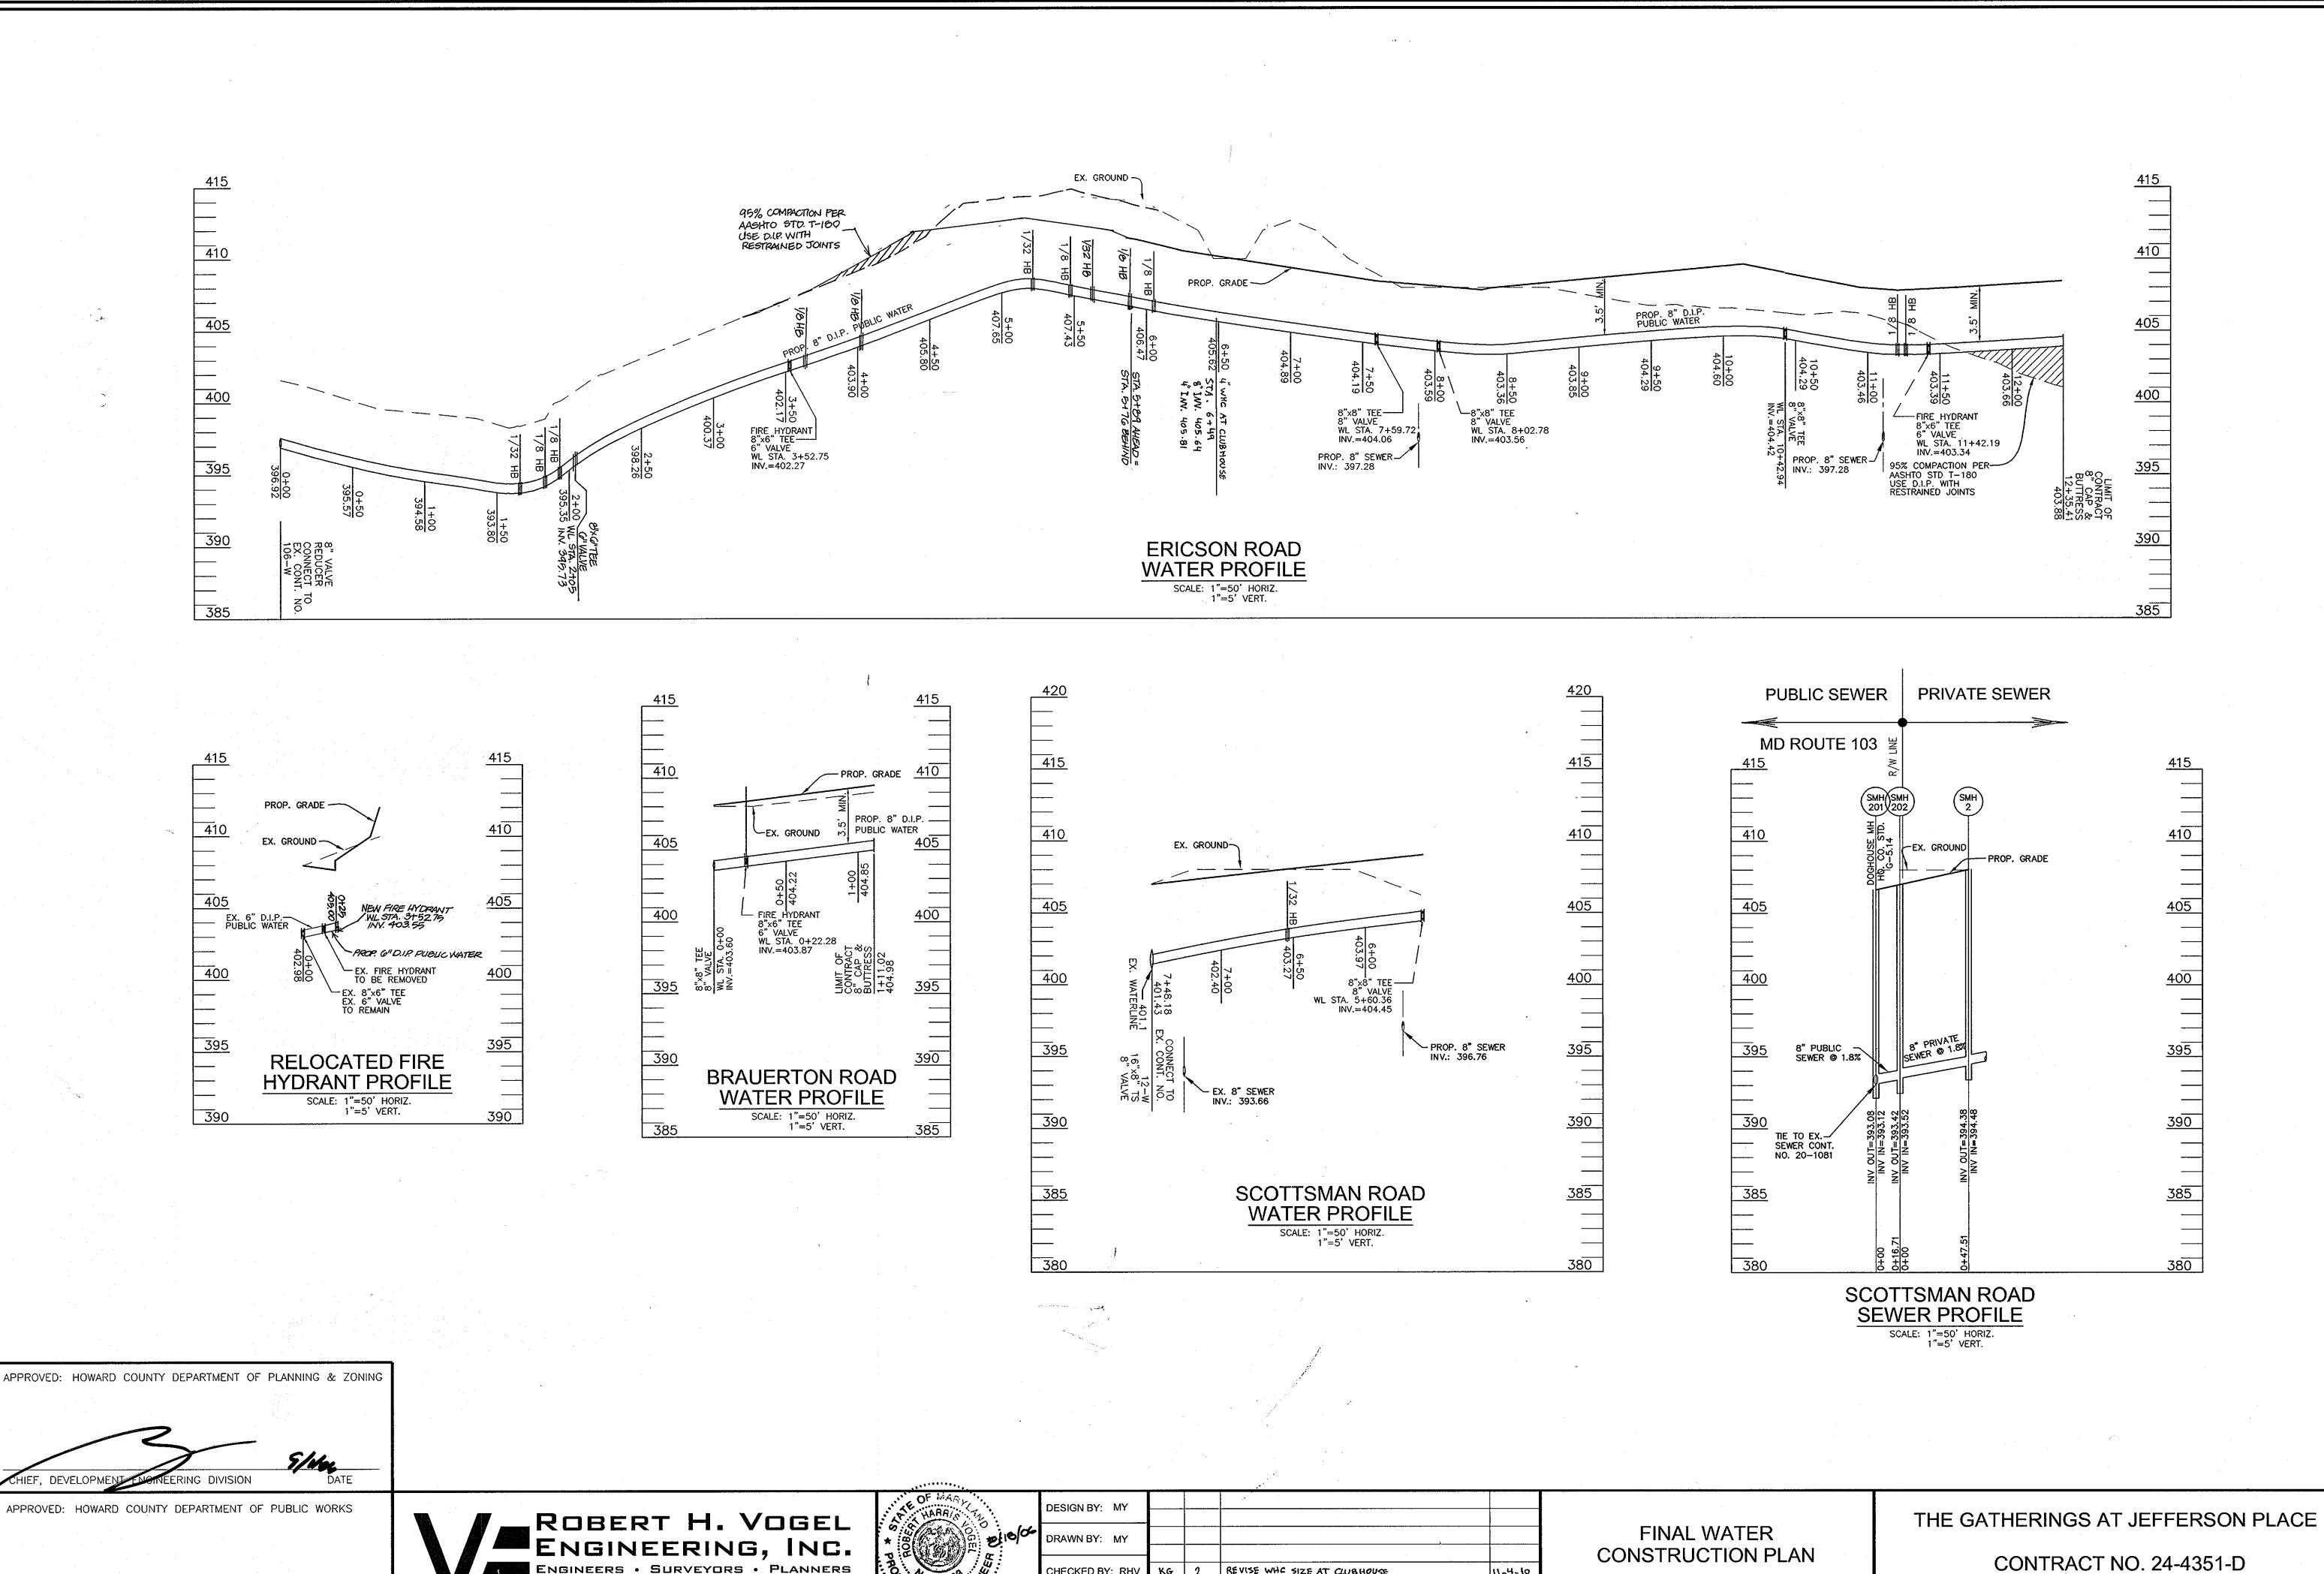

CHECKED BY: RH\

DATE: 06.08.06

KG 2 REVISE WHE SIZE AT CLUBHOUSE

BY NO

REVISE LOCATION OF 8"W AND RELOCATE FIRE HYDRANT 1/14/09

DATE 600' SCALE MAP NO. 24

ENGINEERS . SURVEYORS . PLANNERS

8407 MAIN STREET TEL: 410.461.7666 ELLICOTT CITY, MD 21043 FAX: 410.461.8961

8-21-06

DATE

SHEET PARCELS 318, 319, 320 & 731 HOWARD COUNTY, MARYLAND 3 OF 3

TAX MAP 24 BLOCK NO. 24 2ND ELECTION DISTRICT

BLOCK NO. 24

SCALE

AS

SHOWN