

BENCH MARKS NAD'83 HO. CO. #31E6 3/4" REBAR 0.5' BELOW SURFACE 5' SOUTHWEST OF ILCHESTER ROAD PAVING 500'± WEST OF WHARF LANE. N 570852.3717' E 1376700.6467' HO. CO. #31E7 3/4" REBAR 0.5' BELOW SURFACE

9' SOUTHEAST OF ILCHESTER ROAD PAVING 250'± WEST OF BEECHWOOD ROAD N 572335.3503' E 1377504.0332' HO. CO. BM#2745004 ELEV. 364.78' USED FOR VERTICAL CONTROL.

PROPERTY LINE-

WATER MAIN

BALL VALVE

TYPICAL WATER HOUSE CONNECTION

NOT TO SCALE

SHEET INDEX

QUANTITIES

QUANTITIES

SEWER HOUSE CONNECTION TABLE

INVERT AT

ROW/EASEMENT

400.47

400.84

401.11

401.59

401.86

402.39

402.21

401.19

400.87

QUANTITIES

498.9 L.F.

155 L.F.

463 L.F.

218 L.F.

6 EACH

121 L.F.

1 EACH

LEACH

INVERT AT MAIN/MH

400.28

400.65

400.92

401.40

401.67

402.15

401.80

400.78

400.46

ESTIMATED

DESCRIPTION

WATER AND SEWER PLAN AND DETAIL

SEWER AND WATER PROFILE

AS-BUILT

MANUF./SUPPLIER

REMARKS

_

_

C.N.S.

C.N.S.

C.N.S.

C.N.S.

TYPE

MCE

404.29

404.84

404.95

405.55


405.80

406.87

406.61

405.05

404.81

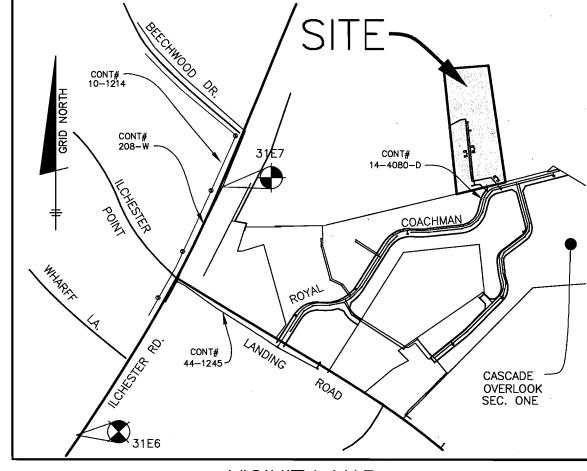

VICINITY MAP

SCALE : 1'=600'

(FOR COUNTY USE ONLY) WATER AND SEWER COUNTY CODE WATER CODE: _____ SEWER CODE: _____

TEST GRADIENT: ____

TYPE OF BUILDING:____SINGLE FAMILY DETACHED NUMBER OF LOTS:____9 BUILDABLE NUMBER OF SHC'S: NUMBER OF WHC'S:_____ DRAINAGE AREA:__ _PATAPSCO

_PATAPSCO

WASTEWATER TREATMENT PLANT

GENERAL NOTES

TREATMENT PLANT:__

PART 1 — GENERAL

APPROXIMATE LOCATION OF EXISTING MAINS ARE SHOWN. THE CONTRACTOR SHALL TAKE ALL NECESSARY PRECAUTIONS TO PROTECT EXISTING MAINS AND SERVICES AND MAINTAIN UNINTERRUPTED SUPPLY. ANY DAMAGE INCURRED SHALL BE REPAIRED IMMEDIATELY TO THE SATISFACTION OF THE ENGINEER AT THE CONTRACTOR'S EXPENSE. ALL HORIZONTAL CONTROLS ARE BASED ON MARYLAND STATE

COORDINATES. ALL VERTICAL CONTROLS ARE BASED ON U.S.G.S. DATA. ALL PIPE ELEVATIONS SHOWN ARE INVERT ELEVATIONS. CLEAR ALL UTILITIES BY A MINIMUM OF 12". CLEAR ALL POLES BY 2'-0" MINIMUM OR TUNNEL AS REQUIRED. THE OWNER HAS CONTACTED THE UTILITY COMPANIES AND HAS MADE ARRANGEMENTS FOR BRACING OF POLES AS SHOWN ON THE DRAWINGS. IN THE EVENT THE CONTRACTOR'S WORK REQUIRES THE BRACING OF ADDITIONAL POLES, ANY COST INCURRED BY THE OWNER FOR BRACING OF ADDITIONAL

POLES OR DAMAGES SHALL BE DEDUCTED FROM MONEY OWED THE CONTRACTOR. THE CONTRACTOR SHALL COORDINATE WITH THE UTILITY COMPANIES TO SCHEDULE THE BRACING OF THE POLES. FOR DETAILS NOT SHOWN ON THE DRAWINGS, AND FOR MATERIALS AND CONSTRUCTION METHODS USE HOWARD COUNTY DESIGN MANUAL VOLUME IV, STANDARD SPECIFICATIONS AND DETAIL FOR CONSTRUCTION (LATEST. EDITION). THE CONTRACTOR SHALL HAVE A COPY OF VOLUME IV ON THE

WHERE TEST PITS HAVE BEEN MADE ON EXISTING UTILITIES, THEY ARE NOTED BY THE SYMBOL AT THE LOCATION OF THE TEST PIT.

A NOTE OR NOTES CONTAINING THE RESULTS OF THE TEST PIT OR PITS IS INCLUDED ON THE DRAWINGS. EXISTING UTILITIES IN THE VICINITY OF THE PROPOSED WORK FOR WHICH TEST PITS HAVE NOT BEEN DUG SHALL BE LOCATED BY THE CONTRACTOR TWO WEEKS IN ADVANCE OF CONSTRUCTION OPERATIONS AT HIS OWN EXPENSE. CONTRACTOR SHALL NOTIFY THE FOLLOWING UTILITY COMPANIES OR AGENCIES AT LEAST FIVE WORKING DAYS BEFORE STARTING WORK SHOWN

ON THESE PLANS: STATE HIGHWAY ADMINISTRATION..... BALTIMORE GAS & ELECTRIC CO. .850-4620 CONTRACTOR SERVICES... BALTIMORE GAS & ELECTRIC CO. UNDERGROUND DAMAGE CONTROL. ..787-9068 ..1-800-257-7777 MISS UTILITY... COLONIAL PIPELINE CO. ..795–1390 HOWARD CO. DEPT. OF PUBLIC WORKS BUREAU OF UTILITIES.... .313-4900

TREES AND SHRUBS ARE TO BE PROTECTED FROM DAMAGE TO MAXIMUM EXTENT. TREES AND SHRUBS LOCATED WITHIN THE CONSTRUCTION STRIP ARE NOT TO BE REMOVED OR DAMAGED BY THE CONTRACTOR. CONTRACTOR SHALL REMOVE TREES, STUMPS AND ROOTS ALONG LINE OF EXCAVATION. PAYMENT FOR SUCH REMOVAL SHALL BE INCLUDED IN THE UNIT PRICE BID FOR CONSTRUCTION OF THE MAIN.

11. PLACE REGULATION "MEN WORKING" AND WARNING SIGNS AS REQUIRED TO COMPLY WITH MARYLAND STATE HIGHWAY ADMINISTRATION MANUAL OF TRAFFIC CONTROL FOR HIGHWAY MAINTENANCE OPERATIONS. THE CONTRACTOR SHALL NOTIFY THE BUREAU OF HIGHWAYS, HOWARD

COUNTY AT (410) 313-2450 AT LEAST FIVE WORKING DAYS BEFORE ANY OPEN CUT OF ANY COUNTY ROAD OR BORING/JACKING OPERATION IN COUNTY ROADS FOR LAYING WATER/SEWER MAINS OR HOUSE CONNECTIONS. THE APPROVAL OF THESE DRAWINGS WILL CONSTITUTE COMPLIANCE WITH DPW REQUIREMENTS PER SECTION 18.114(a) OF THE HOWARD COUNTY CODE.

PART 2 - WATER

ALL WATER MAINS TO BE D.I.P. CLASS 52 UNLESS OTHERWISE NOTED. TOPS OF ALL WATER MAINS TO HAVE A MINIMUM OF 3-1/2' COVER UNLESS OTHERWISE NOTED. VALVES ADJACENT TO TEES SHALL BE STRAPPED TO TEES.

ALL FITTINGS SHALL BE BUTTRESSED OR ANCHORED WITH CONCRETE IN ACCORDANCE WITH THE STANDARD DETAILS UNLESS OTHERWISE PROVIDED FOR ON THE DRAWINGS.

FIRE HYDRANTS SHALL BE SET TO THE BURY LINE ELEVATIONS SHOWN ON THE DRAWINGS. ALL FIRE HYDRANTS SHALL BE RESTRAINED AND BUTTRESSED WITH CONCRETE IN ACCORDANCE WITH STANDARD DETAILS. SOIL AROUND THE FIRE HYDRANT SHALL BE COMPACTED IN ACCORDANCE WITH SECTION 1000 AND 1005 OF THE STANDARD SPECIFICATIONS. THE CONTRACTOR SHALL NOT OPERATE ANY WATER MAIN VALVES ON THE

EXISTING WATER SYSTEM. ALL WATER HOUSE CONNECTIONS SHALL BE FOR INSIDE METER SETTING UNLESS OTHERWISE NOTED ON PLANS OR IN SPECIFICATIONS.

PART 3 — SEWER

ALL SEWER MAINS SHALL BE DIP OR P.V.C. UNLESS OTHERWISE NOTED. ALL MANHOLES SHALL BE 4' - 0" INSIDE DIAMETER UNLESS OTHERWISE

FORCE MAINS SHALL BE D.I.P. ONLY.

MANHOLES SHOWN WITH 12" AND 16" WALLS ARE FOR BRICK MANHOLES MANHOLES DESIGNATED W.T. IN PLAN AND PROFILE SHALL HAVE WATERTIGHT FRAME AND COVERS, STANDARD DETAIL G5.52. WHERE

DRAWINGS. HOUSE(S) WITH THE SYMBOL "C.N.S." INDICATES THAT CELLAR CANNOT BE SERVED.

WATERTIGHT MANHOLE FRAME AND COVER IS USED, SET TOP OF FRAME

" - 6" ABOVE FINISHED GRADE UNLESS OTHERWISE NOTED ON THE

WATER AND SEWER PLAN AND DETAILS

BLOCK 11


CASCADE OVERLOOK SECTION TWO


NON-BUILDABLE BULK PARCEL 'A' TAX MAP 31, GRID 11, PARCEL 259 1st. ELECTION DISTRICT, HOWARD COUNTY, MARYLAND

LOTS 1- 9 OPEN SPACE LOTS 10 -11 AND CONTRACT NO.14-4132-D AS SHOWN SHEET NO. 1 OF 2

SCALE:

\\tsa\vol1\engineer\projects\1480 WOODS PROP\dwg\7046S01ALT1.dwg, Sheet 1, 12/9/2003 6:08:43 PM, Administrator

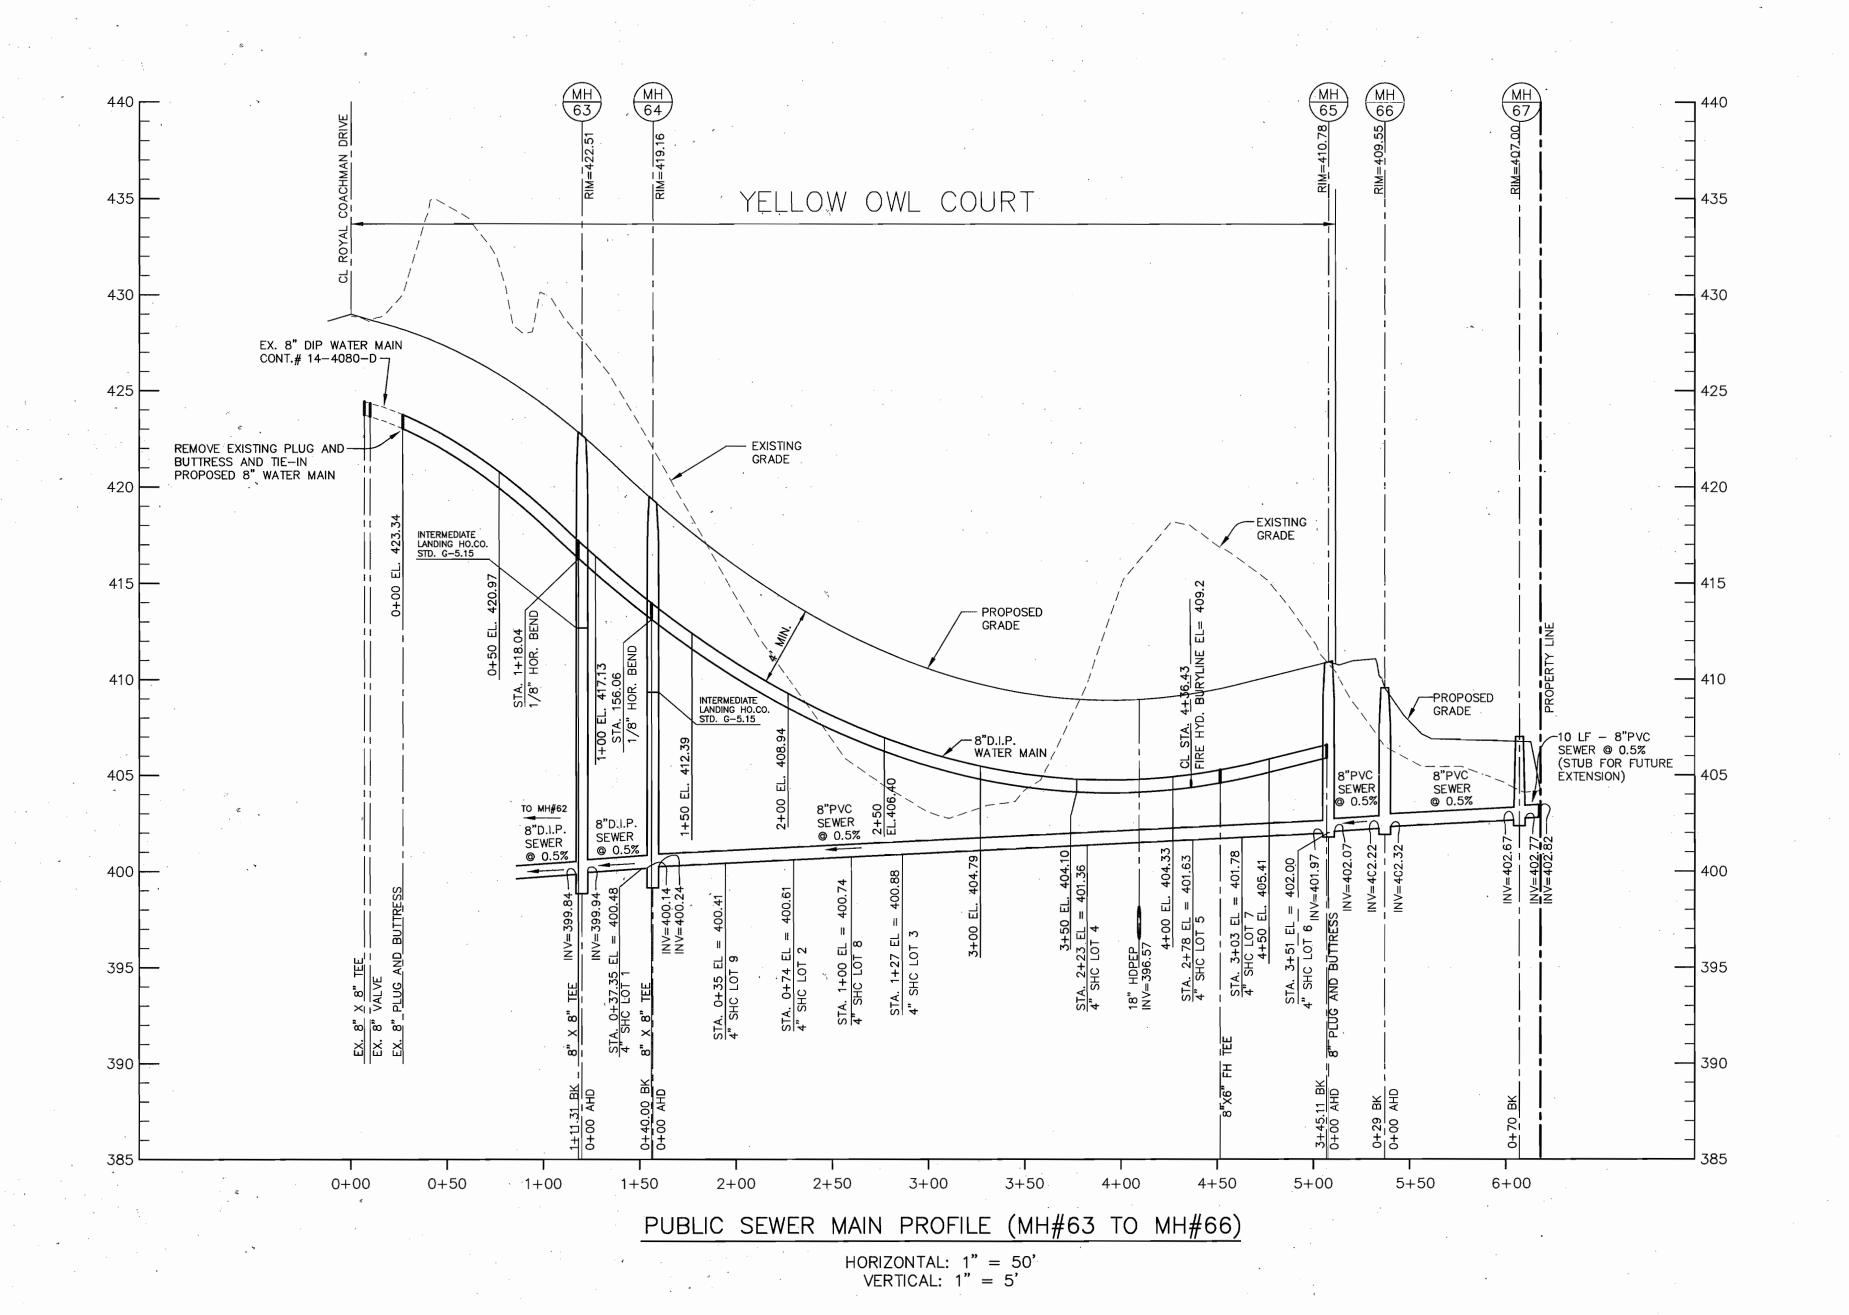

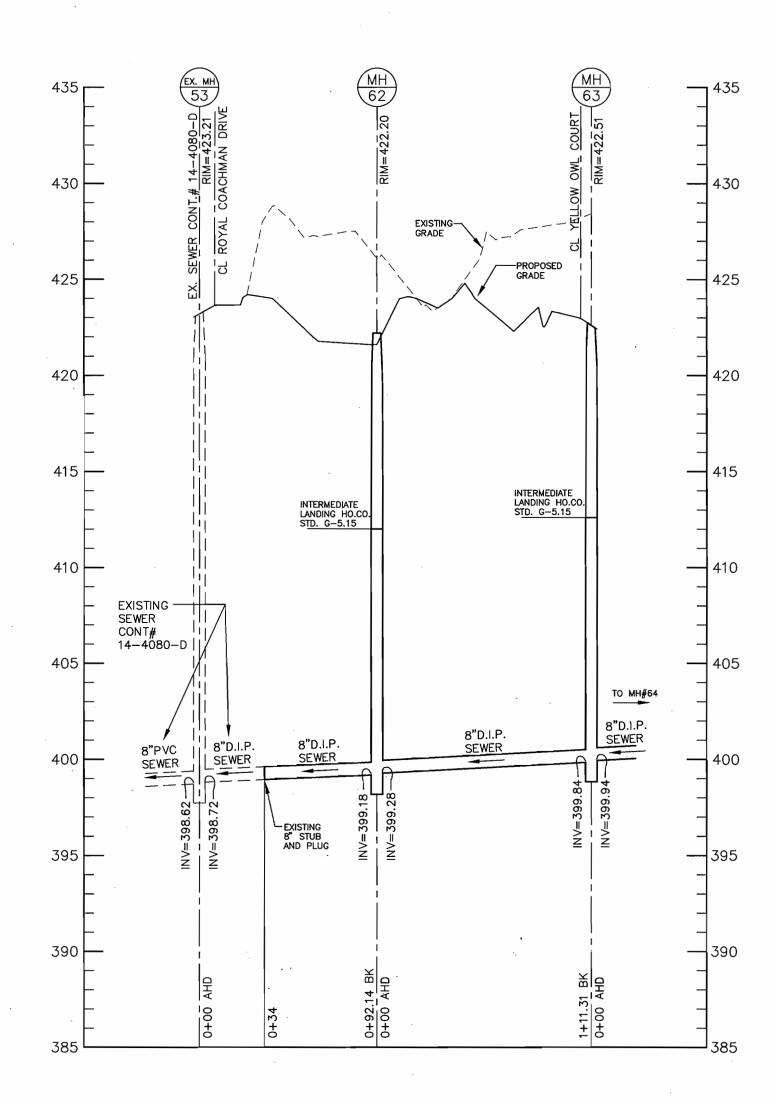

PUBLIC SEWER MAIN PROFILE (EX. MH#53 TO MH#63)

HORIZONTAL: 1" = 50'
VERTICAL: 1" = 5'

DEPARTMENT OF PUBLIC WORKS HOWARD COUNTY, MARYLAND

HIEF DEVELOPMENT ENGINEERING DIVISION DATE

DEPARTMENT OF PLANNING AND ZONING HOWARD COUNTY, MARYLAND

BENCHMARK

ENGINEERS & LAND SURVEYORS & PLANNERS

ENGINEERING, INC.

8480 BALTIMORE NATIONAL PIKE & SUITE 418



DRN: RPS

CHK: DAM

DATE: 9/03

BY NO.

WATER AND SEWER PROFILES

BLOCK 11

DATE 600 SCALE MAP No. 31

CASCADE OVERLOOK

SECTION II

A SUBDIVISION OF PARCEL 259

LOTS 1 THRUGH 9

AND OPEN SPACE LOTS 10 AND 11

TAX MAP 31, GRID 11, PARCEL 259

1st. ELECTION DISTRICT, HOWARD COUNTY, MARYLAND

SCALE:
AS SHOWN

SHEET NO.
2 OF 2

CONTRACT NO.14-4132-D

PROP\dwg\7046S02ALT1.dwg, SEWER WATER, 12/9/2003 6:39:03 PM,