

**QUANTITIES** A5-BUILT ESTIMATED QUANTITIES 8" SEWER (D.I.P.) 162.16 L.F. 4" SEWER 172 L.F. MANHOLES 2 EACH NAME OF UTILITY CONTRACTOR: SURVEY & DRAFTING DIVISION AS-BUILT DATE:


MAN	HOLE TABUI	LATION CHA	RT
NO.	NORTHING	EASTING	RIM ELEVATION
800	537594.68	834484.13	475.10
805	537401.27	Ø34501.45	478.10

SHC INVERT @ PROPERTY LINE CHART				
STATION	LOT	ELEVATION		
	EX. MH 2009 TO MH 800			
0+10 LT.	103	462.35		
0+15 RT.	108	462.30		
	MH 800 TO MH 805			
0+25 LT.	104	463.72		
0+45 LT.	107 (TYPE 'A' DHC)	467.70		
0+84 RT.	109	463.34		
@ MH Ø05 CT.	111 (DROP CONN. @MH)	471.14		
@ MH 005 RT.	110 (SHC @ MH)	463.43		
	EX. MH 204 TO EX. MH 205			
0+15 RT.	105	474.39		
@ EX. MH 205 RT.	106 (SHC @ 1.00%)	475.28		

PUBLIC SEWER & UTILITY EASEMENT

MH RIM ELEV. = 473.75 RIM ELEV. = 478.38 MH NOTE: SET RIMS OF MANHOLES 800 AND 805 FLUSH W/ EXISTING/ OR PROPOSED - EX. GROUND GRADE AS APPLICABLE 475 475 PROP. GROUND -470 470 4" TYPE 'B' DROP CONN. LOT 111 465 **4**70.00 8" 5 @ 0.72% (CL. 52 D.I.P.) | 8" 5 @ 0.50% (CL. 52 D.I.P.) TYPE 'B' - DROP CONN. CONNECT TO - EX. 8" 5 (CONT. LOT 110 461.93 NO. 24-3636-D) 462.17 463.33 455 EX. 8" 5 (5W) INV.= 455.87 450 PROFILE SCALE: HORZ. : 1" = 50" 440

## 8" SEWER MAIN EXTENSION

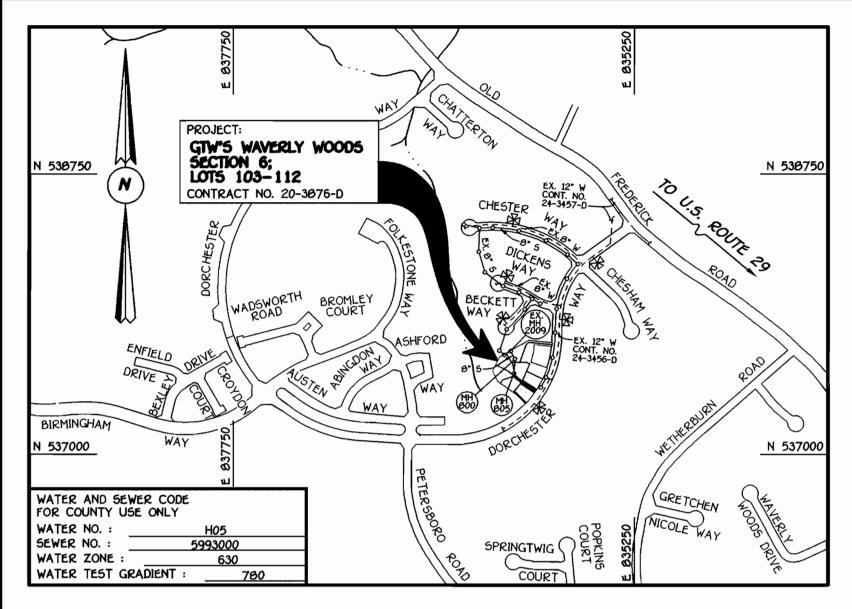

TYPE OF BUILDING : RESIDENTIAL; SINGLE FAMILY DETACHED NUMBER OF LOTS : 10 ( 9 BUILDABLE) NO. OF WATER HOUSE CONNECTIONS : NO. OF SEWER HOUSE CONNECTIONS DRAINAGE AREA : LITTLE PATUXENT TREATMENT PLANT : PATAPSCO; CITY OF BALTIMORE, VIA THE WAVERLY WASTEWATER PUMPING STATION

PLAN REFERENCE NUMBERS: 594-07, P00-18, F01-49 50P01-36

SCALE : 1" = 600'

## GENERAL NOTES

- APPROXIMATE LOCATION OF EXISTING MAINS ARE SHOWN. THE CONTRACTOR SHALL TAKE ALL NECESSARY PRECAUTIONS TO PROTECT EXISTING MAINS AND SERVICES AND MAINTAIN UNINTERRUPTED SUPPLY. ANY DAMAGE INCURRED SHALL BE REPAIRED IMMEDIATELY
- TO THE SATISFACTION OF THE ENGINEER AT THE CONTRACTOR'S EXPENSE. 2. ALL HORIZONTAL CONTROLS ARE BASED ON MARYLAND STATE COORDINATES
- ALL VERTICAL CONTROLS ARE BASED ON U.S.G.S. DATUM.
- 4. ALL PIPE ELEVATIONS ARE INVERT ELEVATIONS.
- 5. CLEAR ALL UTILITIES BY A MINIMUM OF 6". CLEAR ALL POLES BY 2'-0" MINIMUM.
- 6. FOR DETAILS NOT SHOWN ON THE DRAWINGS, AND FOR MATERIALS AND CONSTRUCTION METHODS, USE HOWARD COUNTY DESIGN MANUAL, VOLUME IV, STANDARD SPECIFICATIONS AND DETAILS FOR CONSTRUCTION (1991 AMENDMENTS) THE CONTRACTOR SHALL HAVE A COPY OF VOLUME IV ON THE JOB SITE.
- 7. WHERE TEST PITS HAVE BEEN MADE ON EXISTING UTILITIES, THEY ARE NOTED BY THE SYMBOL AT THE LOCATION OF THE TEST PIT. A NOTE OR NOTES CONTAINING THE RESULTS OF THE TEST PIT OR PITS IS INCLUDED ON THE DRAWINGS. EXISTING UTILITIES IN THE VICINITY OF THE PROPOSED WORK FOR WHICH TEST PITS HAVE NOT BEEN DUG SHALL BE VERIFIED BY THE CONTRACTOR TO HIS OWN SATISFACTION. ANY DAMAGE TO EXISTING FACILITIES DUE TO THE CONTRACTOR'S NEGLIGENCE SHALL BE REPAIRED AT THE CONTRACTOR'S EXPENSE.
- SHOWN ON THESE PLANS:

STATE HIGHWAY ADMINISTRATION - 531-5533 BALTIMORE GAS & ELECTRIC CO.. - CONTRACTOR SERVICES - 050-4620 BALTIMORE GAS & ELECTRIC CO., - UNDER GROUND DAMAGE CONTROL - 707-9060

MISS UTILITY - 1-800-257-7777 COLONIAL PIPELINE CO. - 795-1390

- BUREAU OF UTILITIES, HOWARD COUNTY DEPARTMENT OF PUBLIC WORKS 313-4900 9. TREES AND SHRUBS ARE TO BE PROTECTED FROM DAMAGE TO MAXIMUM EXTENT. TREES AND SHRUBS LOCATED WITHIN THE CONSTRUCTION STRIP ARE NOT TO BE REMOVED OR DAMAGED BY THE CONTRACTOR
- CONTRACTOR SHALL REMOVE TREES, STUMPS AND ROOTS ALONG THE LINE OF EXCAVATION. PAYMENT FOR SUCH REMOVAL SHALL BE INCLUDED IN THE UNIT PRICE BID FOR CONSTRUCTION OF THE MAIN.
- ALL SEWER MAINS SHALL BE D.I.P. OR P.V.C. UNLESS OTHERWISE NOTED.
- ALL MANHOLES SHALL BE 4'-0" INSIDE DIAMETER UNLESS OTHERWISE NOTED.
- T.B. DENOTES TEST BORING.
- MANHOLES SHOWN WITH 12" AND 16" WALLS ARE FOR BRICK MANHOLES ONLY.
- MANHOLES DESIGNATED W.T. IN PLAN AND PROFILE SHALL HAVE WATERTIGHT FRAME AND COVERS, STANDARD DETAIL G 5.52. WHERE WATERTIGHT MANHOLE FRAME AND COVER IS USED, SET TOP OF FRAME 1'-6" ABOVE FINISHED GRADE UNLESS OTHERWISE
- NOTED ON THE PLANS OR IN THE SPECIFICATIONS.
- 17. HOUSE(S) WITH THE SYMBOL "C.N.S." INDICATES THAT THE CELLAR CANNOT BE SERVED. ALL WATER HOUSE CONNECTIONS SHALL BE FOR INSIDE METER SETTING, UNLESS OTHERWISE NOTED ON THE PLANS OR IN
- 19. MANHOLES LOCATED WITHIN THE PROPOSED ROADWAY SHALL HAVE STANDARD HEAVY TRAFFIC MANHOLE FRAMES AND COVERS,
- 20. WATER MAINS AND WATER HOUSE CONNECTION LINES MUST BE PLACED AS TO HAVE ONE (1) FOOT SEPARATION FROM THE SEWER MAIN OR SEWER HOUSE CONNECTION AS THEY PASS ABOUT IT.
- ALL WATER MAINS SHALL BE D.I.P., CLASS 52 UNLESS OTHERWISE NOTED.
- 22. TOPS OF ALL WATER MAINS TO HAVE A MINIMUM OF 3-1/2' COVER UNLESS OTHERWISE NOTED.
- 23. VALVES ADJACENT TO TEES SHALL BE STRAPPED TO TEES.
- 24. ALL FITTINGS SHALL BE BUTTRESSED OR ANCHORED WITH CONCRETE IN ACCORDANCE WITH THE STANDARD DETAILS UNLESS OTHERWISE PROVIDED FOR ON THE DRAWINGS. 25. FIRE HYDRANTS SHALL BE SET TO THE BURY LINE ELEVATION SHOWN ON THE DRAWINGS. ALL FIRE HYDRANTS SHALL BE RESTRAINED AND BUTTRESSED WITH CONCRETE IN ACCORDANCE WITH THE STANDARD DETAILS (W1.11 AND W2.13). SOIL AROUND THE FIRE HYDRANT SHALL
- BE COMPACTED IN ACCORDANCE WITH SECTION 1000 AND 1005 OF THE STANDARD SPECIFICATIONS. 26. THE CONTRACTOR SHALL NOT OPERATE ANY WATER MAIN VALVES ON THE EXISTING WATER SYSTEM.
- 27. ALL D.I.P. FITTINGS SHALL BE IN ACCORDANCE WITH AWWA SPECIFICATIONS C-153; DUCTILE IRON COMPACT FITTINGS, 3-INCH THROUGH 12-INCH FOR WATER AND OTHER LIQUIDS.
- 28. THE CONTRACTOR SHALL NOTIFY THE BUREAU OF HIGHWAYS, HOWARD COUNTY, (410) 313-2450 AT LEAST FIVE WORKING DAYS BEFORE ANY OPEN CUT OF ANY COUNTY ROAD OR BORING/JACKING OPERATION IN COUNTY ROADS FOR LAYING WATER/SEWER MAINS OR HOUSE CONNECTIONS. THE APPROVAL OF THESE DRAWINGS WILL CONSTITUTE COMPLIANCE WITH DPW REQUIREMENTS PER SECTION 18.114(a) OF THE HOWARD COUNTY CODE.

CONTRACT NO. 20-3676-D GTW'S WAVERLY WOODS SECTION 6; LOTS 103 THRU 112 WATER AND SEWER MAIN EXTENSIONS HOWARD COUNTY, MARYLAND

DEPARTMENT OF PUBLIC WORKS HOWARD COUNTY, MARYLAND

SEDIMENT CONTROL MEASURES FOR THIS CONTRACT WILL BE

SPECIFICATIONS FOR SOIL EROSION AND SEDIMENT CONTROL IN

DEVELOPING AREAS AS SHOWN ON THESE PLANS AND ON THE

IMPLEMENTED IN ACCORDANCE WITH SECTION 219 OF THE HOWARD COUNTY DESIGN MANUAL & STANDARDS AND

SITE DEVELOPMENT PLAN, SDP 01-36.

DEPARTMENT OF PLANNING AND ZONING HOWARD COUNTY, MARYLAND CHIEF , DEVELOPMENT ENGINEERING DIVISION

ENGINEER'S CERTIFICATION

PERSONAL KNOWLEDGE OF THE SITE CONDITIONS AND THAT IT WAS

\* I HEREBY CERTIFY THAT THIS PLAN FOR EROSION AND SEDIMENT CONTROL REPRESENTS A PRACTICAL AND WORKABLE PLAN BASED ON MY

PREPARED IN ACCORDANCE WITH THE REQUIREMENTS OF THE HOWARD SOIL

ARE DEEMED NECESSARY.

CONSERVATION DISTRICT.

FISHER, COLLINS & CARTER, INC. CIVIL ENGINEERING CONSULTANTS & LAND SURVEYORS ELLICOTT CITY, MARYLAND 21042



DESIGNED BY

M.D.T. DRAWN BY : M.D.T. CHECKED BY P.W.K. DATE : SEPTEMBER, 2000 REVISION DATE FILE NAME: 30606/WATSEW/FINALS/30606 SECTION 6 LOTS 103-112

SEWER MAINS TITLE SHEET 600' SCALE MAP NO. \_\_\_16\_\_ BLOCK NO. \_ F.C.C. WORK ORDER NO. \_\_\_\_30606

GTW'S WAVERLY WOODS SECTION 6; LOTS 103 THRU 112 CONTRACT NO. 20-3876-D


THIRD ELECTION DISTRICT


HOWARD COUNTY, MARYLAND

**A5** SHOWN SHEET

1 of 1

**SCALE** 

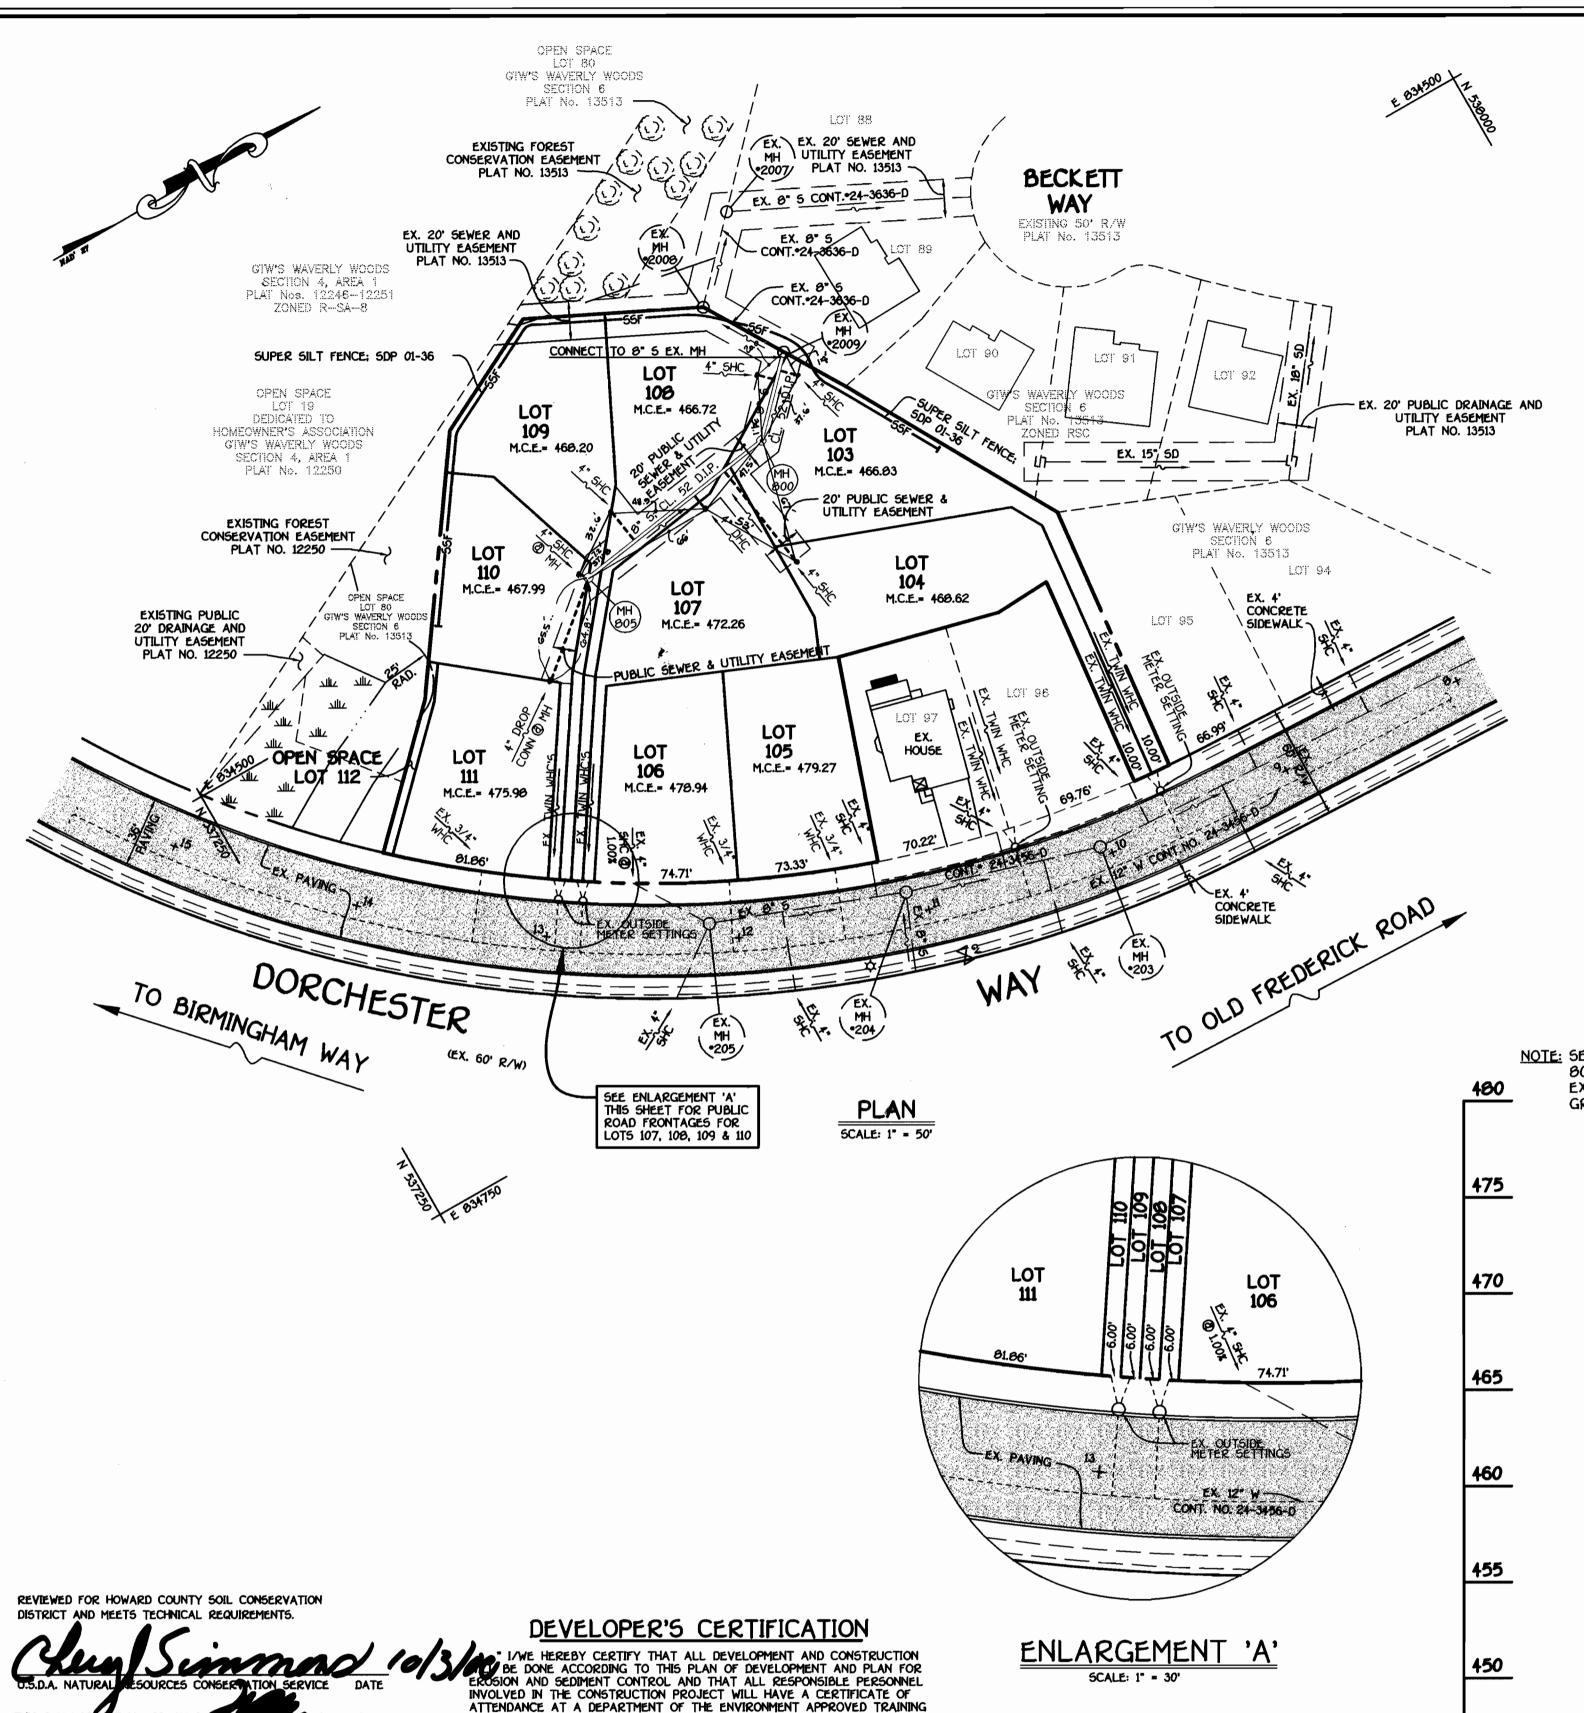

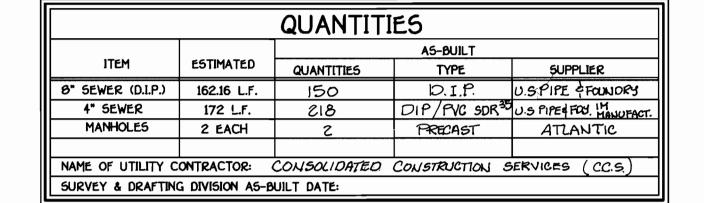


MANHOLE TABULATION CHART					
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8" SEWER MAIN EXTENSION



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WAVERLY WASTEWATER PUMPING STATION

PLAN REFERENCE NUMBERS: 594-07, P00-18, F01-49 5DP01-36

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- CONTRACTOR SHALL NOTIFY THE FOLLOWING UTILITIES OR AGENCIES AT LEAST FIVE WORKING DAYS BEFORE START SHOWN ON THESE PLANS:

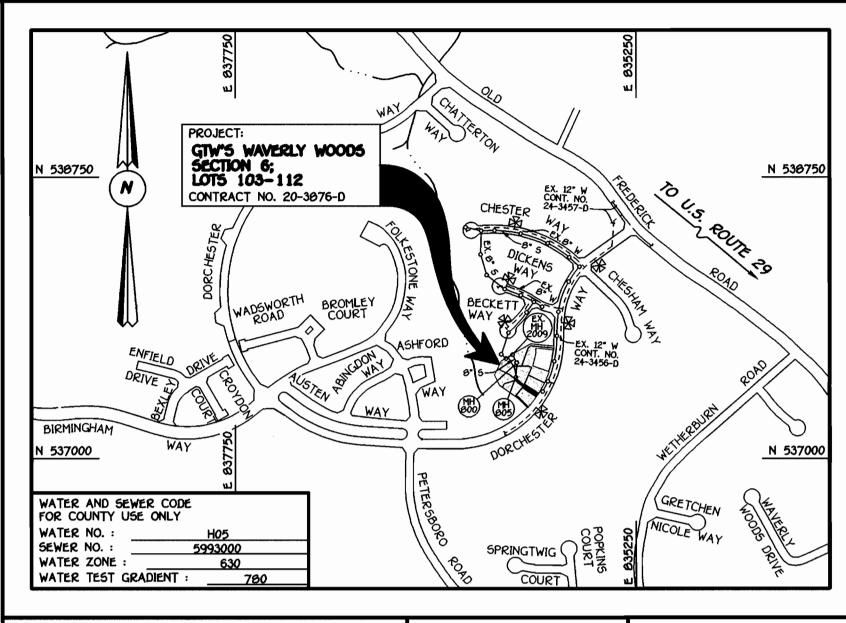STATE HIGHWAY ADMINISTRATION - 531-5533 BALTIMORE GAS & ELECTRIC CO.. - CONTRACTOR SERVICES - 050-4620 BALTIMORE GAS & ELECTRIC CO.. - UNDER GROUND DAMAGE CONTROL - 707-9060

MISS UTILITY - 1-800-257-7777 COLONIAL PIPELINE CO. - 795-1390 BUREAU OF UTILITIES, HOWARD COUNTY DEPARTMENT OF PUBLIC WORKS - 313-4900

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CONTRACT NO. 20-3076-D GTW'S WAVERLY WOODS SECTION 6; LOTS 103 THRU 112 WATER AND SEWER MAIN EXTENSIONS HOWARD COUNTY, MARYLAND

DEPARTMENT OF PUBLIC WORKS HOWARD COUNTY, MARYLAND

SEDIMENT CONTROL MEASURES FOR THIS CONTRACT WILL BE

SPECIFICATIONS FOR SOIL EROSION AND SEDIMENT CONTROL IN

DEVELOPING AREAS AS SHOWN ON THESE PLANS AND ON THE

IMPLEMENTED IN ACCORDANCE WITH SECTION 219 OF THE HOWARD COUNTY DESIGN MANUAL & STANDARDS AND

SITE DEVELOPMENT PLAN, 5DP 01-36.

SIGNATURE OF DEVELOPER

DEPARTMENT OF PLANNING AND ZONING HOWARD COUNTY, MARYLAND

CONSERVATION DISTRICT.

GNATURE OF ENGINEER

CHIEF , DEVELOPMENT ENGINEERING DIVISION

PROGRAM FOR THE CONTROL OF SEDIMENT AND EROSION BEFORE BEGINNING THE PROJECT. I ALSO AUTHORIZE PERIODIC ON-SITE INSPECTION BY THE

HOWARD SOIL CONSERVATION DISTRICT OR THEIR AUTHORIZED AGENTS, AS

ENGINEER'S CERTIFICATION

CONTROL REPRESENTS A PRACTICAL AND WORKABLE PLAN BASED ON MY PERSONAL KNOWLEDGE OF THE SITE CONDITIONS AND THAT IT WAS PREPARED IN ACCORDANCE WITH THE REQUIREMENTS OF THE HOWARD SOIL

" I HEREBY CERTIFY THAT THIS PLAN FOR EROSION AND SEDIMENT

FISHER, COLLINS & CARTER, INC.



M.D.T. DRAWN BY : M.D.T. CHECKED BY : P.W.K. ASBUILT CONDITIONS ADDED TO PLAN DATE : DATE FILE NAME : 30606/WATSEW/FINALS/30606 SECTION 6 LOTS 103-112 SEPTEMBER, 2000 REVISION

SEWER MAINS TITLE SHEET 600' SCALE MAP NO. \_\_\_\_16\_\_\_ BLOCK NO. . F.C.C. WORK ORDER NO. \_\_\_\_30686

GTW'S WAVERLY WOODS SECTION 6; LOTS 103 THRU 112 CONTRACT NO. 20-3876-D THIRD ELECTION DISTRICT

HOWARD COUNTY, MARYLAND

**SCALE** SHOWN SHEET

of 1