
# CLOVER HILL RESTORATION

WATER AND SEWER MAINS EXTENSION

CAPITAL PROJECT No N-3049
CONTRACT No 14-3777
1ST ELECTION DISTRICT
HOWARD COUNTY, MARYLAND

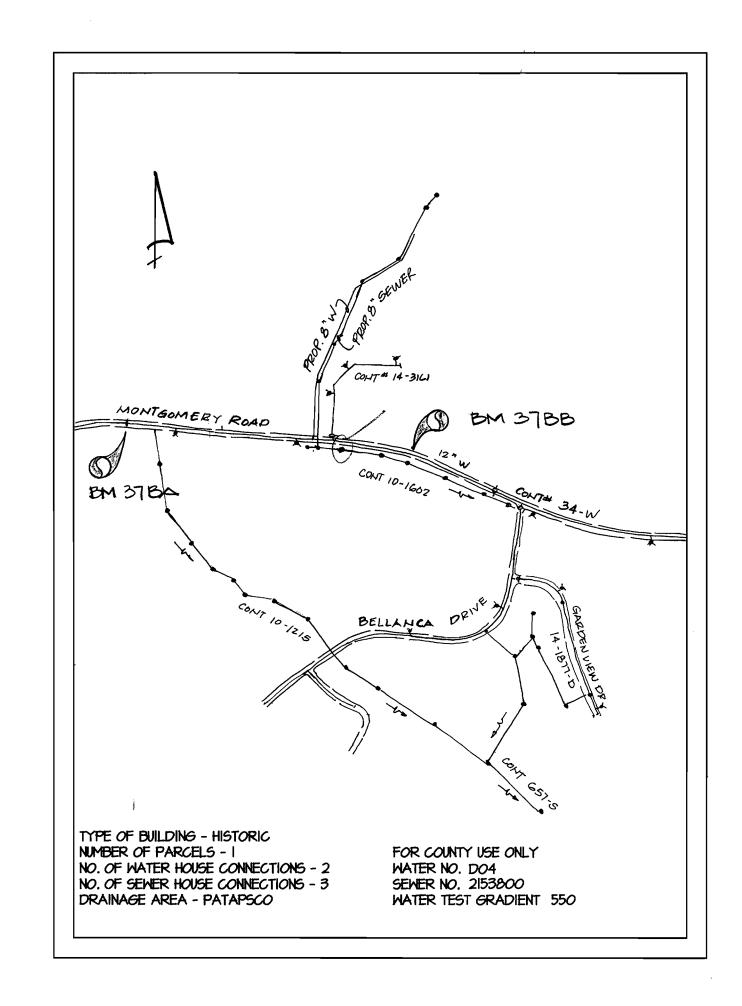

VICINITY MAP

SCALE 1" = 600'

	INDEX OF DRAWINGS	
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2	PLAN & PROFILE	
3	PLAN & PROFILE	
4	SEDIMENT CONTROL DETAILS & NOTES	

# GENERAL NOTES

#### PART I

- I. APPROXIMATE LOCATION OF EXISTING MAINS ARE SHOWN. THE CONTRACTOR SHALL TAKE ALL NECESSARY PRECAUTIONS TO PROTECT EXISTING MAINS AND SERVICES AND MAINTAIN UNINTERRUPTED SERVICE. ANY DAMAGE INCURRED SHALL BE REPAIRED IMMEDIATELY TO THE SATISFACTION OF THE ENGINEER AT THE CONTRACTOR'S EXPENSE.
- 2. ALL HORIZONTAL CONTROLS ARE BASED ON MARYLAND STATE COORDINATES.
- ALL VERTICAL CONTROLS ARE BASED ON U.S.G.S. DATUM.
   ALL PIPE ELEVATIONS SHOWN ARE INVERT ELEVATIONS UNLESS OTHERWISE NOTED ON
- THE PLANS.

  5. CLEAR ALL UTILITIES BY A MINIMUM OF 6". CLEAR ALL POLES BY 5'-O" MINIMUM OR TUNNEL AS REQUIRED. THE OWNER HAS CONTACTED THE UTILITY COMPANIES AND HAS MADE ARRANGEMENTS FOR BRACING OF POLES AS SHOWN ON THE DRAWINGS. IN THE EVENT THE CONTRACTOR'S WORK REQUIRES THE BRACING OF ADDITIONAL POLES, ANY

COST INCURRED BY THE OWNER OR DAMAGES SHALL BE DEDUCTED FROM MONEY

- OWED THE CONTRACTOR. THE CONTRACTOR SHALL COORDINATE WITH THE UTILITY COMPANIES TO SCHEDULE THE BRACING OF THE POLES.

  6. FOR DETAILS NOT SHOWN ON THE DRAWINGS, AND FOR MATERIALS AND CONSTRUCTION METHODS USE HOWARD COUNTY DESIGN MANUAL, VOLUME IV, STANDARD SPECIFICATIONS AND DETAIL FOR CONSTRUCTION (LATEST EDITION). THE
- CONTRACTOR SHALL HAVE A COPY OF VOLUME IV ON THE JOB.

  7. WHERE TEST PITS HAVE BEEN MADE ON EXISTING UTILITIES, THEY ARE NOTED BY THE SYMBOL AT THE LOCATION OF THE TEST PIT. A NOTE OR NOTES CONTAINING THE RESULTS OF THE TEST PIT OR PITS IS INCLUDED ON THE DRAWINGS. EXISTING UTILITIES IN THE VICINITY OF THE PROPOSED WORK FOR WHICH TEST PITS HAVE NOT BEEN DUG SHALL BE LOCATED BY THE CONTRACTOR TWO WEEKS IN ADVANCE OF
- CONSTRUCTION OPERATIONS AT HIS OWN EXPENSE.

  8. CONTRACTOR SHALL NOTIFY THE FOLLOWING UTILITY COMPANIES OR AGENCIES AT LEAST FIVE (5) WORKING DAYS BEFORE STARTING WORK SHOWN ON THESE PLANS:

AT & T 410-865-3803 BG & E CO. (CONTRACTOR SERVICES) 410-850-4620 BG & E CO.-UNDERGROUND DAMAGE CONTROL 410-787-9068 BUREAU OF UTILITIES (DPW) 410-313-4900 BELL ATLANTIC - MARYLAND 410-597-8585 COLONIAL PIPELINE CO. 410-795-1390 MISS UTILITY (800) 251-7177 STATE HIGHWAY ADMINISTRATION 410-531-5533

- 4. TREES AND SHRUBS ARE TO BE PROTECTED FROM DAMAGE TO THE MAXIMUM EXTENT. TREES AND SHRUBS LOCATED WITHIN THE CONSTRUCTION STRIP ARE NOT TO BE REMOVED OR DAMAGED BY THE CONTRACTOR.
- IO. CONTRACTOR SHALL REMOVE TREES, STUMPS AND ROOTS ALONG LINE OF EXCAVATION. PAYMENT FOR SUCH REMOVAL SHALL BE INCLUDED IN THE UNIT PRICE BID FOR CONSTRUCTION OF THE MAIN.
- II. THE CONTRACTOR SHALL NOTIFY THE BUREAU OF HIGHWAYS, HOWARD COUNTY AT (410) 313-7450 AT LEAST FIVE (5) WORKING DAYS BEFORE ANY OPEN CUT OF ANY COUNTY ROAD OR BORING/JACKING OPERATION IN COUNTY ROADS FOR LAYING WATER/SEWER MAINS OR HOUSE CONNECTIONS. THE APPROVAL OF THESE DRAWINGS WILL CONSTITUTE COMPLIANCE WITH DPW REQUIREMENTS PER SECTION 18.114(a) OF THE HOWARD COUNTY CODE.

# <u>Part II water</u>

- ALL WATER MAINS SHALL BE D.I.P. CLASS 52 UNLESS OTHERWISE NOTED.
   TOPS OF ALL WATER MAINS TO HAVE A MINIMUM OF 3'-6" COVER UNLESS OTHERWISE NOTED.
- VALVES ADJACENT TO TEES SHALL BE STRAPPED TO TEES.
   ALL FITTINGS SHALL BE BUTTRESSED OR ANCHORED WITH CONCRETE IN ACCORDANCE WITH THE STANDARD DETAILS UNLESS OTHERWISE
- 5. FIRE HYDRANTS SHALL BE SET TO THE BURY LINE ELEVATIONS SHOWN ON THE DRAWINGS. ALL FIRE HYDRANTS SHALL BE RESTRAINED AND BUTTRESSED WITH CONCRETE IN ACCORDANCE WITH THE STANDARD DETAILS. SOIL AROUND THE FIRE HYDRANT SHALL LIBE COMPACTED IN ACCORDANCE WITH SECTION 1000 AND SECTION 1005 OF THE STANDARD SPECIFICATIONS.
- 6. THE CONTRACTOR SHALL NOT OPERATE ANY WATER MAIN VALVES ON THE EXISTING WATER SYSTEM.
- 7. ALL WATER HOUSE CONNECTIONS SHALL BE FOR INSIDE METER SETTING UNLESS OTHERWISE NOTED ON PLANS OR IN SPECIFICATIONS.

# PART III SEWER

- I. ALL SEWER MAINS SHALL BE P.V.C. OR D.I.P CLASS 52 UNLESS OTHERWISE
- 2. ALL MANHOLES SHALL BE 4'-O" INSIDE DIAMETER UNLESS OTHERWISE
- NOTED.

  3. FORCE MAINS SHALL BE D.I.P. ONLY.

PROVIDED FOR ON THE DRAWINGS.

- 4. MANHOLES DESIGNATED W.T. IN PLAN AND PROFILE SHALL HAVE WATERTIGHT FRAME AND COVER. STANDARD DETAIL 65.52. WHERE WATERTIGHT MANHOLE FRAME AND COVER ARE USED, SET TOP OF FRAME I'-6" ABOVE FINISHED GRADE UNLESS OTHERWISE NOTED ON THE DRAWINGS.
- HOUSE(S) WITH THE SYMBOL "C.N.S." INDICATES THAT CELLAR CANNOT BE SERVED.
- 6. ALL SEWER TRENCH BEDDING SHALL BE IN ACCORDANCE WITH STANDARD DETAIL 62.01 "TRENCH FOR PVC PIPE AND HDPE PIPE".

PLAN REFERANCE NUMBER

DEPARTMENT OF PUBLIC WORKS
HOWARD COUNTY MARYLAND

WARD COUNTY MARYLAND

| Iz | 17 | 99
| CHIEF, BUREAU OF UTILITIES DATE

| CHIEF, UTILITY DESIGN DIVISION IN DATE

· DATE

PB\* 10234

QUANTITIES

ESTIMATED

1420 L.F.

55 L.F.

95.LF.

5 L.F.

1758 L.F.

33 L.F.

IO L.F.

94 V.F.

BENCHMARKS

NORTHING

563785.632

563663.428

SEDIMENT CONTROL SHALL BE IMPLEMENTED IN ACCORDANCE WITH SECTION 219 OF THE STANDARDS AND SPECIFICATIONS

EASTING

1376343.279

1378040.570 373.811

**ELEVATION** 

394.753

ITEM

8" 1/16 HOR. BEND & BUTTRESS

8" 1/32 HOR, BEND & BUTTRESS

6" DIP FIRE HYDRANT LEAD

4" METER & VAULT - ST'D. DETAIL W3.36

AIR RELEASE VALVE & VAULT

NAME OF UTILITY CONTRACTOR:

SURVEY & DRAFTING DIVISION AS-BUILT DATE:

DESCRIPTION

DEVELOPER'S CERTIFICATION

I CERTIFY THAT ALL DEVELOPMENT AND CONSTRUCTION

PERSONNEL INVOLVED IN THE CONSTRUCTION PROJECT WILL

HAVE A CERTIFICATE OF ATTENDANCE AT THE DEPARTMENT OF

NATURAL RESOURCES APPROVED TRAINING PROGRAM FOR THE

CONTROL OF ANY SEDIMENT EROSION BEFORE BEGINNING THE

PROJECT. I ALSO AUTHORIZE PERIODIC ON-SITE INSPECTION

ENGINEER'S CERTIFICATION

I CERTIFY THAT THIS PLAN FOR EROSION AND SEDIMENT

BASED ON MY PERSONAL KNOWLEDGE OF THE CONDITIONS AND THAT IT WAS PREPARED IN ACCORDANCE WITH THE REQUIRE—

CONTROL REPRESENTS A PRACTICAL AND WORKABLE PLAN

MENTS OF THE HOWARD SOIL CONSERVATION DISTRICT.

REVIEWED FOR HOWARD SOIL CONSERVATION DISTRICT AND MEETS

THIS DEVELOPMENT PLAN IS APPROVED FOR SOIL EROSION AND

BY THE HOWARD SOLL CONSERVATION DISTRICT.

Fonald G. Lapson

Dutoe End

Buston English,

ENGINEER'S SIGNATURE

ENGINEER'S NAME

DEVELOPER'S NAME

WILL BE DONE ACCORDING TO THIS PLAN AND ANY RESPONSIBLE

ST'D SURVEY CONTROL

(VOL IV) OF THE HOWARD COUNTY COUNTY DESIGN MANUAL AND THESE PLANS

8" DIP WATER

12" x 8" TS\$∨

8" × 6" F.H. TEE

FIRE HYDRANT

2" WHC

4" W.H.C.

4" VALVE

54" VALVE BOX

4" CAP & BUTTRESS

STANDARD MANHOLE

8" PVC SEWER

4" S.H.C.

6" S.H.C.

TRAVERSE No

31BB

6" VALVE

AS-BUILT

TYPE

SUPPLIER

QUANTITY

FAIRRAND & ENGLISH, INC 416 Lynan avenue Baltinore, nakyland 21212

> 41**0-455-5400** PAX 41**0-455-9209**



DESIGN				
A.R./B.E.				
CHECKED				
		· · · · · · · · · · · · · · · · · · ·		
DATE				
25 AUG 1999	BY	No	REVISION	DATE
	A.R  DRAWN A.R./B.E.  CHECKED B.E.  PROJECT 93-28  DATE	A.R  DRAWN  A.R./B.E.  CHECKED  B.E.  PROJECT  93-28  DATE	A.R  DRAWN  A.R./B.E.  CHECKED  B.E.  PROJECT  93-28  DATE	A.R  DRAWN  A.R./B.E.  CHECKED  B.E.  PROJECT  93-28  DATE

TITLE SHEET & GENERAL NOTES

600' SCALE MAP No \_\_\_\_37\_\_


BLOCK No 3


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CONTRACT No 14-3777
1ST ELECTION DISTRICT
HOWARD COUNTY, MARYLAND

l OF 4

AS SHOWN



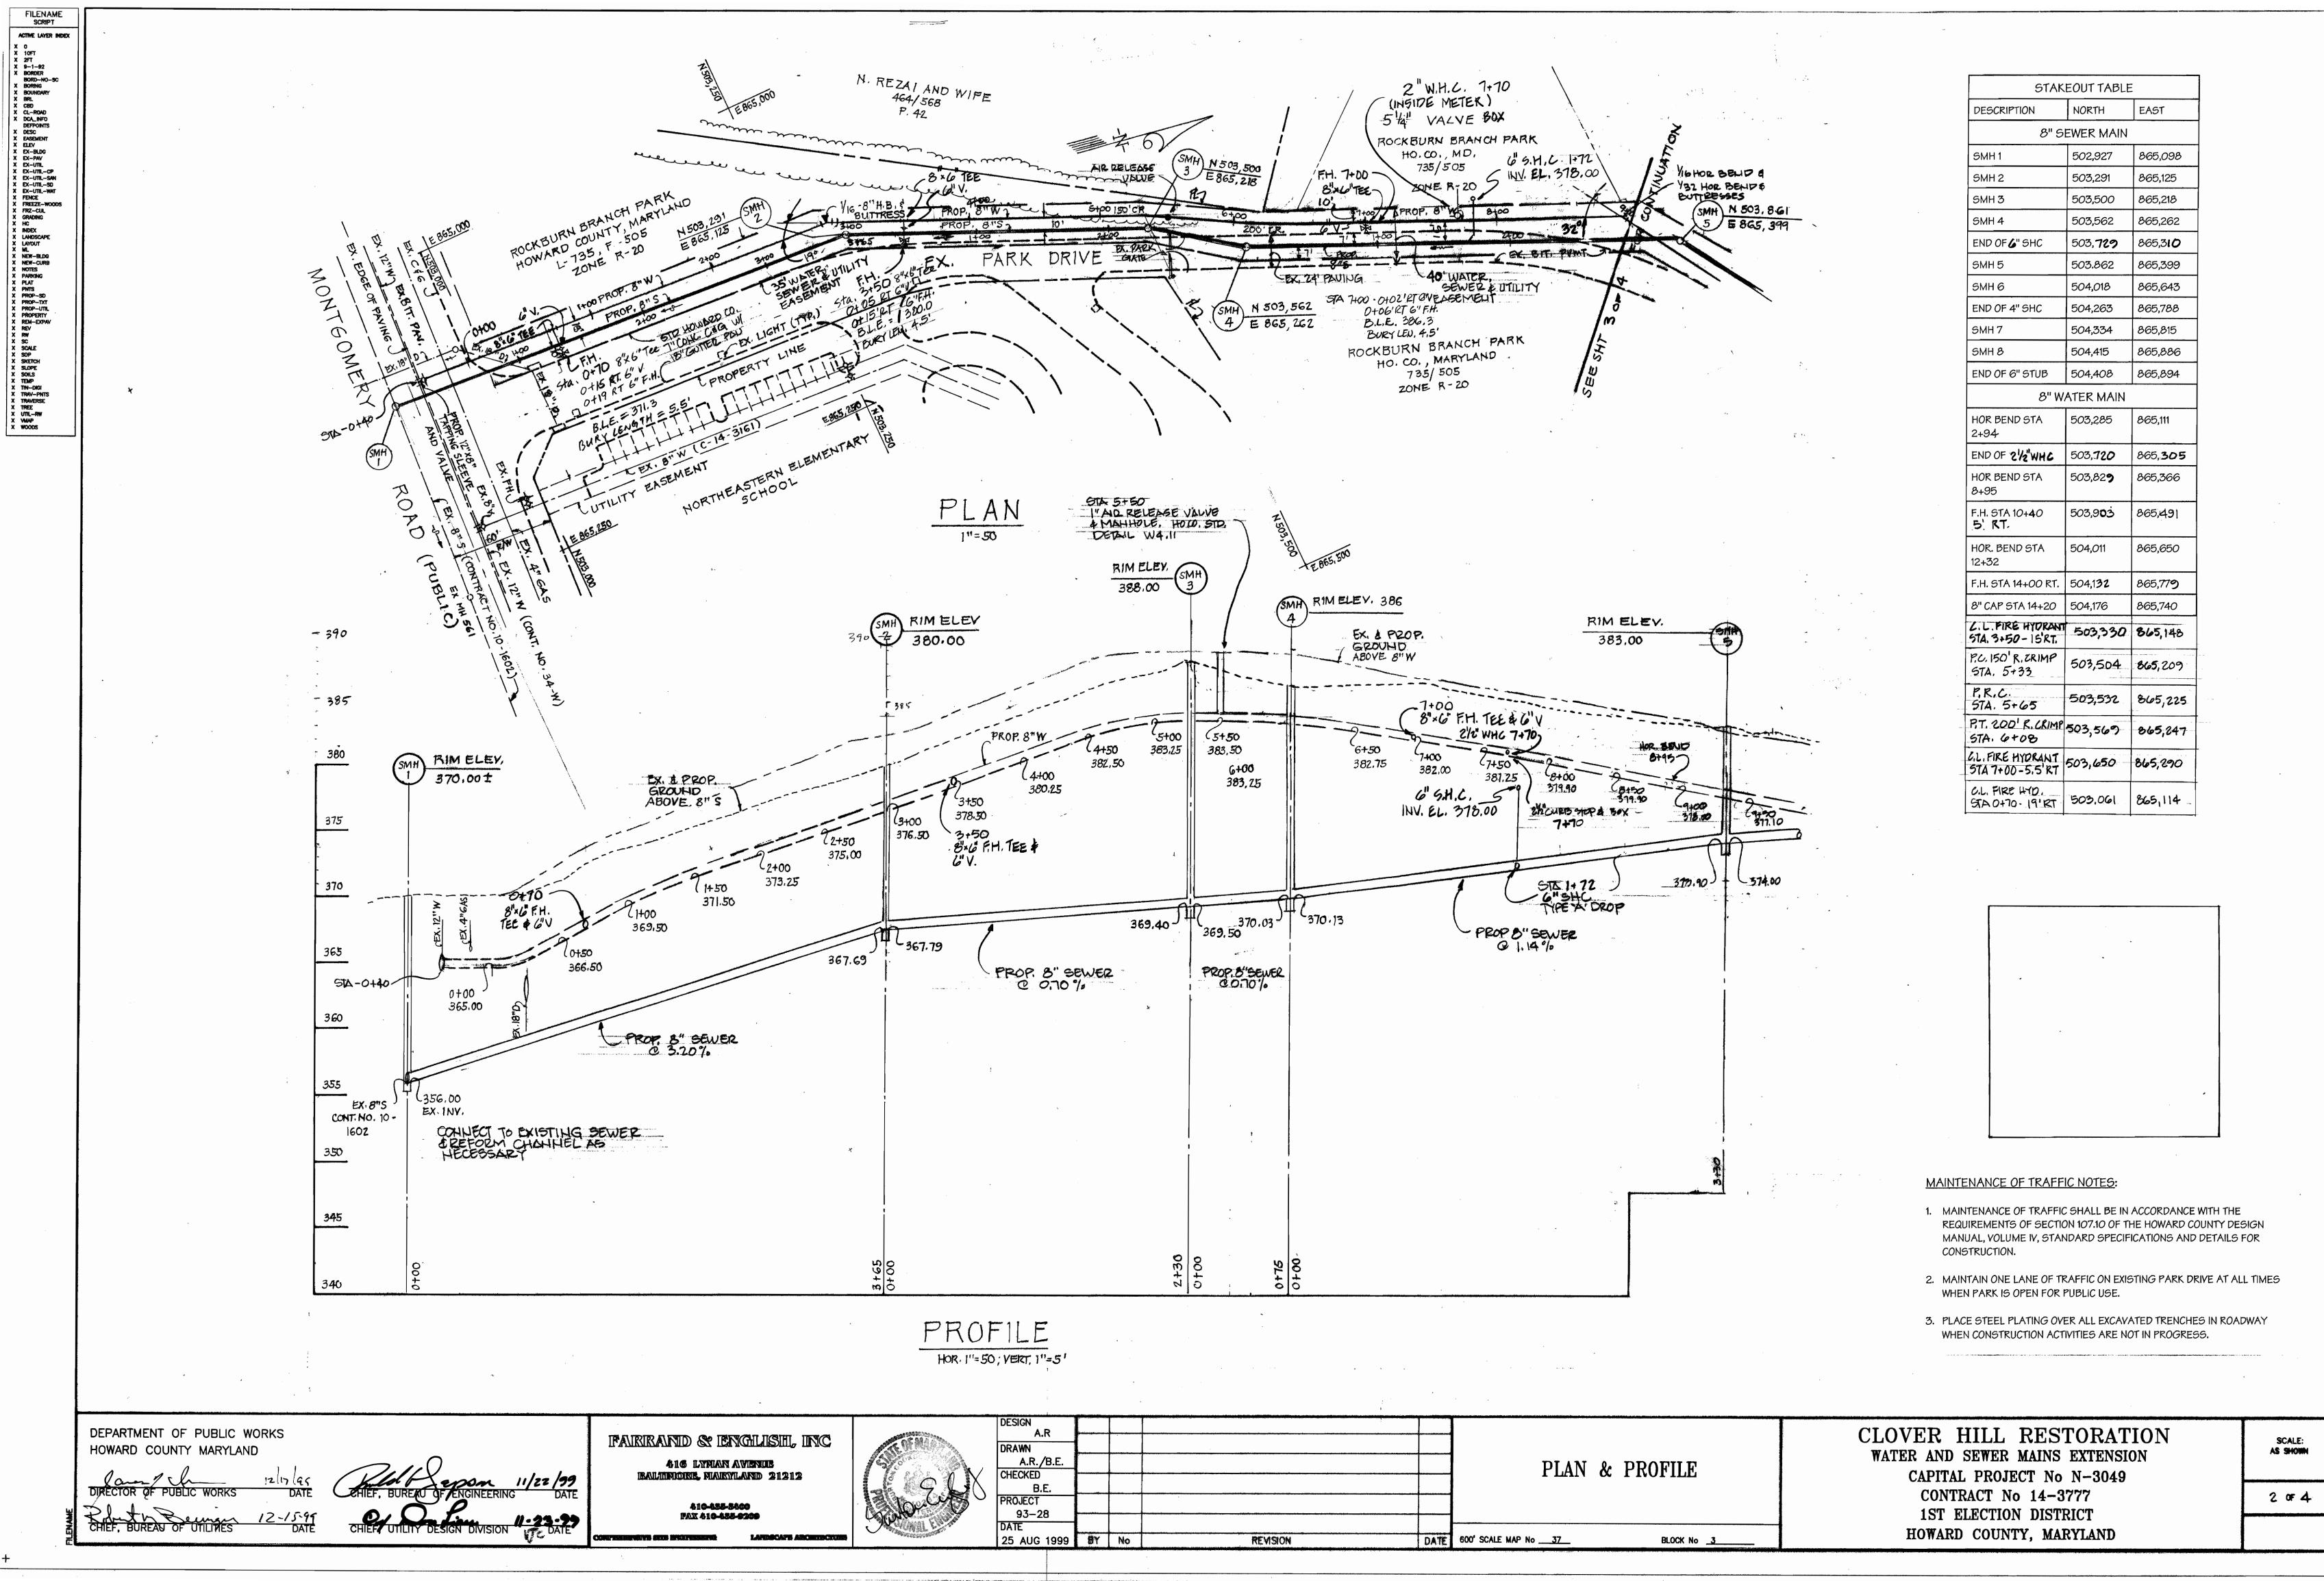
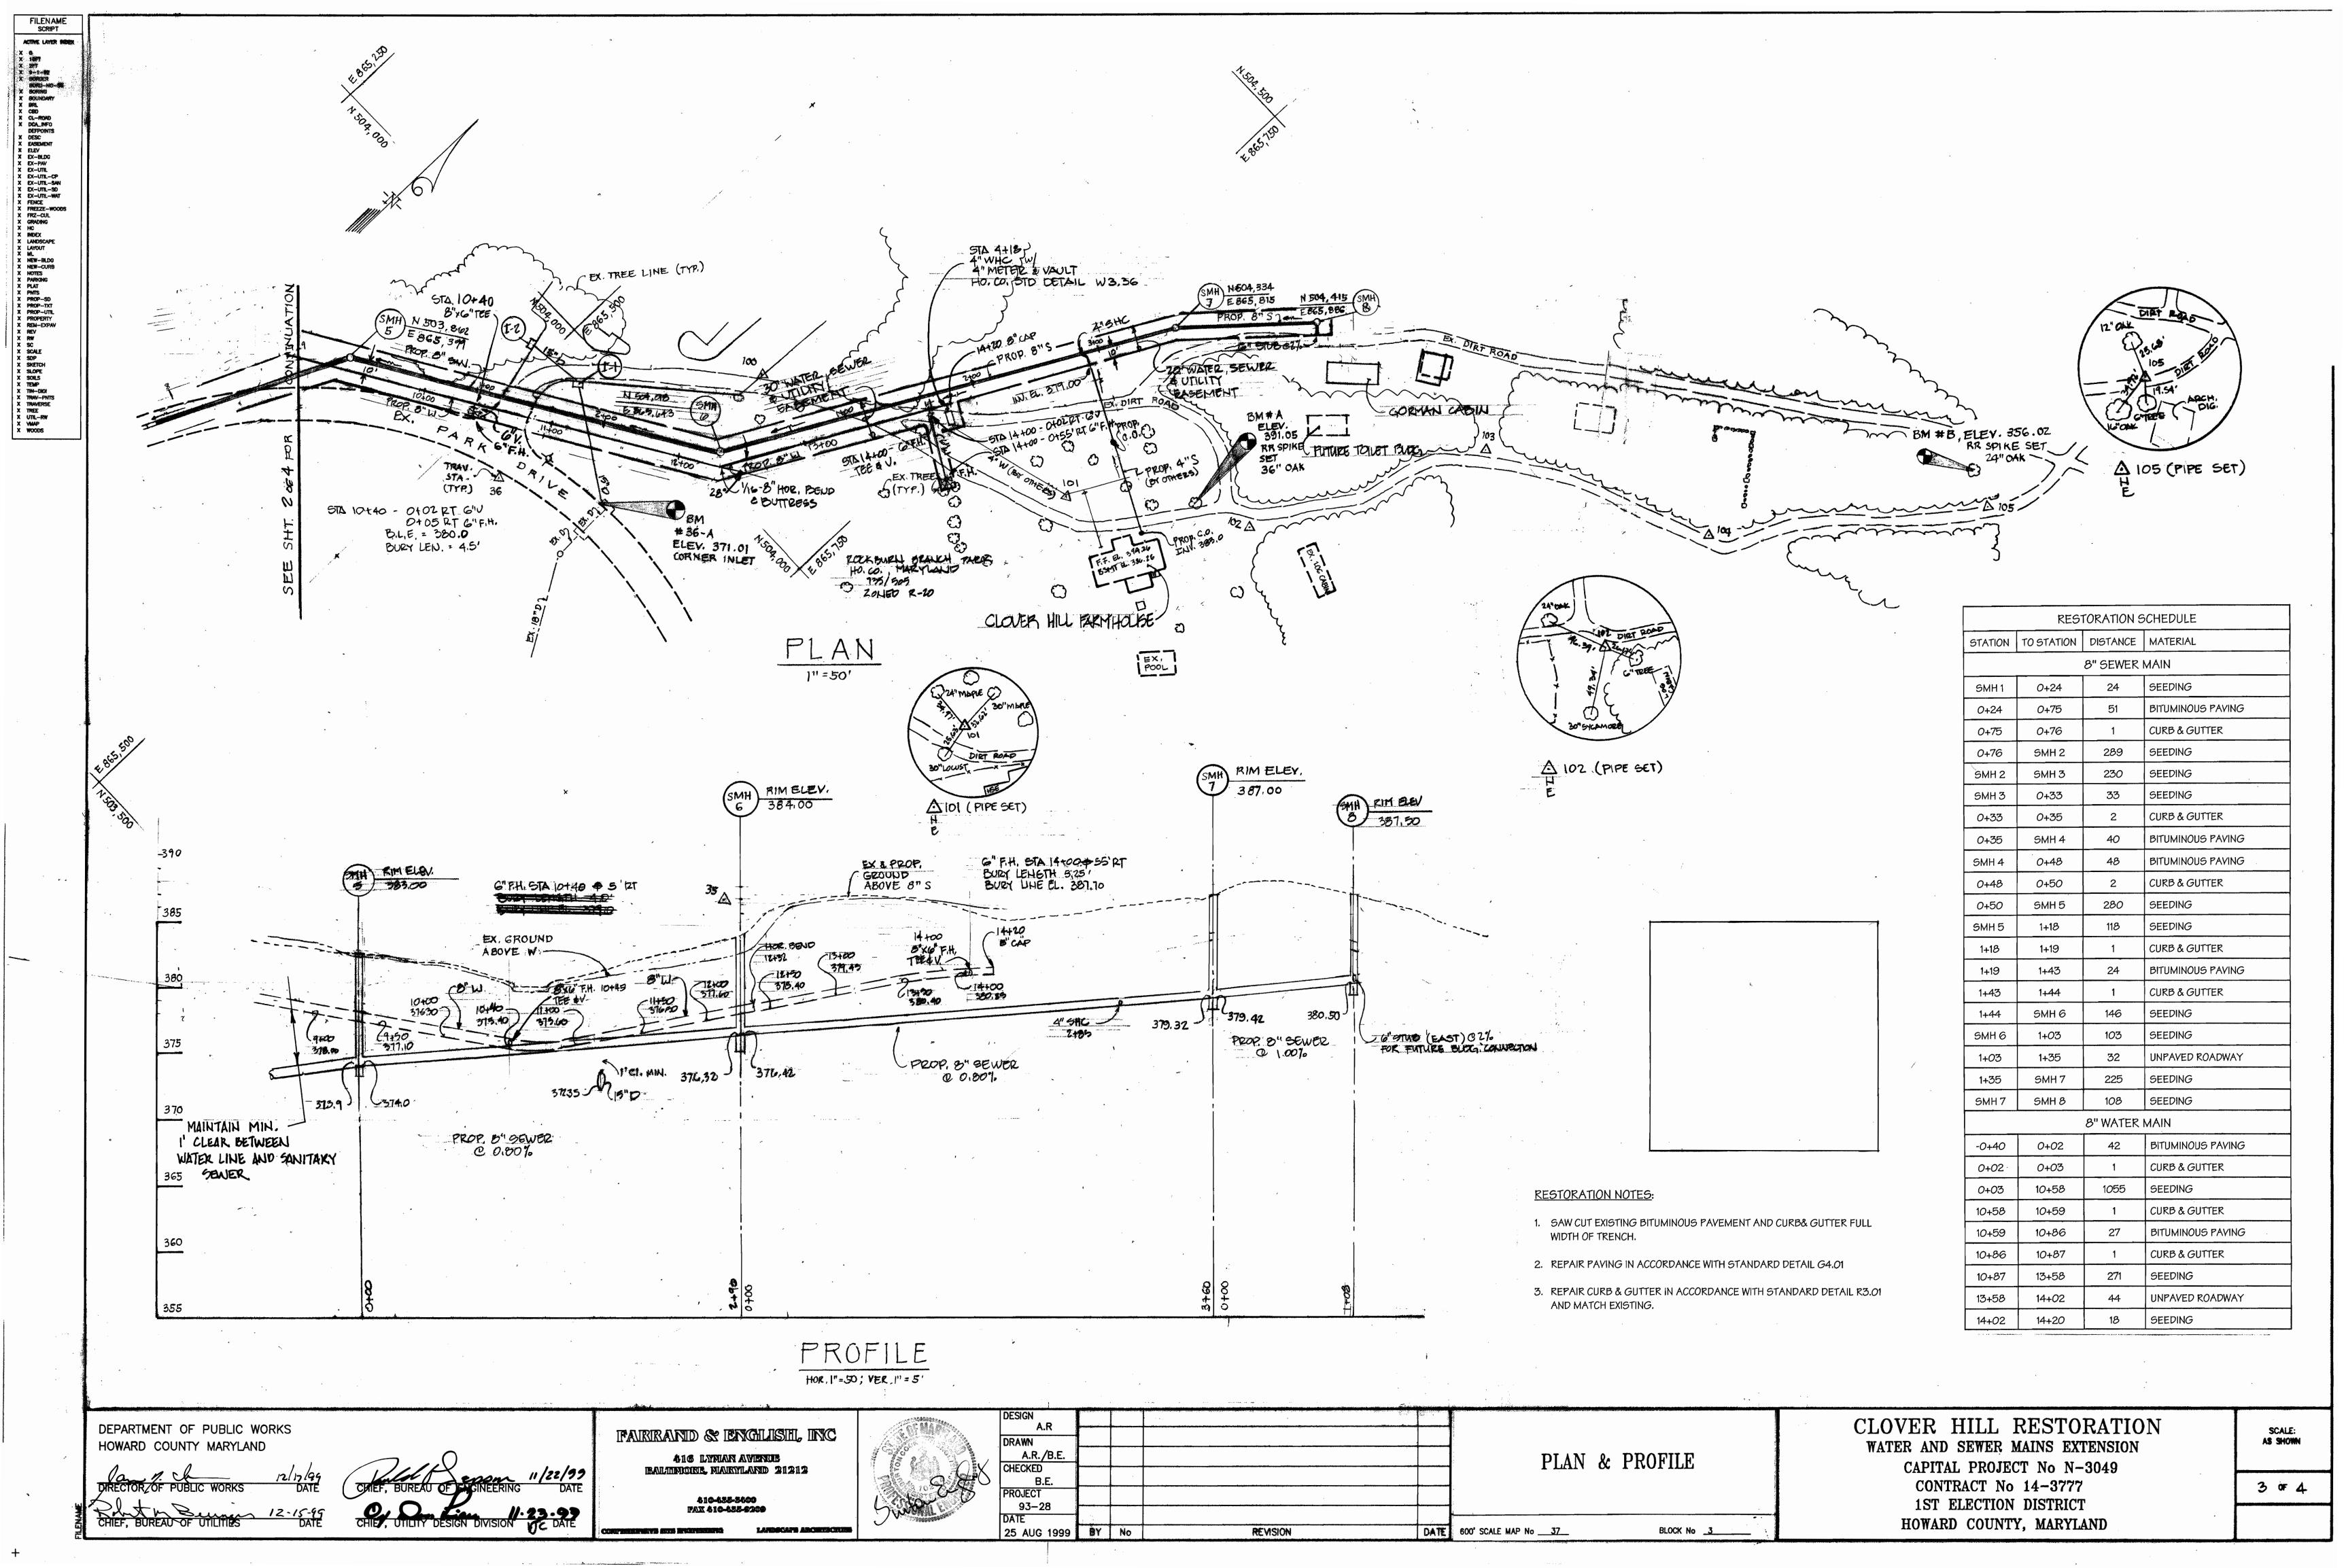
### HOWARD SOIL CONSERVATION DISTRICT PERMANENT SEEDING NOTES

Apply to graded or cleared areas not subject to immediate further disturbance where a short term vegetative cover is needed.

Seedbed Preparation: Loosen upper three inches of soil by raking, disking or other acceptable means before seeding, if not previously loosened.

Soil Amendments: In lieu of soil test recommendations, use one of the following schedules:

1) Preferred - Apply 2 tons per acres dolomitic limestone (92 lbs/1000 sq. ft.) and 600 lbs. per acre 10-10-10 fertilizer (14 lbs/1000 sq.ft.) before seeding. Harrow or disk into upper three inches of soil At time of seeding, apply 400 lbs. per acre 30-0-0 ureaform fertilizer (9 lbs/1000 sq.ft.).

2) Acceptable - Apply 2 tons per acre dolomitic limestone (42 lbs/1000 sq.ft.) and 1000 lbs. per acre 10-10-10 fertilizer (23 lbs/1000 sq.ft.) before seeding. Harrow or disk into upper

Seeding - For the periods march I thru April 31, and August I thru October 15, seed with 60 lbs. per acre (1.4 lbs/1000 sq.ft.) of Kentucky 31 Tall Fescue. For the period May I thru July 31, seed with 60 lbs. Kentucky 31 Tall Fescue per acre and 2 lobs. per acre (.05 lbs/1000 sq.ft.) of weeping lovegrass. During the period of October 16 thru February 28, protect site by: Option (1) - 2 tons per acre of well anchored straw mulch and seed as soon as possible in the spring. Option (2) - Use sod. Option (3) - Seed with 60 lbs:/acre Kentucky 31 Táll Fescue and mulch with 2 tons/acre well anchored

Mulching - Apply 1-1/2 to 2 tons per acre (70 to 90 lbs./1000 sq.ft.) of unrotted small grain straw immediately after seeding. Anchor mulch immediately after application using mulch anchoring tool or 218 gallons per acre (8 gal/1000 sq.ft.) for anchoring.

Maintenance - Inspect all seeding areas and make needed repairs, replacements and reseeding.

TEMPORARY SEEDING NOTES

Apply to graded or cleared areas likely to be redisturbed where a short - term vegetative cover is needed.

Seedbed Preparation: Loosen upper three inches of soil by raking, disking or other acceptable means before seeding, for not previously loosened.

Soil Amendments: Apply 600 lbs. per acre 10-10-10 fertilizer (14 lbs./1000

Seeding: For periods march I thru April 30 and from August 15 thru October 15, seed with 2 - ? bushel per acre of annual rue (3.2 lbs/1000 sq.ft.). For the period May I thru August 14, seed with 3 lbs. per acre of weeping lovegrass (.07 lbs/1000 sq.ft). For the period November 16 thru November 28, protect site by applying 2 tons per acre of well anchored straw mulch and seed as soon as possible in the spring, or use sod.

Mulching: Apply 1 - ? to 2 tons per acre (70 to 90 lbs/1000 sq.ft.) of unrotted weed free small arain straw immediately after seeding. Anchor mulch immediately after application using mulch anchoring tool or 218 gal per acre (5 gal/1000 sq.ft.) of emulsified asphalt on flat areas. On slopes 8 feet or higher, use 348 gal per acre (8 gal/1000 sq. ft.) for anchoring.

Refer to the 1983 MARYLAND STANDARDS AND SPECIFICATIONS FOR SOIL EROSION AND SEDIMENT CONTROL for additional rates and methods not covered.

#### STANDARD SEDIMENT CONTROL NOTES

- 1) A minimum of 48 hours must be given to the Howard County
  Department of inspections, Licensees and Permits, Sediment Control Division prior to the start of any construction, (313-1855).
- 2) All vegetative and structural practices are to be installed according to the provisions of this plan and are to be in conformance with the most current "MARYLAND STANDARDS AND SPECIFICATIONS FOR SOIL EROSION AND SEDIMENT CONTROL", and revisions thereto.
- 3) Following initial soil disturbance or redisturbance, permanent or temporary stabilization shall be completed within: a) 7 calendar days for all perimeter sediment control structures, dikes, perimeter slopes and all slopes greater than 3:1, b) 14 days as to all other disturbed or graded area on the project site.
- 4) All sediment traps/basins shown must be fenced and warning signs posted around their perimeter in accordance with Vol.1, Chapter 12, of the HOWARD COUNTY DESIGN MANUAL, Storm Drainage.
- 5) All disturbed areas must be stabilized within the time period specified above in accordance with the 1991 MARYLAND STANDARD'S AND SPECIFICATIONS FOR SOIL EROSION AND SEDIMENT CONTROL for the permanent seeding (Sec.51), sod (Sec.54), temporary seeding (Sec. 50) and muliching (Sec. 52). Temporary stabilization with mulch alone can only be done when recommended seeding dates do not allow for proper germination and establishment of arasses.
- 6) All sediment control structures are to remain in place and are to be maintained in operative condition until permission for their removal has been obtained from Howard County Sediment Control Inspector.
- Site Analysis: Total Area of Site: 2.83 acres Area Disturbed: 0.30. acres Area to be roofed or paved 0.16 acres Area to be vegetatively stabilized 0.14 acres 4,369 yards Total cut Total fill 5,666 Total wast/borrow area location
- 8) Any sediment control practice which is disturbed by grading activity for placement of utilities must be repaired on the same day of
- 4) Additional sediment control must be provided, if deemed necessary by the Howard County Sediment Control Inspector.
- 10) On all sites with disturbed areas in excess of 2 acres, approval of the inspection agency shall be requested upon completion of installation of perimeter erosion and sediment controls, but before proceeding with any other earth disturbance or grading. Other building or grading inspection approvals may not be authorized until this initial approval by the inspection agency is made.
- II) Trenches for the construction of utilities is limited to three pipe lengths or that which can be filled and stabilized within one working day, whichever is shorter.

# **EROSION AND SEDIMENT CONTROL NOTES:**

- I) ALL SEDIMENT CONTROL OPERATIONS ARE TO BE DONE IN ACCORDANCE WITH SECTION 219 OF THE HOWARD COUNTY VOLUME IV DESIGN MANUAL AND THE STANDARDS AND SPECIFICATIONS FOR THE SEDIMENT CONTROL IN DEVELÒPING AREAS.
- 2) ALL EROSION AND SEDIMENT CONTROL DEVICES SHALL BE INSTALLED AS THE FIRST ORDER OF BUSINESS.
- 3) ALL EXCAVATED MATERIALS SHALL BE STOCKPILED ON THE UPGRADE SIDE OF THE MAIN TRENCH.
- 4) IMMEDIATELY FOLLOWING BACKFILL OF THE SEWER MAIN trench, all disturbed areas are to be stabilized in ACCORDANCE WITH THE PERMANENT STABILIZATION AND SEEDING NOTES SHOWN ON THIS SHEET.
- 5) THROUGHOUT THE PROJECT, THE CONTRACTOR SHALL REGULARLY INSPECT ALL SEDIMENT CONTROL DEVICES AND PROVIDE ALL NECESSARY MAINTENANCE TO INSURE THAT ALL DEVICES ARE IN OPERATIVE CONDITION.
- 6) ALL SEDIMENT CONTROL FACILITIES SHALL REMAIN IN PLACE UNTIL PERMISSION FOR THEIR REMOVAL HAS BEEN OBTAINED FROM THE HOWARD COUNTY SEDIMENT CONTROL INSPECTOR.

SEQUENCE OF OPERATIONS:	APPROXIMATE TIME
<ul> <li>I) CONTACT HOWARD COUNTY CONSTRUCTION INSPECTION         DIVISION 48 HOURS PRIOR TO COMMENCING WORK AT         192 - 1212</li> </ul>	1 DAY
2) OBTAIN THE REQUIRED GRADING PERMIT.	
3) CLEAR AND GRUB AS NECESSARY: ONLY AS REQUIRED FOR EXCAVATION AND INSTALLATION OF THE WATER AND SEWER MAINS. ONLY WITHIN THE DESIGNATED WATER, SEWER AND UTILITY EASEMENTS OR WITHIN THE LIMIT OF DISTURBANCE.	3 DAYS
4) INSTALL SEDIMENT CONTROL DEVICE PERPENDICULAR TO THE CURB ON THE DOWN-SLOPE SIDE OF CONSTRUCTION.	2 DAYS
5) SAW CUT AND EXCAVATE DITCH TO THE GRADE SPECIFIED ON THE PROFILE.	21 DAYS
6) INSTALL SEWER AND WATER LINES.	21 DAYS
7) STABILIZE, SEED AND MULCH ALL DISTURBED AREAS IN ACCORDANCE WITH THE PERMANENT SEEDING NOTES SHOWN ON THIS SHEET.	I DAY
<ol> <li>INSPECT ALL SEDIMENT CONTROL DEVICES DAILY AND AFTER EACH RAINFALL, REPAIR AS NECESSARY.</li> </ol>	
<ol> <li>BACKFILL TRENCH AND RESURFACE WITH TEMPORARY BITUMINOUS PAVING.</li> </ol>	21 DAYS
IO) CLEAN UP CONSTRUCTION SITE.	2 DAYS
II) WHEN ALL CONTRIBUTING AREAS TO SEDIMENT CONTROL DEVICE HAVE BEEN PERMANENTLY STABILIZED, AND AFTER PERMISSION HAS BEEN OBTAINED FROM THE HOWARD COUNTY SEDIMENT CONTROL INSPECTOR, REMOVE ALL EROSION AND SEDIMENT CONTROL DEVICES.	I DAY

12) FOLLOWING INITIAL SOIL DISTURBANCE OR REDISTURBANCE,

PERMANENT OR TEMPORARY STABILIZATION SHALL BE

COMPLETED WITHIN A.) 7 CALENDAR DAYS FOR ALL


GREATER THAN 3:1

B) 14 CALENDAR DAYS FOR ALL

PERIMETER SLOPES

OTHER DISTURBED GRADED

AREAS ON THE PROJECT SITE

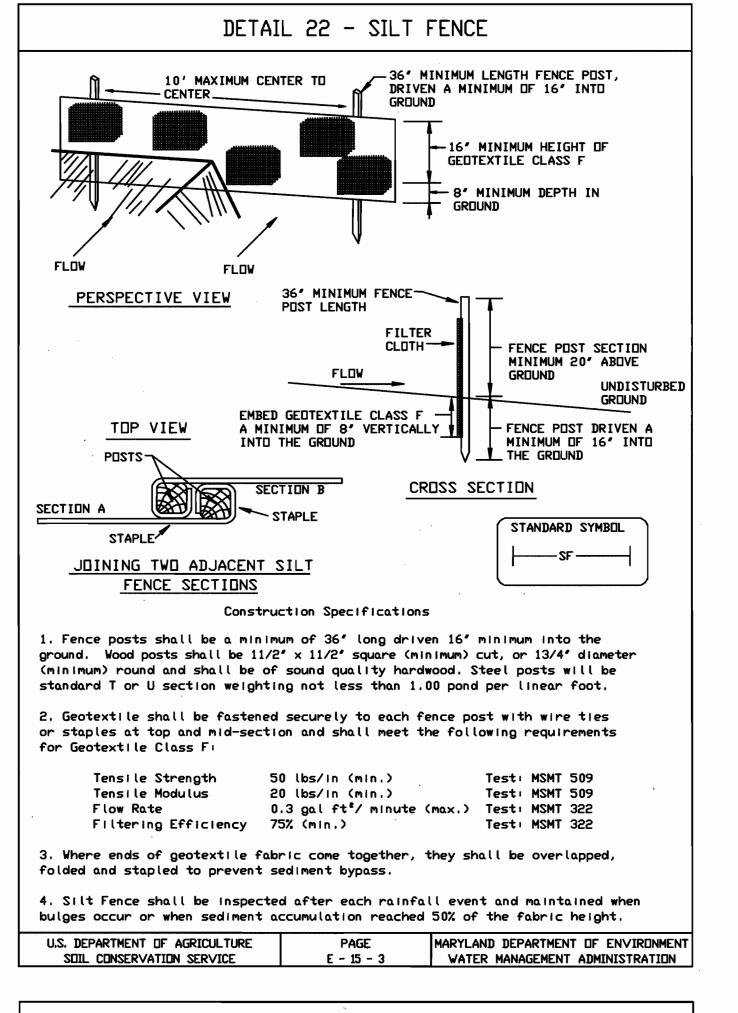



# Silt Fence Design Criteria

Slope Steepness	(Maximum) Slope Length	(Maximum) Silt Fence Length
Flatter than 50:1	unlimited	unlimited
50:1 to 10:1	125 feet	1,000 feet
10:1 to 5:1	100 feet	750 feet
5:1 to 3:1	60 feet	500 feet
3:1 to 2:1	40 feet	250 feet
2:1 and steeper	20 feet	125 feet

Note: In areas of less than 2% slope and sandy soils (USDA general classification system, soil Class A) maximum slope length and silt fence length will be unlimited. In these areas a silt fence may be the only perimeter control

REVIEWED FOR HOWARD SOIL CONSERVATION DISTRICT AND MEETS TECHNICAL REQUIREMENTS.

DEPARTMENT OF PUBLIC WORKS HOWARD COUNTY MARYLAND

FAIRRANID & ENGLISH, INC

416 LYMAN AVENUE BAILINNORIS MAKYLAND 21212

PAX 410-455-9200

DESIGN	DESIGN A.R					
				,		
	DRAWN					CEDIA
,	A.R. /B.E.					SEDIM
K	CHECKED					DÉTA
)	B.E.	_				DETA
	PROJECT					
	93-28				$\vdash$	
	DATE					
	25 AUG 1999	BY	No	REVISION	DATE	600' SCALE MAP No37

SEDIMENT. CONTROL DÉTAILS & NOTES

BLOCK No 3

CLOVER HILL RESTORATION WATER AND SEWER MAINS EXTENSION CAPITAL PROJECT No N-3049 CONTRACT No 14-3777 1ST ELECTION DISTRICT

U.S. DEPARTMENT OF AGRICULTURE

AS SHOWN

MARYLAND DEPARTMENT OF ENVIRONMENT

WATER MANAGEMENT ADMINISTRATION

HOWARD COUNTY, MARYLAND

4 of 4