	QUANTITIES						
	ITEM	ESTIMATED	A5-BUILT				
			QUANTITIE5	TYPE	Supplier		
	8" SEWER	1,145 L.F.					
A	6" SEWER (D.I.P.)	366 L.F.					
	MANHOLES	& EACH					
	,						
	NAME OF UTILITY CONTRACTOR:						
	SURVEY & DRAFTING DIVISION AS-BUILT DATE:						

DEVELOPER'S CERTIFICATION

 I/WE HEREBY CERTIFY THAT ALL DEVELOPMENT AND CONSTRUCTION WILL BE DONE ACCORDING TO THIS PLAN OF DEVELOPMENT AND PLAN FOR EROSION AND SEDIMENT CONTROL AND THAT ALL RESPONSIBLE PERSONNEL INVOLVED IN THE CONSTRUCTION PROJECT WILL HAVE A CERTIFICATE OF ATTENDANCE AT THE DEPARTMENT OF THE ENVIRONMENT APPROVED TRAINING PROGRAM FOR THE CONTROL OF SEDIMENT AND EROSION BEFORE BEGINNING THE PROJECT. I ALSO AUTHORIZE PERIODIC ON-SITE INSPECTION BY THE HOWARD SOIL CONSERVATION DISTRICT OR THEIR AUTHORIZED AGENTS. AS

Paul W. Kpielel FOR:
Waverly Woods Development Corp. 09/05/02

ENGINEER'S CERTIFICATION

* I HEREBY CERTIFY THAT THIS PLAN FOR EROSION AND SEDIMENT CONTROL REPRESENTS A PRACTICAL AND WORKABLE PLAN BASED ON MY PERSONAL KNOWLEDGE OF THE SITE CONDITIONS AND THAT IT WAS PREPARED IN ACCORDANCE WITH THE REQUIREMENTS OF THE HOWARD SOIL

MDE *02-NT-0214/200263886

REVIEWED FOR HOWARD COUNTY SOIL CONSERVATION DISTRICT AND MEETS TECHNICAL REQUIREMENTS.

SEDIMENT CONTROL MEASURES FOR THIS CONTRACT WILL BE IMPLEMENTED IN ACCORDANCE WITH SECTION 219 OF THE

HOWARD COUNTY DESIGN MANUAL & STANDARDS AND SPECIFICATIONS FOR SOIL EROSION AND SEDIMENT CONTROL IN DEVELOPING AREAS AND AS SHOWN ON THESE PLANS.

POUL W. KRIEDE FOR:

W<u>averly Woods Development</u> Grp. <u>09-05-</u>02

DEPARTMENT OF PUBLIC WORKS

HOWARD COUNTY, MARYLAND

DEPARTMENT OF PLANNING AND ZONING







GENERAL NOTES

- 1. APPROXIMATE LOCATION OF EXISTING MAINS ARE SHOWN. THE CONTRACTOR SHALL TAKE ALL NECESSARY PRECAUTIONS TO PROTECT EXISTING MAINS AND SERVICES AND MAINTAIN UNINTERRUPTED SUPPLY. ANY DAMAGE INCURRED SHALL BE REPAIRED IMMEDIATELY
- TO THE SATISFACTION OF THE ENGINEER AT THE CONTRACTOR'S EXPENSE. 2. ALL HORIZONTAL CONTROLS ARE BASED ON MARYLAND STATE COORDINATES, NAD 03.
- 3. ALL VERTICAL CONTROLS ARE BASED ON NAVD 29.

NICOLE WAY

- 4. ALL PIPE ELEVATIONS ARE INVERT ELEVATIONS.
- 5. CLEAR ALL UTILITIES BY A MINIMUM OF 12". CLEAR ALL POLES BY 5'-0" MINIMUM. 6. FOR DETAILS NOT SHOWN ON THE DRAWINGS, AND FOR MATERIALS AND CONSTRUCTION METHODS, USE HOWARD COUNTY MANUAL, VOLUME IV, STANDARD SPECIFICATIONS AND DETAILS FOR CONSTRUCTION (1991 AMENDMENTS) THE CONTRACTOR SHALL HAVE A COPY OF VOLUME IV ON THE JOB SITE.
- 7. WHERE TEST PITS HAVE BEEN MADE ON EXISTING UTILITIES, THEY ARE NOTED BY THE SYMBOL B AT THE LOCATION OF THE TEST PIT. A NOTE OR NOTES CONTAINING THE RESULTS OF THE TEST PIT OR PITS IS INCLUDED ON THE DRAWINGS. EXISTING UTILITIES IN THE VICINITY OF THE PROPOSED WORK FOR WHICH TEST PITS HAVE NOT BEEN DUG SHALL BE VERIFIED BY THE CONTRACTOR TO HIS OWN SATISFACTION. ANY DAMAGE TO THE EXISTING FACILITIES DUE TO THE CONTRACTOR'S NEGLIGENCE SHALL BE REPAIRED AT THE CONTRACTOR'S EXPENSE.
- 8. CONTRACTOR SHALL NOTIFY THE FOLLOWING UTILITIES OR AGENCIES AT LEAST FIVE WORKING DAYS BEFORE STARTING WORK SHOWN ON THESE PLANS:

AT&T 1-000-526-2000 BGE (CONTRACTOR SERVICES) 410-850-4620 BGE (UNDERGROUND DAMAGE CONTROL) 410-787-9096 BUREAU OF UTILITIES, HOWARD COUNTY DEPARTMENT OF PUBLIC WORKS 410-313-4900

BELL ATLANTIC MARYLAND, INC 1-000-621-9900 COLONIAL PIPELINE CO 410-795-1390 MISS UTILITY 1-000-257-7777 STATE HIGHWAY ADMINISTRATION 410-531-5533

- 9. TREES AND SHRUBS ARE TO BE PROTECTED FROM DAMAGE TO MAXIMUM EXTENT. TREES AND SHRUBS LOCATED WITHIN THE CONSTRUCTION STRIP ARE NOT TO BE REMOVED OR DAMAGED BY THE CONTRACTOR. 10. CONTRACTOR SHALL REMOVE TREES, STUMPS AND ROOTS ALONG THE LINE OF EXCAVATION. PAYMENT FOR SUCH REMOVAL SHALL BE INCLUDED IN THE UNIT PRICE BID FOR THE CONSTRUCTION OF THE MAIN.
- 11. ALL SEWER MAINS SHALL BE D.I.P. OR P.V.C. UNLESS OTHERWISE NOTED. 12. ALL MANHOLES SHALL BE 4'-0" INSIDE DIAMETER UNLESS OTHERWISE NOTED.
- 13. T.B. DENOTES TEST BORING. 14. MANHOLES SHOWN WITH 12" AND 16" WALLS ARE FOR BRICK MANHOLES ONLY.
- 15. MANHOLES DESIGNATED W.T. IN PLAN AND PROFILE SHALL HAVE WATERTIGHT FRAME AND COVERS, STANDARD DETAIL G5.52. 16. WHERE WATERTIGHT MANHOLE FRAME AND COVER IS USED, SET TOP OF FRAME 1'-6" ABOVE FINISHED GRADE UNLESS OTHERWISE NOTED ON THE PLANS OR SPECIFICATIONS.
- 17. HOUSE(S) WITH THE SYMBOL "C.N.S." INDICATES THAT THE CELLAR CANNOT BE SERVED. 18. ALL WATER HOUSE CONNECTIONS SHALL BE FOR INSIDE METER SETTING, UNLESS OTHERWISE NOTED ON THE PLANS OR IN THE
- 19. MANHOLES LOCATED WITHIN THE PROPOSED ROADWAY SHALL HAVE STANDARD HEAVY TRAFFIC MANHOLE FRAMES AND COVERS, STANDARD DETAIL G5.51. 20. WATER MAINS AND WATER HOUSE CONNECTION LINES MUST BE PLACED AS TO HAVE ONE (1) FOOT SEPARATION FROM THE SEWER
- MAIN OR SEWER HOUSE CONNECTION AS THEY PASS ABOUT IT. 21. ALL WATER MAINS SHALL BE D.I.P., CLASS 52 UNLESS OTHERWISE NOTED.
- 22. TOPS OF ALL WATER MAINS TO HAVE A MINIMUM OF 3-1/2' COVER UNLESS OTHERWISE NOTED. 23. VALVES ADJACENT TO TEES SHALL BE STRAPPED TO TEES. 24. ALL FITTINGS SHALL BE BUTTRESSED OR ANCHORED WITH CONCRETE IN ACCORDANCE WITH THE STANDARD DETAILS UNLESS
- 25. FIRE HYDRANTS SHALL BE SET TO THE BURY LINE ELEVATION SHOWN ON THE DRAWINGS. ALL FIRE HYDRANTS SHALL BE RESTRAINED AND BUTTRESSED WITH CONCRETE IN ACCORDANCE WITH THE STANDARD DETAILS (WI.11 AND W2.13). SOIL AROUND THE FIRE HYDRANT SHALL BE COMPACTED IN ACCORDANCE WITH SECTION 1000 AND 1005 OF THE STANDARD SPECIFICATIONS. 26. THE CONTRACTOR SHALL NOT OPERATE ANY WATER MAIN VALVES ON THE EXISTING WATER MAIN SYSTEM.
- 27. ALL D.I.P. FITTINGS SHALL BE IN ACCORDANCE WITH THE AWWA SPECIFICATIONS C-153; DUCTILE IRON COMPACT FITTINGS. 3-INCH THROUGH 12-INCH FOR WATER AND OTHER LIQUIDS.
- 28. THE CONTRACTOR SHALL NOTIFY THE BUREAU OF HIGHWAYS, HOWARD COUNTY, (410) 313-2450 AT LEAST FIVE (5) WORKING DAYS BEFORE ANY OPEN CUT OF ANY COUNTY ROAD OR BORING/JACKING OPERATION IN COUNTY ROADS FOR LAYING WATER/SEWER MAINS OR HOUSE CONNECTIONS. THE APPROVAL OF THESE DRAWINGS WILL CONSTITUTE COMPLIANCE WITH DPW REQUIREMENTS PER SECTION 18.114(a) OF THE HOWARD COUNTY CODE.

CONTRACT No. 20-3673-D

VICINITY MAP

SCALE: 1"=600"

YMEK PROPERTY

SEWER MAIN OUTFALL HOWARD COUNTY, MARYLAND BENCHMARK INFORMATION

B.M. •1 - HOWARD COUNTY CONTROL STATION •1012 (NAD '83) (NEAR THE INTERSECTION OF MARYLAND ROUTE 99 & WOODSTOCK ROAD)
N 601,060,177 E 1,345,336.750 ELEVATION = 445.577

B.M. •2 - HOWARD COUNTY CONTROL STATION • 16E1 (NAD '83) (NEAR THE INTERSECTION OF U.S. ROUTE 40 & MARRIOTTSVILLE ROAD)

TITLE SHEET

F.C.C. WORK ORDER NO. ___528_

520 FINAL SEWER TITLE SHT

CONTRACT NO. 20-3673-D DYMEK PROPERTY SEWER MAIN OUTFALL

HOWARD COUNTY, MARYLAND DYMEK PROPERTY **SCALE**

SEWER MAIN OUTFALL CONTRACT NO. 20-3673-D THIRD ELECTION DISTRICT HOWARD COUNTY, MARYLAND

SHEET 1 or 5

SHOWN

6-60-05

POINT OF ENTRY & EXIT FOR CONSTRUCTION -

DYMEK PROPERTY

SEWER MAIN OUTFALL

CONTRACT NO. 20-3673-D

N 539,000

WATER & SEWER CODE

FOR COUNTY USE ONLY WATER NO.: N/A

DRAINAGE AREA: _____

PUMPING STATION

SEWER NO.: _______5992000

NUMBER OF LOTS & PARCELS:


NO. OF WATER HOUSE CONNECTIONS: _____

NO. OF SEWER HOUSE CONNECTIONS: _____


TREATMENT PLANT: PATAPASCO WASTEWATER TREATMENT

PLANT: CITY OF BALTIMORE: VIA THE WAVERLY WASTEWATER

WATER ZONE: N/A WATER TEST GRADIENT: _____N/A_

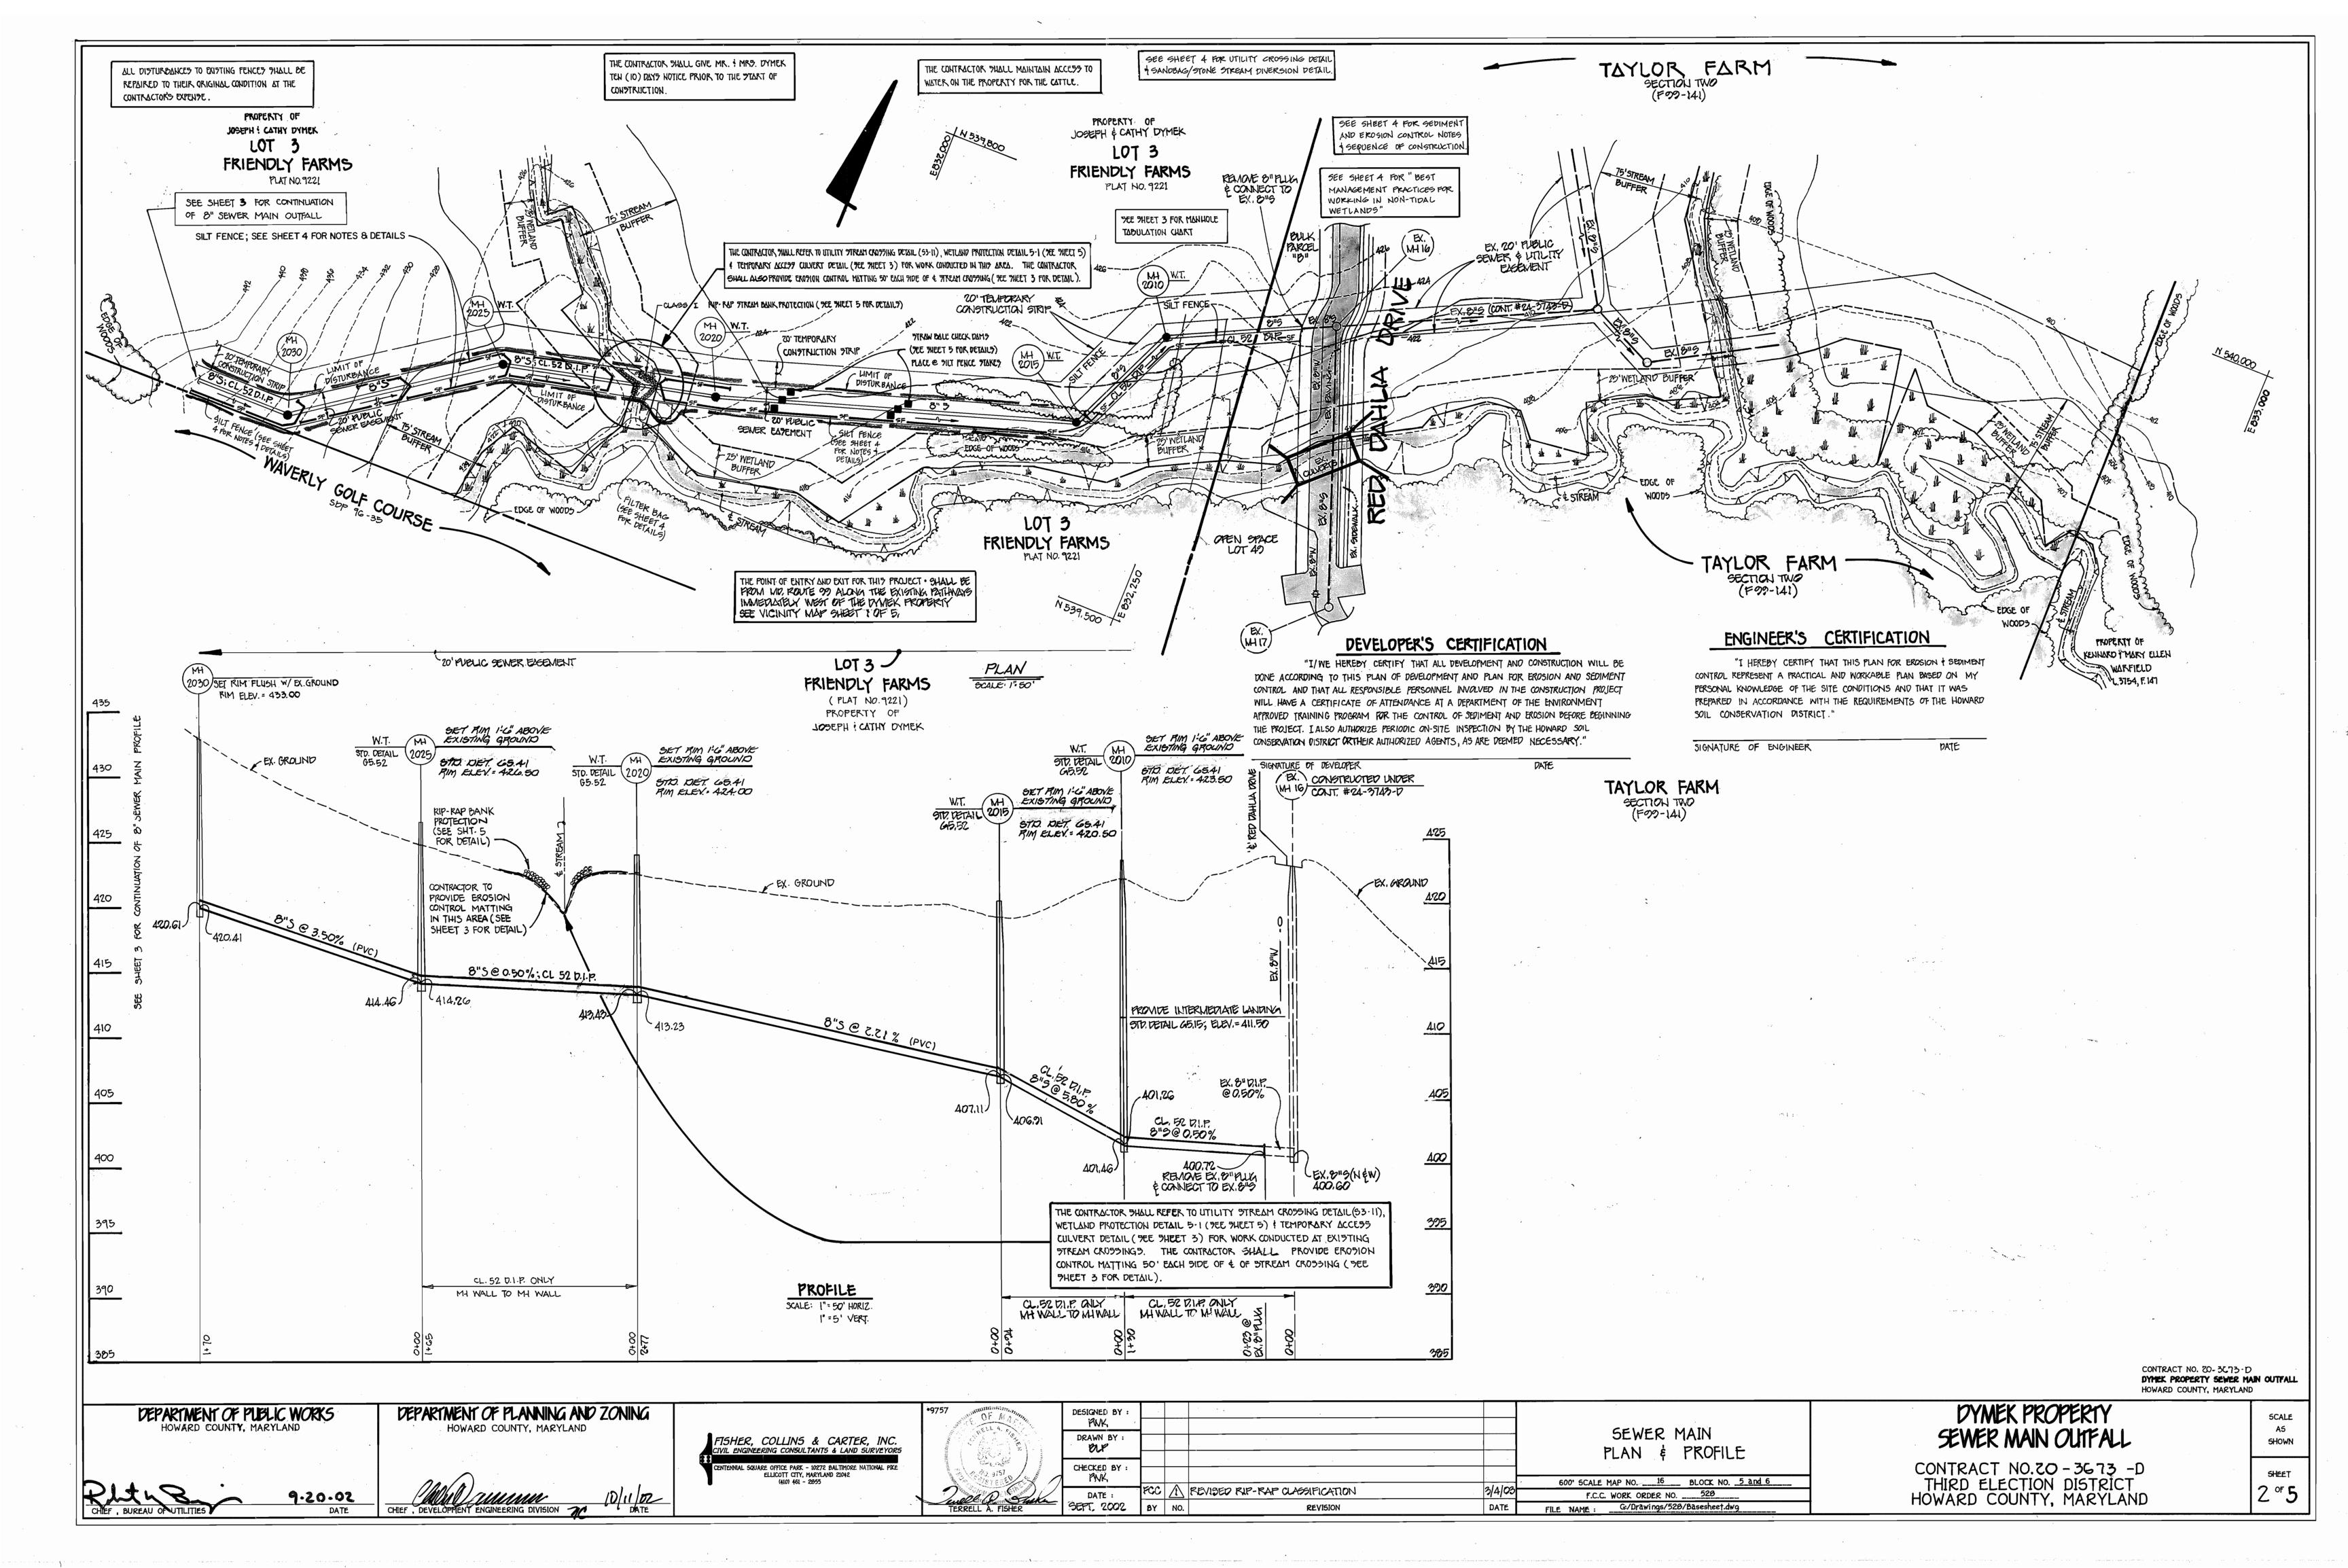

MAN	HOLE	TABULATION	CHART	
MH NO.	RIM ELEV.	NORTHING	EASTING	
-				
7010	107 -0	##### 00 F	070007 007	
ळा०	423.50	539718.225	832207.285	
2015	420.50	5:39630.519	832166.311	
८०८०	424.00	539 544 . 375	831 904, 515	
2025	426.50	537507.303	831 743, 734	
2030	433.00	539 410 . 754	831603,811	
2035	440.00	559410.37Z	831503.812	
2040	462.20	539408, 511	831.153.815	
8" PLUG		539373.95	830919,39	
2045	466,40	539407, 99	39,296068	

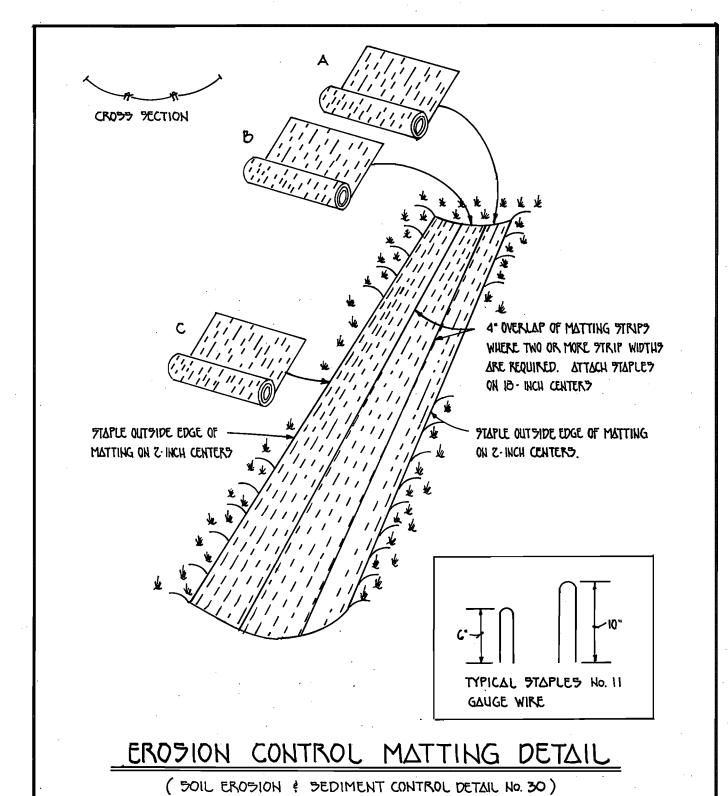

NOT TO PLALE CONSTRUCTION SPECIFICATIONS FOR EROSION CONTROL MATTING


- KEY-IN THE MATTING BY PLACING THE TOP ENDS OF THE MATTING IN A NARROW TRENCH, C" IN DEPTH. BACKFILL THE TRENCH ! TAMP FIRMLY TO CONFORM TO THE CHANNEL CROPP-PECTION; PECURE WITH A ROW OF PTAPLED ABOUT 4" DOWN FLOPE FROM THE TRENCH. PRACING BETWEEN FLAPLET 19 C".
- . FTAPLE THE 4" OVERLAP IN THE CHANNEL CENTER USING AN 18" SPACING DETWEEN STAPLES.
- 3 . BEFORE FLAPLING THE OUTER EDGES OF THE MATTING , MAKE SURE THE MATTING 17 SMOOTLI ! IN FIRM CONTACT WITH THE SOIL . I. TAPLET THALL BE PLACED 2'APART WITH 4 ROWT ON EACH TIRIP, ZOUTER ROWT, & Z ALTERNATING ROWT DOWN THE CENTER
- 5. WHERE ONE ROW OF MATTING ENDS! ANOTHER BEGINS, THE END OF THE TOP STRIP SHALL OVERLAP THE UPPER END OF THE LOWER TRIP BY 4", THIPLAP FATHION. REINFORCE THE OVERLAP WITH A DOUBLE ROW OF TIAPLET TRACED G"APART IN A STAGGERED PATTERN ON EITHER FIDE.
- . THE DITCHARGE END OF THE END OF THE MATTING LINER THOULD BE TIMILARLY DECURED WITH 2 DOUBLE ROWS OF STAPLES.
- IF FLOW WILL ENTER FROM THE EDGE OF THE MATTING THEN THE AREA EFFECTED BY THE FLOW MUST BE KEYED IN .

DEVELOPER'S CERTIFICATION

ACCORDING TO THIS PLAN OF DEVELOPMENT AND PLAN FOR EROSION AND SEDIMENT CONTROL AND THAT ALL RESPONSIBLE PERSONNEL INVOLVED IN THE CONSTRUCTION PROJECT WILL HAVE A CERTIFICATE OF ATTENDANCE AT A DEPARTMENT OF THE ENVIRONMENT APPROVED TRAINING PROGRAM FOR THE CONTROL OF SEDIMENT AND EROSION DEFORE BEGINNING THE PROJECT. I ALSO AUTHORIZE PERIODIC ON-SITE INSPECTION BY THE HOWARD SOIL CONSERVATION DISTRICT OR THEIR AUTHORIZED AGENTS, AS ARE DEEMED NECESSARY."

SIGNATURE OF DEVELOPER

DEPARTMENT OF PUBLIC WORKS

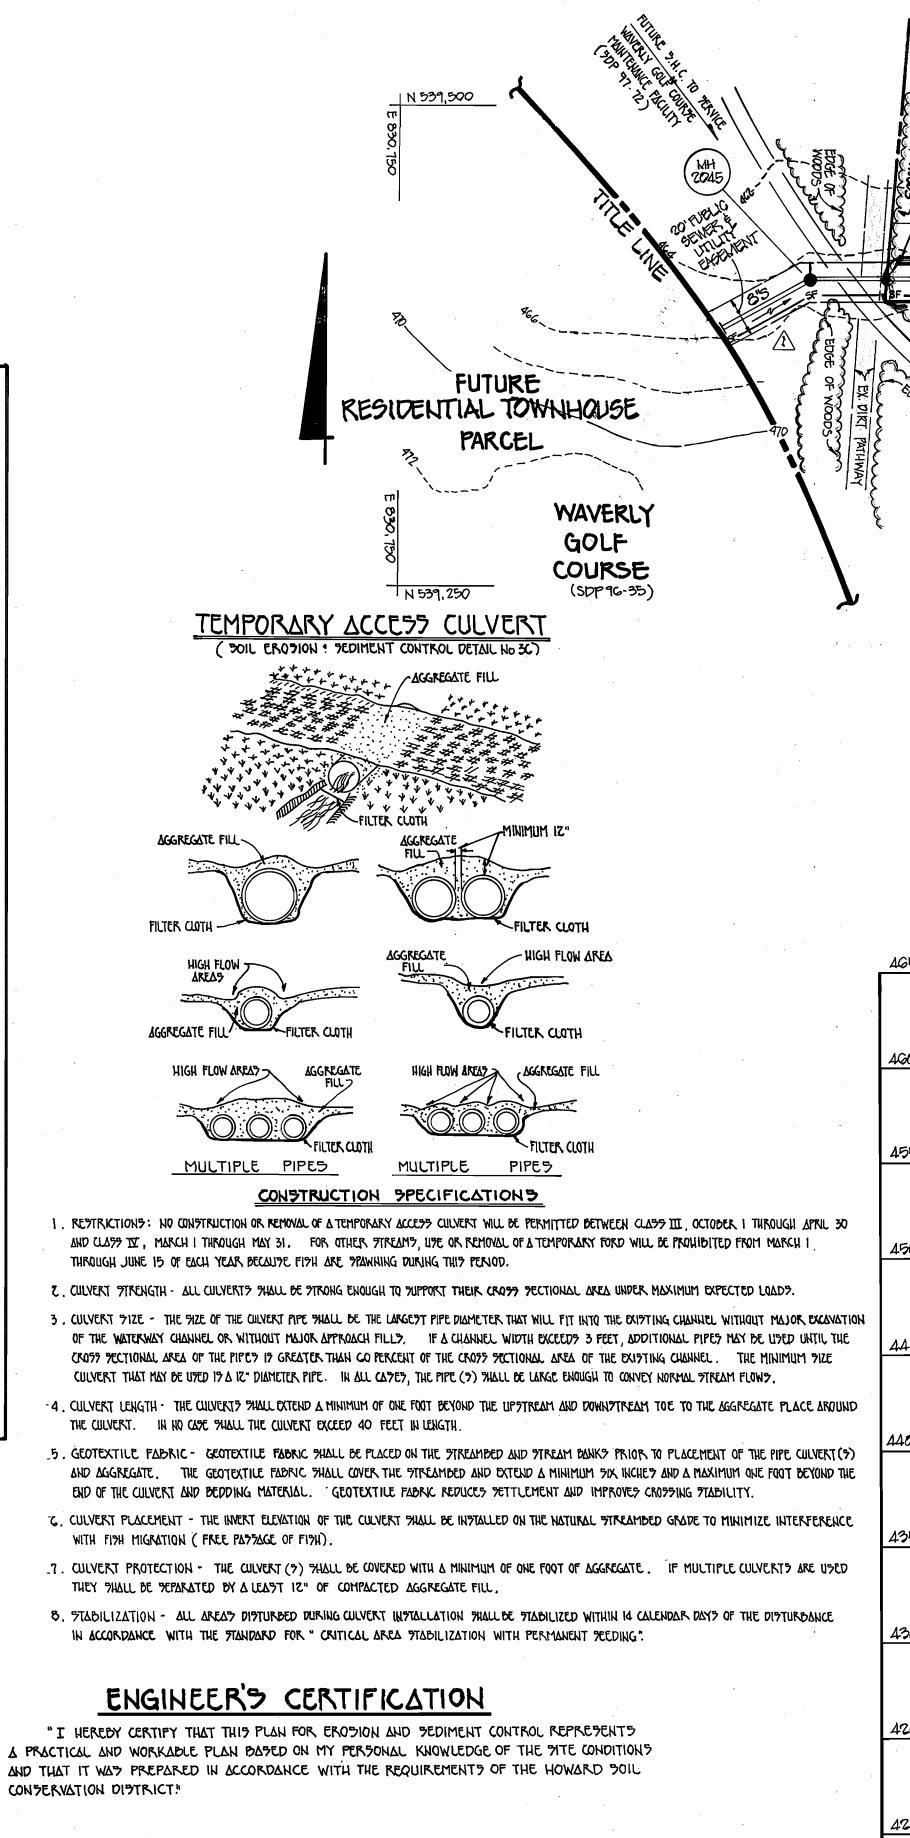

4 FOR NOTES | DETAILS) (2040) (THE PHEET 5 FOR DETAIL) PLACE @ FILT FENCE FLAKE. SILT FENCE (SEE SHEET 4 FOR NOTES & DETAILS) SILT FENCE (SEE, SHEET 4 FOR NOTES + DETAILS) EX. GOLF CART (SEE FLEET 5 FOR DETAIL) PLACE @ FILT FENCE FTAKE ALL DIFTURBANCES TO EXISTING FENCES SHALL BE REPAIRED STRAW BALE CHECK DAM TO THEIR ORIGINAL CONDITION AT THE CONTRACTORY EXPENSE (SEE SHEET 5 FOR DETAIL) TEE BOX #7 SEE SHEET 4 FOR SEDIMENT AND EROSION CONTROL NOTES & SEQUENCE OF CONSTRUCTION WAVERLY GOLF COURSE (SDP 96-35) N 539,250 THE CONTRACTOR THALL GIVE MR. ! MRT. DYMEK TEN (10) DAYS NOTICE PRIOR TO THE START OF CONFIRUCTION. PLAN SCALE: 1": 50' SET RIM FLUSH MH W/EX. GROUND (2045) PROPERTY OF JOSEPH & CLATHY DYMEK LOT 3 WAVERLY FRIENDLY FARMS GOLF COURSE (50P 96-35) (PLAT NO. 9221) 20' PUBLIC SEWER' SET RIM FLUSH W/ EXISTING GROUND EASEMENT EX. GROUND (2040) RIM ELEV. : 462.20 8"RUG 454,58, EX. GROUND 454.02 MH EXISTING GROUND 2035 RIM ELEV = 440.00 453,82 SET RIM FLUSH W/ EXISTING GROUND MH RIM ELEV. = 433.00 (2030) PROFILE SCALE: 1"=50' HORIZ 420 1"= 5' VERT. 420,41 CONTRACT NO. ZO-3G73-D DYMEK PROPERTY SEWER MAIN OUTFALL HOWARD COUNTY, MARYLAND SCALE

SEWER MAIN

PLAN AND PROFILE

F.C.C. WORK ORDER NO. ____528_ FILE NAME: G:/Drawings/528/Basesheet.dwg

600' SCALE MAP NO. ___16 BLOCK NO. _5 and 6

PROPERTY OF

JOSEPH CATHY DYMEK

FRIENDLY FARMS

LOT 3

THE CONTRACTOR PHALL MAINTAIN ACCESS TO

WATER ON THE PROPERTY FOR THE CATTLE

SEE SHEET 2 FOR CONTINUATION

SILT FENCE; SEE SHEET 4 FOR NOTES & DETAILS

OF 8"SEWER MAIN OUTFALL

THE POINT OF ENTRY AND EXIT FOR THIS PROJE

SHALL BE FROM MD, ROUTE 99 ALONG THE

Existing pathways immediately west of dymek property; see vicinity map

TIRAW BALE CHECK DAM

PROVIDE 3"PLUG; LIMIT OF FEWER

MAIN CONTRUCTION THIS CONTRACT

SILT FENCE (SEE SHEET / MH)

"I/WE HEREBY CERTIFY THAT ALL DEVELOPMENT AND CONSTRUCTION WILL BE DONE

DEPARTMENT OF PLANNING AND ZONING

HOWARD COUNTY, MARYLAND

FISHER, COLLINS & CARTER, INC.



DESIGNED BY

PWK

· · · · · · · · · · · · · · · · · · ·	1			
DRAWN BY:				
0140440 014	1			
CHECKED BY :				
DATE :	FCC	\triangle	REVISED MH TABULATION CHART, SEWER FLAN & SEWER PROFILE	3/4/0
SEPT. 2002	BY	NO.	REVISION	DATE

DYMEK PROPERTY SEWER MAIN OUTFALL

SHOWN


3 or 5

CONTRACT NO. 20 - 3673 -D THIRD ELECTION DISTRICT HOWARD COUNTY, MARYLAND

9-20-02

DATE


SIGNATURE OF ENGINEER

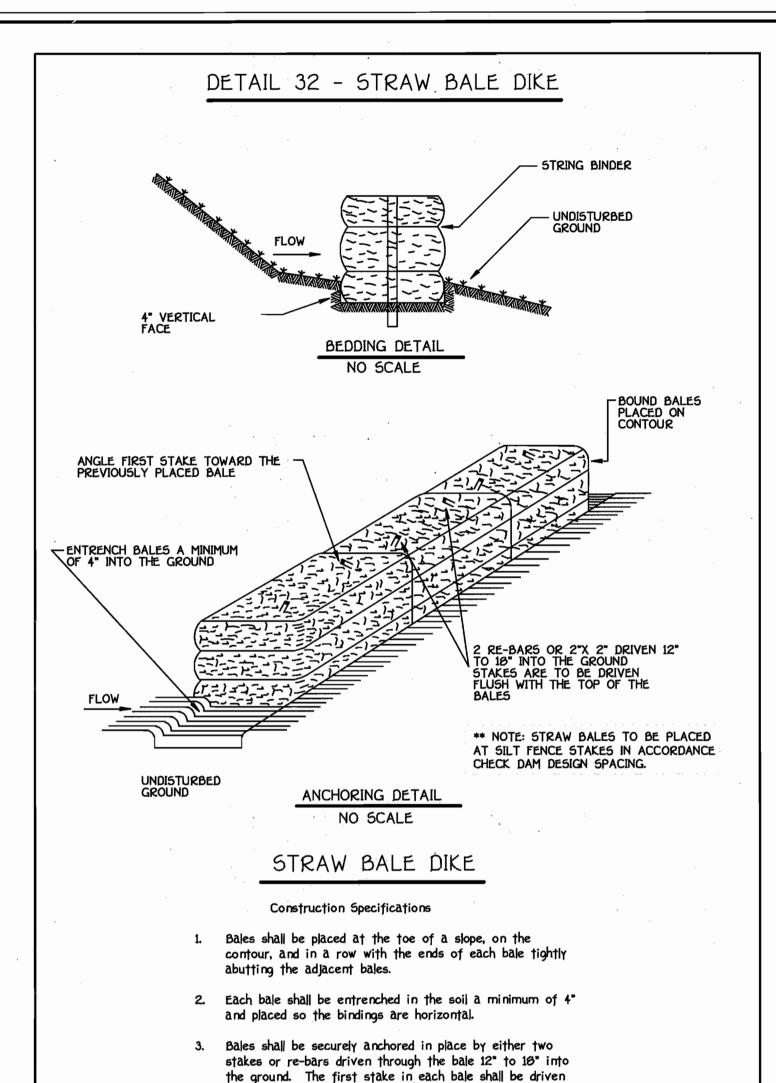

- toward the previously laid bale at an angle to force the bales together. Stakes shall be driven flush with the top of the
- each rain event and maintenance performed as necessary.
- 5. All bales shall be removed when the site has been stabilized. The trench where the bales were located shall be graded flush and stabilized.

DEVELOPER'S CERTIFICATION " I/WE HEREBY CERTIFY THAT ALL DEVELOPMENT AND CONSTRUCTION WILL BE DONE ACCORDING TO THIS PLAN OF DEVELOPMENT AND PLAN FOR EROSION AND SEDIMENT CONTROL AND THAT ALL RESPONSIBLE PERSONNEL INVOLVED IN THE CONSTRUCTION PROJECT WILL HAVE A CERTIFICATE OF ATTENDANCE AT A DEPARTMENT OF THE ENVIRONMENT APPROVED TRAINING PROGRAM FOR THE CONTROL OF SEDIMENT AND EROSION BEFORE BEGINNING THE PROJECT. I ALSO AUTHORIZE PERIODIC ON-SITE INSPECTION BY THE HOWARD SOIL CONSERVATION DISTRICT OR THEIR AUTHORIZED AGENTS, AS ARE DEEMED NECESSARY."

ENGINEER'S CERTIFICATION

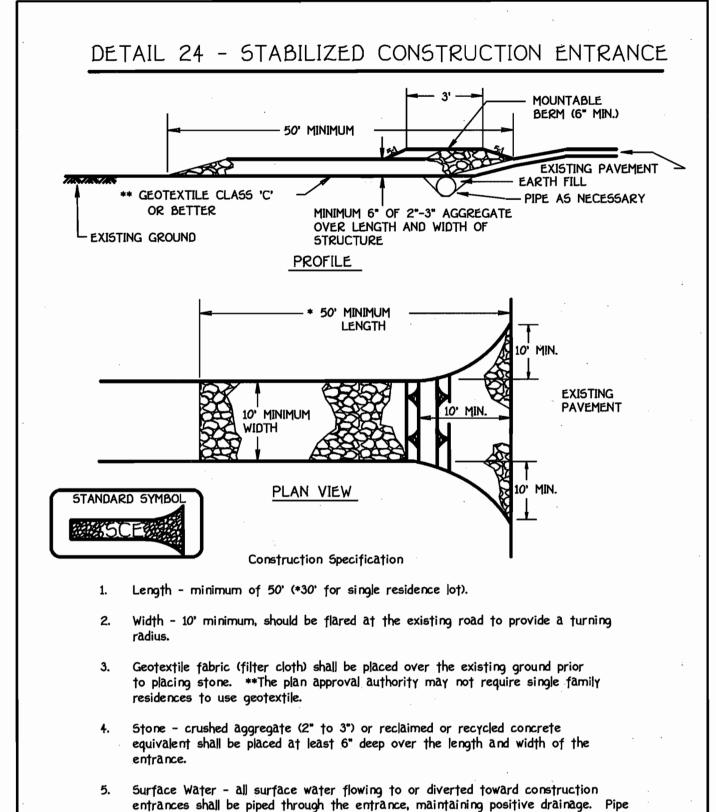

installed through the stabilized construction entrance shall be protected with a


has no drainage to convey a pipe will not be necessary. Pipe should be sized according to the amount of runoff to be conveyed. A 6" minimum will be required.


where construction traffic enters or leaves a construction site. Vehicles leaving

the site must travel over the entire length of the stabilized construction entrance.

6. Location - A stabilized construction entrance shall be located at every point

mountable berm with 5:1 slopes and a minimum of 6" of stone over the pipe. Pipe has to be sized according to the drainage. When the SCE is located at a high spot and

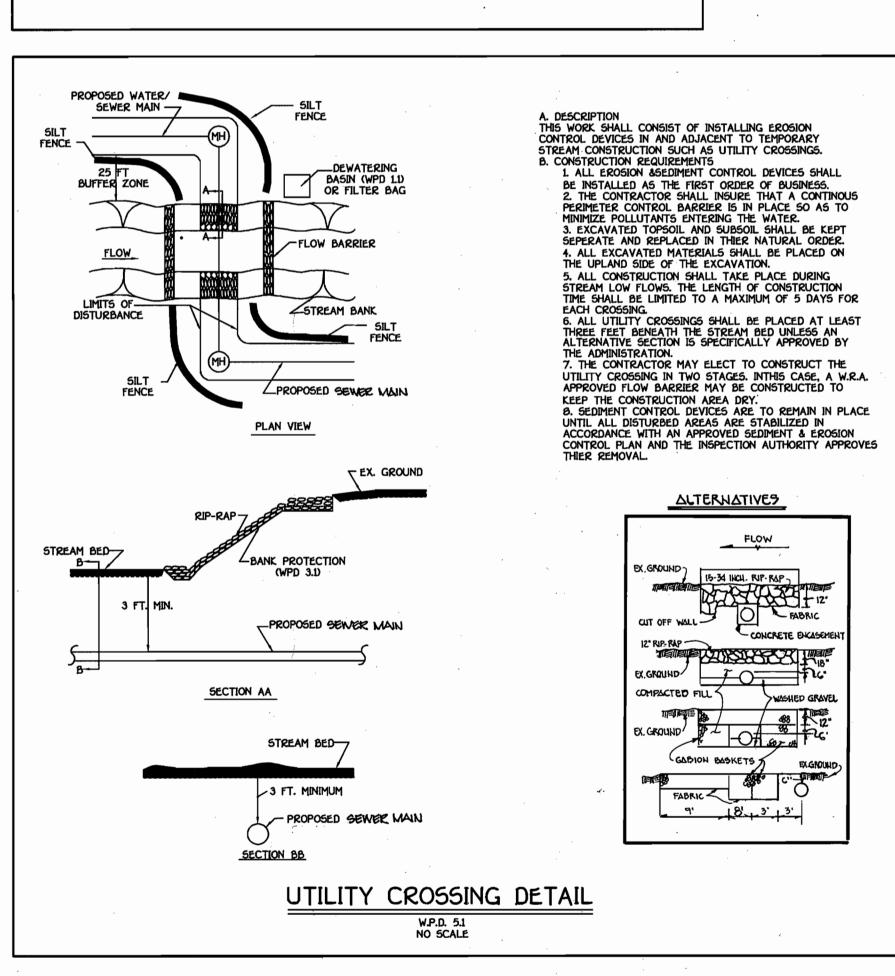

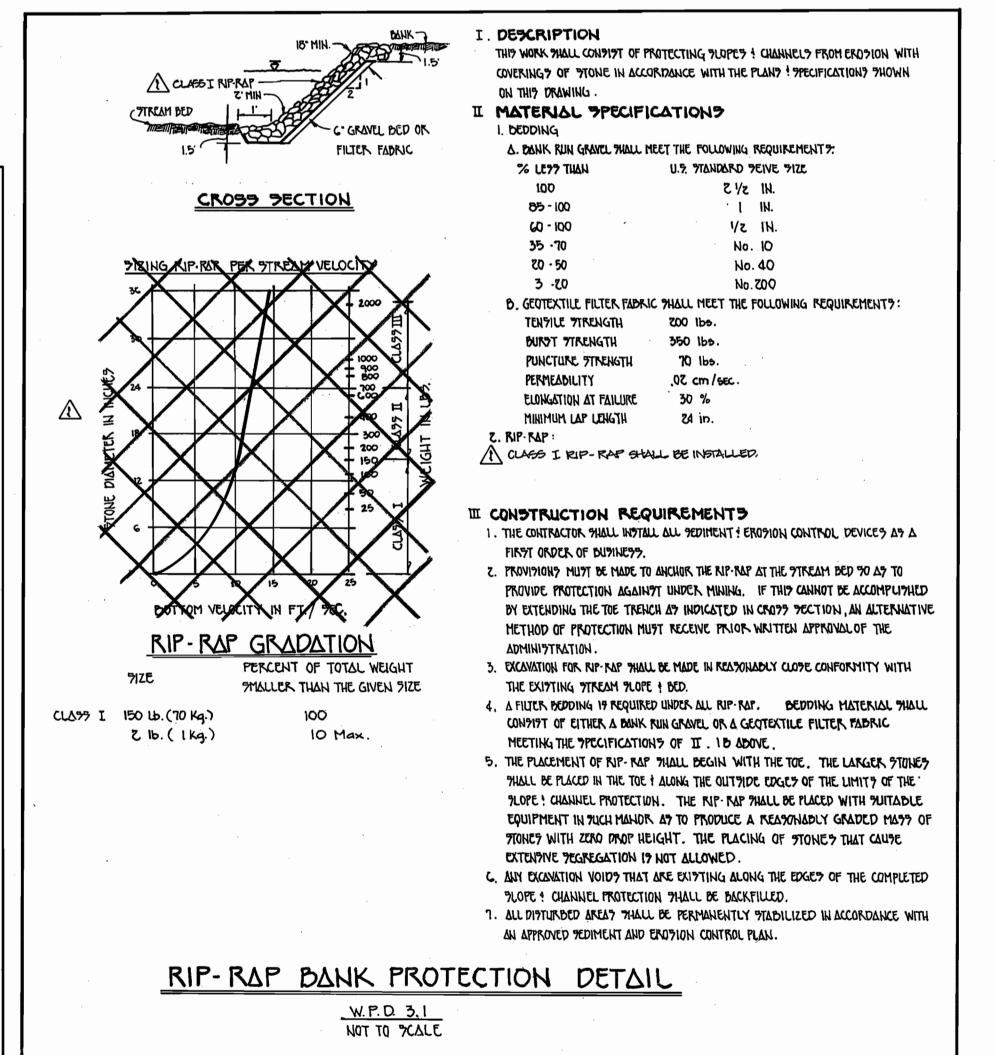

"I HEREBY CERTIFY THAT THIS PLAN FOR EROSION AND SEDIMENT CONTROL REPRESENTS A PRACTICAL AND WORKABLE PLAN BASED ON MY PERSONAL KNOWLEDGE OF THE SITE CONDITIONS AND THAT IT WAS PREPARED IN ACCORDANCE WITH THE REQUIREMENTS OF THE HOWARD SOIL

9.20.02

DEPARTMENT OF PUBLIC WORKS HOWARD COUNTY, MARYLAND

DEPARTMENT OF PLANNING AND ZONING HOWARD COUNTY, MARYLAND

FISHER, COLLINS & CARTER, INC. CIVIL ENGINEERING CONSULTANTS & LAND SURVEYORS AL SQUARE OFFICE PARK - 10272 BALTIMORE NATIONAL PIKE ELLICOTT CITY, MARYLAND 21042



DESIGN	DESIGNED BY:			
M.	M.J.M.			
DRAWN BY : L.A.				
<u> </u>				
	CHECKED BY : M.J.M.			
DA	DATE :	FCC		REVISED RIP-RAP BANK PROTECTION DETAIL
SEPT.	PT. 2002	BY	NO.	REVISION
CHECK M.	ED BY :	_	<u>₹</u>	

NOTES AND DETAILS

F.C.C. WORK ORDER NO. ____528 FILE NAME: G:/Drawings/520/NotesandDetails.dwg

SEWER MAIN OUTFALL 600' SCALE MAP NO. ___16___ BLOCK NO. _5 and 6___

CONTRACT NO. 20-3673-D DYMEK PROPERTY SEWER MAIN OUTFALL HOWARD COUNTY, MARYLAND DYMEK PROPERTY

CONTRACT NO. 20-3673-D THIRD ELECTION DISTRICT HOWARD COUNTY, MARYLAND

SHEET 5 of 5

SCALE

SHOWN