

APPROXIMATE LOCATION OF EXISTING MAINS ARE SHOWN. THE CONTRACTOR SHALL TAKE ALL NECESSARY PRECAUTIONS TO PROTECT EXISTING MAINS AND SERVICES AND MAINTAIN UNINTERRUPTED SUPPLY. ANY DAMAGE INCURRED SHALL BE REPAIRED IMMEDIATELY TO THE SATISFACTION OF THE ENGINEER AT THE CONTRACTOR'S EXPENSE.
2. ALL HORIZONTAL CONTROLS ARE BASED ON MARYLAND STATE

COORDINATES, (NORTH AMERICAN DATUM OF 1983(NAD 83)) ALL VERTICAL CONTROLS ARE BASED ON U.S.G.S. DATA. ALL PIPE ELEVATIONS SHOWN ARE INVERT ELEVATIONS. 5. CLEAR ALL UTILITIES BY A MINIMUM OF 6". CLEAR ALL POLES BY 2" - 0" MINIMUM OR TUNNEL AS REQUIRED. THE OWNER HAS CONTACTED THE UTILITY COMPANIES AND HAS MADE ARRANGEMENTS FOR BRACING OF POLES AS SHOWN ON THE DRAWINGS. IN THE EVENT THE CONTRACTOR'S WORK REQUIRES THE BRACING OF ADDITIONAL POLES, ANY COST INCURRED BY THE OWNER FOR BRACING OF ADDITIONAL POLES OR DAMAGES SHALL BE DEDUCTED FROM MONEY OWED THE CONTRACTOR, THE CONTRACTOR SHALL COORDINATE WITH THE UTILITY COMPANIES TO SCHEDULE THE BRACING OF THE

POLES.

6. FOR DETAILS NOT SHOWN ON THE DRAWINGS AND FOR MATERIALS AND CONSTRUCTION METHODS USE HOWARD COUNTY DESIGN MANUAL, VOLUME IV, STANDARD SPECIFICATIONS AND DETAIL FOR CONSTRUCTION (LATEST EDITION). THE CONTRACTOR SHALL HAVE A COPY OF VOLUME IV ON THE JOB.

7. WHERE TEST PITS HAVE BEEN MADE ON EXISTING UTILITIES, THEY ARE

NOTED BY THE SYMBOL AT THE LOCATION OF THE TEST PIT. A NOTE OR NOTES CONTAINING THE RESULTS OF THE TEST PIT OR PITS IS INCLUDED ON THE DRAWINGS. EXISTING UTILITIES IN THE VICINITY OF THE PROPOSED WORK FOR WHICH TEST PITS HAVE NOT BEEN DUG SHALL BE LOCATED BY THE CONTRACTOR TWO WEEKS IN ADVANCE OF CONSTRUCTION OPERATIONS AT HIS OWN EXPENSE. CONTRACTOR SHALL NOTIFY THE FOLLOWING UTILITY COMPANIES OR AGENCIES AT LEAST FIVE WORKING DAYS BEFORE STARTING WORK SHOWN ON THESE PLANS:

> STATE HIGHWAY ADMINISTRATION BG&E CO. CONTRACTOR SERVICES BG&E CO. UNDER GROUND DAMAGE CONTROL MISS UTILITY

COLONIAL PIPELINE CO. HOWARD COUNTY DEPARTMENT OF PUBLIC WORKS BUREAU OF UTILITIES CHESAPEAKE & POTOMAC TELEPHONE CO.

9. TREES AND SHRUBS ARE TO BE PROTECTED FROM DAMAGE TO MAXIMUM EXTENT. TREES AND SHRUBS LOCATED WITHIN THE CONSTRUCTION STRIP ARE NOT TO BE REMOVED OR DAMAGED BY THE CONTRACTOR. IO. CONTRACTOR SHALL REMOVE TREES, STUMPS, AND ROOTS ALONG LINE OF EXCAVATION, PAYMENT FOR SUCH REMOVAL SHALL BE INCLUDED IN THE UNIT PRICE BID FOR CONSTRUCTION OF THE MAIN. II. THE CONTRACTOR SHALL NOTIFY THE BUREAU OF HIGHWAYS, HOWARD COUNTY, AT (410) 313-2450 AT LEAST FIVE WORKING DAYS BEFORE ANY OPEN CUT OF ANY COUNTY ROAD OR BORING/JACKING OPERATION IN COUNTY ROADS FOR LAYING WATER/SEWER MAINS OR HOUSE CONNECTIONS. THE APPROVAL OF THESE DRAWINGS WILL CONSTITUTE COMPLIANCE WITH DPW REQUIREMENTS PER SECTION

PART II - WATER

ALL WATER MAINS TO BE D.I.P. CLASS 52 UNLESS OTHERWISE NOTED. TOPS OF ALL WATER MAINS TO HAVE A MINIMUM OF 3-1/2' COVER UNLESS OTHERWISE NOTED.

3. VALVES ADJACENT TO TEES SHALL BE STRAPPED TO TEES.

4. ALL FITTINGS SHALL BE BUTTRESSED OR ANCHORED WITH CONCRETE IN ACCORDANCE WITH THE STANDARD DETAILS UNLESS OTHERWISE PROVIDED FOR ON THE DRAWINGS.

5. FIRE HYDRANTS SHALL BE SET TO THE BURY LINE ELEVATIONS SHOWN ON THE DRAWINGS. ALL FIRE HYDRANTS SHALL BE RESTRAINED AND BUTTRESSED WITH CONCRETE IN ACCORDANCE WITH STANDARD DETAILS SOIL AROUND THE FIRE HYDRANT SHALL BE COMPACTED IN DETAILS, SOIL AROUND THE FIRE HYDRANT SHALL BE COMPACTED IN ACCORDANCE WITH SECTION 1000 AND 1005 OF THE STANDARD SPECIFICATIONS. 6. THE CONTRACTOR SHALL NOT OPERATE ANY WATER MAIN VALVES ON THE EXISTING WATER SYSTEM. 7. ALL WATER HOUSE CONNECTIONS SHALL BE FOR INSIDE METER SETTING UNLESS OTHERWISE NOTED ON PLANS OR IN SPECIFICATIONS.

PART III - SEWER

1. ALL SEWER MAINS SHALL BE DIP AND P.V.C. UNLESS OTHERWISE NOTED. ALL MANHOLES SHALL BE 4' - O'INSIDE DIAMETER UNLESS OTHERWISE NOTED.

FORCE MAINS SHALL BE D.I.P. ONLY. MANHOLES SHOWN WITH 12" AND 16" WALLS ARE FOR BRICK MANHOLES ONLY. MANHOLES DESIGNATED W.T. IN PLAN AND PROFILE SHALL HAVE WATERTIGHT FRAME AND COVERS, STANDARD DETAIL G5.52. WHERE WATERTIGHT MANHOLE FRAME AND COVER IS USED, SET TOP OF FRAME I" - 6" ABOVE FINISHED GRADE UNLESS OTHERWISE NOTED ON THE DRAWINGS. 6. HOUSE(S) WITH THE SYMBOL "C.N.S." INDICATES THAT CELLAR CANNOT BE SERVED.

DATE 600 SCALE MAP NO. ______36_

8. SPRINKLER SYSTEM FOR ALL TOWNHOMES OR MULTI-FAMILY

DWELLING UNITS SHOULD HAVE A MINIMUM OF 1" CONNECTION WITH A 34" METER.

VICINITY MAP

SCALE: P = 600"

TYPE OF BUILDING: NO. OF LOTS / PARCELS NO. OF WATER HOUSE CONNECTIONS: NO. OF SEWER HOUSE CONNECTIONS:
DRAINAGE AREA: LITTLE PATUXENT TREATMENT PLANT:

LITTLE PATUXENT WATER QUALITY MANAGEMENT CENTER-SAVAGE HOWARD COUNTY WATER CODE: TEST GRADIENT: SEWER CODE:

SHEET INDEX DESCRIPTION WATER AND SEWER PLAN, VICINITY MAP & GENERAL NOTES PROFILE OF WATER AND SEWER MAINS

		QUAN	TITIES				
	QUANTITIES ESTIMATED	AS-BUILT					
ITEM		QUANTITIES	TYPE	MANUFACTURERSUPPLIE			
8' SEWER	J22 LF	123 LF	PVC	UM Manufacturer/Filts			
			5DR 36				
MANHOLES	40' VF	1 EA	Brecast Conc.	Atlantic Conc. Product			
eye e missengil kememiliyigin di eneki siste kop tayyidan yay dimemor, ibi damilika den imedii madii madii madi	TEA	na Giristanday da musuni kanageri makani indigi banyak malali ayah malali gali di Salimina di Makayi Managa ba	And the state of t	en Grand Branches (1975) de region de Resident (1985) de region de Residen			
6"WATER	0	IO LE	DIP. CL:52	Atlantic States /Fitter			
8' WATER	78 LF	79 LF	DIP C1- 52	, u			
12" WATER	570 LF	590 LF	DIPCL-52				
8" VALVE	The state of the s	1		Mueller 6./45 Filter			
IZ" VALVE		1	GateValve				
FIRE HYDRANTS		1	A 423	Centurian F.H.			
G'VALVE	1	1		Mueller Co./U.S. Filt			
NAME OF UTILITY CONTRACTOR W.F. Wilson, Inc.							

AS-BUILTS

BROKEN LAND PARKWAY MALL ACCESS EXTENSION

SECTION 2 AREA 9 PHASE 224

PARCEL 81

SCALE 1'' = 50'SHEET

1 OF 2

BENCHMARK

DESCRIPTION

ELEVATIONS SHOWN HEREON ARE BASED ON THE FOLLOWING TRAVERSE STATIONS ESTABLISHED BY * FISHER, COLLINS AND CARTER, INC.* (NGVD 29 VERTICAL DATUM) E 838550.3680 TR 906 N 504280.1630 ELEV. 381.500 TR 907 N 504400.6701 E 838647,7701 ELEV. 394.150

REVIEWED FOR HOWARD SOIL CONSERVATION DISTRICT AND MEETS_TECHNICAL REQUIREMENT

THIS DEVELOPMENT PLAN IS APPROVED FOR SOIL EROSION AND SEDIMENT CONTROL BY THE HOWARD COUNTY CONSERVATION DISTRICT.

HOWARD COUNTY, MARYLAND

HOWARD S.C.D.

mones DEPARTMENT OF PLANNING & ZONING DEPARTMENT OF PUBLIC WORKS

SEDIMENT CONTROL MEASURES WILL

BE IMPLEMENTED IN ACCORDANCE WITH

SECTION 219 OF THE SPECIFICATIONS AND

WITH ROAD CONSTRUCTION PLANS F-97-159

Daft · McCune · Walker, Inc. A Team of Land Planners, 200 East Pennsylvania Avenue Towson, Maryland 21286 410 296 3333 Landscape Architects.



18.114(A) OF THE HOWARD COUNTY CODE.

	DESIGN BY:			Λ	
- The second	JWS				
	DRAWN BY: JWS				100
	CHECKED BY:				\\
***************************************	JWR	******			
	DATE: 6-18-97			Š.	
1		BY	NO.	REVISION	

1-410-865-3803 1-410-531-5533

1-410-850-4620

1-410-787-9068 1-800-257-7777

1-410-795-1390

1-410-313-4900

1-410-597-8585

WATER & SEWER PLAN VICINITY MAP AND GENERAL NOTES

_BLOCK NO. ____1_


CONTRACT NO. ___ 24-3632-D


DEVELOPMENT ENGINEERING DIVISION - DATI

HOWARD COUNTY, MARYLAND

Engineers.Surveyors & Fax 296 4705 Environmental Professionals

Tue due 17 22,06:35 1937 - 01.9501961.9501961.451

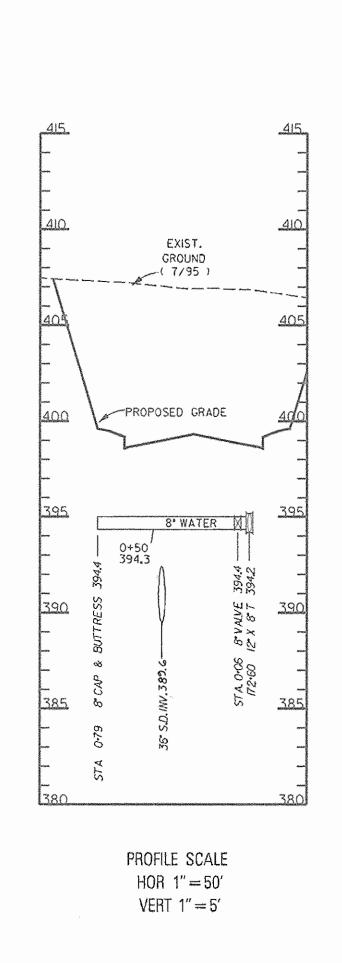

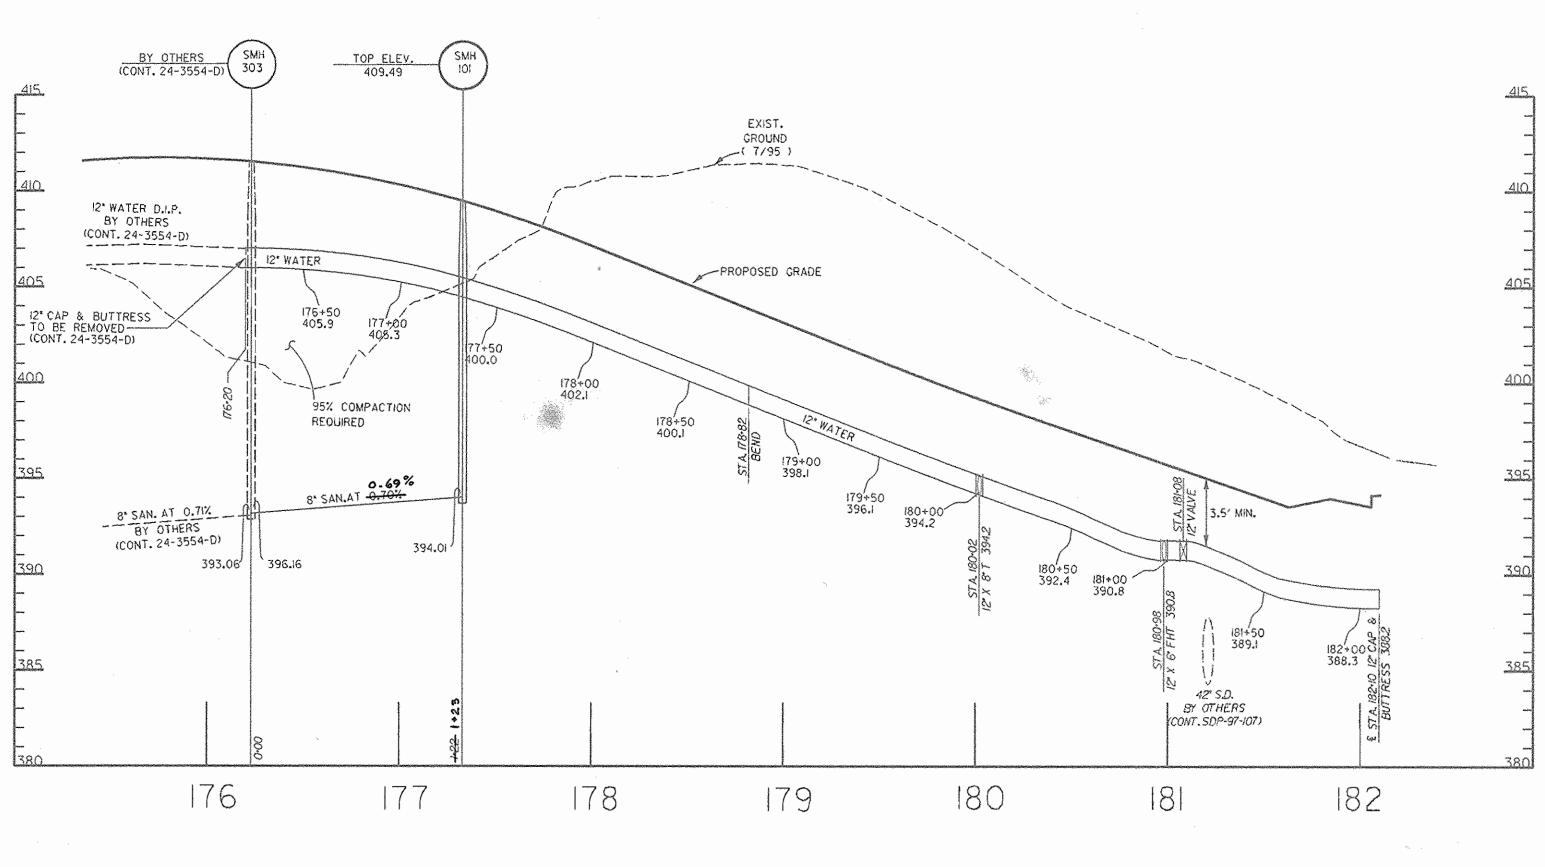

PROFILE SCALE
HOR 1"=50'
VERT 1"=5'

DATE 600 SCALE MAP NO. 36

DEPARTMENT OF PUBLIC WORKS
HOWARD COUNTY, MARYLAND

DEPARTMENT OF PLANNING & ZONING HOWARD COUNTY, MARYLAND

CHIEF - DEVELOPMENT ENGINEERING DIVISION - DATE

Daft · McCune · Walker, Inc.

A Team of Land Planners.
Landscape Architects.
Engineers. Surveyors & 410 296 3333
Environmental Professionals Fax 296 4705



DESIGN BY: JWS			
DRAWN BY: JWS			
CHECKED BY: JWR			
DATE:			
6–18–97	BY	NO.	REVISION
		on the second second second	

WATER & SEWER PROFILES

BLOCK NO. 1

BROKEN LAND PARKWAY
MALL ACCESS EXTENSION
SECTION 2 AREA 9 PHASE 224

SECTION 2 AREA 9 PHASE 224
TAX MAP 36 PARCEL 81

CONTRACT NO. 24–3632–D

2 OF 2

SCALE

AS SHOWN

SHEET