
QUANTITIES							
ITEM	BID	AS-BUILT	SUPPLIER				
8" WATER	262 L.F.						
8"×6" FHT	1 EA.						
8"x8" TS&V	1 EA .						
FIRE HYDRANT	2 EA.						
6" VALVE	3 EA						
6" WATER	201 L.F.						
8" PLUG	1 EA.						
8 -1/8 VERT. BEND	2 EA.						
8"x6" TS&V	1 EA.						
6"x6" FHT	1 EA.						
4" SHC (1EA.)	13 L.F.						

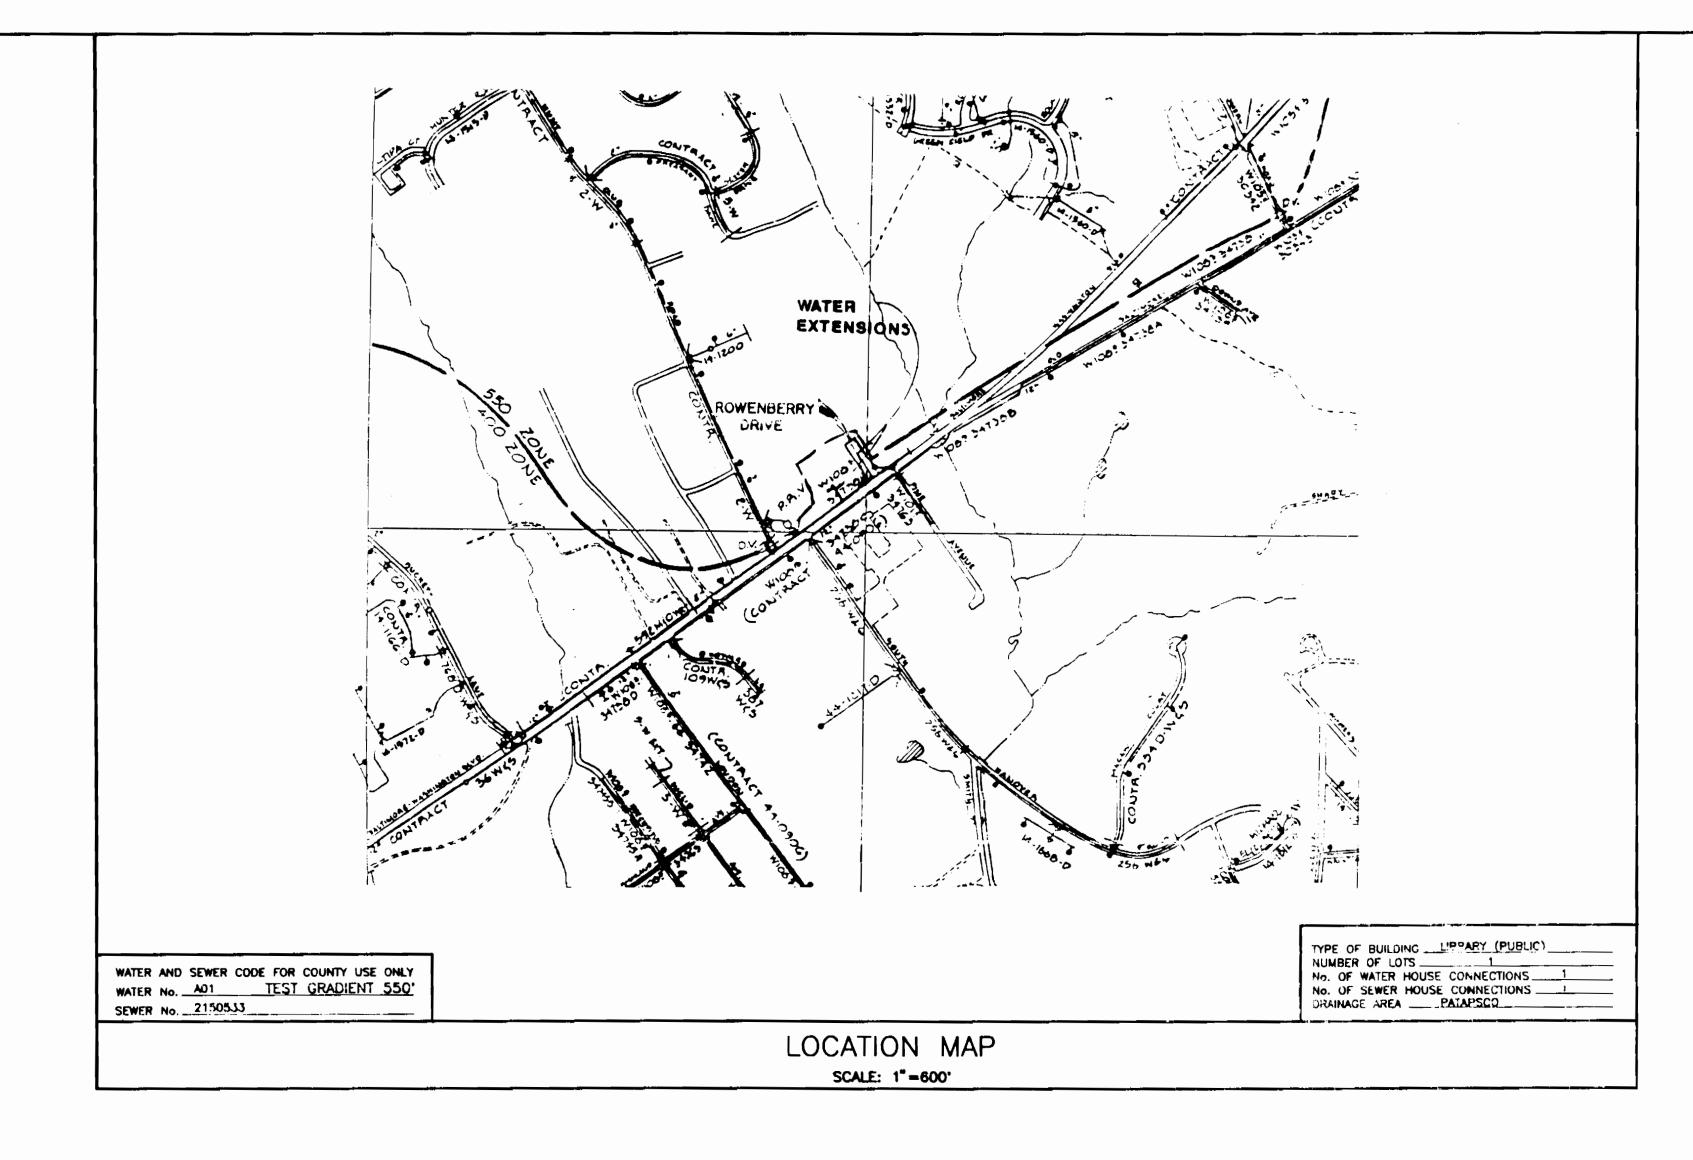

CONTRACT No. 14-3171 ROWENBERRY DRIVE ELKRIDGE LIBRARY

WATER MAIN EXTENSION

HOWARD COUNTY, MARYLAND DEPARTMENT OF PUBLIC WORKS

GENERAL NOTES

- APPROXIMATE LOCATION OF EXISTING MAINS ARE SHOWN. THE CONTRACTOR SHALL TAKE ALL NECESSARY PRECAUTIONS TO PROTECT EXISTING MAINS AND SERVICES AND MAINTAIN UNINTERRUPTED SUPPLY. ANY DAMAGE INCURRED SHALL BE REPAIRED IMMEDIATELY TO THE SATISFACTION OF THE ENGINEER. AT THE CONTRACTOR'S
- ALL HORIZONTAL CONTROLS ARE BASED ON MARYLAND STATE COORDINATES.
- ALL VERTICAL CONTROLS ARE BASED ON U.S.G.S. DATUM. ALL PIPE ELEVATIONS SHOWN ARE INVERT ELEVATIONS.

OF THE MAIN.

- CLEAR ALL UTILITIES BY A MINIMUM OF 6". CLEAR ALL POLES BY 2'-0" MINIMUM OR TUNNEL AS REQUIRED ANY COST INCURRED TO THE CONTRACTOR FOR TUNNELING OR BRACING AT POLES SHALL BE INCLUDED IN UNIT PRICES BID FOR CONSTRUCTION
- FOR DETAILS NOT SHOWN ON THE DRAWINGS USE HOWARD COUNTY STANDARD DETAILS. CONTRACTUR SHALL LOCATE EXISTING UTILITIES A MINIMUM OF TWO (2) WEEKS IN
- ADVANCE OF CONSTRUCTION OPERATIONS IN THE VICINITY OF PROPOSED OFFICIALS. AT HIS OWN EXPENSE. 8. CONTRACTOR SHALL NOTIFY THE FOLLOWING UTILITIES OR AGENCIES AT LEAST FIVE
 - (5) WORKING DAYS BEFORE STARTING WORK SHOWN ON THESE PLANS. STATE HIGHWAY ADMINISTRATION 531-5533
 - BALTIMORE GAS AND ELECTRIC COMPANY UNDERGROUND GAS & ELECTRIC DISTRIBUTION CUSTOMER SERVICE 685-0123
 - ENGINEERING "DAMAGE CONTROL" 234-5611
 - "MISS UTILITY" 1-800-257-7777
 - CHESAPEAKE & POTOMAC (C & P) TELEPHONE COMPANY 725-9976
 - AMERICAN TELEPHONE AND TELEGRAPH CABLE LOCATION DIVISION 393-3533 COLONIAL PIPELINE COMPANY 795-9976 BUREAU OF UTILITIES HOWARD COUNTY 313-4900
- 9. TREES ARE TO BE PROTECTED FROM DAMAGE TO MAXIMUM EXTENT. TREES LOCATED WITHIN THE CONSTRUCTION STRIP ARE NOT TO BE REMOVED OR DAMAGED BY THE CONTRACTOR. 10. CONTRACTOR SHALL REMOVE TREES, STUMPS, AND ROOTS ALONG LINE OF EXCAVATION
- AS DIRECTED BY THE ENGINEER. PAYMENT FOR SUCH REMOVAL SHALL BE INCLUDED. IN THE UNIT PRICE BID FOR CONSTRUCTION OF THE MAIN.
- 11. PLACE REGULATION "MEN WORKING" AND WARNING SIGNS AS REQUIRED TO COMPLY WITH MARYLAND STATE HIGHWAY ADMINISTRATION MANUAL OF TRAFFIC CONTROL FOR HIGHWAY CONSTRUCTION AND MAINTENANCE.
- 12. ALL WATER MAINS TO BE D.I.P. CLASS 52 ONLY. 13. TOP OF ALL WATER MAINS TO HAVE A MINIMUM OF 3-1/2' COVER UNLESS OTHERWISE
- 14. VALVES ADJACENT TO THES SHALL BE STRAPPED TO TEES.
- 15. BLOCK ALL FITTINGS WITH CONCRETE.
- 16. BURY LINE ELEVATIONS ON FIRE HYDRANTS SHALL BE SET AS SHOWN ON THE DRAWINGS. ALL FIRE HYDRANTS SHALL BE STRAPPED AND BUTTRESSED WITH CONCRETE IN ACCORDANCE WITH STANDARD DETAILS. SOIL AROUND THE FIRE HYDRANT TO BE COMPACTED IN ACCORDANCE WITH SECTION 1000 AND 1005 OF THIS STANDARD SPECIFICATIONS.
- 17. ALL WATER HOUSE CONNECTIONS SHALL BE FOR AN INCIDE METER SETTING UNLESS
- 18. THE CONTRACTOR SHALL NOT OPERATE ANY WATER MAIN VALVES ON THE EXISTING
- 19. POR/ALL/COPPER/WATER MOUSE/COMMECIAINS, ATIMZE AXAMED THIE ATAMOS
- 20. ALL SEWER MAINS SHALL BE C.S.P.X., R.C.S.P., V.C.P.X., -A.C.P. CLASS 2400
- OR PVC UNLESS OTHERWISE NOTED.
- 21. THE CONTRACTOR SHALL PROVIDE A JOINT IN ALL SEWER MAINS WITHIN 2'0" OF EXTERIOR MANHOLF WALL
- 22. ALL MANHOLES SHALL BE 4'-C" INSIDE DIAMETER, UNLESS OTHERWISE NOTED. 23. FORCE MAINS SHALL BE D.I.P. ONLY.
- 24. MANHOLES SHOWN WITH 12" AND 16" WALLS ARE FOR BRICK MANHOLES ONLY. 25. MANHOLES DESIGNATED W.T. IN PLAN AND PROFILE SHALL HAVE WATERTIGHT FRAME
- AND COVERS. STANDARD DETAIL G.5.52 WHERE WATERTIGHT MANHOLE FRAME AND COVER IS USED, SET TOP OF FRAME 1'6" ABOVE FINISH GRADE, STANDARD DETAIL.
- 26. HOUSE(S) WITH THE SYMBOL "C.N.S." INDICATES THAT CELLAR CAN NOT BE
- 27. ALL D.I.P FITTINGS SHALL BE IN ACCORDANCE WITH AWWA SPECIFICATION C-153 DUCTILE IRON COMPACT FITTINGS 3" THROUGH 12" WIDTH.
- 28. ALL SEWER HOUSE CONNECTIONS SHALL BE AT 2% SCOPE AND ARE 4" DIAMETER UNLESS OTHERWISE SHOWN.
- 29. ALL 3" BLOW-OFF SHALL BE PER STANDARD DETAIL W.4.13
- 30. ALL CONSTRUCTION TO BE DONE AS PER THIS PLAN AND CURRENT HOWARD COUNTY DESIGN MANUAL VOL. IV.
- 31. SEDIMENT CONTROL FOR WATER AND SEWER INSTALLATION AS PER SDP 91-83

BENCHMARKS

HO. CO. MONUMENT #2445004 ELEV.=192.59"

HO. CO. MONUMENT #2445005 ELEV.=172.65

AL'OCAD FILENAME: FILETIME.DWG

JALË: NO VE

ROWENBERRY DRIVE CONTRACT No. 14-3171 FIRST ELECTION DISTRICT HOWARD COUNTY, MARYLAND

SHEET No. W1

THIS DEVELOPMENT PLAN IS APPROVED FOR EROSION AND DIMENT CONTROL BY HOWARD SOIL CONSERVATION DISTRICT 1-10-9 CHIEF, BUREAU OF ENGINEERING DATE CHIEF, BUREAU OF UTILITIES 1-7-92 DATE (M) Jingon 1/9/92 CHIEF, LAND DEVELOPMENT DIVISION

SEDIMENT CONTROL MEASURES FOR THIS CONTRACT WILL BE IMPLEMENTED IN ACCORDANCE WITH SECTION 219 OF THE HOWARD COUNTY DESIGN MANUAL AND STANDARDS AND SPECIFICATIONS FOR SOIL EROSION AND SEDIMENT CONTROL

DEVELOPING AREAS AND ALSO AS SHOWN ON THE GRADING


AND SEDIMENT CONTROL PLAN.

GREENMAN-PEDERSEN INC. 14504 GREENVIEW DRIVE, SUITE 100, LAUREL, MD. 20708 MASH. (301) 470-2772 BALT. (301) 880-3055

REVISIONS D.J. DESCRIPTION DRAWN: D.J. R.L.C. DEC. 7 1991 600' SCALE MAP NO. 38

TITLE SHEET

BLOCK NO.

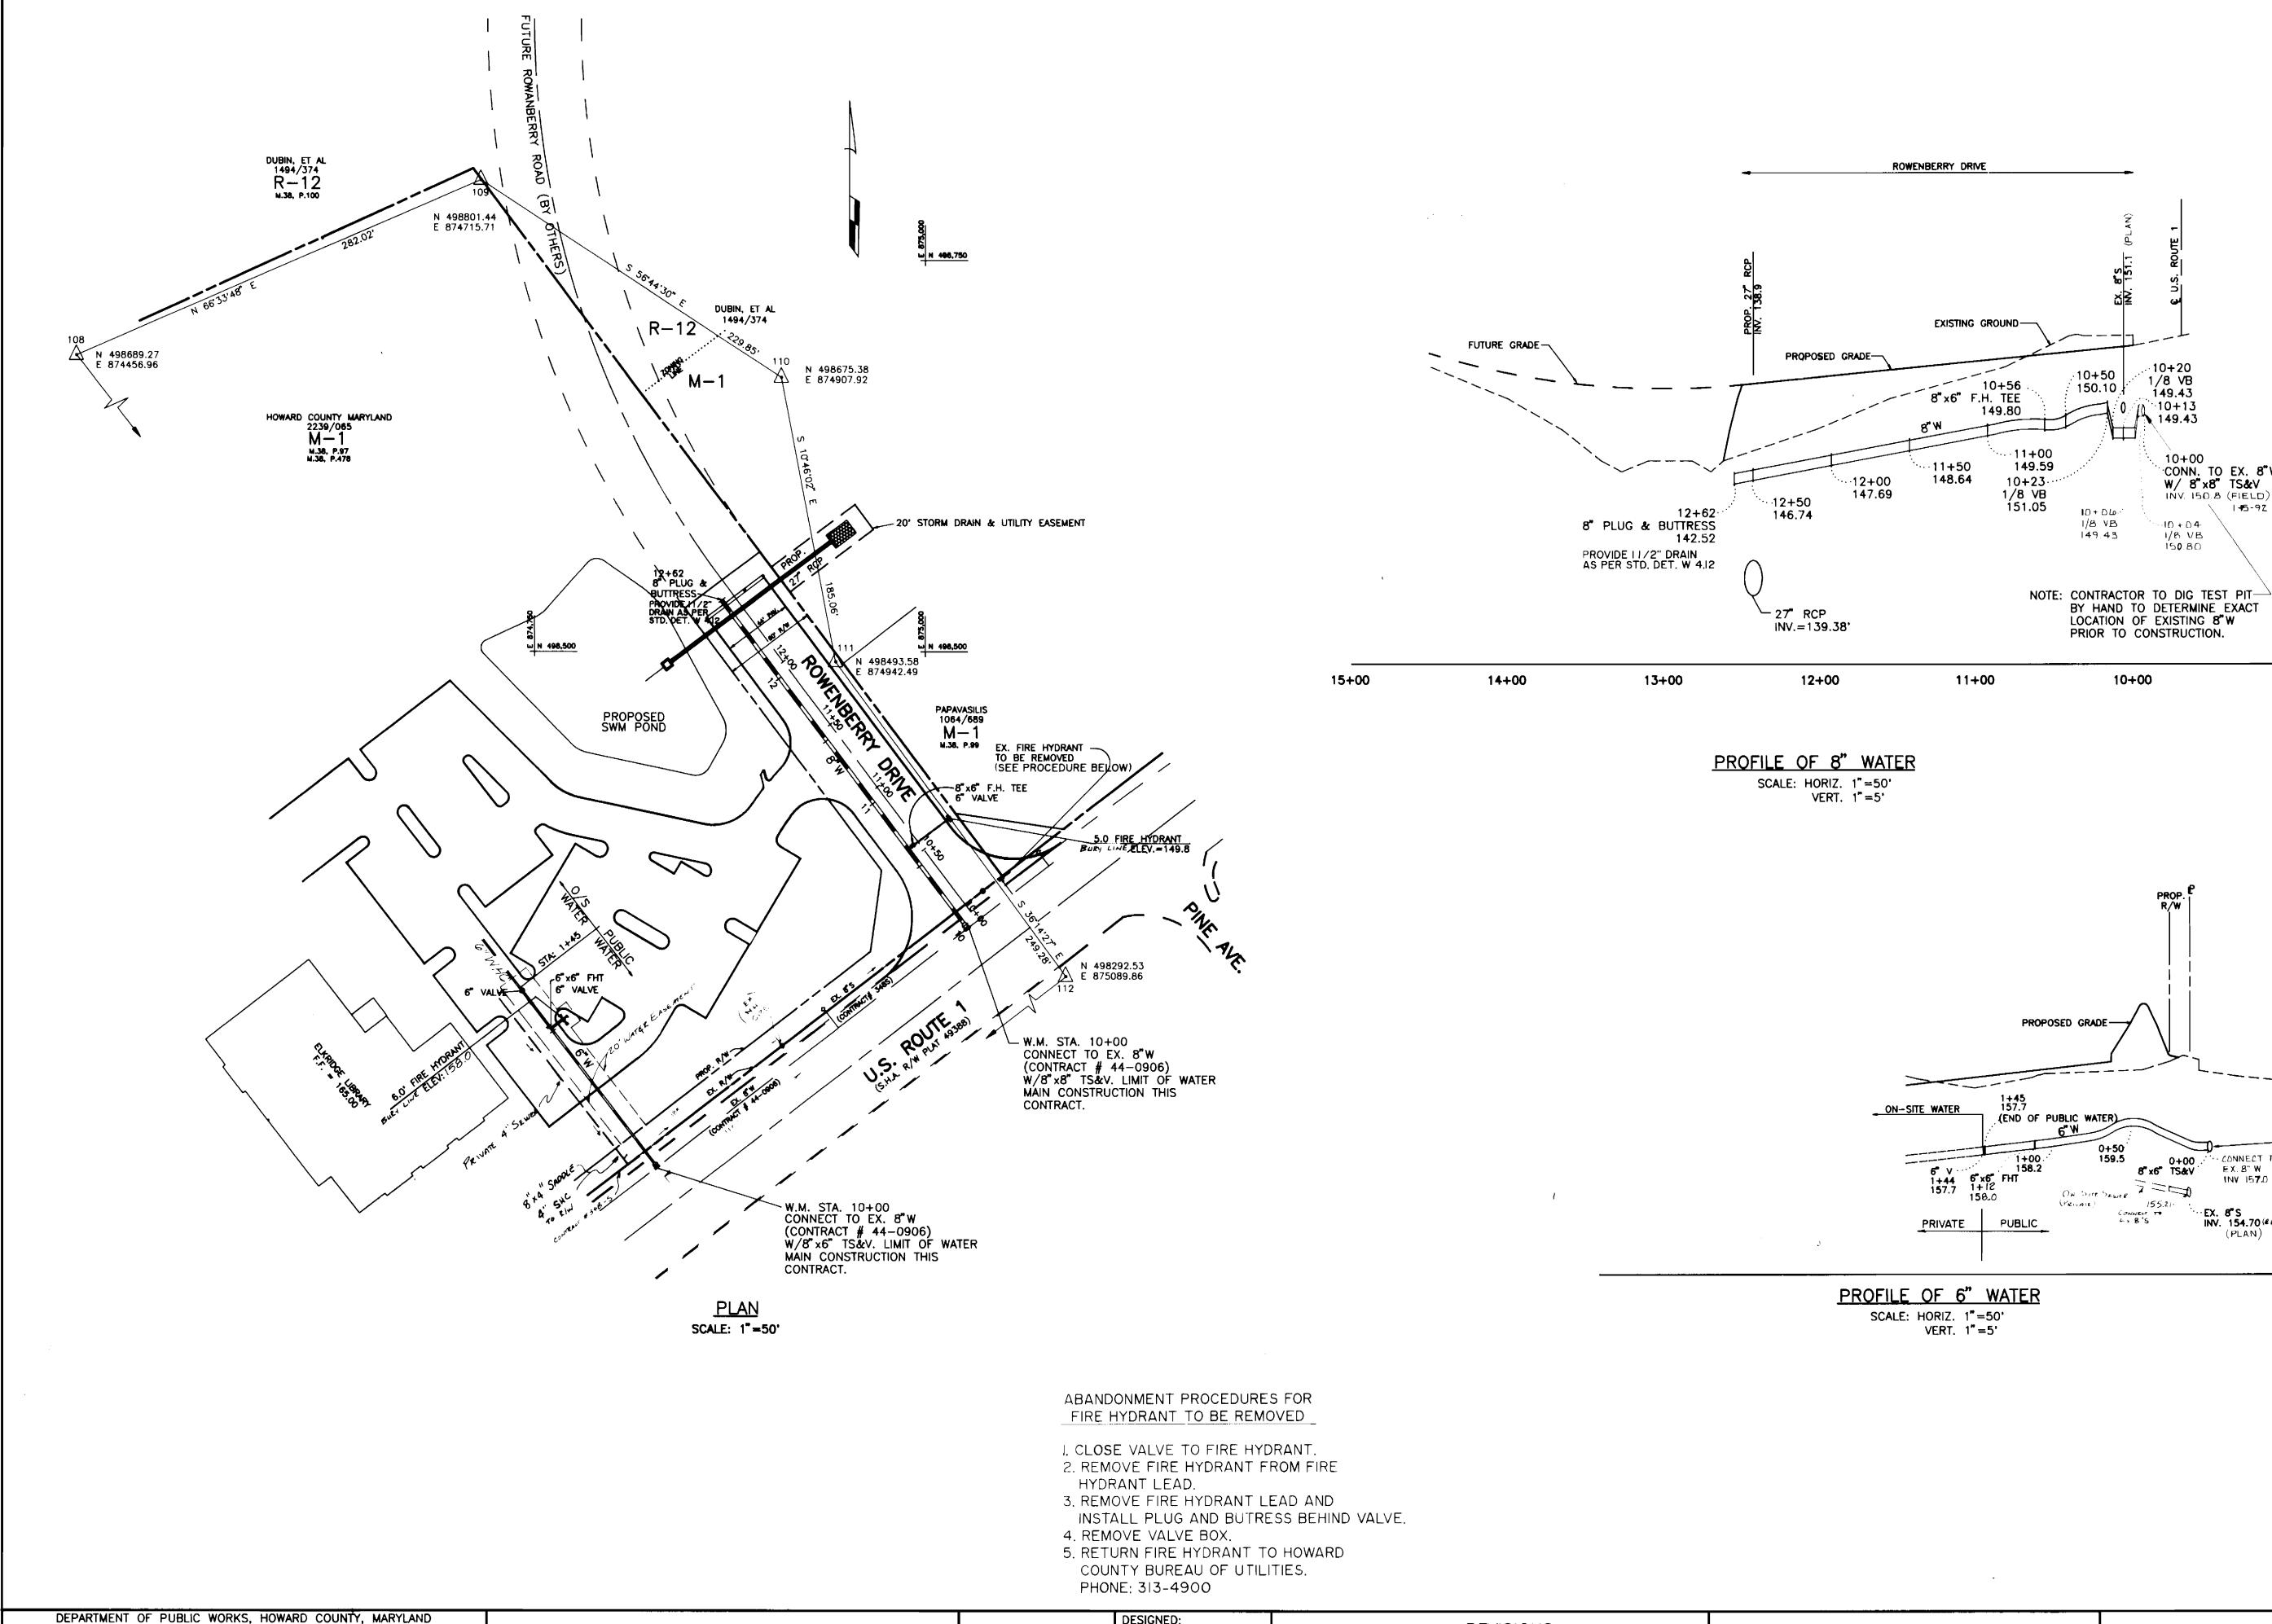


DATE DIRECTOR OF PUBLIC WORKS CHIEF, BUREAU OF ENGINEERING

CHIEF, BUREAU OF UTILITIES

HE CHIEF, LAND DEVELOPMENT DIVISION DATE 1-7-92 DATE, 1/9/95 DATE

GREENMAN-PEDERSEN INC. ENGINEERS/ARCHITECTS/PLANNERS 14504 GREENVIEW DRIVE, SUITE 100, LAUREL, MD. 20708 WASH. (301) 470-2772 BALT. (301) 880-3055

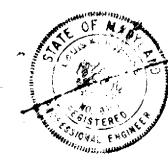

	DESIGNED:	M.A.H.	REVISIONS			
.	DRAWN:		BY	NO.	DESCRIPTION	DATE
٠		M.A.H.	KLL	1	REV. WE CONNECTIONS PER FIELD LOCATION DATA	2-10-92
	CHECKED:	R.L.C.				
•	DATE: ≀⊃∈	C.7,1991				

PLAN AND PROFILE WATER EXTENSION

ROWENBERRY DRIVE CONTRACT No. 14 - 3171 FIRST ELECTION DISTRICT HOWARD COUNTY, MARYLAND

155

DATUM ELEV 136.00

| 170

165

INV 157.0 (FIELD 1-16-92)

0+00 CONNECT TO EX.8" W

···EX. 8"S INV. 154.70 (4世)

(PLAN)

155.21. CONNEUT TO 4.8 5

(PRIVATE)

NOTE: CONTRACTOR TO DIG TEST PIT

BY HAND TO DETERMINE EXACT
LOCATION OF EXISTING 8"W
PRIOR TO CONSTRUCTION.

10+20 1/8 VB 149.43

·10+13 149.43

~10 + D4

I/B VB 15**0**.80

10+00 CONN. TO EX. 8"W W/ 8"x8" TS&V

INV. 150.8 (FIELD)

1+5-92 + 145

10+50 150.10

1/8 VB

149 43

10+00

SCALE: AS SHOWN SHEET No.W2

OF 2

AutoCAD FILENAME: RR-WTR2.DWG

600' SCALE MAP NO. 38 BLOCK NO. _