



PLAN
Scale: 1" = 50'

GENERAL NOTES

1. Approximate location of existing mains are shown. The Contractor shall take all necessary precautions to protect existing mains and services and maintain uninterrupted supply. Any damage incurred shall be repaired immediately.
2. All pipe elevations shown are invert elevations.
3. The Contractor shall locate existing utilities a minimum of two weeks in advance of construction operations in vicinity of utilities.
4. For all standard details see standards bound in Specifications.
5. Clear all utilities by a minimum of 6'. Clear all poles by a minimum of 2'-0" or tunnel as required.
6. The Contractor shall provide a joint in all sewer mains within 2'-0" of exterior manhole walls.
7. All manholes shall be 4'-0" inside diameter.
8. All horizontal and vertical controls are based on Maryland State Datum.

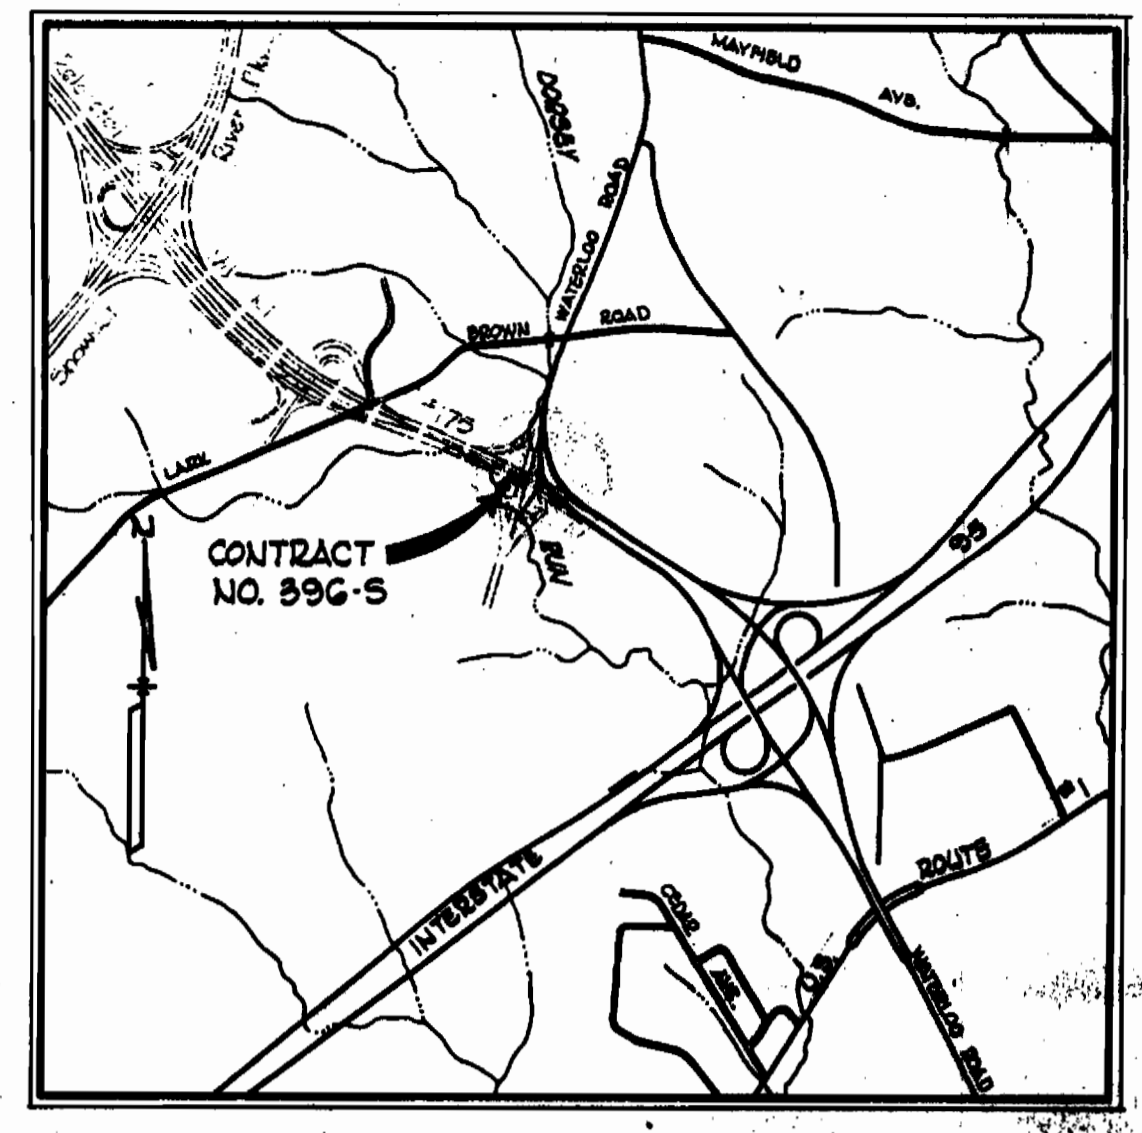

VICINITY MAP
Scale: 1" = 2000'

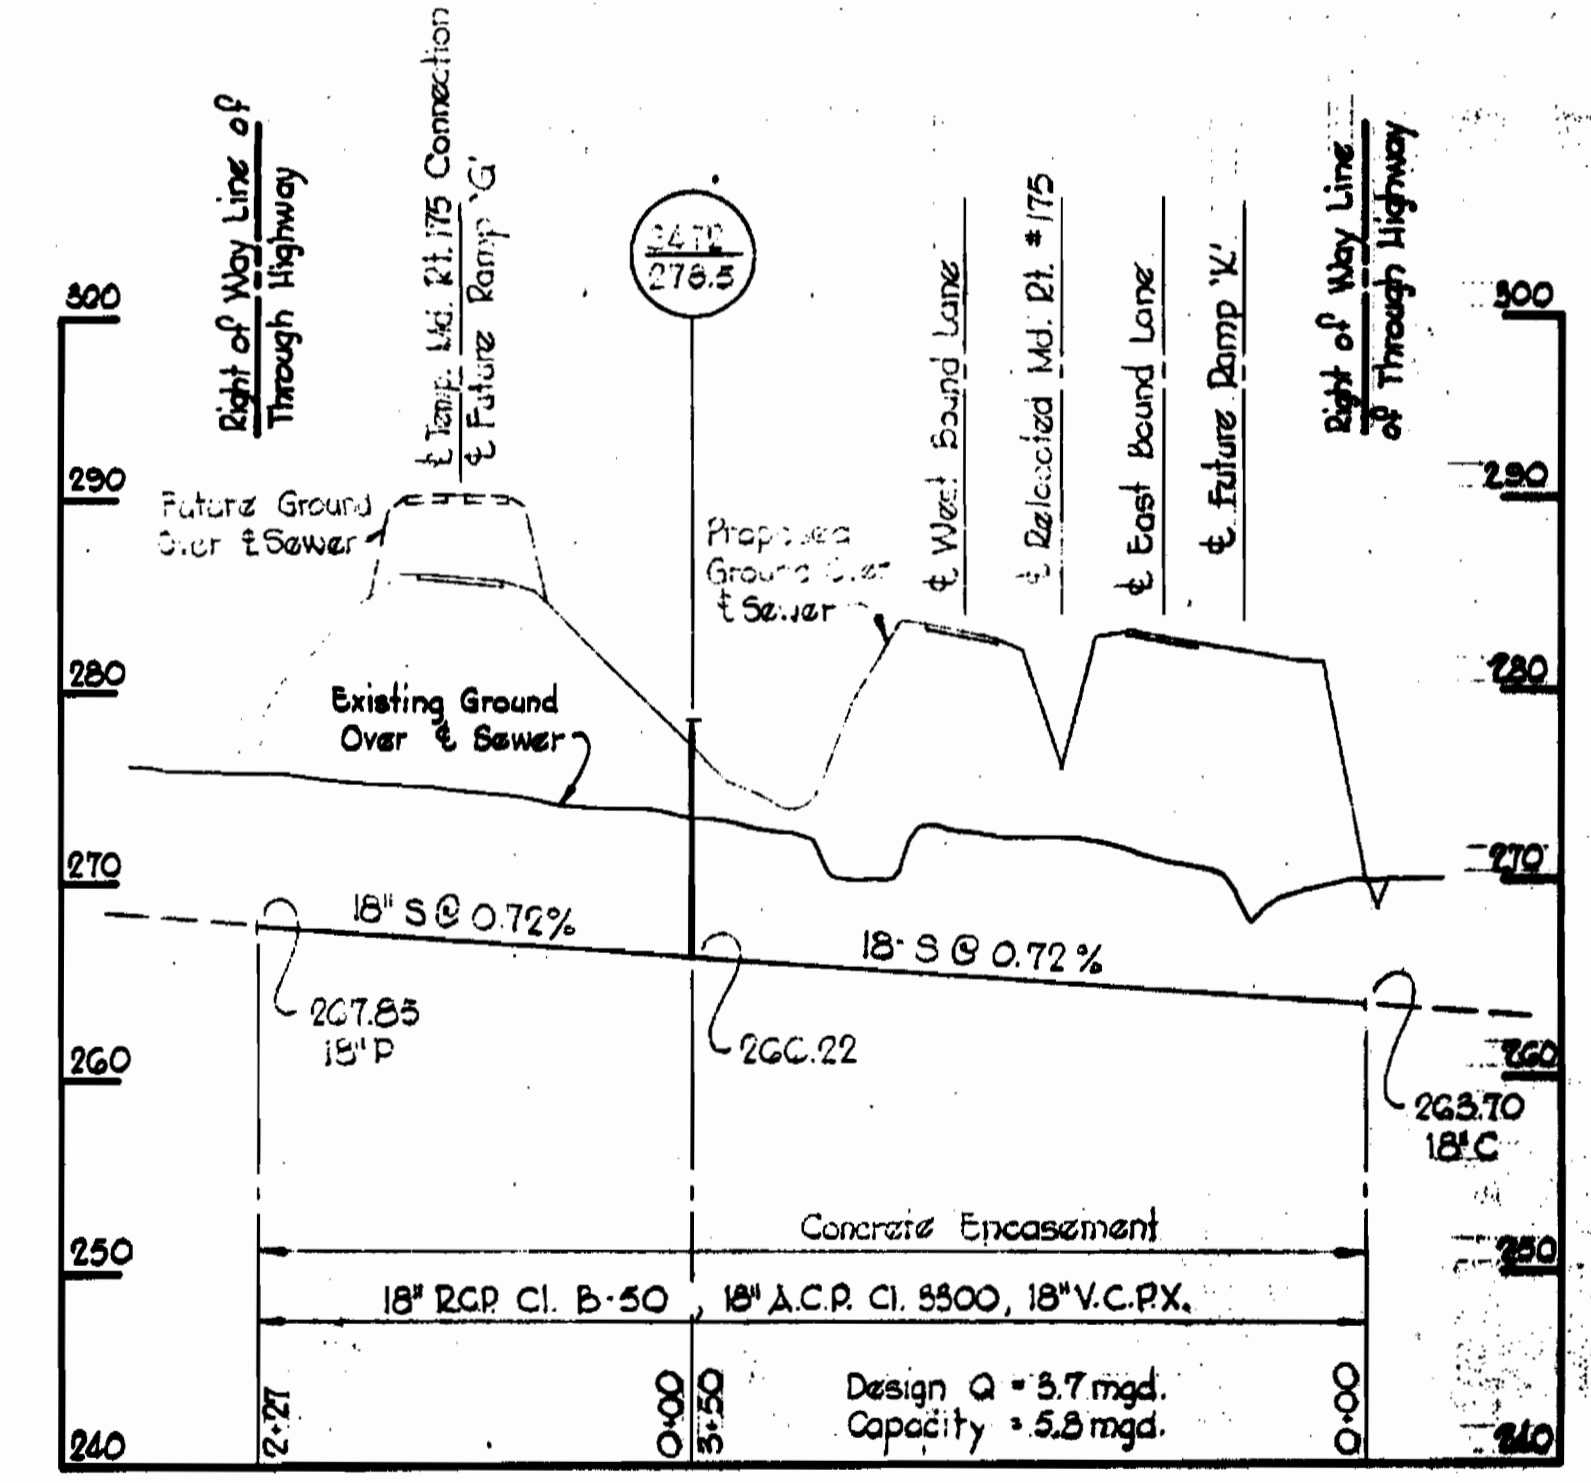

PROFILE
Scale: Horiz. 1" = 100'
Vert. 1" = 10'

NOTES:
Future proposed and existing ground over sewer taken from Green & Associates plans, profiles, cross-sections and contour maps for State Route Commission Contract No. 10-400-1-77B.



Kenneth A. McLeod

Contract No. 396-S

WHITMAN, REQUARDT & ASSOCIATES
ENGINEERS
1304 ST. PAUL ST.
BALTIMORE, MARYLAND

DEPARTMENT OF PUBLIC WORKS
HOWARD COUNTY, MARYLAND
DATE: 12-8-70
W. O. Pelletier
CHIEF - BUREAU OF WATER AND SEWER

CONTRACT NO. 396-S

PLAN AND PROFILE OF
SEWER MAINS

ELECTION DISTRICT
GUILFORD NO. 6

DRAWING NO. 1 OF 1
SCALE AS SHOWN