

SHEET INDEX	
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2	SITE DEVELOPMENT PLAN
3	DRAINAGE AREA MAP AND SEDIMENT CONTROL PLAN
4	NOTES AND DETAILS
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6	LANDSCAPE PLAN

SITE DEVELOPMENT PLAN


DORSEY HALL

SECTION 2 AREA 5 PARCEL 0-7

ASSISTED LIVING FACILITY

2nd ELECTION DISTRICT





HOWARD COUNTY, MARYLAND

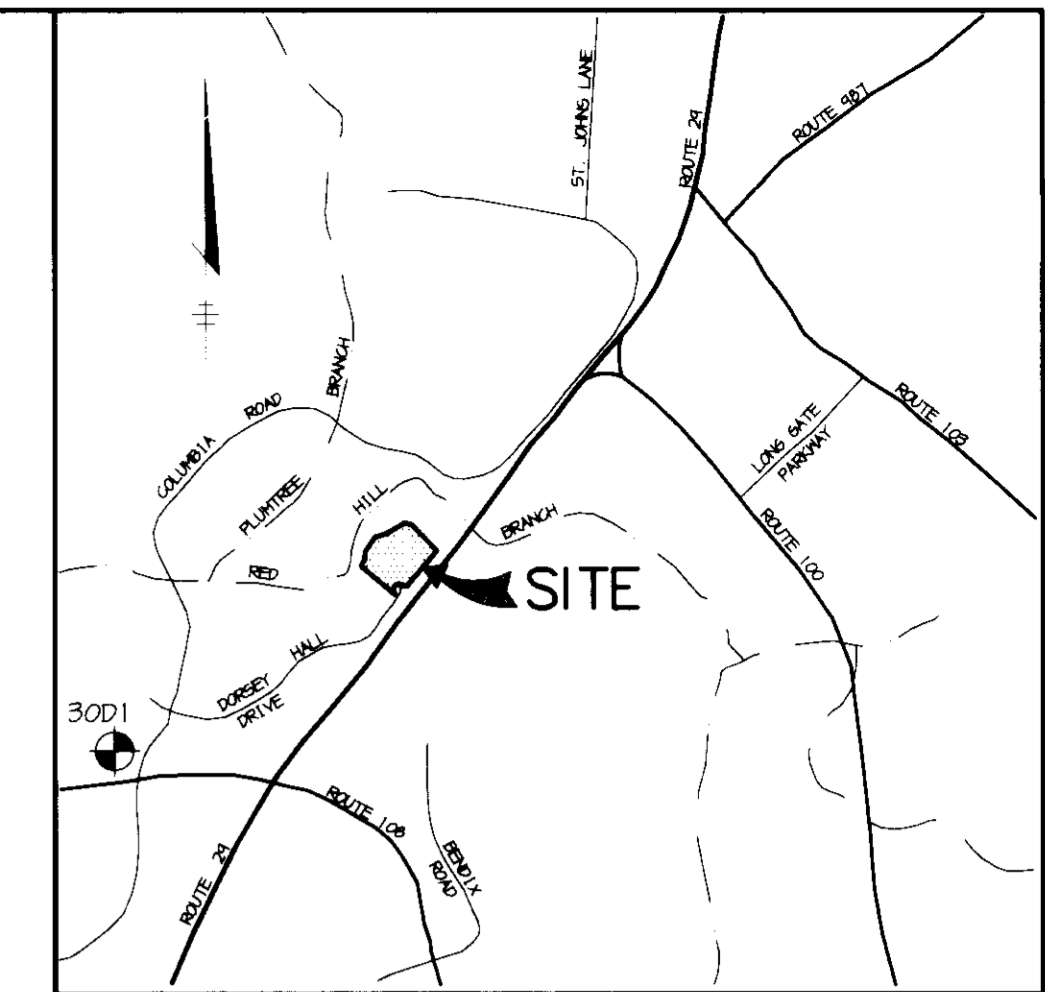

VICINITY MAP
SCALE: 1" = 2000'

GENERAL NOTES

- ALL CONSTRUCTION SHALL BE IN ACCORDANCE WITH THE LATEST STANDARDS AND SPECIFICATIONS OF HOWARD COUNTY PLUS MSHA STANDARDS AND SPECIFICATIONS, IF APPLICABLE.
- THE CONTRACTOR SHALL NOTIFY THE DEPARTMENT OF PUBLIC WORKS/BUREAU OF ENGINEERING/CONSTRUCTION INSPECTION DIVISION AT (410) 313-1600 AT LEAST FIVE (5) WORKING DAYS PRIOR TO THE START OF WORK.
- THE CONTRACTOR SHALL NOTIFY "MISS UTILITY" AT 1-800-251-7177 AT LEAST 48 HOURS PRIOR TO ANY EXCAVATION WORK BEING DONE.
- TRAFFIC CONTROL DEVICES, MARKINGS, AND SIGNING SHALL BE IN ACCORDANCE WITH THE LATEST EDITION OF THE MANUAL ON UNIFORM TRAFFIC CONTROL DEVICES (MUTCD). ALL STREET AND REGULATORY SIGNS SHALL BE IN PLACE PRIOR TO THE PLACEMENT OF ANY ASPHALT.
- ALL PLAN DIMENSIONS ARE TO FACE OF CURB AND FACE OF BUILDING UNLESS OTHERWISE NOTED.
- THE EXISTING TOPOGRAPHY IS TAKEN FROM FIELD SURVEY WITH MAXIMUM TWO FOOT CONTOUR INTERVALS PREPARED BY RIEMER MUEGGE & ASSOC. DATED JANUARY, 1997.
- THE COORDINATES SHOWN HEREON ARE BASED UPON THE HOWARD COUNTY GEODETIC CONTROL WHICH IS BASED UPON THE MARYLAND STATE PLANE COORDINATE SYSTEM.
- WATER SERVICE IS PUBLIC, CONTRACT NO. 24-1127-D.
- SEWER SERVICE IS PUBLIC, SEWER DRAINAGE AREA: 106P5. TREATMENT PLANT: LITTLE PATUXENT CONTRACT NO. 24-1127-D.
- THE STORMWATER MANAGEMENT QUANTITY FACILITY IS OFF-SITE UNDER F-05-16. WATER QUALITY IS PROVIDED BY AN ON-SITE, PRIVATELY MAINTAINED STORMWATER MANHOLE.
- APPROXIMATE LOCATION OF EXISTING UTILITIES ARE SHOWN. THE CONTRACTOR SHALL TAKE ALL NECESSARY PRECAUTIONS TO PROTECT THE EXISTING UTILITIES AND MAINTAIN UNINTERRUPTED SERVICE. ANY DAMAGE INCURRED DUE TO CONTRACTOR'S OPERATION SHALL BE REPAIRED IMMEDIATELY AT THE CONTRACTOR'S EXPENSE. EXISTING UTILITIES ARE SHOWN BASED ON THE BEST AVAILABLE INFORMATION.
- A 100-YEAR FLOODPLAIN STUDY IS NOT REQUIRED FOR THIS PROJECT. FLOODPLAIN IS SHOWN AT PROPERTY LINE PER PLAT #8866.
- A APFO TRAFFIC STUDY IS NOT REQUIRED FOR THIS PROJECT AS NO ALLOCATIONS ARE ISSUED FOR THIS DEVELOPMENT.
- A NOISE STUDY HAS BEEN PREPARED BY RIEMER MUEGGE & ASSOC. DATED MARCH 1997.
- NO GEOTECHNICAL STUDY FOR SHM IS REQUIRED FOR THIS PROJECT AS THIS SITE HAS BEEN MASS GRADED.
- THE BOUNDARY FOR THIS PROJECT IS BASED ON PREVIOUSLY RECORDED PLAT NO. 12690.
- SUBJECT PROPERTY ZONED FOR PER 10-18-93 COMPREHENSIVE ZONING PLAN.
- ALL ELEVATIONS SHOWN ARE BASED ON THE U.S.C. AND G.S. MEAN SEA LEVEL DATUM, 1929.
- SEE DEPARTMENT OF PLANNING AND ZONING FILE NO'S S-18-20, P-84-21, P-86-26, F-05-16, F-05-56, VP-01-01, F-00-31, F-01-247, F-01-184, F-01-06, F-01-134.
- THE CONTRACTOR SHALL TEST PIT EXISTING UTILITIES AT LEAST (5) DAYS BEFORE STARTING WORK SHOWN ON THESE DRAWINGS.
- CONTRACTOR IS SOLELY RESPONSIBLE FOR CONSTRUCTION MEANS, METHODS, TECHNIQUES, SEQUENCES, PROCEDURES, AND SAFETY PRECAUTIONS AND PROGRAMS.
- PIPE SHALL NOT BE INSTALLED BY THE CONTRACTOR UNTIL THE LENGTH CALLED FOR AT EACH STATION HAS BEEN APPROVED BY THE ENGINEER IN THE FIELD.
- NO PIPE SHALL BE LAID UNTIL LINES OF EXCAVATION HAVE BEEN BROUGHT WITHIN 6' OF FINISHED GRADE.
- ALL STORM DRAIN PIPE BEDDING SHALL BE CLASS 'C' AS SHOWN IN FIG. 11.4, VOLUME 1 OF HOWARD COUNTY DESIGN MANUAL UNLESS OTHERWISE NOTED.
- ALL INLETS SHALL BE CONSTRUCTED IN ACCORDANCE WITH HOWARD COUNTY STANDARDS.
- ALL PIPE ELEVATIONS SHOWN ARE INVERT ELEVATIONS.
- STORM DRAIN TRENCHES WITHIN ROAD RIGHT OF WAY SHALL BE BACKFILLED AND COMPACTED IN ACCORDANCE WITH THE HOWARD COUNTY DESIGN MANUAL, VOLUME IV, I. P., 5 STANDARD SPECIFICATIONS AND DETAILS FOR CONSTRUCTION, LATEST AMENDMENTS.
- PROFILE STATIONS SHALL BE ADJUSTED AS NECESSARY TO CONFORM TO PLAN DIMENSIONS.
- ALL FILL AREAS WITHIN ROADWAY AND UNDER STRUCTURES TO BE COMPACTED TO A MINIMUM OF 95% COMPACTION OF AASHTO T100.
- REINFORCED CONCRETE CIRCULAR PIPE (RCCP) MAY BE USED AS AN ALTERNATE TO ADS N-12 PIPING FOR THE STORM DRAIN SYSTEM ONLY. ALL STORM DRAIN PIPE TO BE INSTALLED PER SECTION 906 OF HO. CO. DESIGN MANUAL VOL. IV.
- THE PAVEMENT DETAILS SHOWN ON THESE PLANS REFLECT THE HOWARD COUNTY MINIMUM STANDARD PAVEMENT SECTIONS AND ARE NOT BASED ON SITE SPECIFIC CONDITIONS. PRIOR TO PAVING, THE FINAL PAVEMENT SECTIONS SHALL BE DETERMINED BY A QUALIFIED GEOTECHNICAL ENGINEER BASED ON IN-SITU TESTING OF THE FINISHED SUBGRADE. THE TESTING AND GEOTECHNICAL ENGINEER SHALL BE FURNISHED BY THE OWNER. IF THE PAVING SECTION REQUIRED IS LESS THAN THE COUNTY MINIMUM, APPROVAL FROM THE COUNTY WILL BE NECESSARY.
- THE 65 dBA NOISE CONTOUR LINE REPRESENTS THE APPROXIMATE LOCATION OF THE 65 dBA (DECIBEL) NOISE EXPOSURE GENERATED BY ROUTE 24 TRAFFIC IN THE YEAR 2015 BASED UPON ASSUMPTIONS ABOUT ACTUAL CONDITIONS AT THAT TIME. THIS VALUE REPRESENTS THE AVERAGE SOUND LEVEL DURING THE SINGLE NOISEST ONE-HOUR PERIOD OF VEHICULAR TRAFFIC DURING A TYPICAL DAY. THIS CALCULATION IS BASED ON THE SHA ESTIMATE OF THE YEAR 2015 HIGHWAY TRAFFIC VOLUME. THE CONTOUR LINE DRAWN ON THIS PLAN IS ADVISORY AS REQUIRED BY THE HO. CO. DESIGN MANUAL, CHAPTER 5 REVISED FEB. 1992 AND CANNOT BE CONSIDERED TO LOCATE EXACTLY THE 65 dBA EXPOSURE. THE 65 dBA THRESHOLD HAS ESTABLISHED BY HOWARD COUNTY TO ALERT DEVELOPERS, BUILDERS AND FUTURE RESIDENTS THAT AREAS BEYOND THIS THRESHOLD MAY EXCEED GENERALLY ACCEPTED NOISE LEVELS ESTABLISHED BY THE U.S. DEPARTMENT OF HOUSING AND URBAN DEVELOPMENT. THE PROPOSED BUILDING'S ARCHITECTURAL DESIGN WILL REDUCE THE EXTERIOR NOISE LEVEL TO A MAX. OF 45 dBA WITHIN THE DWELLING UNITS.
- NO CLEARING, GRADING OR CONSTRUCTION IS PERMITTED WITHIN THE WETLANDS OR STREAM BUFFERS EXCEPT AS DETERMINED ESSENTIAL BY THE DEPARTMENT OF PLANNING AND ZONING IN ACCORDANCE WITH SECTION 16.116 (c) OF THE SUBDIVISION AND LAND DEVELOPMENT REGULATIONS.

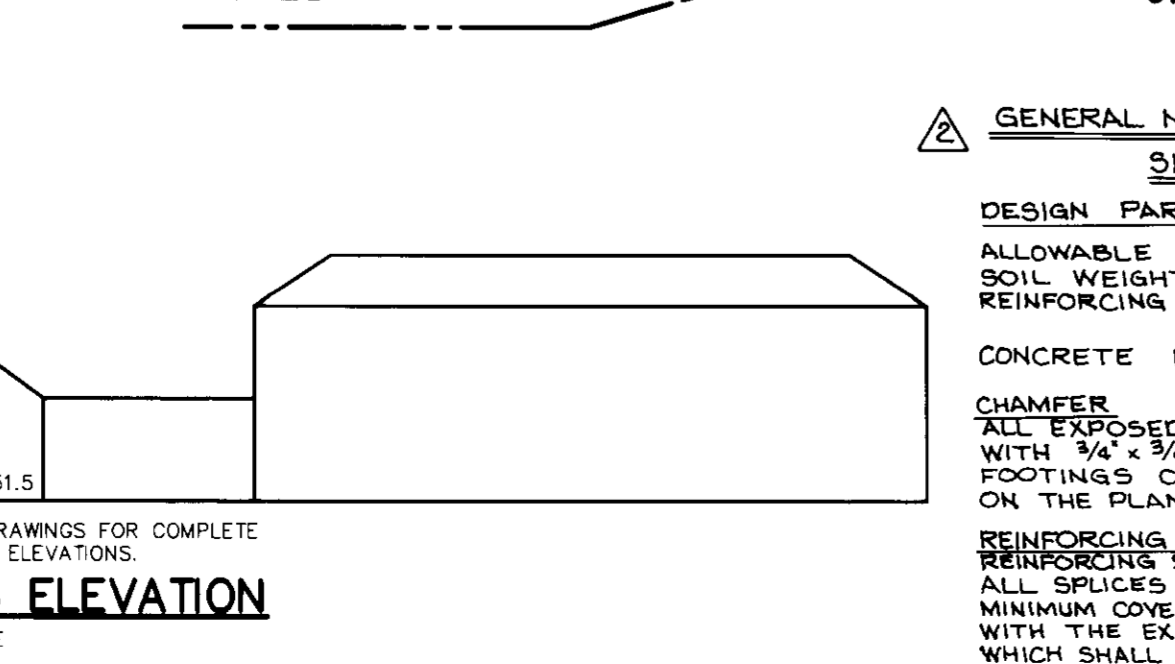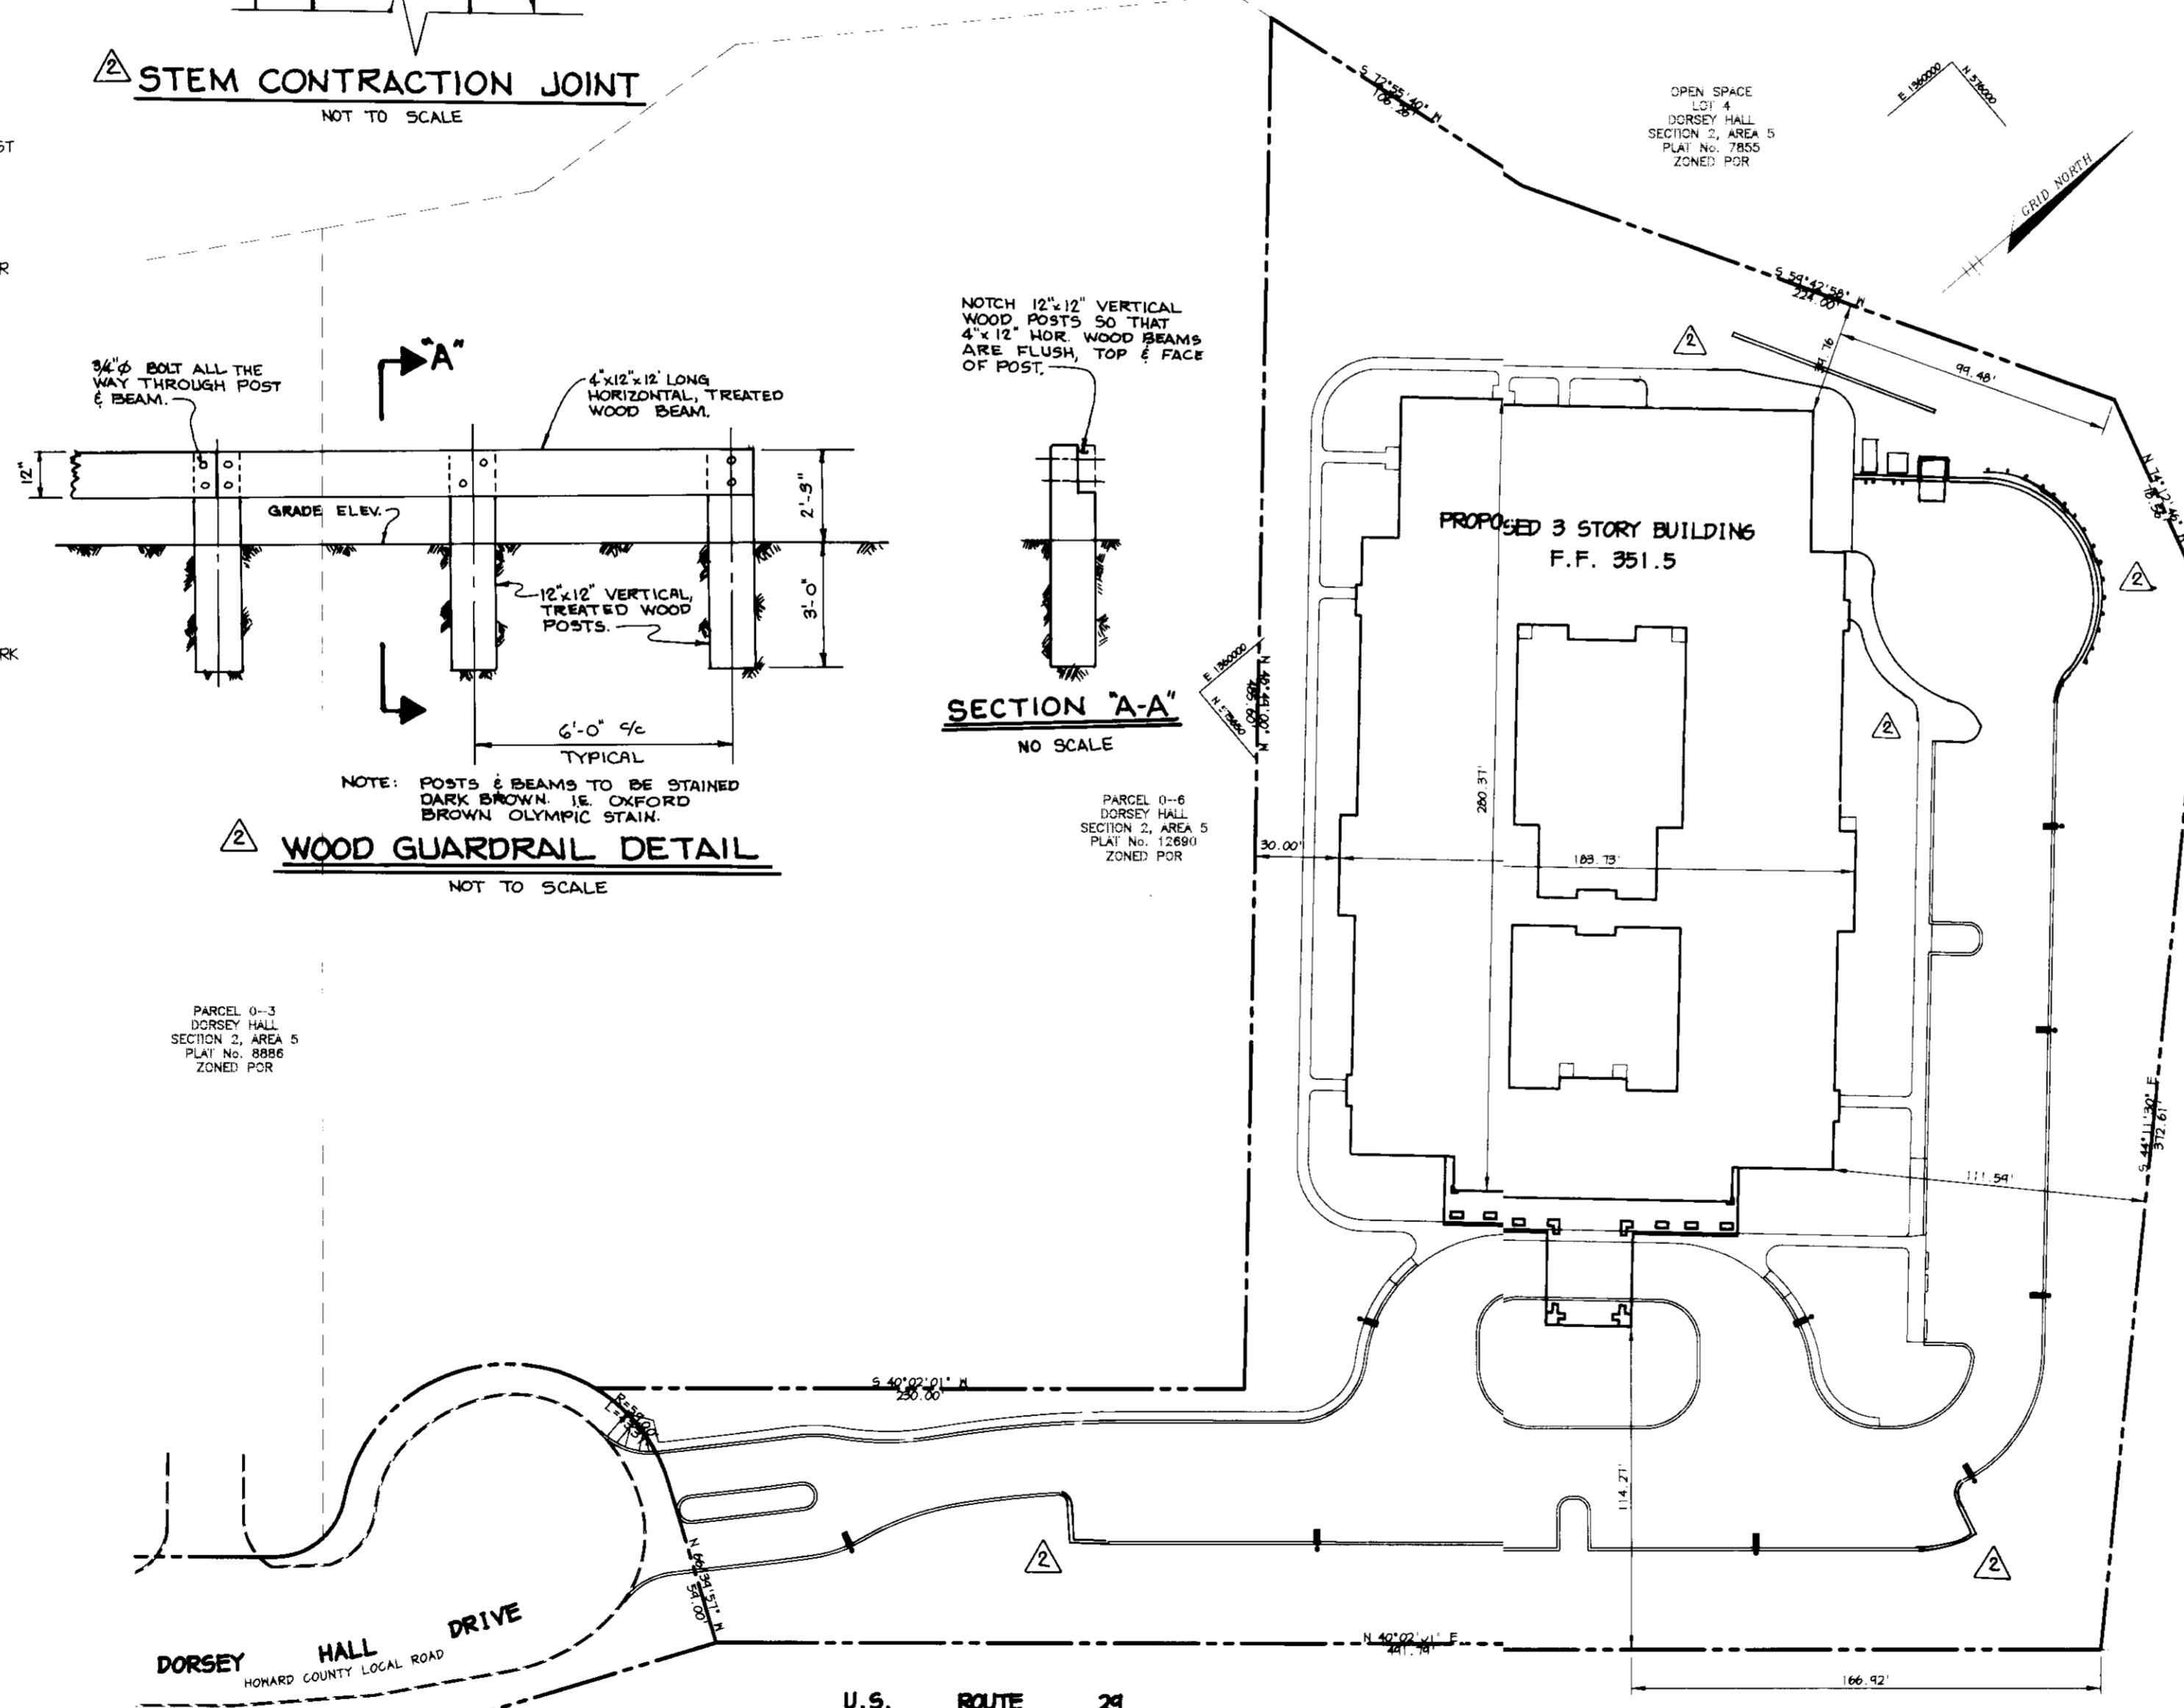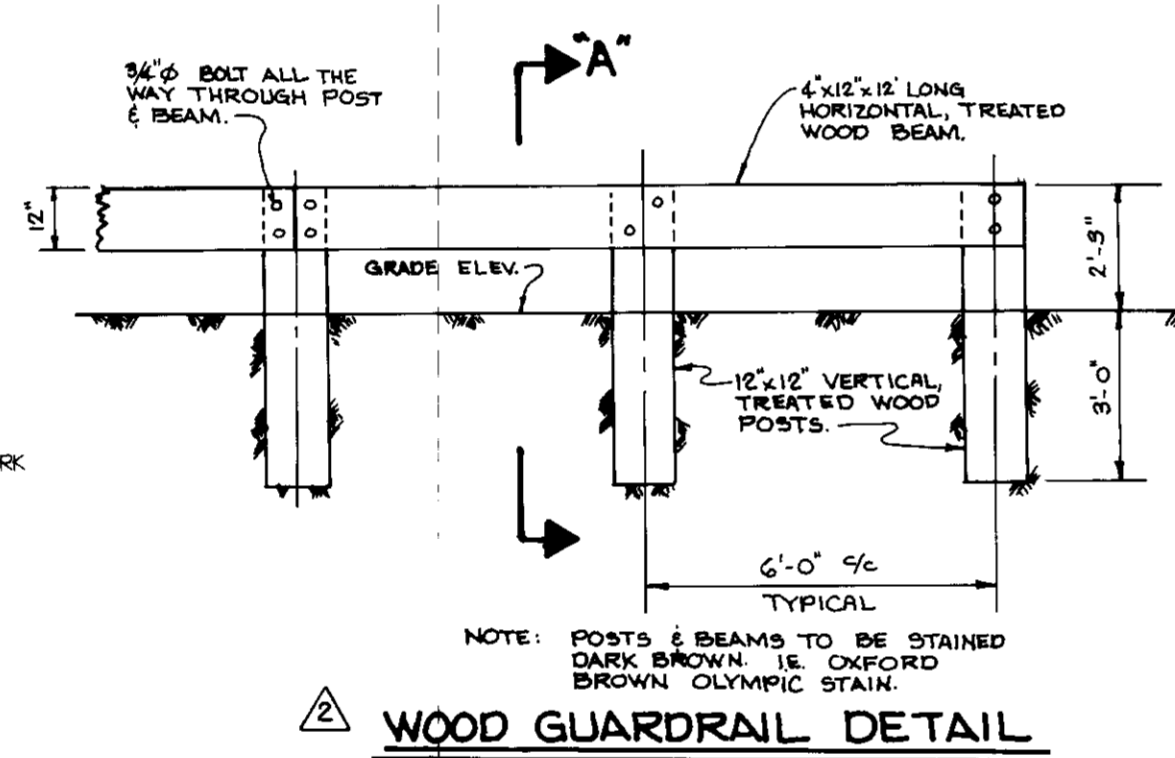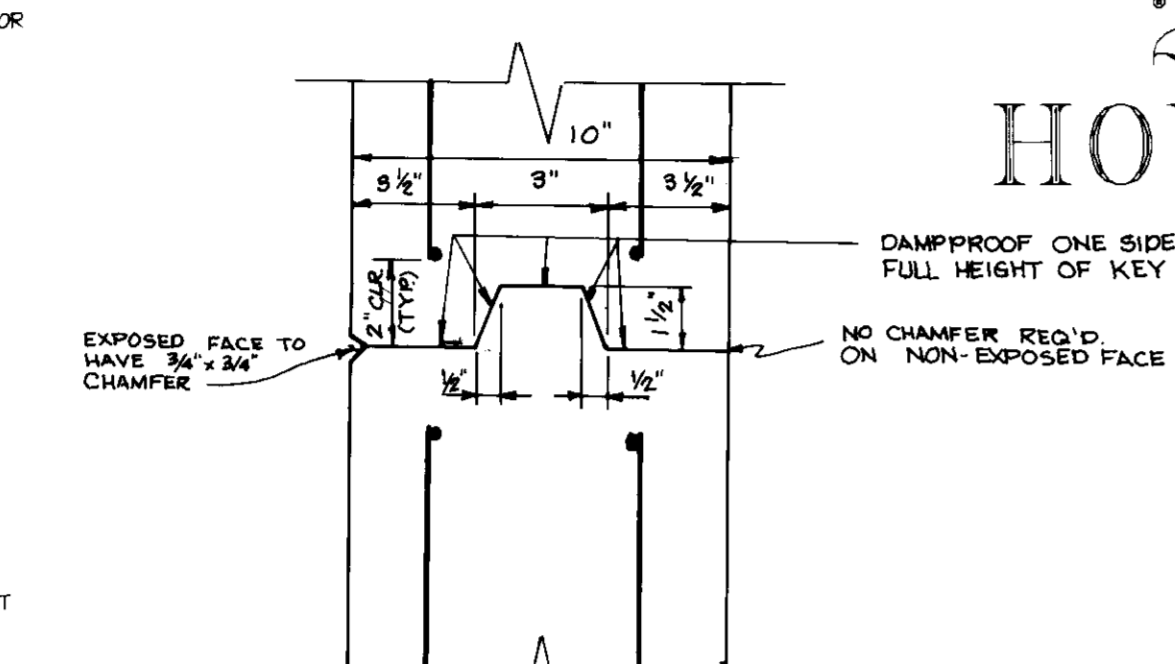

GENERAL NOTES: RETAINING WALL SPECIFICATIONS

DESIGN PARAMETERS:

- ALLOWABLE BEARING PRESSURE: 2500 Lbs/Ft²
- SOIL WEIGHT: 120 Lbs/Ft³
- REINFORCING STEEL DESIGN: $f_c = 12000$ PSI, $f_s = 2400$ PSI
- CONCRETE DESIGN: SERVICE LOAD DESIGN METHOD

CHAMFER: ALL EXPOSED CORNERS OF CONCRETE SHALL BE CHAMFERED WITH 3/4" x 3/4" MILLED CHAMFER STRIPS, EXCEPT ON UNEXPOSED FOOTINGS OR WHERE INDICATED BY THE FOLLOWING NOTATION ON THE PLANS, "DO NOT CHAMFER."

REINFORCING STEEL: REINFORCING STEEL SHALL CONFORM TO ASTM A-615 GRADE 60. ALL SPLICES NOT SHOWN SHALL BE LAPPED AS PER BAR LAP CHARTS. MINIMUM COVER FOR ANY BAR SHALL BE 2" UNLESS OTHERWISE NOTED, WITH THE EXCEPTION OF BARS AT THE BOTTOM OF ALL FOOTINGS WHICH SHALL HAVE A 3" MINIMUM COVER.

KEYS: ALL KEYS ARE NOMINAL SIZE. JOINTS:

- JOINT LOCATIONS AS SHOWN ON DRAWING.
- STOP KEY 9" BELOW TOP OF WALL.
- REINFORCING STEEL SHALL NOT PASS THROUGH VERTICAL CONTRACTION OR EXPANSION JOINT.
- CONTRACTION & EXPANSION JOINTS TO BE IN STEM ONLY, (NOT IN FOOTINGS).

CONCRETE: CONCRETE FOR RETAINING WALLS TO BE MK NO.3 (3500 PSI)

FENCE: MATERIALS TO MEET REQUIREMENTS OF AASHTO M-181. MESH TO BE FIXED TO FRAME WITH #9 GALVANIZED STEEL WIRE.

BACKFILL: BACKFILL TO BE PLACED IN 6" LAYERS & COMPACTED TO 95% MOD-AASHTO.

- BACKFILL TO BE BROUGHT UP EVENLY ON BOTH SIDES OF WALL TO AVOID OVERLOADING WALL BY BACKFILLING ONE SIDE ONLY.

BENCHMARKS

SURVEY CONTROL STATION 30BA
N 573,149.04 E 1,357,083.22
ELEVATION 397.91


SURVEY CONTROL STATION 30D1
N 572,311.62 E 1,353,139.10
ELEVATION 409.97

SITE ANALYSIS

AREA OF PARCEL: 4.078 ACRES (177,638 SF)
DISTURBED AREA: 3.53 ACRES
PRESENT ZONING: POR
PROPOSED USE: ASSISTED LIVING FACILITY (110 UNITS, 119 BEDS) ΔBUILDING COVERAGE: 86,390 SF (48.6% OF SITE)
FIRST FLOOR: 24,740 SF
SECOND FLOOR: 24,740 SF
THIRD FLOOR: 24,740 SF

OF PARKING SPACES REQUIRED @ 1 SP./2 BEDS: Δ 60 SPACES
OF PARKING SPACES PROVIDED: Δ 55 SPACES (INCL. 3 HC)

PER HOWARD COUNTY ZONING REGULATIONS SECT. 133 D.7(1) HOWEVER, PER LETTER FROM DEVELOPER DATED SEPT. 2, 1997 THE ACTUAL PARKING REQUIRED FOR THIS DEVELOPMENT IS 46 SPACES. THE DIVISION OF LAND DEVELOPMENT APPROVED THE USE OF 55 PARKING SPACES TO SERVE 119 BEDS BASED UPON INFORMATION SUBMITTED BY THE DEVELOPER ON SEPT. 8, 1997.

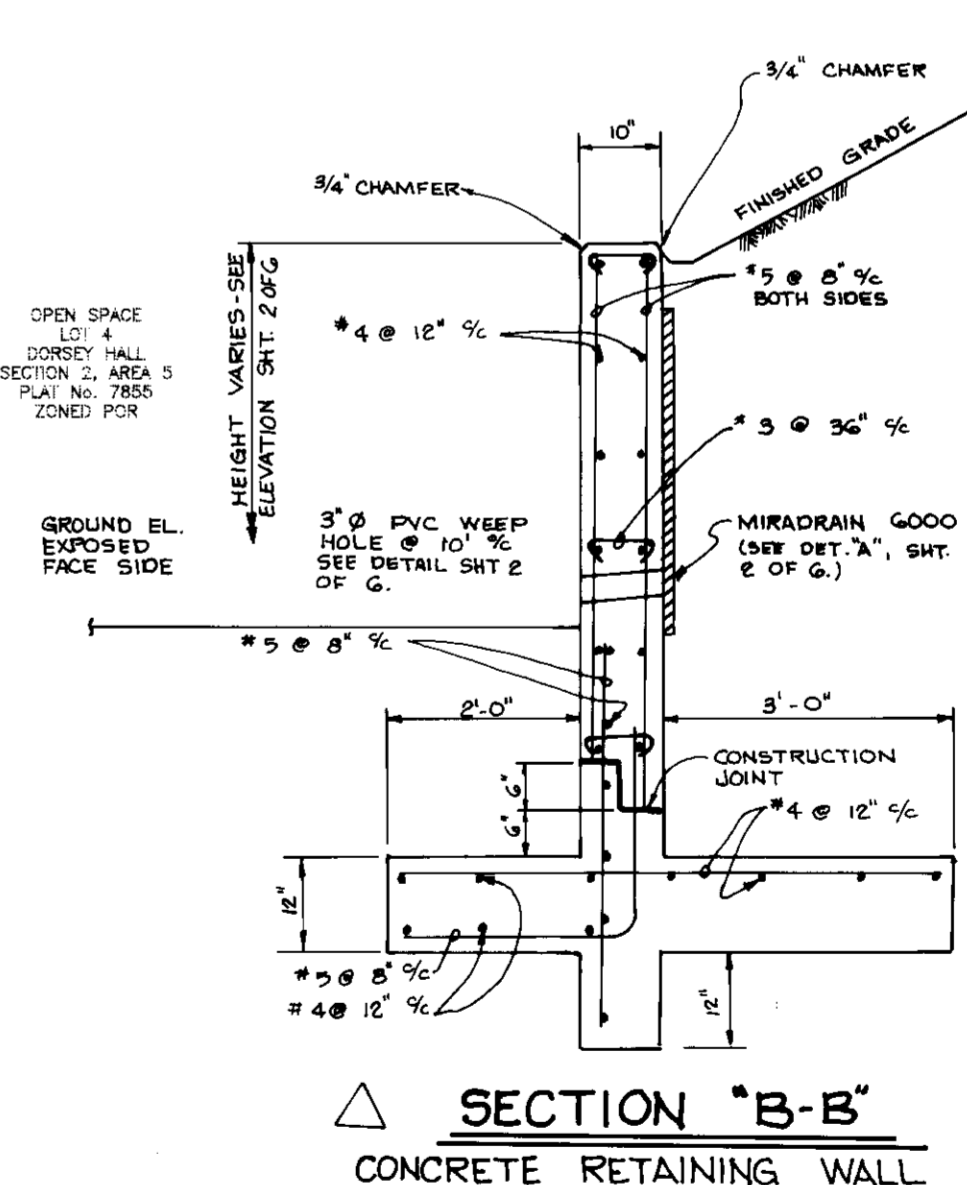

ADDRESS CHART			
PARCEL	STREET ADDRESS		
0-7	5330 DORSEY HALL DRIVE		

SUBDIVISION NAME	SECT./AREA	PARCEL
DORSEY HALL	2/5	0-7

PLAT #	BLOCK #	ZONING	TAX MAP NO.	ELECT. DIST.	CENSUS TRACT
12690	4	POR	30	2nd	6023.01

WATER CODE: F 08 SEWER CODE: 5750600

APPROVED: HOWARD COUNTY DEPARTMENT OF PLANNING AND ZONING.

J. Lankford 7/18/97 DATE
DIRECTOR

John Demme 7/17/97 DATE
CHIEF, DEVELOPMENT ENGINEERING DIVISION

Cinda Hamilton 7/18/97 DATE
CHIEF, DIVISION OF LAND DEVELOPMENT

REVISIONS:
8-9-98 GENERAL PLAN VIEW, ADDED DETAILS & SECTIONS, ADDED GENERAL NOTES & RETAIN. WALL SPECS.
9/18/97 Δ UPDATED NUMBER OF PROPOSED BEDS, ADDED NOTE PERTAINING TO PARKING.

OWNER: THE HOWARD RESEARCH & DEVELOPMENT CORP.
THE ROUSE BUILDING
10275 LITTLE PATUXENT PARKWAY
COLUMBIA, MARYLAND 21044
(410) 992-6000

DEVELOPER: CAREMATRIX CORPORATION
1871 FIRST AVENUE
NEEDHAM, MA 02194
(617) 433-1000

PROJECT: DORSEY HALL
ASSISTED LIVING FACILITY

AREA DORSEY HALL SECT 2 AREA 5 PARCEL 0-7
ZONED FOR TAX MAP 30 BLOCK 4
2nd ELECTION DISTRICT HOWARD COUNTY, MD.

TITLE: TITLE SHEET

RIEMER MUEGGE & ASSOCIATES, INC.
ENGINEERING • ENVIRONMENTAL SERVICES • PLANNING • SURVEYING
8818 Centre Park Drive, Columbia, Maryland 21045
tel 410.997.8900 fax 410.997.9282

6-27-97 DATE

DESIGNED BY: C.J.R.
DRAWN BY: DAM
PROJECT NO.: 96084
SDP1.DWG
DATE: JUNE 27, 1997
SCALE: AS SHOWN
DRAWING NO. 1 OF 6

J. Lankford
JAYKANT D. PAREKH #19148
SDP-97-102

NOTES

1. ALL CURB RADII ARE 5' UNLESS OTHERWISE LABELED.
2. ALL SITE LIGHTING TO BE DIRECTED/REFLECTED AWAY FROM ADJACENT RESIDENTIALLY ZONED PROPERTIES AND PUBLIC ROADS AND TO BE IN ACCORDANCE WITH BILL # 1-1987 (ZRA-8).
3. ALL ON-SITE ROADS ARE PRIVATE.
4. ALL DIMENSIONS SHOWN ARE TO FACE OF CURB OR BUILDING FACE UNLESS OTHERWISE NOTED.
5. THIS BUILDING WILL HAVE AN AUTOMATIC FIRE PROTECTION SPRINKLER SYSTEM.
6. THE STORM DRAIN SYSTEM SHALL BE BUILT ACCORDING TO THE CRITERIA IN SECTION 308 OF THE HOWARD COUNTY DESIGN MANUAL, VOLUME IV, "NONMETALLIC PIPES AND DRAINAGE TILES".
7. SEE SHEET 1 FOR BUILDING DIMENSIONS AND TIE-DOWNS.

RETAINING WALL - CORNER COORDINATES

- ① N. 575917.18 E. 1360090.57
- ② N. 575872.69 E. 1360012.34

LEGEND

- STANDARD/REVERSE CURB AND BUTTER TRANSITION
- P-1 PAVING
- P-2 PAVING
- ELEV. 100 YEAR FLOODPLAIN ELEVATION L. 2795 P. 321
- CONCRETE SIDEWALK
- 25% OR GREATER SLOPES
- 15% - 24.9% SLOPES
- UNHEDICATED 65 DBA
- 25' HIGH LIGHT POST WITH 250 WATT LAMP

APPROVED: HOWARD COUNTY DEPARTMENT OF PLANNING AND ZONING.

Joseph S. Suter 7/12/97
DIRECTOR DATE

Bill Dammann 7/12/97
CHIEF, DEVELOPMENT ENGINEERING DIVISION DATE

Cindy Harriott 7/16/97
CHIEF, DIVISION OF LAND DEVELOPMENT DATE

3-9-96 REV LAYOUT OF LOADING AREA & PAD LOCATIONS: ADDED RETAIN WALL, GUARDRAIL & DETAILS.

OWNER: THE HOWARD RESEARCH & DEVELOPMENT CORP.
THE ROUSE BUILDING
10275 LITTLE PATUXENT PARKWAY
COLUMBIA, MARYLAND 21044
(410) 492-0000

DEVELOPER: CAREMATRIX CORPORATION
137 FIRST AVENUE
NEEDHAM, MA 02194
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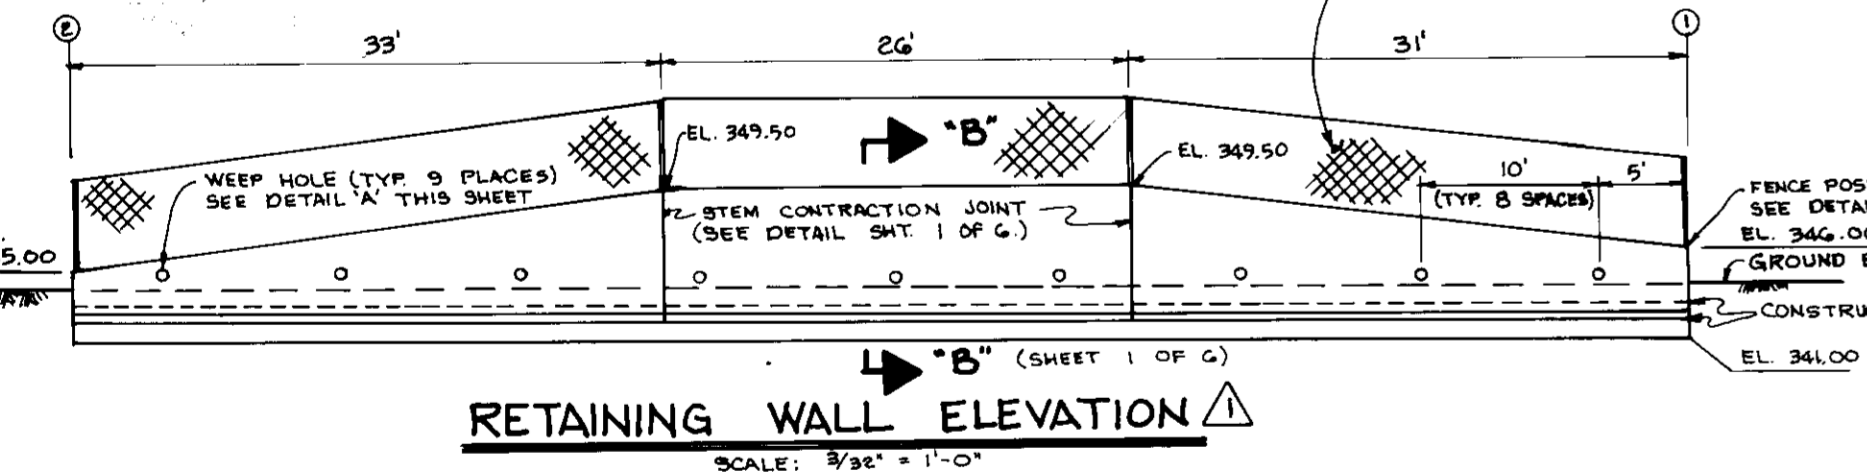
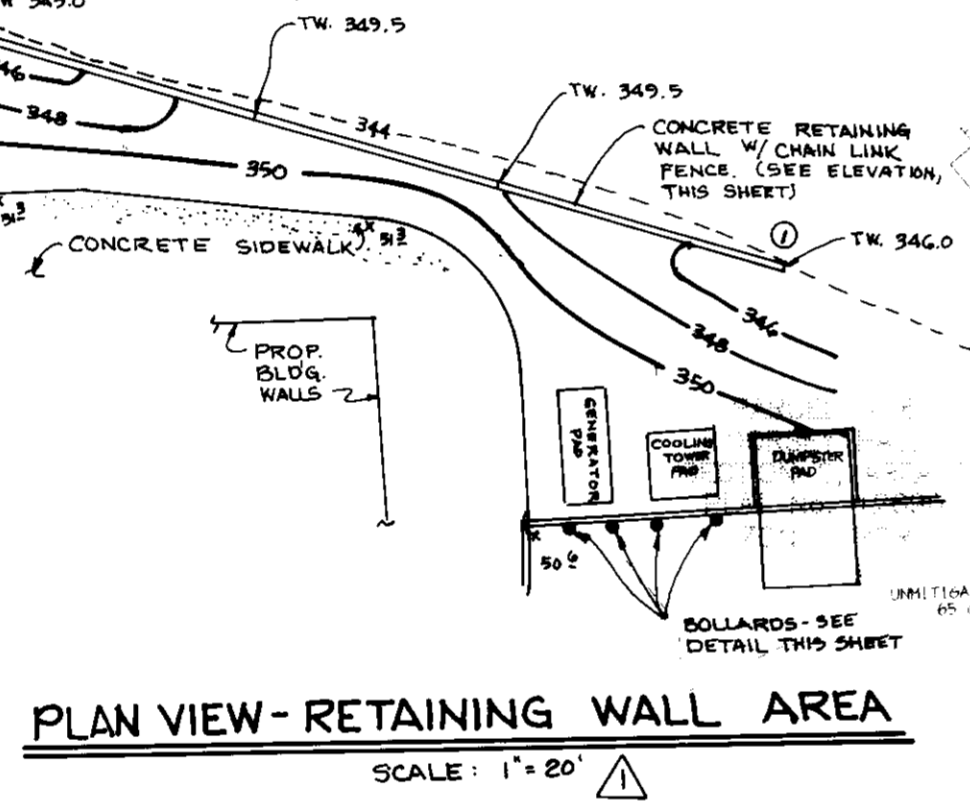
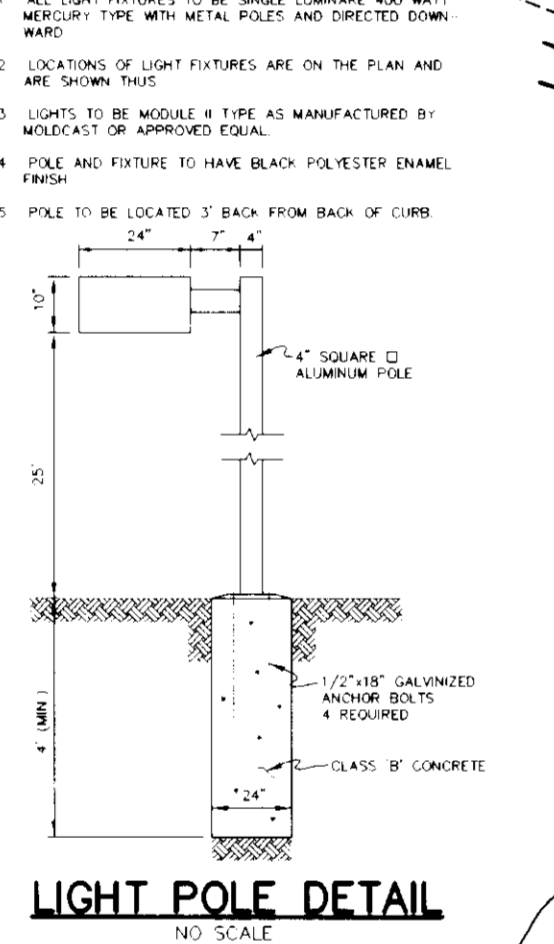
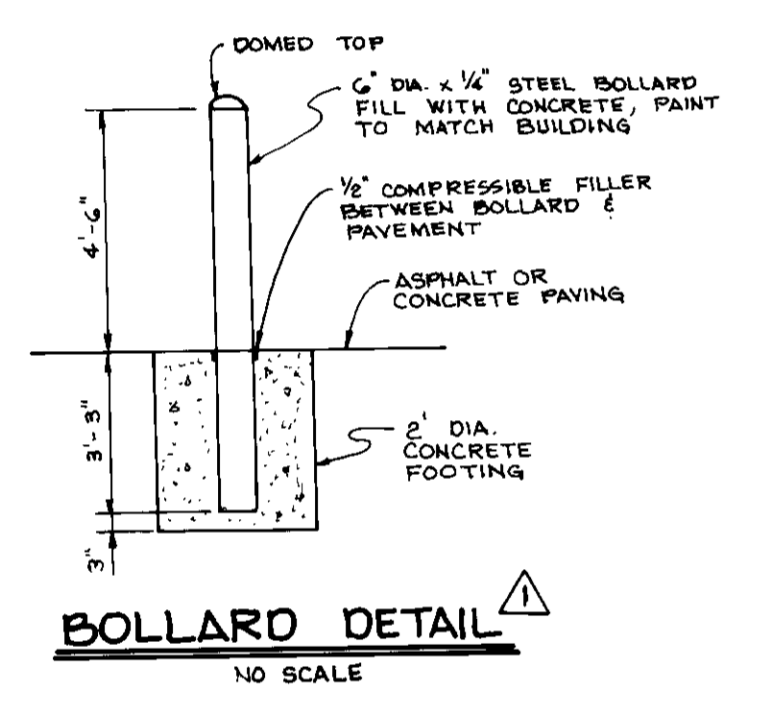
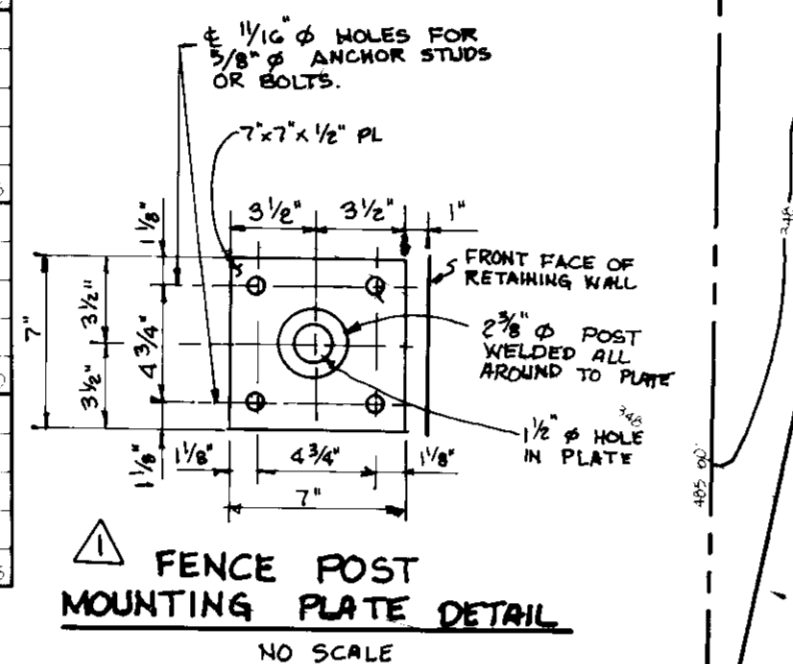
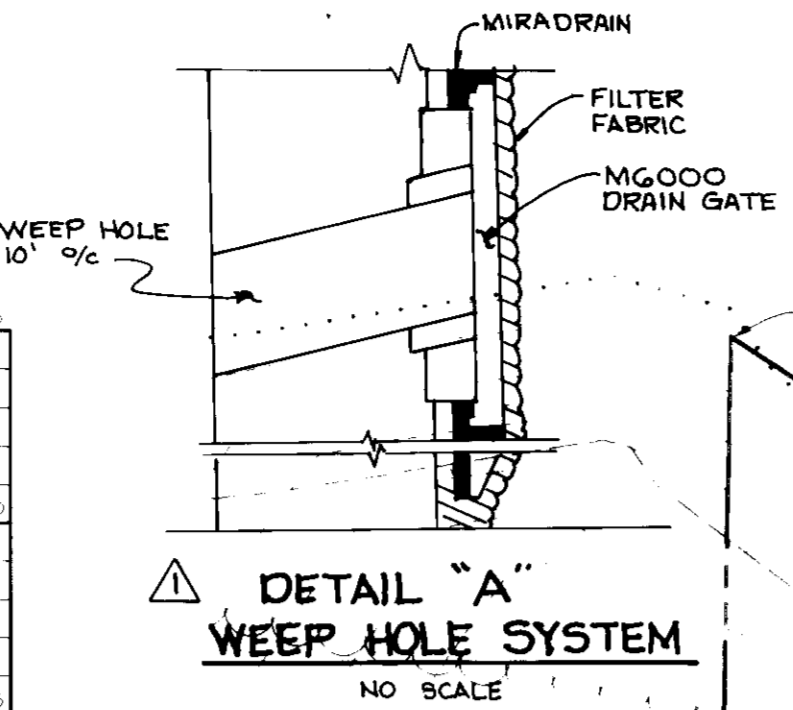
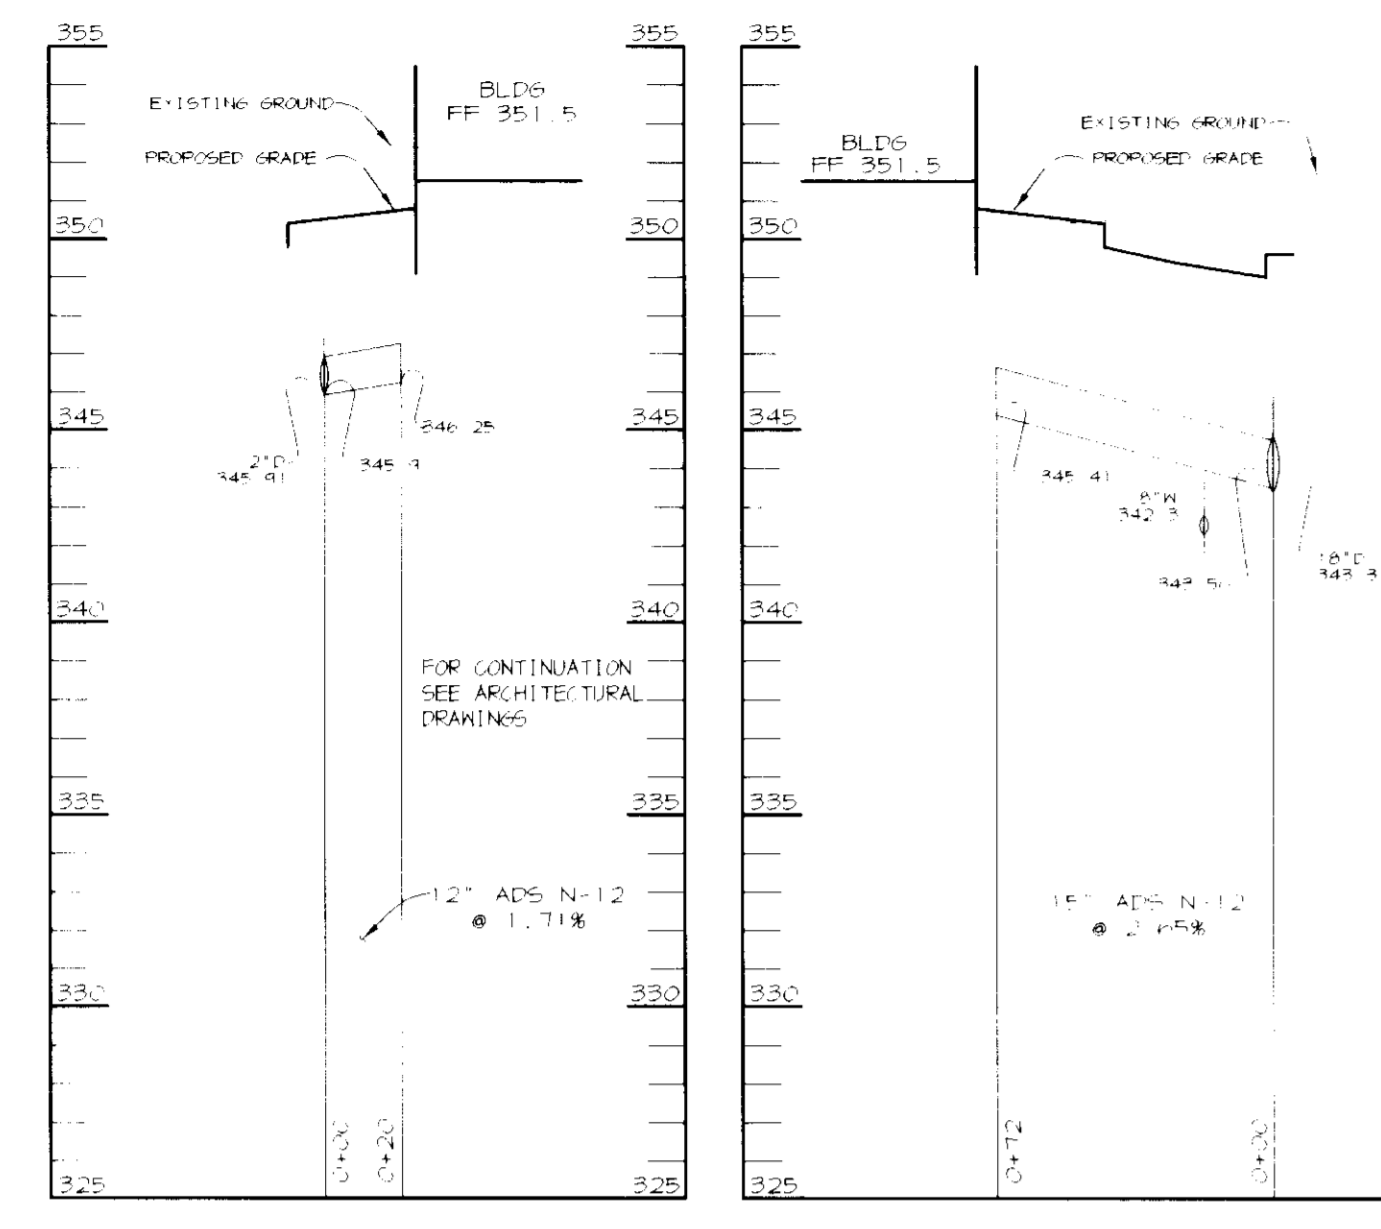
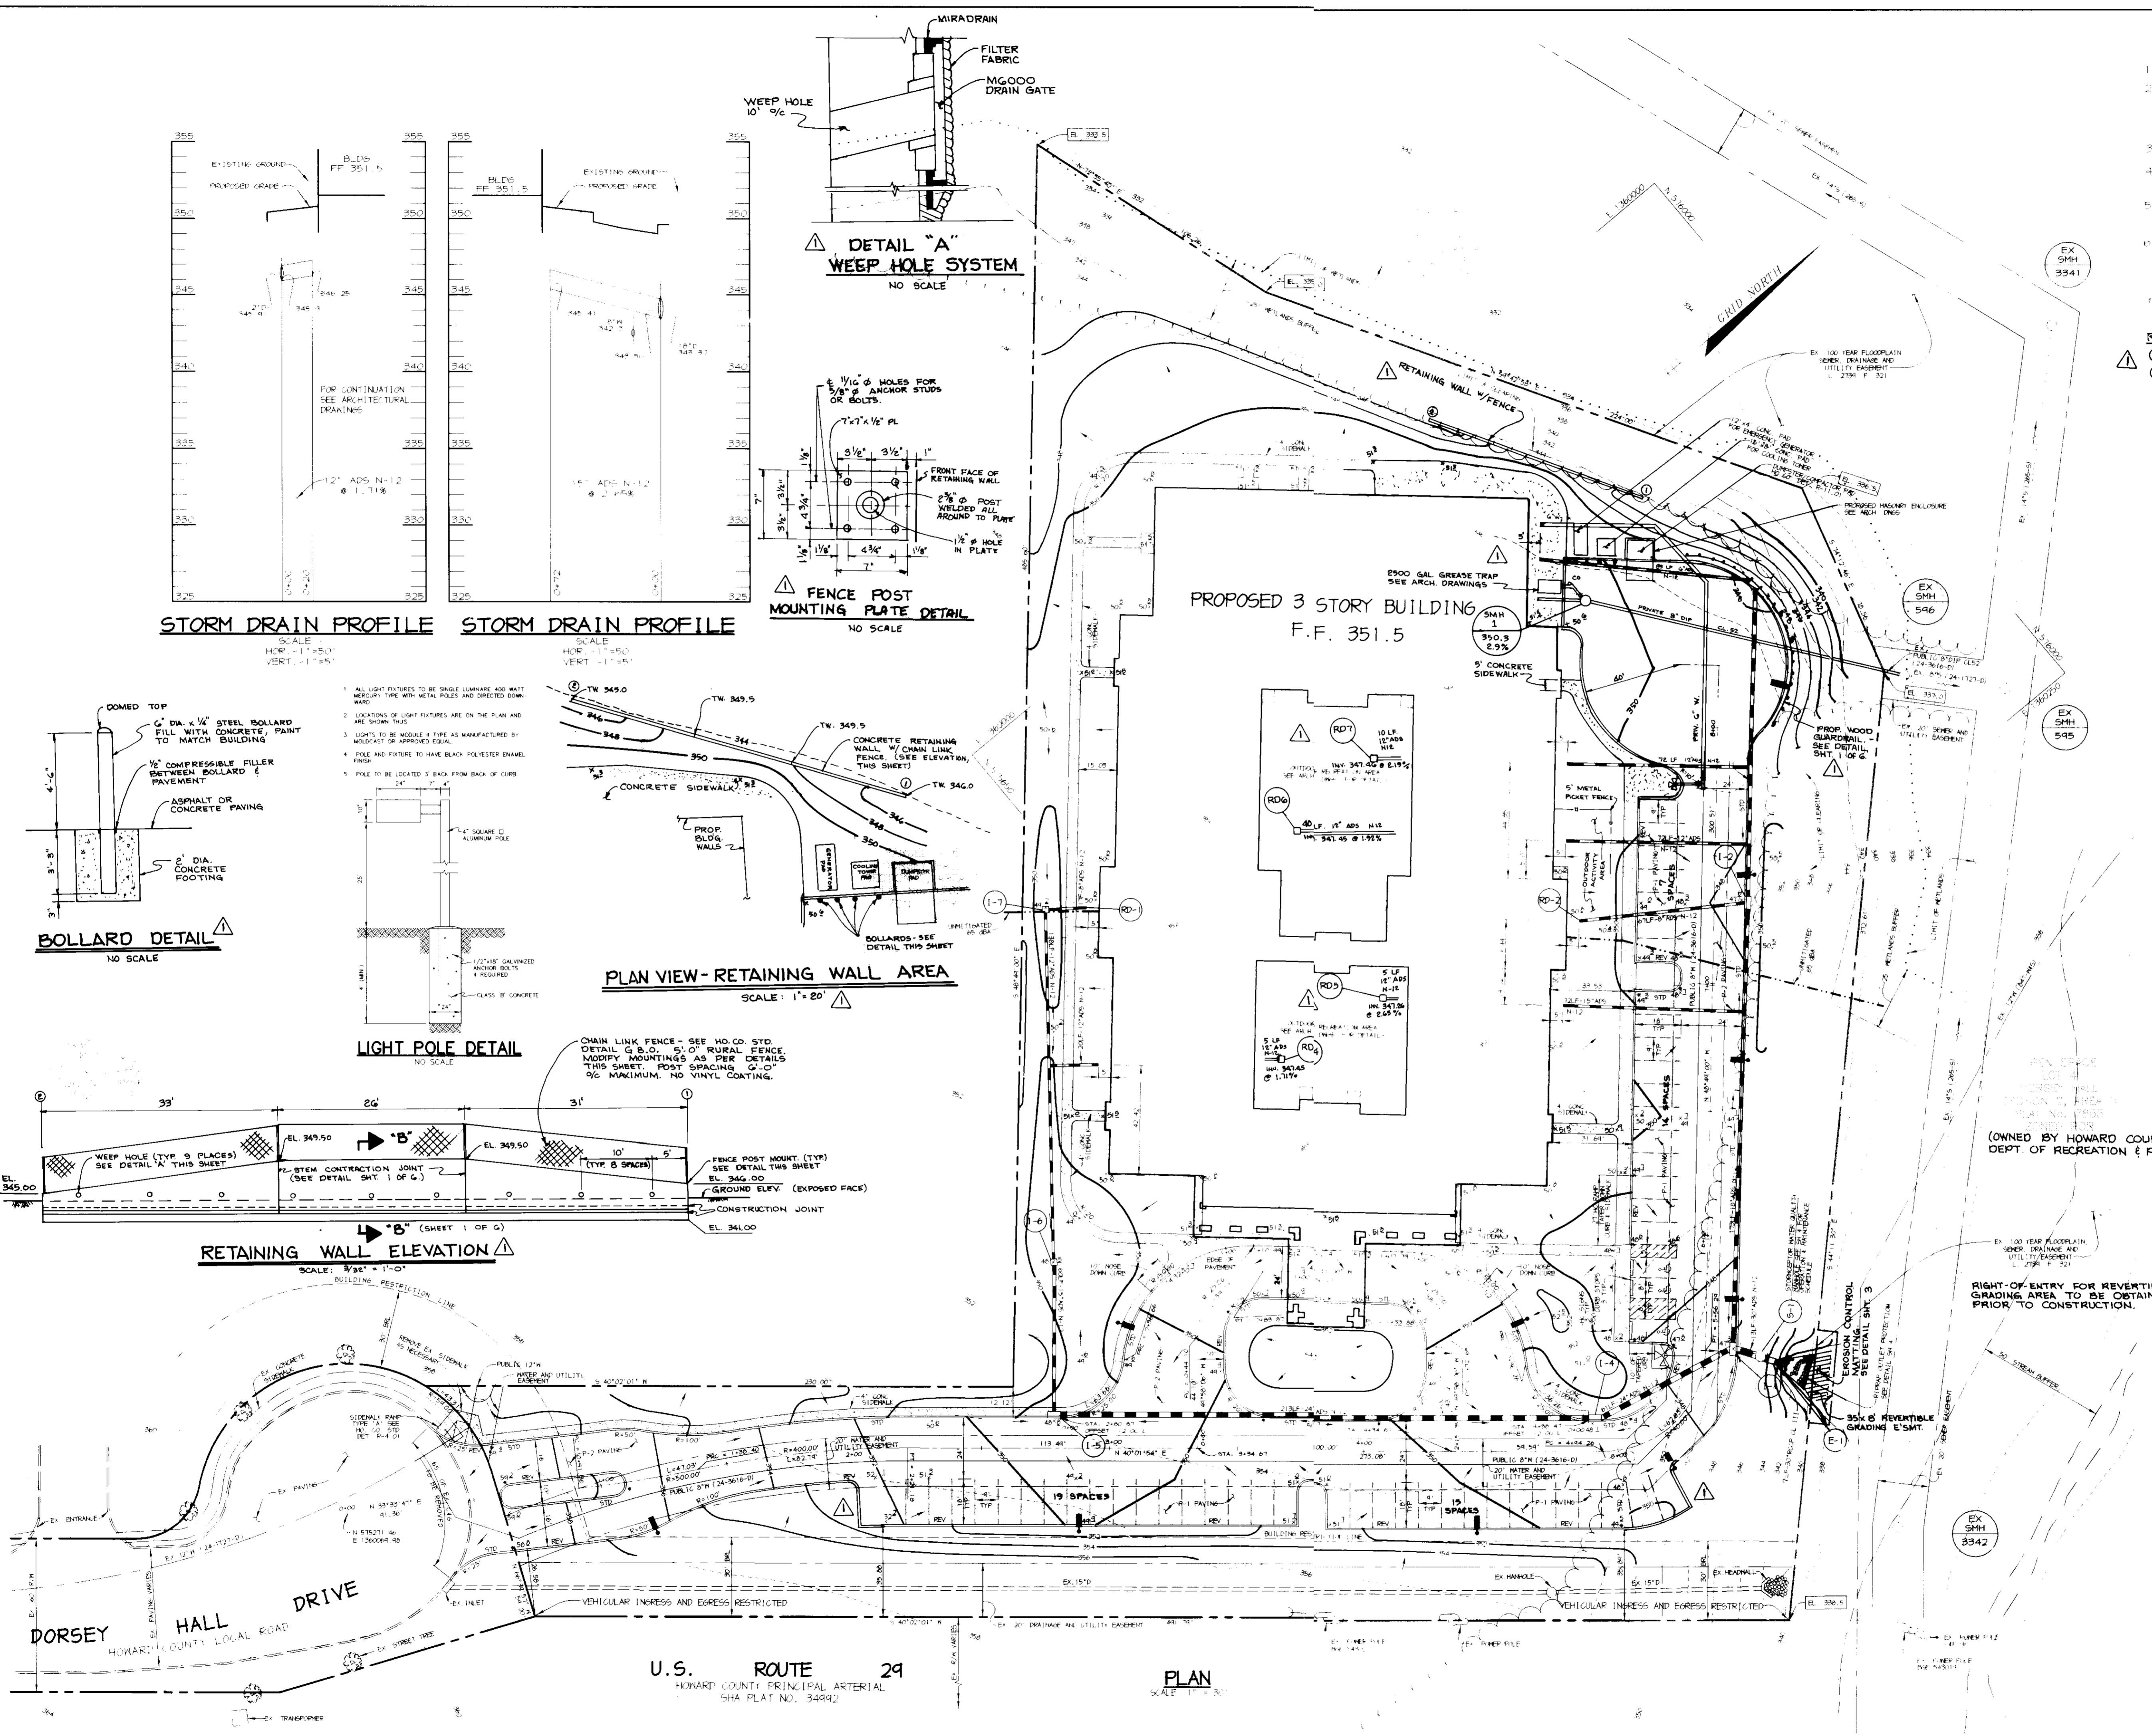
PROJECT: DORSEY HALL
ASSISTED LIVING FACILITY

AREA DORSEY HALL SECT 2 AREA 5 PARCEL 0-17
ZONED FOR TAX MAP 30 BLOCK 4
2nd ELECTION DISTRICT HOWARD COUNTY, MD.

TITLE: SITE DEVELOPMENT PLAN


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6-27-97 DATE
DESIGNED BY: C.J.R.
DRAWN BY: DAM
PROJECT NO: 96084 SDP2.DWG
DATE: JUNE 27, 1997
SCALE: AS SHOWN
DRAWING NO. 2 OF 6




U.S. ROUTE 29
HOWARD COUNTY PRINCIPAL ARTERIAL
SHA PLAT NO. 34492


PLAN
SCALE: 1" = 20'

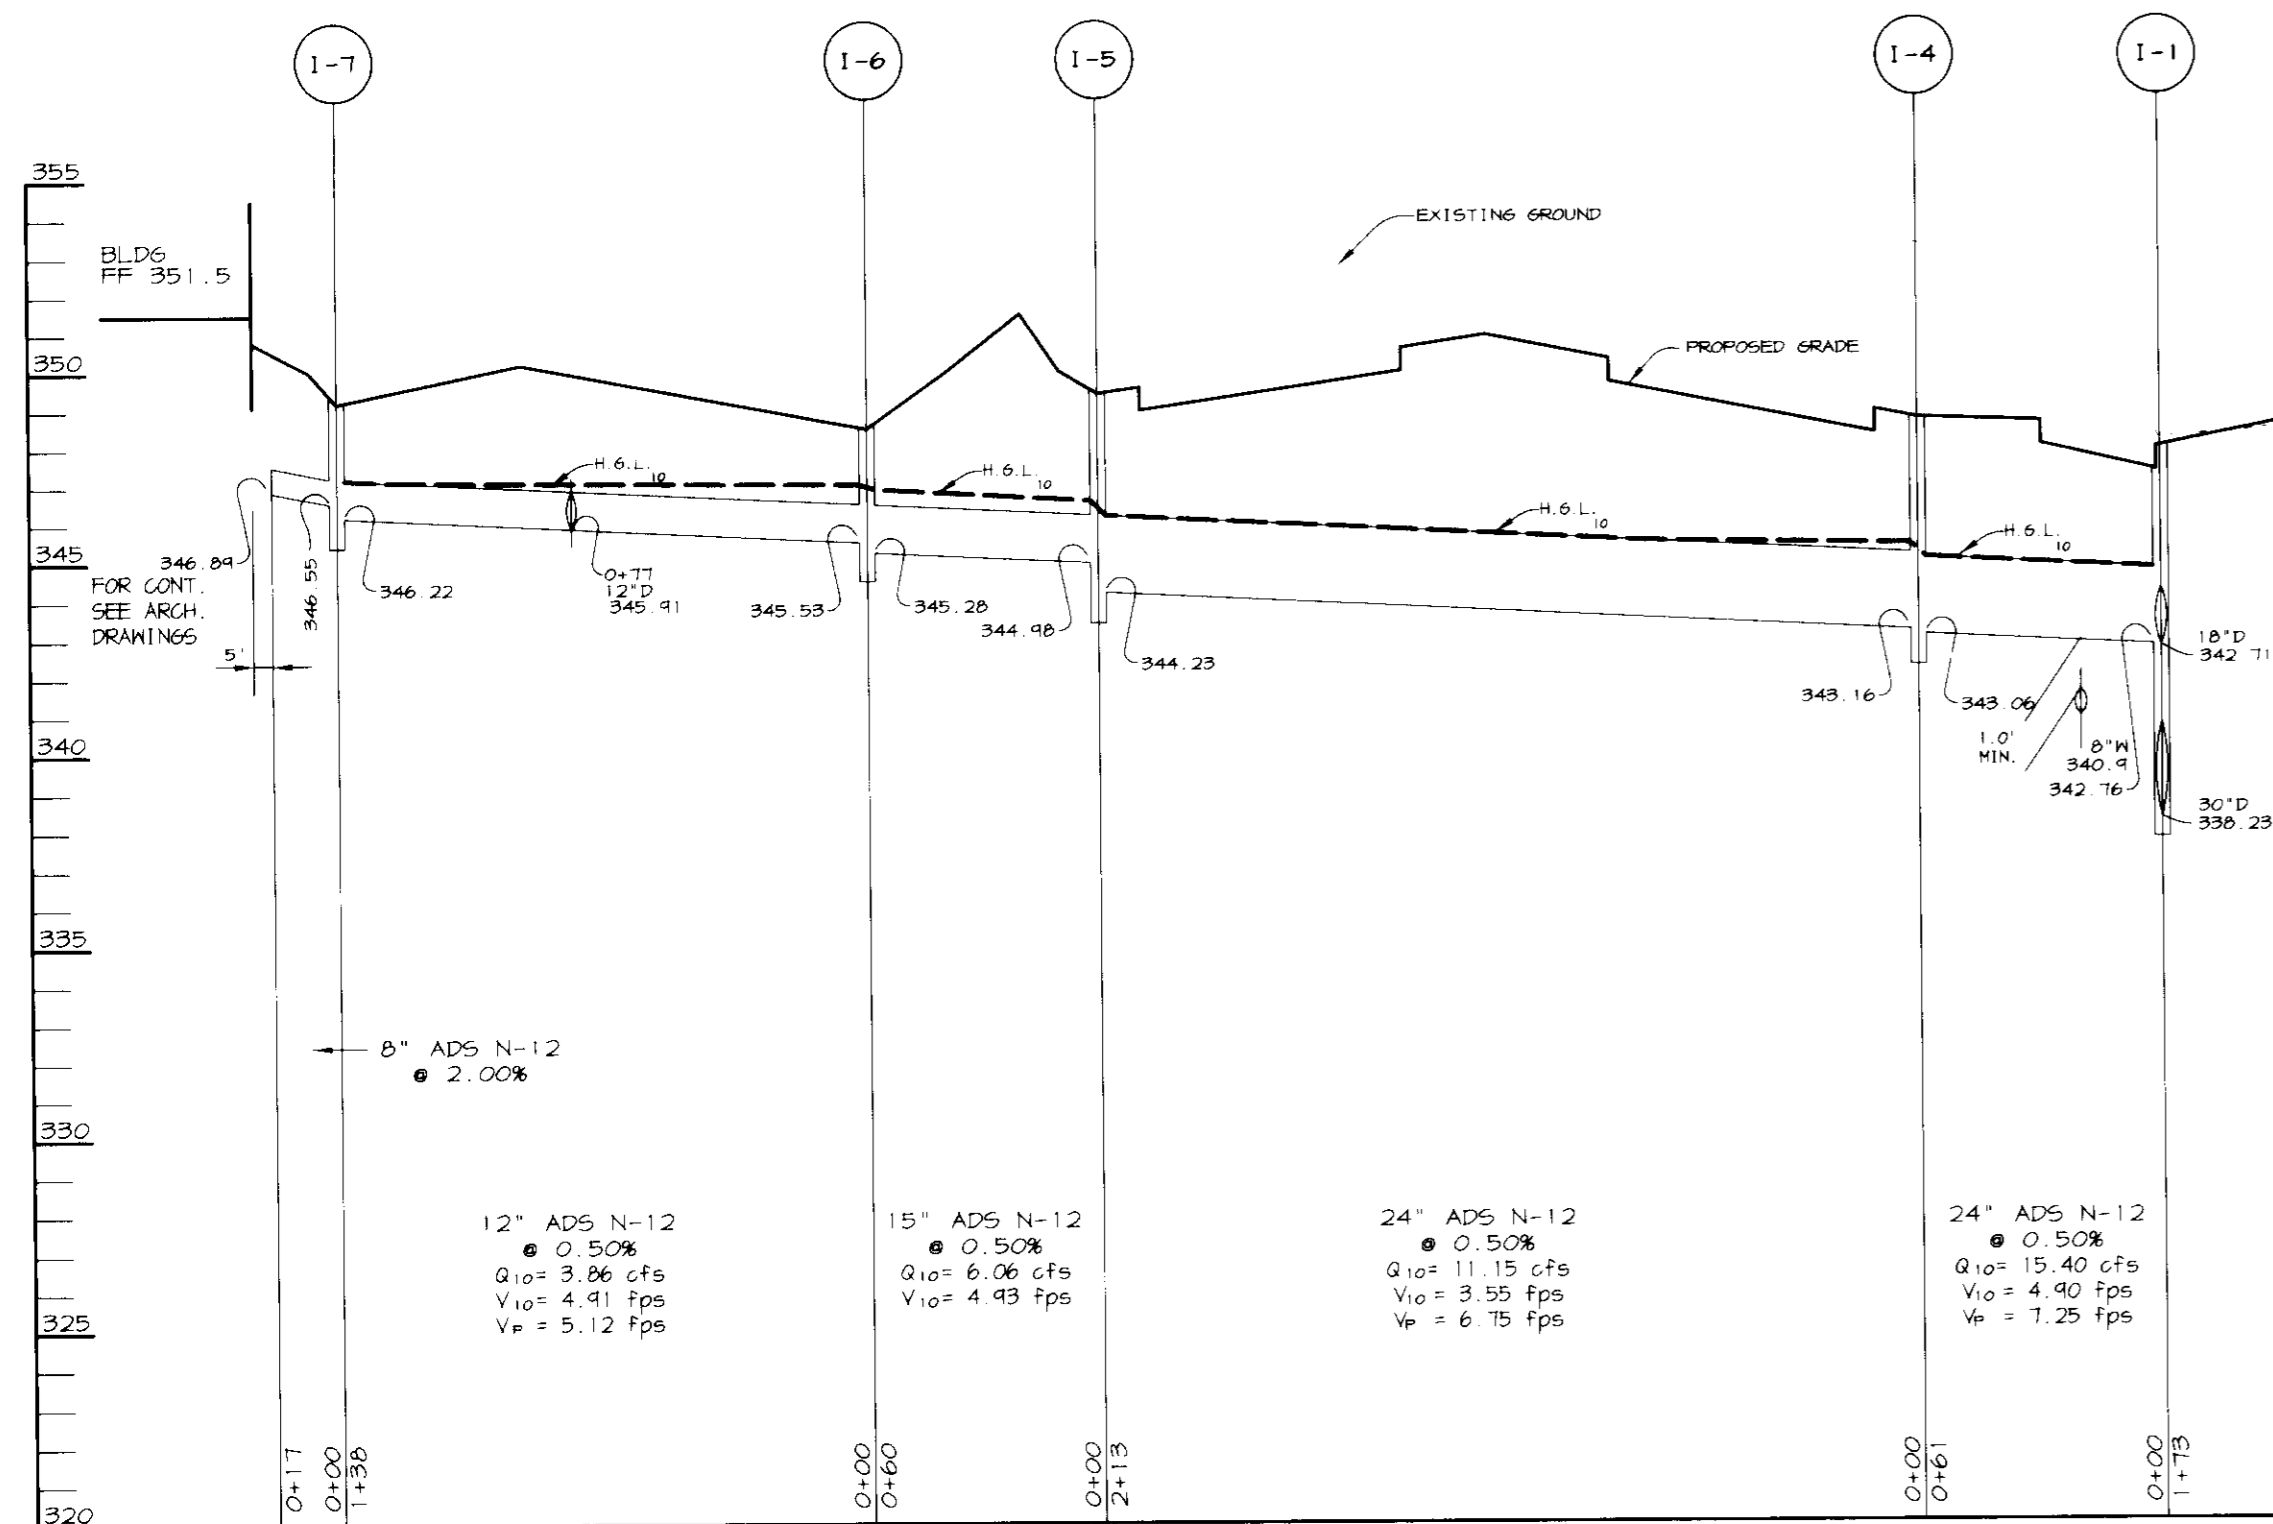


STORM DRAIN PROFILE
SCALE:
HOR. - 1"=50'
VERT. - 1"=5'

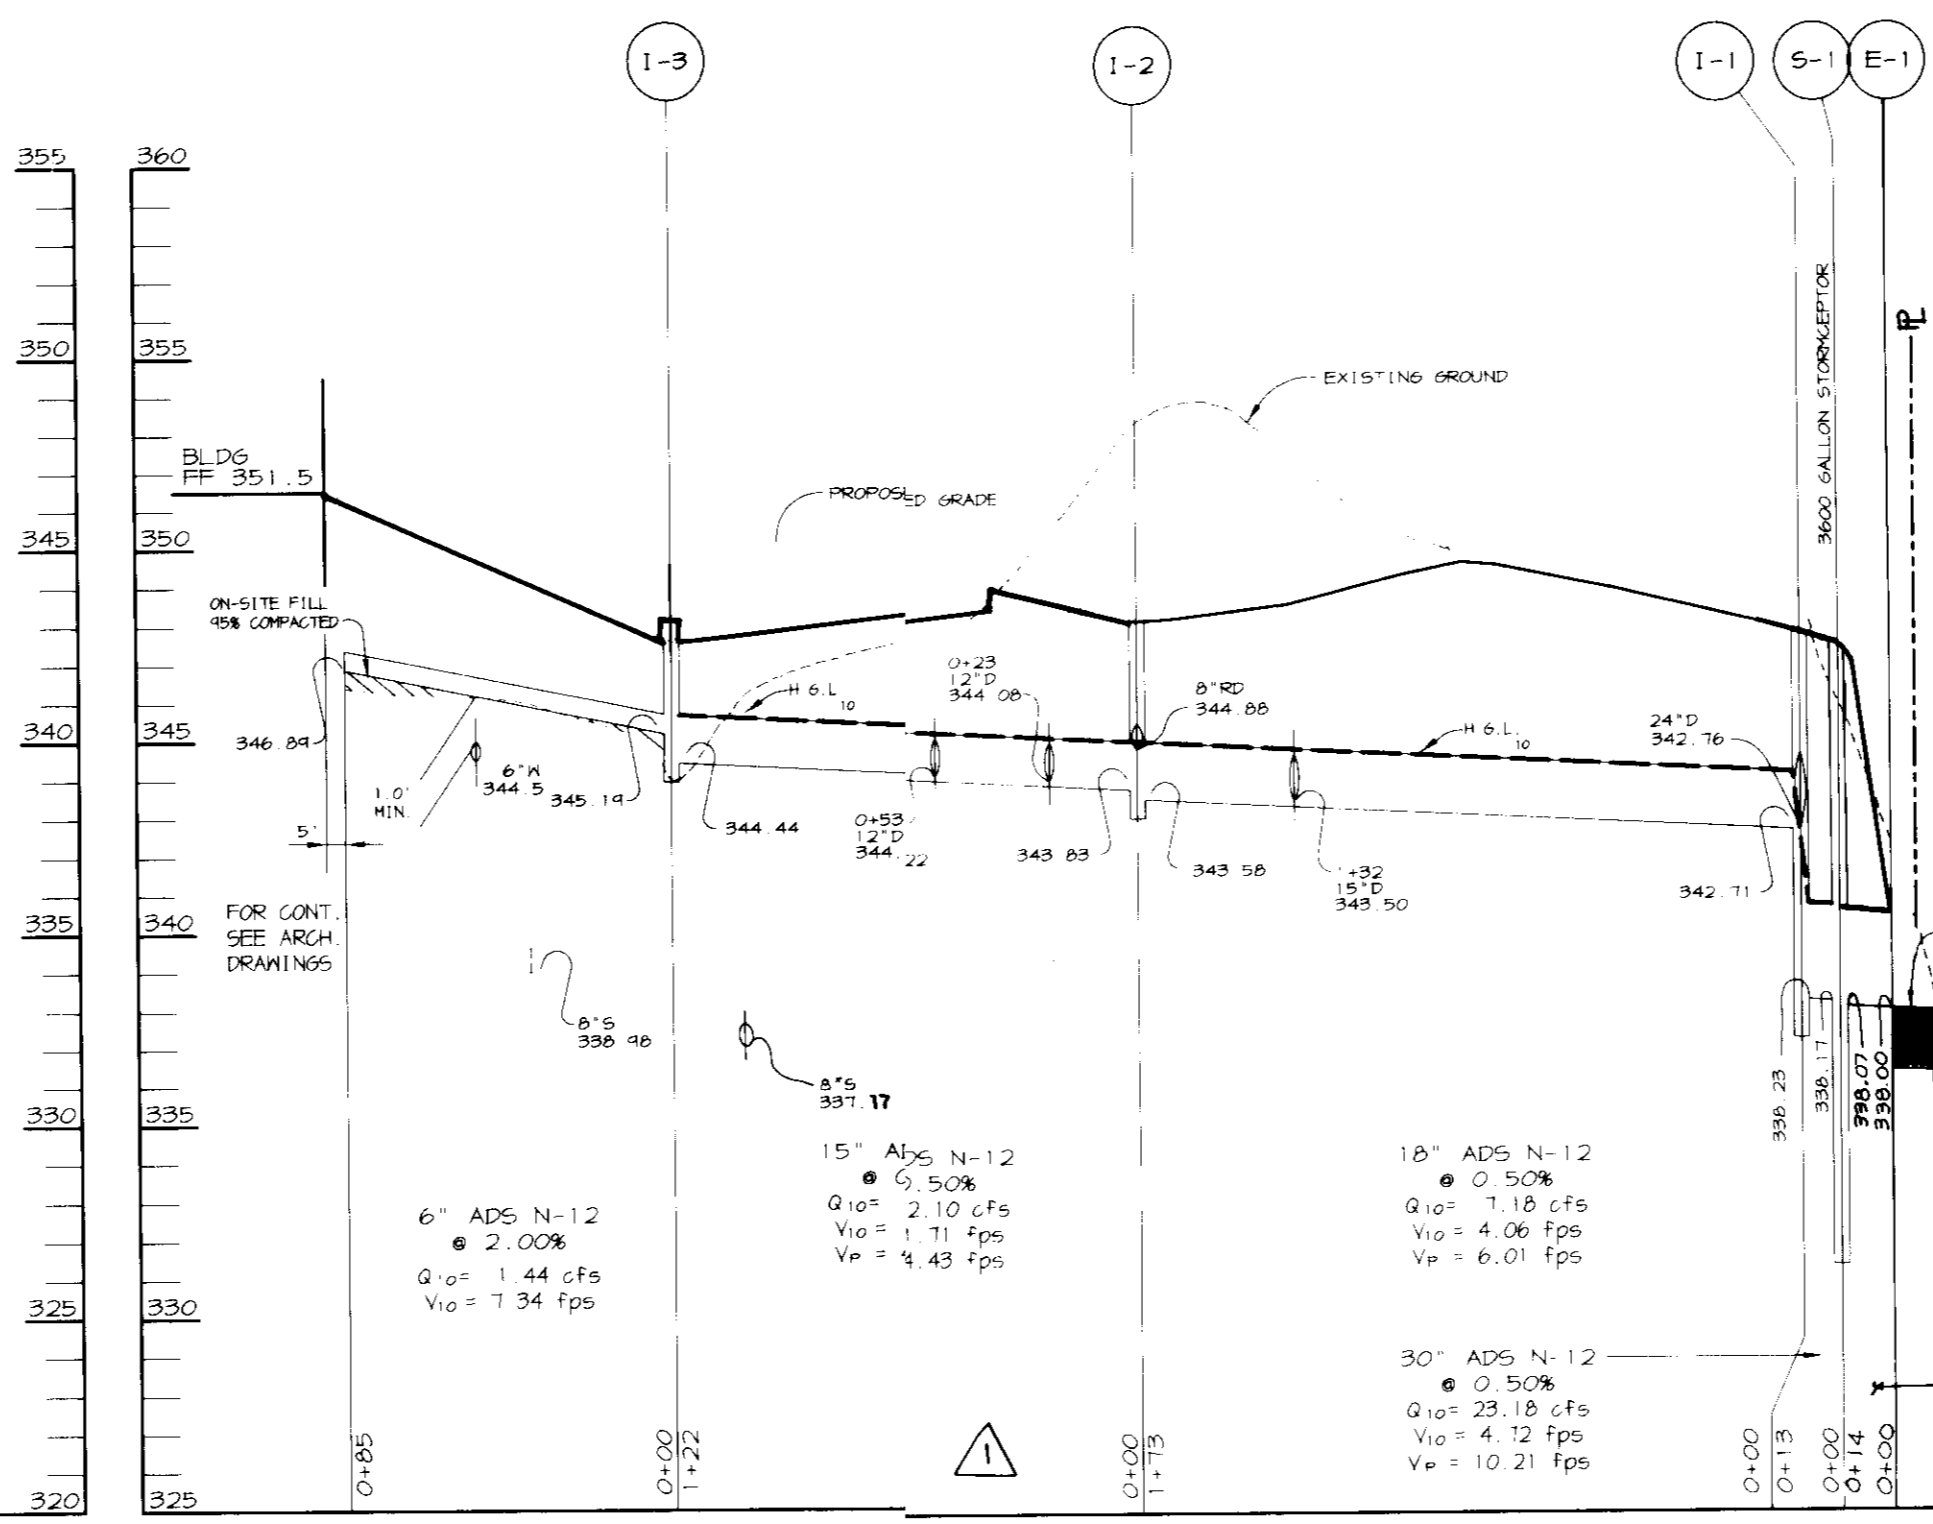

STORM DRAIN PROFILE
SCALE:
HOR. - 1"=50'
VERT. - 1"=5'


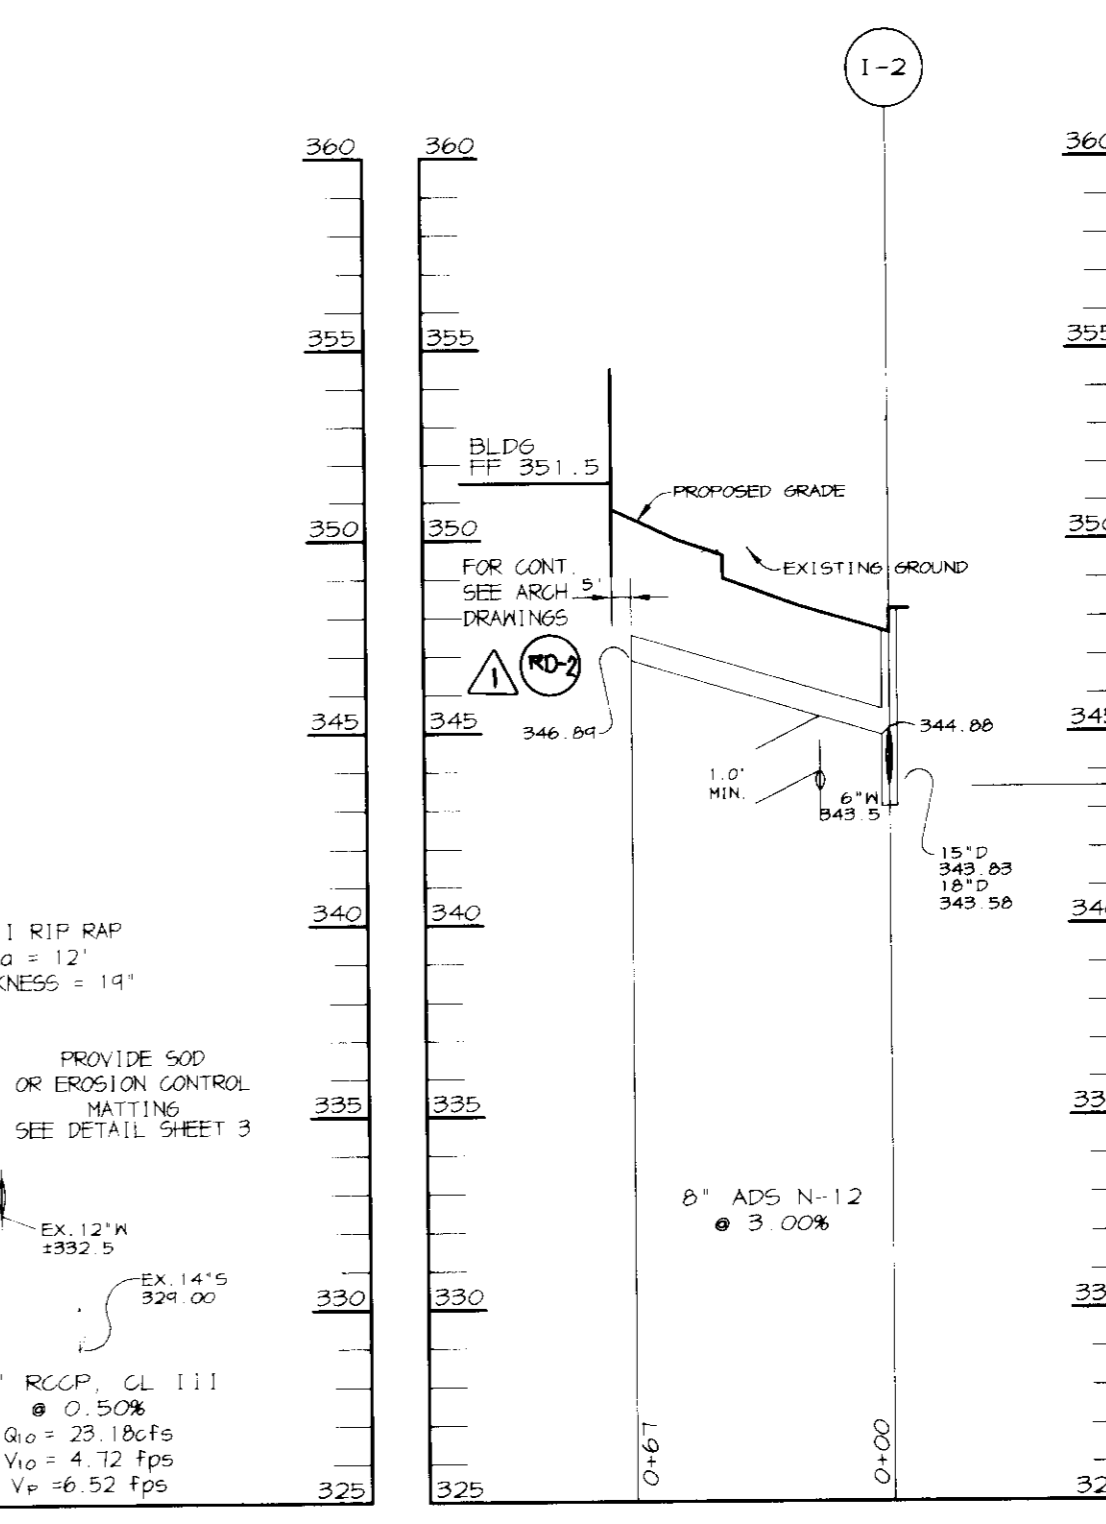


STORM DRAIN PROFILE
SCALE:
HOR. - 1"=50'
VERT. - 1"=5'

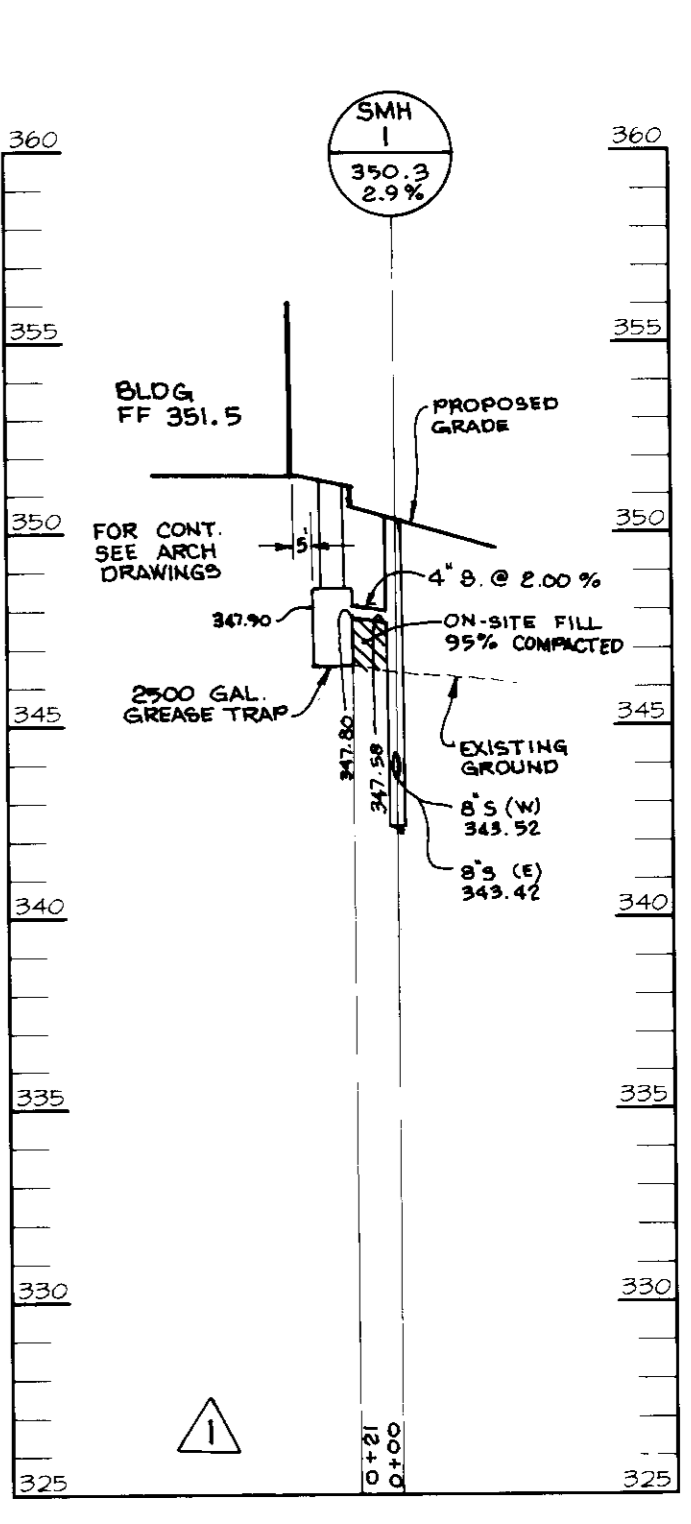


SEWER PROFILE
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VERT. - 1"=5'


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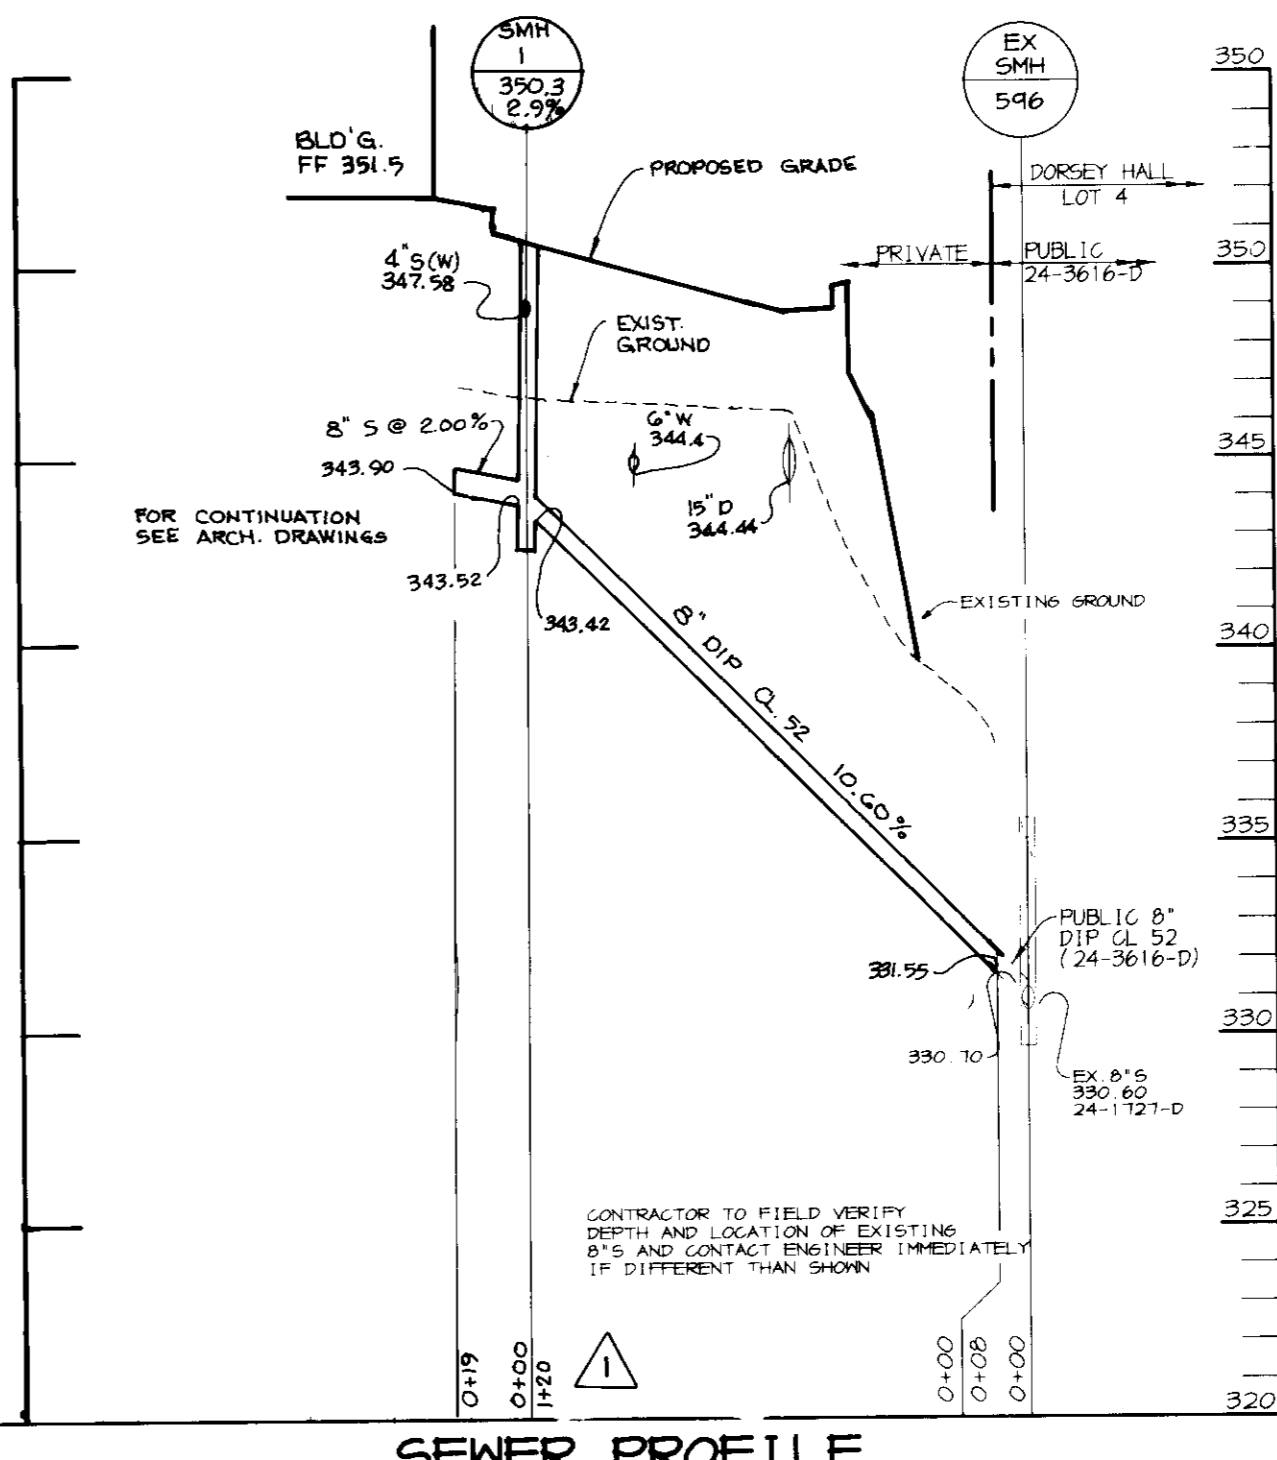
STORM DRAIN PROFILE
SCALE:
HOR. - 1"=50'
VERT. - 1"=5'

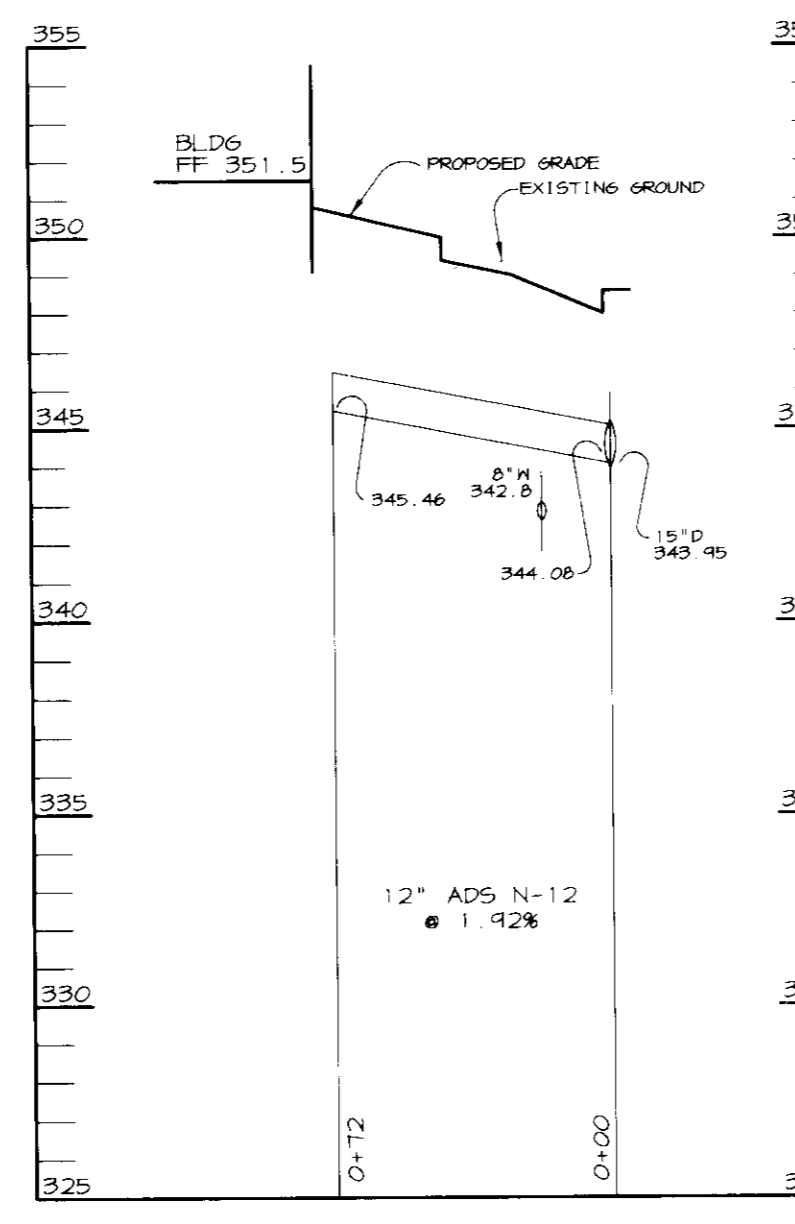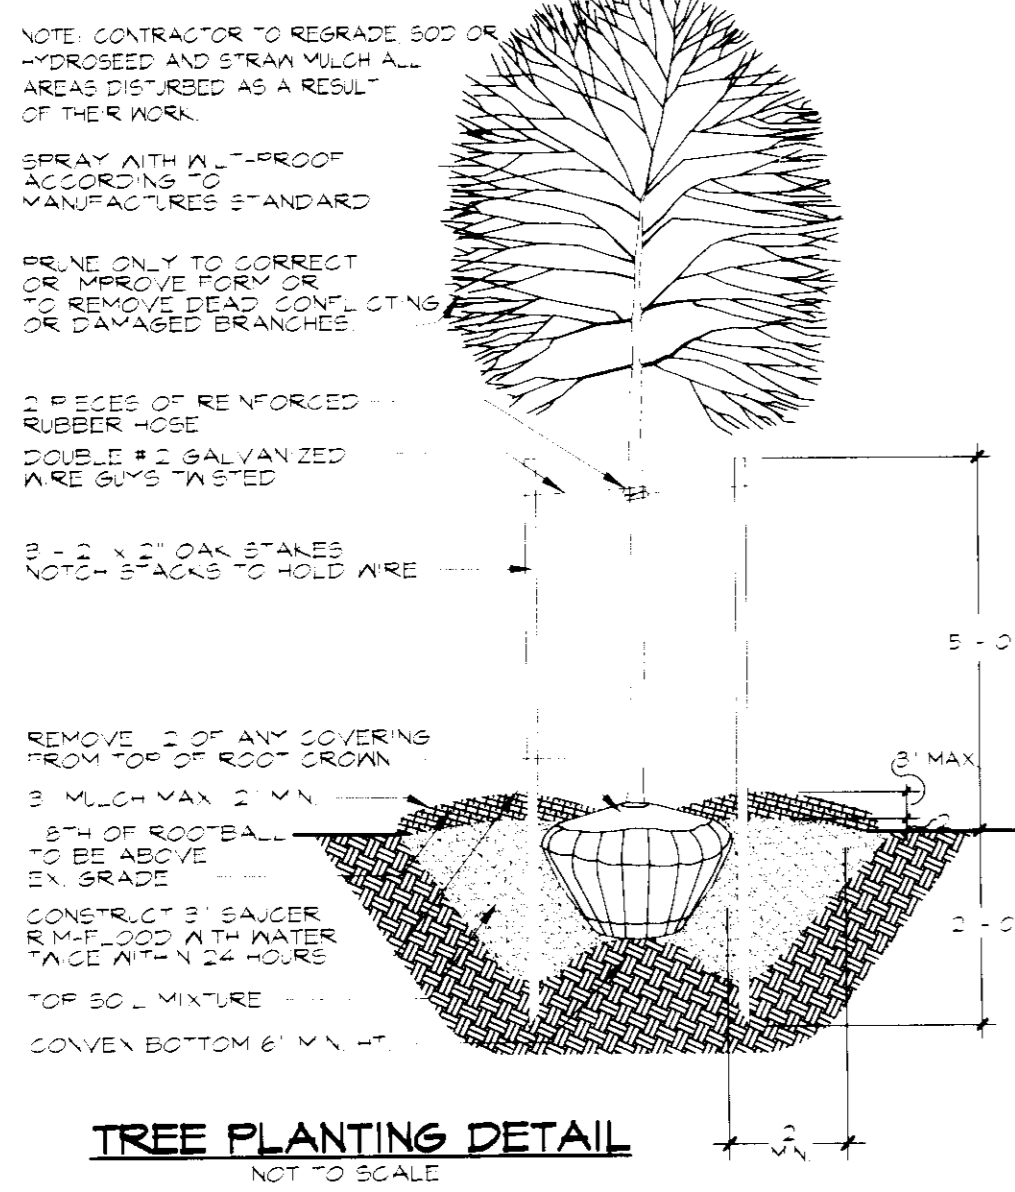

STORM DRAIN PROFILE
SCALE:
HOR. - 1"=50'
VERT. - 1"=5'

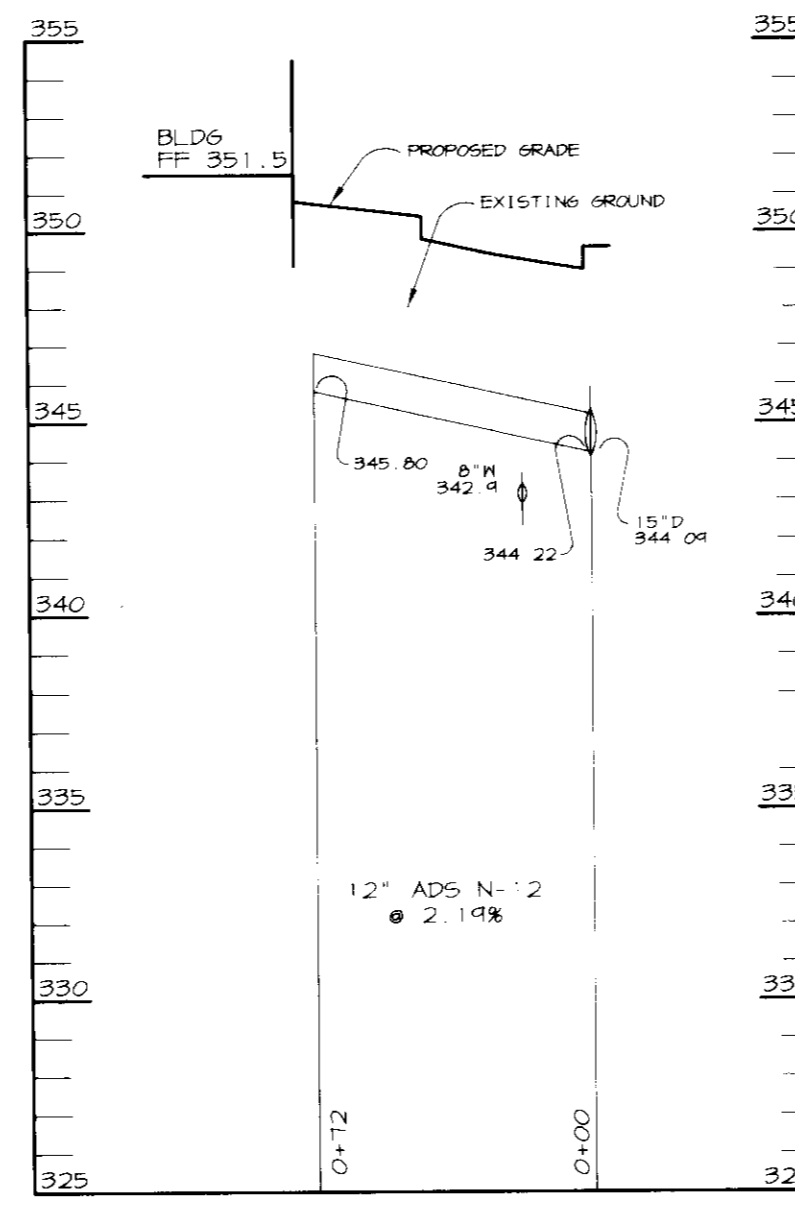

WATER PROFILE
SCALE:
HOR. - 1"=50'
VERT. - 1"=5'

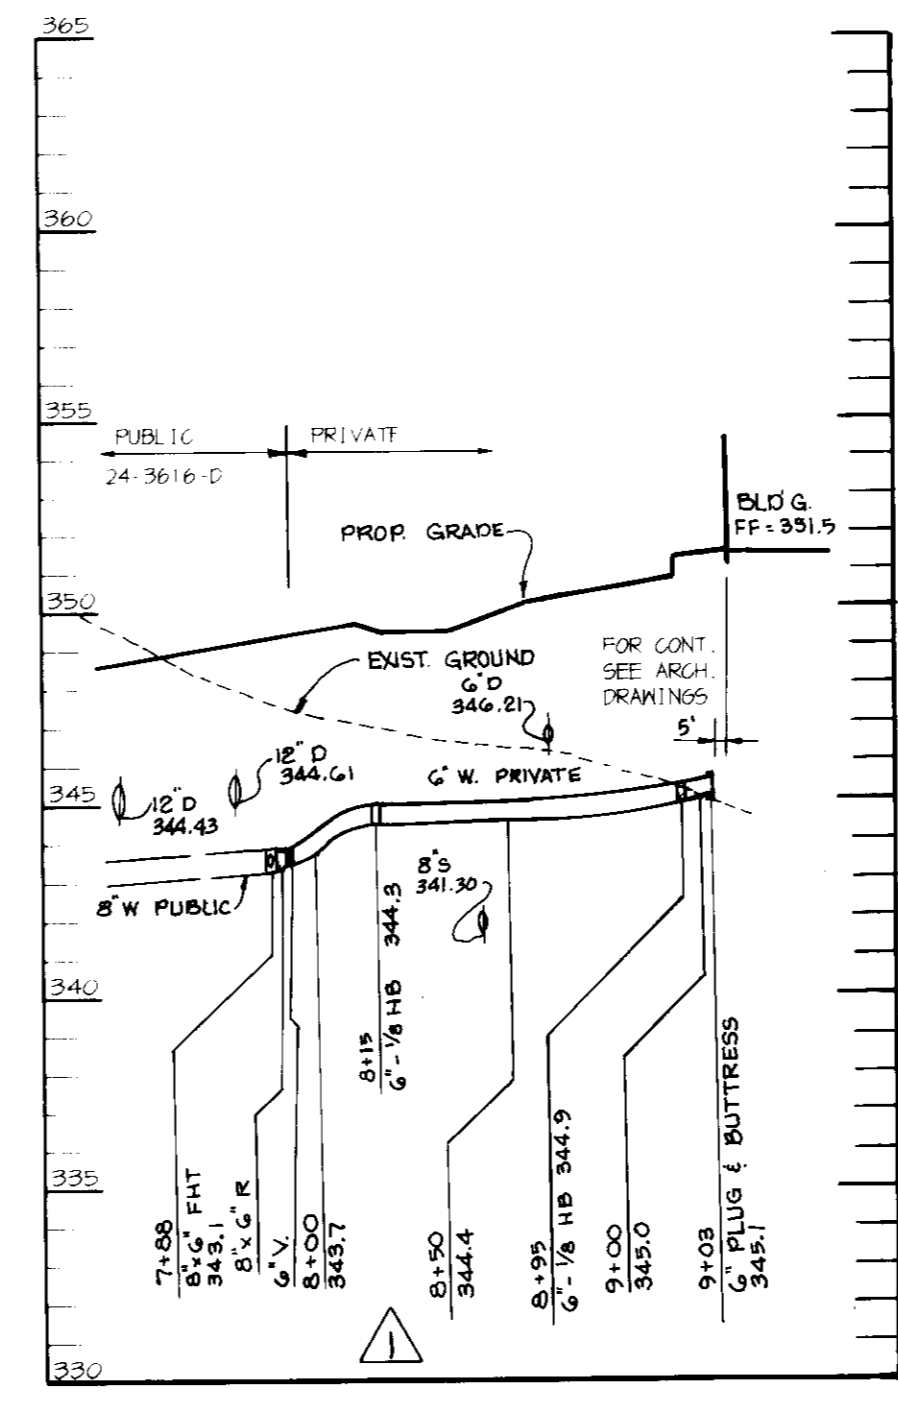

SEWER PROFILE
SCALE:
HOR. - 1"=50'
VERT. - 1"=5'



SEQUENCE OF CONSTRUCTION

- OBTAIN GRADING PERMIT.
- INSTALL STABILIZED CONSTRUCTION ENTRANCE, SUPER SILT FENCE AND SILT FENCE (2 DAYS)
- ROUGH GRADE SITE AND BEGIN BUILDINGS CONSTRUCTION.
- AS SUBGRADE ELEVATIONS ARE ESTABLISHED, INSTALL STORM DRAINS WITH INLET PROTECTION AND INLET TRAPS AS NECESSARY. WATER AND SEWER DELAY CONSTRUCTION OF DRAINS FROM 1-5 TO 1-1 UNTIL TRAP #2 IS FILLED. (3 WEEKS)
- INSTALL CURB AND BUTTER AND PAVE ROADWAYS. REMOVE INLET TRAPS UPON APPROVAL OF HOWARD COUNTY DILP SEDIMENT CONTROL INSPECTOR. (2 WEEKS)
- FINE GRADE SITE, STABILIZE DISTURBED AREAS IN ACCORDANCE WITH PERMANENT SEEDING NOTES AS NECESSARY. (10 DAYS)
- INSTALL LIGHTS, LANDSCAPING, WALKS, AND SIGNS AS REQUIRED. (10 DAYS)
- COMPLETE REMAINING CONSTRUCTION. (16 WEEKS)
- UPON APPROVAL OF HOWARD COUNTY DILP SEDIMENT CONTROL INSPECTOR, REMOVE ALL SEDIMENT CONTROL DEVICES AND STABILIZE ALL REMAINING AREAS IN ACCORDANCE WITH PERMANENT SEEDING NOTES. (2 DAYS)

STRUCTURE SCHEDULE

STRUCTURE	TYPE	LOCATION *	INV. IN	INV. OUT	TOP RIM/ CURB	STANDARD DETAIL
1-1	S-COMB W/RET GRATE	N 575,730.99 E 1,360,369.45	342.71(18")	338.23	341.9	HOCO SD-4.93
1-2	A-5	N 575,846.07 E 1,360,231.92	343.83(15")	343.58	348.2	HOCO SD-4.40
1-3	A-5	N 575,929.01 E 1,360,146.15	345.19	344.44	348.9	HOCO SD-4.40
1-4	MOD. A-5	N 575,670.66 E 1,360,355.29	343.16	343.06	348.7	HOCO SD-4.40
1-5	A-5	N 575,507.87 E 1,360,218.54	344.98	344.23	349.4	HOCO SD-4.40
1-6	D	N 575,546.84 E 1,360,172.09	345.53	345.28	348.5	HOCO SD-4.39
1-7	D	N 575,633.23 E 1,360,064.32	346.55	346.22	349.2	HOCO SD-4.39
E-1	30" HW	N 575,740.08 E 1,360,382.45	-	338.04	-	HOCO SD-5.11
S-1	3600 GAL	N 575,756.40 E 1,360,277.81	338.17	338.07	346.6	SEE SHEET 4
SMH-1	4'-0"	N 575,874.56 E 1,360,108.59	343.92	343.42	350.3 2.9%	HOCO S-5.12

* LOCATIONS - INLETS: CENTER OF CURB OPENING, FACE OF CURB; OTHERS: CENTER OF STRUCTURE
 † ELEVATION AT THROAT OPENING
 ‡ INLET TO HAVE 3.5' INNER WIDTH

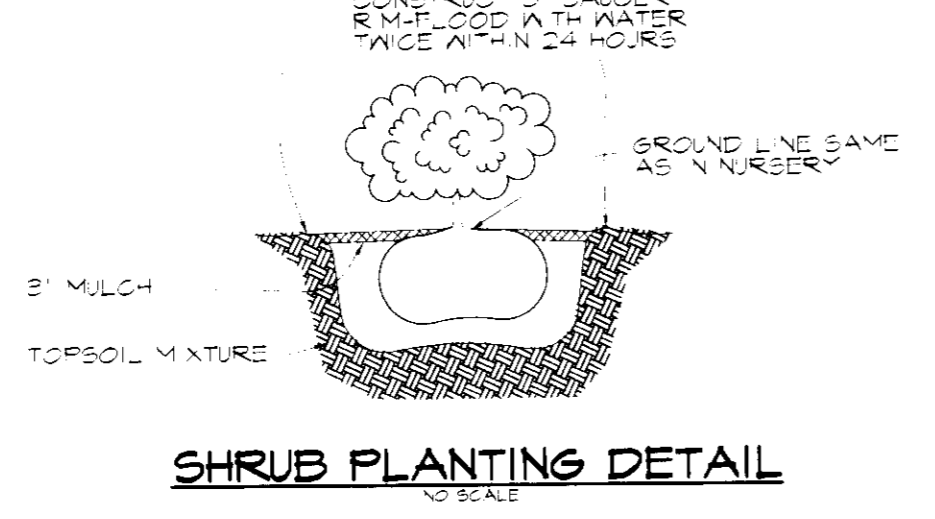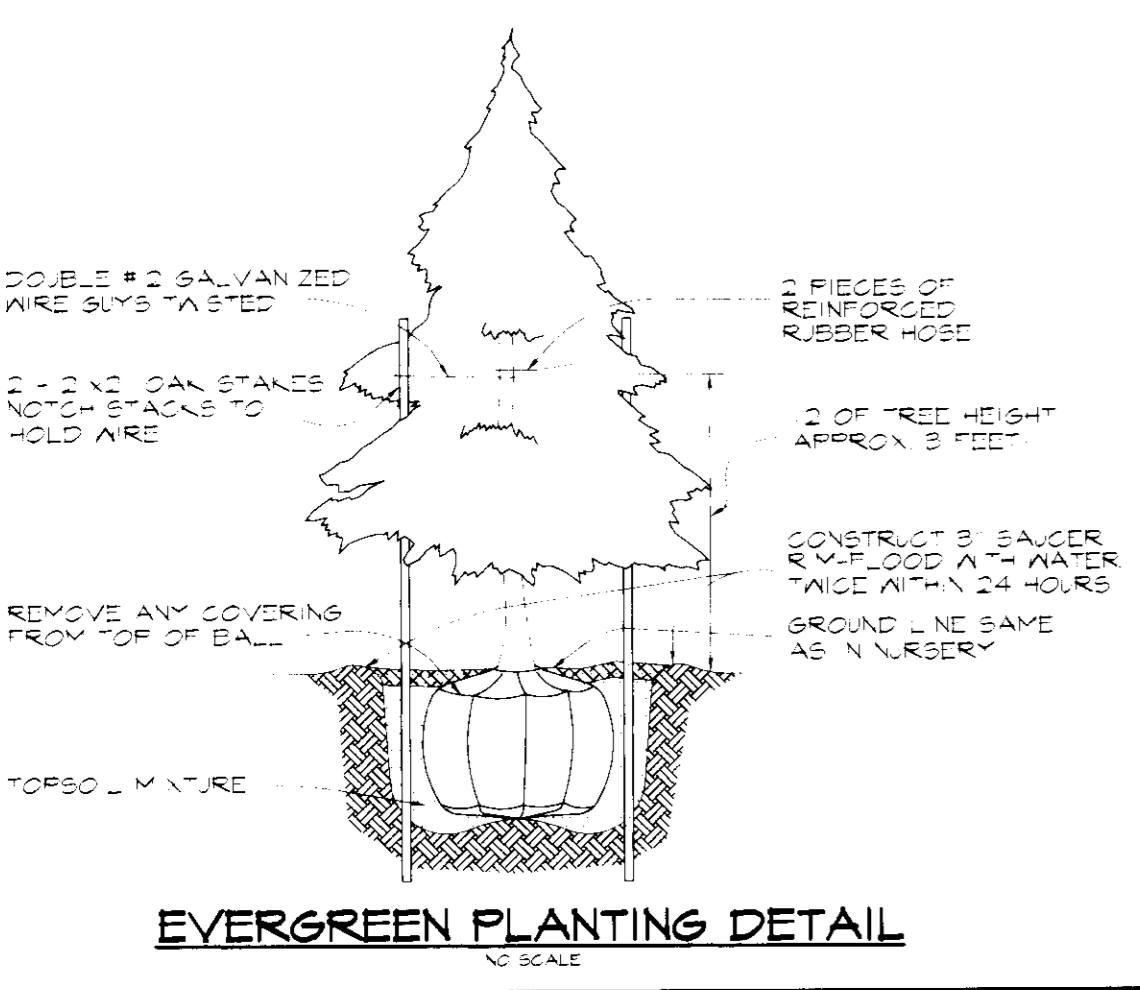

APPROVED: HOWARD COUNTY DEPARTMENT OF PLANNING AND ZONING.

[Signature] 7/18/97
DIRECTOR DATE

[Signature] 7/17/97
CHIEF, DEVELOPMENT ENGINEERING DIVISION DATE

[Signature] 7/18/97
CHIEF, DIVISION OF LAND DEVELOPMENT DATE

3-9-98 REVISED STORM DRAIN, SEWER & WATER PROFILES. MODIFIED STRUCTURE SCHEDULE.

DATE NO. REVISION

OWNER: THE HOWARD RESEARCH & DEVELOPMENT CORP.
 THE ROUSE BUILDING
 10275 LITTLE PATUXENT PARKWAY
 COLUMBIA, MARYLAND 21044
 (410) 992-6000

DEVELOPER: CAREMATRIX CORPORATION
 197 FIRST AVENUE
 NEEDHAM, MA. 02194
 (617) 433-1000

PROJECT: DORSEY HALL ASSISTED LIVING FACILITY

AREA: DORSEY HALL, SECT 2, AREA 5, PARCEL 0-7, ZONED FOR TAX MAP 30, BLOCK 4, 2nd ELECTION DISTRICT, HOWARD COUNTY, MD.

PROFILES AND STRUCTURE SCHEDULE

RIEMER MUEGGE & ASSOCIATES, INC.
 ENGINEERING • ENVIRONMENTAL SERVICES • PLANNING • SURVEYING
 8818 Centre Park Drive, Columbia, Maryland 21045
 tel 410.997.8900 fax 410.997.9282

DATE: _____

DESIGNED BY: C.J.R.

DRAWN BY: DAM








PROJECT NO.: 96084 SDP5.DWG

DATE: JUNE 27, 1997

SCALE: AS SHOWN

JAYKANT D. PAREKH #19148

DRAWING NO. 5 OF 6

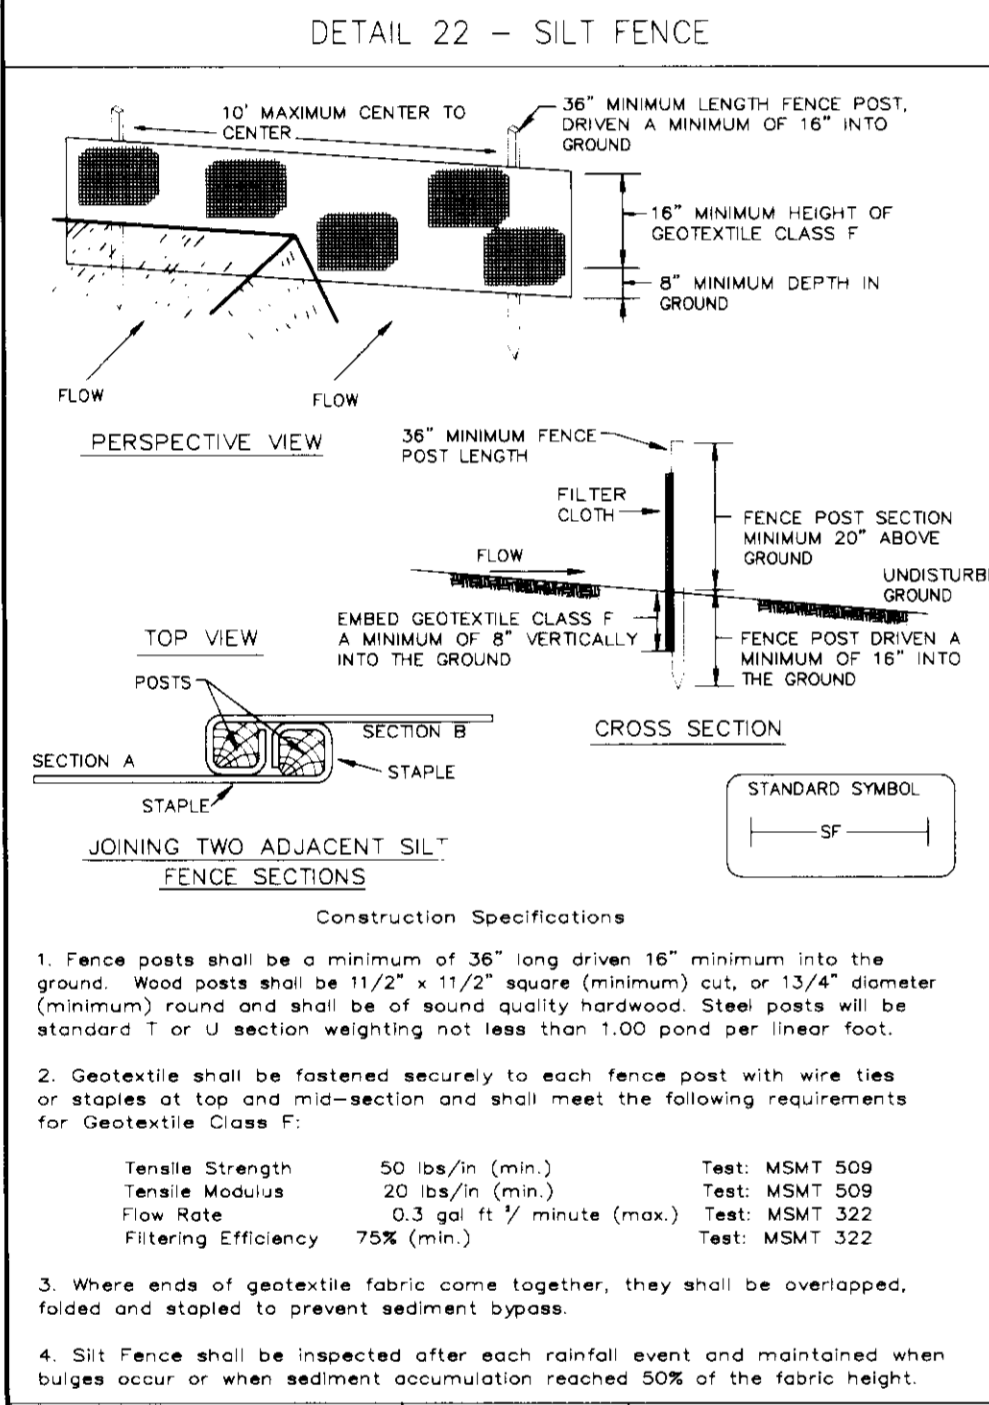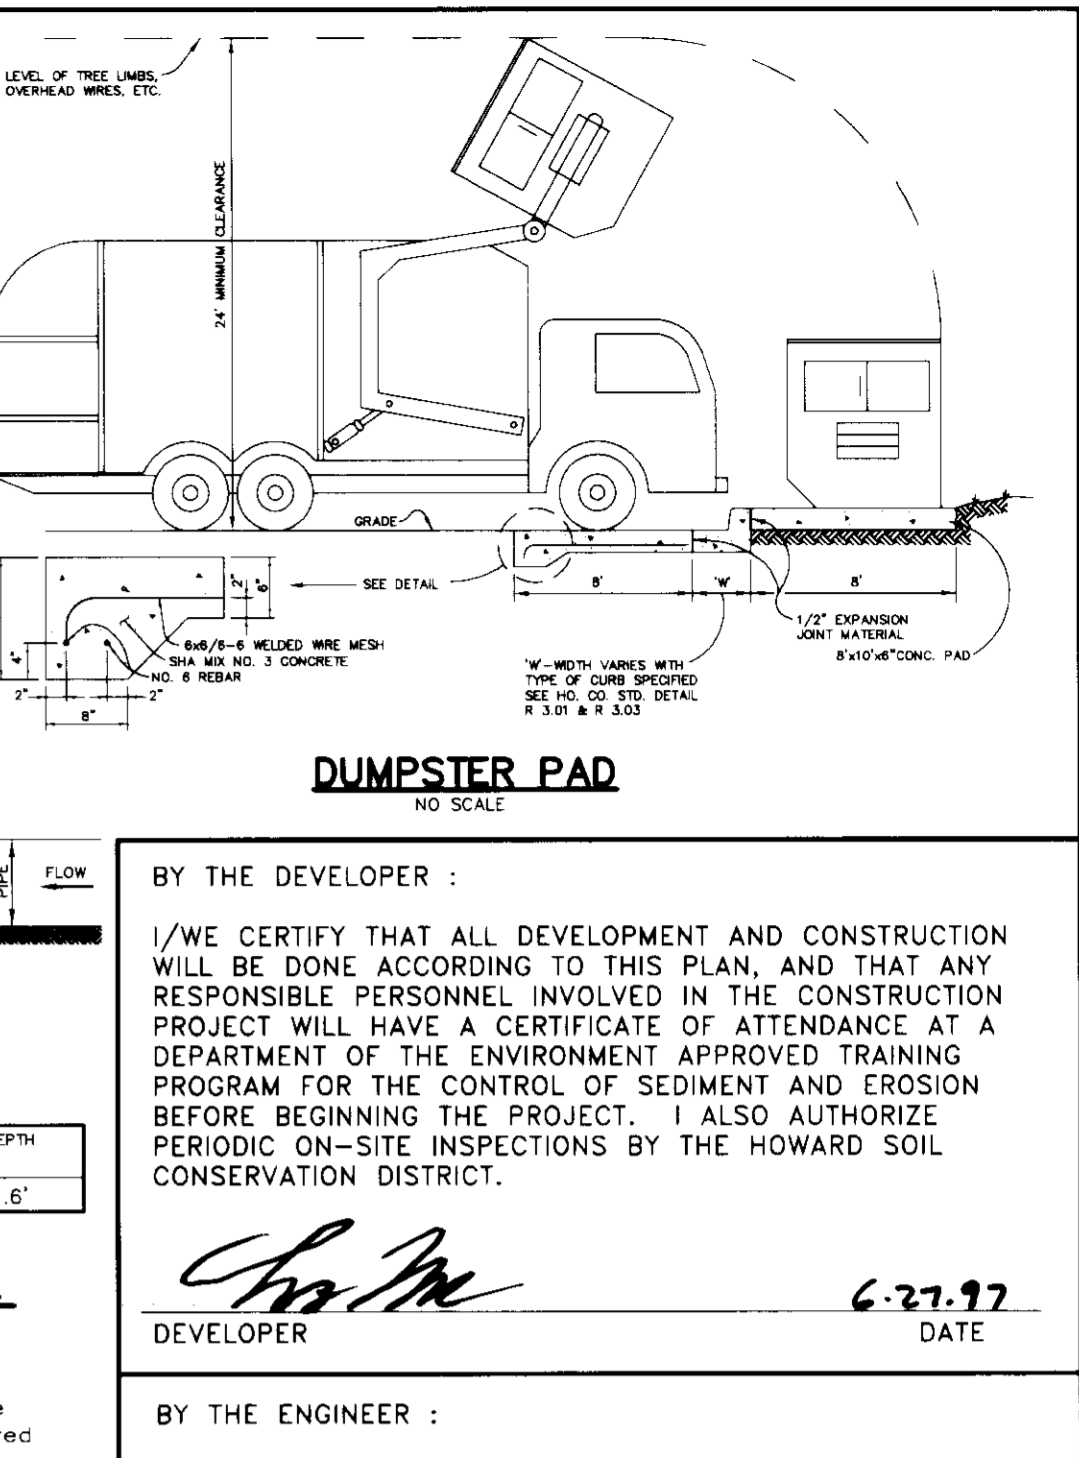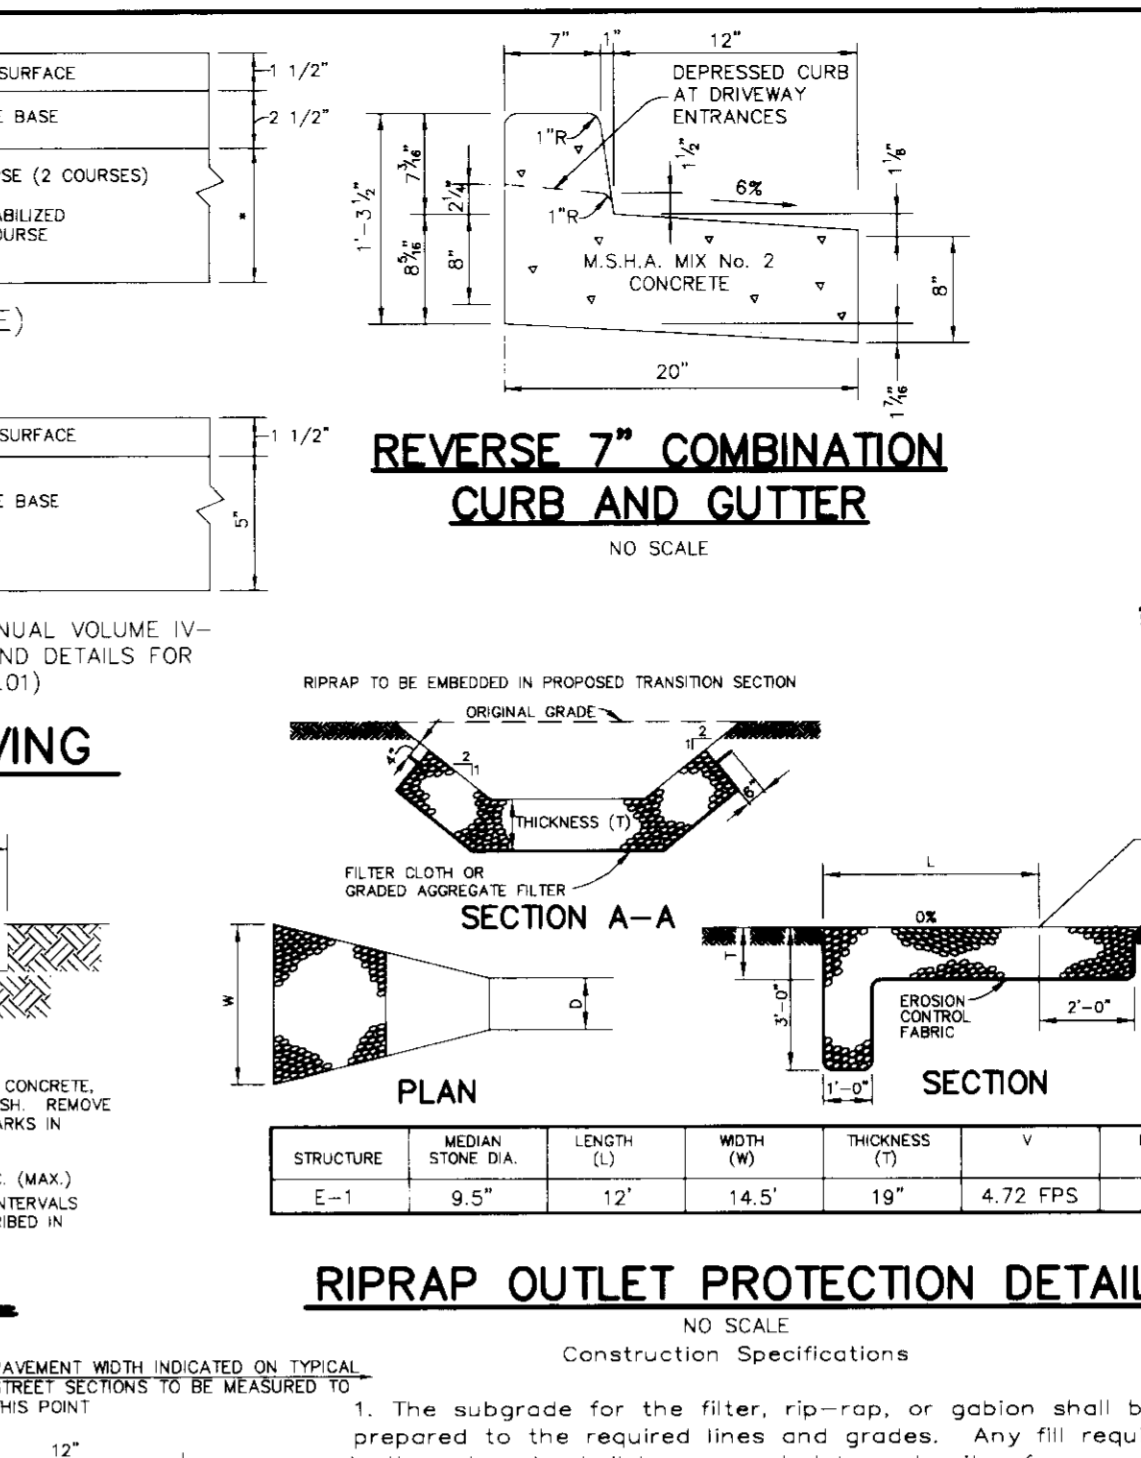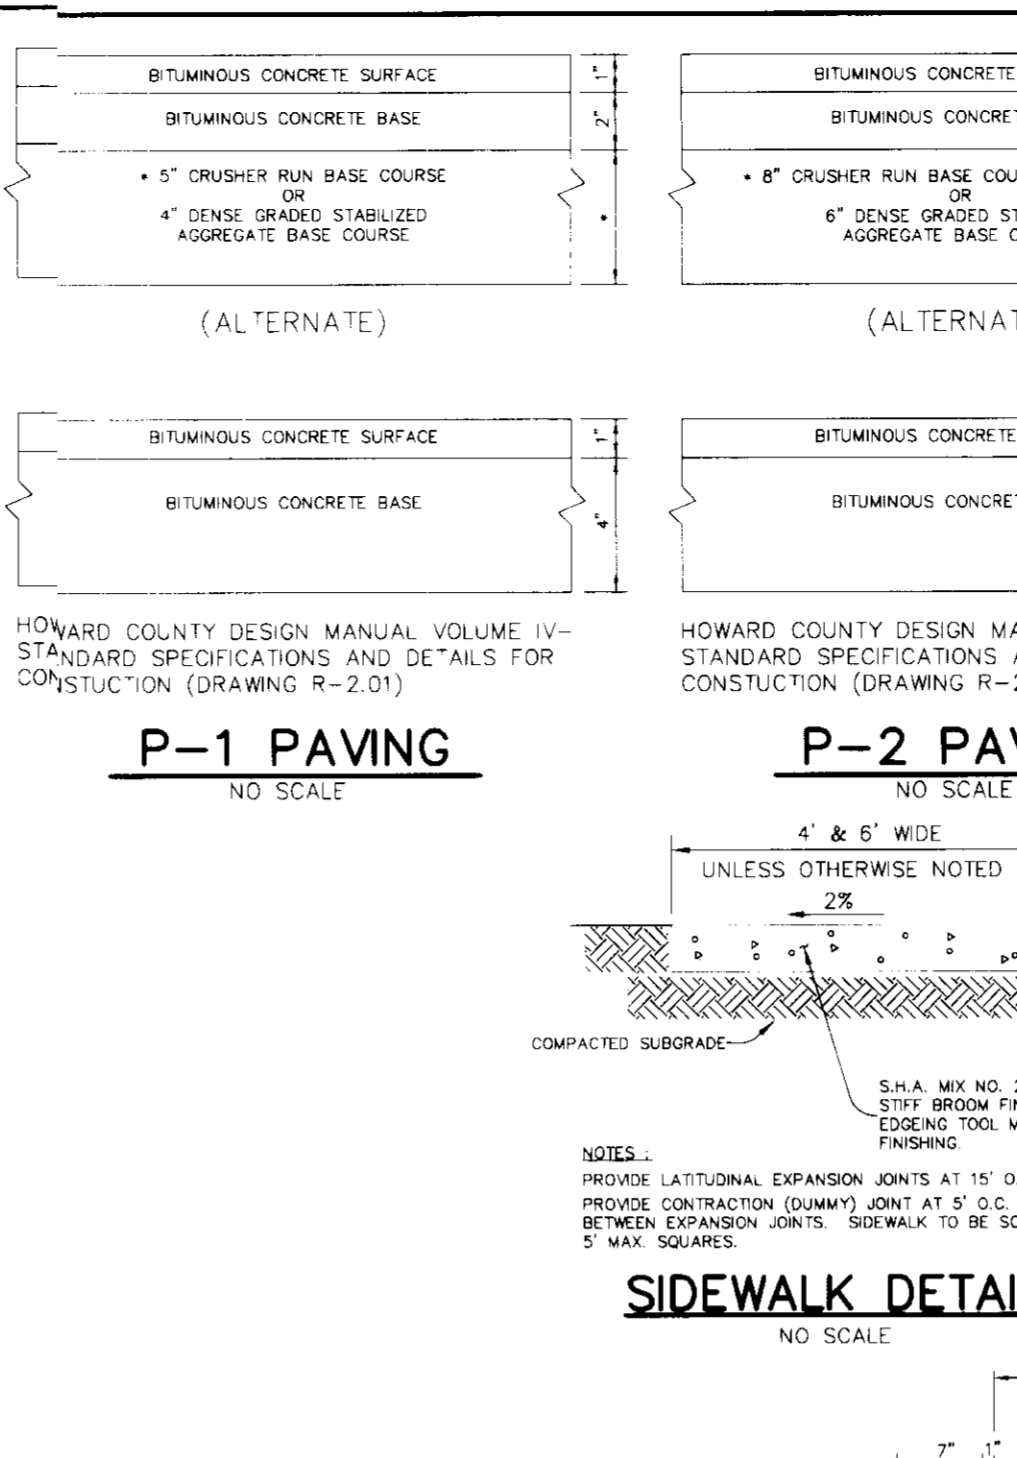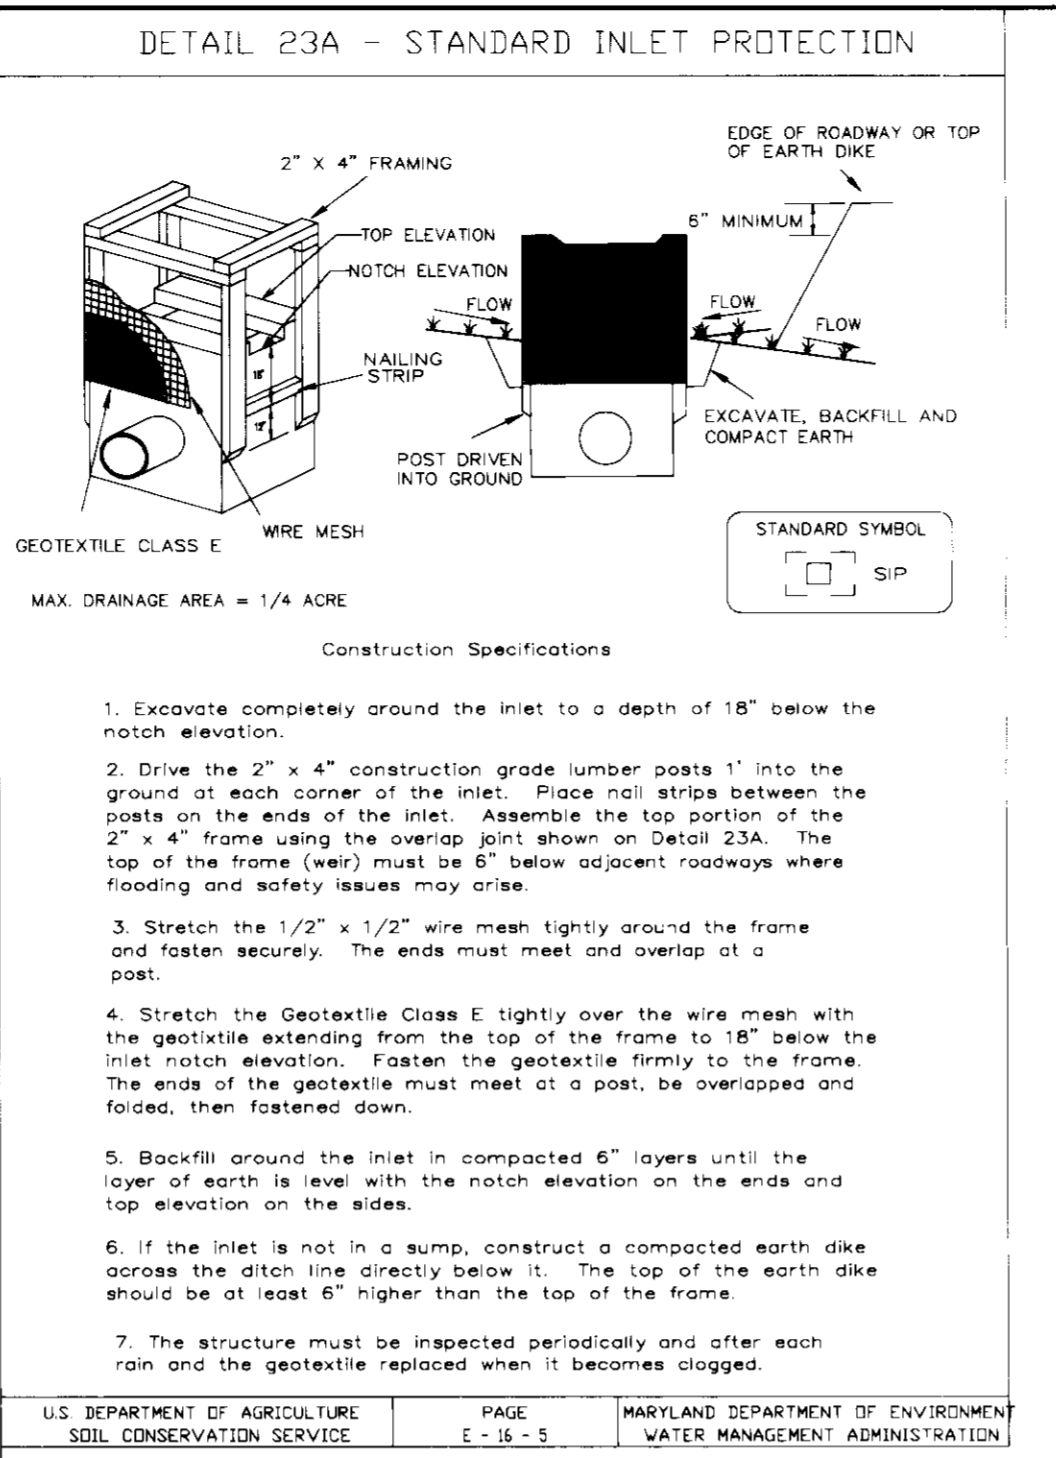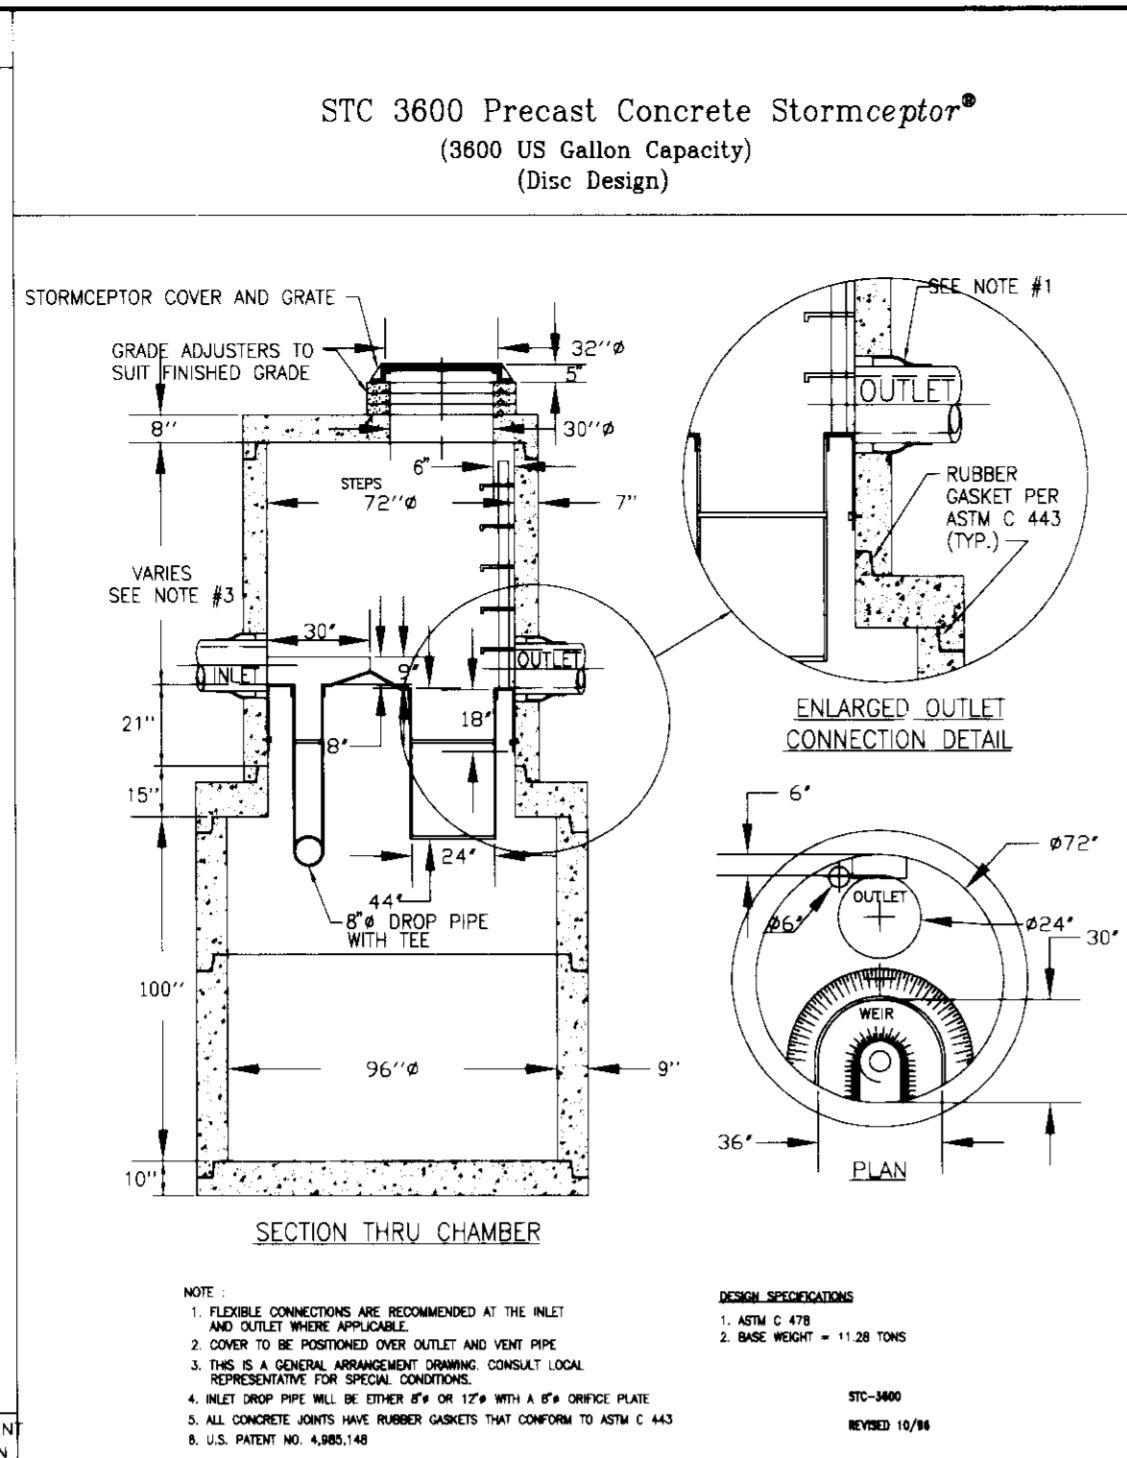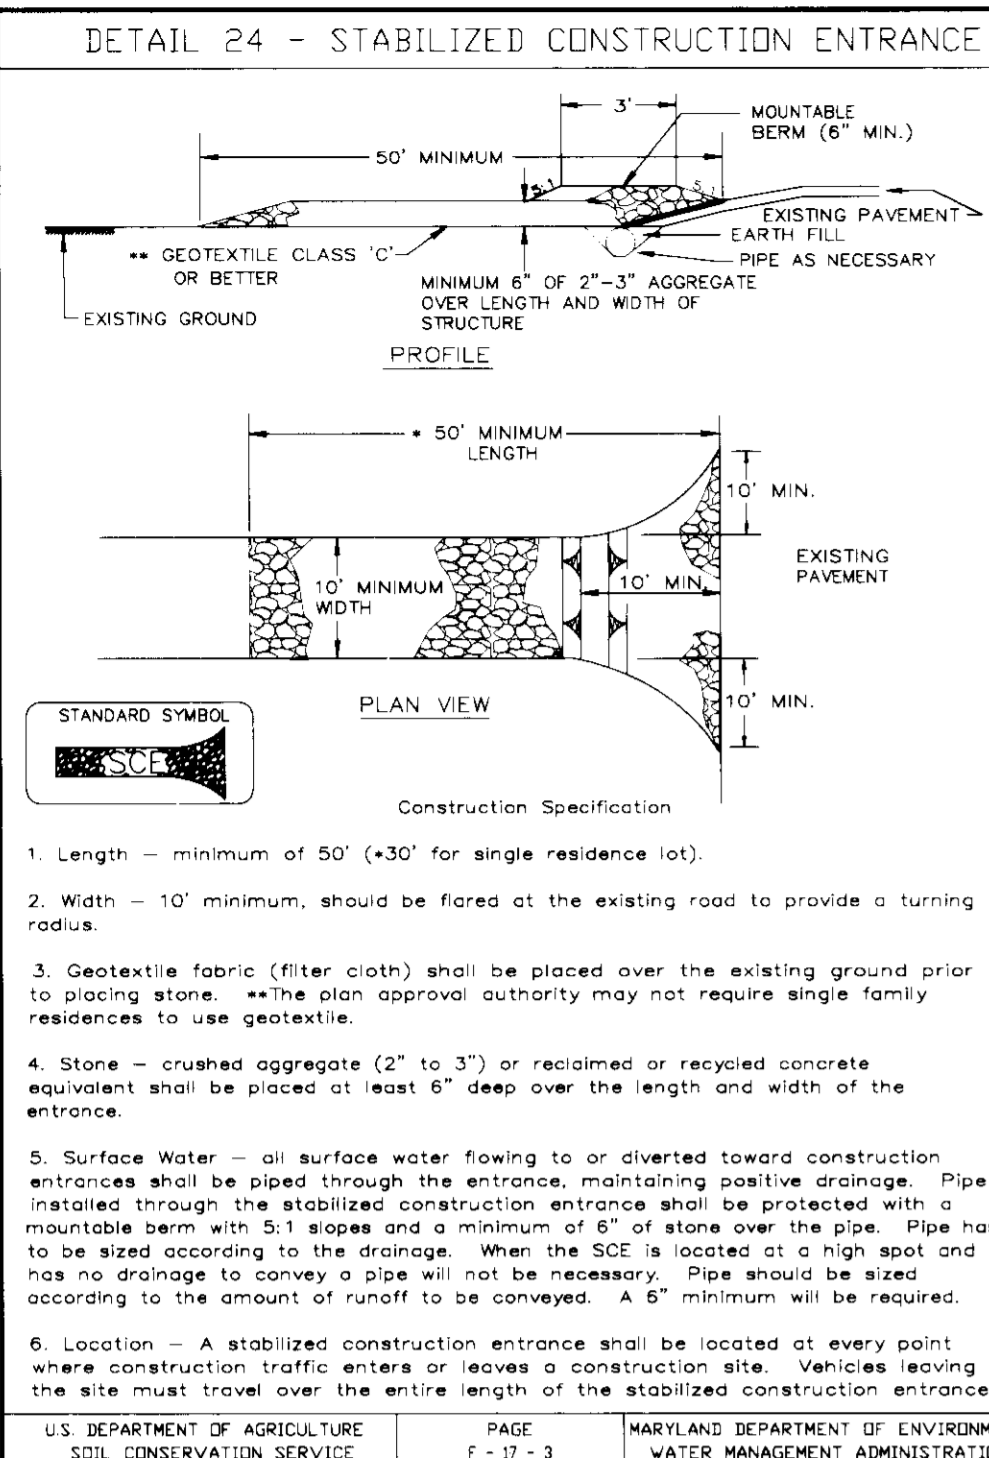

Concrete Stormceptor Order Request Form

Contractor Information: Name, Address, City, State, Zip Code, Contact, Phone.

Owner Information: Name, Phone, Fax.

Stormceptor Model Selection: 9000, 1200, 1400, 1800, 2400.

Insert Size Selection: 18, 22, 32, 42.




Manhole Number, Top Elevation, Inlet Pipe Invert, Outlet Pipe Invert, Pipe Type, Inlet Pipe Diameter, Outlet Pipe Diameter.

Project Name, Address, City, Designer Company, Designer Contact.

For credit information/applications contact Carolle Broadus at (804)798-8068.

For Technical Assistance Please Call Stormceptor Corporation at (301)762-8361 or toll free at (800)762-4703

U.S. DEPARTMENT OF AGRICULTURE SOIL CONSERVATION SERVICE PAGE E-15-3 MARYLAND DEPARTMENT OF ENVIRONMENT WATER MANAGEMENT ADMINISTRATION

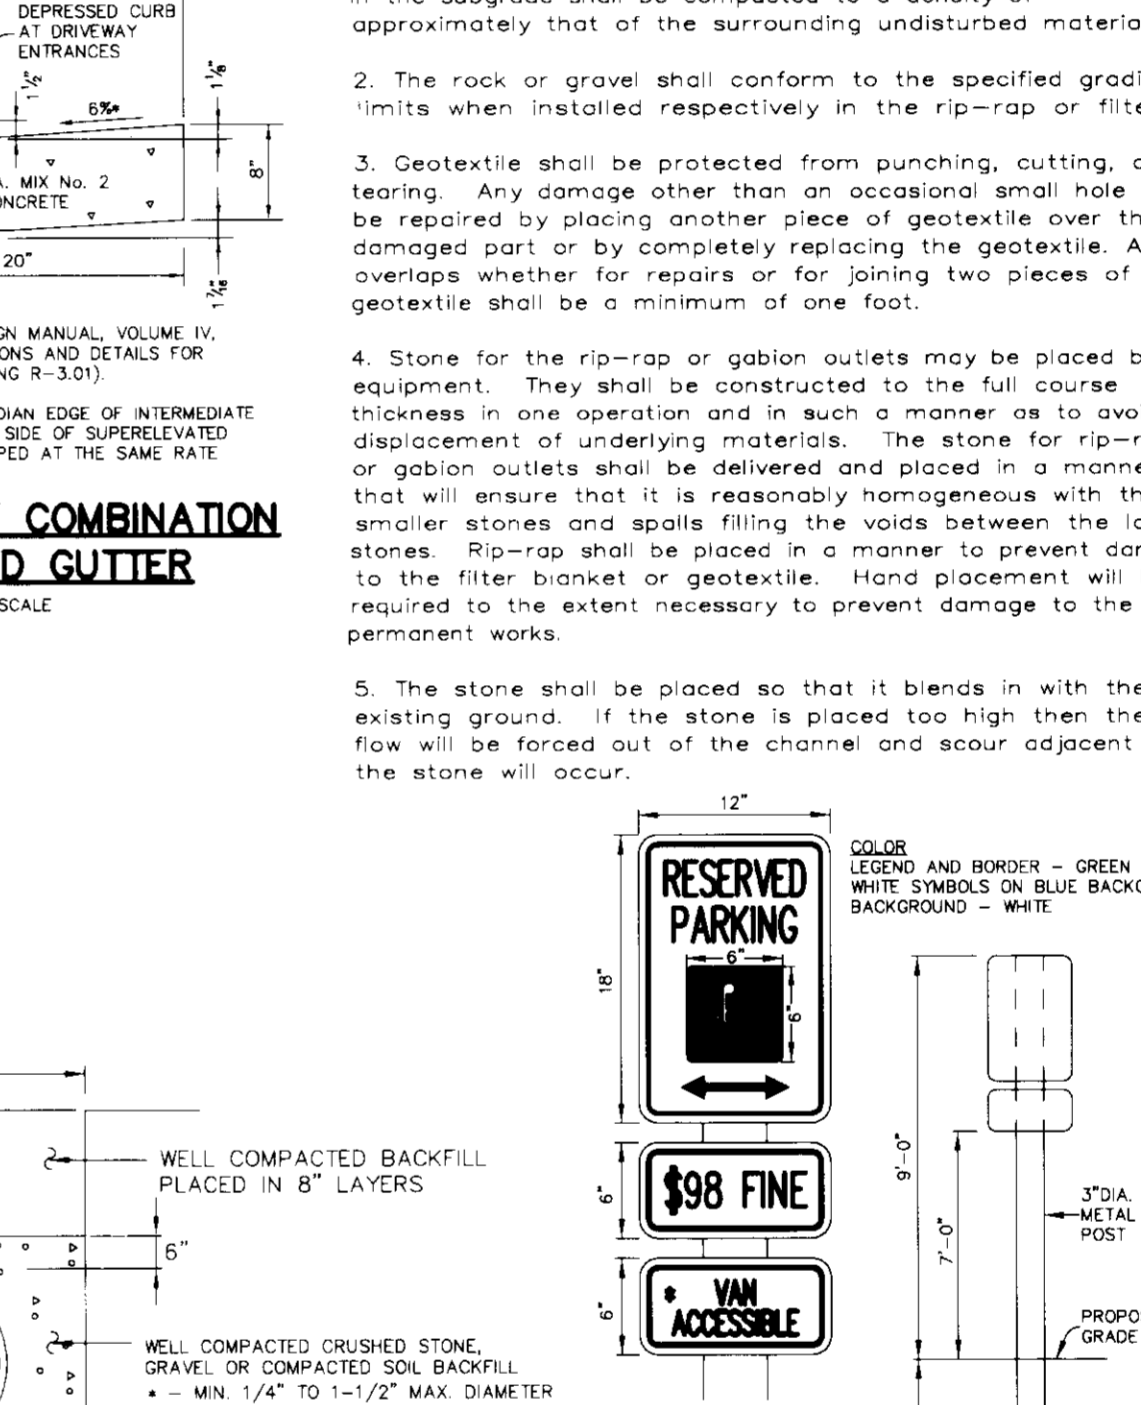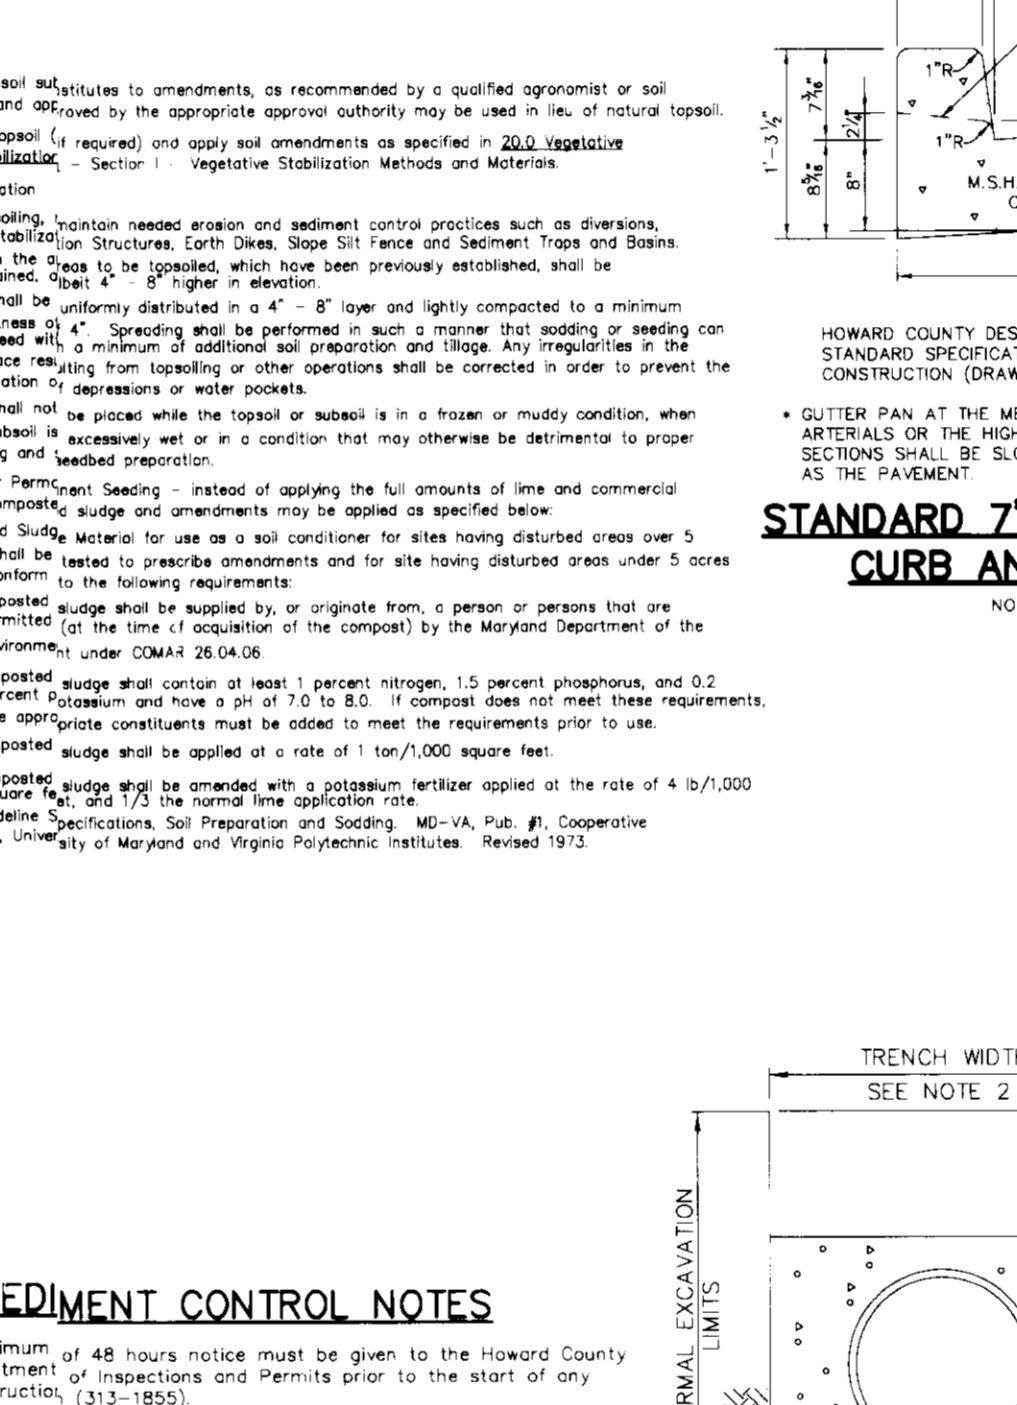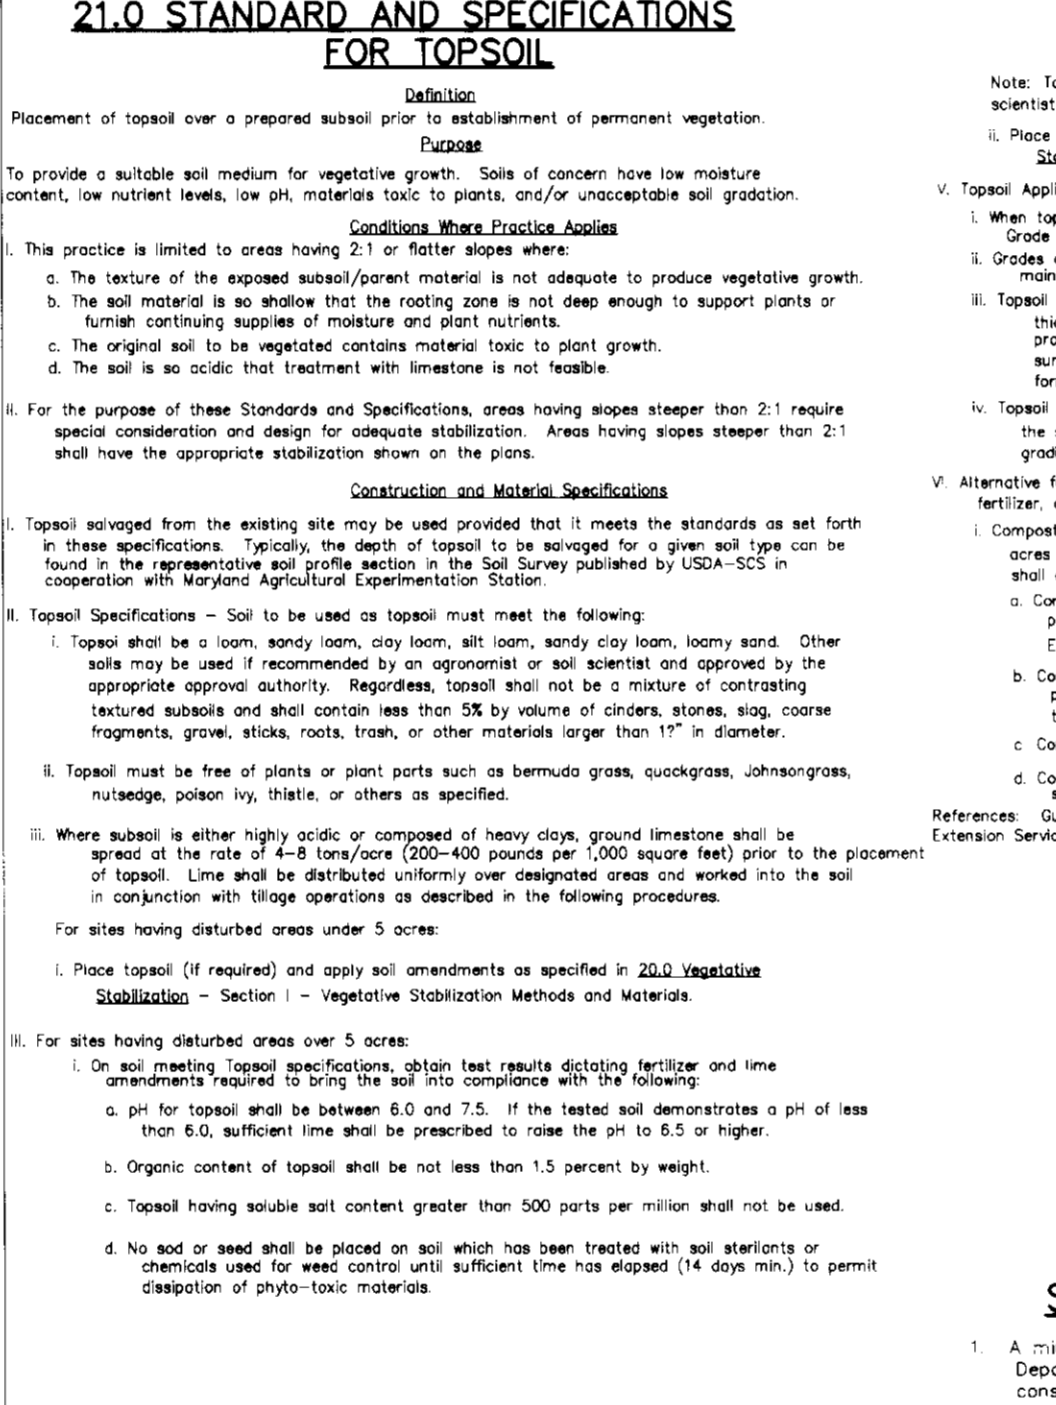


BY THE DEVELOPER: *J. Farrell* DATE 6-27-97

I/WE CERTIFY THAT ALL DEVELOPMENT AND CONSTRUCTION WILL BE DONE ACCORDING TO THIS PLAN, AND THAT ANY RESPONSIBLE PERSONNEL INVOLVED IN THE CONSTRUCTION PROJECT WILL HAVE A CERTIFICATE OF ATTENDANCE AT A TRAINING PROGRAM FOR THE CONTROL OF SEDIMENT AND EROSION BEFORE BEGINNING THE PROJECT. I ALSO AUTHORIZE PERIODIC ON-SITE INSPECTIONS BY THE HOWARD SOIL CONSERVATION DISTRICT.

BY THE ENGINEER: *J. Farrell* DATE 6-27-97

I CERTIFY THAT THIS PLAN FOR EROSION AND SEDIMENT CONTROL REPRESENTS A PRACTICAL AND WORKABLE PLAN BASED ON MY PERSONAL KNOWLEDGE OF THE SITE CONDITIONS AND THAT IT WAS PREPARED IN ACCORDANCE WITH THE REQUIREMENTS OF THE HOWARD SOIL CONSERVATION DISTRICT.

U.S. DEPARTMENT OF AGRICULTURE SOIL CONSERVATION SERVICE PAGE E-15-3 MARYLAND DEPARTMENT OF ENVIRONMENT WATER MANAGEMENT ADMINISTRATION

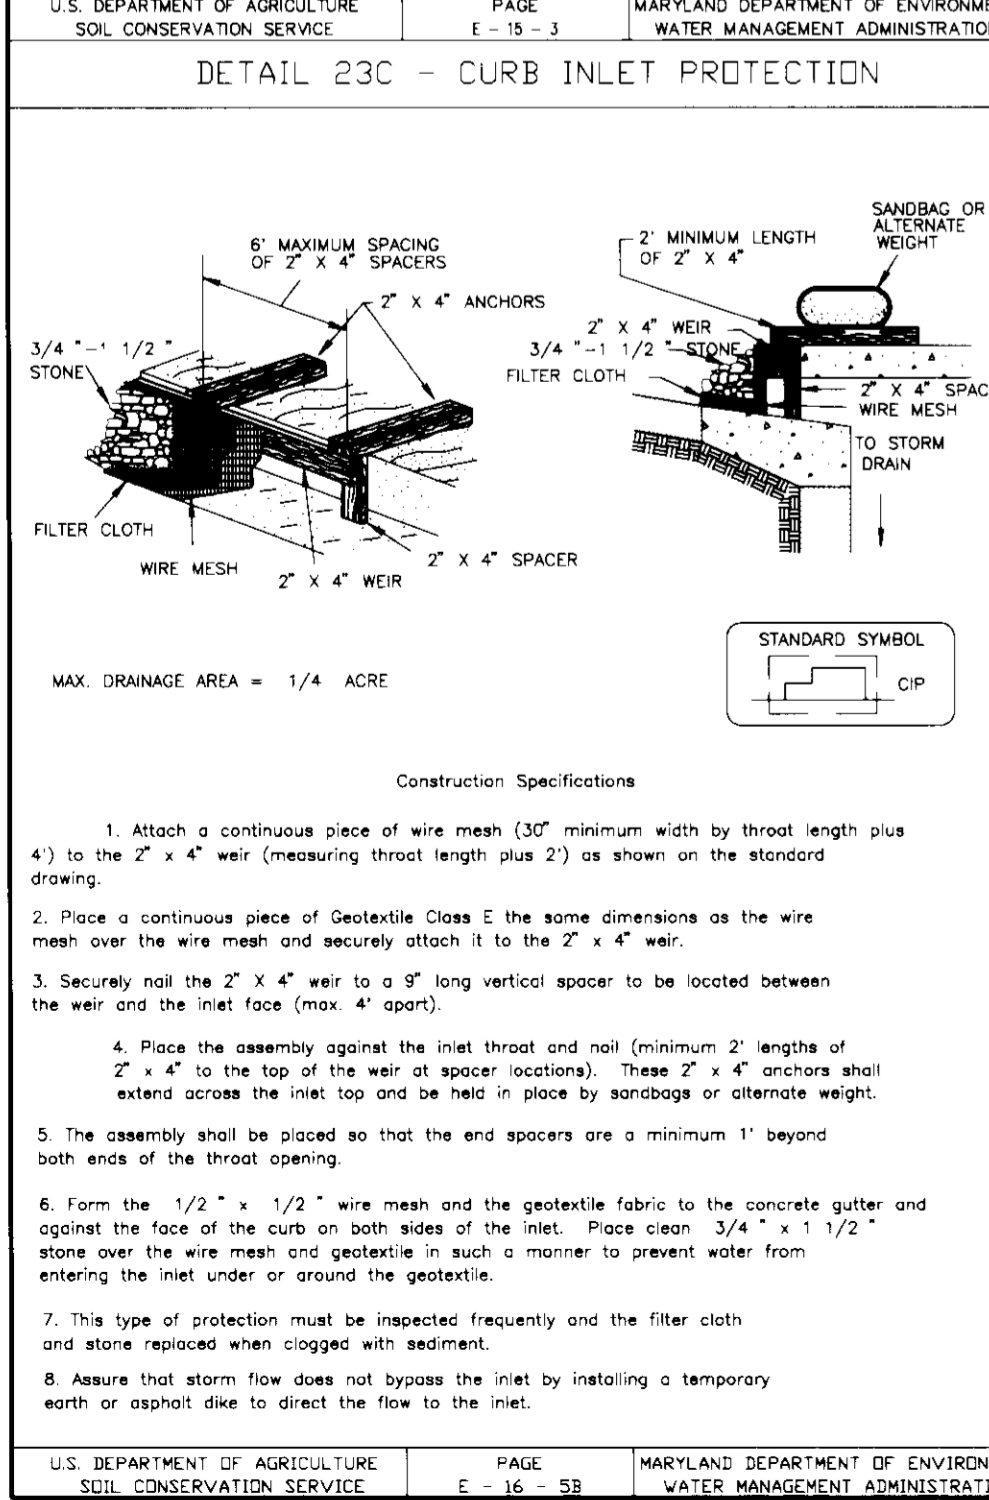

Concrete Stormceptor Order Request Form

Contractor Information: Name, Address, City, State, Zip Code, Contact, Phone.

Owner Information: Name, Phone, Fax.

Stormceptor Model Selection: 9000, 1200, 1400, 1800, 2400.

Insert Size Selection: 18, 22, 32, 42.




Manhole Number, Top Elevation, Inlet Pipe Invert, Outlet Pipe Invert, Pipe Type, Inlet Pipe Diameter, Outlet Pipe Diameter.

Project Name, Address, City, Designer Company, Designer Contact.

For credit information/applications contact Carolle Broadus at (804)798-8068.

For Technical Assistance Please Call Stormceptor Corporation at (301)762-8361 or toll free at (800)762-4703

U.S. DEPARTMENT OF AGRICULTURE SOIL CONSERVATION SERVICE PAGE E-15-3 MARYLAND DEPARTMENT OF ENVIRONMENT WATER MANAGEMENT ADMINISTRATION

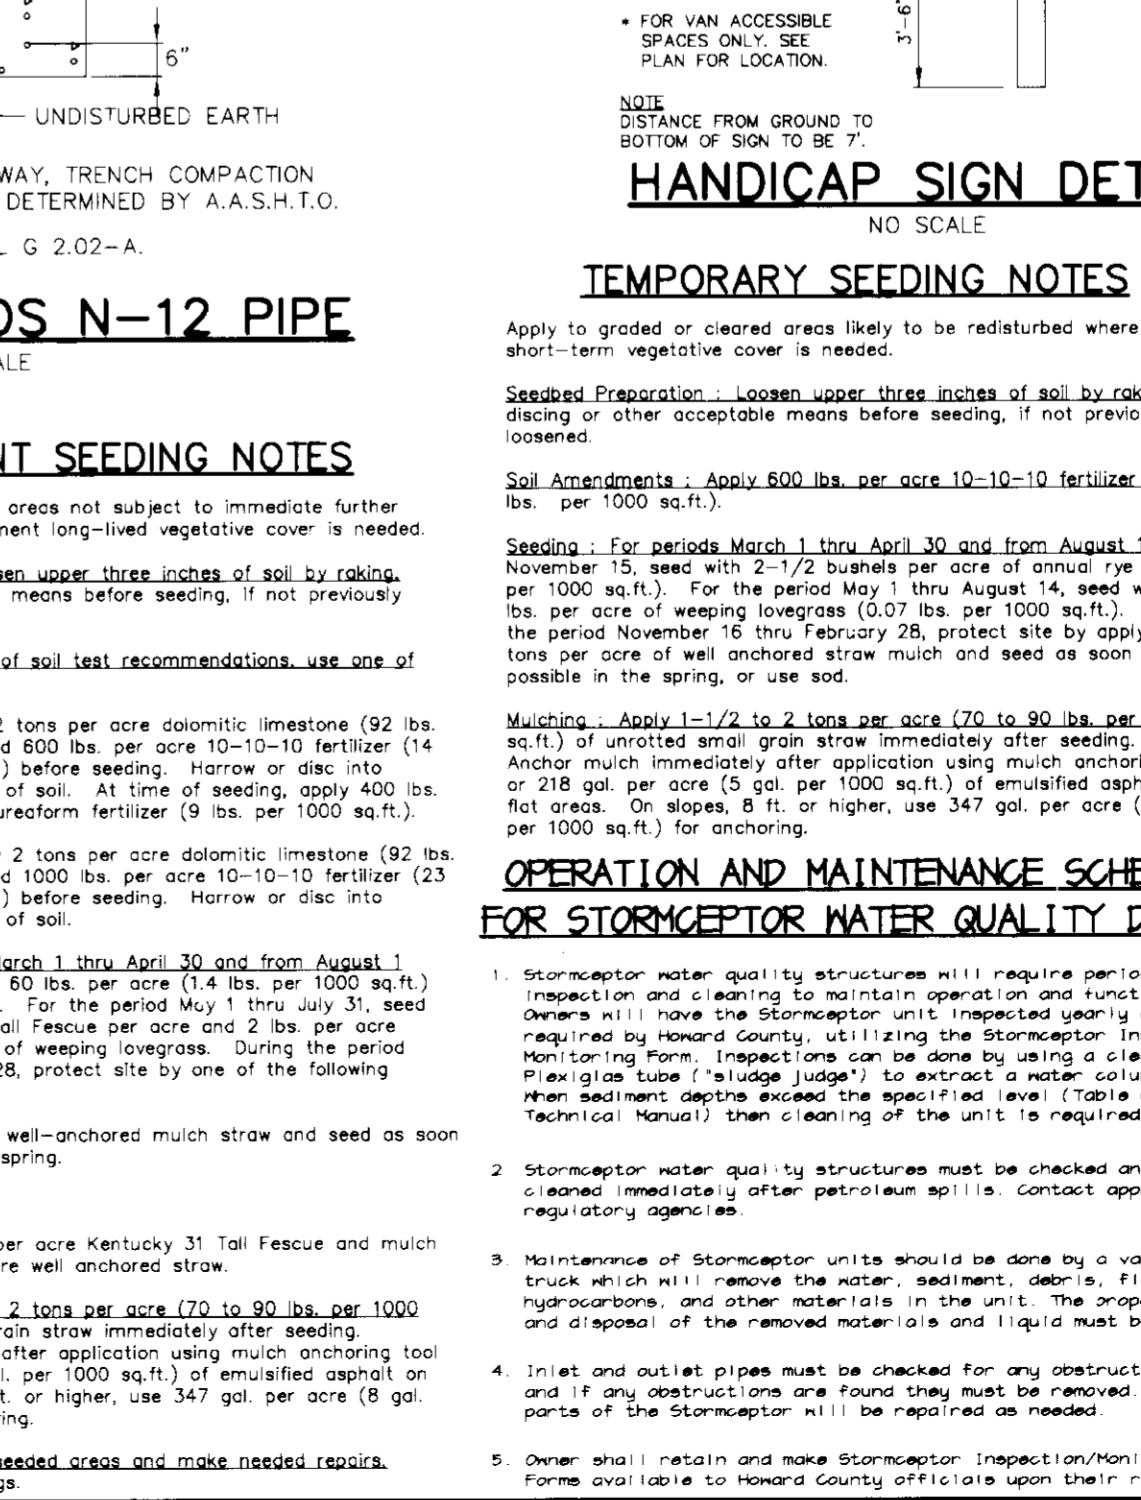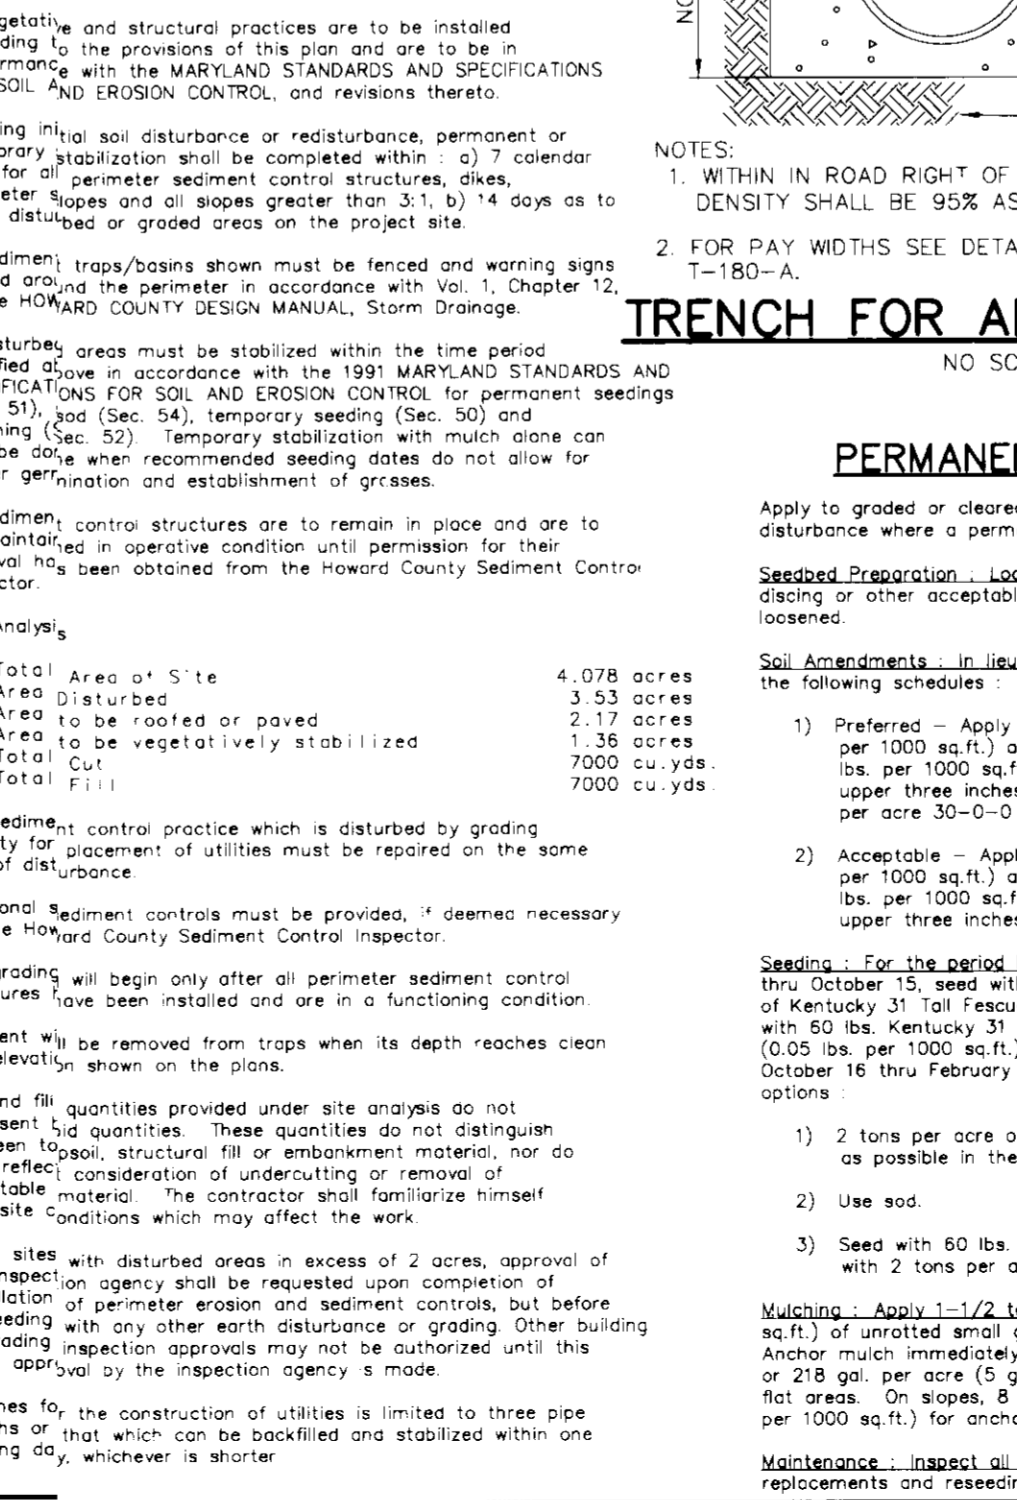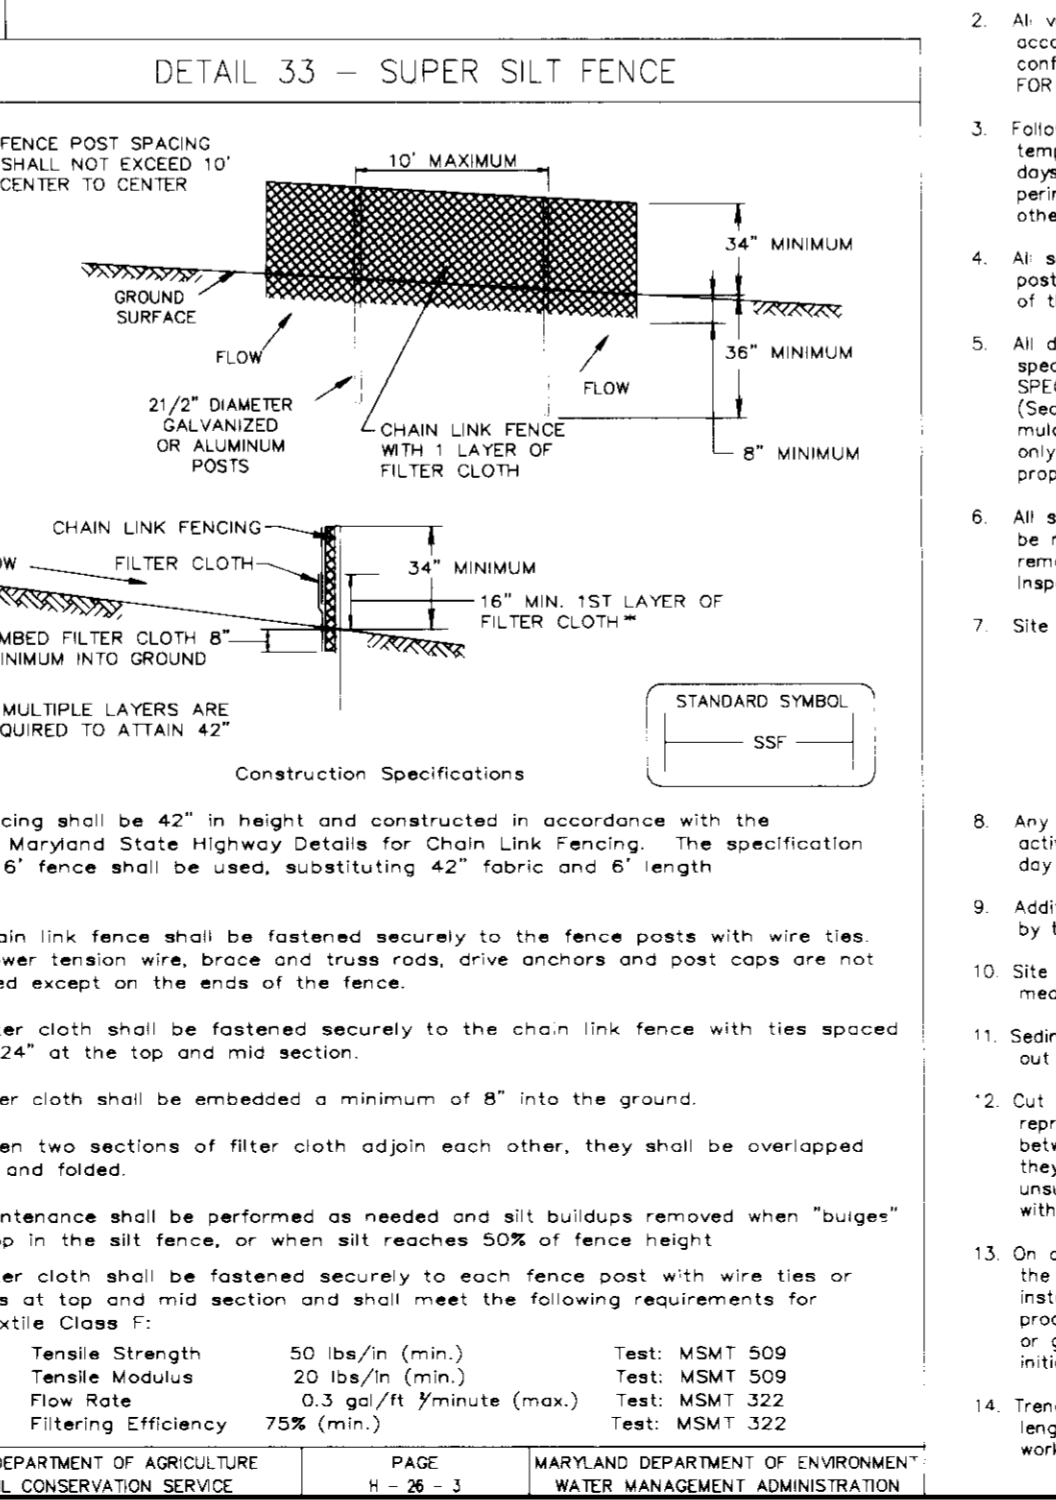

APPROVED: *James Keefe* DATE 7/18/97

APPROVED: *Michael...* DATE 7/17/97

APPROVED: *Carole Hamner* DATE 7/18/97

OWNER: THE HOWARD RESEARCH & DEVELOPMENT CORP. 10275 THE ROUSE BUILDING COLUMBIA, MARYLAND 21044 (410) 982-6000

DEVELOPER: CAREMATIX CORPORATION 147 FIRST AVENUE NEEDHAM, MA 02194 (617) 433-1000


PROJECT: DORSEY HALL ASSISTED LIVING FACILITY

AREA: DORSEY HALL SECT 2 AREA 5 PARCEL 0-7 ZONED FOR TAX MAP 30 BLOCK 4 2nd ELECTION DISTRICT HOWARD COUNTY, MD

TITLE: NOTES AND DETAILS

OPERATION AND MAINTENANCE SCHEDULE FOR STORMCEPTOR WATER QUALITY DEVICE

U.S. DEPARTMENT OF AGRICULTURE SOIL CONSERVATION SERVICE PAGE E-16-3 MARYLAND DEPARTMENT OF ENVIRONMENT WATER MANAGEMENT ADMINISTRATION

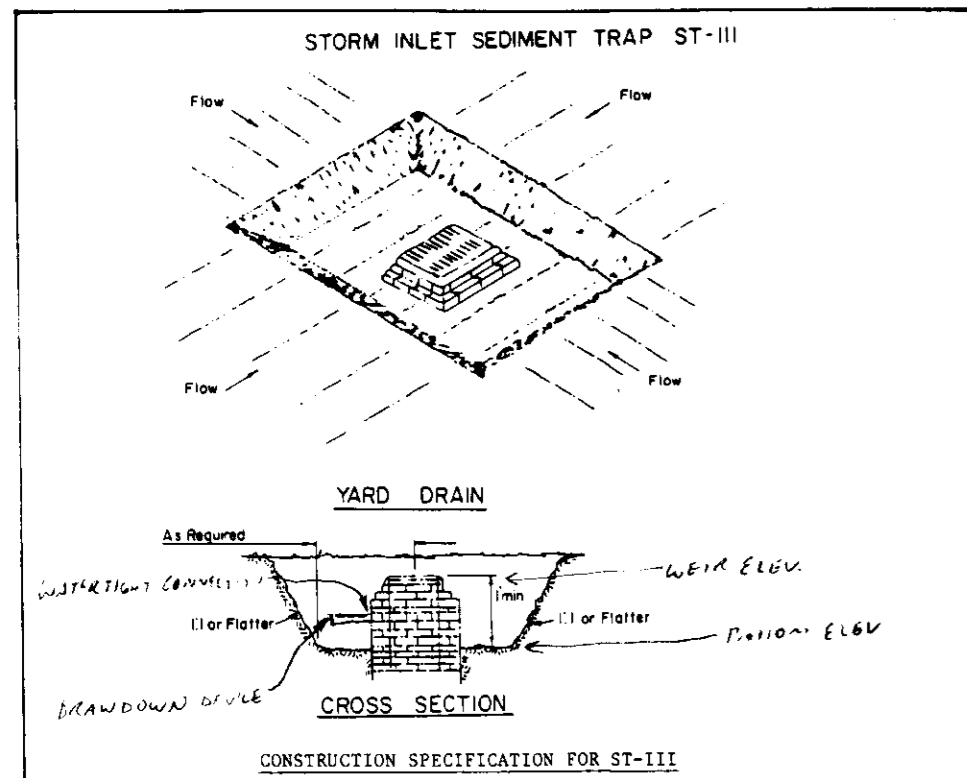

STORM INLET SEDIMENT TRAP ST-III

1. Sediment shall be removed and the trap restored to its original dimensions when the sediment has accumulated to 1/2 the design depth of the trap. Removed sediment shall be deposited in a suitable area and in such a manner that it will not erode.

2. The volume of sediment storage shall be 1800 cubic feet per acre of contributory drainage.

3. The structure shall be inspected after each rain and repairs made as needed.

4. Construction operations shall be carried out in such a manner that erosion and water pollution shall be minimized.


5. The sediment trap shall be removed and the area stabilized when the constructed drainage area has been properly stabilized.

6. All out slopes shall be 1:1 or flatter.

Maximum Drainage Area: 3 Acres

U.S. DEPARTMENT OF AGRICULTURE SOIL CONSERVATION SERVICE COLLEGE PARK, MARYLAND

STORM INLET SEDIMENT TRAP STANDARD DRAWING C-19-113

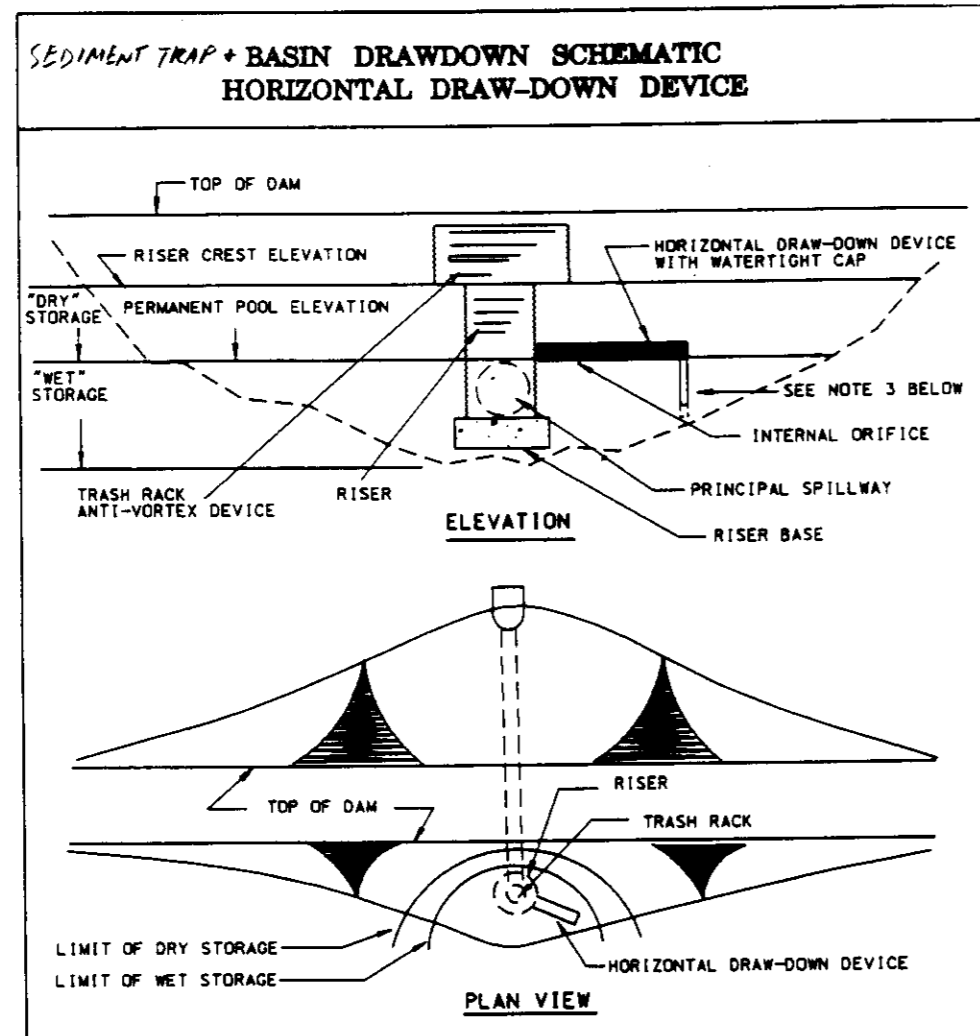

SEDIMENT TRAP + BASIN DRAWDOWN SCHEMATIC HORIZONTAL DRAW-DOWN DEVICE

1. The total area of the perforations must be greater than 2 times the area of the internal orifice.

2. The perforated portion of the draw-down device shall be wrapped with 1/2" hardware cloth and geotextile fabric. The geotextile fabric shall meet the specifications for Geotextiles Class E.

3. Provide support of draw-down device to prevent sagging and flotation. An acceptable preventive measure is to stake both sides of draw-down device with 1" steel angles or 1" by 4" square or 2" round wooden posts set 3' minimum into the ground then joining them to the device by wrapping with 12 gauge minimum wire.

U.S. DEPARTMENT OF AGRICULTURE SOIL CONSERVATION SERVICE

DRAINAGE DATA


INLET NO.	AREA IN ACRES	PERCENT IMPERVIOUS
1	0.1	0.60
2	0.3	0.66
3	0.2	0.55
4	0.4	0.55
5	0.6	0.55
6	0.6	0.24
7	0.1	0.24

STORM INLET SEDIMENT TRAP #1

DRAINAGE AREA: 0.4 AC.
 STORAGE VOLUME REQUIRED: 120 C.F. (NET/DRY)
 STORAGE VOLUME PROVIDED: 707 C.F. @ 346.75 (NET) = DRAWDOWN DEVICE ELEV.
 STORAGE VOLUME PROVIDED: 707 C.F. @ 340.10 (DRY) ELEV.
 NET IR. ELEV.: 346.10
 BOTTOM ELEV.: 344.00
 CLEANOUT ELEV.: 345.00
 SIDE SLOPES: 2:1
 CREST WIDTH: 5'-0"
 BOTTOM DIMENSIONS: 9' X 14'
 DEPTH: 4'-1"

STORM INLET SEDIMENT TRAP #2

DRAINAGE AREA: 1.4 AC.
 STORAGE VOLUME REQUIRED: 2520 C.F. (NET/DRY)
 STORAGE VOLUME PROVIDED: 2634 C.F. @ 346.75 (NET) = DRAWDOWN DEVICE ELEV.
 STORAGE VOLUME PROVIDED: 2634 C.F. @ 340.80 (DRY)
 NET IR. ELEV.: 346.80
 BOTTOM ELEV.: 345.00
 CLEANOUT ELEV.: 345.90
 SIDE SLOPES: 2:1
 CREST WIDTH: 2'-5"
 BOTTOM DIMENSIONS: 10' X 10'
 DEPTH: 3'-5"

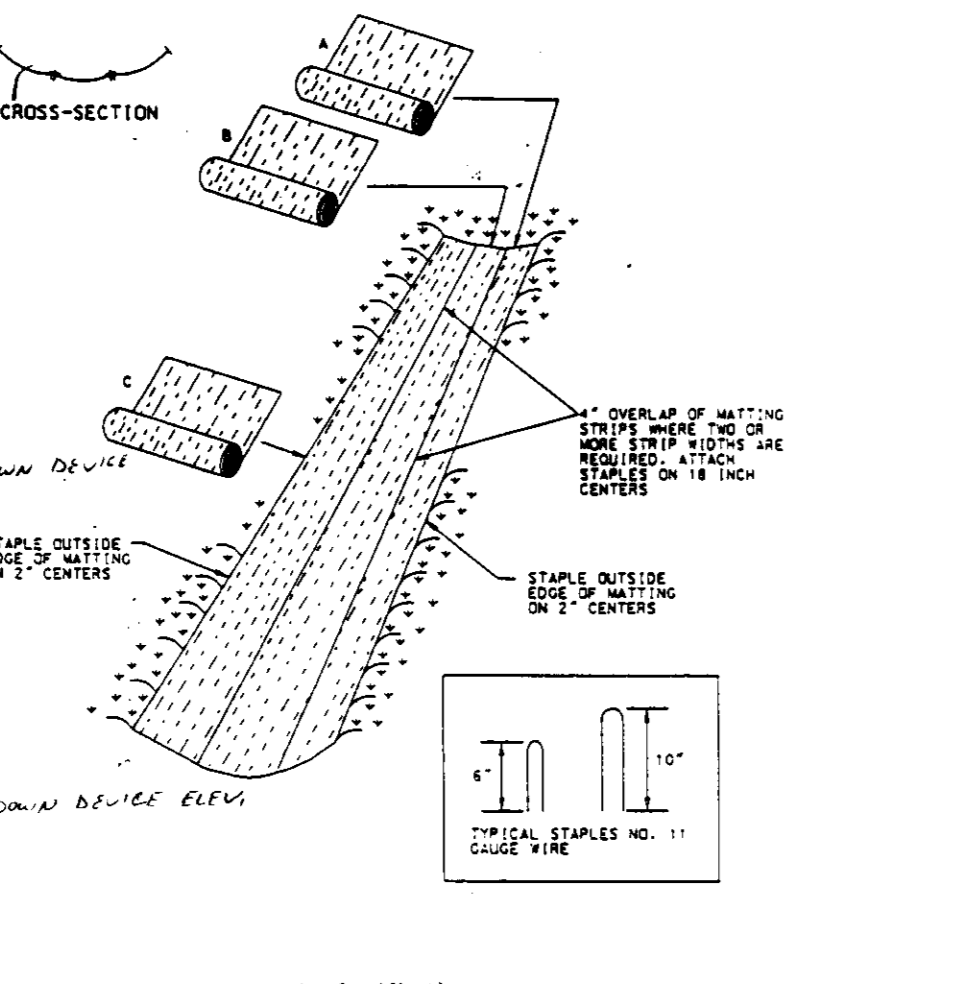

EROSION CONTROL MATTING DETAIL

1. Key-in the matting by placing the top edge of the matting in a narrow trench, 1/2" in depth. Backfill the trench and ram firmly to conform to the channel cross-section. Secure with a row of staples down 4" open slope from the trench. Spacing between staples is 6".

2. Staple the 4" overlap in the channel center using an 18" spacing between staples.


3. Before stapling the outer edge of the matting, make sure the matting is smooth and in firm contact with the soil.

4. Staples shall be placed 2' apart with 4 rows for each 8'-2" outer row; and 2 alternating rows down the center.

5. Where one roll of matting ends and another begins, the end of the top strip shall overlap the upper end of the lower strip by 4" in the channel center. Reinforce the overlap with a double row of staples spaced 6" apart in a staggered pattern on either side.

6. The discharge end of the matting liner should be similarly secured with 2 double rows of staples.

Notes: If flow will enter from the edge of the matting then the area affected by the flow must be key-in.

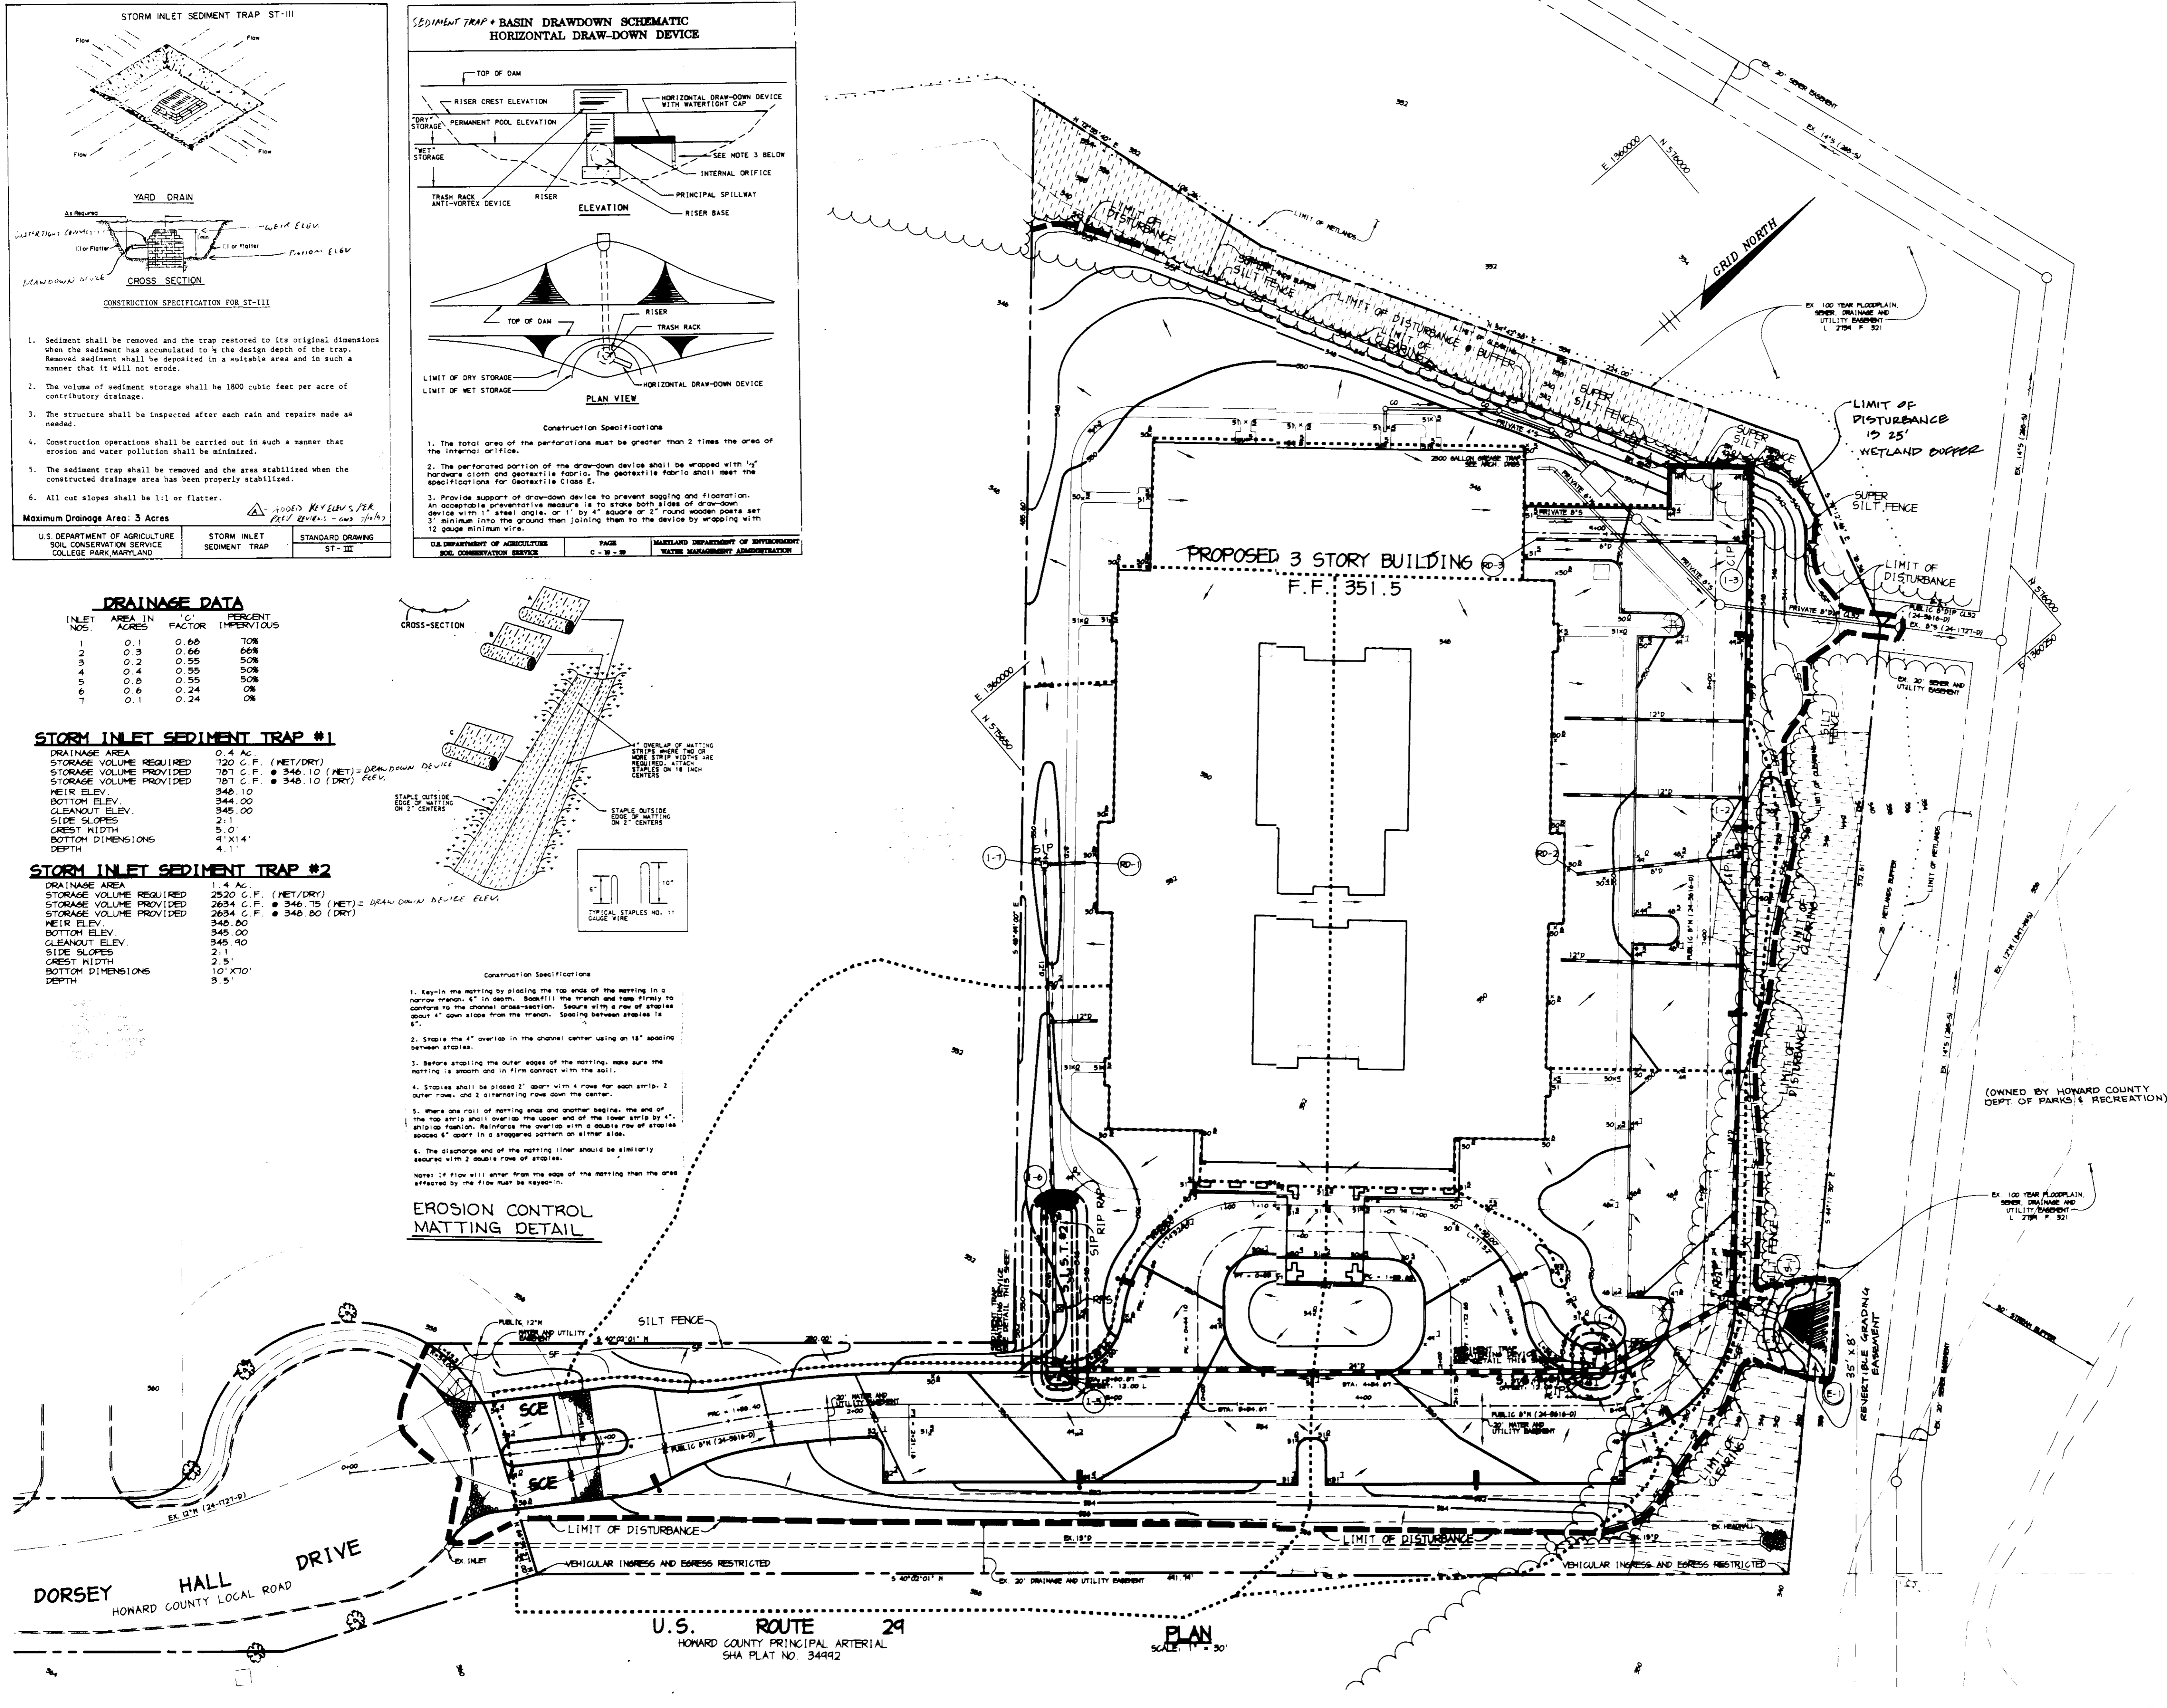

LEGEND

- DRAINAGE DIVIDE
- LIMIT OF DISTURBANCE
- SFP--- SUPER SILT FENCE
- SF--- SILT FENCE
- CIP CURB INLET PROTECTION
- AGIP AT GRADE INLET PROTECTION
- SCE STABILIZED CONSTRUCTION ENTRANCE

NOTE: LIMIT OF DISTURBANCE IS AT PROPERTY LINE UNLESS OTHERWISE NOTED.

BY THE DEVELOPER:

I/WE CERTIFY THAT ALL DEVELOPMENT AND CONSTRUCTION WILL BE DONE ACCORDING TO THIS PLAN, AND THAT ANY RESPONSIBLE PERSONNEL INVOLVED IN THE CONSTRUCTION PROJECT WILL HAVE A CERTIFICATE OF ATTENDANCE AT A DEPARTMENT OF THE ENVIRONMENT APPROVED TRAINING PROGRAM FOR THE CONTROL OF SEDIMENT AND EROSION BEFORE BEGINNING THE PROJECT. I ALSO AUTHORIZE PERIODIC ON-SITE INSPECTIONS BY THE HOWARD SOIL CONSERVATION DISTRICT.

Charm
 DEVELOPER DATE 6-27-97

BY THE ENGINEER:

I CERTIFY THAT THIS PLAN FOR EROSION AND SEDIMENT CONTROL REPRESENTS A PRACTICAL AND WORKABLE PLAN BASED ON MY PERSONAL KNOWLEDGE OF THE SITE CONDITIONS AND THAT IT WAS PREPARED IN ACCORDANCE WITH THE REQUIREMENTS OF THE HOWARD SOIL CONSERVATION DISTRICT.

J. Parekh
 ENGINEER DATE 6-27-97

THESE PLANS HAVE BEEN REVIEWED FOR THE HOWARD SOIL CONSERVATION DISTRICT AND MEET THE TECHNICAL REQUIREMENTS FOR SOIL EROSION AND SEDIMENT CONTROL.

Amel Simons 7/10/97
 NATURAL RESOURCES CONSERVATION SERVICE DATE

THIS DEVELOPMENT PLAN IS APPROVED FOR SOIL EROSION AND SEDIMENT CONTROL BY THE HOWARD SOIL CONSERVATION DISTRICT.

Melby 7/10/97
 HOWARD SOIL CONSERVATION DISTRICT DATE

APPROVED: HOWARD COUNTY DEPARTMENT OF PLANNING AND ZONING.

James R. Smith 7/13/97
 DIRECTOR DATE

Mike Dammicus 7/12/97
 CHIEF, DEVELOPMENT ENGINEERING DIVISION DATE

Linda Harriott 7/13/97
 CHIEF, DIVISION OF LAND DEVELOPMENT DATE

OWNER: THE HOWARD RESEARCH & DEVELOPMENT CORP.
 THE ROUSE BUILDING
 10275 LITTLE PATUXENT PARKWAY
 COLUMBIA, MARYLAND 21044
 (410) 992-6000

DEVELOPER: CAREMATRIX CORPORATION
 197 FIRST AVENUE
 NEEDHAM MA 02194
 (617) 433-1000

PROJECT: DORSEY HALL ASSISTED LIVING FACILITY

AREA DORSEY HALL SECT 2 AREA 5 PARCEL 0-7 ZONED FOR TAX MAP 30 BLOCK 4 2nd ELECTION DISTRICT HOWARD COUNTY, MD.

TITLE: DRAINAGE AREA MAP AND SEDIMENT CONTROL PLAN

RIEMER MUEGGE & ASSOCIATES, INC.
 ENGINEERING • ENVIRONMENTAL SERVICES • PLANNING • SURVEYING
 8818 Centre Park Drive, Columbia, Maryland 21045
 tel 410.997.8900 fax 410.997.9282

DATE: 6-27-97

DESIGNED BY: C.J.R.
 DRAWN BY: DAM
 PROJECT NO: 96084 SDP3.DWG
 DATE: JUNE 27, 1997
 SCALE: AS SHOWN
 DRAWING NO: 3 OF 6

J. Parekh
 JAYKANT D. PAREKH #19148

LANDSCAPE SCHEDULES

ALTERNATIVE COMPLIANCE REQUIRED
 HRD SHADE TREE EQUIVALENT (S.T.E.) REQUIREMENTS

COMMERCIAL ZONING - 14 ACRES
 UNWOODED (3 AC @ 28 S.T.E./AC)
 SEMI-WOODED (11 AC @ 24 S.T.E./AC)
 TOTAL S.T.E. REQUIRED 108 S.T.E.

PROVIDED:
 Each Shade Tree = 1 S.T.E.
 Each Evergreen Tree = 0.5 S.T.E.
 Each Flowering Tree = 0.5 S.T.E.
 Each Shrub = 0.1 S.T.E.

SUBTOTAL S.T.E. 27
 SPECIMEN TREES = 2 S.T.E.
 TOTAL 29 S.T.E.

SCHEDULE B
PARKING LOT INTERNAL LANDSCAPING

NUMBER OF PARKING SPACES	55
NUMBER OF SHADE TREES REQUIRED * (1:10) SPACES	5.5
NUMBER OF TREES PROVIDED	12
NUMBER OF SHADE TREES SUBSTITUTION OTHER TREES (1:10) SPACES	2.75
NUMBER OF ISLANDS REQUIRED / (ISLAND: 30 SPACES)	2
NUMBER OF ISLANDS PROVIDED	3

NOTES: THIS PLAN HAS BEEN PREPARED IN ACCORDANCE WITH THE PROVISIONS OF SECTION 6-24 OF THE HOWARD COUNTY CODE AND THE LANDSCAPE MANUAL.


FINANCIAL SURETY FOR THE REQUIRED LANDSCAPING HAS BEEN POSTED AS PART OF THE DPA DEVELOPERS AGREEMENT IN THE AMOUNT OF \$ 3,930

SCHEDULE A
PERIMETER LANDSCAPE EDGE

PERIMETER	ADJACENT TO ADJACENTS		ADJACENT TO PERIMETER PROPERTIES	
	A-1 & A-2	F-1	F-2	F-3
PERIMETER	1.46	1.36	1.24	1.24
LINEAR FEET OF ROADWAY FRONTAGE PERIMETER	1.46	1.36	1.24	1.24
CREDIT FOR EXISTING VEGETATION (YES, NO, LINEAR FEET, DISCOUNT PERCENT NEEDED)	0.6	0.6	0.6	0.6
CREDIT FOR WALL, FENCE OR BENCH (YES, NO, LINEAR FEET, DISCOUNT PERCENT NEEDED)	0	0	0	0
NUMBER OF PLANTS REQUIRED	16	16	16	16
SHADE TREES	0	0	0	0
EVERGREEN TREES	0	0	0	0
FLOWERING TREES	0	0	0	0
SHRUBS	0	0	0	0
NUMBER OF PLANTS PROVIDED	16	16	16	16
SHADE TREES	0	0	0	0
EVERGREEN TREES	0	0	0	0
FLOWERING TREES	0	0	0	0
SHRUBS	0	0	0	0


SUBSTITUTION NOTES:
 PERIMETER LANDSCAPE EDGE, SCHEDULE A
 PERIMETER F-2
 (5) EVERGREEN TREES HAVE BEEN SUBSTITUTED FOR THE (7) REQUIRED SHRUBS AT A SUBSTITUTION RATE OF (1) EVERGREEN TREE FOR (5) SHRUBS

- PLANT NOTES & SPECIFICATIONS**
- Plants, related material and operators shall meet the detailed description as given on the plans and as described herein.
 - All plant material, unless otherwise specified, shall be nursery grown, uniformly branched, have a vigorous root system and shall conform to American Association of Nurserymen (A.A.N.) Standards. Plant material shall be healthy, vigorous, free from defects, decay, dieback, insect infestations, diseases of the bark, plant diseases, insect pest eggs, borers and all forms of insect infestations or objectionable damage. Plant material that is weak or which has been cut back from larger grades to meet specified requirements will be rejected. Trees with forward leaders will not be accepted. All plants shall be freshly dug, no heading plants or plants from cold storage will be accepted.
 - Unless otherwise specified, all general conditions, planting operations, details and planting specifications shall conform to "Landscape Specification Guidelines for Baltimore-Washington Metropolitan Areas," hereinafter "Landscape Guidelines" approved by the Landscape Contractors Association of Metropolitan Washington and the National Chapter of the American Society of Landscape Architects, latest edition, including all addenda.
 - Contractor shall be required to guarantee all plant material for a period of one year after date of acceptance in accordance with the appropriate section of the Landscape Guidelines. Contractor's attention is directed to the maintenance requirements found within the one year specifications including watering and replacement of specified plant material.
 - Contractor shall be responsible for notifying utility companies, utility contractors and Title Utility a minimum of 48 hours prior to beginning any work. Contractor may make minor adjustments in spacing and location of plant material to avoid conflicts with utilities. Damage to existing structures and utilities shall be repaired at the expense of the Contractor.
 - Protection of existing vegetation to remain shall be accomplished by the temporary installation of 4 foot high fence as the strip line.
 - Contractor is responsible for installing all material in the proper planting season for each plant type. All planting is to be completed within growing season of completion of site construction.
 - Bid shall be based on actual site conditions. No extra payment shall be made for work arising from site conditions differing from those indicated on drawings and specifications.
 - Plant quantities are provided for the convenience of the contractor only. If discrepancies exist between quantities shown on plan and those shown on the plant list, the quantities on the plan take precedence.
 - All shrubs and groundcover areas shall be planted in continuous prepared planting beds mulched with composted hardwood mulch as detailed and specified except where noted on plans.
 - Positive drainage shall be maintained in planting beds (minimum 2 percent slope).
 - Planting mix shall be as follows: Deciduous Plants - Two parts topsoil, one part well-rotted cow or horse manure. Add 3 lbs of standard fertilizer per cubic yard of planting mix. Evergreen Plants - Two parts topsoil, one part manure or other approved organic material. Add 3 lbs of evergreen (acidic) fertilizer per cubic yard of planting mix. Topsoil shall conform to the Landscape Guidelines.
 - Seed Control: Incorporate a pre-emergent herbicide into the planting bed following recommended rates on the label. Caution: Be sure to carefully check the chemical used to assure its adaptability to the specific groundcover to be treated.
 - Mulch: Groundcover beds should be mulched with minimum 2 inches of shredded composted hardwood or as specified on the details, whichever is greater.
 - All areas within contract limits disturbed during or prior to construction not designated to receive plants and mulch shall be fine graded and seeded.
 - The plan is intended for landscape use only. See other plan sheets for more information on grading, sediment control, layout, etc.

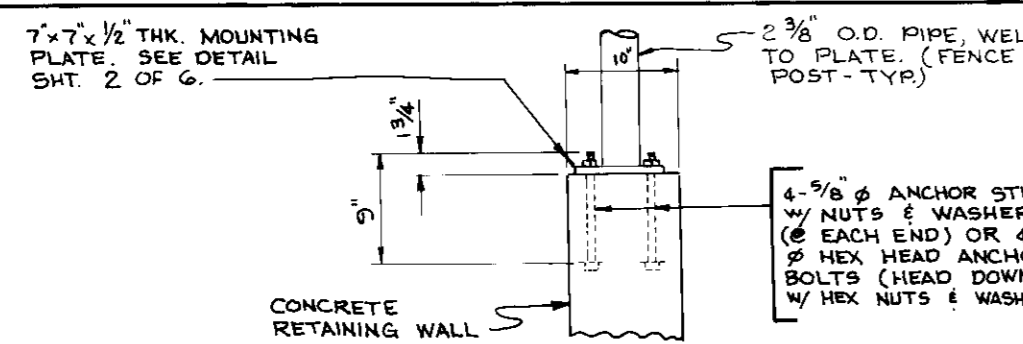

FENCE POST MOUNTING PLATE ON RETAINING WALL DETAIL
 NO SCALE

NOTE: THIS PLAN FOR LANDSCAPE PURPOSES ONLY.

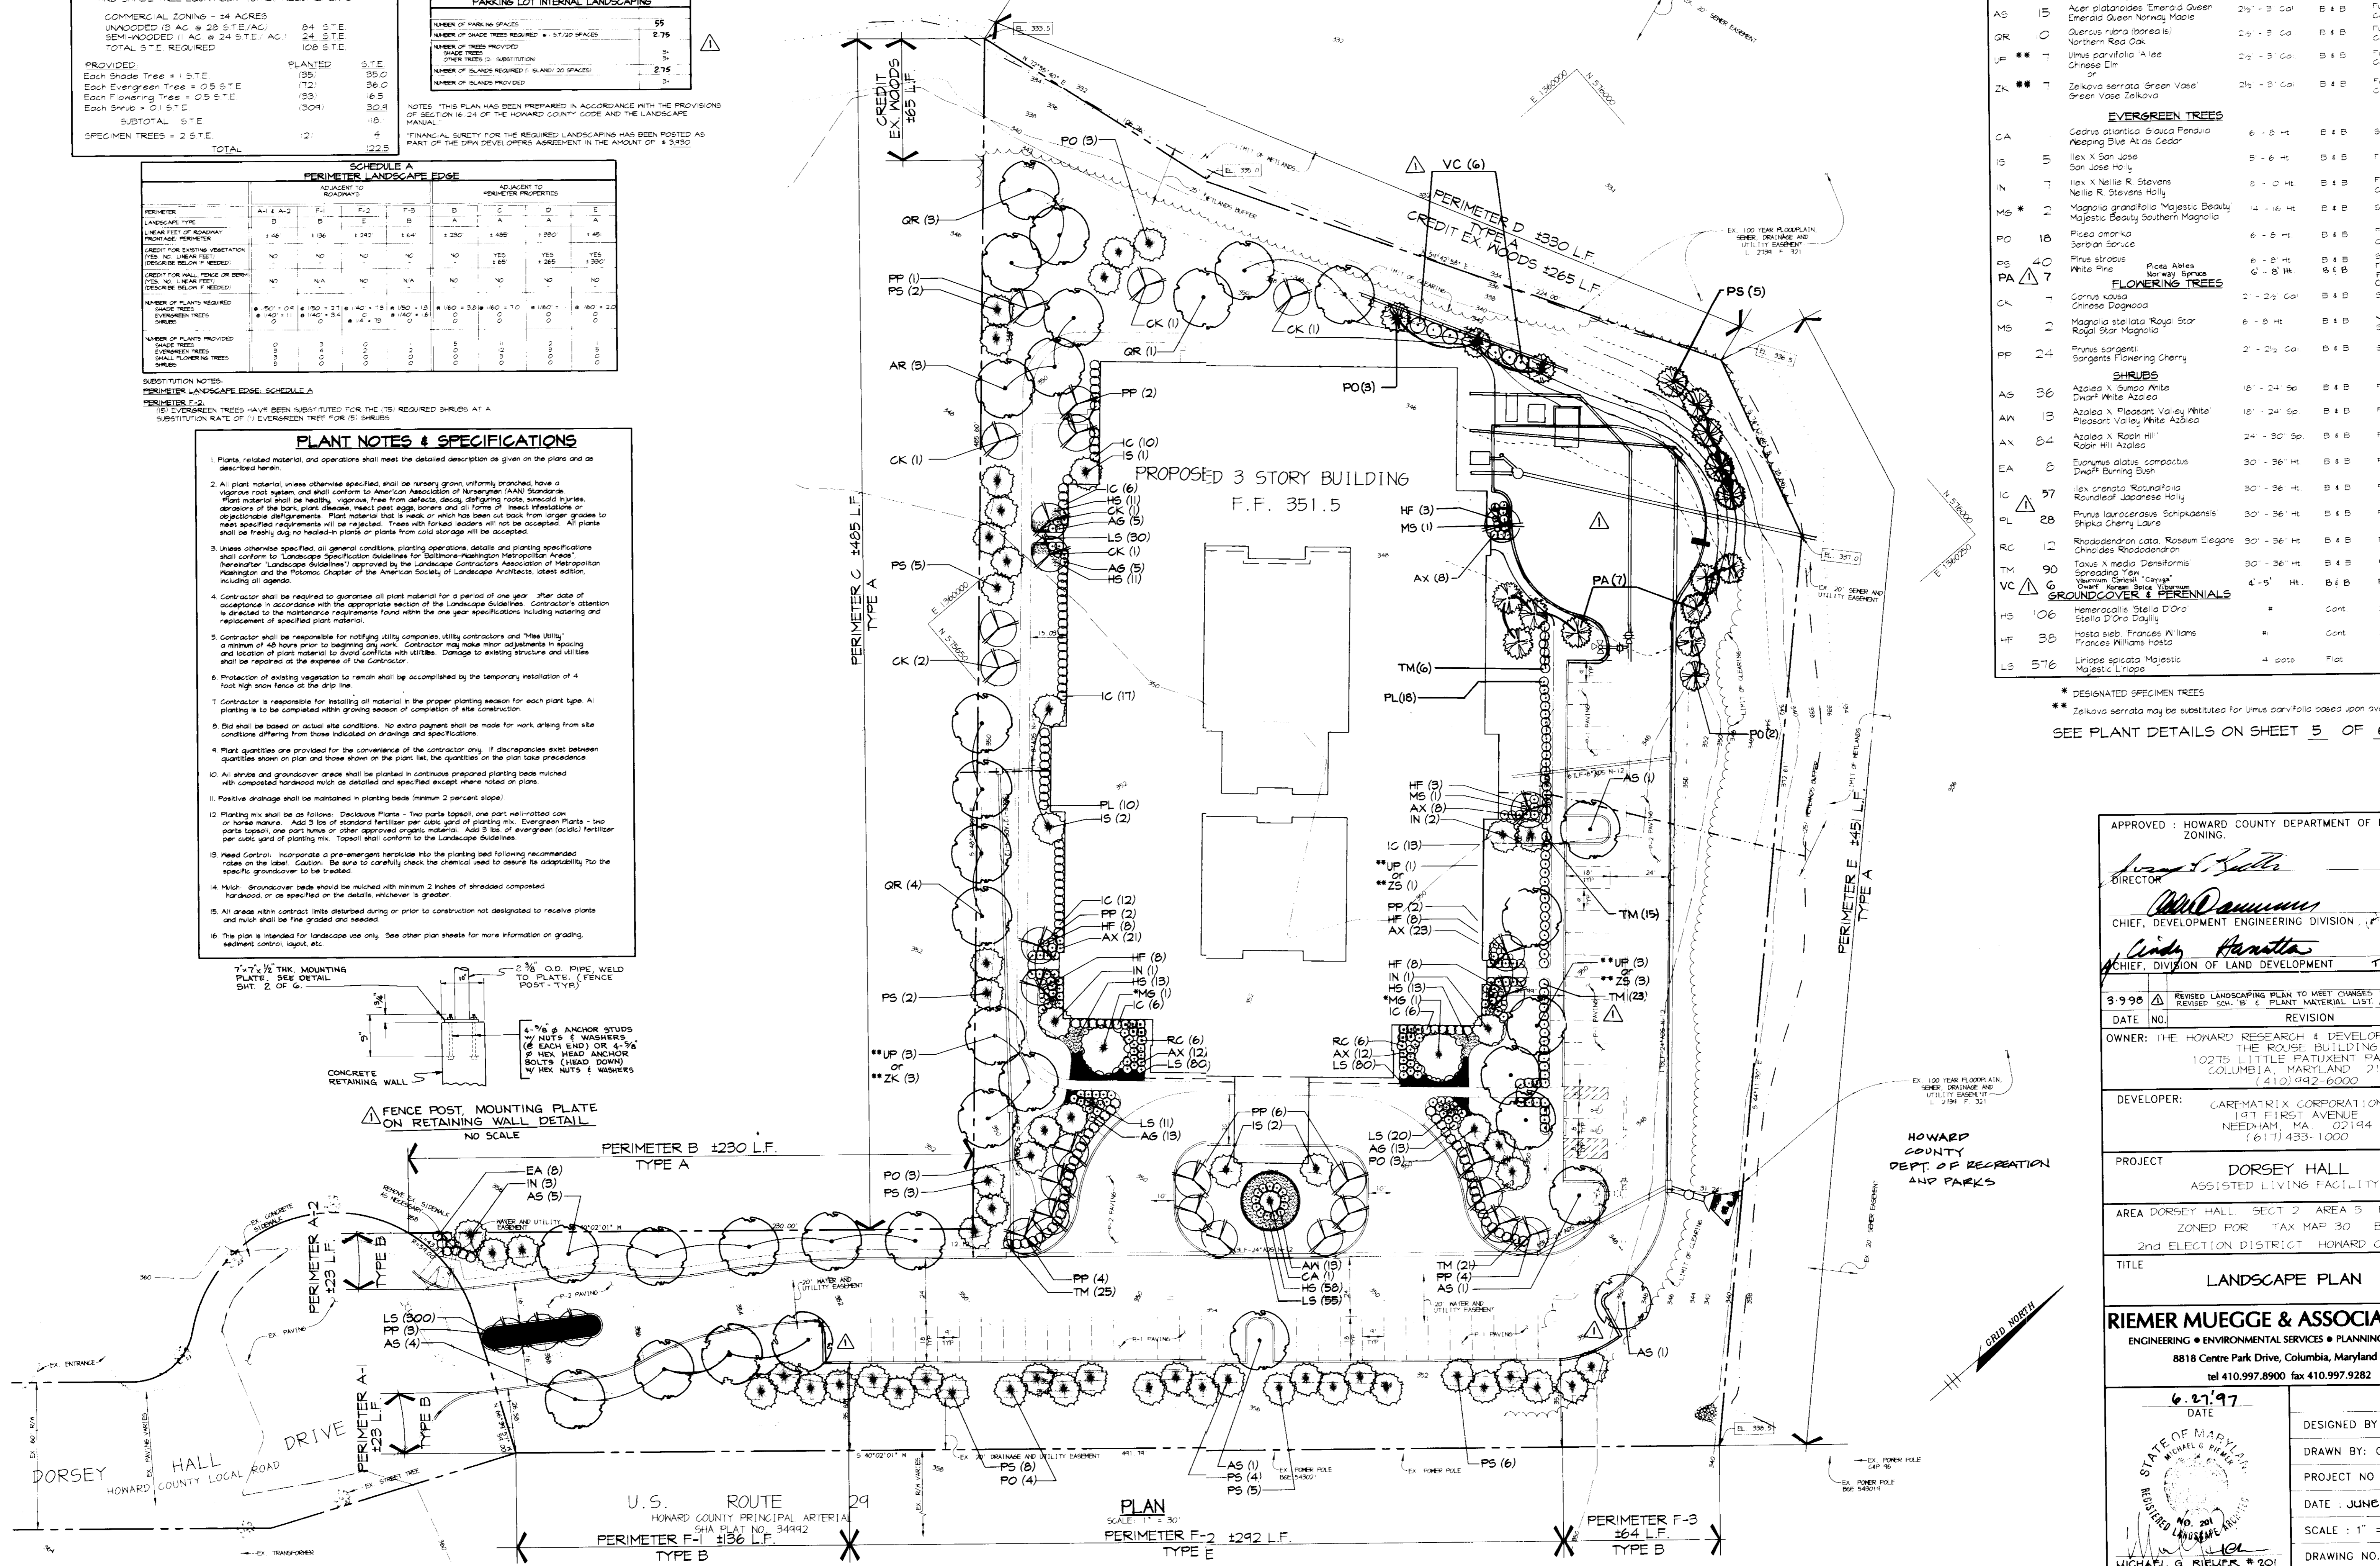

PLANT MATERIAL LIST

KEY	QTY	BOTANICAL + COMMON NAME	SIZE	ROOT	REMARKS
SHADE TREES					
AR	3	Acer rubrum October Glory	2 1/2 - 3 Cal	B + B	Full Crown Central Leader
AS	15	Acer platanoides Emerald Queen	2 1/2 - 3 Cal	B + B	Full Crown Central Leader
GR	0	Quercus rubra (brassia)	2 1/2 - 3 Cal	B + B	Full Crown Central Leader
UP	7	Ulmus parvifolia A'ice	2 1/2 - 3 Cal	B + B	Full Crown Central Leader
ZK	7	Zelkova serrata Green Vase	2 1/2 - 3 Cal	B + B	Full Crown Central Leader
EVERGREEN TREES					
CA		Cedrus atlantica Glauca Pendula	6 - 8 Ht	B + B	Specimen
IS	5	Ilex X San Jose	5 - 6 Ht	B + B	Full Form
N	7	Ilex X Nellie R. Stevens	8 - 10 Ht	B + B	Full Form Central Leader
M	1	Magnolia grandifolia Majestic Beauty	4 - 6 Ht	B + B	Specimen
PO	18	Picea omorika Serbian Spruce	6 - 8 Ht	B + B	Full Form Central Leader
PS	40	Pinus strobus	6 - 8 Ht	B + B	Specimen
PA	7	Pinus strobus White Pine	6 - 8 Ht	B + B	Full Form Central Leader
FLOWERING TREES					
CK	1	Cornus kousa Chinese Dogwood	2 - 2 1/2 Cal	B + B	Specimen
MS	1	Magnolia stellata Royal Star	6 - 8 Ht	B + B	Multistemmed Specimen
PP	24	Prunus sargentii Sargent's Flowering Cherry	2 - 2 1/2 Cal	B + B	Specimen
SHRUBS					
AS	36	Azalea X Sump White Dwarf White Azalea	18 - 24 Sp	B + B	Full
AX	13	Azalea X Pleasant Valley White	18 - 24 Sp	B + B	Full
AX	84	Azalea X Regis Hill	24 - 30 Sp	B + B	Full
EA	8	Eurymia glauca compacta Dwarf Burning Bush	30 - 36 Ht	B + B	Full
IC	57	Ilex crenata Rotundifolia	30 - 36 Ht	B + B	Full
FL	28	Prunus laurocerasus Sappucaensis Shrub Cherry Laurel	30 - 36 Ht	B + B	Full
RC	12	Rhododendron cata Roseum Elegans	30 - 36 Ht	B + B	Full
TM	90	Taxus X mega densiformis Spreading Yew	30 - 36 Ht	B + B	Full
VC	6	Veronica speciosa Virginia Creeper	4 - 5 Ht	B + B	Full
GROUNDCOVER & PERENNIALS					
HS	06	Hemerocallis Stella D'Oro		Cont	24" O.C.
HF	33	Hosta sive Frances Williams		Cont	24" O.C.
LS	576	Liriodendron speciosum	4" O.C.	Flat	18" O.C.

* DESIGNATED SPECIMEN TREES
 ** Zelkova serrata may be substituted for Ulmus parvifolia based upon availability

SEE PLANT DETAILS ON SHEET 5 OF 6

APPROVED: HOWARD COUNTY DEPARTMENT OF PLANNING AND ZONING.

James J. Suter 7/18/97
 DIRECTOR DATE

William Dammann 7/17/97
 CHIEF, DEVELOPMENT ENGINEERING DIVISION DATE

Linda Haratta 7/18/97
 CHIEF, DIVISION OF LAND DEVELOPMENT DATE

3-990 REVISED LANDSCAPING PLAN TO REFLECT CHANGES IN LOADING AREA. REVISED SCH. B - 2 PLANT MATERIAL LIST ADDED MNT'G DET.

OWNER: THE HOWARD RESEARCH & DEVELOPMENT CORP.
 THE ROUSE BUILDING
 10275 LITTLE PATUXENT PARKWAY
 COLUMBIA, MARYLAND 21044
 (410) 492-6000

DEVELOPER: CAREMATRIX CORPORATION
 1211 FIRST AVENUE
 NEEDHAM, MA 02194
 (617) 433-1000

PROJECT: DORSEY HALL
 ASSISTED LIVING FACILITY

AREA DORSEY HALL SECT. 2 AREA 5 PARCEL 0-1
 ZONED FOR TAX MAP 30 BLOCK 4
 2nd ELECTION DISTRICT HOWARD COUNTY, MD.

TITLE: LANDSCAPE PLAN

RIEMER MUEGGE & ASSOCIATES, INC.
 ENGINEERING • ENVIRONMENTAL SERVICES • PLANNING • SURVEYING
 8818 Centre Park Drive, Columbia, Maryland 21045
 tel 410.997.8900 fax 410.997.9282

DATE: 6.27.97
 DESIGNED BY: L.O.H., C.A.K.
 DRAWN BY: C.A.K.
 PROJECT NO: 96084
 LSCP.DWG
 DATE: JUNE 27, 1997
 SCALE: 1" = 30'
 DRAWING NO. 6 OF 6

STATE OF MARYLAND
 MICHAEL G. RIEMER
 REGISTERED PROFESSIONAL LANDSCAPE ARCHITECT
 NO. 201
 MICHAEL G. RIEMER #201