SHEET INDEX NO DESCRIPTION 1 TITLE SHEET 2 SITE DEVELOPMENT PLAN 3 SEDIMENT CONTROL PLAN AND DRAINAGE AREA MAP 4 PROFILES, NOTES, AND DETAILS 5 LANDSCAPING PLAN

GENERAL NOTES


- 1. ALL MATER LINES SHALL BE CONSTRUCTED A MINIMUM OF 42" COVER BELOW FINISHED SRAPE.
- 2. ALL CONSTRUCTION SHALL BE IN ACCORDANCE WITH THE LATEST STANDARDS AND SPECIFICATIONS OF HOWARD COUNTY PLUS M.S.H.A. STANDARDS AND SPECIFICATIONS
- 3. APPROXIMATE LOCATION OF EXISTING UTILITIES ARE SHOWN FROM BEST AVAILABLE INFORMATION. THE CONTRACTOR SHALL TAKE ALL NECESSARY PRECAUTIONS TO PROTECT THE EXISTING UTILITIES AND MAINTAIN UNINTERRUPTED SERVICE. ANY DAMAGE INCURRED DUE TO CONTRACTOR'S OPERATION SHALL BE REPAIRED IMMEDIATELY
- 4. THE CONTRACTOR SHALL TEST PIT EXISTING UTILITIES AT LEAST (5) DAYS BEFORE STARTING WORK SHOWN ON THESE DRAWINGS TO VERIFY THEIR LOCATION AND ELEVATION. THE CONTRACTOR SHALL NOTIFY THE ENGINEER IMMEDIATELY IF LOCATION OF UTILITIES IS OTHER THAN SHOWN.
- THE CONTRACTOR SHALL NOTIFY THE DEPARTMENT OF PUBLIC MORKS
 CONSTRUCTION INSPECTION DIVISION AT 313-1880 AT LEAST FIVE (5) WORKING
 DAYS PRIOR TO THE START OF WORK.
- 6. CONTRACTOR TO NOTIFY THE FOLLOWING UTILITIES OR AGENCIES AT LEAST FIVE DAYS BEFORE STARTING WORK SHOWN ON THESE DRAWINGS:

MISS UTILITY
BELL ATLANTIC TELEPHONE COMPANY
HOWARD COUNTY BUREAU OF UTILITIES
ATAT CABLE LOCATION DIVERSION
BALTIMORE GAS & ELECTRIC COMPANY
STATE HIGHWAY ADMINISTRATION

1-800-257-7777 725-9976 313-4900 343-3553 685-0123 531-5533

- T. TRAFFIC CONTROL DEVICES, MARKINGS AND SIGNING SHALL BE IN ACCORDANCE HITH THE LATEST EDITION OF THE MANUAL ON UNIFORM TRAFFIC CONTROL DEVICES (MUTCD). ALL STREET AND REGULATORY SIGNS SHALL BE IN PLACE PRIOR TO THE PLACEMENT OF ANY ASPHALT.
- ALL INLETS SHALL BE CONSTRUCTED IN ACCORDANCE WITH HOWARD COUNTY STANDARDS.

 ALL PIPE ELEVATIONS SHOWN ARE INVERT ELEVATIONS.
- 10. THE CONTRACTOR SHALL PROVIDE A JOINT IN ALL SEMER MAINS WITHIN 2'-O" OF EXTERIOR MANHOLE WALLS.
- 1. PROFILE STATIONS SHALL BE ADJUSTED AS NECESSARY TO CONFORM TO PLAN
- 12. NO PIPE SHALL BE LAID UNTIL LINES OF EXCAVATION HAVE BEEN BROUGHT TO SUBGRADE.
- 13. TOPO IS PROPOSED GRADE FROM SDP-95-62. CONTOURS SHOWN AT 2-FOOT INTERVAL.
- 14. ALL PLAN DIMENSIONS ARE TO FACE OF CURB UNLESS OTHERWISE NOTED.
- 15. ALL STORM DRAIN PIPE BEDDING SHALL BE AS SHOWN IN DETAIL 62.01 (TRENCH IN ROCK OR TRENCH IN EARTH AS DETERMINED BY FIELD CONDITIONS) IN VOL. IV OF HOWARD COUNTY DESIGN MANUAL UNLESS OTHERWISE DIRECTED BY THE ENGINEER OR AS SHOWN ON THE DRAWINGS.
- 16. THE DEVELOPER IS RESPONSIBLE FOR THE ACQUISITION OF ALL EASEMENTS, RIGHTS AND/OR RIGHTS-OF-WAY THAT MAY BE REQUIRED FOR THE SEDIMENT AND EROSION CONTROL PRACTICES, STORMWATER MANAGEMENT PRACTICES AND THE DISCHARGE OF STORMWATER ONTO OR ACROSS ADJACENT OR DOMNSTREAM PROPERTIES INCLUDED IN THIS PLAN. HE IS ALSO RESPONSIBLE FOR THE ACQUISITION OF ALL EASEMENTS, RIGHTS AND/OR WORK ON ADJACENT PROPERTIES INCLUDED IN THIS PLAN.
- 17. THE PAVEMENT DETAILS SHOWN ON THESE PLANS REFLECT THE HOWARD COUNTY MINIMUM STANDARD PAVEMENT SECTIONS AND ARE NOT BASED ON SITE SPECIFIC CONDITIONS. PRIOR TO PAVING, THE FINAL PAVEMENT SECTIONS SHALL BE DETERMINED BY A GUALIFIED GEOTECHNICAL ENGINEER BASED ON IN-SITU TESTING OF THE FINISHED SUBGRADE. ANY PAVEMENT SECTION DETERMINED BY THE GEOTECHNICAL ENGINEER THAT IS LESS THAN THE HOWARD COUNTY MINIMUM STANDARD, SHALL FIRST BE APPROVED BY THE HOWARD COUNTY DEPARTMENT OF PUBLIC WORKS. THE TESTING AND GEOTECHNICAL ENGINEER SHALL BE FURNISHED BY THE OWNER.
- 18. STORMNATER MANAGEMENT QUANTITY AND QUALITY CONTROL FOR THIS DEVELOPMENT IS PROVIDED BY A PRIVATE RETENTION FACILITY PER SPP-45-62.
- 14. ALL ELEVATIONS SHOWN ARE BASED ON U.S.C. AND 6.S. MEAN SEA LEVEL DATUM, 142
- 20. ANY DAMAGE TO THE COUNTY'S RIGHT-OF-WAY SHALL BE CORRECTED AT THE DEVELOPERS EXPENSE.
- 21. THE WATER METER IS TO BE LOCATED INSIDE THE BUILDING.
- 22. THE COORDINATES SHOWN HEREON ARE BASED ON NAD 27, MARYLAND COORDINATE
 SYSTEM AS PROJECTED BY HOWARD COUNTY MONUMENT NOS. 3043001-R AND 29430
- 23. WP-94-60 A REQUEST TO WAIVE SECTION 16.119(f)(2) TO PERMIT A COMMERCIAL DRIVENAY DIRECT ACCESS TO A MINOR ARTERIAL HIGHWAY, MD ROUTE 103, WAS APPROVED ON MAY 13, 1994 FOR PARCELS A, B&C.
- 24. CONTRACTOR IS SOLELY RESPONSIBLE FOR CONSTRUCTION MEANS, METHODS, TECHNIQUES, SEQUENCES, PROCEDURES, AND SAFETY PRECAUTIONS.
- 25. MP-95-64, A REQUEST TO MAIVE SECTION 16.115(a) MHICH RESTRICTS DEVELOPMENT MITHIN A 100 YEAR FLOODPLAIN, 16.116(a)(1) AND (2) MHICH RESTRICTS GRAPING MITHIN A METLAND AND STREAM, 16.119(f)(1) MHICH REQUIRES MINOR COLLECTORS OR LOWER ROAD CLASSIFICATION ACCESS TO ARTERIAL ROADS AND 16.144(a) AND (f) MHICH REQUIRE PROCESSING OF SKETCH AND PRELIMINARY PLANS FOR SUBDIVISION WAS APPROVED MARCH 15, 1995.
- 26. WATER AND SEMER SERVICE FOR THIS PROJECT IS PRIVATE.
- 27. THERE IS NO 100-YEAR FLOODPLAIN ON SITE.
- 28. TRAFFIC STUDY PROVIDED BY THE TRAFFIC GROUP, INC. DATED APRIL 21, 1
- 29. THERE ARE NO ON-SITE WETLANDS FOR THIS PROJECT
- 30. SEE PREVIOUS FILE NUMBERS F-95-93, F-96-163, SDP-95-62, NP-95-64, NP-94-60, F-96-03, F-97-25, F-97-77.
- 31. FOREST CONSERVATION REQUIREMENTS FOR THIS PROJECT ARE BEING MET UNDER SDP-45-62.
- 32. ACCESS FOR THIS DEVELOPEMENT IS OBTAINED VIA CROSS ACCESS EASEMENTS OVER PARCEL "L", PLAT 12481 & L,3589, F.161.

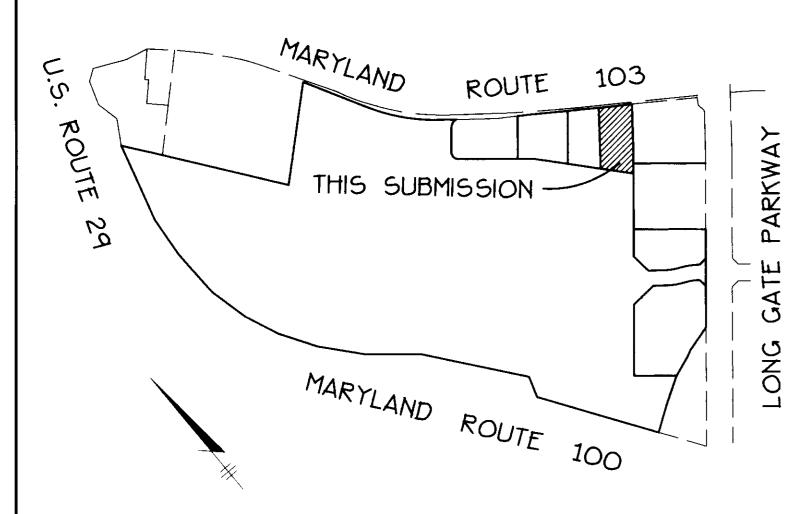

LONG GATE CENTER PLAN

SCALE: 1'=400'

SITE DEVELOPMENT PLAN

CITIZEN'S NATIONAL BANK AT LONG GATE CENTER PARCEL O

2nd ELECTION DISTRICT HOWARD COUNTY, MARYLAND

> LONG GATE CENTER PARCEL N

> > ZONED B-2

PARCEL LINE AND LEASE LINE


LONG GATE CENTER

PARCEL L

ZONED B-2

PLAT NO. 12481 \$ 12482

PLAT NO. 12481

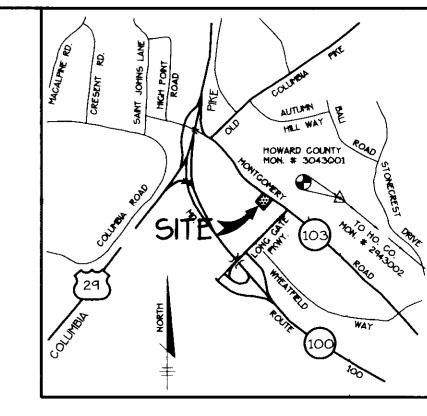

VICINITY MAP

<u>BENCHMARKS</u>

BM#1 5TA 3043001 ELEV. 437.92 N 516,549.55 E 853,656.51 32'± NORTH OF BGE TOWER 276-A BEHIND SCHOOL GROUNDS BM#2 STA 2943002

N 513,205.90 E 857,478.69

LOCATED ON THE TRANSMISSION LINE

1700'± NORTH OF INTERSECTION OF

ROUTE 103 AND NEW CUT ROAD AND

1:50'± EAST OF NEW CUT ROAD

<u>SITE ANALYSIS</u>

AREA OF PARCEL
PRESENT ZONING
PROPOSED USE
BUILDING COVERAGE
OF PARKING SPACE

OF PARKING SPACES REQ'D • 5 SP/1000 SF # OF PARKING SPACES PROVIDED

OF STACKING SPACES REQUIRED

OF STACKING SPACES PROVIDED

PAVED AREA

OVERHANG COVERAGE

BUILDING + OVERHANG COVERAGE


0.86 ACRES (37,467 SF) B-2

BANK BUILDING 2789 SQ. FT. (7.4% OF SITE)

20 **⚠ 30**

1 (INCL. 1 HC)

0.44 ACRES G5! SQ.FT. (1.7% OF SITE) 3440 SQ.FT. (9.1% OF SITE)

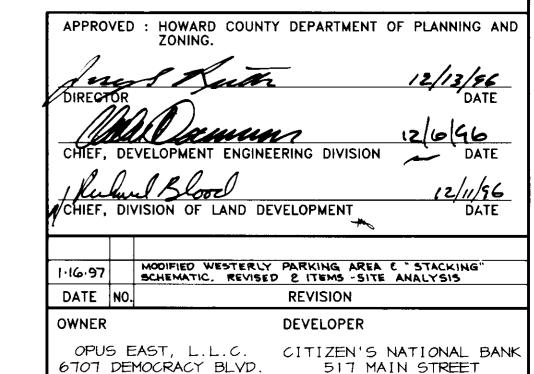

PROJECT CITIZEN'S NATIONAL BANK
AT LONG GATE CENTER

LAUREL, MD 20707

(301)497-6275

DESIGNED BY : CUR

AREA TAX MAP 24 BLOCK 24 PARCEL O ZONED B-2 2nd ELECTION DISTRICT HOWARD COUNTY, MARYLAND

TITLE SHEET

SUITE 510

BETHESDA, MD 20817

(301)493-4444

RIEMER MUEGGE & ASSOCIATES, INC. ENGINEERING • ENVIRONMENTAL SERVICES • PLANNING • SURVEYING

8818 Centre Park Drive, Columbia, Maryland 21045

tel 410.997.8900 fax 410.997.9282

11.27.96

F-95-93 SDP-95-62 NP-94-60
F-96-163 NP-95-64

DRAWN BY : RPP

PROJECT NO : HOCO\96050
SDP1.DMG

DATE : NOVEMBER 27,1000

SCALE : AS SHOWN

JAYKANT D. PAREKH #19148

DRAWN BY : RPP

PROJECT NO : HOCO\96050
SDP1.DMG

DATE : NOVEMBER 27,1000

DRAWN BY : RPP

PROJECT NO : HOCO\96050
SDP1.DMG

DATE : NOVEMBER 27,1000

DRAWN BY : RPP

PROJECT NO : HOCO\96050
SDP1.DMG


DATE : NOVEMBER 27,1000

DRAWN BY : RPP

PROJECT NO : HOCO\96050
SDP1.DMG


DATE : NOVEMBER 27,1000

DRAWN BY : RPP

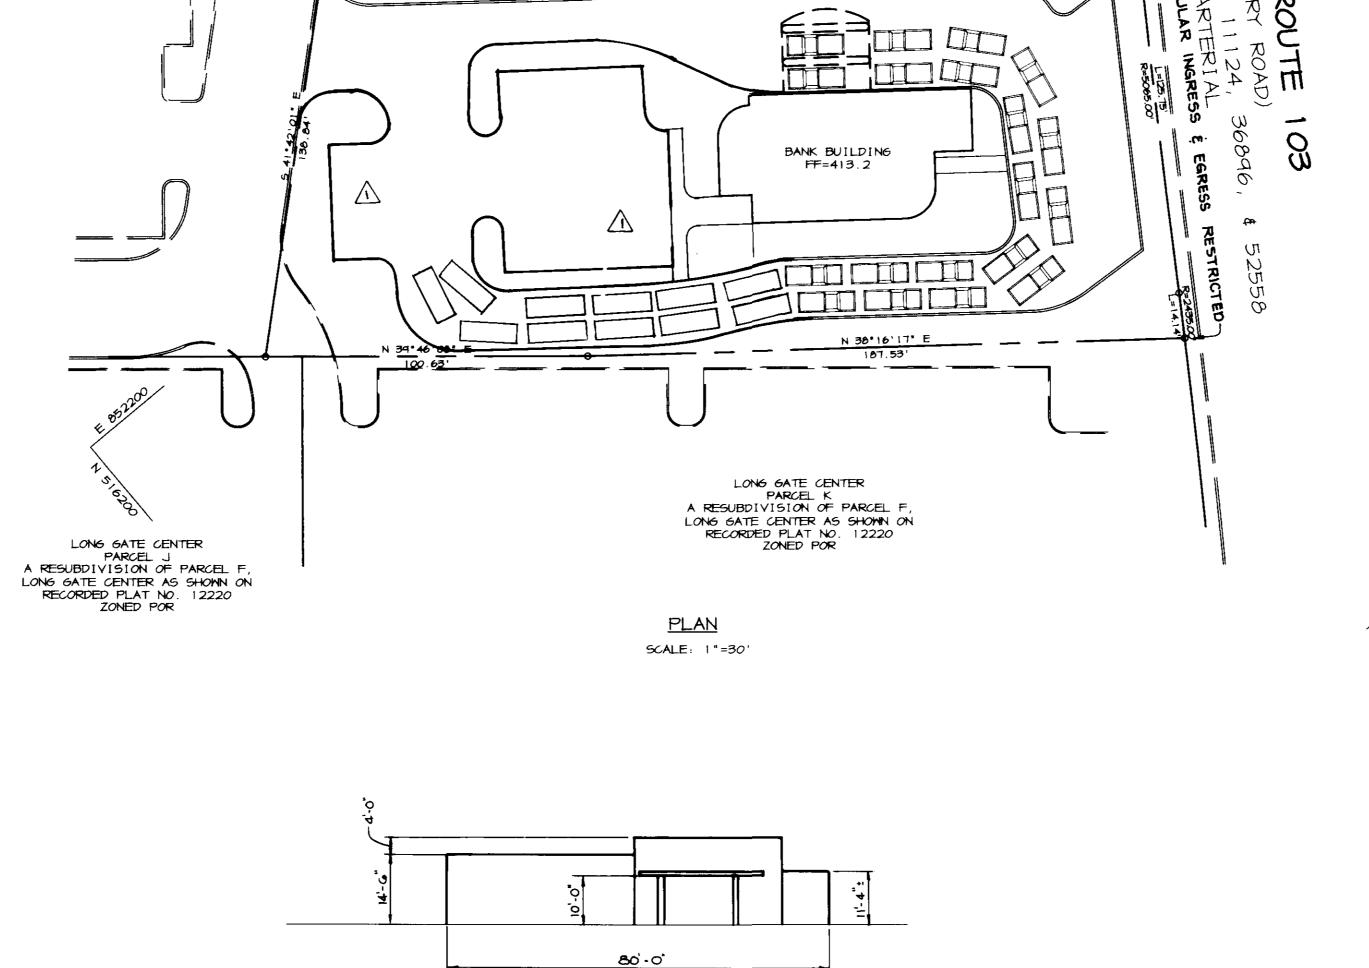

WEST BUILDING ELEVATION

NO SCALE

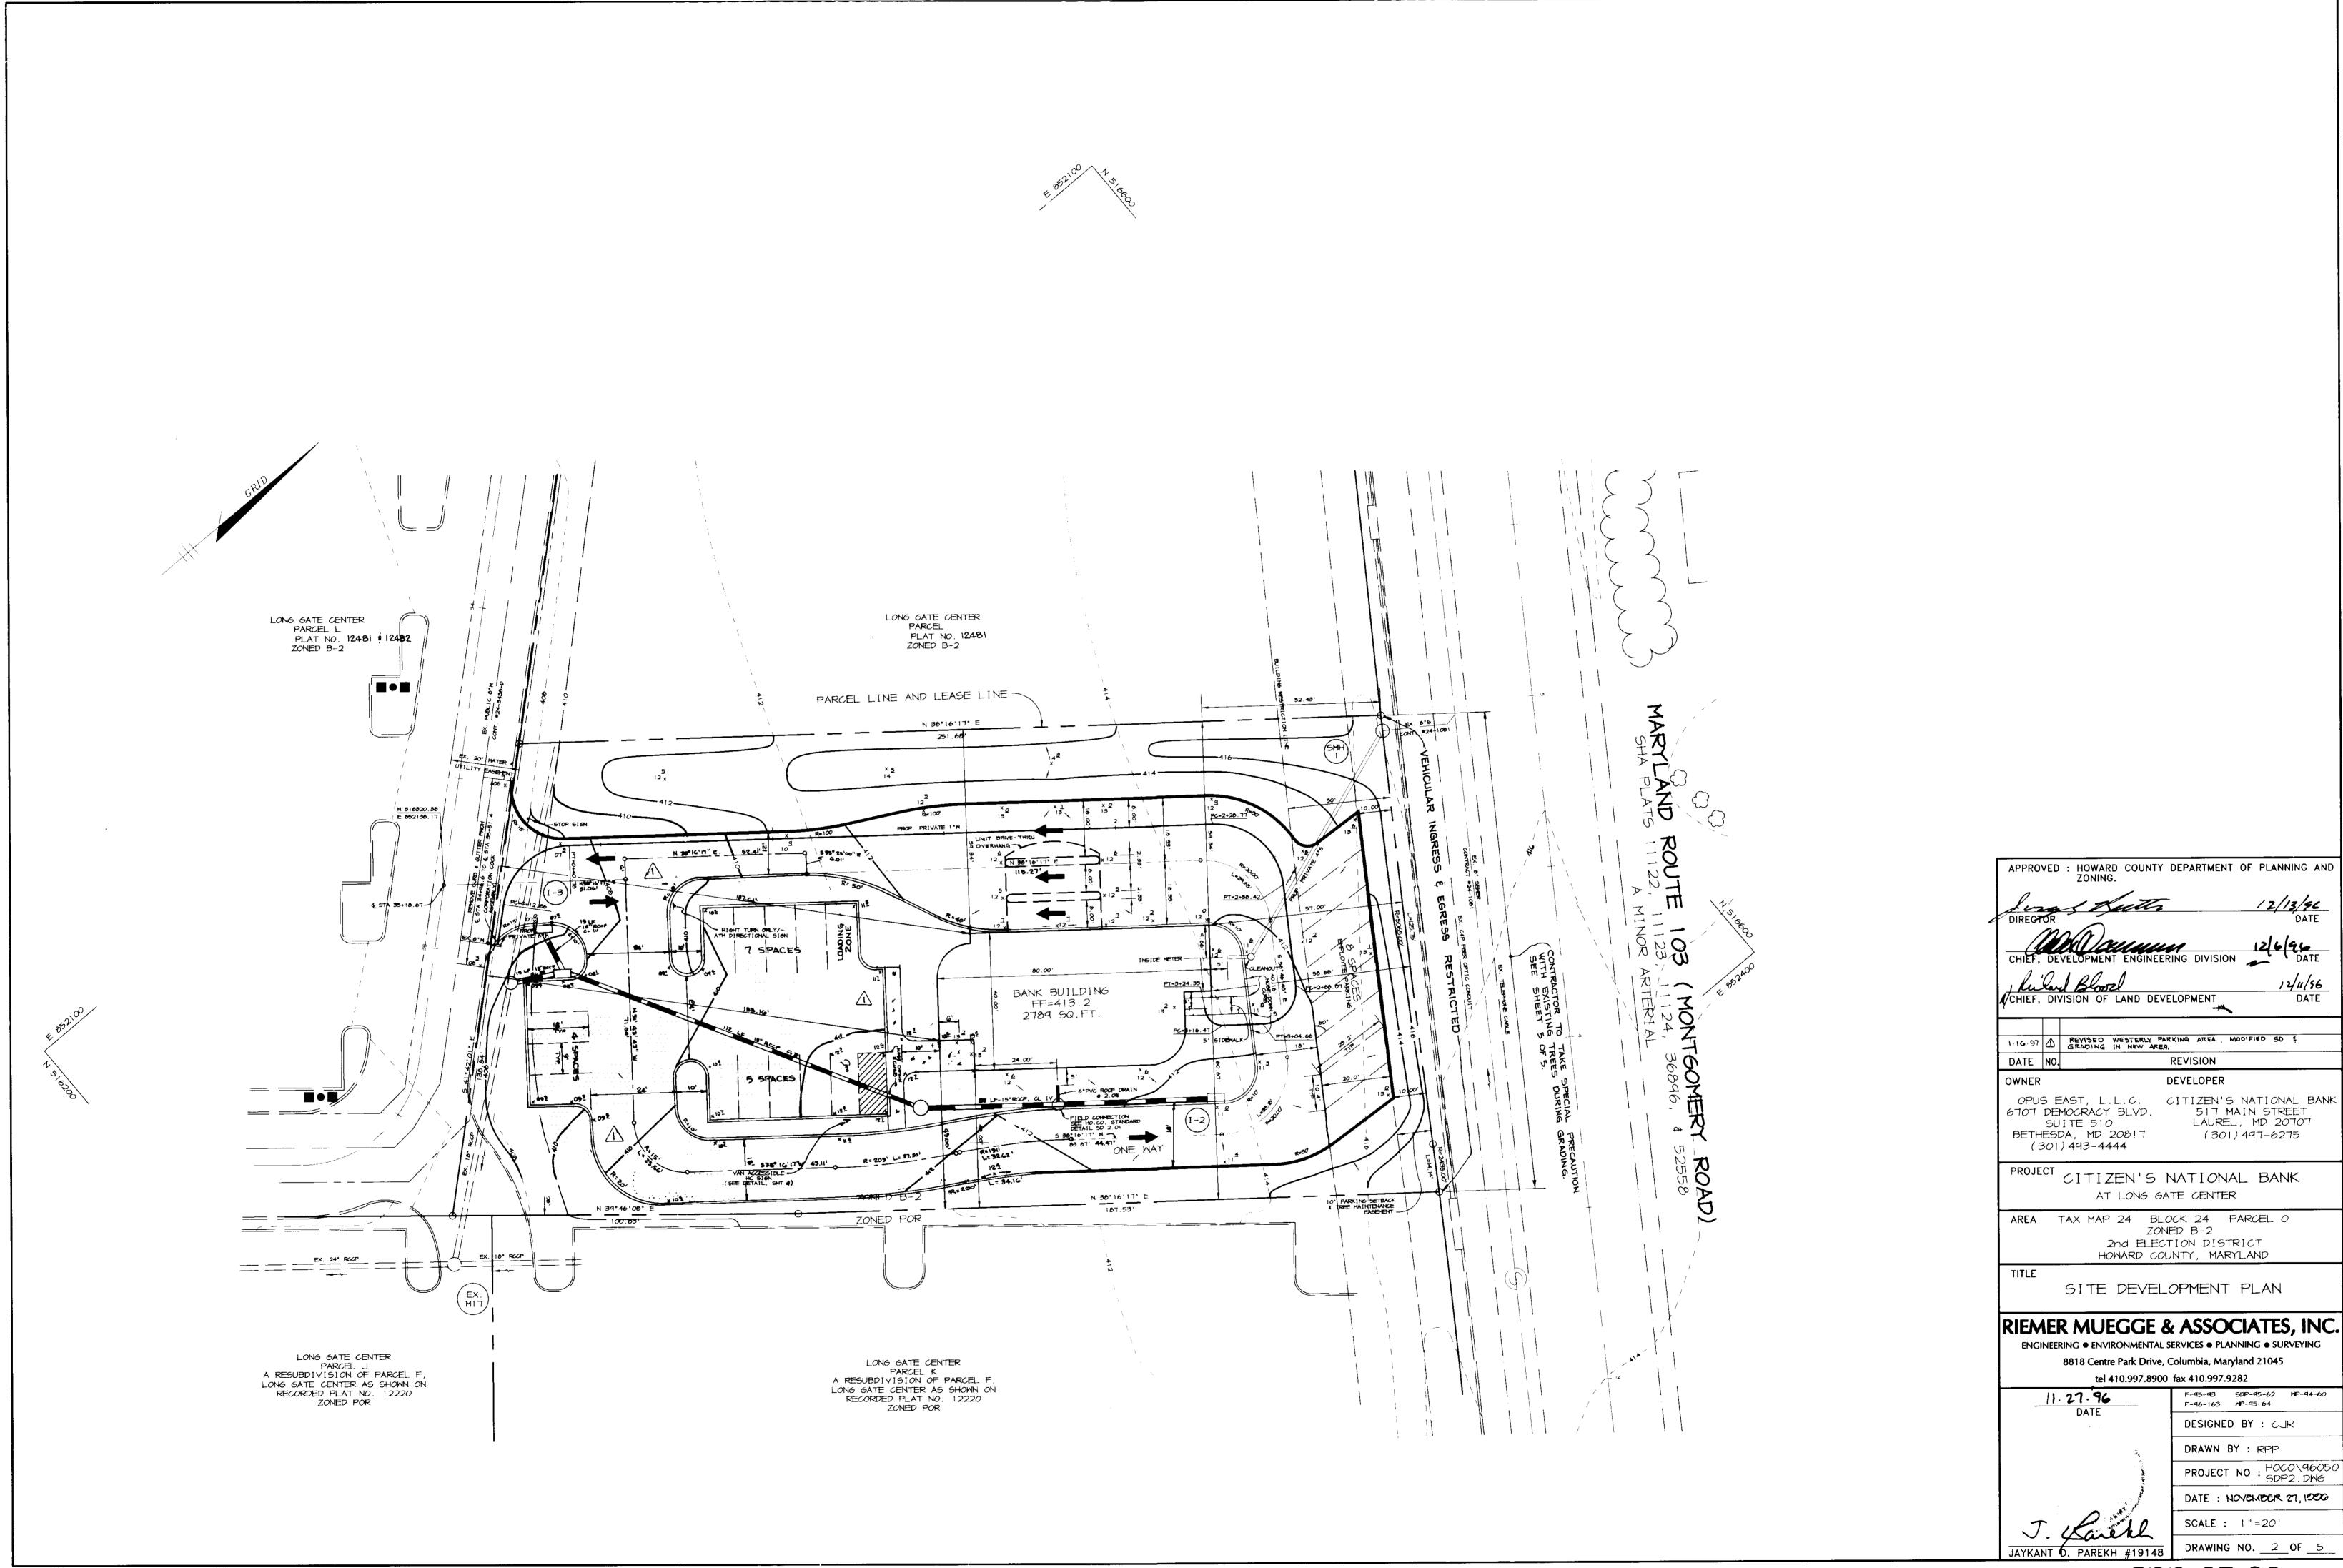

SEDIMENT CONTROL NOTES

- 1. A MINIMUM OF 48 HOURS NOTICE MUST BE GIVEN TO THE HOWARD COUNTY DEPARTMENT OF INSPECTIONS AND PERMITS PRIOR TO THE START OF ANY CONSTRUCTION (313-1855)
- ALL VEGETATIVE AND STRUCTURAL PRACTICES ARE TO BE INSTALLED ACCORDING TO THE PROVISIONS OF THIS PLAN AND ARE TO BE IN CONFORMANCE WITH THE MARYLAND STANDARDS AND SPECIFICATIONS FOR SOIL AND EROSION CONTROL,
- 3. FOLLOWING INITIAL SOIL DISTURBANCE OR REDISTURBANCE, PERMANENT OR TEMPORARY STABILIZATION SHALL BE COMPLETED WITHIN: A) 7 CALENDAR DAYS FOR ALL PERIMETER SEDIMENT CONTROL STRUCTURES, DIKES, PERIMETER SLOPES AND ALL SLOPES AND ALL SLOPES GREATER THAN 3:1, B) 14 DAYS AS TO OTHER DISTURBED OR GRADED AREAS ON THE PROJECT SITE.
- 4. ALL SEDIMENT TRAPS/BASINS SHOWN MUST BE FENCED AND WARNING SIGNS POSTED AROUND THE PERIMETER IN ACCORDANCE WITH VOL. 1, CHAPTER 12, OF THE HOWARD COUNTY DESIGN MANUAL, STORM DRAINAGE.
- 5. ALL DISTURBED AREAS MUST BE STABILIZED WITHIN THE TIME PERIOD SPECIFIED ABOVE IN ACCORDANCE WITH THE 1991 MARYLAND STANDARDS AND SPECIFICATIONS FOR SOIL AND EROSION CONTROL FOR PERMANENT SEEDINGS (SEC. 51), SOD (SEC. 54), TEMPORARY SEEDING (SEC. 50) AND MULCHING (SEC. 52). TEMPORARY STABILIZATION WITH MULCH ALONG CAN ONLY BE DONE WHEN RECOMMENDED SEEDING DATES DO NOT ALLOW FOR PROPER GERMINATION AND
- 6. ALL SEDIMENT CONTROL STRUCTURES ARE TO REMAIN IN PLACE AND ARE TO BE MAINTAINED IN OPERATIVE CONDITION UNTIL PERMISSION FOR THEIR REMOVAL HAS BEEN OBTAINED FROM THE HOWARD COUNTY SEDIMENT CONTROL INSPECTOR.
- 7. SITE ANALYSIS:

- TOTAL AREA OF SITE AREA DISTURBED AREA TO BE ROOFED OR PAVED AREA TO BE VEGETATIVELY STABILIZED TOTAL CUT TOTAL FILL
- 8. ANY SEDIMENT CONTROL PRACTICE WHICH IS DISTURBED BY GRADING ACTIVITY FOR PLACEMENT OF UTILITIES MUST BE REPAIRED ON THE SAME DAY OF

0.86 ACRES

0.85 ACRES

0.50 ACRES

0.35 ACRES

909 CU. YARDS

379 CU. YARDS

- 9. ADDITIONAL SEDIMENT CONTROLS MUST BE PROVIDED, IF DEEMED NECESSARY BY THE HOWARD COUNTY SEDIMENT CONTROL INSPECTOR.
- 10. SITE GRADING WILL BEGIN ONLY AFTER ALL PERIMETER SEDIMENT CONTROL MEASURES HAVE BEEN INSTALLED AND ARE IN A FUNCTIONING CONDITION.
- 11. SEDIMENT WILL BE REMOVED FROM TRAPS WHEN ITS DEPTH REACHES CLEAN OUT ELEVATION SHOWN ON THE PLANS.
- 12. OUT AND FILL QUANTITIES PROVIDED UNDER SITE ANALYSIS DO NOT REPRESENT BID QUANTITIES. THESE QUANTITIES DO NOT DISTINGUISH BETWEEN TOPSOIL STRUCTURAL FILL OR EMBANKMENT MATERIAL, NOR DO THEY REFLECT CONSIDERATION OF UNDERCUTTING OR REMOVAL OF UNSUITABLE MATERIAL. THE CONTRACTOR SHALL FAMILIARIZE HIMSELF WITH SITE CONDITIONS WHICH MAY AFFECT THE WORK
- 13. ON ALL SITES WITH DISTURBED AREAS IN EXCESS OF 2 Ac., APPROVAL OF THE INSPECTION AGENCY SHALL BE REQUESTED UPON COMPLETION OF INSTALLATION OF PERIMETER EROSION AND SEDIMENT CONTROLS, BUT BEFORE PROCEEDING WITH ANY OTHER EARTH DISTURBANCE OR GRADING. OTHER BUILDING OR GRADING INSPECTION APPROVALS MAY NOT BE AUTHORIZED UNTIL THIS INITIAL APPROVAL BY THE INSPECTION AGENCY IS MADE.
- 14. TRENCHES FOR THE CONSTRUCTION OF UTILITIES IS LIMITED TO THREE PIPE LENGTHS OR THAT WHICH CAN BE BACKFILLED AND STABILIZED WITHIN ONE WORKING DAY, WHICHEVER IS SHORTER.
- 15. BORROW SITE TO BE PRE-APPROVED BY THE SEDIMENT CONTROL INSPECTOR, OR IN CASE OF EXCESS MATERIAL, AN APPROVED SEDIMENT CONTROL PLAN WILL BE NEEDED TO DEPOSIT EXCESS OFF-SITE.

TEMPORARY SEEDING NOTES

Apply to graded or cleared areas likely to be redisturbed where a short-term vegetative cover is needed.

Seedbed Preparation: Loosen upper three inches of soil by raking, discing or other acceptable means before seeding, if not previously

Soll Amendments: Apply 600 lbs. per acre 10-10-10 fertilizer (14 lbs. per 1000 sq.ft.).

Seeding: For periods March 1 thru April 30 and from August 15 thru November 15, seed with 2-1/2 bushels per acre of annual rye (3.2 lbs per 1000 sq.ft.). For the period May 1 thru August 14, seed with 3 lbs. per acre of weeping lovegrass (0.07 lbs. per 1000 sq.ft.). For the period November 16 thru February 28, protect site by applying 2 tons per acre of well anchored straw mulch and seed as soon as possible in the spring, or use sod.

Mulching: Apply 1-1/2 to 2 tons per acre (70 to 90 lbs. per 1000 sq.ft.) of unrotted small grain straw immediately after seeding. Anchor mulch immediately after application using mulch anchoring tool or 218 gal. per acre (5 gal. per 1000 sq.ft.) of emulsified asphalt on flat areas. On slopes, 8 ft. or higher, use 347 gal. per acre (8 gal. per 1000 sq.ft.) for anchoring.

Refer to the 1983 MARYLAND STANDARDS AND SPECIFICATIONS FOR SOIL EROSION AND SEDIMENT CONTROL for rate and methods not covered.

PERMANENT SEEDING NOTES

Apply to graded or cleared areas not subject to immediate further disturbance where a permanent long-lived vegetative cover is needed.

<u>Seedbed Preparation: Loosen upper three Inches of soll by raking.</u>
discing or other acceptable means before seeding, if not previously

<u>Soil Amendments : In lieu of soil test recommendations, use one of</u> the following schedules

upper three inches of soil.


- 1) Preferred Apply 2 tons per acre dolomitic limestone (92 lbs. per 1000 sq.ft.) and 600 lbs. per acre 10-10-10 fertilizer (14 1bs. per 1000 sq.ft.) before seeding. Harrow or disc into upper three inches of soil. At time of seeding, apply 400 lbs.
- per acre 30-0-0 ureaform fertilizer (9 lbs. per 1000 sq.ft.). 2) Acceptable - Apply 2 tons per acre dolomitic limestone (92 lbs. per 1000 sq.ft.) and 1000 lbs. per acre 10-10-10 fertilizer (23 lbs. per 1000 sq.ft.) before seeding. Harrow or disc into

<u>Seeding: For the period March 1 thru April 30 and from August 1</u> thru October 15, seed with 60 lbs. per acre (1.4 lbs. per 1000 sq.ft.) of Kentucky 31 Tall Fescue. For the period May 1 thru July 31, seed with 60 lbs. Kentucky 31 Tall Fescue per acre and 2 lbs. per acre (0.05 lbs. per 1000 sq.ft.) of weeping lovegrass. During the period October 16 thru February 28, protect site by one of the following

- 1) 2 tons per acre of well-anchored mulch straw and seed as soon as possible in the spring.
- 2) Use sod
- 3) Seed with 60 lbs. per acre Kentucky 3! Tall Fescue and mulch with 2 tons per acre well anchored straw.

Mulching: Apply 1-1/2 to 2 tons per acre (70 to 90 lbs. per 1000 sq.ft.) of unrotted small grain straw immediately after seeding. Anchor mulch immediately after application using mulch anchoring tool or 218 gal. per acre (5 gal. per 1000 sq.ft.) of emulsified asphalt on flat areas. On slopes, 8 ft. or higher, use 347 gal. per acre (8 gal. per 1000 sq.ft.) for anchoring.


Maintenance: Inspect all seeded areas and make needed repairs. replacements and reseedings.

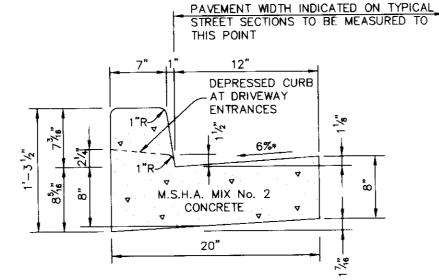

HOWARD COUNTY DESIGN MANUAL, VOLUME IV, STANDARD SPECIFICATIONS AND DETAILS FOR CONSTRUCTION (DRAWING R-3.01).


* GUTTER PAN AT THE MEDIAN EDGE OF INTERMEDIATE ARTERIALS OR THE HIGH SIDE OF SUPERELEVATED SECTIONS SHALL BE SLOPED AT THE SAME RATE AS THE PAVEMENT.

STANDARD 7" COMBINATION CURB AND GUTTER

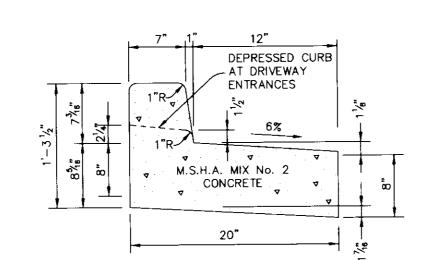


REVERSE 7" COMBINATION CURB AND GUTTER

NO SCALE

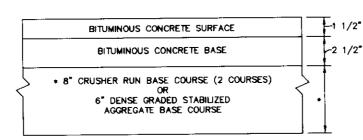


(ALTERNATE)

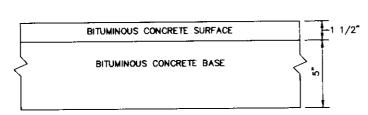


HOWARD COUNTY DESIGN MANUAL VOLUME IV-STANDARD SPECIFICATIONS AND DETAILS FOR CONSTUCTION (DRAWING R-2.01)

P-2 PAVING

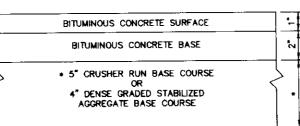


(ALTERNATE)

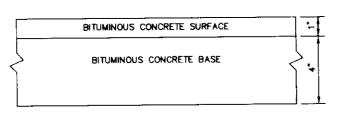


STANDARD SPECIFICATIONS AND DETAILS FOR CONSTUCTION (DRAWING R-2.01) P-1 PAVING

HOWARD COUNTY DESIGN MANUAL VOLUME IV-

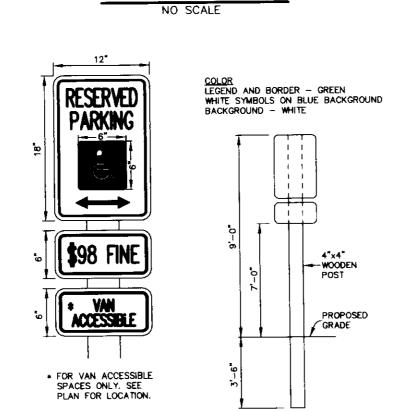

NOTE DISTANCE FROM GROUND TO BOTTOM OF SIGN TO BE 7'. HANDICAP SIGN DETAIL

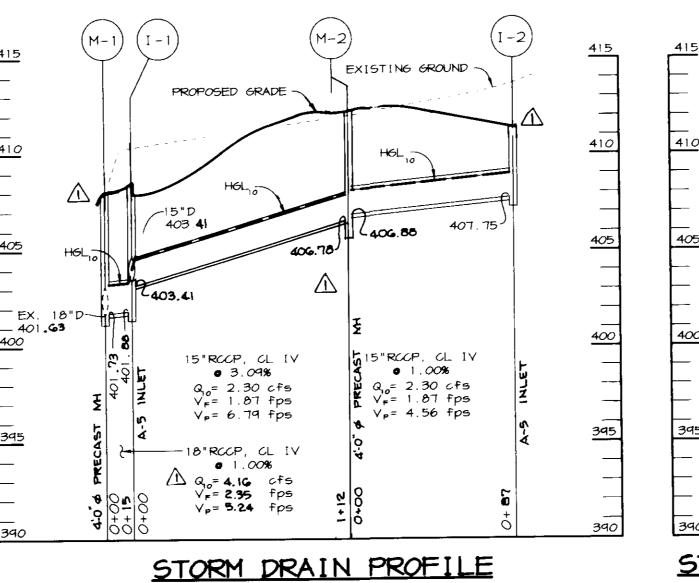


HOR. -1"=50"


VERT. -1"=5'


EXISTING GROUND PROPOSED GRADE 403.46 ~18"D(OUT) 401.90 15"RCCP, **a** 1.00% Q₁₀= 1.28 cfs w V_F= 1.04 fps z Vp= 3.95 fps STORM DRAIN PROFILE

SCALE HOR. -1"=50' VERT. -1"=5'

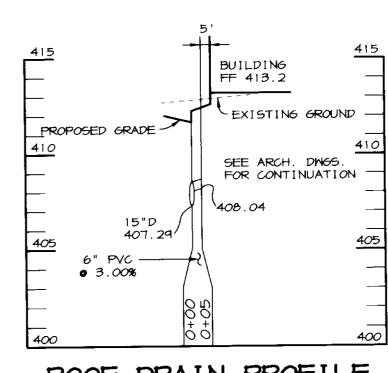


ROOF DRAIN PROFILE SCALE HOR. -1"=50' VERT. -1"=5'

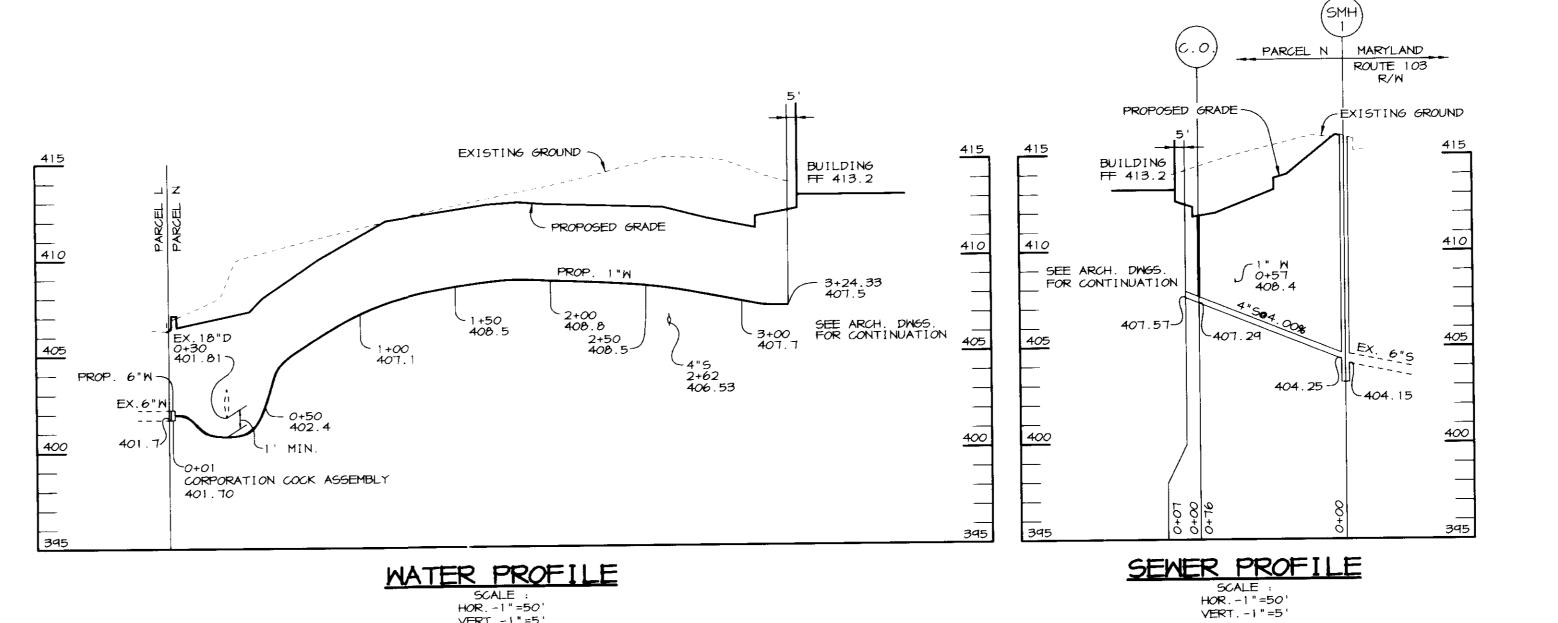


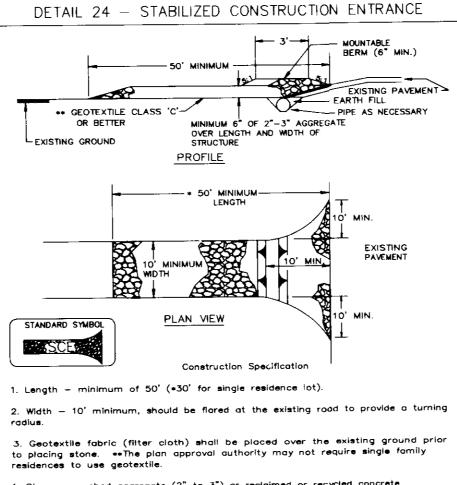

 Stone — crushed aggregate (2" to 3") or reclaimed or recycled concrete equivalent shall be placed at least 6" deep over the length and width of the 5. Surface Water — all surface water flowing to or diverted toward construction entrances shall be piped through the entrance, maintaining positive drainage. Pipe installed through the stabilized construction entrance shall be protected with a mountable berm with 5:1 slopes and a minimum of 6" of stone over the pipe. Pipe has to be sized according to the drainage. When the SCE is located at a high spot and has no drainage to convey a pipe will not be necessary. Pipe should be sized according to the amount of runoff to be conveyed. A 6" minimum will be required. 6. Location — A stabilized construction entrance shall be located at every point where construction traffic enters or leaves a construction site. Vehicles leaving the site must travel over the entire length of the stabilized construction entrance.

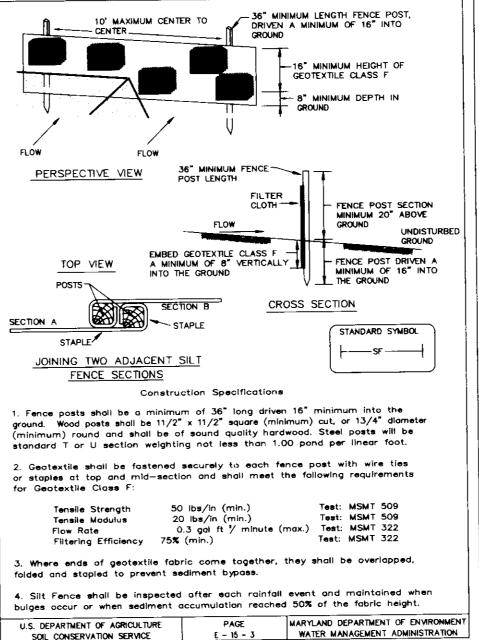

DETAIL 22 - SILT FENCE

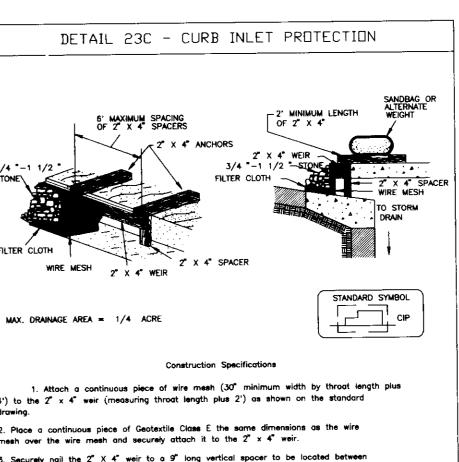

4') to the 2" \times 4" weir (measuring throat length plus 2') as shown on the standard 2. Place a continuous piece of Geotextile Class E the same dimensions as the wire mesh over the wire mesh and securely attach it to the $2^{\rm w}$ x $4^{\rm w}$ weir. 3. Securely nail the 2" \times 4" weir to a 9" long vertical spacer to be located between the weir and the inlet face (max. 4' apart). 4. Place the assembly against the inlet throat and nail (minimum 2' lengths of 2" x 4" to the top of the weir at spacer locations). These 2" x 4" anchors shall extend across the inlet top and be held in place by sandbags or alternate weight. 5. The assembly shall be placed so that the end spacers are a minimum 1' beyond both ends of the throat opening.

6. Form the 1/2 " x 1/2 " wire mesh and the geotextile fabric to the concrete gutter and against the face of the curb on both sides of the inlet. Place clean 3/4 " x 1 1/2 " stone over the wire mesh and geotextile in such a manner to prevent water from entering the inlet under or around the geotextile. 7. This type of protection must be inspected frequently and the filter cloth and stone replaced when clogged with sediment.

8. Assure that storm flow does not bypass the inlet by installing a temporary earth or asphalt dike to direct the flow to the inlet. U.S. DEPARTMENT OF AGRICULTURE PAGE MARYLAND DEPARTMENT OF ENVIRONMENT E - 16 - 5B VATER MANAGEMENT ADMINISTRATION SDIL CONSERVATION SERVICE

5' WIDE UNLESS OTHERWISE NOTED COMPACTED SUBGRADE-S.H.A. MIX NO. 2 CONCRETE, STIFF BROOM FINISH. REMOVE EDGEING TOOL MARKS IN

> PROVIDE LATITUDINAL EXPANSION JOINTS AT 15' O.C. (MAX.) PROVIDE CONTRACTION (DUMMY) JOINT AT 5' O.C. INTERVALS BETWEEN EXPANSION JOINTS. SIDEWALK TO BE SCRIBED IN

SIDEWALK DETAIL NO SCALE

BY THE DEVELOPER :

CONSERVATION DISTRICT.

I/WE CERTIFY THAT ALL DEVELOPMENT AND CONSTRUCTION WILL BE DONE ACCORDING TO THIS PLAN, AND THAT ANY RESPONSIBLE PERSONNEL INVOLVED IN THE CONSTRUCTION PROJECT WILL HAVE A CERTIFICATE OF ATTENDANCE AT A DEPARTMENT OF THE ENVIRONMENT APPROVED TRAINING PROGRAM FOR THE CONTROL OF SEDIMENT AND EROSION BEFORE BEGINNING THE PROJECT. I ALSO AUTHORIZE PERIODIC ON-SITE INSPECTIONS BY THE HOWARD SOIL

N.27.96

BY THE ENGINEER

DISTRICT.

CERTIFY THAT THIS PLAN FOR EROSION AND SEDIMENT CONTROL REPRESENTS A PRACTICAL AND WORKABLE PLAN BASED ON MY PERSONAL KNOWLEDGE OF THE SITE CONDITIONS AND THAT IT WAS PREPARED IN ACCORDANCE WITH THE REQUIREMENTS OF THE HOWARD SOIL CONSERVATION DISTRICT.

11.27.96

THESE PLANS HAVE BEEN REVIEWED FOR THE HOWARD SOIL CONSERVATION DISTRICT AND MEET THE TECHNICAL REQUIREMENTS FOR SOIL EROSION AND SEDIMENT CONTROL.

(news NATURAL RESOURCES CONSERVATION SERVICE THIS DEVELOPMENT PLAN IS APPROVED FOR SOIL EROSION AND SEDIMENT CONTROL BY THE HOWARD SOIL CONSERVATION

APPROVED: HOWARD COUNTY DEPARTMENT OF PLANNING AND

DEVELOPMENT ENGINEERING DIVISION 12/11/96 HIEF, DIVISION OF LAND DEVELOPMENT

1-16-97 A REV. 2 SD PROFILES; M-1 TO T-2 & I-3 TO I-1 **REVISION** DEVELOPER OWNER CITIZEN'S NATIONAL BANK OPUS EAST, L.L.C. 517 MAIN STREET 6707 DEMOCRACY BLVD. LAUREL, MD 20707 SUITE 510 (301)497-6275 BETHESDA, MD 2081

PROJECT CITIZEN'S NATIONAL BANK AT LONG GATE CENTER

(301)493-4444

AREA TAX MAP 24 BLOCK 24 PARCEL O ZONED B-2 2nd ELECTION DISTRICT HOWARD COUNTY, MARYLAND

PROFILES, NOTES AND DETAILS

RIEMER MUEGGE & ASSOCIATES, INC ENGINEERING ● ENVIRONMENTAL SERVICES ● PLANNING ● SURVEYING 8818 Centre Park Drive, Columbia, Maryland 21045 tel 410.997.8900 fax 410.997.9282

F-96-163 MP-95-64 DESIGNED BY : CJR DRAWN BY : RPP JAYKANT D. PAREKH #19148

. HOCO\96050 SDP4.DMG PROJECT NO: DATE : NOVEMBER 27, 1990 SCALE : AS SHOWN

=-95-93 SDP-95-62 NP-94-60

