


SHEET INDEX	
NO	DESCRIPTION
1	TITLE SHEET
2	SITE DEVELOPMENT PLAN
3	GRADING & SEDIMENT CONTROL PLAN
4	PROFILES, NOTES, AND DETAILS
5	NOTES AND DETAILS
6	LANDSCAPING PLAN

SITE DEVELOPMENT PLAN OUTBACK STEAKHOUSE/CARRABBA'S AT LONG GATE CENTER PARCELS J&K 2nd ELECTION DISTRICT HOWARD COUNTY, MARYLAND

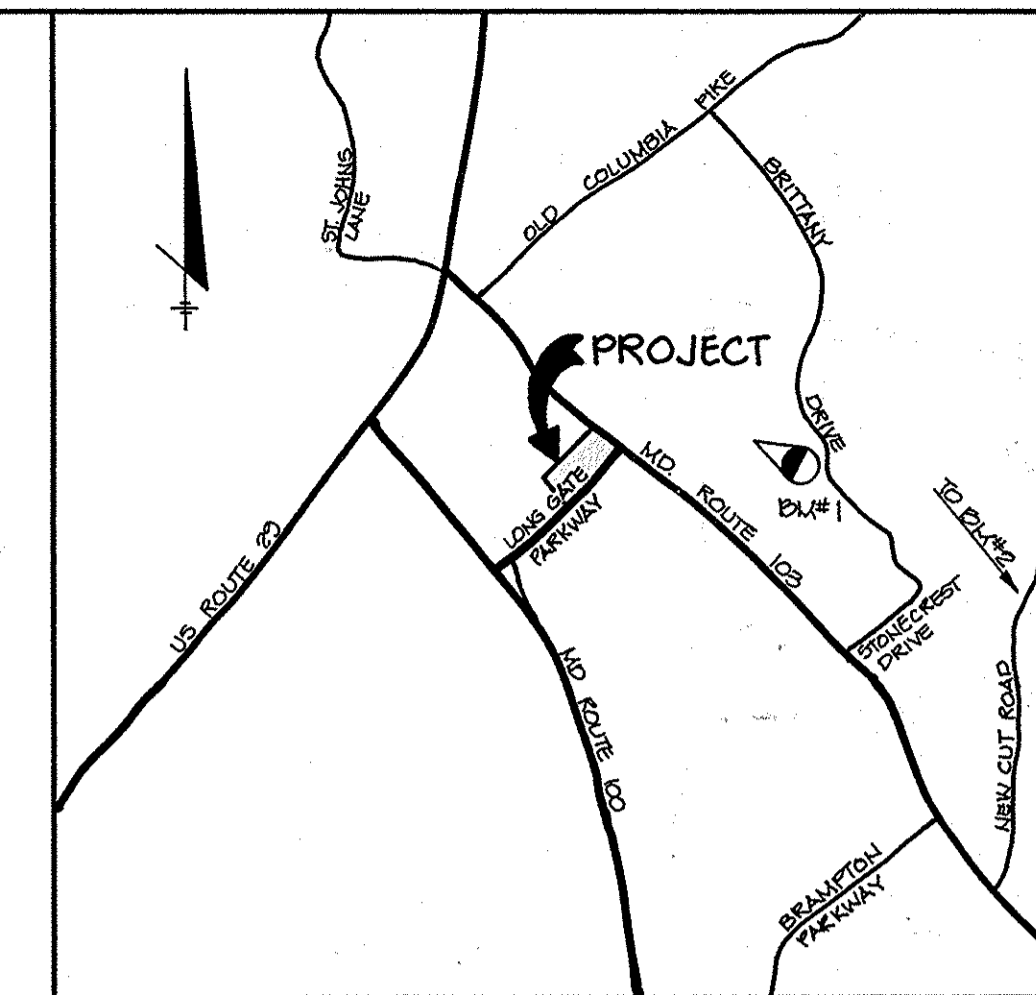


BEVCHMARKS

BH#1	STA 3043001	BH#2	STA 2943002
ELEV. 487.42		N 513,205.90	E 857,478.64
N 516,544.55	E 853,656.51	LOCATED ON THE TRANSMISSION LINE	
32' ± NORTH OF B&E TOWER 276-A		1700' ± NORTH OF INTERSECTION OF	
BEHIND SCHOOL GROUNDS		ROUTE 103 AND NEW CUT ROAD AND	
		1150' ± EAST OF NEW CUT ROAD	

VICINITY MAP
SCALE: 1" = 2000'

GENERAL NOTES

- ALL CONSTRUCTION SHALL BE IN ACCORDANCE WITH THE LATEST STANDARDS AND SPECIFICATIONS OF HOWARD COUNTY PLUS MSHA STANDARDS AND SPECIFICATIONS, IF APPLICABLE.
- THE CONTRACTOR SHALL NOTIFY THE DEPARTMENT OF PUBLIC WORKS/BUREAU OF ENGINEERING/CONSTRUCTION INSPECTION DIVISION AT (410) 313-1880 AT LEAST FIVE (5) WORKING DAYS PRIOR TO THE START OF WORK.
- THE CONTRACTOR SHALL NOTIFY "MISS UTILITY" AT 1-800-257-7777 AT LEAST 48 HOURS PRIOR TO ANY EXCAVATION WORK BEING DONE.
- TRAFFIC CONTROL DEVICES, MARKINGS, AND SIGNING SHALL BE IN ACCORDANCE WITH THE LATEST EDITION OF THE MANUAL ON UNIFORM TRAFFIC CONTROL DEVICES (MUTCD). ALL STREET AND REGULATORY SIGNS SHALL BE IN PLACE PRIOR TO THE PLACEMENT OF ANY ASPHALT.
- ALL PLAN DIMENSIONS ARE TO FACE OF CURB UNLESS OTHERWISE NOTED.
- THE EXISTING TOPOGRAPHY IS TAKEN FROM SDP-95-62 WITH MAXIMUM TWO FOOT CONTOUR INTERVALS PREPARED BY RIEMER MUEGGE & ASSOC. DATED SEPT. 1995.
- THE COORDINATES SHOWN HEREON ARE BASED UPON THE HOWARD COUNTY GEODETIC CONTROL WHICH IS BASED UPON THE MARYLAND STATE PLANE COORDINATE SYSTEM, HOWARD COUNTY MONUMENT NOS. 3043001-R AND 2943002 WERE USED FOR THIS PROJECT.
- WATER IS PUBLIC PER CONTRACT NUMBER 24-3438-D.
- SEWER IS PUBLIC PER CONTRACT NUMBER 24-3438-D. SEWER DRAINAGE AREA: 108 PUMPING STATION
- THE STORMWATER MANAGEMENT FACILITY PROPOSED FOR THIS SITE IS PROVIDED BY A RETENTION FACILITY APPROVED UNDER SDP-95-62.
- APPROXIMATE LOCATION OF EXISTING UTILITIES ARE SHOWN. THE CONTRACTOR SHALL TAKE ALL NECESSARY PRECAUTIONS TO PROTECT THE EXISTING UTILITIES AND MAINTAIN UNINTERRUPTED SERVICE. ANY DAMAGE INCURRED DUE TO CONTRACTOR'S OPERATION SHALL BE REPAIRED IMMEDIATELY AT THE CONTRACTOR'S EXPENSE. EXISTING UTILITIES ARE SHOWN BASED ON THE BEST AVAILABLE INFORMATION.
- THERE IS NO ON-SITE 100 YEAR FLOODPLAIN.
- THERE ARE NO ON-SITE WETLANDS.
- THE TRAFFIC STUDY FOR THIS PROJECT WAS PREPARED BY THE TRAFFIC GROUP, INC. DATED APRIL 21, 1993 AND WAS APPROVED UNDER SDP-95-62.
- THE BOUNDARY SURVEY FOR THIS PROJECT WAS PREPARED BY RIEMER MUEGGE & ASSOC., INC. DATED APRIL 1996.
- SUBJECT PROPERTY ZONED FOR PER 10-18-93 COMPREHENSIVE ZONING PLAN.
- ALL ELEVATIONS SHOWN ARE BASED ON THE U.S.C. AND G.S. MEAN SEA LEVEL DATUM, 1929.
- SEE DEPARTMENT OF PLANNING AND ZONING FILE-NO'S. SDP-95-62, F-95-93, F-97-25.
- THE CONTRACTOR SHALL TEST PIT EXISTING UTILITIES AT LEAST (5) DAYS BEFORE STARTING WORK SHOWN ON THESE DRAWINGS.
- CONTRACTOR IS SOLELY RESPONSIBLE FOR CONSTRUCTION MEANS, METHODS, TECHNIQUES, SEQUENCES, PROCEDURES, AND SAFETY PRECAUTIONS AND PROGRAMS.
- PIPE SHALL NOT BE INSTALLED BY THE CONTRACTOR UNTIL THE LENGTH CALLED FOR AT EACH STATION HAS BEEN APPROVED BY THE ENGINEER IN THE FIELD.
- NO PIPE SHALL BE LAID UNTIL LINES OF EXCAVATION HAVE BEEN BROUGHT WITHIN 6" OF FINISHED GRADE.
- ALL STORM DRAIN PIPE BEDDING SHALL BE CLASS "C" AS SHOWN IN FIG. 11-4, VOLUME 1 OF HOWARD COUNTY DESIGN MANUAL UNLESS OTHERWISE NOTED.
- ALL INLETS SHALL BE CONSTRUCTED IN ACCORDANCE WITH HOWARD COUNTY STANDARDS.
- ALL PIPE ELEVATIONS SHOWN ARE INVERT ELEVATIONS.
- STORM DRAIN TRENCHES WITHIN ROAD RIGHT OF WAY SHALL BE BACKFILLED AND COMPACTED IN ACCORDANCE WITH THE HOWARD COUNTY DESIGN MANUAL, VOLUME IV, I.A., STANDARD SPECIFICATIONS AND DETAILS FOR CONSTRUCTION, LATEST AMENDMENTS.
- PROFILES STATIONS SHALL BE ADJUSTED AS NECESSARY TO CONFORM TO PLAN DIMENSIONS.
- ALL FILL AREAS WITHIN ROADWAY AND UNDER STRUCTURES TO BE COMPACTED TO A MINIMUM OF 95% COMPACTION OF AASHTO T88.
- FOREST CONSERVATION OBLIGATIONS FOR THIS DEVELOPMENT HAVE BEEN ADDRESSED UNDER SDP-95-62.

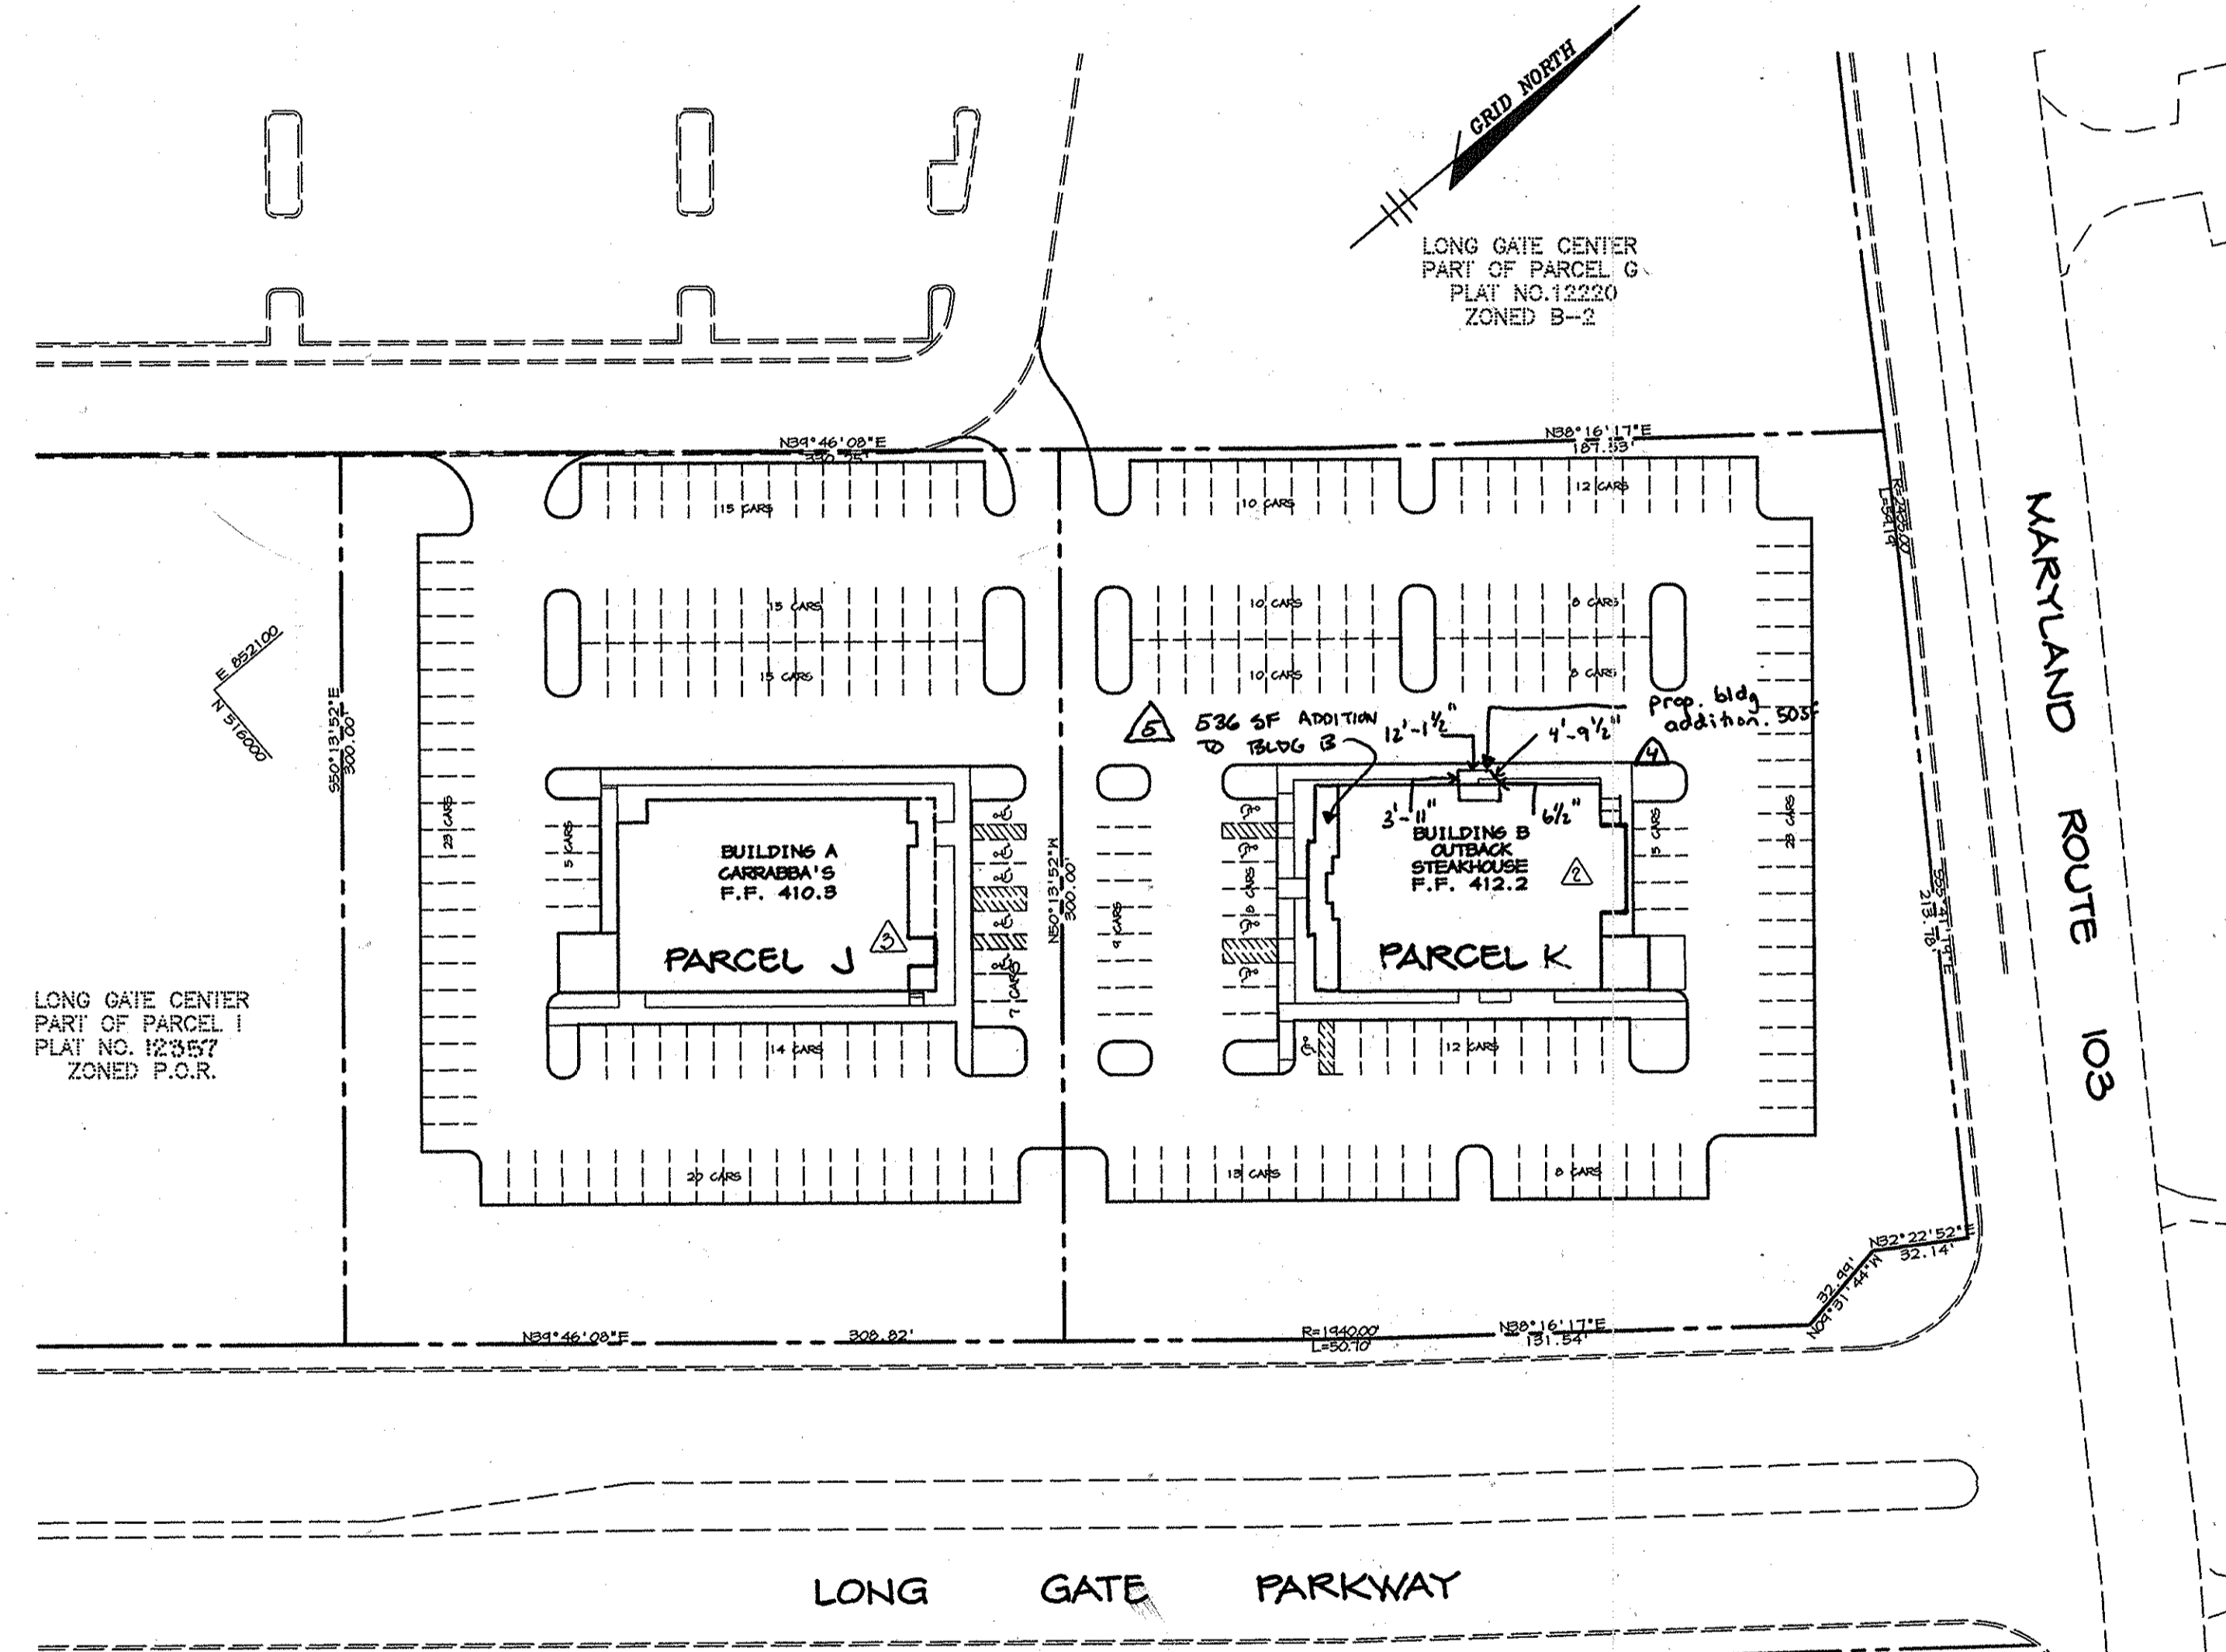



LONG GATE CENTER
PART OF PARCEL G,
PLAT NO. 12220
ZONED B-2

LONG GATE PARKWAY

PLAN
SCALE: 1" = 50'


SITE ANALYSIS

AREA OF PARCELS	72,329 SF - 1.66 ACRES (PARCEL J) 86,364 SF - 1.98 ACRES (PARCEL K)
PRESENT ZONING	FOR
PROPOSED USE	SIT-DOWN RESTAURANTS
BUILDING COVERAGE	BLDG A: 7200 SF (10.0% OF PARCEL J) BLDG B: 5284 SF (8.4% OF PARCEL K) TOTAL 12,484 SF
# OF PARKING SPACES REQ'D @ 14 SP/1000 SF	101 (PARCEL J) 102 (PARCEL K) TOTAL 203
# OF PARKING SPACES PROVIDED	114 INCL. 5 HC (PARCEL J) 136 INCL. 5 HC (PARCEL K) TOTAL 250
PAVED AREA	87,984 SF
PARKING LOT SIDEWALKS	5,193 SF
TOTAL	93,177 SF (58.7% OF PARCELS J&K)

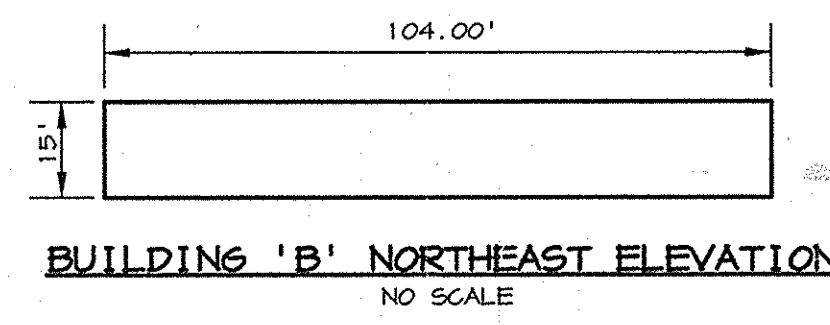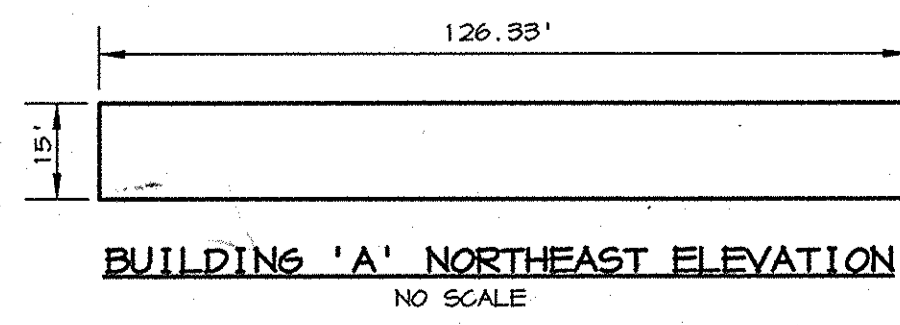

I hereby certify that these documents were prepared or approved by me, and that I am a duly licensed professional engineer under the laws of the State of Maryland.
License No. 21770
Expiration Date: 11/16/16

5th REVISION ONLY

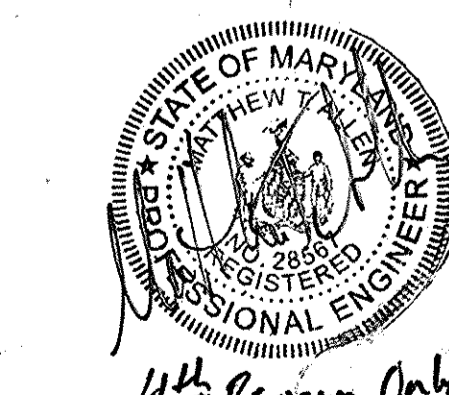


4th Revision Only

ADDRESS CHART

BUILDING	STREET ADDRESS
A	4430 LONG GATE PARKWAY
B	4420 LONG GATE PARKWAY

5-6-15	5	ADDED ADDITION TO BLDG B
APPROVED : FOR PUBLIC WATER AND PUBLIC SEWERAGE SYSTEMS, HOWARD COUNTY HEALTH DEPARTMENT.		
James N. Boyd (Seal)		10/18/96
COUNTY HEALTH OFFICER		DATE
APPROVED : HOWARD COUNTY DEPARTMENT OF PLANNING AND ZONING.		
Joseph Smith (Seal)		10/23/96
DIRECTOR		DATE
M. J. ... (Seal)		10/17/96
CHIEF, DEVELOPMENT ENGINEERING DIVISION		DATE
Richard B. ... (Seal)		10/22/96
CHIEF, DIVISION OF LAND DEVELOPMENT AND RESEARCH		DATE

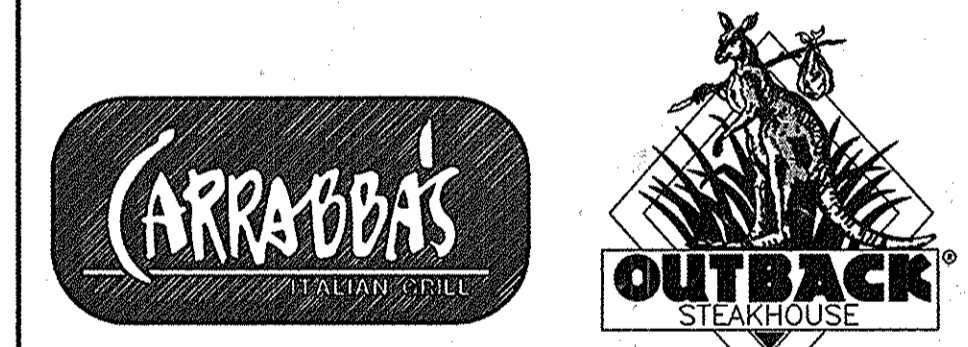

4-13-05	1	ADDED BLDG. ADDITION TO BLDG. 'B'
5-27-05	2	ADDED BLDG. ADDITION TO BLDG. 'A'
5-2-05	3	ADDED BLDG. ADDITION & REV. SITE PAD
DATE	NO.	REVISION


OWNER	DEVELOPER
OPUS EAST, L.L.C. 6707 DEMOCRACY BLVD. SUITE 510 BETHESDA, MD 20817 (301) 493-4464	OUTBACK STEAKHOUSE 550 NORTH REO ST. SUITE 200 TAMPA, FL 33609 (813) 282-1225

PROJECT	OUTBACK STEAKHOUSE/ CARRABBA'S
AREA	TAX MAPS 24 & 30 PARCELS J&K 2nd ELECTION DISTRICT HOWARD COUNTY, MARYLAND

TITLE SHEET



RIEMER MUEGGE & ASSOCIATES, INC.
ENGINEERING • ENVIRONMENTAL SERVICES • PLANNING • SURVEYING
8818 Centre Park Drive, Columbia, Maryland 21045
tel 410.997.8900 fax 410.997.9282

DATE	10-10-96
DESIGNED BY :	CJR
DRAWN BY :	RPP/DAM
PROJECT NO :	HOCO-96E4701
DATE :	OCTOBER 10, 1996
SCALE :	AS SHOWN
DRAWING NO. :	1 OF 6

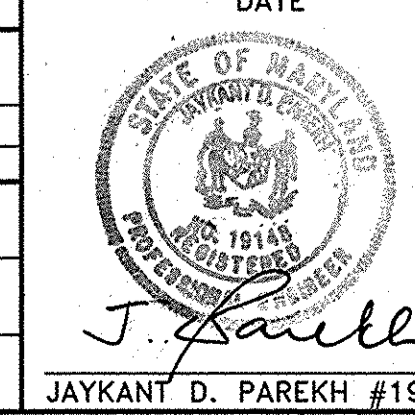

JAYKANT D. PAREKH #19148

SDP-97-020

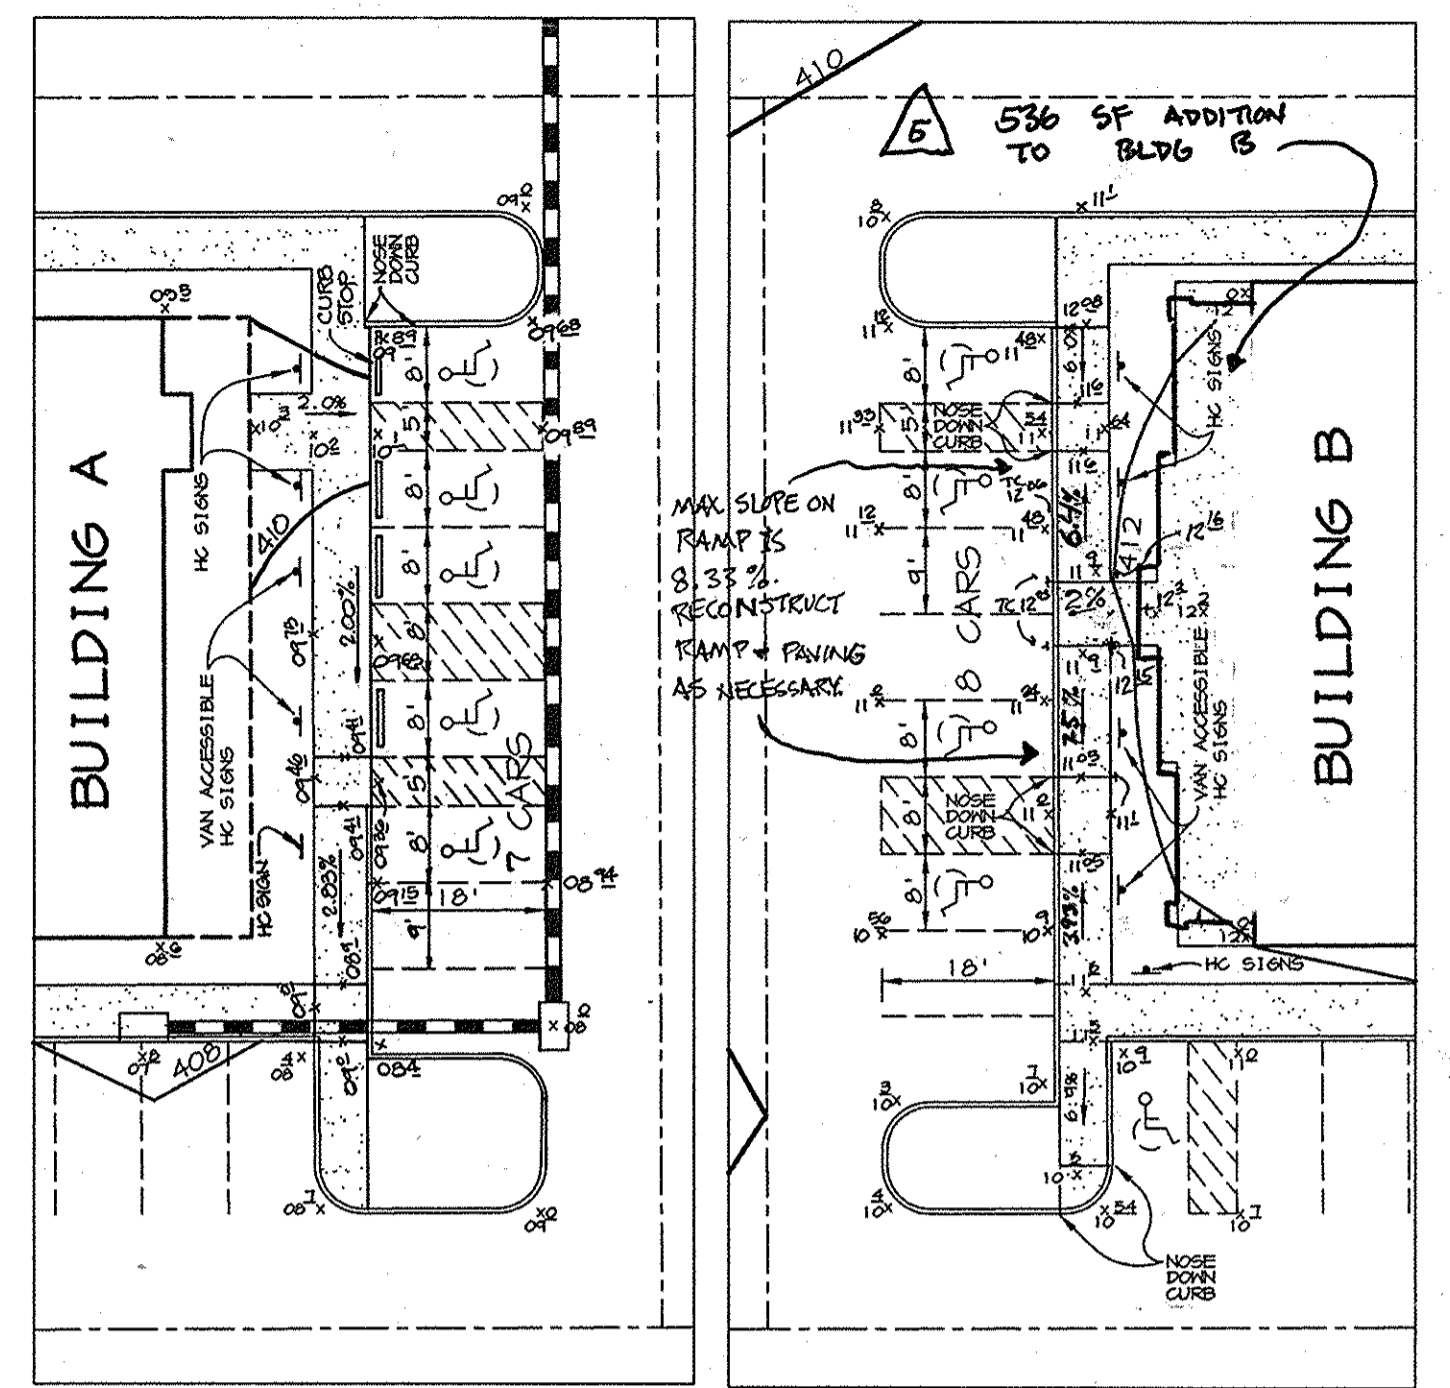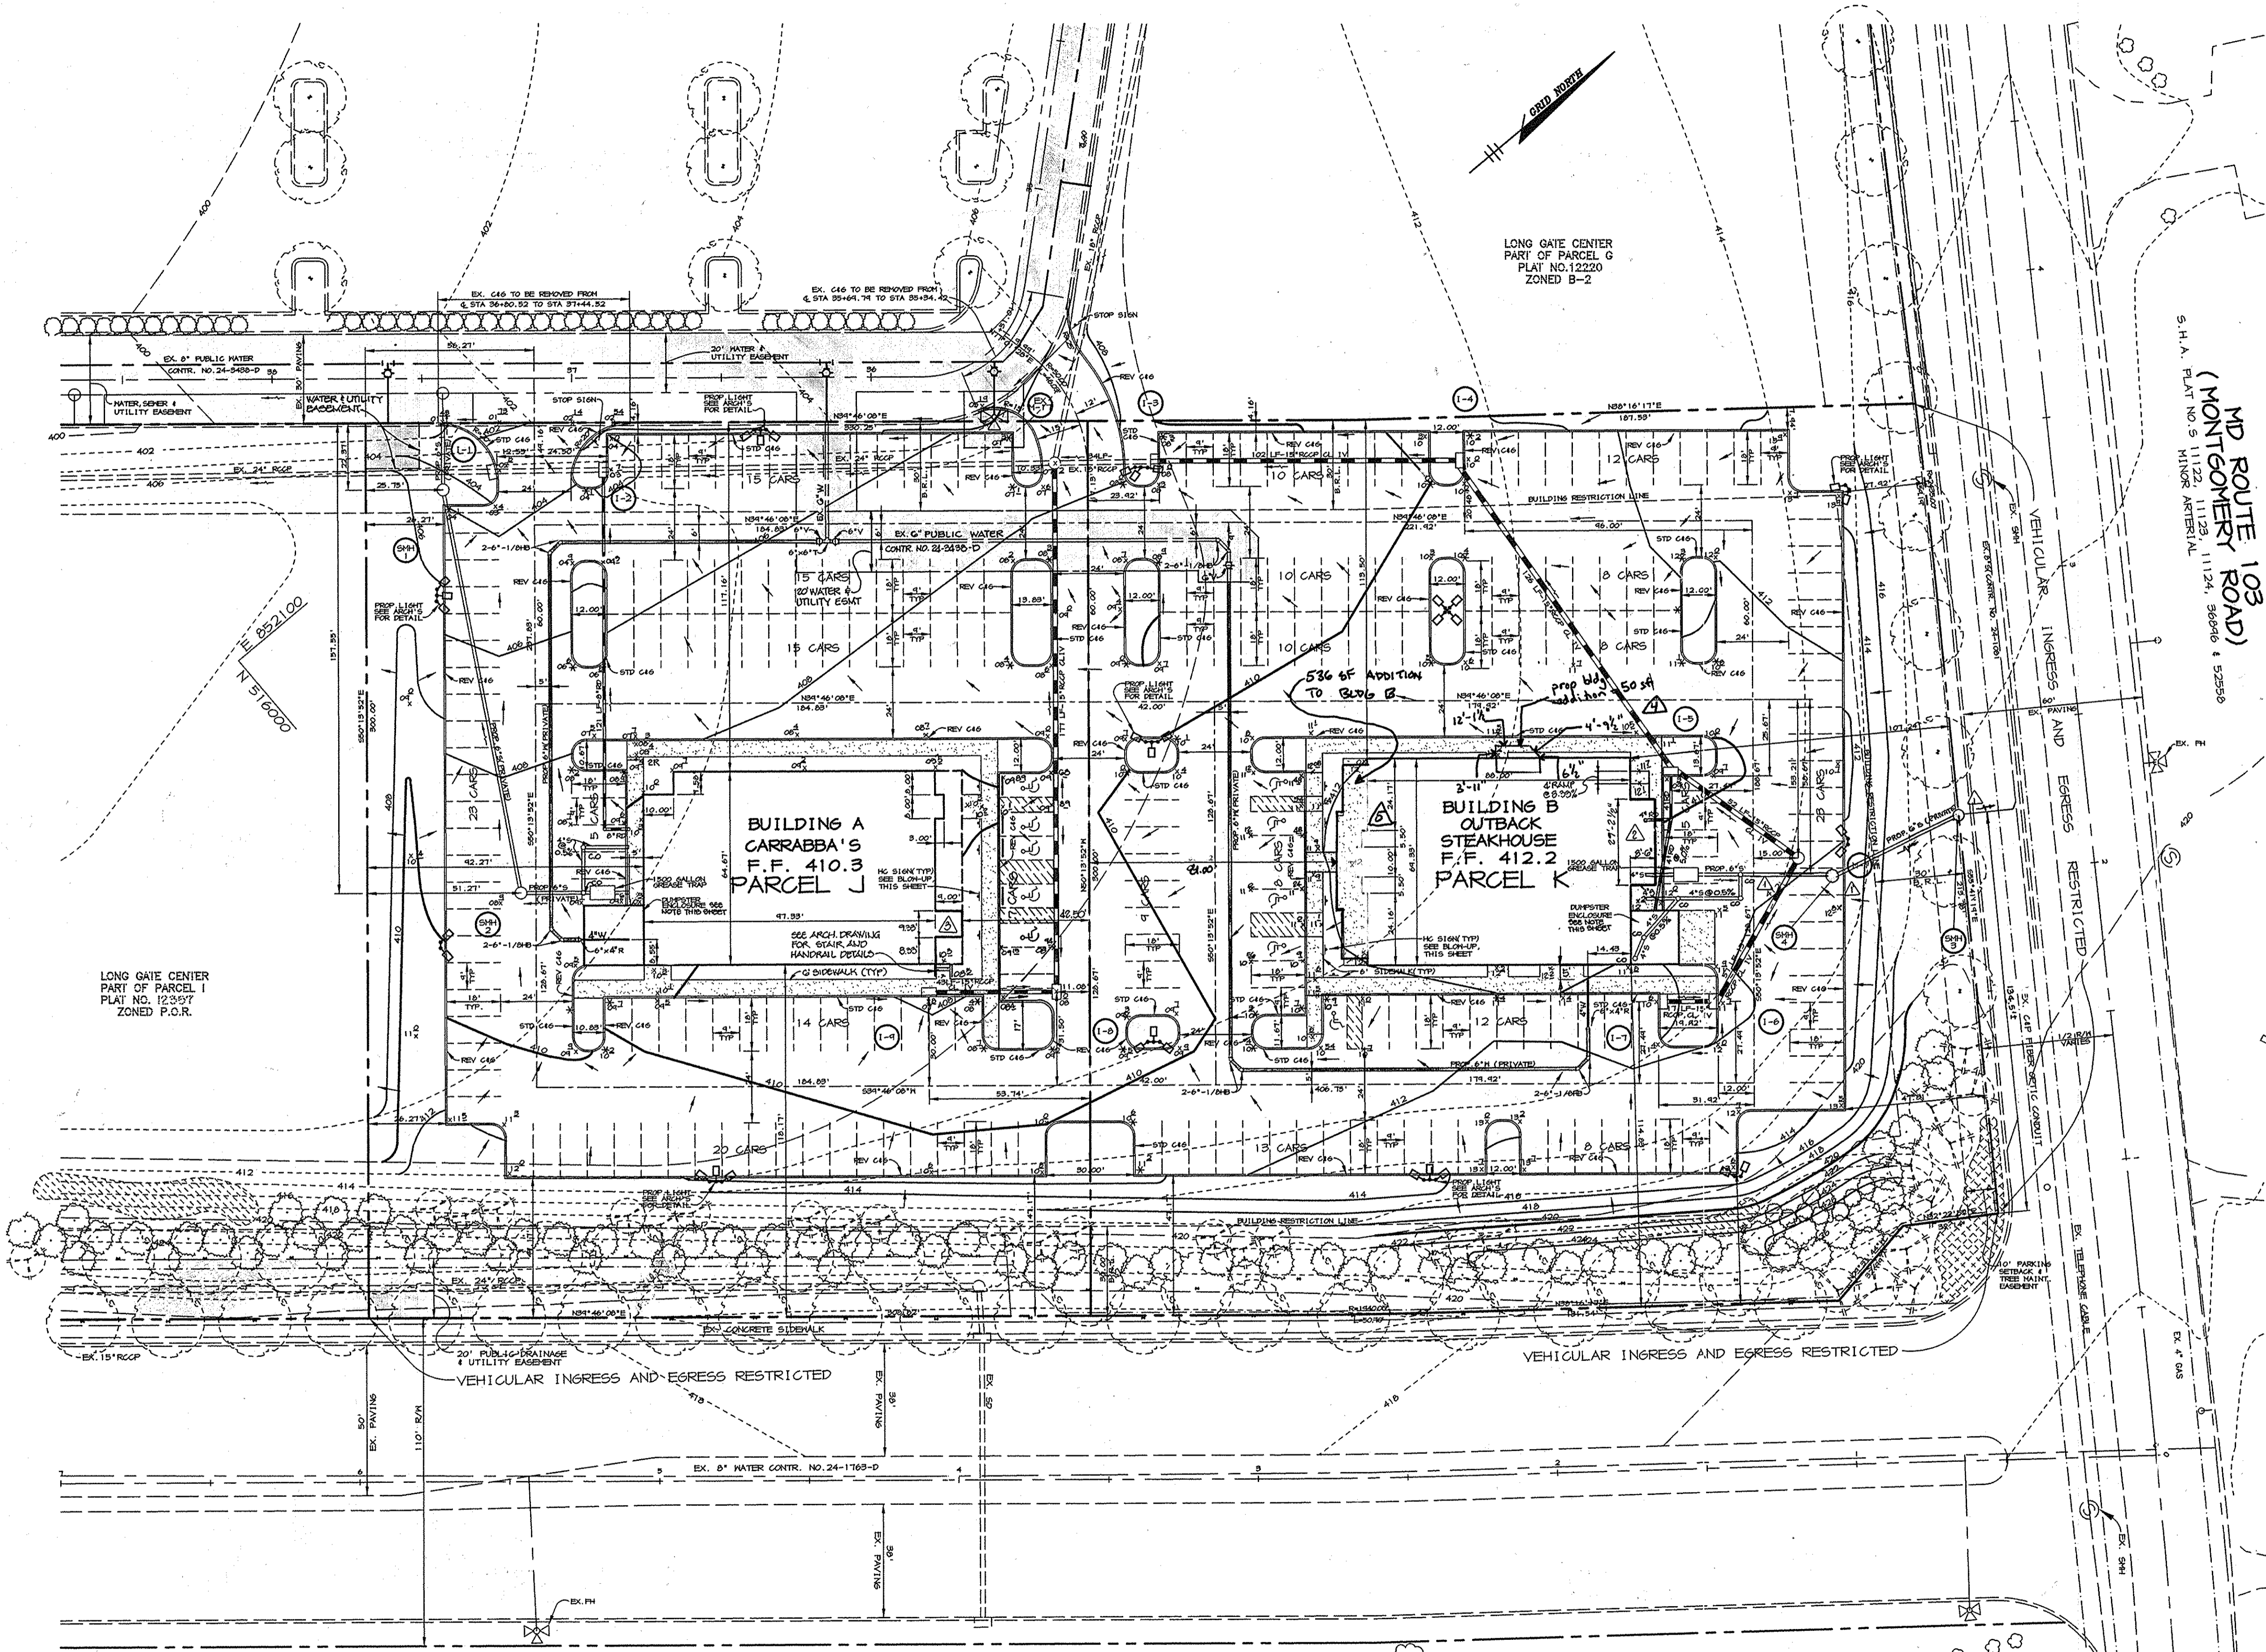


HANDICAP ACCESS AREA

SCALE: 1"=20'

5-5-15	5	ADDED BLDG. ADDITION TO BUILDING B
5-27-05	5	ADDED TAKEOUT AREA ENCLOSURE & DRIVEWAY CONNECTION - BLDG. A
DATE	NO.	REVISION
APPROVED: FOR PUBLIC WATER AND PUBLIC SEWERAGE SYSTEMS, HOWARD COUNTY HEALTH DEPARTMENT.		
James M. Bond, M.D. (E) 10/18/96		DATE
COUNTY HEALTH OFFICER		
APPROVED: HOWARD COUNTY DEPARTMENT OF PLANNING AND ZONING.		
Joseph A. Hutter 10/23/96		DATE
DIRECTOR		
Michael Dammann 10/17/96		DATE
CHIEF, DEVELOPMENT ENGINEERING DIVISION		
Richard Blood 10/22/96		DATE
CHIEF, DIVISION OF LAND DEVELOPMENT AND RESEARCH		

LEGEND

- * CURB TRANSITION
- LIGHTS

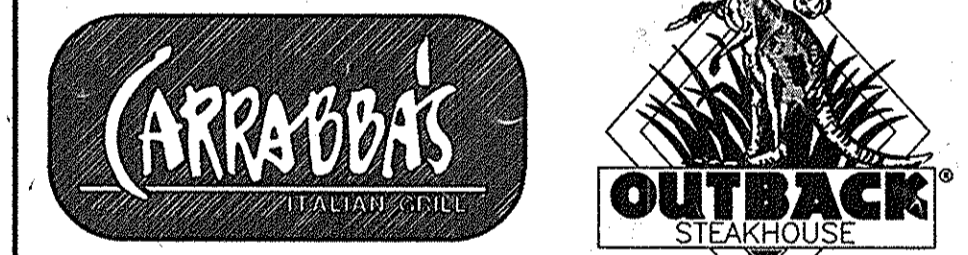

4-13-05	5	ADDED BLDG. ADDITION TO BLDG. "B"
5-2-05	5	ADDED BLDG. ADDITION
12/13/96	5	RELOC. SM'S 3 & 4, REROUTED CONNECTING SAN LINES
DATE	NO.	REVISION
OWNER	DEVELOPER	
OPUS EAST, L.L.C. 6707 DEMOCRACY BLVD. SUITE 510 BETHESDA, MD 20817 (301) 493-4464	OUTBACK STEAKHOUSE 550 NORTH REO ST. SUITE 200 TAMPA, FL 33609 (813) 282-1225	

PROJECT **OUTBACK STEAKHOUSE/ CARRABBA'S**
TWO RESTAURANT BUILDINGS

AREA TAX MAPS 24 & 30 PARCELS J&K
2nd ELECTION DISTRICT
HOWARD COUNTY, MARYLAND

SITE DEVELOPMENT PLAN

RIEMER MUEGGE & ASSOCIATES, INC.
ENGINEERING • ENVIRONMENTAL SERVICES • PLANNING • SURVEYING
8818 Centre Park Drive, Columbia, Maryland 21045
tel 410.997.8900 fax 410.997.9282

10-10-96	DATE	SOP-85-62 P-85-413	P-87-29
DESIGNED BY: CJR	DRAWN BY: RFP/DAM		
PROJECT NO: HOCO/96E4701 C-2.DWG			
DATE: OCTOBER 10, 1996			
SCALE: 1"=30'			
DRAWING NO. 2 OF 6			

I hereby certify that these documents were prepared or approved by me, and that I am a duly licensed professional engineer under the laws of the State of Maryland.
M.D.
2-1774
Expiration Date: 11/12/15
5th REVISION ONLY



NOTES:

1. ALL CURB RADII ARE 5' UNLESS OTHERWISE NOTED.
2. ALL DIMENSIONS ARE TO FACE OF CURB OR FACE OF BUILDING UNLESS OTHERWISE NOTED.
3. ALL SPOT ELEVATIONS ARE TOP OF PAVING OR FINAL GROUND UNLESS OTHERWISE NOTED.
4. ALL EXTERIOR LIGHTING IS TO BE DIRECTED/REFLECTED AWAY FROM ADJACENT ROAD RIGHT-OF-WAYS AND RESIDENTIALLY ZONED PROPERTIES.
5. ALL ON-SITE ROADWAYS ARE PRIVATE.
6. ALL PAVING IS P-2 UNLESS OTHERWISE SHOWN.
7. INLETS 1-1, 1-2 & 1-3 SHALL BE INSTALLED ALONG AN EXISTING STORM DRAIN. REMOVE STORM DRAIN PIPES AS NECESSARY TO NEAREST PIPE JOINT FOR INSTALLATION OF INLETS.
8. DUMPSTER ENCLOSURE TO BE CONSTRUCTED WITH SAME MATERIAL AS BUILDING. WOODEN GATE IN FRONT. SEE ARCHITECTURAL DRAWINGS FOR FURTHER DETAILS.
9. GREASE TRAP DETAILS TO BE PROVIDED UNDER ARCHITECTURAL DRAWING.

LONG GATE PARKWAY
S.H.A. PLAT NO. 11042
MINOR ARTERIAL

N 51° 00' 00"
E 85° 20' 00"

SEDIMENT CONTROL NOTES

- A MINIMUM OF 48 HOURS NOTICE MUST BE GIVEN TO THE HOWARD COUNTY DEPARTMENT OF INSPECTIONS AND PERMITS PRIOR TO THE START OF ANY CONSTRUCTION (313-1055)
- ALL VEGETATIVE AND STRUCTURAL PRACTICES ARE TO BE INSTALLED ACCORDING TO THE PROVISIONS OF THIS PLAN AND ARE TO BE IN CONFORMANCE WITH THE MARYLAND STANDARDS AND SPECIFICATIONS FOR SOIL AND EROSION CONTROL, AND REVISIONS THERE TO.
- FOLLOWING INITIAL SOIL DISTURBANCE OR REDISTURBANCE, PERMANENT OR TEMPORARY STABILIZATION SHALL BE COMPLETED WITHIN: A) 7 CALENDAR DAYS FOR ALL PERIMETER SEDIMENT CONTROL STRUCTURES, DIKES, PERIMETER SLOPES AND ALL SLOPES AND ALL SLOPES GREATER THAN 3:1, B) 14 DAYS AS TO OTHER DISTURBED OR GRADED AREAS ON THE PROJECT SITE.
- ALL SEDIMENT TRAPS/BASINS SHOWN MUST BE FENCED AND WARNING SIGNS POSTED AROUND THE PERIMETER IN ACCORDANCE WITH VOL. 1, CHAPTER 12, OF THE HOWARD COUNTY DESIGN MANUAL, STORM DRAINAGE.
- ALL DISTURBED AREAS MUST BE STABILIZED WITHIN THE TIME PERIOD SPECIFIED ABOVE IN ACCORDANCE WITH THE 1983 MARYLAND STANDARDS AND SPECIFICATIONS FOR SOIL AND EROSION CONTROL FOR PERMANENT SEEDINGS (SEC. 51), SOD (SEC. 54), TEMPORARY SEEDING (SEC. 50) AND MULCHING (SEC. 52). TEMPORARY STABILIZATION WITH MULCH ALONG CAN ONLY BE DONE WHEN RECOMMENDED SEEDING DATES DO NOT ALLOW FOR PROPER GERMINATION AND ESTABLISHMENT OF GRASSES.
- ALL SEDIMENT CONTROL STRUCTURES ARE TO REMAIN IN PLACE AND ARE TO BE MAINTAINED IN OPERATIVE CONDITION UNTIL PERMITS FOR THEIR REMOVAL HAS BEEN OBTAINED FROM THE HOWARD COUNTY SEDIMENT CONTROL INSPECTOR.
- SITE ANALYSIS:

TOTAL AREA OF SITE	3.64 ACRES
AREA TO BE ROOFED OR PAVED	3.21 ACRES
AREA TO BE VEGETATIVELY STABILIZED	0.43 ACRES
TOTAL CUT	8281 CU. YARDS
TOTAL FILL	1084 CU. YARDS
- ANY SEDIMENT CONTROL PRACTICE WHICH IS DISTURBED BY GRADING ACTIVITY FOR PLACEMENT OF UTILITIES MUST BE REPAIRED ON THE SAME DAY OF DISTURBANCE.
- ADDITIONAL SEDIMENT CONTROLS MUST BE PROVIDED, IF DEEMED NECESSARY BY THE HOWARD COUNTY SEDIMENT CONTROL INSPECTOR.
- SITE GRADINGS WILL BEGIN ONLY AFTER ALL PERIMETER SEDIMENT CONTROL MEASURES HAVE BEEN INSTALLED AND ARE IN A FUNCTIONING CONDITION.
- SEDIMENT WILL BE REMOVED FROM TRAPS WHEN ITS DEPTH REACHES CLEAN OUT ELEVATION SHOWN ON THE PLANS.
- CUT AND FILL QUANTITIES PROVIDED UNDER SITE ANALYSIS DO NOT REPRESENT BID QUANTITIES. THESE QUANTITIES DO NOT DISTINGUISH BETWEEN TOPSOIL, STRUCTURAL FILL OR EMBANKMENT MATERIAL. NOR DO THEY REFLECT CONSIDERATION OF UNDERCUTTING OR REMOVAL OF UNSUITABLE MATERIAL. THE CONTRACTOR SHALL FAMILIARIZE HIMSELF WITH SITE CONDITIONS WHICH MAY AFFECT THE WORK.
- ON ALL SITES WITH DISTURBED AREAS IN EXCESS OF 2 AC., APPROVAL OF THE INSPECTION AGENCY SHALL BE REQUESTED UPON COMPLETION OF INSTALLATION OF PERIMETER EROSION AND SEDIMENT CONTROL BEFORE PROCEEDING WITH ANY OTHER EARTH DISTURBANCE OR GRADING. OTHER BUILDING OR GRADING INSPECTION APPROVALS MAY NOT BE AUTHORIZED UNTIL THIS INITIAL APPROVAL BY THE INSPECTION AGENCY IS MADE.
- TRENCHES FOR THE CONSTRUCTION OF UTILITIES IS LIMITED TO THREE PIPE LENGTHS OR THAT WHICH CAN BE BACKFILLED AND STABILIZED WITHIN ONE WORKING DAY, WHICHEVER IS SHORTER.
- BORROW SITE TO BE PRE-APPROVED BY THE SEDIMENT CONTROL INSPECTOR, OR IN CASE OF EXCESS MATERIAL, AN APPROVED SEDIMENT CONTROL PLAN WILL BE NEEDED TO DEPOSIT EXCESS OFF-SITE.

TEMPORARY SEEDING NOTES

Apply to graded or cleared areas likely to be redisturbed where a short-term vegetative cover is needed.

Seeded Preparation: Loosen upper three inches of soil by raking, disking or other acceptable means before seeding. If not previously loosened.

Soil Amendments: Apply 600 lbs. per acre 10-10-10 fertilizer (14 lbs. per 1000 sq. ft.).

Seeding: For periods March 1 thru April 30 and from August 15 thru November 15, seed with 2-1/2 bushels per acre of annual rye (3.2 lbs. per 1000 sq. ft.). For the period May 1 thru August 14, seed with 3 lbs. per acre of creeping lovegrass (0.07 lbs. per 1000 sq. ft.). For the period November 16 thru February 28, protect site by applying 2 tons per acre of well anchored straw mulch and seed as soon as possible in the spring, or use sod.

Mulching: Apply 1-1/2 to 2 tons per acre (70 to 90 lbs. per 1000 sq. ft.) of unrotted small grain straw immediately after seeding. Anchor mulch immediately after application using mulch anchoring tool or 218 gal. per acre (5 gal. per 1000 sq. ft.) of emulsified asphalt on flat areas. On slopes, 8 ft. or higher, use 341 gal. per acre (8 gal. per 1000 sq. ft.) for anchoring.

Refer to the 1983 MARYLAND STANDARDS AND SPECIFICATIONS FOR SOIL EROSION AND SEDIMENT CONTROL FOR rate and methods not covered.

PERMANENT SEEDING NOTES

Apply to graded or cleared areas not subject to immediate further disturbance where a permanent long-lived vegetative cover is needed.

Seeded Preparation: Loosen upper three inches of soil by raking, disking or other acceptable means before seeding. If not previously loosened.

Soil Amendments: In lieu of soil test recommendations, use one of the following schedules:

- Preferred - Apply 2 tons per acre dolomitic limestone (42 lbs. per 1000 sq. ft.) and 600 lbs. per acre 10-10-10 fertilizer (14 lbs. per 1000 sq. ft.) before seeding. Harrow or disc into upper three inches of soil. At time of seeding, apply 400 lbs. per acre 30-0-0 ureaform fertilizer (4 lbs. per 1000 sq. ft.)
- Acceptable - Apply 2 tons per acre dolomitic limestone (42 lbs. per 1000 sq. ft.) and 1000 lbs. per acre 10-10-10 fertilizer (23 lbs. per 1000 sq. ft.) before seeding. Harrow or disc into upper three inches of soil.


Seeding: For the period March 1 thru April 30 and from August 1 thru October 15, seed with 60 lbs. per acre Kentucky 31 Tall Fescue (0.05 lbs. per 1000 sq. ft.) of creeping lovegrass. During the period October 16 thru February 28, protect site by one of the following options:

- 2 tons per acre of well-anchored mulch straw and seed as soon as possible in the spring.
- Use sod.
- Seed with 60 lbs. per acre Kentucky 31 Tall Fescue and mulch with 2 tons per acre well anchored straw.

Mulching: Apply 1-1/2 to 2 tons per acre (70 to 90 lbs. per 1000 sq. ft.) of unrotted small grain straw immediately after seeding. Anchor mulch immediately after application using mulch anchoring tool or 218 gal. per acre (5 gal. per 1000 sq. ft.) of emulsified asphalt on flat areas. On slopes, 8 ft. or higher, use 341 gal. per acre (8 gal. per 1000 sq. ft.) for anchoring.

Maintenance: Inspect all seeded areas and make needed repairs, replacements and reseedings.

DETAIL 23B - AT GRADE INLET PROTECTION

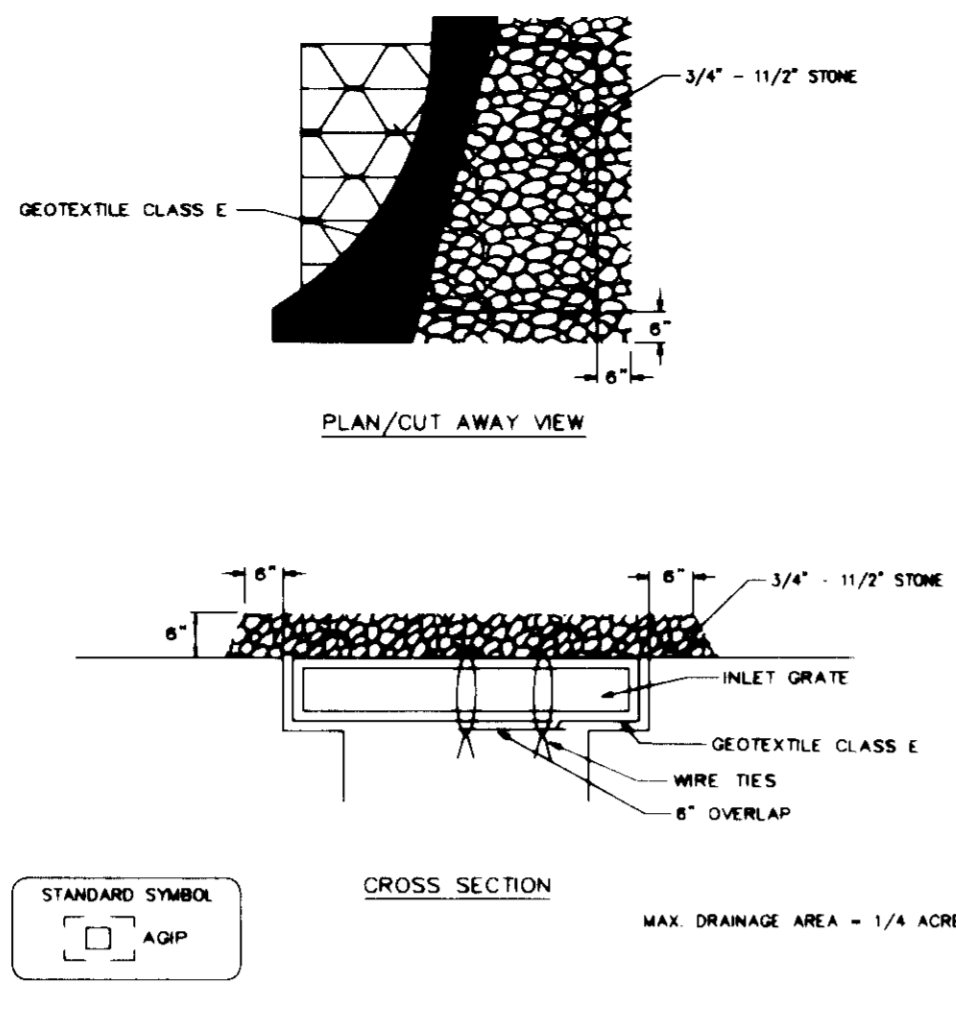


Construction Specifications

- Lift grate and wrap with Geotextile Class E to completely cover all openings, then set grate back in place.
- Place 3/4" to 1 1/2" stone, 4" to 6" thick on the grate to secure the fabric and provide additional filtration.

U.S. DEPARTMENT OF AGRICULTURE SOIL CONSERVATION SERVICE PAGE E-18-54 MARYLAND DEPARTMENT OF ENVIRONMENT WATER MANAGEMENT ADMINISTRATION

DETAIL 24 - STABILIZED CONSTRUCTION ENTRANCE

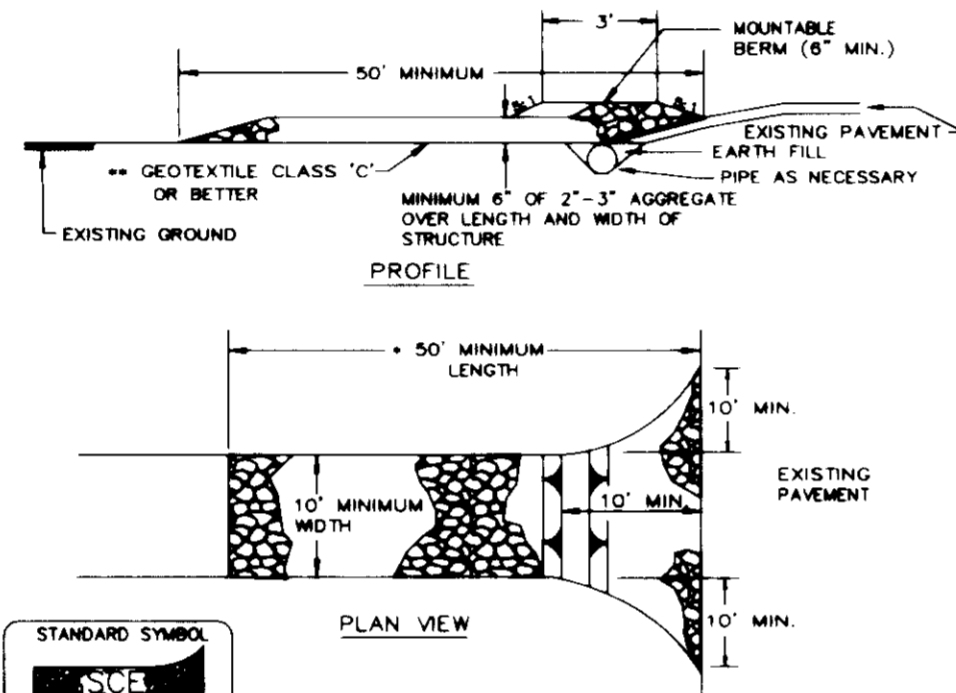


Construction Specifications

- Length - minimum of 50' (+30' for single residence lot)
- Width - 10' minimum, should be flared at the existing road to provide a turning radius.
- Geotextile fabric (filter cloth) shall be placed over the existing ground prior to placing stone. This plan approval authority may not require single family residences to use geotextile.
- Stone - crushed aggregate (2" to 3") or reclaimed or recycled concrete equivalent shall be placed at least 6" deep over the length and width of the entrance.
- Surface Water - all surface water flowing to or diverted toward construction entrances shall be piped through the entrance, maintaining positive drainage. Pipe installed through the stabilized construction entrance shall be protected with a mountable berm with 5" wood and a minimum of 6" of stone over the pipe. Pipe has to be sized according to the drainage. When the SCE is located at a high spot and has no drainage to convey a pipe will not be necessary. Pipe should be sized according to the amount of runoff to be conveyed. A 6" minimum will be required.
- Location - A stabilized construction entrance shall be located at every point where construction traffic enters or leaves a construction site. Vehicles leaving the site must travel over the entire length of the stabilized construction entrance.

U.S. DEPARTMENT OF AGRICULTURE SOIL CONSERVATION SERVICE PAGE E-17-3 MARYLAND DEPARTMENT OF ENVIRONMENT WATER MANAGEMENT ADMINISTRATION

DETAIL 33 - SUPER SILT FENCE

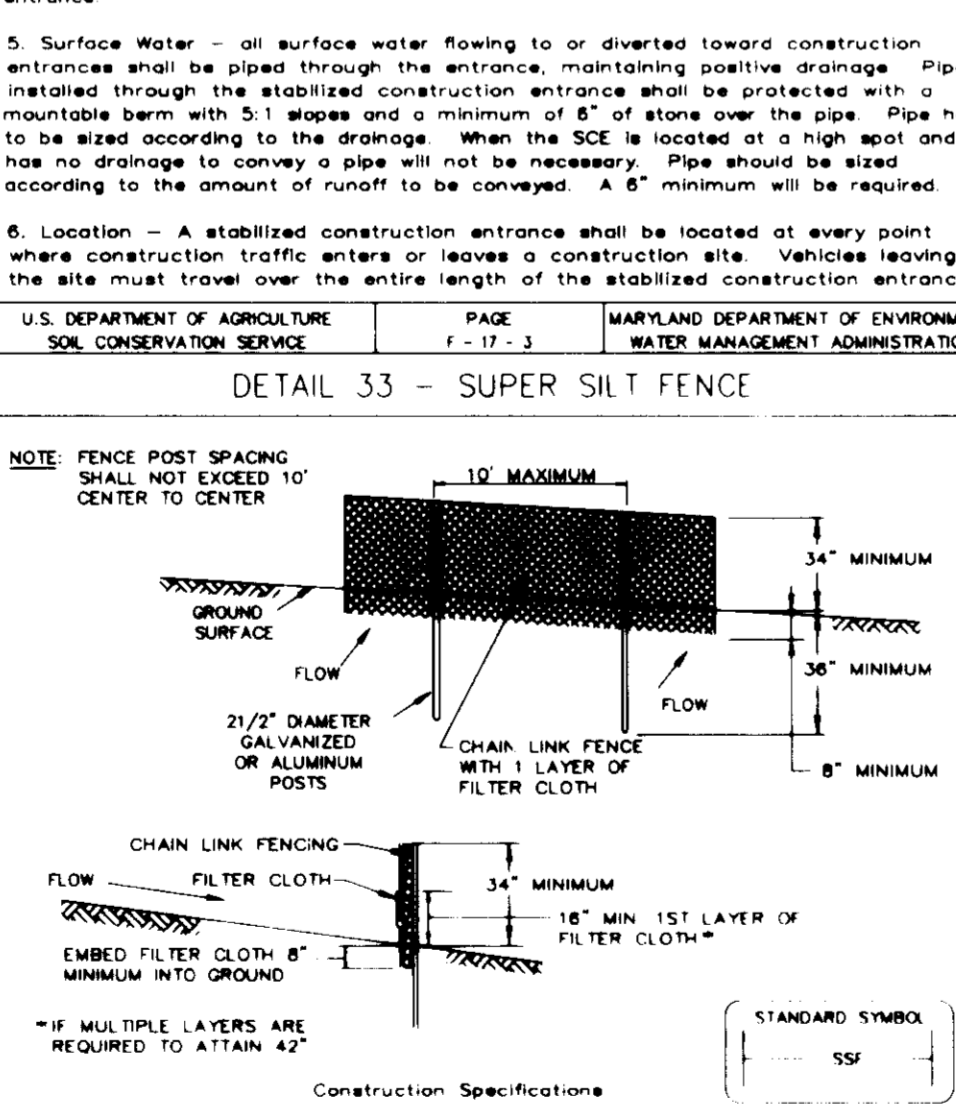

Construction Specifications


- Fencing shall be 42" in height and constructed in accordance with the latest Maryland State Highway Details for Chain Link Fencing. The specification for a 6" fence shall be used, substituting 42" fabric and 6" length posts.
- Chain link fence shall be fastened securely to the fence posts with wire ties. The lower tension wire, brace and truss rods, drive anchors and post caps are not required except on the ends of the fence.
- Filter cloth shall be fastened securely to the chain link fence with ties spaced every 24" at the top and mid section.
- Filter cloth shall be embedded a minimum of 8" into the ground.
- When two sections of filter cloth adjoin each other, they shall be overlapped by 6" and folded.
- Maintenance shall be performed as needed and all bulges removed when "bulges" develop in the silt fence, or when silt reaches 50% fence post height.
- Filter cloth shall be fastened securely to each fence post with wire ties or staples at top and mid section and shall meet the following requirements for Geotextile Class E:

Tensile Strength	50 lbs./in. (min.)	Test: USMT 508
Tensile Modulus	20 lbs./in. (min.)	Test: USMT 508
Flow Rate	0.3 gal./ft. Y/minute (max.)	Test: MSMT 322
Filtration Efficiency	75% (min.)	Test: MSMT 322


U.S. DEPARTMENT OF AGRICULTURE SOIL CONSERVATION SERVICE PAGE H-2-2 MARYLAND DEPARTMENT OF ENVIRONMENT WATER MANAGEMENT ADMINISTRATION

SEQUENCE OF CONSTRUCTION


- OBTAIN GRADING PERMIT.
- INSTALL STABILIZED CONSTRUCTION ENTRANCE, SUPER SILT FENCE (2 DAYS)
- ROUGH GRADE SITE. (1 WEEK)
- AS SUBGRADE ELEVATIONS ARE ESTABLISHED, INSTALL STORM DRAINS WITH INLET PROTECTION, WATER AND SEWER UTILITIES. (2 WEEKS)
- INSTALL CURB AND GUTTER AND PAVE ROADWAYS. (10 DAYS)
- FINE GRADE SITE, STABILIZE DISTURBED AREAS IN ACCORDANCE WITH PERMANENT SEEDING NOTES AS NECESSARY (10 DAYS)
- INSTALL STREET LIGHTS, LANDSCAPING, AND SIGNS AS REQUIRED. (5 DAYS)
- UPON APPROVAL OF THE HOWARD COUNTY DIMP SEDIMENT CONTROL INSPECTOR, REMOVE ALL SEDIMENT CONTROL DEVICES AND STABILIZE ALL REMAINING AREAS IN ACCORDANCE WITH THE PERMANENT SEEDING NOTES (1 DAYS)

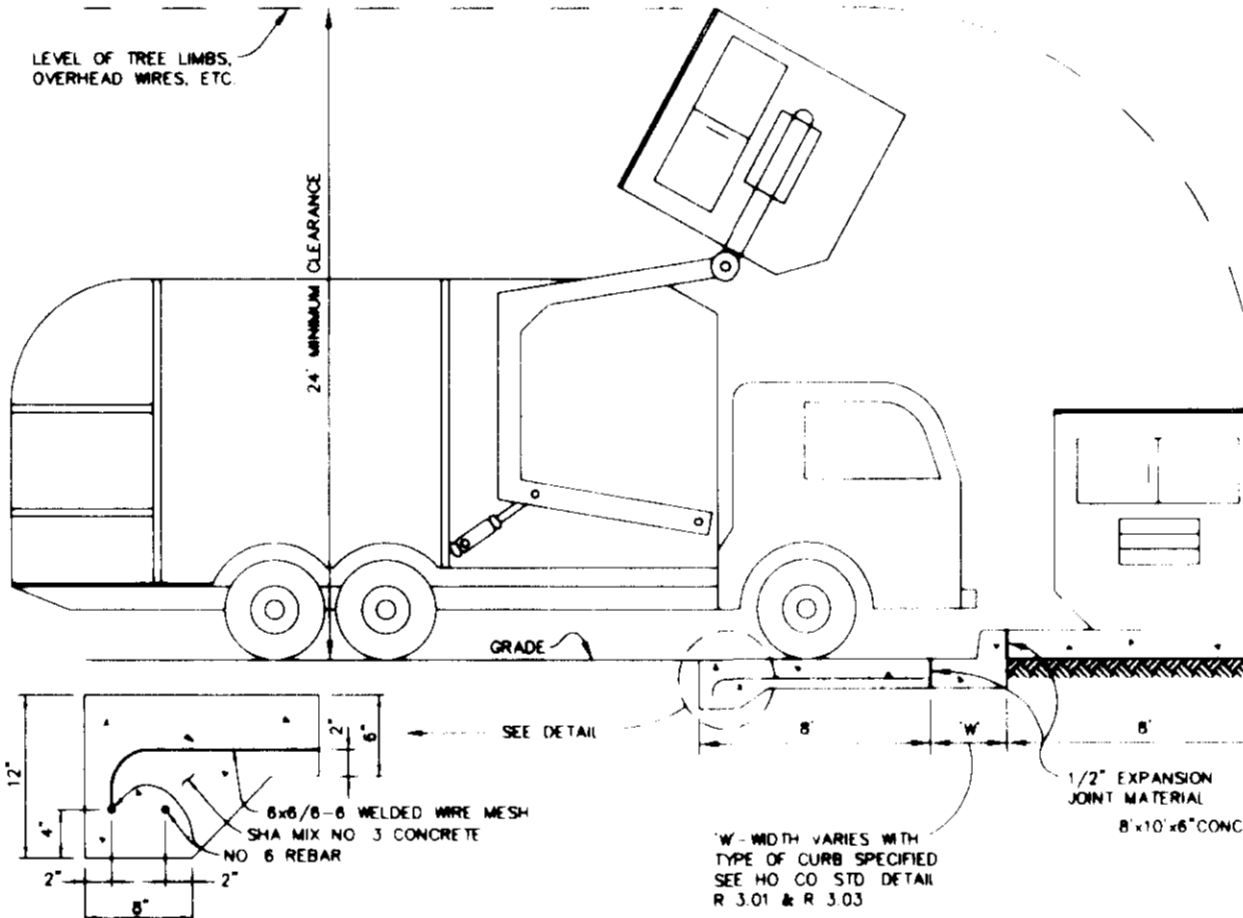


DUMPSTER PAD
NO SCALE

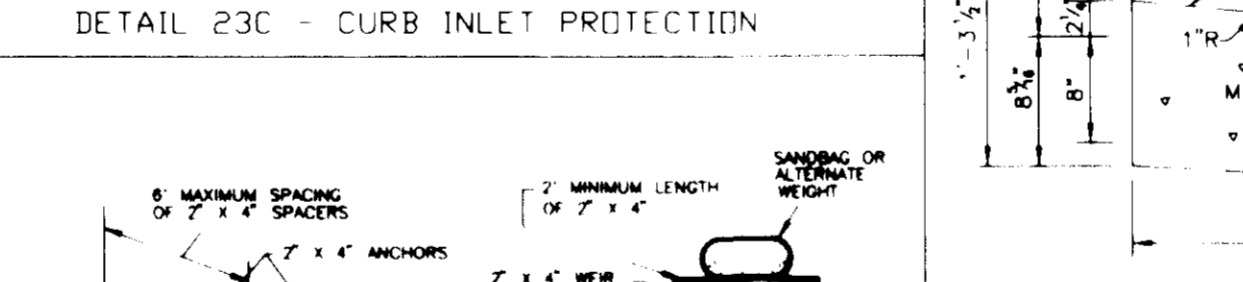


DETAIL 23C - CURB INLET PROTECTION

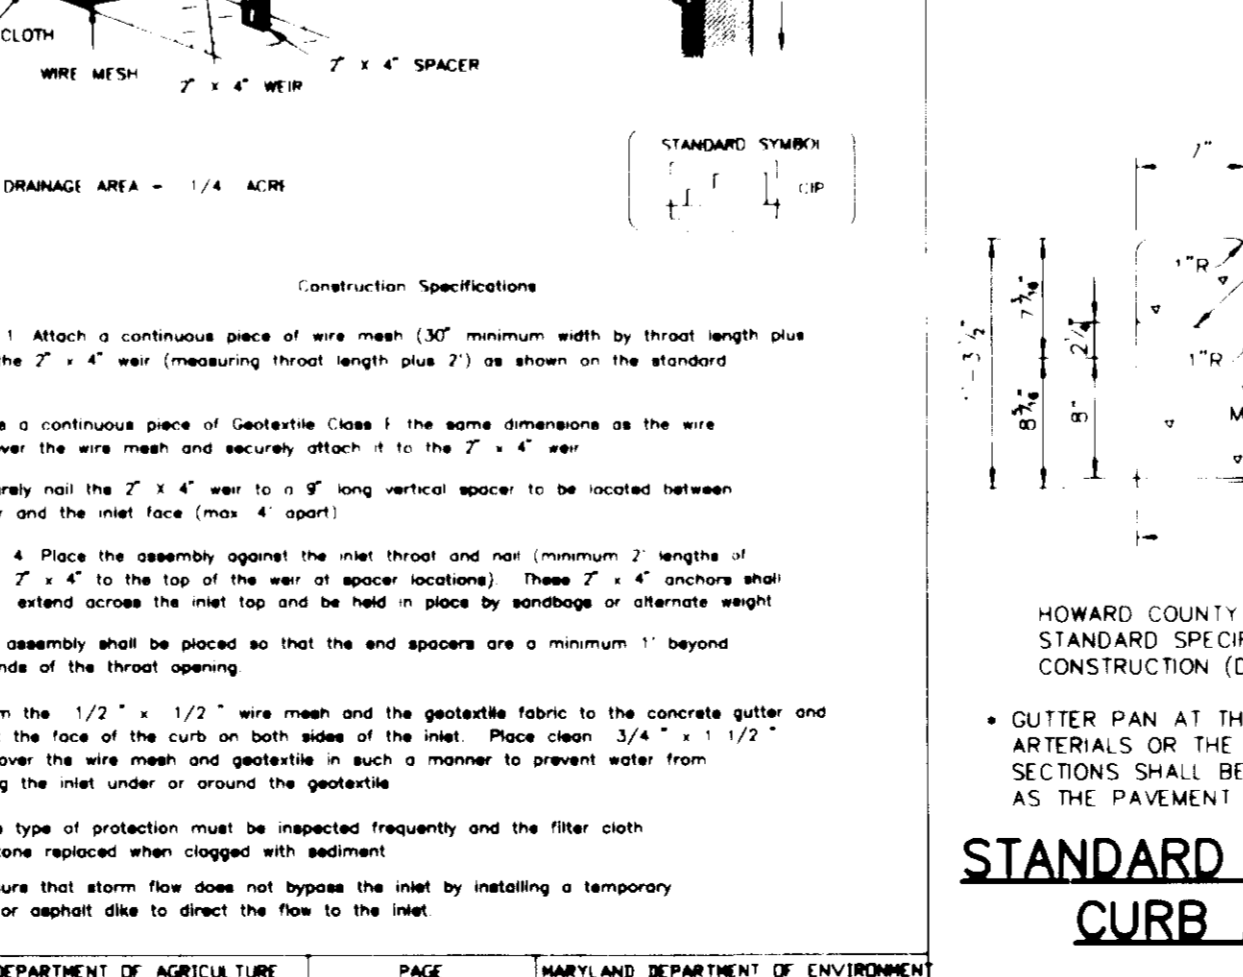


U.S. DEPARTMENT OF AGRICULTURE SOIL CONSERVATION SERVICE PAGE E-18-53 MARYLAND DEPARTMENT OF ENVIRONMENT WATER MANAGEMENT ADMINISTRATION

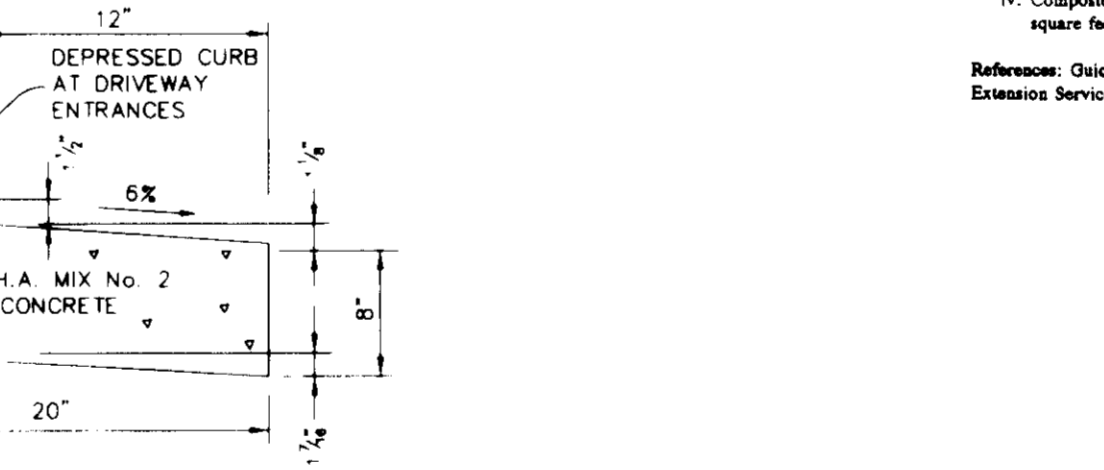

REVERSE 7\"/>

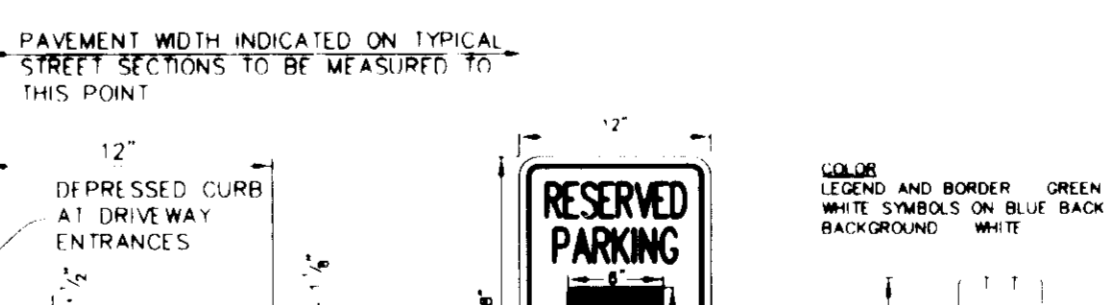

STANDARD 7\"/>

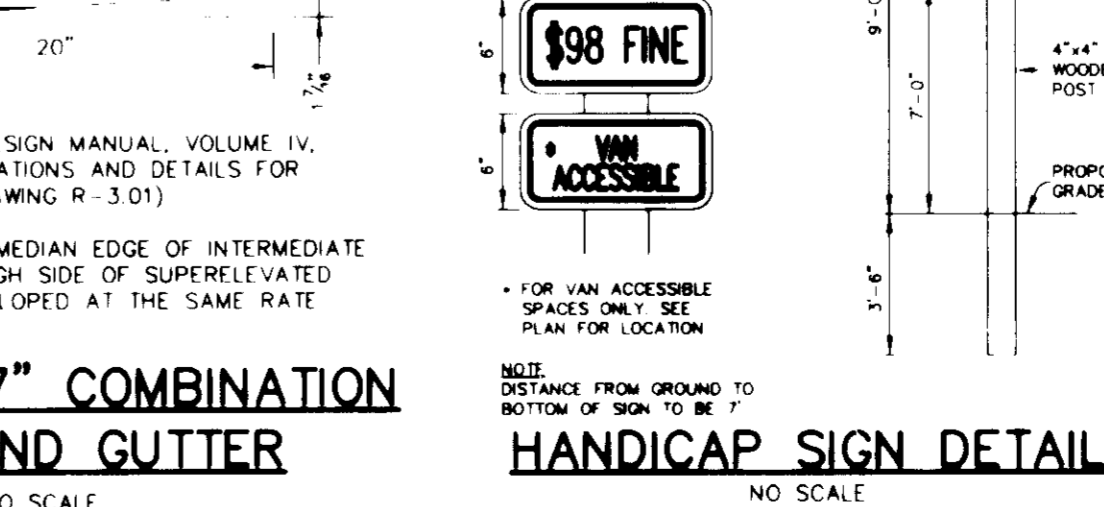

U.S. DEPARTMENT OF AGRICULTURE SOIL CONSERVATION SERVICE PAGE H-2-2 MARYLAND DEPARTMENT OF ENVIRONMENT WATER MANAGEMENT ADMINISTRATION

21.8 STANDARD AND SPECIFICATIONS FOR TOPSOIL

Definition
Placement of topsoil over a prepared subsoil prior to establishment of permanent vegetation.

Purpose
To provide a suitable soil medium for regenerative growth. Soil of concern have low moisture content, low nutrient levels, low pH, materials toxic to plants, and/or unacceptable soil gradation.

- Conditions Where Practice Applies**
- This practice is limited to areas having 2:1 or flatter slopes where:
 - The texture of the exposed subsoil/parent material is not adequate to produce vegetative growth.
 - The soil material is so shallow that the rooting zone is not deep enough to support plants or furnish containing supplies of moisture and plant nutrients.
 - The original soil to be vegetated contains material toxic to plant growth.
 - The soil is so acidic that treatment with limestone is not feasible.
 - For the purpose of these Standards and Specifications, areas having slopes steeper than 2:1 require special consideration and design for adequate stabilization. Areas having slopes steeper than 2:1 shall have the appropriate stabilization shown on the plans.

Construction and Material Specifications


- Topsoil salvaged from the existing site may be used provided that it meets the standards as set forth in these specifications. Typically, the depth of topsoil to be salvaged for a given soil type can be found in the representative soil profile section in the Soil Survey published by USDA-SCS in cooperation with Maryland Agricultural Experiment Stations.
- Topsoil Specifications - Soil to be used as topsoil must meet the following:
 - Topsoil shall be a loam, sandy loam, clay loam, silt loam, sandy clay loam, loamy sand. Other soils may be used if recommended by an agronomist or soil scientist and approved by the appropriate approval authority. Regardless, topsoil shall not be a mixture of contrasting textured subsoils and shall contain less than 1% by volume of coarse, stony, slag, coarse fragments, gravel, sticks, roots, trash, or other materials larger than 1 1/4" in diameter.
 - Topsoil must be free of plants or plant parts such as Bermuda grass, quackgrass, Johnsongrass, weeds, poison ivy, thistle, or others as specified.
 - Where the subsoil is either highly acidic or composed of heavy clays, ground limestone shall be spread at the rate of 4-8 tons/1000-2000 pounds per 1,000 square feet prior to the placement of topsoil. Lime shall be distributed uniformly over designated areas and worked into the soil in conjunction with tillage operations as described in the following procedure.
- For sites having disturbed areas under 5 acres:
 - Place topsoil (if required) and apply soil amendments as specified in 20.0 Vegetative Stabilization - Section 1 - Vegetative Stabilization Methods and Materials.
- For sites having disturbed areas over 5 acres:
 - On soil meeting Topsoil specifications, obtain test results dictating fertilizer and lime amendments required to bring the soil into compliance with the following:
 - pH for topsoil shall be between 6.0 and 7.5. If the tested soil demonstrates a pH of less than 6.0, sufficient lime shall be prescribed to raise the pH to 6.5 or higher.
 - Organic content of topsoil shall be not less than 1.5 percent by weight.
 - Topsoil having soluble salt content greater than 500 parts per million shall not be used.
 - No sod or seed shall be placed on soil which has been treated with soil sterilants or chemical used for weed control until sufficient time has elapsed (14 days min.) to permit dissipation of phytotoxic materials.
 - Place topsoil (if required) and apply soil amendments as specified in 20.0 Vegetative Stabilization - Section 1 - Vegetative Stabilization Methods and Materials.

Note: Topsoil substitutes or amendments, as recommended by a qualified agronomist or soil scientist approved by the appropriate approval authority, may be used in lieu of native topsoil.


V. Topsoil Application

- When topsoiling, maintain needed erosion and sediment control practices such as diversions, Grade Stabilization Structures, Earth Dikes, Slope Silt Fence and Sediment Traps and Basins.
- Grades on the areas to be topsoiled, which have been previously established, shall be maintained, albeit 4" - 8" higher in elevation.
- Topsoil shall be uniformly distributed in a 4" - 8" layer and lightly compacted to a minimum thickness of 4". Spreading shall be performed in such a manner that sodding or seeding can proceed with a minimum of additional soil preparation and tillage. Any irregularities in the surface resulting from topsoiling or other operations shall be corrected in order to prevent the formation of depressions or water pockets.
- Topsoil shall not be placed while the topsoil or subsoil is in a frozen or muddy condition, when the subsoil is excessively wet or in a condition that may otherwise be detrimental to proper germination and seedling emergence.
- Alternative for Permanent Seeding - Instead of applying the full amount of lime and commercial fertilizer, composted sludge and amendments may be applied as specified below:
 - Composted Sludge Material for use as a soil conditioner for sites having disturbed areas over 5 acres shall be used to prescribe amendments and for sites having disturbed areas under 5 acres shall conform to the following requirements:
 - Composted sludge shall be supplied by, or originate from, a person or persons that are permitted (at the time of acquisition of the compost) by the Maryland Department of the Environment under COMAR 26.06.06.
 - Composted sludge shall contain at least 1 percent nitrogen, 1.5 percent phosphorus, and 0.2 percent potassium and have a pH of 7.0 to 8.0. If compost does not meet these requirements, the appropriate constituents must be added to meet the requirements prior to use.
 - Composted sludge shall be applied at a rate of 1 ton/1,000 square feet.
 - Composted sludge shall be amended with a potassium fertilizer applied at the rate of 4 lbs./1,000 square feet, and 1/3 the normal lime application rate.


References: Outline Specifications, Soil Preparation and Soiling, MD-VA, Pub. #1, Cooperative Extension Service, University of Maryland and Virginia Polytechnic Institutes, Revised 1973.

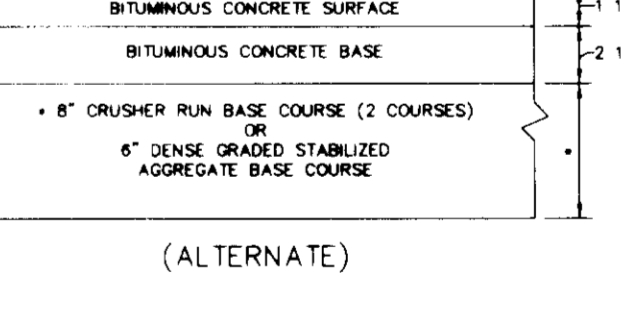

P-2 PAVING
NO SCALE

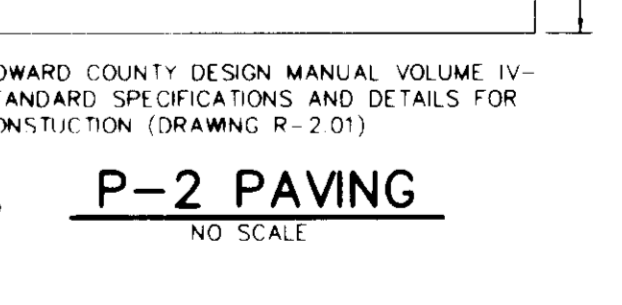

SIDEWALK DETAIL
NO SCALE

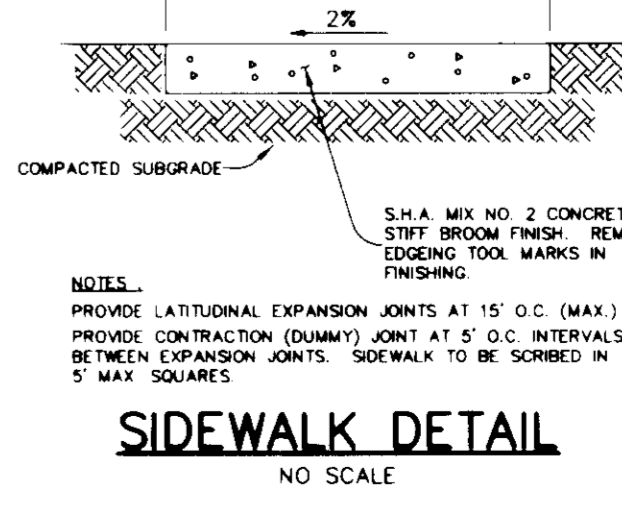

U.S. DEPARTMENT OF AGRICULTURE SOIL CONSERVATION SERVICE PAGE H-2-2 MARYLAND DEPARTMENT OF ENVIRONMENT WATER MANAGEMENT ADMINISTRATION

BY THE DEVELOPER:
I/WE CERTIFY THAT ALL DEVELOPMENT AND CONSTRUCTION WILL BE DONE ACCORDING TO THIS PLAN, AND THAT ANY RESPONSIBLE PERSONNEL INVOLVED IN THE CONSTRUCTION PROJECT WILL HAVE A CERTIFICATE OF ATTENDANCE AT A DEPARTMENT OF THE ENVIRONMENT APPROVED TRAINING PROGRAM FOR THE CONTROL OF SEDIMENT AND EROSION BEFORE BEGINNING THE PROJECT. I ALSO AUTHORIZE PERIODIC ON-SITE INSPECTIONS BY THE HOWARD SOIL CONSERVATION DISTRICT.

James Butler
DEVELOPER 10.9.96
DATE

BY THE ENGINEER:
I CERTIFY THAT THIS PLAN FOR EROSION AND SEDIMENT CONTROL REPRESENTS A PRACTICAL AND WORKABLE PLAN BASED ON MY PERSONAL KNOWLEDGE OF THE SITE CONDITIONS AND THAT IT WAS PREPARED IN ACCORDANCE WITH THE REQUIREMENTS OF THE HOWARD SOIL CONSERVATION DISTRICT.

J. Parekh
ENGINEER 10.10.96
DATE

THESE PLANS HAVE BEEN REVIEWED FOR THE HOWARD SOIL CONSERVATION DISTRICT AND MEET THE TECHNICAL REQUIREMENTS FOR SOIL EROSION AND SEDIMENT CONTROL.

J. E. Warfield
NATURAL RESOURCES CONSERVATION SERVICE 10/5/96
DATE

THIS DEVELOPMENT PLAN IS APPROVED FOR SOIL EROSION AND SEDIMENT CONTROL BY THE HOWARD SOIL CONSERVATION DISTRICT.

John R. Poretsky
HOWARD SOIL CONSERVATION DISTRICT 11/15/96
DATE

APPROVED: FOR PUBLIC WATER AND PUBLIC SEWERAGE SYSTEMS, HOWARD COUNTY HEALTH DEPARTMENT.


James Butler
COUNTY HEALTH OFFICER 10/23/96
DATE

APPROVED: HOWARD COUNTY DEPARTMENT OF PLANNING AND ZONING.

James Butler
DIRECTOR 10/23/96
DATE

John R. Poretsky
CHIEF, DEVELOPMENT ENGINEERING DIVISION 10/23/96
DATE

John R. Poretsky
ASST. DIVISION OF LAND DEVELOPMENT AND RESEARCH 10/23/96
DATE

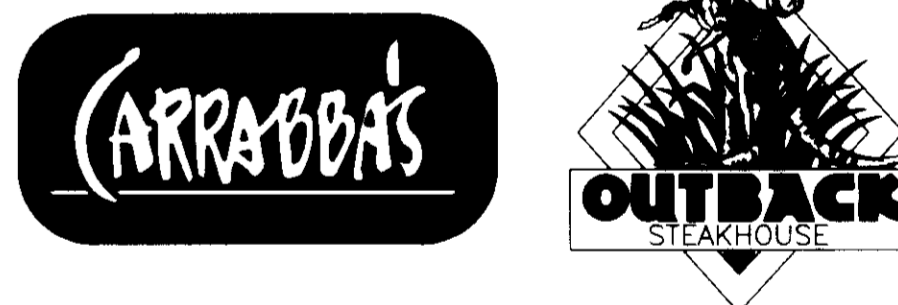

DATE	NO.	REVISION

OWNER	DEVELOPER
OPUS EAST, L.L.C. 6707 DEMOCRACY BLVD. SUITE 510 BETHESDA, MD 20817 (301) 443-4464	OUTBACK STEAKHOUSE 550 NORTH REO ST. SUITE 200 TAMPA, FL 33604 (813) 282-1225

PROJECT OUTBACK STEAKHOUSE/
CARRABBA'S
TWO RESTAURANT BUILDINGS

AREA TAX MAPS 24 & 30 PARCELS J1K
2nd ELECTION DISTRICT
HOWARD COUNTY, MARYLAND

TITLE NOTES AND DETAILS

RIEMER MUEGGE & ASSOCIATES, INC.
ENGINEERING • ENVIRONMENTAL SERVICES • PLANNING • SURVEYING
8818 Centre Park Drive, Columbia, Maryland 21045
tel 410.997.8900 fax 410.997.9282

10.10.96
DATE


DESIGNED BY: CJR

DRAWN BY: RPP/DAM

PROJECT NO: HCS096E4701
G-5 DWG

DATE: OCTOBER 10, 1996
SCALE: AS SHOWN
DRAWING NO. 5 OF 6

SOP-07-020

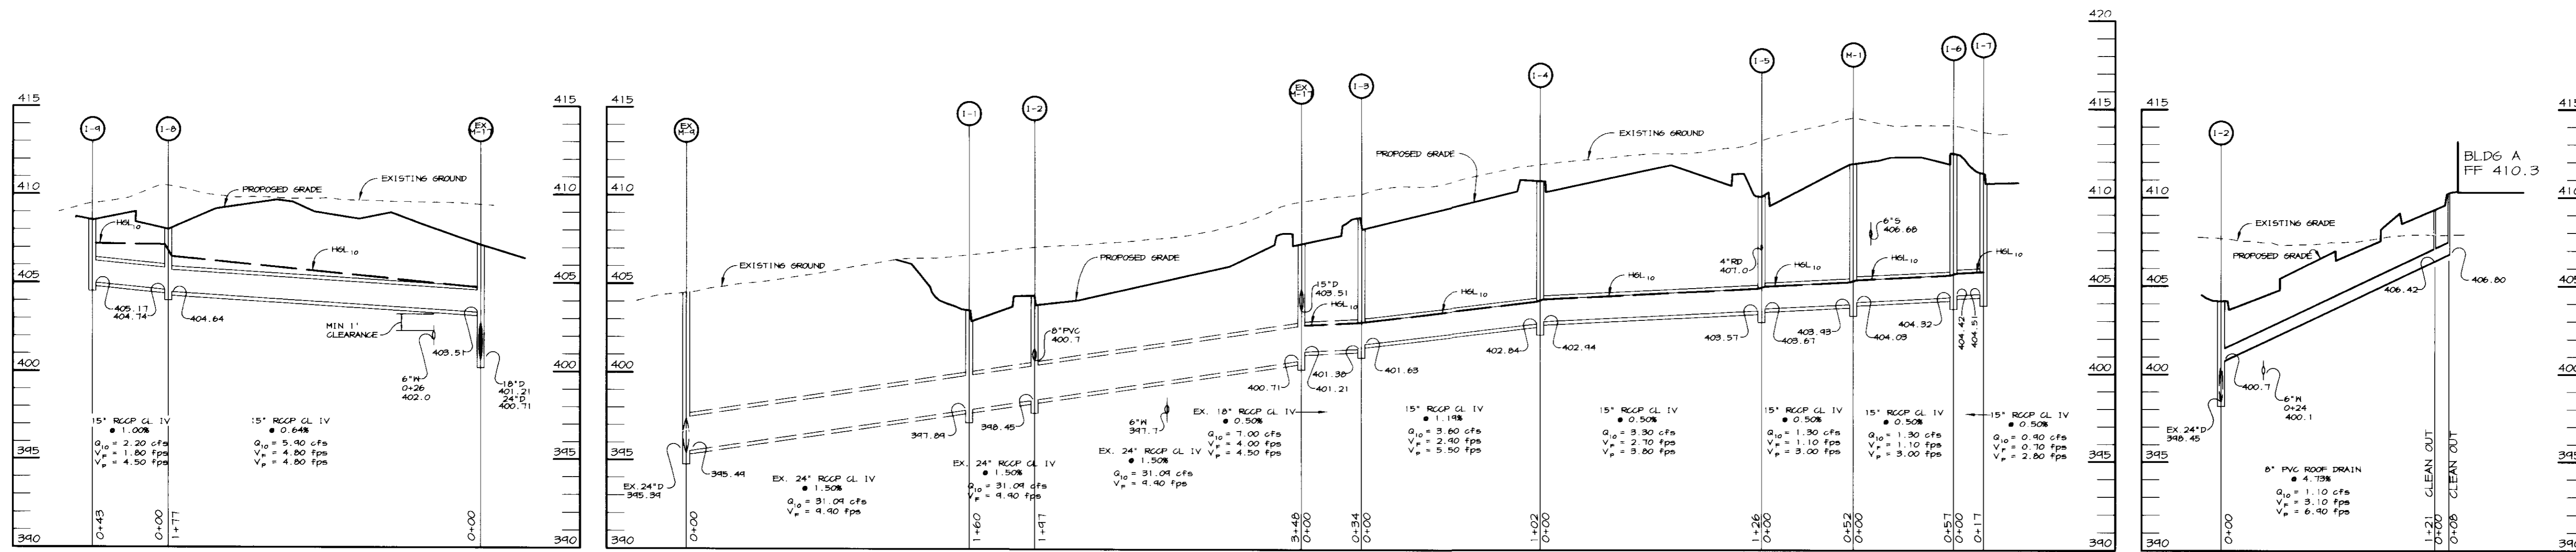

STORM DRAIN PROFILE


SCALE:
HOR. - 1"=50'
VERT. - 1"=5'

STORM DRAIN PROFILE

SCALE:
HOR. - 1"=50'
VERT. - 1"=5'


STORM DRAIN PROFILE

SCALE:
HOR. - 1"=50'
VERT. - 1"=5'

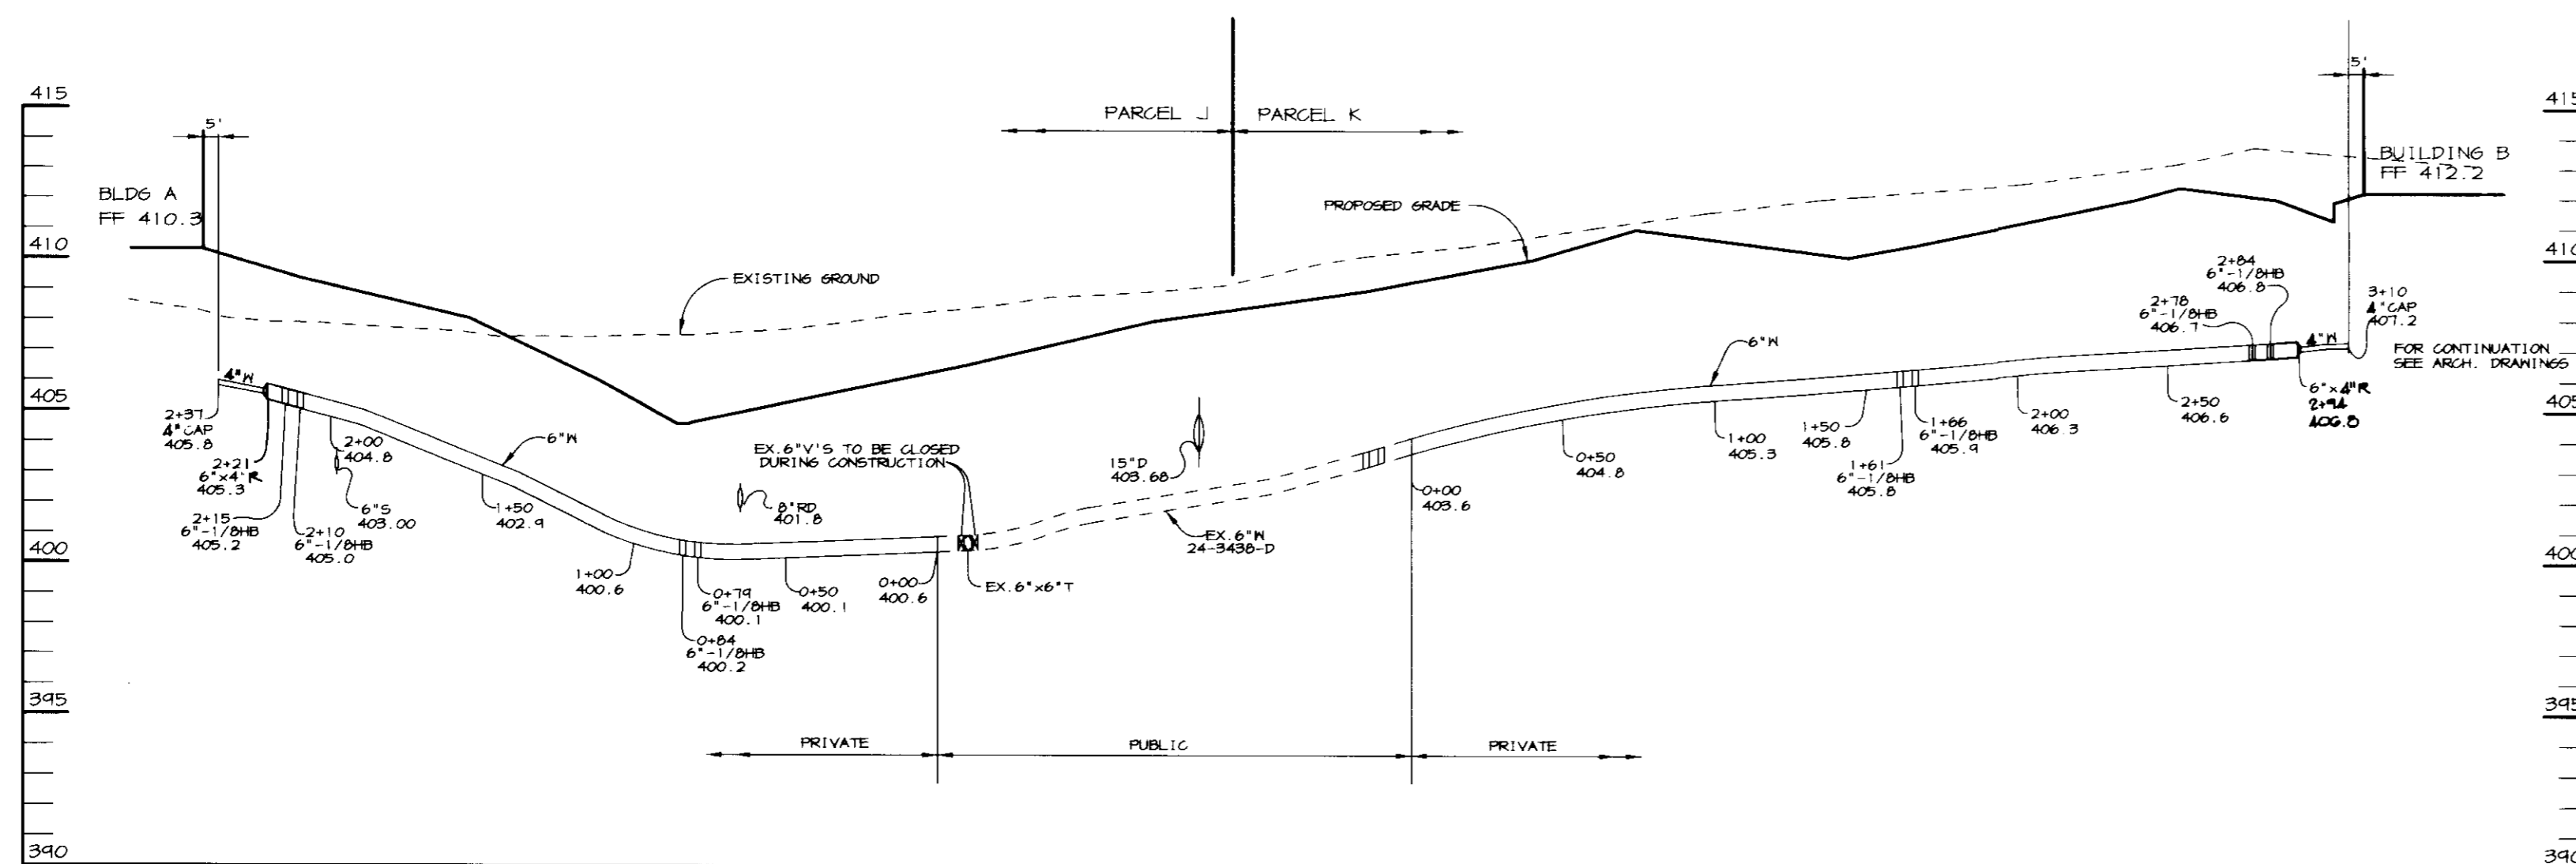


WATER PROFILE

SCALE:
HOR. - 1"=50'
VERT. - 1"=5'

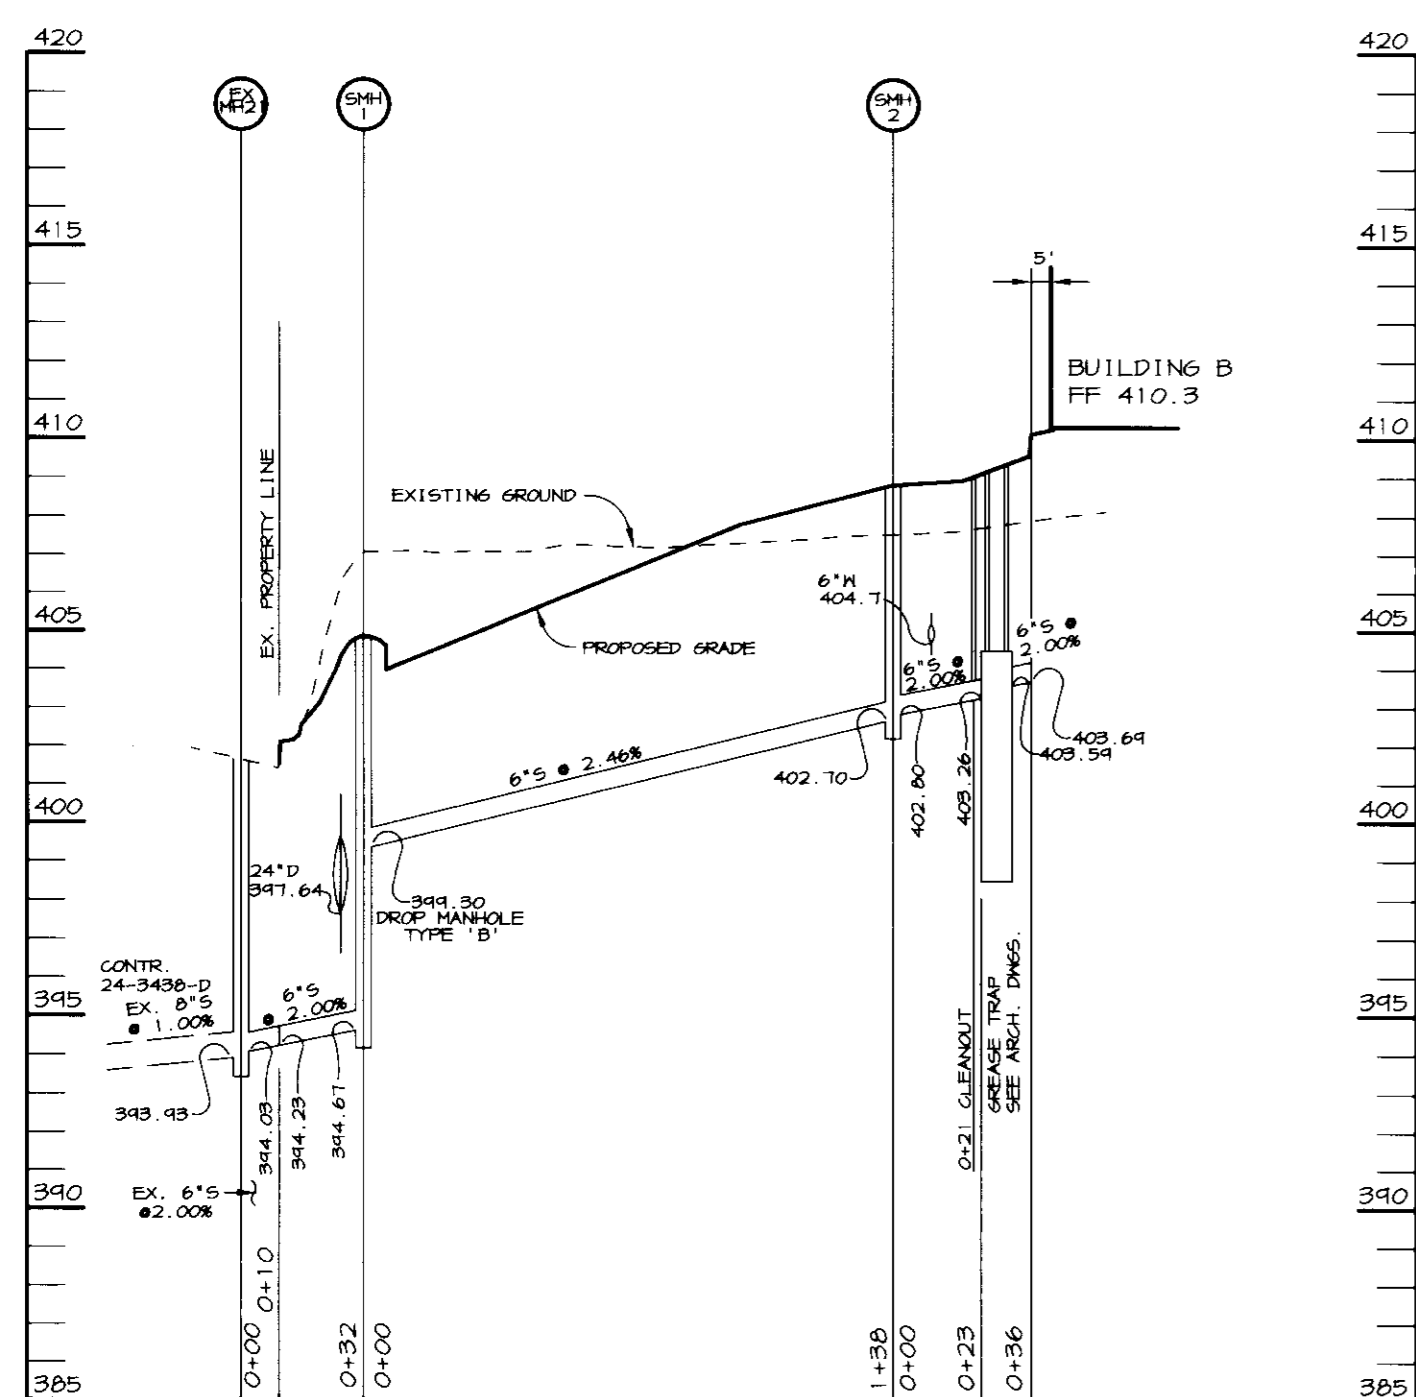

SEWER PROFILE

SCALE:
HOR. - 1"=50'
VERT. - 1"=5'

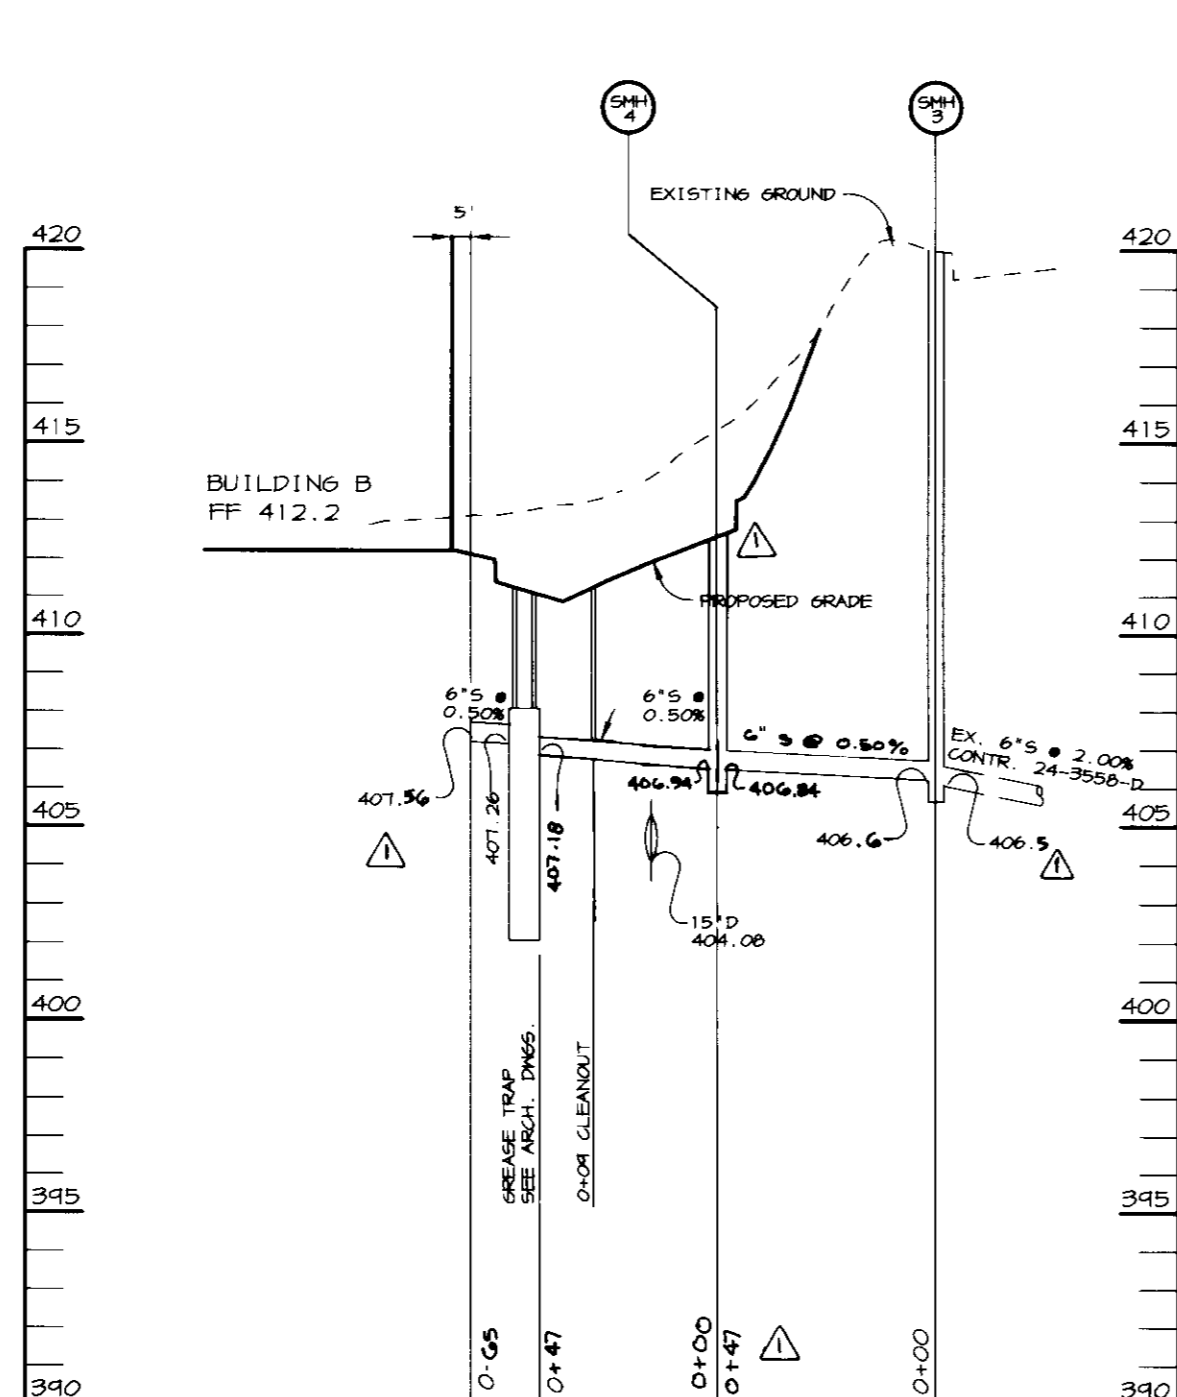

SEWER PROFILE

SCALE:
HOR. - 1"=50'
VERT. - 1"=5'

STORM DRAIN STRUCTURE SCHEDULE

NO.	TYPE	LOCATION	INV. IN	INV. OUT	TOP ELEV.	REMARKS
1-1	A-5	SEE PLAN	-	397.89	403.4	HOGO STD. DETAIL SD 4.01
1-2	A-5	SEE PLAN	-	398.45	404.3	HOGO STD. DETAIL SD 4.01
1-3	A-5	SEE PLAN	401.63	401.30	408.6	HOGO STD. DETAIL SD 4.01
1-4	A-5	SEE PLAN	402.94	402.84	410.6	HOGO STD. DETAIL SD 4.01
1-5	A-5	SEE PLAN	403.67	403.57	409.9	HOGO STD. DETAIL SD 4.01
1-6	A-5	SEE PLAN	404.42	404.32	412.3	HOGO STD. DETAIL SD 4.01
1-7	A-5	SEE PLAN	-	404.51	411.2	HOGO STD. DETAIL SD 4.01
1-8	S INLET W/ RET. GRATE	SEE PLAN	404.74	404.64	408.0*	HOGO STD. DETAILS SD 4.22, 4.93
1-4	A-5	SEE PLAN	-	405.17	408.4	HOGO STD. DETAIL SD 4.01
M-1	4" MH	SEE PLAN	404.03	403.93	411.7	HOGO STD. DETAIL SD 5.12

* DENOTES TOP OF GRATE ELEVATION

SANITARY SEWER STRUCTURE SCHEDULE

NO.	TYPE	LOCATION	INV. IN	INV. OUT	TOP ELEV.	REMARKS
SMH-1	4" MH	SEE PLAN	399.30	394.67	404.80	HOGO STD. DETAIL SD 5.12
SMH-2	4" MH	SEE PLAN	402.80	402.70	408.9	HOGO STD. DETAIL SD 5.12
SMH-3	4" MH	SEE PLAN	406.6	406.5	420.0	HOGO STD. DETAIL SD 5.12
SMH-4	4" MH	SEE PLAN	406.94	406.84	411.75	HOGO STD. DETAIL SD 5.12

APPROVED: FOR PUBLIC WATER AND PUBLIC SEWERAGE SYSTEMS, HOWARD COUNTY HEALTH DEPARTMENT.


COUNTY HEALTH OFFICER: *[Signature]* DATE: 10/23/96

APPROVED: HOWARD COUNTY DEPARTMENT OF PLANNING AND ZONING.

DIRECTOR: *[Signature]* DATE: 10/17/96

CHIEF, DEVELOPMENT ENGINEERING DIVISION: *[Signature]* DATE: 10/23/96

CHIEF, DIVISION OF LAND DEVELOPMENT AND RESEARCH: *[Signature]* DATE: 10/23/96

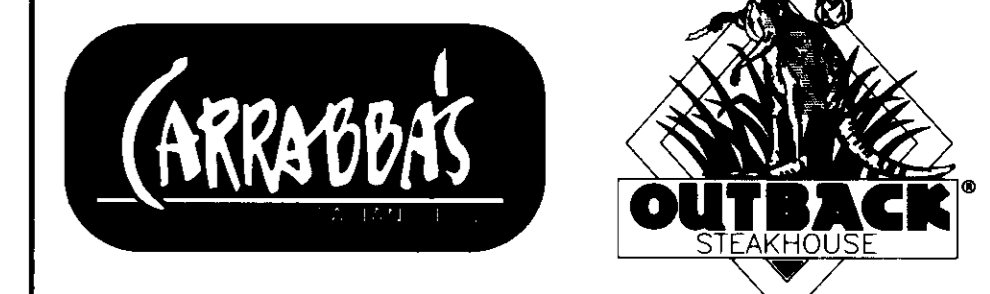

12.13.96 MODIFIED SEWER PROFILE SAN SEWER STRUC. SCHED TO REFLECT RELOC. OF SMH'S 3 & 4.

DATE NO. REVISION

OWNER: OPUS EAST, L.L.C. 6707 DEMOCRACY BLVD. SUITE 510 BETHESDA, MD 20817 (301) 493-4464
DEVELOPER: OUTBACK STEAKHOUSE 550 NORTH REO ST. SUITE 200 TAMPA, FL 33609 (813) 282-1225

PROJECT: OUTBACK STEAKHOUSE/ CARRABBA'S TWO RESTAURANT BUILDINGS

AREA: TAX MAPS 24 & 30 PARCELS J&K 2nd ELECTION DISTRICT HOWARD COUNTY, MARYLAND

TITLE: PROFILES, NOTES, AND DETAILS

RIEMER MUEGGE & ASSOCIATES, INC. ENGINEERING • ENVIRONMENTAL SERVICES • PLANNING • SURVEYING 8818 Centre Park Drive, Columbia, Maryland 21045 tel 410.997.8900 fax 410.997.9282

DATE: 10.10.96


DESIGNED BY: C.J.R.

DRAWN BY: RPP/DAM

PROJECT NO.: HOCO96E4701 C-4.DWG

DATE: OCTOBER 10, 1996
SCALE: AS SHOWN
DRAWING NO. 4 OF 6

JAYKANT D. PAREKH #19148

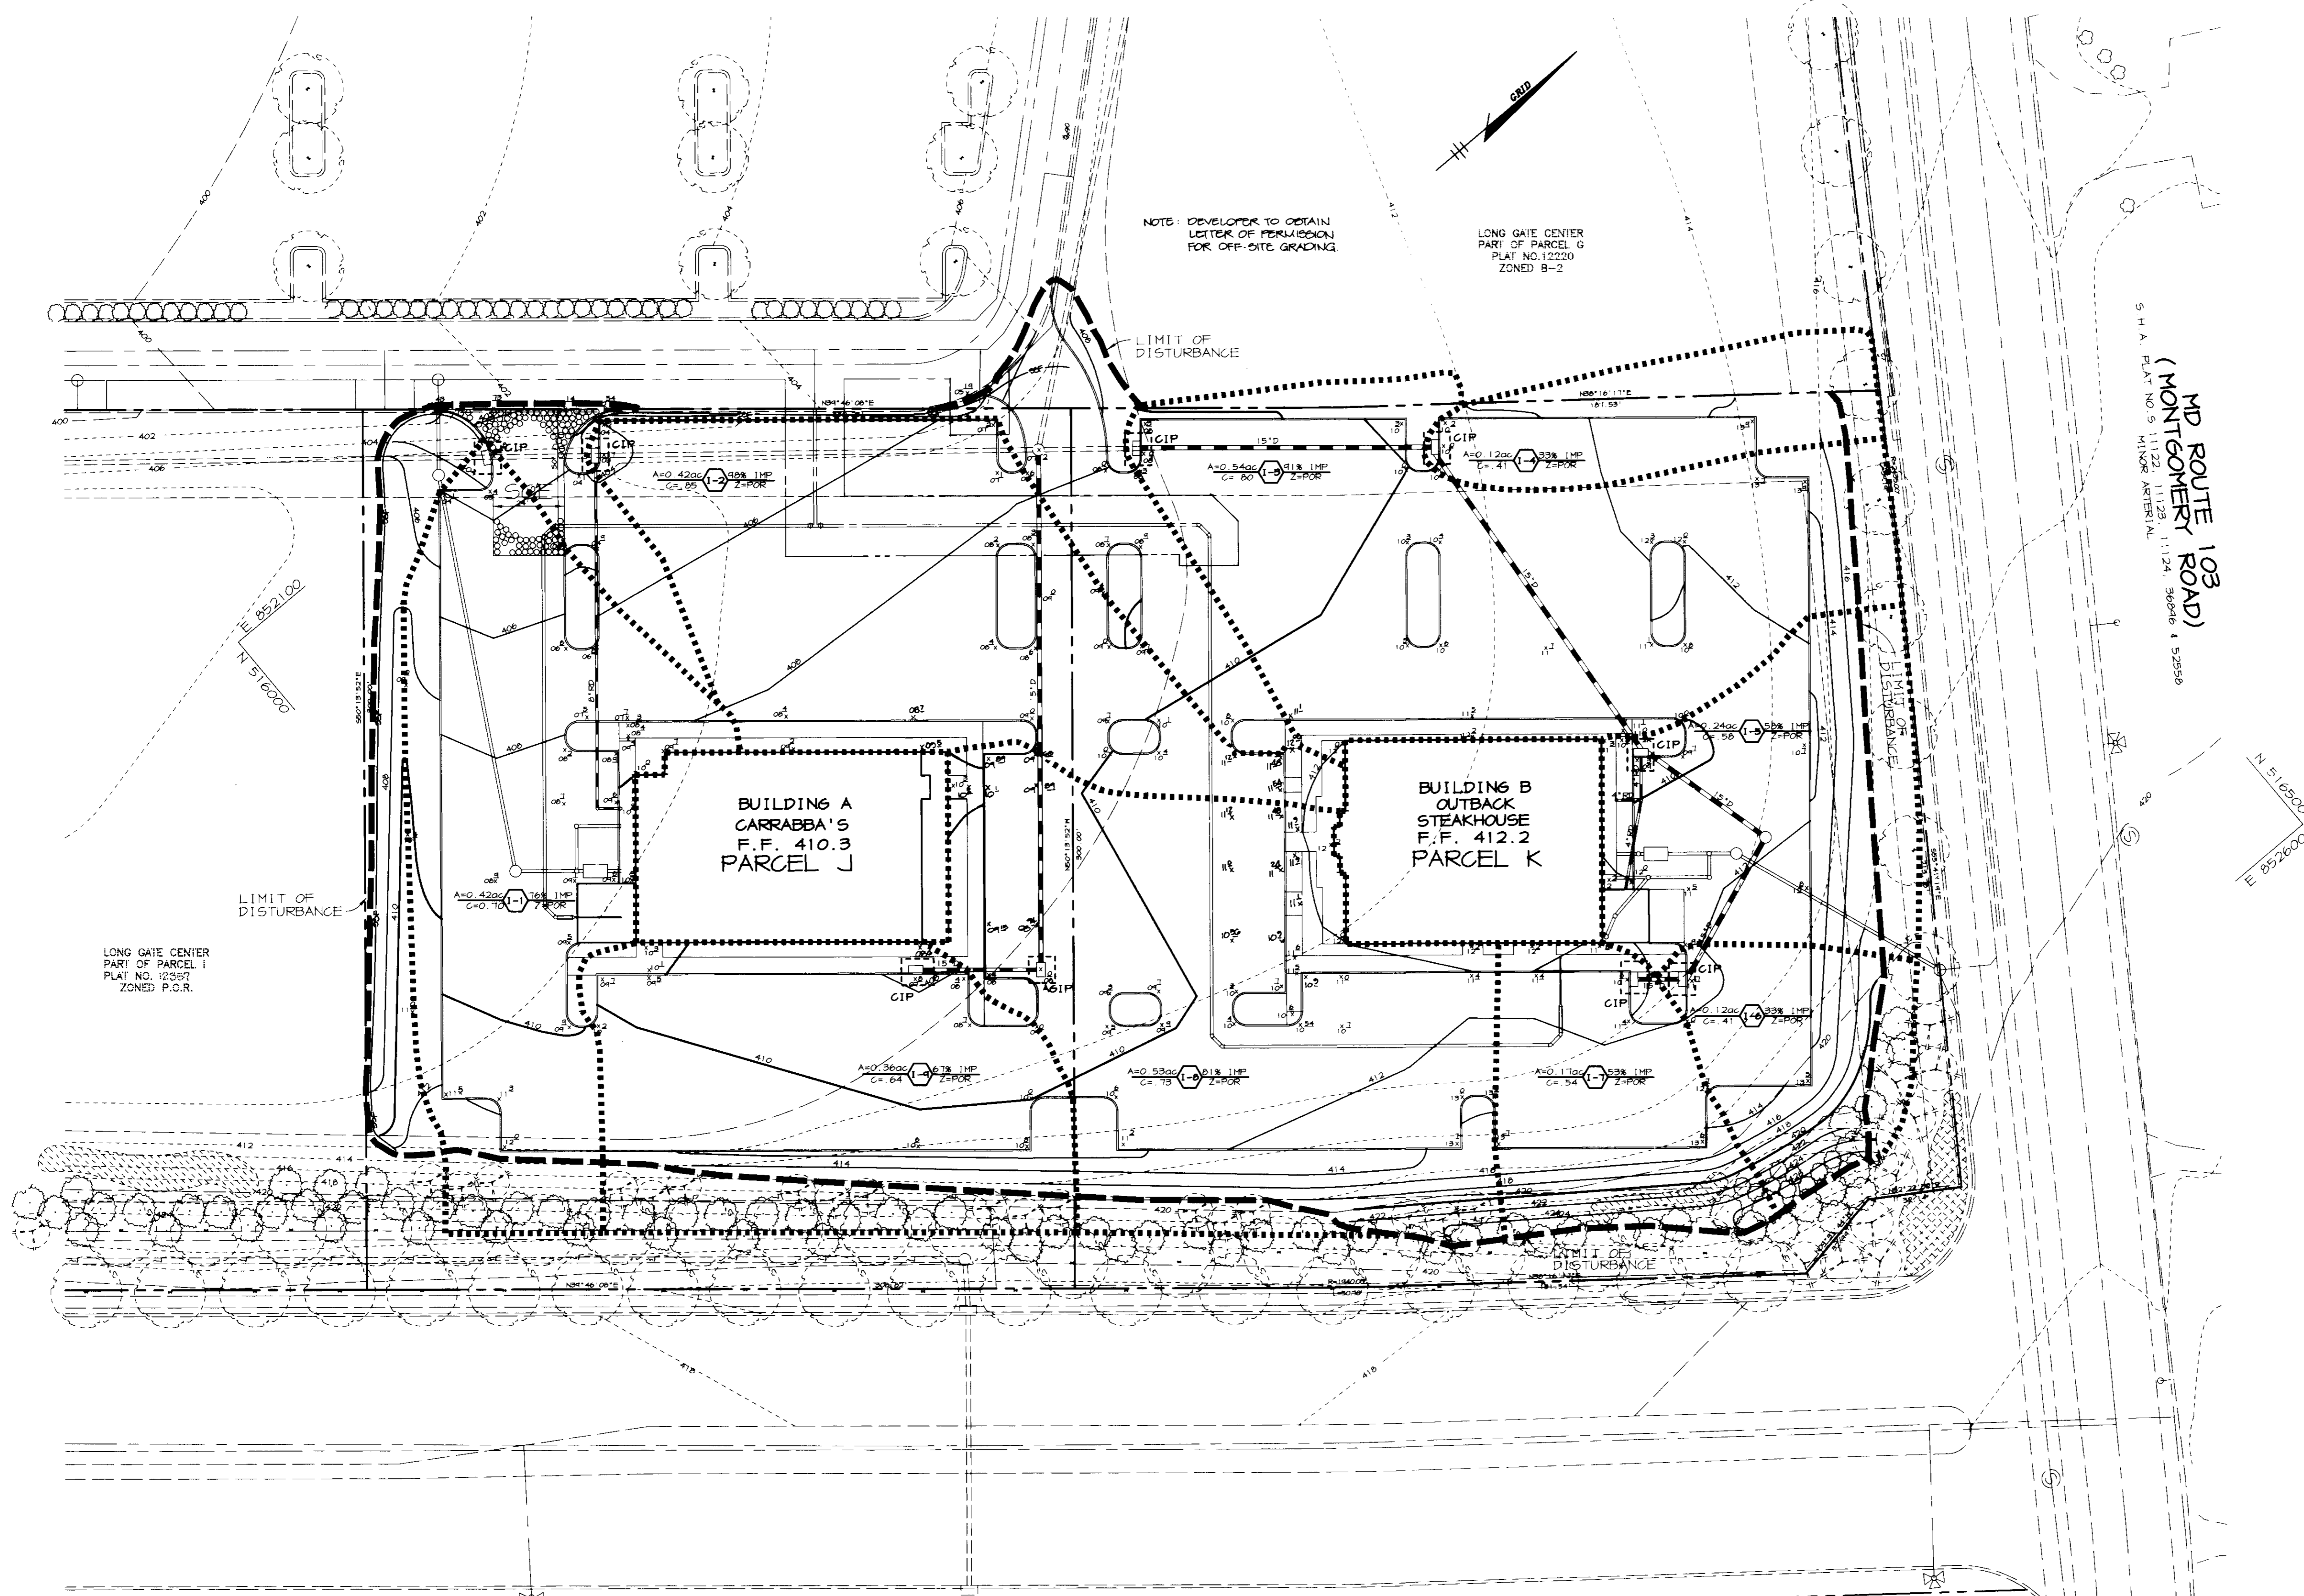

BY THE DEVELOPER :

I/WE CERTIFY THAT ALL DEVELOPMENT AND CONSTRUCTION WILL BE DONE ACCORDING TO THIS PLAN, AND THAT ANY RESPONSIBLE PERSONNEL INVOLVED IN THE CONSTRUCTION PROJECT WILL HAVE A CERTIFICATE OF ATTENDANCE AT A DEPARTMENT OF THE ENVIRONMENT APPROVED TRAINING PROGRAM FOR THE CONTROL OF SEDIMENT AND EROSION BEFORE BEGINNING THE PROJECT. I ALSO AUTHORIZE PERIODIC ON-SITE INSPECTIONS BY THE HOWARD SOIL CONSERVATION DISTRICT.

James Bitt 10.9.96
DEVELOPER DATE

BY THE ENGINEER :

I CERTIFY THAT THIS PLAN FOR EROSION AND SEDIMENT CONTROL REPRESENTS A PRACTICAL AND WORKABLE PLAN BASED ON MY PERSONAL KNOWLEDGE OF THE SITE CONDITIONS AND THAT IT WAS PREPARED IN ACCORDANCE WITH THE REQUIREMENTS OF THE HOWARD SOIL CONSERVATION DISTRICT.

J. Farrell 10.10.96
ENGINEER DATE

THESE PLANS HAVE BEEN REVIEWED FOR THE HOWARD SOIL CONSERVATION DISTRICT AND MEET THE TECHNICAL REQUIREMENTS FOR SOIL EROSION AND SEDIMENT CONTROL.

J. G. Washfield 10/15/96
NATURAL RESOURCES CONSERVATION SERVICE DATE

THIS DEVELOPMENT PLAN IS APPROVED FOR SOIL EROSION AND SEDIMENT CONTROL BY THE HOWARD SOIL CONSERVATION DISTRICT.

John R. Robertson 10/15/96
HOWARD SOIL CONSERVATION DISTRICT DATE

APPROVED : FOR PUBLIC WATER AND PUBLIC SEWERAGE SYSTEMS, HOWARD COUNTY HEALTH DEPARTMENT.

George N. ... 10/15/96
COUNTY HEALTH OFFICER DATE

APPROVED : HOWARD COUNTY DEPARTMENT OF PLANNING AND ZONING.

James R. ... 10/23/96
DIRECTOR DATE

Alan ... 10/17/96
CHIEF, DEVELOPMENT ENGINEERING DIVISION DATE

Richard ... 10/12/96
CHIEF, DIVISION OF LAND DEVELOPMENT AND RESEARCH DATE

CARRABBA'S

OUTBACK STEAKHOUSE

DATE	NO.	REVISION

OWNER	DEVELOPER
OPUS EAST, L.L.C. 6707 DEMOCRACY BLVD. SUITE 510 BETHESDA, MD 20817 (301) 443-4464	OUTBACK STEAKHOUSE 550 NORTH REO ST. SUITE 200 TAMPA, FL 33609 (813) 282-1225

PROJECT **OUTBACK STEAKHOUSE/ CARRABBA'S**
TWO RESTAURANT BUILDINGS

AREA TAX MAPS 24 & 30 PARCELS J&K
2nd ELECTION DISTRICT
HOWARD COUNTY, MARYLAND

TITLE **GRADING AND SEDIMENT CONTROL PLAN & DRAINAGE AREA MAP**

RIEMER MUEGGE & ASSOCIATES, INC.
ENGINEERING • ENVIRONMENTAL SERVICES • PLANNING • SURVEYING
8818 Centre Park Drive, Columbia, Maryland 21045
tel 410.997.8900 fax 410.997.9282

10.10.96
DATE

DESIGNED BY : CJR

DRAWN BY : RFP/DAM

PROJECT NO : HOCV46E4101
C-3.DWG

DATE : OCTOBER 10, 1996

SCALE : 1"=30'

DRAWING NO. 3 OF 6

J. Farrell
JAYKANT D. PAREKH #19148

SDP-07-020

LANDSCAPE SCHEDULES

SCHEDULE A * PERIMETER LANDSCAPE EDGE		
LANDSCAPE TYPE	ADJACENT TO	
	1	2
PERIMETER	E	E
LINEAR FEET OF ROADWAY FRONTAGE PERIMETER	± 545'	± 272'
CREDIT FOR EXISTING VEGETATION (YES, NO, LINEAR FEET) (DESCRIBE BELOW IF NEEDED)	NO	NO
CREDIT FOR WALL FENCE OR BERM (YES, NO, LINEAR FEET) (DESCRIBE BELOW IF NEEDED)	SEE NOTE #1 BELOW	SEE NOTE #2 BELOW
NUMBER OF PLANTS REQUIRED	# 1/4" ± 14	# 1/4" ± 7
SHADE TREES	0	0
EVERGREEN TREES	0	0
SHRUBS	4,000	0
SHALL-FLOWERING TREES	0	0


SUBSTITUTION NOTES:
PERIMETER LANDSCAPE EDGE, SCHEDULE A
PERIMETER 1:
 SUBSTITUTE (4) FLOWERING TREES FOR (2) SHADE TREES.
 TEN (10) SHADE TREES TO BE LOCATED IN ISLANDS ADJACENT TO BUILDINGS DUE TO THE DENSE BERM LANDSCAPING ALONG LONG GATE PARKWAY IN ACCORDANCE TO AGREEMENTS WITH ADJACENT NEIGHBORHOODS. LITTLE SPACE EXISTS TO ACCOMMODATE SHADE TREE REQUIREMENTS. IT IS APPROPRIATE TO MEET THE PERIMETER OBLIGATIONS WITH THE ISLAND PLANTINGS AS NEAR TO THIS PERIMETER AS POSSIBLE.

NOTES:
 #1 TOP OF BERM ± 4' HIGHER THAN LONG GATE PARKWAY ± 4' LOWER THAN LONG GATE PARKWAY ± 4' LOWER THAN TOP OF BERM ± USED AS SUBSTITUTION FOR REQUIRED SHRUBS.
 #2 PARKING LOT 'B' LOWER THAN MARYLAND ROUTE 103 - BERM USED AS SUBSTITUTION FOR REQUIRED SHRUBS.
 #3 THE REGULATIONS DO NOT REQUIRE LANDSCAPED EDGES BUFFERING OR SCREENING BETWEEN INTERNAL LOTS OR PARCELS WITHIN THE SAME DRIVEWAY OR PAVEMENT. (SEE PERIMETER LANDSCAPE EDGES ON P. 17 OF LANDSCAPE MANUAL)

SCHEDULE B PARKING LOT INTERNAL LANDSCAPING	
NUMBER OF PARKING SPACES	25
NUMBER OF SHADE TREES REQUIRED ± 18,000 SPACES	15
NUMBER OF TREES PROVIDED	0
SHADE TREES	0
OTHER TREES (2) SUBSTITUTION	0
NUMBER OF ISLANDS REQUIRED (1 ISLAND/20 SPACES)	15
NUMBER OF ISLANDS PROVIDED	17

NOTES: THIS PLAN HAS BEEN PREPARED IN ACCORDANCE WITH THE PROVISIONS OF SECTION 6.124 OF THE HOWARD COUNTY CODE AND THE LANDSCAPE MANUAL.
 FINANCIAL SURETY FOR THE REQUIRED LANDSCAPING HAS BEEN POSTED AS PART OF THE GRADING PERMIT IN THE AMOUNT OF \$5500.00

APPROVED: HOWARD COUNTY DEPARTMENT OF PLANNING AND ZONING.
 [Signature] 10/23/96
 DIRECTOR DATE
 [Signature] 10/17/96
 CHIEF, DEVELOPMENT ENGINEERING DIVISION DATE
 [Signature] 10/20/96
 CHIEF, DIVISION OF LAND DEVELOPMENT AND RESEARCH DATE

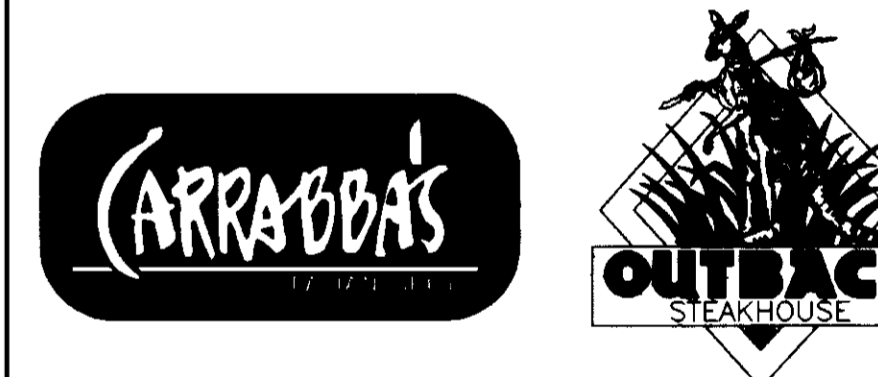

DATE	NO.	REVISION
OWNER	DEVELOPER	
OPUS EAST, L.L.C. 6707 DEMOCRACY BLVD. SUITE 510 BETHESDA, MD 20817 (301) 493-4464	OUTBACK STEAKHOUSE 550 NORTH REO ST. SUITE 200 TAMPA, FL 33609 (813) 282-1225	


PROJECT **OUTBACK STEAKHOUSE/ CARRABBA'S**
 TWO RESTAURANT BUILDINGS
 AREA TAX MAPS 24 & 30 PARCELS J&K
 2nd ELECTION DISTRICT
 HOWARD COUNTY, MARYLAND
 TITLE **LANDSCAPE PLAN**

RIEMER MUEGGE & ASSOCIATES, INC.
 ENGINEERING • ENVIRONMENTAL SERVICES • PLANNING • SURVEYING
 8818 Centre Park Drive, Columbia, Maryland 21045
 tel 410.997.8900 fax 410.997.9282


8-23-96
 DATE
 DESIGNED BY: CJR/LOH
 DRAWN BY: RPP/ML/CK
 PROJECT NO: H000\96E4701
 LSCP2.DWG
 DATE: OCTOBER 10, 1996
 SCALE: 1" = 30'
 DRAWING NO. 6 OF 6

KEY	QTY	BOTANICAL + COMMON NAME	SIZE	REMARKS
TREES				
AS	12	Acer saccharum 'Green Mountain'	2 1/2" - 3" Cal.	B & B
		Green Mountain Sugar Maple		
CR	4	Chionochloa reticulata	1 1/2" - 2" Cal.	B & B
		Chinese Fringetree		
QP	20	Quercus phellos	2 1/2" - 3" Cal.	B & B
		Willow Oak		

PLANTING DETAILS


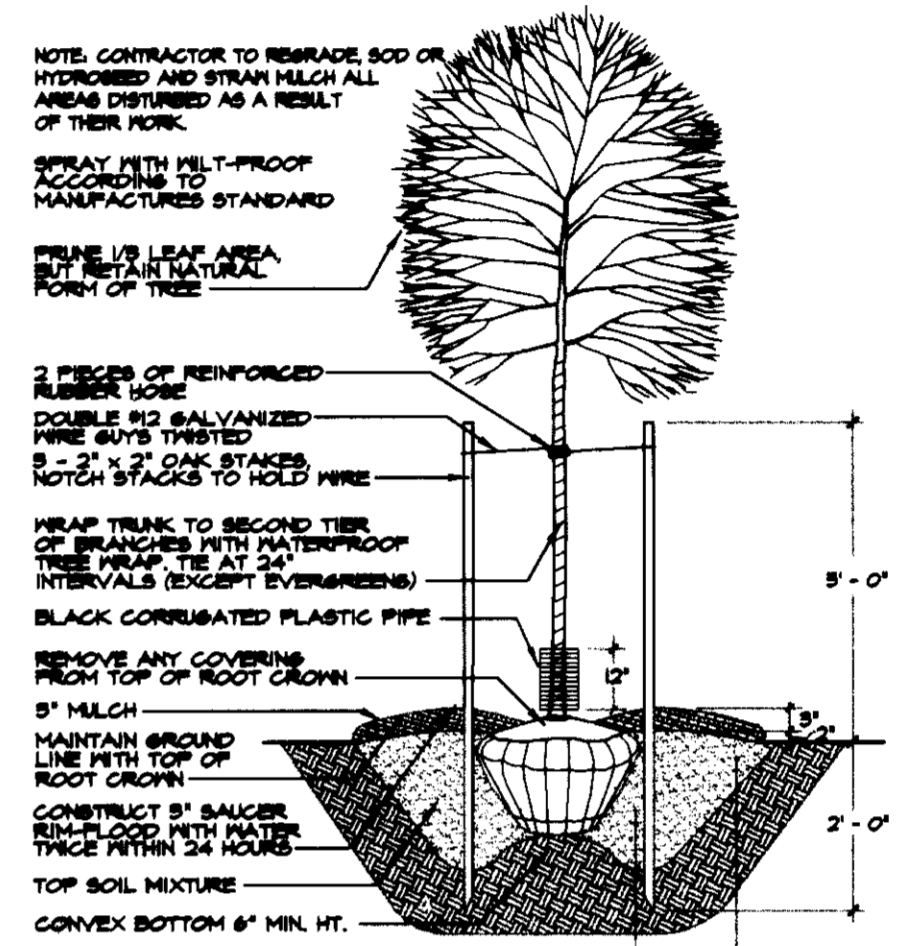


TREE PLANTING DETAIL
 NTS

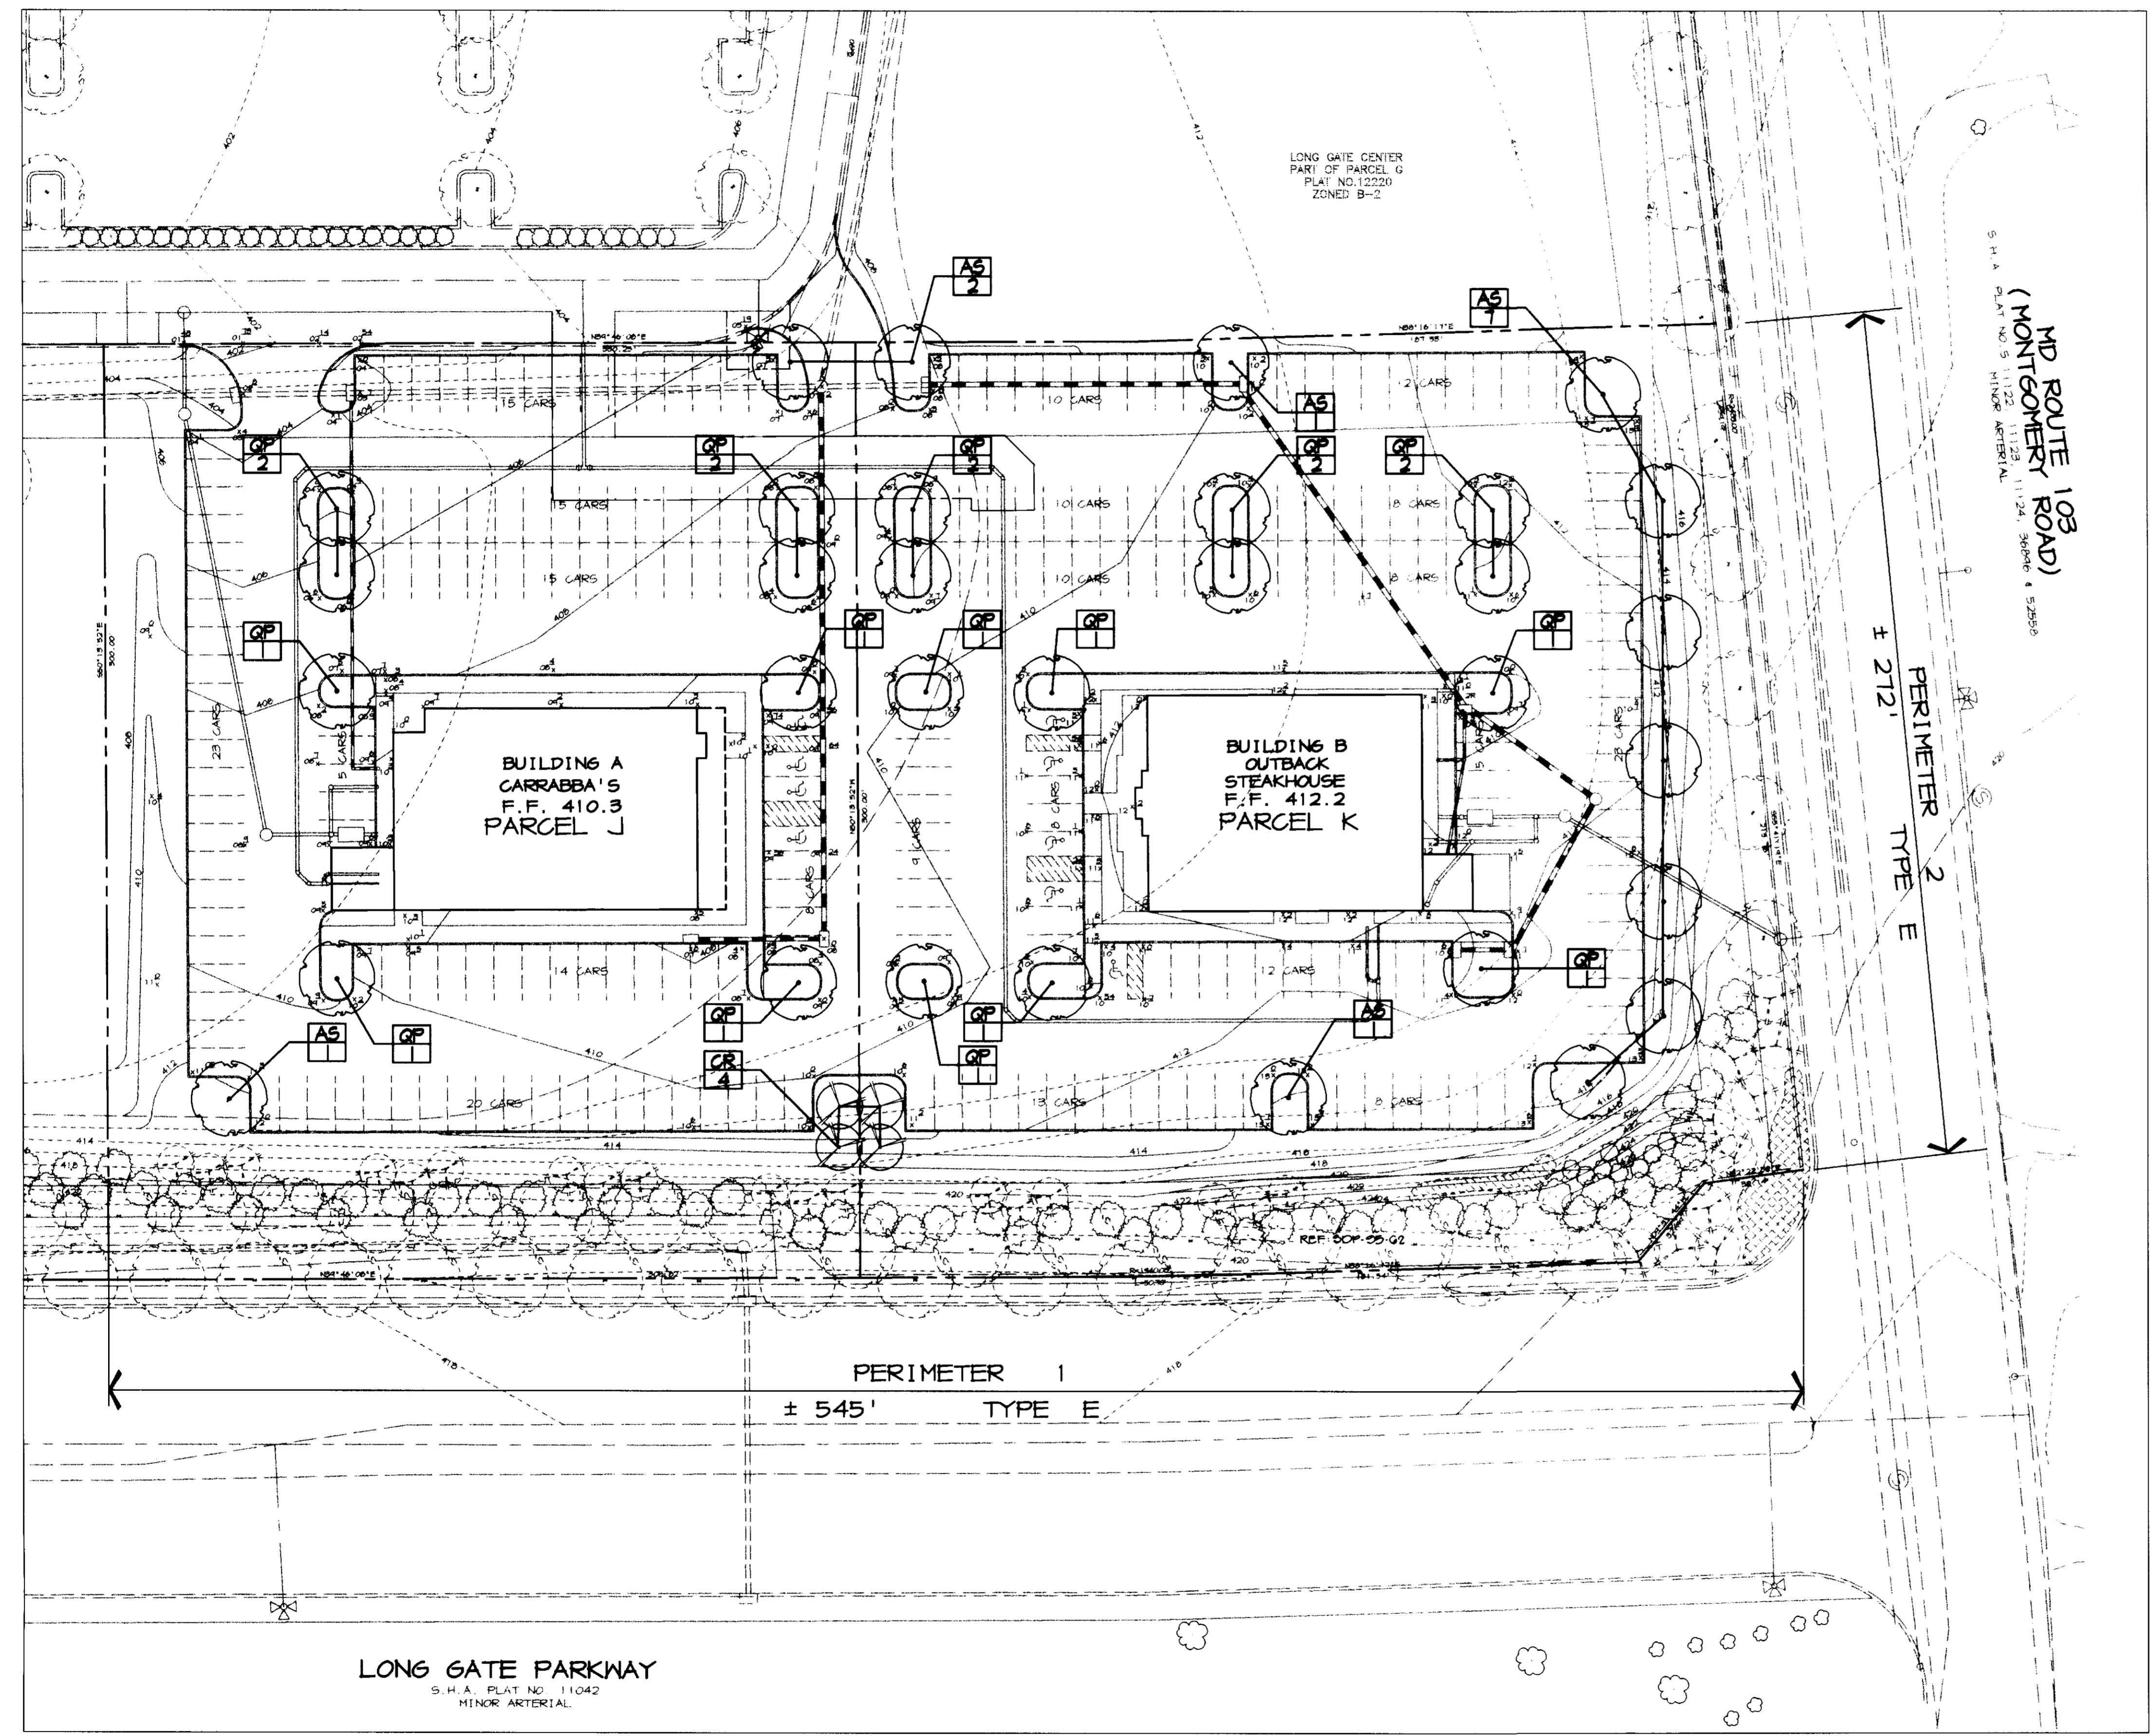

NOTE: THIS PLAN FOR LANDSCAPE PURPOSES ONLY.

GENERAL REFERENCE NOTE:
 FOR EXISTING TREE PLANTINGS ALONG BERM, ROUTE 103,
 AND LONG GATE PARKWAY SEE SDP-95-62.

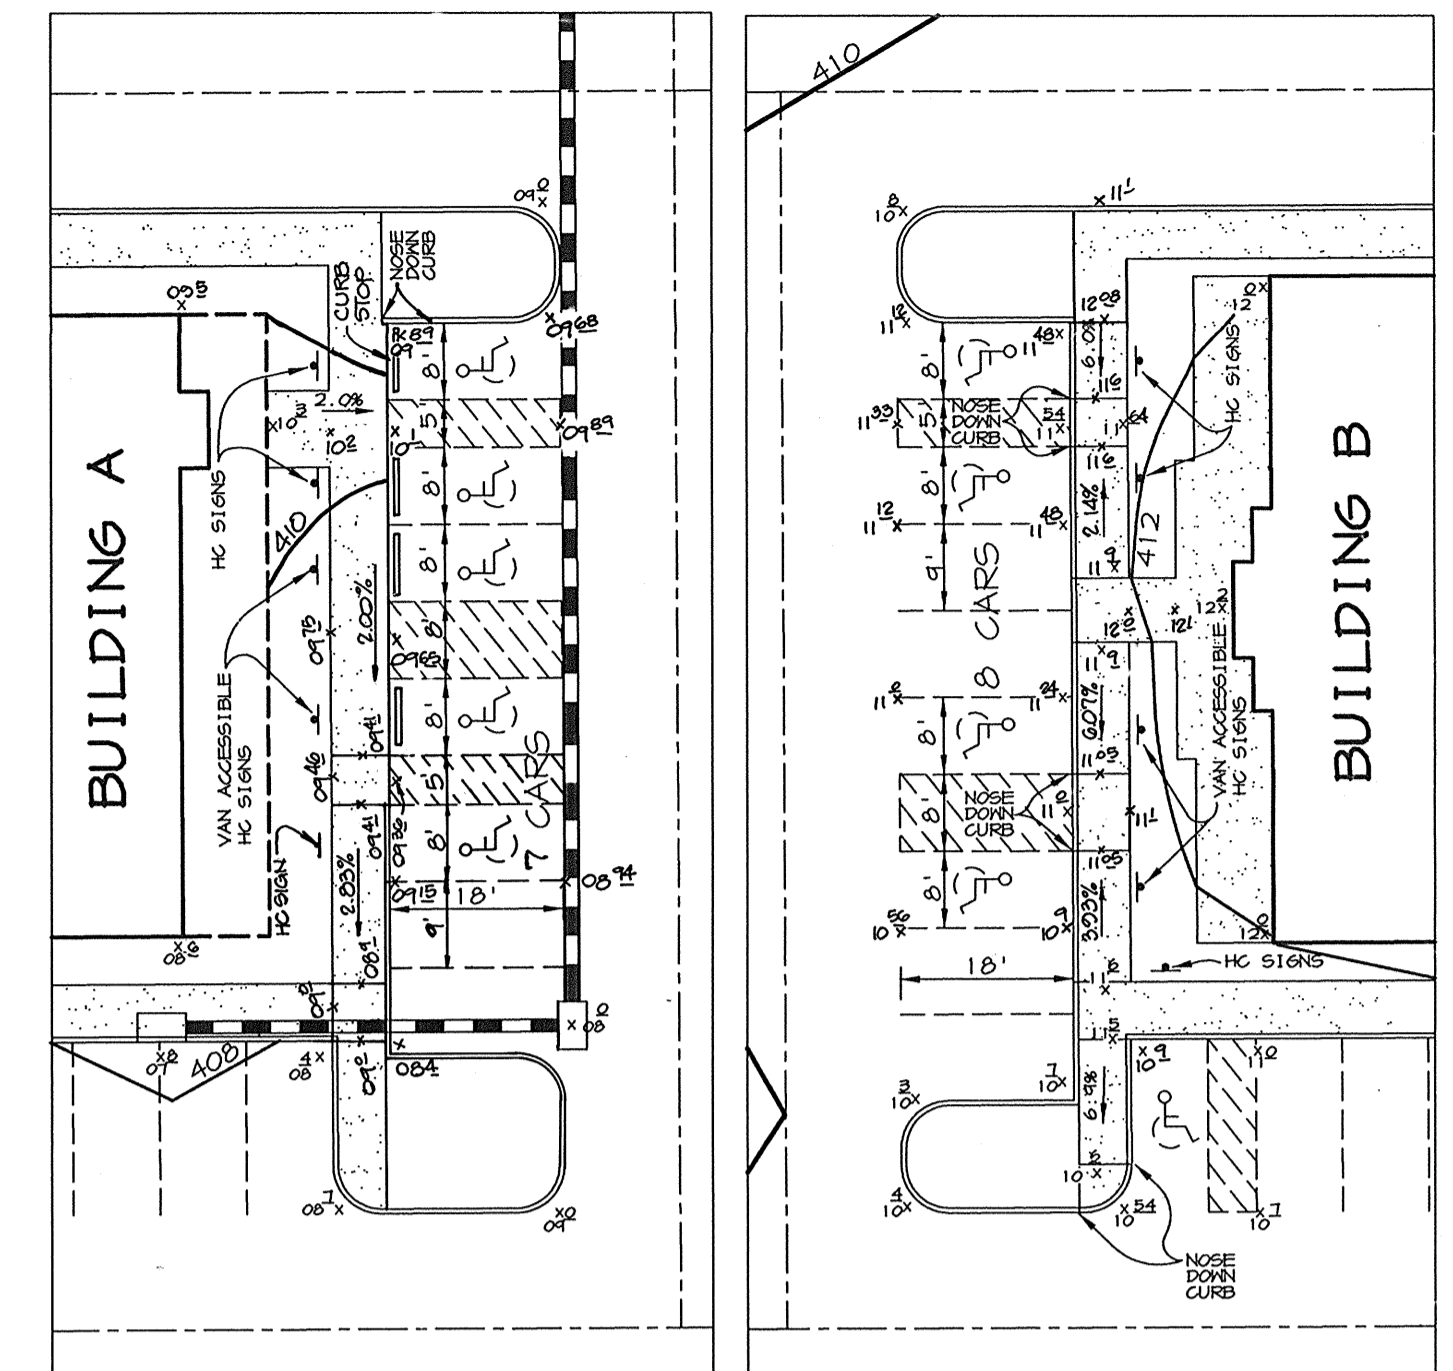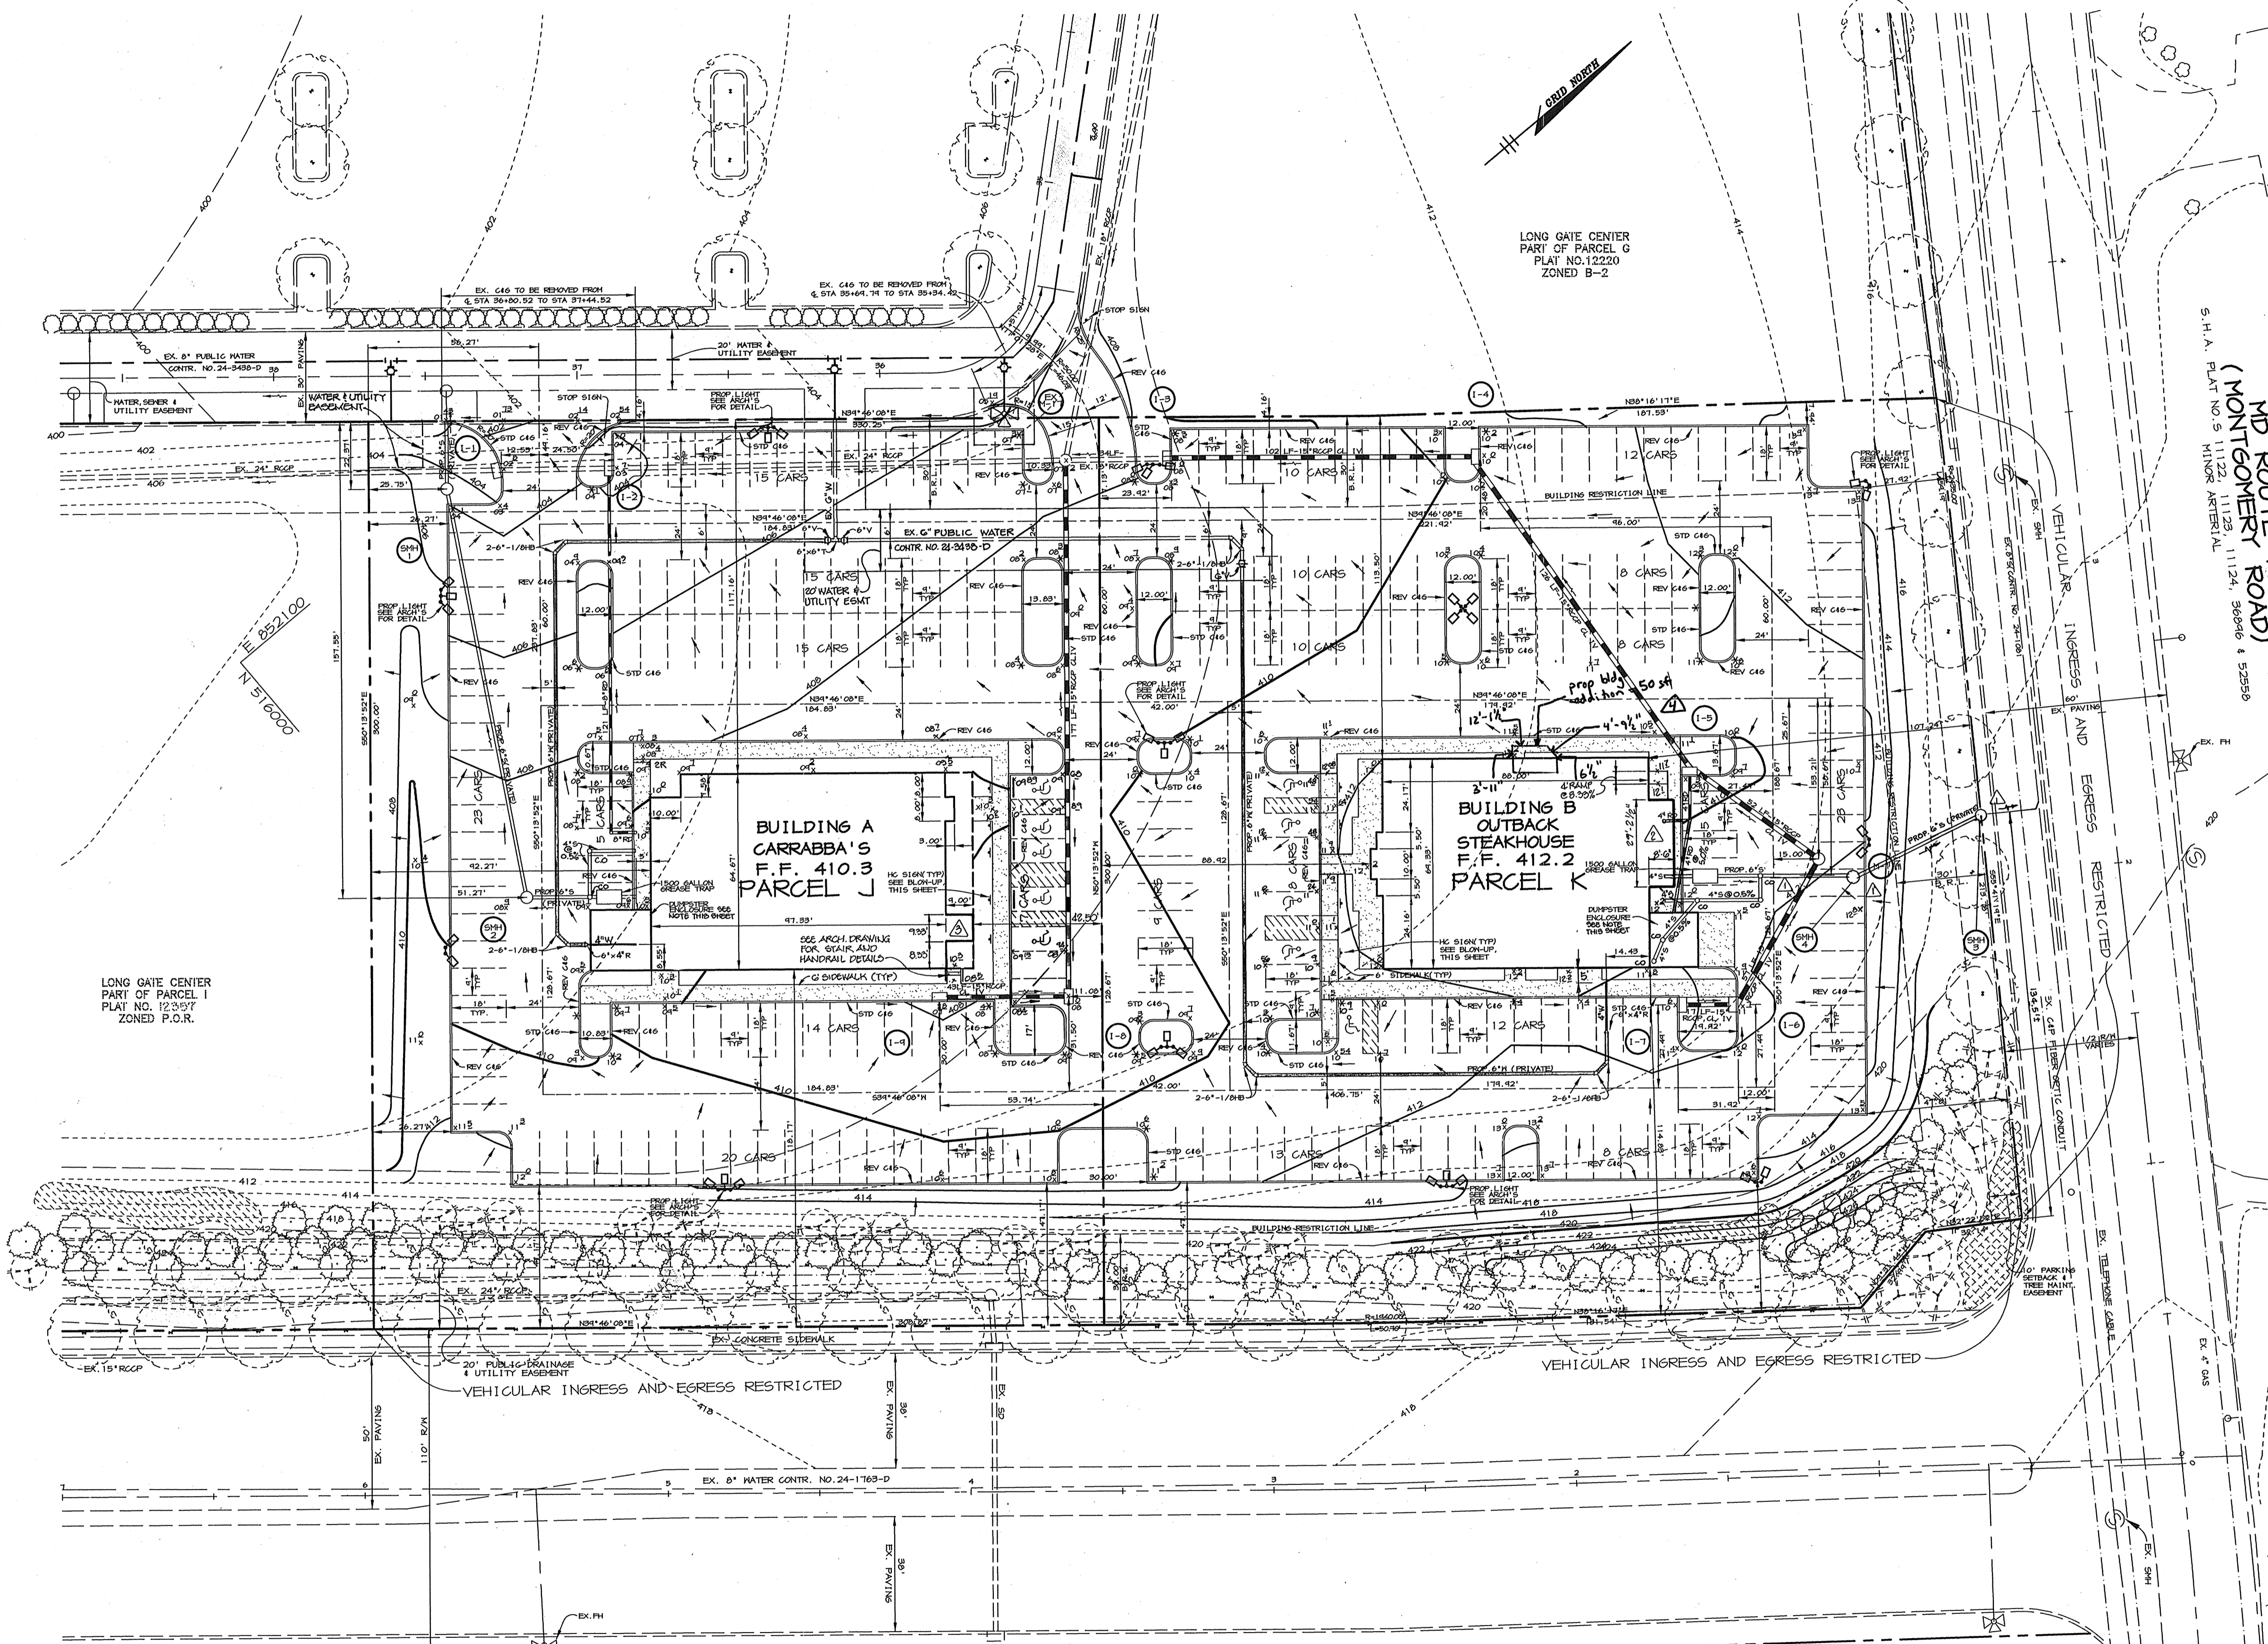

HANDICAP ACCESS AREA
SCALE: 1"=20'

LEGEND
* CURB TRANSITION LIGHTS

MD ROUTE 103 (MONTGOMERY ROAD)
S.H.A. PLAT NO. S 1122, 11123, 11124, 56006 & 52586



LONG GATE CENTER PART OF PARCEL I PLAT NO. 12397 ZONED P.O.R.

LONG GATE PARKWAY
S.H.A. PLAT NO. 11042 MINOR ARTERIAL

NOTES:


1. ALL CURB RADII ARE 5' UNLESS OTHERWISE NOTED.
2. ALL DIMENSIONS ARE TO FACE OF CURB OR FACE OF BUILDING UNLESS OTHERWISE NOTED.
3. ALL SPOT ELEVATIONS ARE TOP OF PAVING OR FINAL GROUND UNLESS OTHERWISE NOTED.
4. ALL EXTERIOR LIGHTING IS TO BE DIRECTED/REFLECTED AWAY FROM ADJACENT ROAD RIGHT-OF-WAYS AND RESIDENTIALLY ZONED PROPERTIES.
5. ALL ON-SITE ROADWAYS ARE PRIVATE.
6. ALL PAVING IS P-2 UNLESS OTHERWISE SHOWN.
7. INLETS 1-1, 1-2 & 1-3 SHALL BE INSTALLED ALONG AN EXISTING STORM DRAIN. REMOVE STORM DRAIN PIPES AS NECESSARY TO NEAREST PIPE JOINT FOR INSTALLATION OF INLETS.
8. COMPUTER ENCLOSURE TO BE CONSTRUCTED WITH SAME MATERIAL AS BUILDING. WOODEN GATE IN FRONT. SEE ARCHITECTURAL DRAWING FOR FURTHER DETAIL.
9. GREASE TRAP DETAILS TO BE PROVIDED UNDER ARCHITECTURAL DRAWING.



5-27-05	ADDED TAKEOUT AREA ENCLOSURE & BOUNDARY CONNECTION - BLDG. A	REVISION
DATE	NO.	REVISION
APPROVED: FOR PUBLIC WATER AND PUBLIC SEWERAGE SYSTEMS, HOWARD COUNTY HEALTH DEPARTMENT.		
<i>Joseph M. Boudreau, M.D. (CW)</i>	10/18/96	DATE
COUNTY HEALTH OFFICER	<i>RK</i>	
APPROVED: HOWARD COUNTY DEPARTMENT OF PLANNING AND ZONING.		
<i>James P. Rutter</i>	10/23/96	DATE
DIRECTOR		
<i>John Dammer</i>	10/17/96	DATE
CHIEF, DEVELOPMENT ENGINEERING DIVISION		
<i>Richard Blumel</i>	10/22/96	DATE
CHIEF, DIVISION OF LAND DEVELOPMENT AND RESEARCH		
 		
4-13-05	ADDED BLDG. ADDITION TO BLDG. 'A'	
3-2-00	ADDED BLDG. ADDITION	
12/13/94	RELOC. SM'S 'F', REROUTED CONNECTING SAN LINES	
DATE	NO.	REVISION
OWNER	DEVELOPER	
OPUS EAST, L.L.C. 6707 DEMOCRACY BLVD. SUITE 510 BETHESDA, MD 20817 (301) 493-4464	OUTBACK STEAKHOUSE 550 NORTH REO ST. SUITE 200 TAMPA, FL 33609 (813) 282-1225	
PROJECT OUTBACK STEAKHOUSE/ CARRABBA'S TWO RESTAURANT BUILDINGS		
AREA	TAX MAPS 24 & 30	PARCELS J&K
2nd ELECTION DISTRICT HOWARD COUNTY, MARYLAND		
TITLE SITE DEVELOPMENT PLAN		
RIEMER MUEGGE & ASSOCIATES, INC. ENGINEERING • ENVIRONMENTAL SERVICES • PLANNING • SURVEYING 8818 Centre Park Drive, Columbia, Maryland 21045 tel 410.997.8900 fax 410.997.9282		
10.10.96	DATE	DESIGNED BY: CJR
DRAWN BY: RPP/DAM		
PROJECT NO: HOCO/96E4701 C-2.DWG		
DATE: OCTOBER 10, 1996		
SCALE: 1"=30'		
DRAWING NO. 2 OF 6		
JAYKANT D. PAREKH #19148		

SHEET INDEX	
NO	DESCRIPTION
1	TITLE SHEET
2	SITE DEVELOPMENT PLAN
3	GRADING & SEDIMENT CONTROL PLAN
4	PROFILES, NOTES, AND DETAILS
5	NOTES AND DETAILS
6	LANDSCAPING PLAN

SITE DEVELOPMENT PLAN OUTBACK STEAKHOUSE/CARRABBA'S AT LONG GATE CENTER PARCELS J&K 2nd ELECTION DISTRICT HOWARD COUNTY, MARYLAND

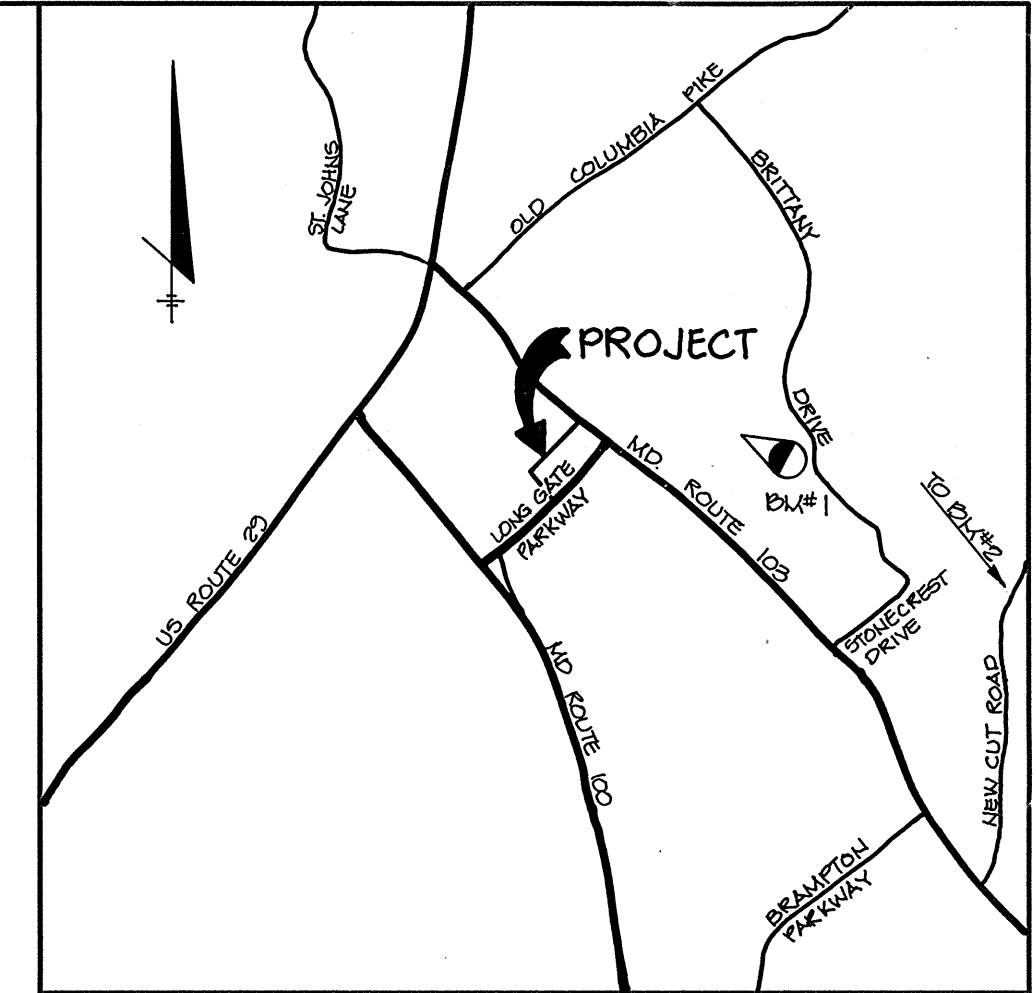


BENCHMARKS

BHM#1	STA 3043001	BHM#2	STA 2943002
ELEV. 437.42		N 513,205.90	E 857,478.69
N 516,549.55	E 853,656.51	LOCATED ON THE TRANSMISSION LINE	
32' ± NORTH OF B&E TOWER 276-A		1700' ± NORTH OF INTERSECTION OF	
BEHIND SCHOOL GROUNDS		ROUTE 103 AND NEW CUT ROAD	
		1150' ± EAST OF NEW CUT ROAD	

VICINITY MAP
SCALE: 1" = 2000'

GENERAL NOTES

- ALL CONSTRUCTION SHALL BE IN ACCORDANCE WITH THE LATEST STANDARDS AND SPECIFICATIONS OF HOWARD COUNTY PLUS MSHA STANDARDS AND SPECIFICATIONS, IF APPLICABLE.
- THE CONTRACTOR SHALL NOTIFY THE DEPARTMENT OF PUBLIC WORKS/BUREAU OF ENGINEERING/CONSTRUCTION INSPECTION DIVISION AT (410) 313-1880 AT LEAST FIVE (5) WORKING DAYS PRIOR TO THE START OF WORK.
- THE CONTRACTOR SHALL NOTIFY "MISS UTILITY" AT 1-800-257-7777 AT LEAST 48 HOURS PRIOR TO ANY EXCAVATION WORK BEING DONE.
- TRAFFIC CONTROL DEVICES, MARKINGS, AND SIGNING SHALL BE IN ACCORDANCE WITH THE LATEST EDITION OF THE MANUAL ON UNIFORM TRAFFIC CONTROL DEVICES (MUTCD). ALL STREET AND REGULATORY SIGNS SHALL BE IN PLACE PRIOR TO THE PLACEMENT OF ANY ASPHALT.
- ALL PLAN DIMENSIONS ARE TO FACE OF CURB UNLESS OTHERWISE NOTED.
- THE EXISTING TOPOGRAPHY IS TAKEN FROM SDP-95-62 WITH MAXIMUM TWO FOOT CONTOUR INTERVALS PREPARED BY RIEMER MUEGGE & ASSOC. DATED SEPT. 1995.
- THE COORDINATES SHOWN HEREON ARE BASED UPON THE HOWARD COUNTY GEODETIC CONTROL WHICH IS BASED UPON THE MARYLAND STATE PLANE COORDINATE SYSTEM. HOWARD COUNTY MONUMENT NOS. 3043001-R AND 2943002 WERE USED FOR THIS PROJECT.
- WATER IS PUBLIC PER CONTRACT NUMBER 24-3438-D.
- SEWER IS PUBLIC PER CONTRACT NUMBER 24-3438-D. SEWER DRAINAGE AREA: 108 PUMPING STATION
- THE STORMWATER MANAGEMENT FACILITY PROPOSED FOR THIS SITE IS PROVIDED BY A RETENTION FACILITY APPROVED UNDER SDP-95-62.
- APPROXIMATE LOCATION OF EXISTING UTILITIES ARE SHOWN. THE CONTRACTOR SHALL TAKE ALL NECESSARY PRECAUTIONS TO PROTECT THE EXISTING UTILITIES AND MAINTAIN UNINTERRUPTED SERVICE. ANY DAMAGE INCURRED DUE TO CONTRACTOR'S OPERATION SHALL BE REPAIRED IMMEDIATELY AT THE CONTRACTOR'S EXPENSE. EXISTING UTILITIES ARE SHOWN BASED ON THE BEST AVAILABLE INFORMATION.
- THERE IS NO ON-SITE 100 YEAR FLOODPLAIN.
- THERE ARE NO ON-SITE WETLANDS.
- THE TRAFFIC STUDY FOR THIS PROJECT WAS PREPARED BY THE TRAFFIC GROUP, INC. DATED APRIL 21, 1995 AND WAS APPROVED UNDER SDP-95-62.
- THE BOUNDARY SURVEY FOR THIS PROJECT WAS PREPARED BY RIEMER MUEGGE & ASSOC., INC. DATED APRIL 1996.
- SUBJECT PROPERTY ZONED FOR PER 10-18-93 COMPREHENSIVE ZONING PLAN.
- ALL ELEVATIONS SHOWN ARE BASED ON THE U.S.C. AND G.S. MEAN SEA LEVEL DATUM, 1929.
- SEE DEPARTMENT OF PLANNING AND ZONING FILE NOS. SDP-95-62, F-95-93, F-97-25.
- THE CONTRACTOR SHALL TEST PIT EXISTING UTILITIES AT LEAST (5) DAYS BEFORE STARTING WORK SHOWN ON THESE DRAWINGS.
- CONTRACTOR IS SOLELY RESPONSIBLE FOR CONSTRUCTION MEANS, METHODS, TECHNIQUES, SEQUENCES, PROCEDURES, AND SAFETY PRECAUTIONS AND PROGRAMS.
- PIPE SHALL NOT BE INSTALLED BY THE CONTRACTOR UNTIL THE LENGTH CALLED FOR AT EACH STATION HAS BEEN APPROVED BY THE ENGINEER IN THE FIELD.
- NO PIPE SHALL BE LAID UNTIL LINES OF EXCAVATION HAVE BEEN BROUGHT WITHIN 6" OF FINISHED GRADE.
- ALL STORM DRAIN PIPE BEDDING SHALL BE CLASS "C" AS SHOWN IN FIG. 11.4, VOLUME 1 OF HOWARD COUNTY DESIGN MANUAL UNLESS OTHERWISE NOTED.
- ALL INLETS SHALL BE CONSTRUCTED IN ACCORDANCE WITH HOWARD COUNTY STANDARDS.
- ALL PIPE ELEVATIONS SHOWN ARE INVERT ELEVATIONS.
- STORM DRAIN TRENCHES WITHIN ROAD RIGHT OF WAY SHALL BE BACKFILLED AND COMPACTED IN ACCORDANCE WITH THE HOWARD COUNTY DESIGN MANUAL, VOLUME IV, I.E., STANDARD SPECIFICATIONS AND DETAILS FOR CONSTRUCTION, LATEST AMENDMENTS.
- PROFILES STATIONS SHALL BE ADJUSTED AS NECESSARY TO CONFORM TO PLAN DIMENSIONS.
- ALL FILL AREAS WITHIN ROADWAY AND UNDER STRUCTURES TO BE COMPACTED TO A MINIMUM OF 95% COMPACTION OF AASHTO T100.
- FOREST CONSERVATION OBLIGATIONS FOR THIS DEVELOPMENT HAVE BEEN ADDRESSED UNDER SDP-95-62.


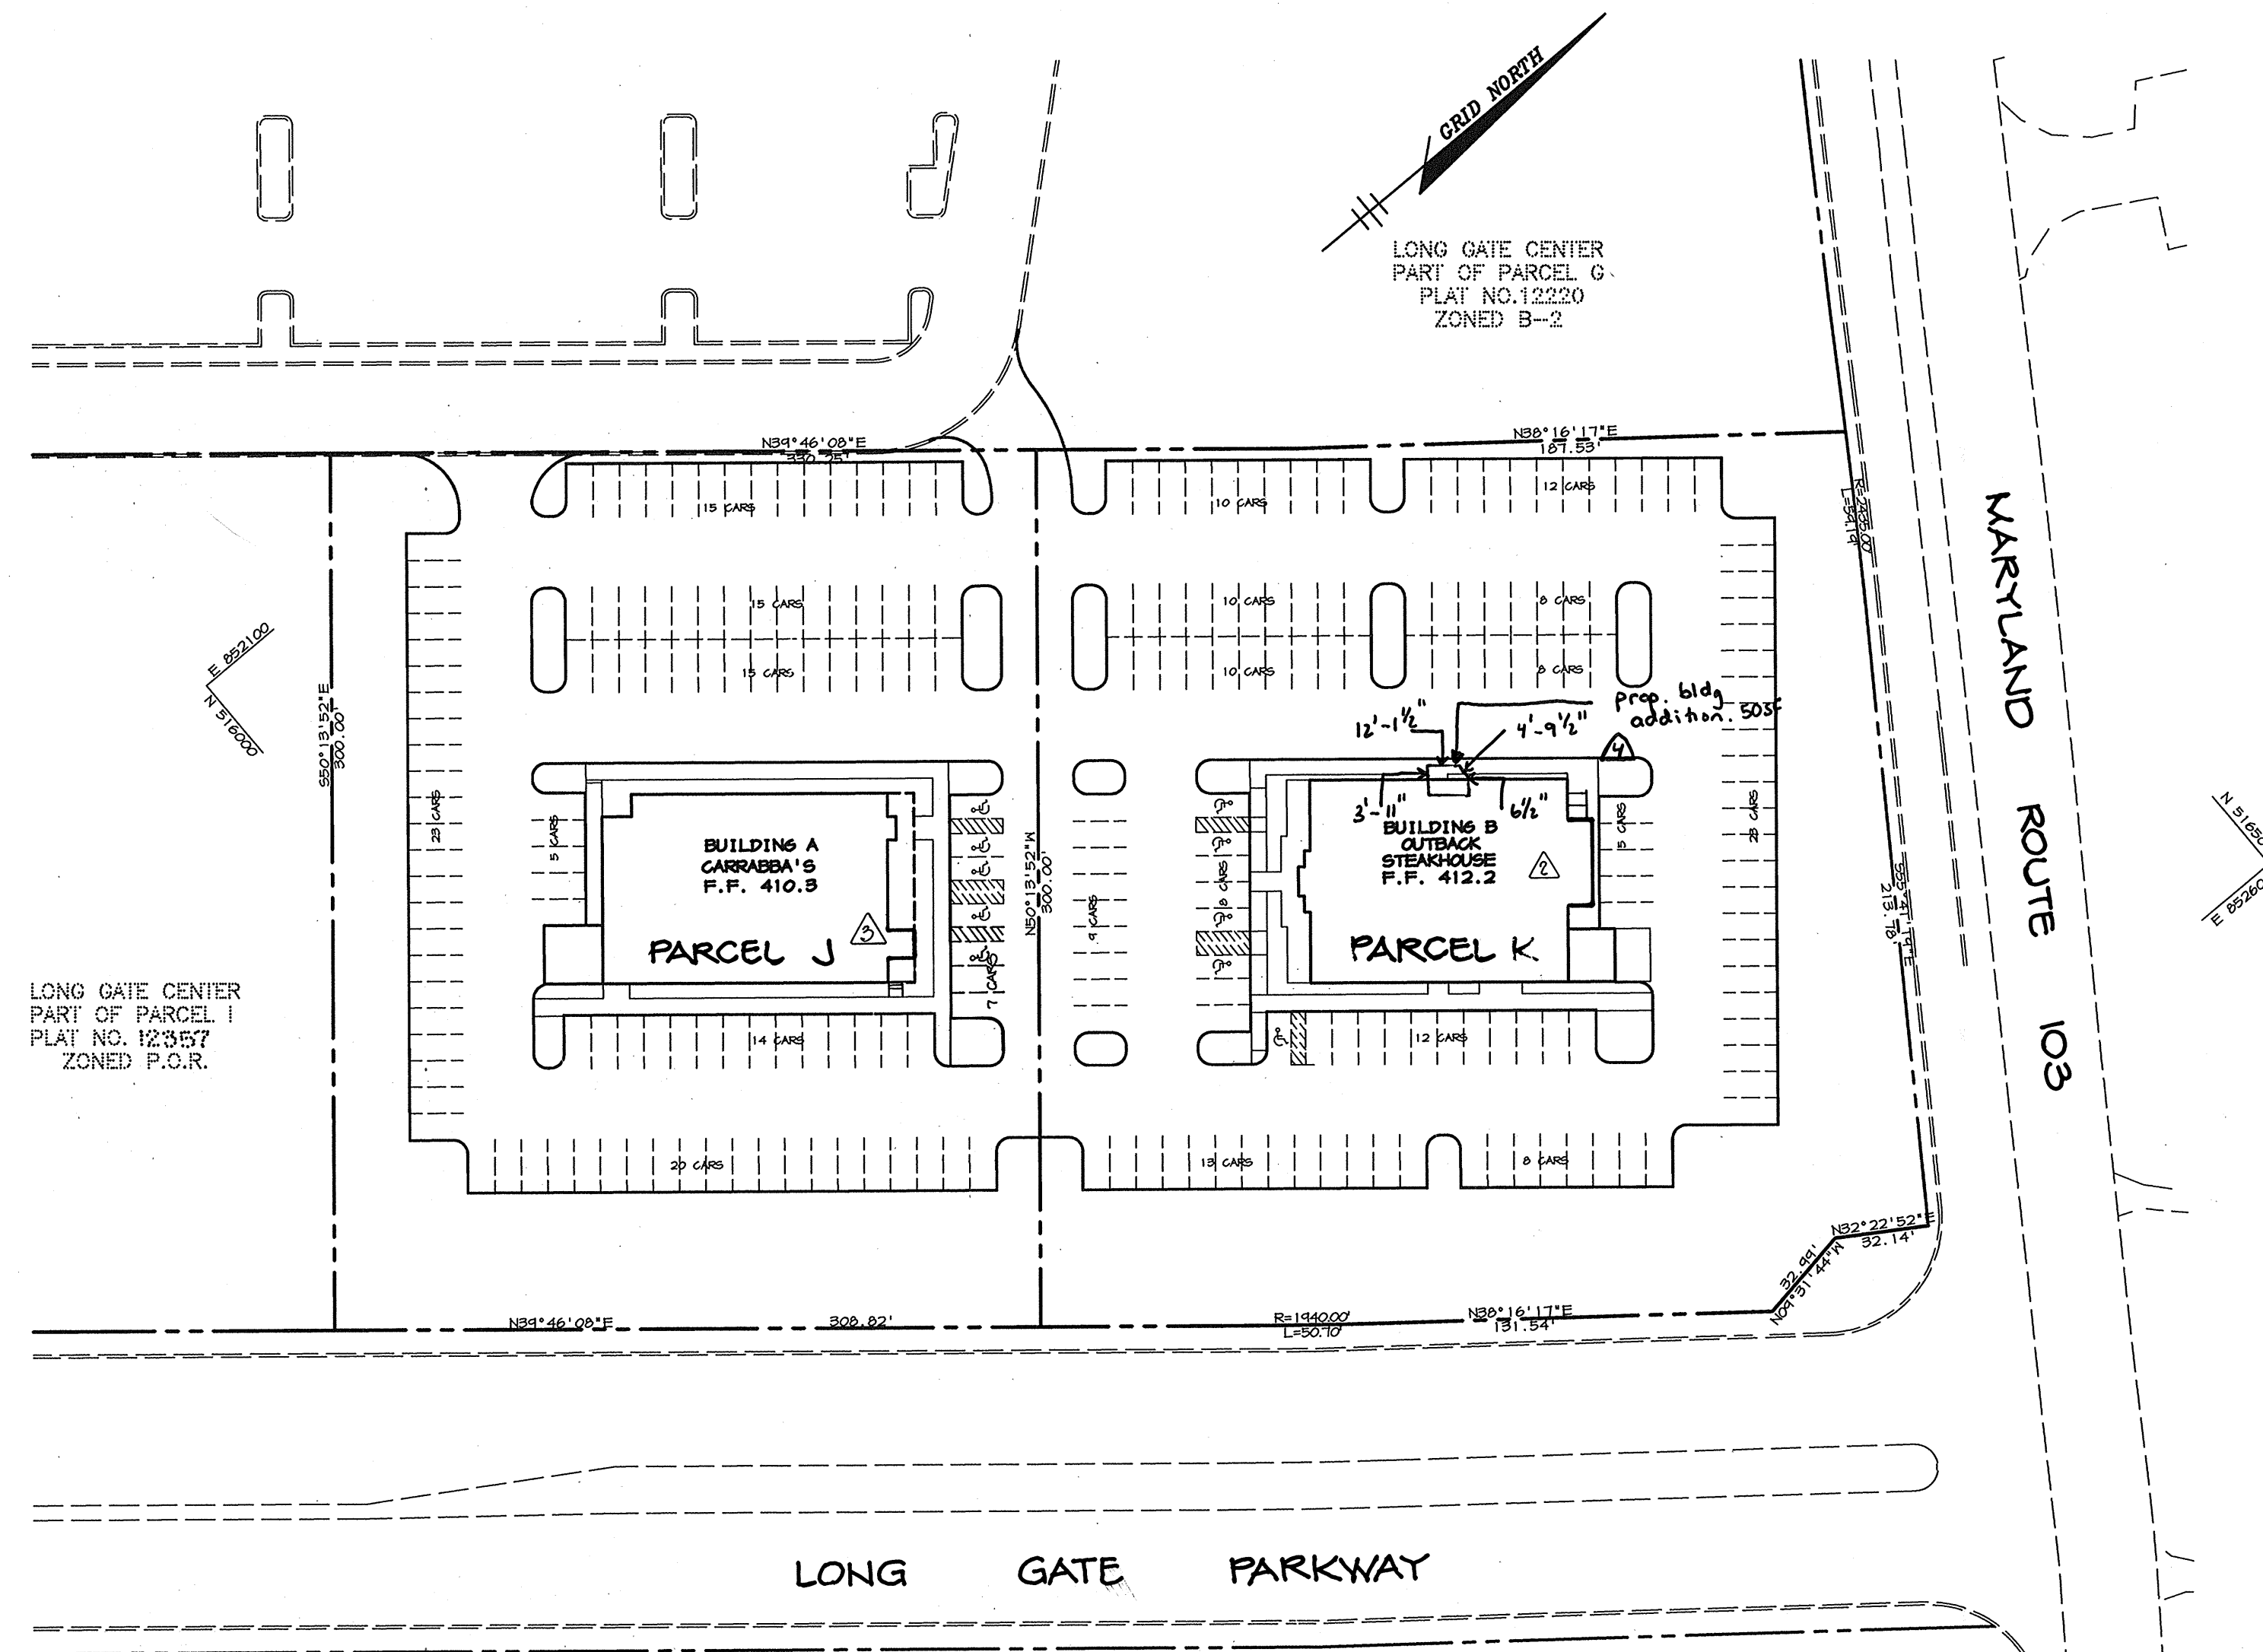


LONG GATE PARKWAY

PLAN
SCALE: 1"=50'

SITE ANALYSIS

AREA OF PARCELS	72,324 SF - 1.66 ACRES (PARCEL J) 86,364 SF - 1.98 ACRES (PARCEL K)
PRESENT ZONING	FOR
PROPOSED USE	SIT-DOWN RESTAURANTS
BUILDING COVERAGE	BLDG A: 7200 SF (10.0% OF PARCEL J) BLDG B: 6749 SF (7.0% OF PARCEL K)
# OF PARKING SPACES REQ'D @ 14 SP/1000 SF	101 (PARCEL J) 6749 (PARCEL K) TOTAL 196
# OF PARKING SPACES PROVIDED	114 INCL. 5 HC (PARCEL J) 136 INCL. 5 HC (PARCEL K) TOTAL 250
PAVED AREA	
PARKING LOT SIDEWALKS	87,984 SF 5,193 SF
TOTAL	93,177 SF (58.7% OF PARCELS J&K)

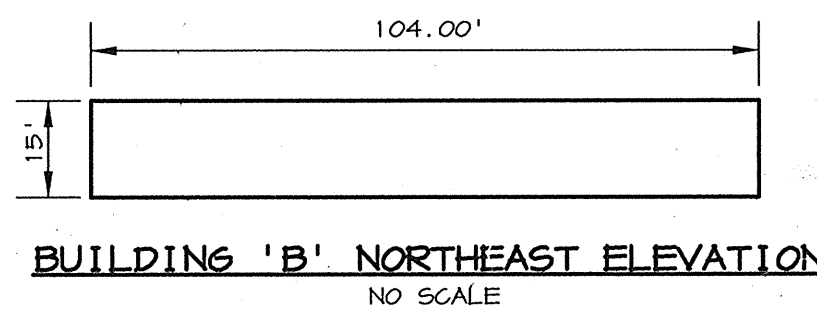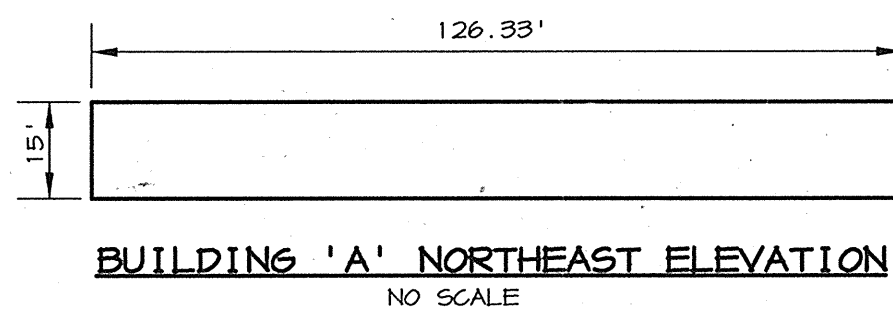

ADDRESS CHART

BUILDING	STREET ADDRESS
A	4430 LONG GATE PARKWAY
B	4420 LONG GATE PARKWAY

APPROVED: FOR PUBLIC WATER AND PUBLIC SEWERAGE SYSTEMS, HOWARD COUNTY HEALTH DEPARTMENT.


James M. Boyd 10/18/96
COUNTY HEALTH OFFICER MK DATE

APPROVED: HOWARD COUNTY DEPARTMENT OF PLANNING AND ZONING.

James M. Boyd 10/23/96
DIRECTOR DATE

John D. Muegge 10/17/96
CHIEF, DEVELOPMENT ENGINEERING DIVISION DATE

Richard B. Beard 10/22/96
CHIEF, DIVISION OF LAND DEVELOPMENT AND RESEARCH DATE

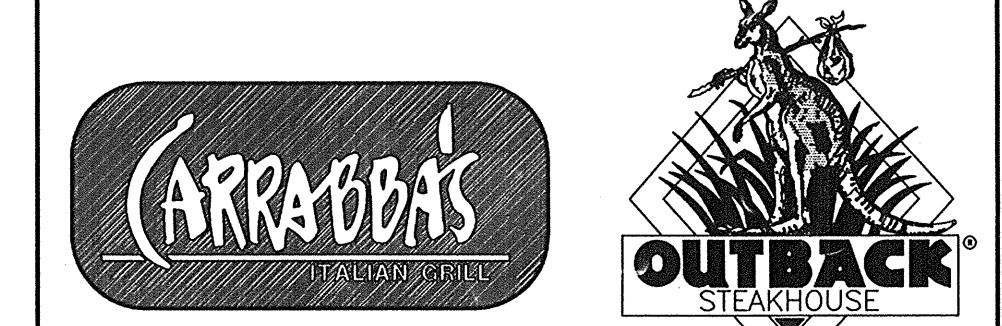

4-13-05	ADDED BLDG. ADDITION TO BLDG. "B"
9-27-05	ADDED BLDG. ADDITION TO BLDG. A
9-2-05	ADDED BLDG. ADDITION & REV. SITE TAB
DATE NO.	REVISION
OWNER	DEVELOPER
OPUS EAST, L.L.C. 6707 DEMOCRACY BLVD. SUITE 510 BETHESDA, MD 20817 (301) 493-4464	OUTBACK STEAKHOUSE 550 NORTH REO ST. SUITE 200 TAMPA, FL 33604 (813) 282-1225

PROJECT OUTBACK STEAKHOUSE/
CARRABBA'S
TWO RESTAURANT BUILDINGS

AREA TAX MAPS 24 & 30 PARCELS J&K
2nd ELECTION DISTRICT
HOWARD COUNTY, MARYLAND

TITLE TITLE SHEET

RIEMER MUEGGE & ASSOCIATES, INC.
ENGINEERING • ENVIRONMENTAL SERVICES • PLANNING • SURVEYING
8818 Centre Park Drive, Columbia, Maryland 21045
tel 410.997.8900 fax 410.997.9282

DATE: 10.10.96
DESIGNED BY: CJR
DRAWN BY: RPP/DAM
PROJECT NO.: HOC096E4701
DATE: OCTOBER 10, 1996
SCALE: AS SHOWN
DRAWING NO.: 1 OF 6



LANDSCAPE SCHEDULES

SCHEDULE A * PERIMETER LANDSCAPE EDGE			
PERIMETER	ADJACENT TO ROADWAYS		REMARKS
	1	2	
LANDSCAPE TYPE	E	E	
LINEAR FEET OF ROADWAY FRONTAGE/PERIMETER	± 545'	± 272'	
CREDIT FOR EXISTING VEGETATION (YES, NO, LINEAR FEET) (DESCRIBE BELOW IF NEEDED)	NO	NO	
CREDIT FOR WALL, FENCE OR BERM (YES, NO, LINEAR FEET) (DESCRIBE BELOW IF NEEDED)	SEE NOTE #1 BELOW	SEE NOTE #2 BELOW	
NUMBER OF PLANTS REQUIRED			
SHADE TREES	0	0	
EVERGREEN TREES	0	0	
SHRUBS	0	0	
NUMBER OF PLANTS PROVIDED			
SHADE TREES	12	0	
EVERGREEN TREES	0	0	
SHRUBS	4	0	
SMALL FLOWERING TREES	0	0	

SUBSTITUTION NOTES:
PERIMETER LANDSCAPE EDGE, SCHEDULE A
 SUBSTITUTE (4) FLOWERING TREES FOR (2) SHADE TREES
 TEN (10) SHADE TREES TO BE LOCATED IN ISLANDS ADJACENT TO BUILDINGS - DUE TO THE DENSE BERM LANDSCAPING ALONG LONG GATE PARKWAY IN ACCORDANCE TO AGREEMENTS WITH ADJACENT NEIGHBORHOODS, LITTLE SPACE EXISTS TO ACCOMMODATE SHADE TREE REQUIREMENTS. IT IS APPROPRIATE TO MEET THE PERIMETER 1 OBLIGATIONS WITH THE ISLAND PLANTINGS AS NEAR TO THIS PERIMETER AS POSSIBLE.


NOTES:
 #1 TOP OF BERM ± 4' HIGHER THAN LONG GATE PARKWAY; PARKING LOT ± 4' LOWER THAN LONG GATE PARKWAY ± 8' LOWER THAN TOP OF BERM - USED AS SUBSTITUTION FOR REQUIRED SHRUBS.
 #2 PARKING LOT ± 8' LOWER THAN MARYLAND ROUTE 103 - BERM USED AS SUBSTITUTION FOR REQUIRED SHRUBS.
 * THE REGULATIONS DO NOT REQUIRE LANDSCAPED EDGES, BUFFERINGS, OR SCREENING, BETWEEN INTERNAL LOTS OR PARCELS WITHIN THE SAME DEVELOPMENT. (SEE PERIMETER LANDSCAPE EDGES ON P. 17 OF LANDSCAPE MANUAL.)

SCHEDULE B PARKING LOT INTERNAL LANDSCAPING	
NUMBER OF PARKING SPACES	251
NUMBER OF SHADE TREES REQUIRED @ 1:5.7/20 SPACES	18
NUMBER OF TREES PROVIDED	0
SHADE TREES	0
OTHER TREES (2) SUBSTITUTION	18
NUMBER OF ISLANDS REQUIRED @ 1 ISLAND/ 20 SPACES	13
NUMBER OF ISLANDS PROVIDED	17


NOTES: THIS PLAN HAS BEEN PREPARED IN ACCORDANCE WITH THE PROVISIONS OF SECTION 16.124 OF THE HOWARD COUNTY CODE AND THE LANDSCAPE MANUAL.
 * FINANCIAL SURETY FOR THE REQUIRED LANDSCAPING HAS BEEN POSTED AS PART OF THE GRADING PERMIT IN THE AMOUNT OF \$35000.00

PLANT MATERIAL LIST				
KEY	QTY	BOTANICAL + COMMON NAME	SIZE	REMARKS
TREES				
AS	12	Acer saccharum Green Mountain ¹ Green Mountain Sugar Maple	2 1/2" - 3" Cal.	B & B
CR	4	Chionodoxa retusa Chinese Fringetree	1 1/2" - 2" Cal.	B & B
QP	20	Quercus phellos Willow Oak	2 1/2" - 3" Cal.	B & B

PLANTING DETAILS

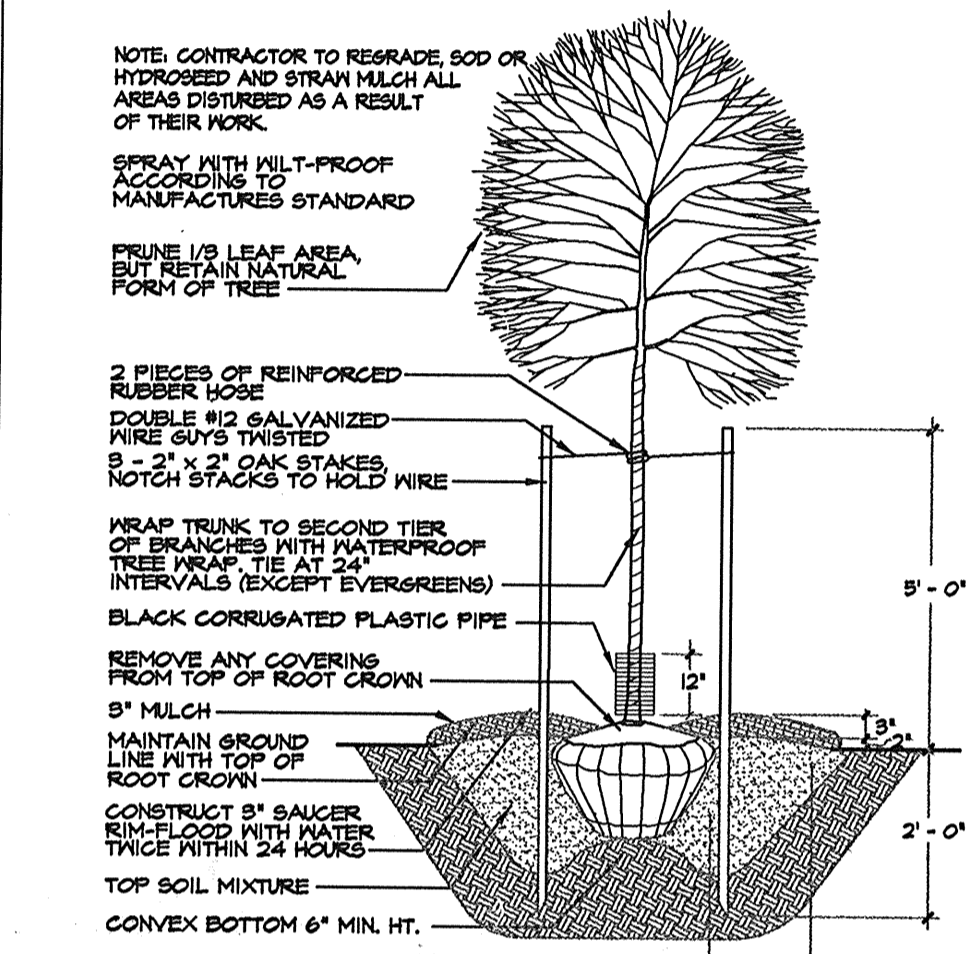

TREE PLANTING DETAIL
NTB

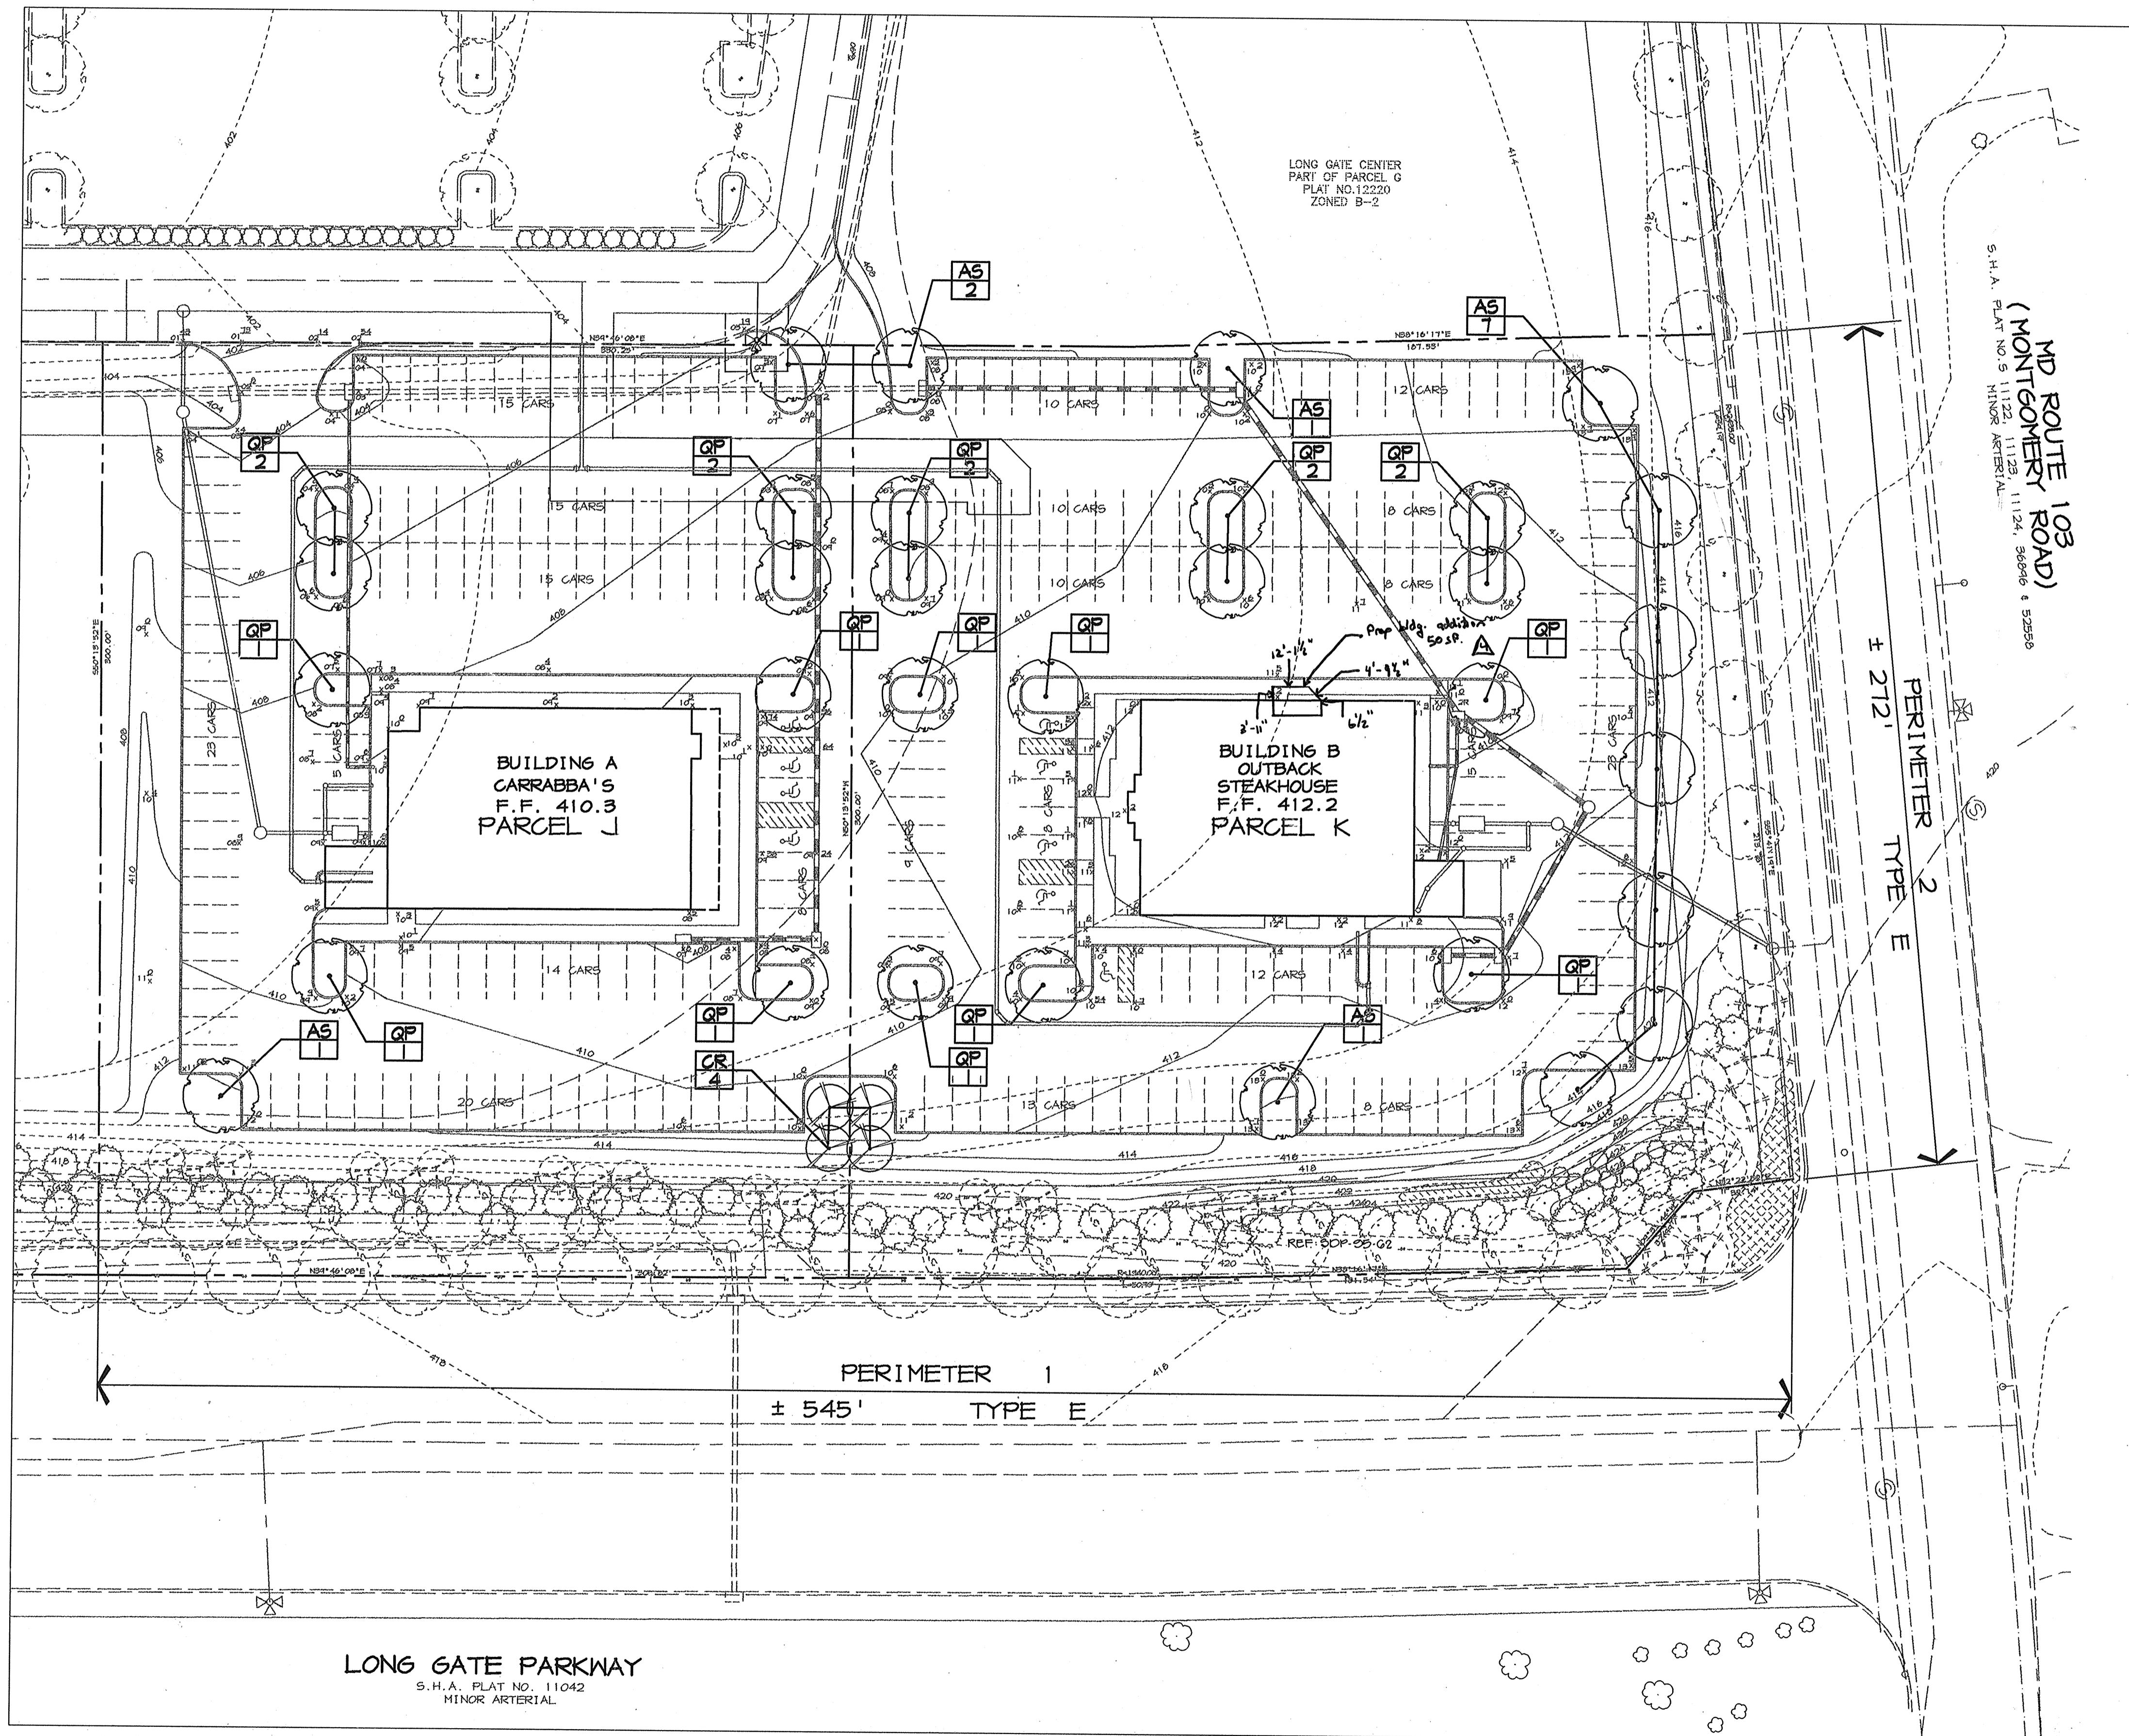

NOTE: THIS PLAN FOR LANDSCAPE PURPOSES ONLY.

GENERAL REFERENCE NOTE:
 FOR EXISTING TREE PLANTINGS ALONG BERM, ROUTE 103, AND LONG GATE PARKWAY SEE SDP-45-62.

APPROVED: HOWARD COUNTY DEPARTMENT OF PLANNING AND ZONING.
 Director: [Signature] 10/23/06 DATE
 Chief, Development Engineering Division: [Signature] 10/17/06 DATE
 Chief, Division of Land Development and Research: [Signature] 10/23/06 DATE




4-13-05	4	ADDED BLOC. ADDITION TO BLOC. "B"
DATE	NO.	REVISION
OWNER		
OPUS EAST, L.L.C. 6707 DEMOCRACY BLVD. SUITE 510 BETHESDA, MD 20817 (301) 493-4464		DEVELOPER OUTBACK STEAKHOUSE 550 NORTH REO ST. SUITE 200 TAMPA, FL 33609 (813) 282-1225
PROJECT OUTBACK STEAKHOUSE/ CARRABBA'S TWO RESTAURANT BUILDINGS		
AREA TAX MAPS 24 & 30 PARCELS J&K 2nd ELECTION DISTRICT HOWARD COUNTY, MARYLAND		
TITLE LANDSCAPE PLAN		

RIEMER MUEGGE & ASSOCIATES, INC.
 ENGINEERING • ENVIRONMENTAL SERVICES • PLANNING • SURVEYING
 8818 Centre Park Drive, Columbia, Maryland 21045
 tel 410.997.8900 fax 410.997.9282

8-23-96	SDP-45-62 F-45-43	F-46-163 F-46-
DATE	PROJECT	SCALE
DESIGNED BY: CJR/LOH	DRAWN BY: RFP/ML/CK	PROJECT NO: HOCO9064701 LSCP2.DWG
DATE: OCTOBER 10, 2006	SCALE: 1" = 30'	DRAWING NO. 6 OF 6
LINDON O. HART #1098		



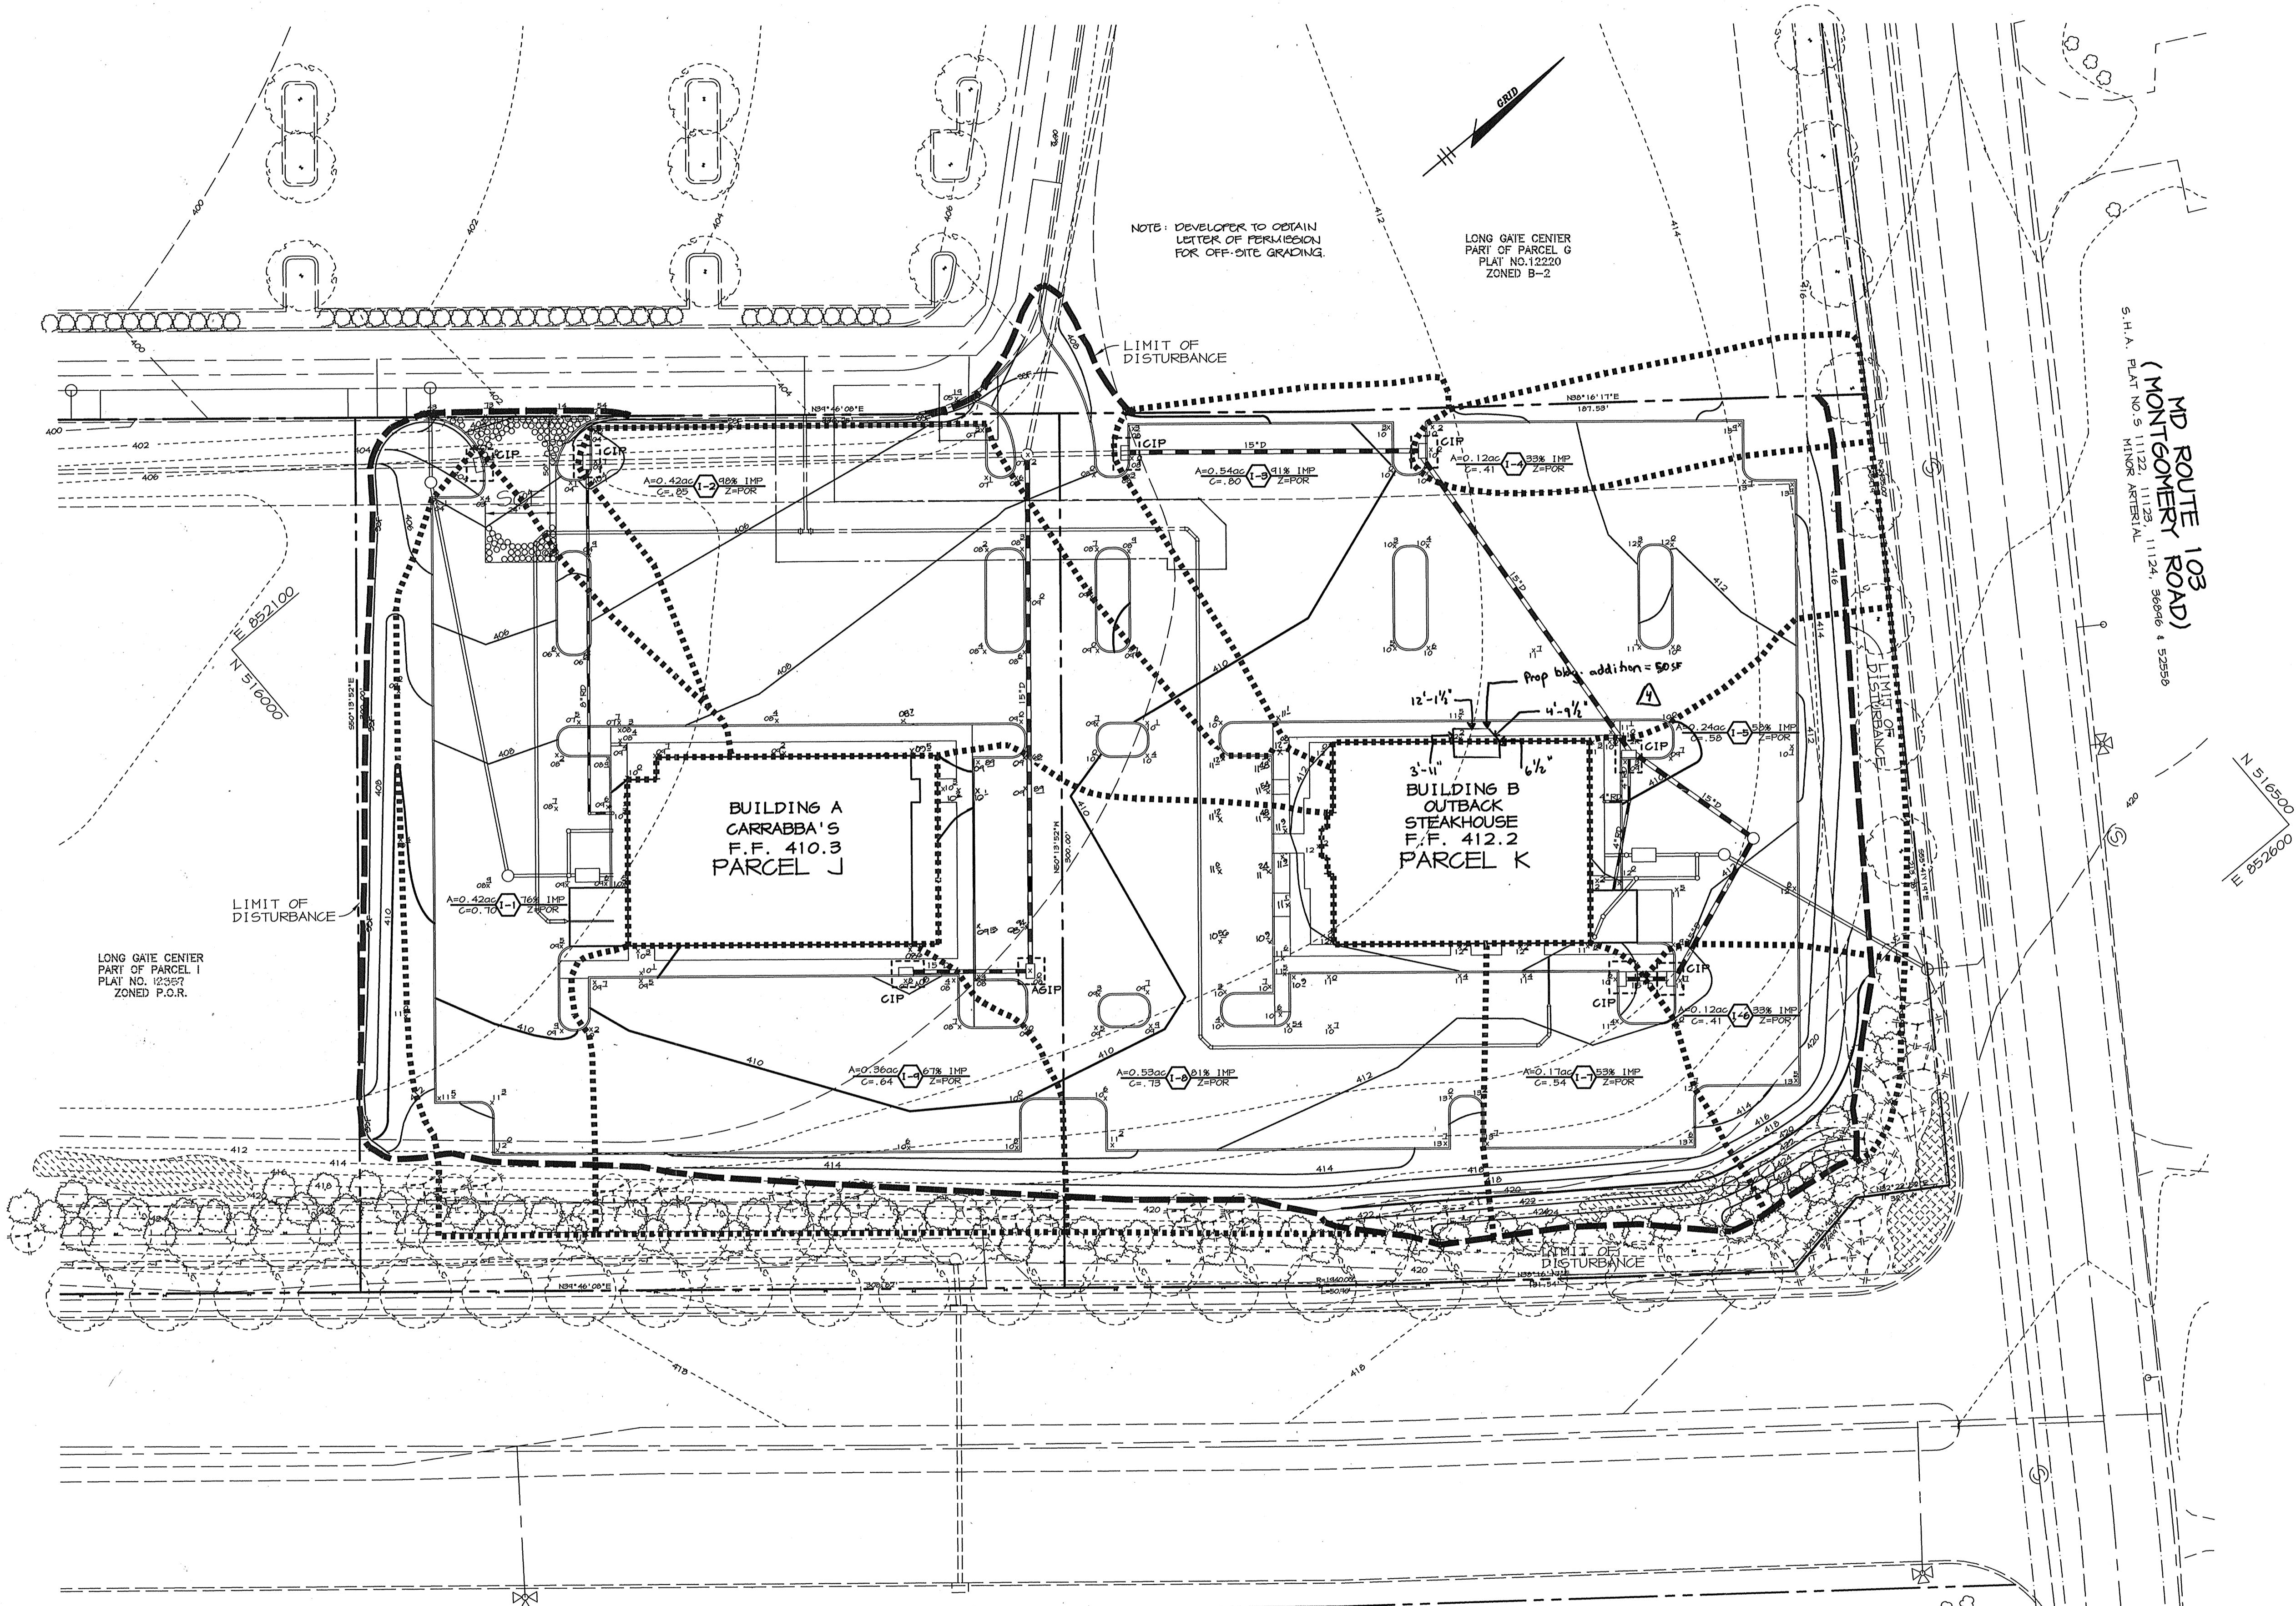

BY THE DEVELOPER :

I/WE CERTIFY THAT ALL DEVELOPMENT AND CONSTRUCTION WILL BE DONE ACCORDING TO THIS PLAN, AND THAT ANY RESPONSIBLE PERSONNEL INVOLVED IN THE CONSTRUCTION PROJECT WILL HAVE A CERTIFICATE OF ATTENDANCE AT A DEPARTMENT OF THE ENVIRONMENT APPROVED TRAINING PROGRAM FOR THE CONTROL OF SEDIMENT AND EROSION BEFORE BEGINNING THE PROJECT. I ALSO AUTHORIZE PERIODIC ON-SITE INSPECTIONS BY THE HOWARD SOIL CONSERVATION DISTRICT.

James Bitt 10.9.96
 DEVELOPER DATE

BY THE ENGINEER :

I CERTIFY THAT THIS PLAN FOR EROSION AND SEDIMENT CONTROL REPRESENTS A PRACTICAL AND WORKABLE PLAN BASED ON MY PERSONAL KNOWLEDGE OF THE SITE CONDITIONS AND THAT IT WAS PREPARED IN ACCORDANCE WITH THE REQUIREMENTS OF THE HOWARD SOIL CONSERVATION DISTRICT.

J. Farrell 10.10.96
 ENGINEER DATE

THESE PLANS HAVE BEEN REVIEWED FOR THE HOWARD SOIL CONSERVATION DISTRICT AND MEET THE TECHNICAL REQUIREMENTS FOR SOIL EROSION AND SEDIMENT CONTROL.

J. Y. Warfield 10/12/96
 NATURAL RESOURCES CONSULTANT SERVICE DATE

THIS DEVELOPMENT PLAN IS APPROVED FOR SOIL EROSION AND SEDIMENT CONTROL BY THE HOWARD SOIL CONSERVATION DISTRICT.

John R. Robertson 10/15/96
 HOWARD SOIL CONSERVATION DISTRICT DATE

APPROVED : FOR PUBLIC WATER AND PUBLIC SEWERAGE SYSTEMS, HOWARD COUNTY HEALTH DEPARTMENT.


Janice M. Boyd, M.D., C.H. 10/18/96
 COUNTY HEALTH OFFICER DATE

APPROVED : HOWARD COUNTY DEPARTMENT OF PLANNING AND ZONING.

Joseph S. Smith 10/23/96
 DIRECTOR DATE

Mr. Cameron 10/17/96
 CHIEF, DEVELOPMENT ENGINEERING DIVISION DATE

Richard Blood 10/21/96
 CHIEF, DIVISION OF LAND DEVELOPMENT AND RESEARCH DATE

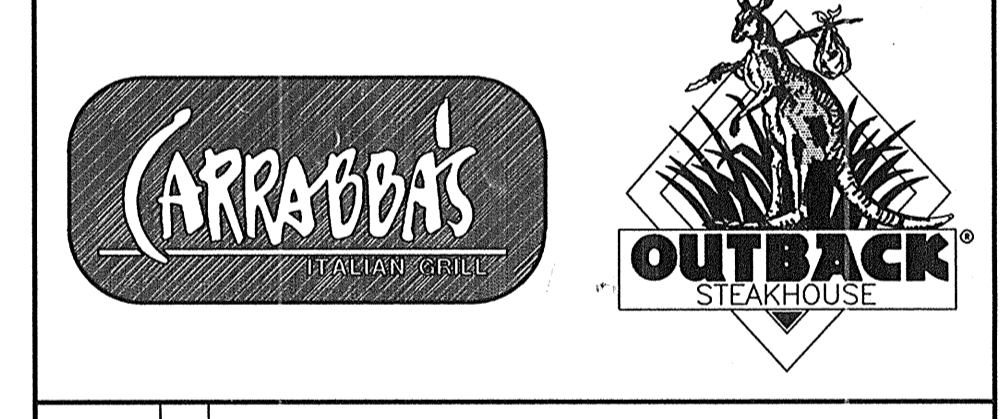

4-13-05 A ADDED BLDG. ADDITION TO BLDG "B"
 DATE NO. REVISION

OWNER	DEVELOPER
OPUS EAST, L.L.C. 6707 DEMOCRACY BLVD. SUITE 510 BETHESDA, MD 20817 (301) 493-4464	OUTBACK STEAKHOUSE 550 NORTH REO ST. SUITE 200 TAMPA, FL 33609 (813) 282-1225

PROJECT OUTBACK STEAKHOUSE/
 CARRABBA'S
 TWO RESTAURANT BUILDINGS

AREA TAX MAPS 24 & 30 PARCELS J&K
 2nd ELECTION DISTRICT
 HOWARD COUNTY, MARYLAND

TITLE GRADING AND
 SEDIMENT CONTROL PLAN
 & DRAINAGE AREA MAP

RIEMER MUEGGE & ASSOCIATES, INC.
 ENGINEERING • ENVIRONMENTAL SERVICES • PLANNING • SURVEYING
 8818 Centre Park Drive, Columbia, Maryland 21045
 tel 410.997.8900 fax 410.997.9282

10.10.96
 DATE

DESIGNED BY : CJR

DRAWN BY : RPP/DAM

PROJECT NO : H000946E4701
 C-3.DWG

DATE : OCTOBER 10, 1996

SCALE : 1"=30'

J. Farrell
 JAYKANT D. PAREKH #19148

DRAWING NO. 3 OF 6

- NOTES:
1. LIMIT OF DISTURBANCE IS AT PROPERTY LINE UNLESS OTHERWISE SHOWN.
 2. ALL SOILS ARE ASSUMED 'C' AS SITE WAS MASS GRADED.
 3. BUILDINGS TO HAVE INTERIOR SPRINKLER SYSTEMS.

LEGEND

- LIMIT OF DISTURBANCE
- DRAINAGE DIVIDE
- SCE STABILIZED CONSTRUCTION ENTRANCE
- SUPER SILT FENCE
- INLET PROTECTION

LONG GATE PARKWAY
 S.H.A. PLAT NO. 11042
 MINOR ARTERIAL



SEDIMENT CONTROL NOTES

- A MINIMUM OF 48 HOURS NOTICE MUST BE GIVEN TO THE HOWARD COUNTY DEPARTMENT OF INSPECTIONS AND PERMITS PRIOR TO THE START OF ANY CONSTRUCTION (313-1085).
- ALL VEGETATIVE AND STRUCTURAL PRACTICES ARE TO BE INSTALLED ACCORDING TO THE PROVISIONS OF THIS PLAN AND ARE TO BE IN CONFORMANCE WITH THE MARYLAND STANDARDS AND SPECIFICATIONS FOR SOIL AND EROSION CONTROL, AND REVISIONS THERETO.
- FOLLOWING INITIAL SOIL DISTURBANCE OR REDISTURBANCE, PERMANENT OR TEMPORARY STABILIZATION SHALL BE COMPLETED WITHIN: A) 7 CALENDAR DAYS FOR ALL PERIMETER SEDIMENT CONTROL STRUCTURES, DIKES, PERIMETER SLOPES AND ALL SLOPES AND ALL SLOPES GREATER THAN 3:1, B) 14 DAYS AS TO OTHER DISTURBED OR GRADED AREAS ON THE PROJECT SITE.
- ALL SEDIMENT TRAPS/BASINS SHOWN MUST BE FENCED AND WARNING SIGNS POSTED AROUND THE PERIMETER IN ACCORDANCE WITH VOL. 1, CHAPTER 12, OF THE HOWARD COUNTY DESIGN MANUAL, STORM DRAINAGE.
- ALL DISTURBED AREAS MUST BE STABILIZED WITHIN THE TIME PERIOD SPECIFIED ABOVE IN ACCORDANCE WITH THE 1981 MARYLAND STANDARDS AND SPECIFICATIONS FOR SOIL AND EROSION CONTROL FOR PERMANENT SEEDINGS (SEC. 51), SOD (SEC. 54), TEMPORARY SEEDING (SEC. 50) AND MULCHING (SEC. 52). TEMPORARY STABILIZATION WITH MULCH ALONGS CAN ONLY BE DONE WHEN RECOMMENDED SEEDING DATES DO NOT ALLOW FOR PROPER GERMINATION AND ESTABLISHMENT OF GRASSES.
- ALL SEDIMENT CONTROL STRUCTURES ARE TO REMAIN IN PLACE AND ARE TO BE MAINTAINED IN OPERATIVE CONDITION UNTIL PERMISSION FOR THEIR REMOVAL HAS BEEN OBTAINED FROM THE HOWARD COUNTY SEDIMENT CONTROL INSPECTOR.
- SITE ANALYSIS:

TOTAL AREA OF SITE	3.64 ACRES
AREA TO BE ROOFED OR PAVED	2.45 ACRES
AREA TO BE VEGETATIVELY STABILIZED	0.16 ACRES
TOTAL CUT	8281 CU. YARDS
TOTAL FILL	1084 CU. YARDS
- ANY SEDIMENT CONTROL PRACTICE WHICH IS DISTURBED BY GRADING ACTIVITY FOR PLACEMENT OF UTILITIES MUST BE REPAIRED ON THE SAME DAY OF DISTURBANCE.
- ADDITIONAL SEDIMENT CONTROLS MUST BE PROVIDED, IF DEEMED NECESSARY BY THE HOWARD COUNTY SEDIMENT CONTROL INSPECTOR.
- SITE GRADING WILL BEGIN ONLY AFTER ALL PERIMETER SEDIMENT CONTROL MEASURES HAVE BEEN INSTALLED AND ARE IN A FUNCTIONING CONDITION.
- SEDIMENT WILL BE REMOVED FROM TRAPS WHEN ITS DEPTH REACHES CLEAN OUT ELEVATION SHOWN ON THE PLANS.
- CUT AND FILL QUANTITIES PROVIDED UNDER SITE ANALYSIS DO NOT REPRESENT BID QUANTITIES. THESE QUANTITIES DO NOT DISTINGUISH BETWEEN TOPSOIL, STRUCTURAL FILL OR EMBANKMENT MATERIAL, NOR DO THEY REFLECT CONSIDERATION OF UNDERCUTTING OR REMOVAL OF UNSUITABLE MATERIAL. THE CONTRACTOR SHALL FAMILIARIZE HIMSELF WITH SITE CONDITIONS WHICH MAY AFFECT THE WORK.
- ON ALL SITES WITH DISTURBED AREAS IN EXCESS OF 2 AC., APPROVAL OF THE INSPECTION AGENCY SHALL BE REQUESTED UPON COMPLETION OF INSTALLATION OF PERIMETER EROSION AND SEDIMENT CONTROLS, BUT BEFORE PROCEEDING WITH ANY OTHER EARTH DISTURBANCE OR GRADING. OTHER BUILDING OR GRADING INSPECTION APPROVALS MAY NOT BE AUTHORIZED UNTIL THIS INITIAL APPROVAL BY THE INSPECTION AGENCY IS MADE.
- TRENCHES FOR THE CONSTRUCTION OF UTILITIES IS LIMITED TO THREE PIPE LENGTHS OR THAT WHICH CAN BE BACKFILLED AND STABILIZED WITHIN ONE WORKING DAY, WHICHEVER IS SHORTER.
- BORROW SITE TO BE PRE-APPROVED BY THE SEDIMENT CONTROL INSPECTOR, OR IN CASE OF EXCESS MATERIAL, AN APPROVED SEDIMENT CONTROL PLAN WILL BE NEEDED TO DEPOSIT EXCESS OFF-SITE.

TEMPORARY SEEDING NOTES

Apply to graded or cleared areas likely to be redisturbed where a short-term vegetative cover is needed.

Seeded Preparation - Loosen upper three inches of soil by raking, disking or other acceptable means before seeding, if not previously loosened.

Soil Amendments - Apply 600 lbs. per acre 10-10-10 fertilizer (14 lbs. per 1000 sq.ft.).

Seeding - For periods March 1 thru April 30 and from August 15 thru November 15, seed with 1-1/2 bushels per acre of annual ryegrass (3.2 lbs. per 1000 sq.ft.). For the period May 1 thru August 14, seed with 3 lbs. per acre of creeping lovegrass (0.07 lbs. per 1000 sq.ft.). For the period November 16 thru February 28, protect site by applying 2 tons per acre of well anchored straw mulch and seed as soon as possible in the spring, or use sod.

Mulching - Apply 1-1/2 to 2 tons per acre (70 to 90 lbs. per 1000 sq.ft.) of unrotted small grain straw immediately after seeding. Anchor mulch immediately after application using mulch anchoring tool or 2lb gal. per acre (5 gal. per 1000 sq.ft.) of emulsified asphalt on flat areas. On slopes, 8 ft. or higher, use 347 gal. per acre (8 gal. per 1000 sq.ft.) for anchoring.

Refer to the 1983 MARYLAND STANDARDS AND SPECIFICATIONS FOR SOIL EROSION AND SEDIMENT CONTROL FOR rate and methods not covered.

PERMANENT SEEDING NOTES

Apply to graded or cleared areas not subject to immediate further disturbance where a permanent long-lived vegetative cover is needed.

Seeded Preparation - Loosen upper three inches of soil by raking, disking or other acceptable means before seeding, if not previously loosened.

Soil Amendments - In lieu of soil test recommendations use one of the following schedules:

- Preferred - Apply 2 tons per acre dolomitic limestone (42 lbs. per 1000 sq.ft.) and 600 lbs. per acre 10-10-10 fertilizer (14 lbs. per 1000 sq.ft.) before seeding. Harrow or disc into upper three inches of soil. At time of seeding, apply 400 lbs. per acre 30-0-0 ureaform fertilizer (4 lbs. per 1000 sq.ft.).
- Acceptable - Apply 2 tons per acre dolomitic limestone (42 lbs. per 1000 sq.ft.) and 1000 lbs. per acre 10-10-10 fertilizer (23 lbs. per 1000 sq.ft.) before seeding. Harrow or disc into upper three inches of soil.


Seeding - For the period March 1 thru April 30 and from August 1 thru October 15, seed with 60 lbs. per acre (1.4 lbs. per 1000 sq.ft.) of Kentucky 31 Tall Fescue. For the period May 1 thru July 31, seed with 60 lbs. Kentucky 31 Tall Fescue per acre and 2 lbs. per acre (0.05 lbs. per 1000 sq.ft.) of emulsified asphalt. During the period October 16 thru February 28, protect site by one of the following options:

- 2 tons per acre of well-anchored mulch straw and seed as soon as possible in the spring.
- Use sod.
- Seed with 60 lbs. per acre Kentucky 31 Tall Fescue and mulch with 2 tons per acre well anchored straw.

Mulching - Apply 1-1/2 to 2 tons per acre (70 to 90 lbs. per 1000 sq.ft.) of unrotted small grain straw immediately after seeding. Anchor mulch immediately after application using mulch anchoring tool or 2lb gal. per acre (5 gal. per 1000 sq.ft.) of emulsified asphalt on flat areas, 8 ft. or higher, use 347 gal. per acre (8 gal. per 1000 sq.ft.) for anchoring.

Maintenance - Inspect all seeded areas and make needed repairs, replacements and reseeding.

DETAIL 23B - AT GRADE INLET PROTECTION

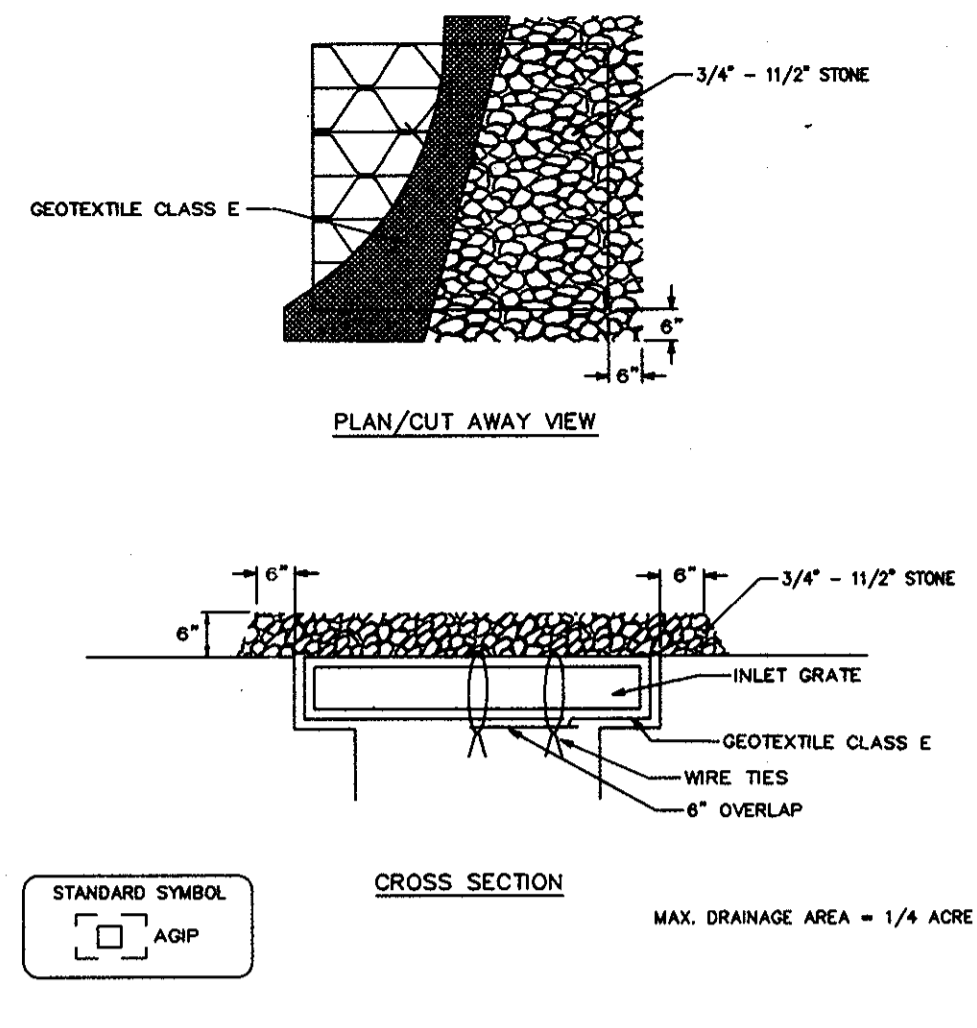


Construction Specifications

- Lift grate and wrap with Geotextile Class E to completely cover all openings, then set grate back in place.
- Place 3/4" to 1 1/2" stone, 4"-8" thick on the grate to secure the fabric and provide additional filtration.

U.S. DEPARTMENT OF AGRICULTURE SOIL CONSERVATION SERVICE PAGE E-18-5A MARYLAND DEPARTMENT OF ENVIRONMENT WATER MANAGEMENT ADMINISTRATION

DETAIL 24 - STABILIZED CONSTRUCTION ENTRANCE

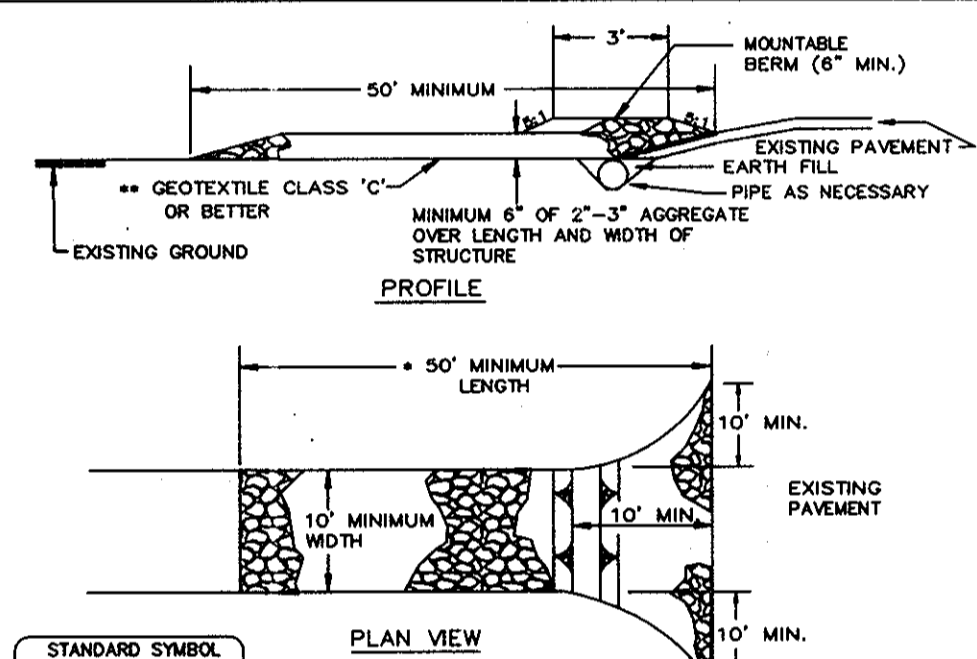


Construction Specifications

- Length - minimum of 50' (*30' for single residence lot).
- Width - 10' minimum, should be flared at the existing road to provide a turning radius.
- Geotextile fabric (filter cloth) shall be placed over the existing ground prior to placing stone. **The plan approval authority may not require single family residences to use geotextile.
- Stone - crushed aggregate (2" to 3") or reclaimed or recycled concrete equivalent shall be placed at least 6" deep over the length and width of the entrance.
- Surface Water - all surface water flowing to or diverted toward construction entrances shall be piped through the entrance, maintaining positive drainage. Pipe installed through the stabilized construction entrance shall be protected with a mounded berm with 5:1 slopes and a minimum of 6" of stone over the pipe. Pipe has to be drained according to the drainage. When the SCE is located at a high spot and has no drainage to convey a pipe will not be necessary. Pipe should be sized according to the amount of runoff to be conveyed.
- Location - A stabilized construction entrance shall be located at every point where construction traffic enters or leaves a construction site. Vehicles leaving the site must travel over the entire length of the stabilized construction entrance.

U.S. DEPARTMENT OF AGRICULTURE SOIL CONSERVATION SERVICE PAGE E-17-3 MARYLAND DEPARTMENT OF ENVIRONMENT WATER MANAGEMENT ADMINISTRATION

DETAIL 33 - SUPER SILT FENCE

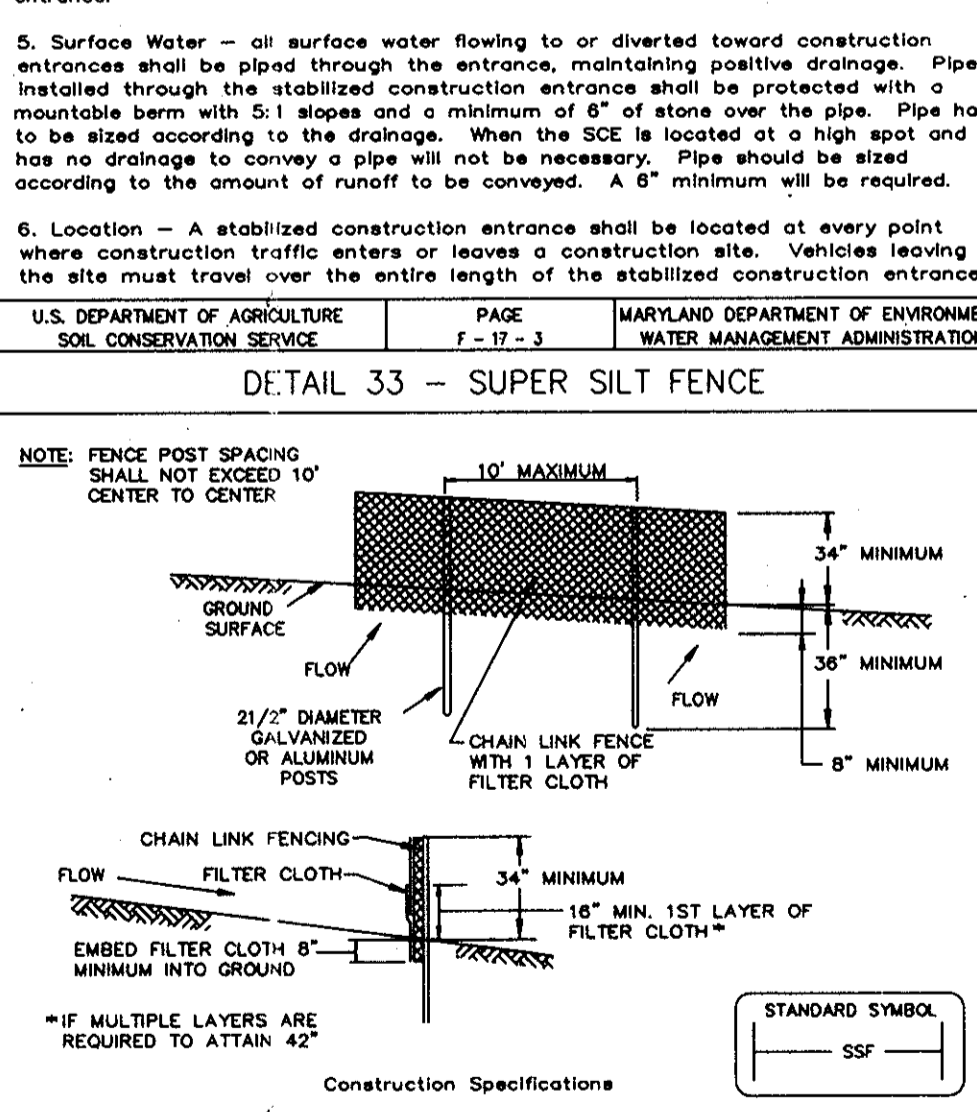

Construction Specifications


- Fencing shall be 42" in height and constructed in accordance with the latest Maryland State Highway Details for Chain Link Fencing. The specification for a 6" fence shall be used, substituting 42" fabric and 6" length posts.
- Chain link fence shall be fastened securely to the fence posts with wire ties. The lower tension wire, brace and brace rods, drive anchors and post caps are not required except on the ends of the fence.
- Filter cloth shall be fastened securely to the chain link fence with ties spaced every 24" at the top and mid section.
- Filter cloth shall be embedded a minimum of 8" into the ground.
- When two sections of filter cloth adjoin each other, they shall be overlapped by 6" and fastened.
- Maintenance shall be performed as needed and all bulges removed when "bulges" develop in the silt fence, or when silt reaches 50% of fence height.
- Filter cloth shall be fastened securely to each fence post with wire ties or staples at top and mid section and shall meet the following requirements for Geotextile Class F:

Tensile Strength	50 lbs/in (min.)	Test: MSMT 509
Tensile Modulus	20 lbs/in (min.)	Test: MSMT 509
Flow Rate	0.2 gal./ft ² /min (max.)	Test: MSMT 322
Filtering Efficiency	75% (min.)	Test: MSMT 322

U.S. DEPARTMENT OF AGRICULTURE SOIL CONSERVATION SERVICE PAGE E-28-3 MARYLAND DEPARTMENT OF ENVIRONMENT WATER MANAGEMENT ADMINISTRATION


SEQUENCE OF CONSTRUCTION

- OBTAIN GRADING PERMIT.
- INSTALL STABILIZED CONSTRUCTION ENTRANCE, SUPER SILT FENCE. (2 DAYS)
- ROUGH GRADE SITE. (1 WEEK)
- AS SUBGRADE ELEVATIONS ARE ESTABLISHED, INSTALL STORM DRAINS WITH INLET PROTECTION, WATER AND SEWER UTILITIES. (2 WEEKS)
- INSTALL CURB AND GUTTER AND PAVE ROADWAYS. (10 DAYS)
- FINE GRADE SITE. STABILIZE DISTURBED AREAS IN ACCORDANCE WITH PERMANENT SEEDING NOTES AS NECESSARY. (10 DAYS)
- INSTALL STREET LIGHTS, LANDSCAPING, AND SIGNS AS REQUIRED. (5 DAYS)
- UPON APPROVAL OF THE HOWARD COUNTY DILP SEDIMENT CONTROL INSPECTOR, REMOVE ALL SEDIMENT CONTROL DEVICES AND STABILIZE ALL REMAINING AREAS IN ACCORDANCE WITH THE PERMANENT SEEDING NOTES. (1 DAYS)

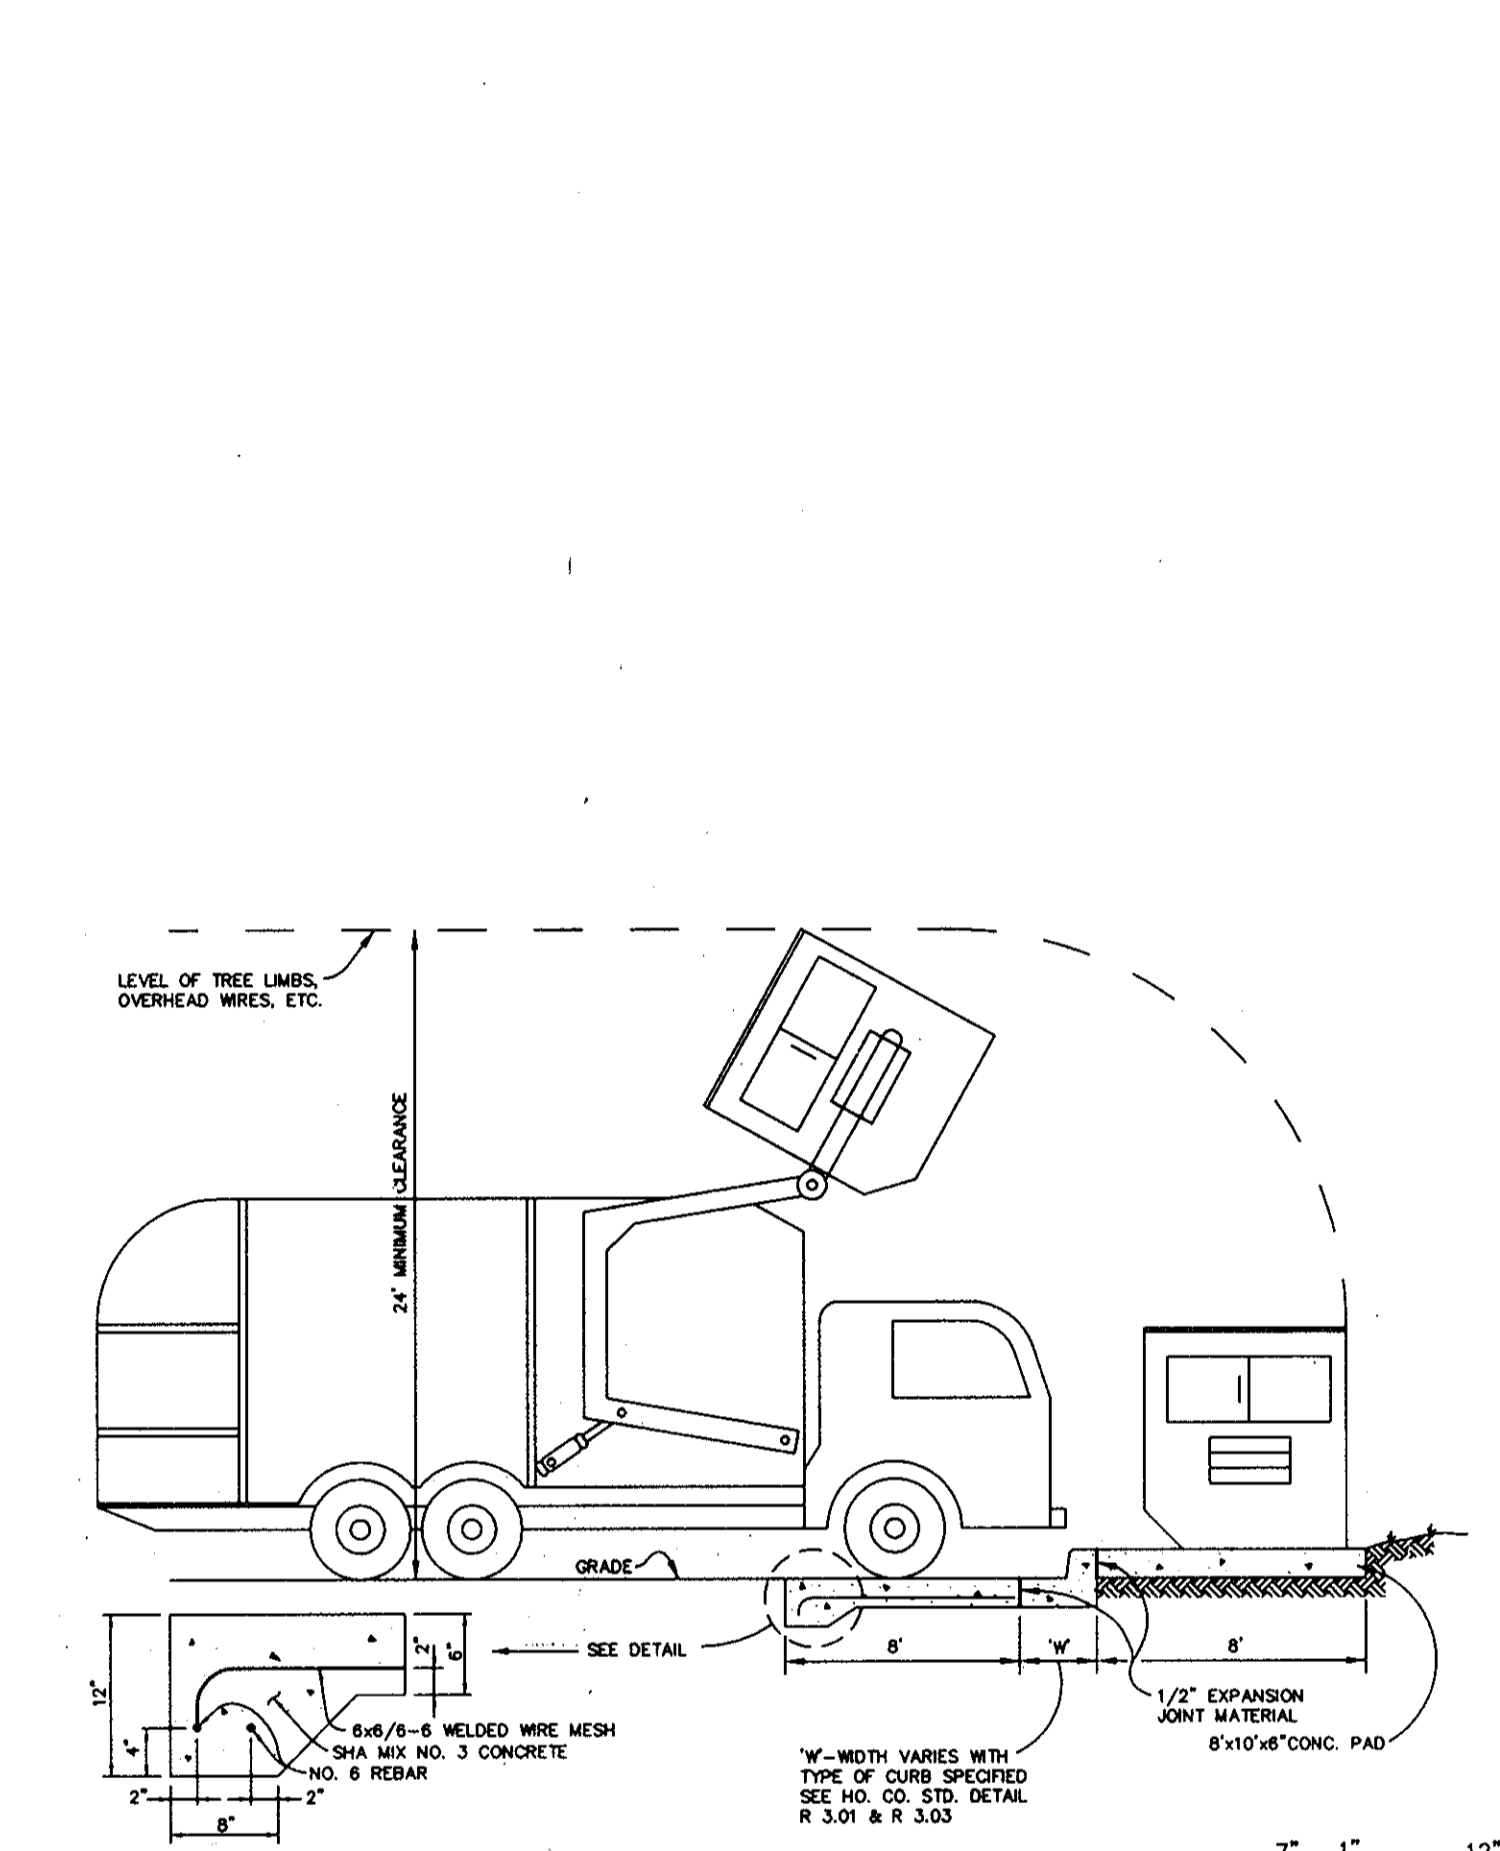

DUMPSTER PAD
NO SCALE

DETAIL 23C - CURB INLET PROTECTION

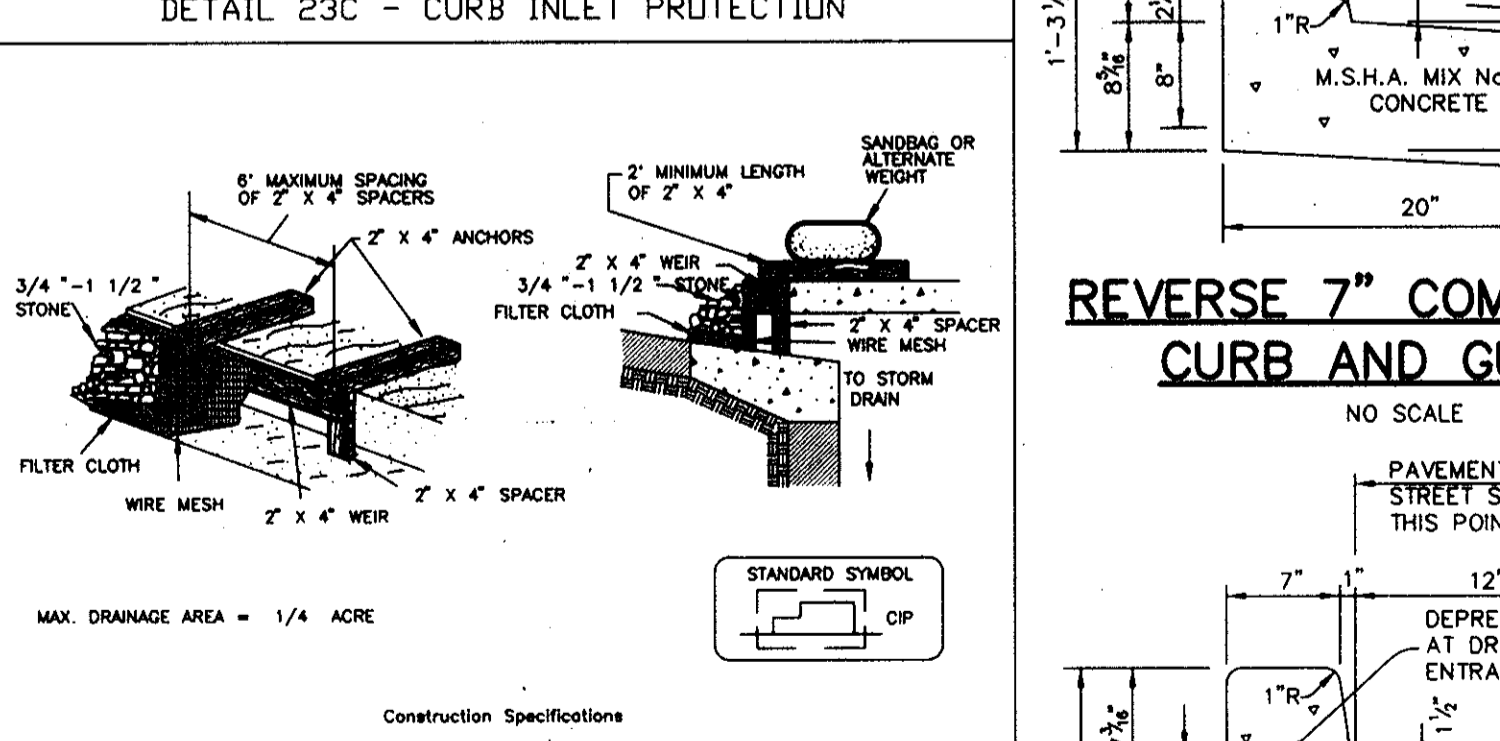

Construction Specifications

- Attach a continuous piece of wire mesh (30" minimum width by throat length plus 2" to the 2" x 4" wall (measuring throat length plus 2") as shown on the standard drawing).
- Place a continuous piece of Geotextile Class E the same dimensions as the wire mesh over the wire mesh and securely attach it to the 2" x 4" wall.
- Securely nail the 2" x 4" wall to a 6" long vertical spacer to be located between the wall and the inlet face (max. 4" apart).
- The assembly shall be placed so that the end anchors are a minimum 1" beyond both ends of the throat opening.
- Form the 1/2" x 1/2" wire mesh and the geotextile filter to the concrete gutter and attach the face of the curb on both sides of the inlet. Place clean 3/4" x 1 1/2" stone over the wire mesh and geotextile in such a manner to prevent water from entering the inlet, under or around the gutter.
- This type of protection must be inspected frequently and the filter cloth and stone replaced when clogged with sediment.
- Assure that storm flow does not bypass the inlet by installing a temporary earth or asphalt dike to direct the flow to the inlet.

U.S. DEPARTMENT OF AGRICULTURE SOIL CONSERVATION SERVICE PAGE E-16-38 MARYLAND DEPARTMENT OF ENVIRONMENT WATER MANAGEMENT ADMINISTRATION

7.6 STANDARD AND SPECIFICATIONS

FOR TOPSOIL

Definition

Placement of topsoil over a prepared subsoil prior to establishment of permanent vegetation.

Purpose

To provide a suitable soil medium for vegetative growth. Soils of concern have low moisture content, low nutrient levels, low pH, materials toxic to plants, and/or unacceptable soil gradation.

Conditions Where Practice Applies

- This practice is limited to areas having 2:1 or flatter slopes where:
 - The texture of the exposed subsoil/parent material is not adequate to produce vegetative growth.
 - The soil material is so shallow that the rooting zone is not deep enough to support plants or furnish containing supplies of moisture and plant nutrients.
 - The original soil to be vegetated contains material toxic to plant growth.
 - The soil is so acidic that treatment with limestone is not feasible.
- For the purpose of these Standards and Specifications, areas having slopes steeper than 2:1 require special consideration and design for adequate stabilization. Areas having slopes steeper than 2:1 shall have the appropriate stabilization shown on the plan.

Construction and Material Specifications

- Topsoil salvaged from the existing site may be used provided that it meets the standards as set forth in these specifications. Typically, the depth of topsoil to be salvaged for a given soil type can be found in the representative soil profile section in the Soil Survey published by USDA-SCS in cooperation with Maryland Agricultural Experiment Station.
- Topsoil Specifications - Soil to be used as topsoil must meet the following:
 - Topsoil shall be a loam, sandy loam, clay loam, silt loam, sandy clay loam, loamy sand. Other soils may be used if recommended by an agronomist or soil scientist and approved by the appropriate approval authority. The topsoil shall be a minimum of 6" containing nutrient substances and shall contain less than 5% by volume of clods, stones, slag, coarse fragments, gravel, sticks, roots, trash, or other materials larger than 1 1/4" in diameter.
 - Topsoil must be free of plants or plant parts such as bermuda grass, quackgrass, Johanna grass, weeds, poison ivy, thistle, or others as specified.
 - Where the subsoil is either highly acidic or composed of heavy clay, ground limestone shall be spread at the rate of 4-8 tons/acre (200-400 pounds per 1,000 square feet) prior to the placement of topsoil. Lime shall be distributed uniformly over designated areas and worked into the soil in conjunction with tillage operations as described in the following procedures.
 - For sites having disturbed areas under 5 acres:
 - Place topsoil (if required) and apply soil amendments as specified in 20.0 Vegetative Stabilization - Section I - Vegetative Stabilization Methods and Materials.
 - For sites having disturbed areas over 5 acres:
 - On soil meeting Topsoil specifications, obtain test results dictating fertilizer and lime amendments required to bring the soil into compliance with the following:
 - pH for topsoil shall be between 6.0 and 7.5. If the tested soil demonstrates a pH of less than 6.0, sufficient lime shall be prescribed to raise the pH to 6.5 or higher.
 - Organic content of topsoil shall be not less than 1.5 percent by weight.
 - Topsoil having soluble salt content greater than 500 parts per million shall not be used.
 - No sod or seed shall be placed on soil which has been treated with soil sterilants or chemicals used for weed control until sufficient time has elapsed (14 days min.) to permit dissipation of phytotoxic materials.
 - Note: Topsoil substitutes or amendments, as recommended by a qualified agronomist or soil scientist approved by the appropriate approval authority, may be used in lieu of annual topsoil.
 - Place topsoil (if required) and apply soil amendments as specified in 20.0 Vegetative Stabilization - Section I - Vegetative Stabilization Methods and Materials.
- Topsoil Application
 - When topsoiling, maintain needed erosion and sediment control practices such as diversions, Grade Stabilization Structures, Bank Dikes, Slope Stiff Fences and Sediment Traps and Basins.
 - Grades on the areas to be topsoiled, which have been previously established, shall be maintained, about 4" higher in diversion.
 - Topsoil shall be uniformly distributed in a 4" - 8" layer and lightly compacted to a minimum thickness of 4". Spreading shall be performed in such a manner that sodding or seeding can proceed with a minimum of additional soil preparation and tillage. Any irregularities in the surface resulting from topsoiling or other operations shall be corrected in order to prevent the formation of depressions or water pockets.
 - Topsoil shall not be placed while the topsoil or subsoil is in a frozen or muddy condition, when the grading is excessively wet or in a condition that may otherwise be detrimental to proper grading and seedbed preparation.
- Alternative for Permanent Seeding - Instead of applying the full amount of lime and commercial fertilizer, composted sludge and amendments may be applied as specified below:
 - Composted Sludge Material for use as a soil conditioner for sites having disturbed areas over 5 acres shall be used to generate amendments and for sites having disturbed areas under 5 acres shall conform to the following requirements:
 - Composted sludge shall be applied by, or originate from, a person or person that has permitted (at the time of acquisition of the compost) by the Maryland Department of the Environment under COMAR 26.04.06.
 - Composted sludge shall contain at least 1 percent nitrogen, 1.5 percent phosphorus, and 0.2 percent potassium and have a pH of 7.0 to 8.0. If compost does not meet these requirements, the appropriate constituents must be added to meet the requirements prior to use.
 - Composted sludge shall be applied at a rate of 1 to 2,000 square feet.
 - Composted sludge shall be amended with a potassium fertilizer applied at the rate of 4 lbs/1,000 square feet, and 1/3 the normal lime application rate.

References: Guidelines Specifications, Soil Preparation and Sodding, MD-VA, Pub. #1, Cooperative Extension Service, University of Maryland and Virginia Polytechnic Institute, Revised 1973.

BY THE DEVELOPER :

I/WE CERTIFY THAT ALL DEVELOPMENT AND CONSTRUCTION WILL BE DONE ACCORDING TO THIS PLAN, AND THAT ANY RESPONSIBLE PERSONNEL INVOLVED IN THE CONSTRUCTION PROJECT WILL HAVE A CERTIFICATE OF ATTENDANCE AT A DEPARTMENT OF THE ENVIRONMENT APPROVED TRAINING PROGRAM FOR THE CONTROL OF SEDIMENT AND EROSION BEFORE BEGINNING THE PROJECT. I ALSO AUTHORIZE PERIODIC ON-SITE INSPECTIONS BY THE HOWARD SOIL CONSERVATION DISTRICT.

James Boyd 10.9.96
DEVELOPER DATE

BY THE ENGINEER :

I CERTIFY THAT THIS PLAN FOR EROSION AND SEDIMENT CONTROL REPRESENTS A PRACTICAL AND WORKABLE PLAN BASED ON MY PERSONAL KNOWLEDGE OF THE SITE CONDITIONS AND THAT IT WAS PREPARED IN ACCORDANCE WITH THE REQUIREMENTS OF THE HOWARD SOIL CONSERVATION DISTRICT.

J. Sarell 10.10.96
ENGINEER DATE

THESE PLANS HAVE BEEN REVIEWED FOR THE HOWARD SOIL CONSERVATION DISTRICT AND MEET THE TECHNICAL REQUIREMENTS FOR SOIL EROSION AND SEDIMENT CONTROL.

J. L. Warfield 10/15/96
NATURAL RESOURCES CONSERVATION SERVICE DATE

THIS DEVELOPMENT PLAN IS APPROVED FOR SOIL EROSION AND SEDIMENT CONTROL BY THE HOWARD SOIL CONSERVATION DISTRICT.

John R. Robertson 10/15/96
HOWARD SOIL CONSERVATION DISTRICT DATE

APPROVED : FOR PUBLIC WATER AND PUBLIC SEWERAGE SYSTEMS, HOWARD COUNTY HEALTH DEPARTMENT.


Coyce M. Boyd MD 10/15/96
COUNTY HEALTH OFFICER DATE

APPROVED : HOWARD COUNTY DEPARTMENT OF PLANNING AND ZONING.

Angela S. Suter 10/23/96
DIRECTOR DATE

John D. Williams 10/15/96
CHIEF, DEVELOPMENT ENGINEERING DIVISION DATE

Richard Blood 10/22/96
CHIEF, DIVISION OF LAND DEVELOPMENT AND RESEARCH DATE

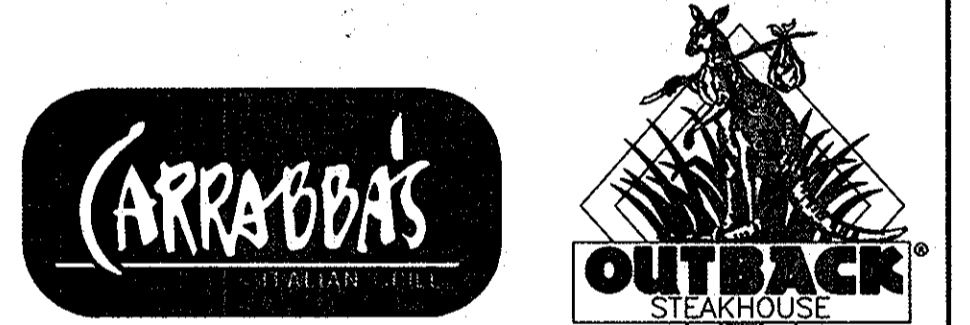

DATE	NO.	REVISION

OWNER: OPUS EAST, L.L.C. 6707 DEMOCRACY BLVD. SUITE 510 BETHESDA, MD 20817 (301) 493-4464

DEVELOPER: OUTBACK STEAKHOUSE 550 NORTH REO ST. SUITE 200 TAMPA, FL 33609 (813) 282-1225

PROJECT: OUTBACK STEAKHOUSE/CARRABBA'S TWO RESTAURANT BUILDINGS

AREA: TAX MAPS 24 & 30 PARCELS J&K 2nd ELECTION DISTRICT HOWARD COUNTY, MARYLAND

TITLE: NOTES AND DETAILS

RIEMER MUEGGE & ASSOCIATES, INC.
ENGINEERING & ENVIRONMENTAL SERVICES • PLANNING • SURVEYING
8818 Centre Park Drive, Columbia, Maryland 21045
tel 410.997.8900 fax 410.997.9282

DATE: 10.10.96

DESIGNED BY: CJR

DRAWN BY: RPP/DAM


PROJECT NO.: HOC0496E4701 C-5, DMS

DATE: OCTOBER 10, 1996

SCALE: AS SHOWN

DRAWING NO.: 5 OF 6

REVERSE 7" COMBINATION CURB AND GUTTER

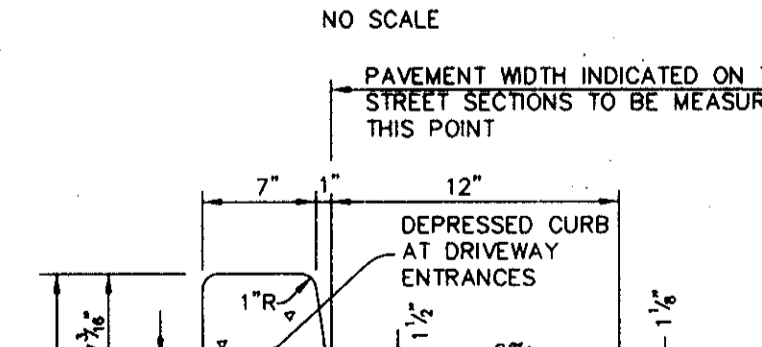

Construction Specifications


- Attach a continuous piece of wire mesh (30" minimum width by throat length plus 2" to the 2" x 4" wall (measuring throat length plus 2") as shown on the standard drawing).
- Place a continuous piece of Geotextile Class E the same dimensions as the wire mesh over the wire mesh and securely attach it to the 2" x 4" wall.
- Securely nail the 2" x 4" wall to a 6" long vertical spacer to be located between the wall and the inlet face (max. 4" apart).
- The assembly shall be placed so that the end anchors are a minimum 1" beyond both ends of the throat opening.
- Form the 1/2" x 1/2" wire mesh and the geotextile filter to the concrete gutter and attach the face of the curb on both sides of the inlet. Place clean 3/4" x 1 1/2" stone over the wire mesh and geotextile in such a manner to prevent water from entering the inlet, under or around the gutter.
- This type of protection must be inspected frequently and the filter cloth and stone replaced when clogged with sediment.
- Assure that storm flow does not bypass the inlet by installing a temporary earth or asphalt dike to direct the flow to the inlet.

U.S. DEPARTMENT OF AGRICULTURE SOIL CONSERVATION SERVICE PAGE E-16-38 MARYLAND DEPARTMENT OF ENVIRONMENT WATER MANAGEMENT ADMINISTRATION

STANDARD 7" COMBINATION CURB AND GUTTER

NO SCALE


P-2 PAVING

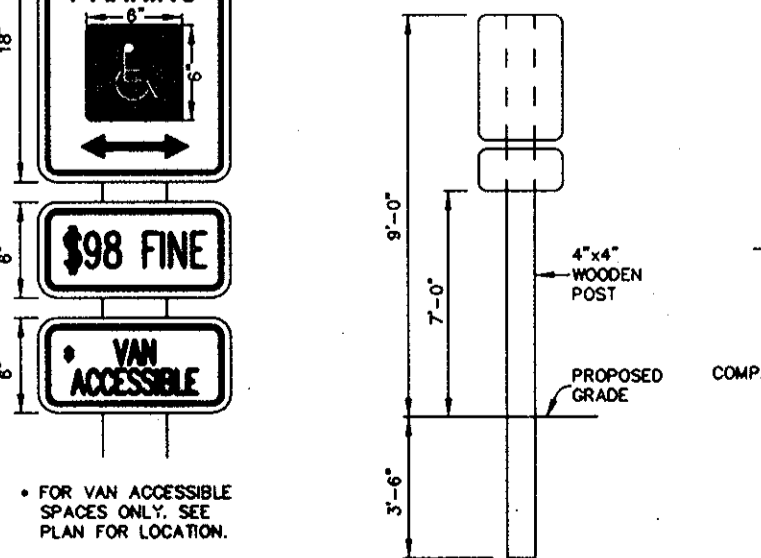

HANDICAP SIGN DETAIL



NO SCALE

SIDEWALK DETAIL

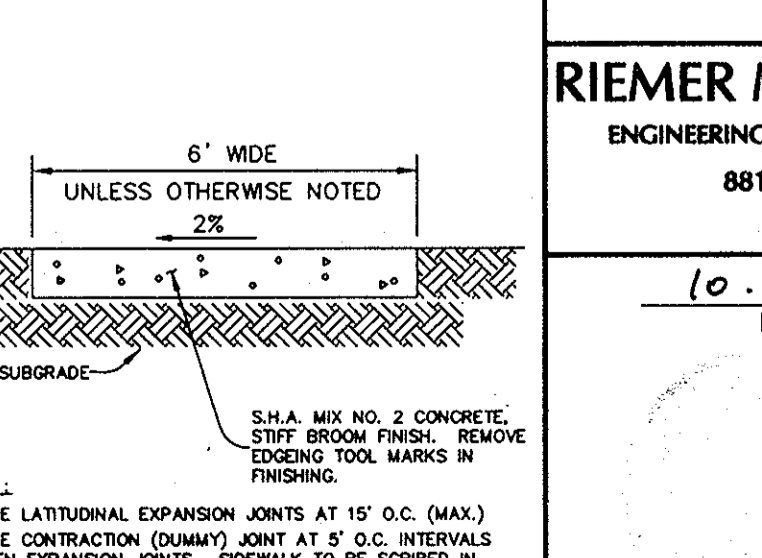


RESERVED PARKING

NO SCALE

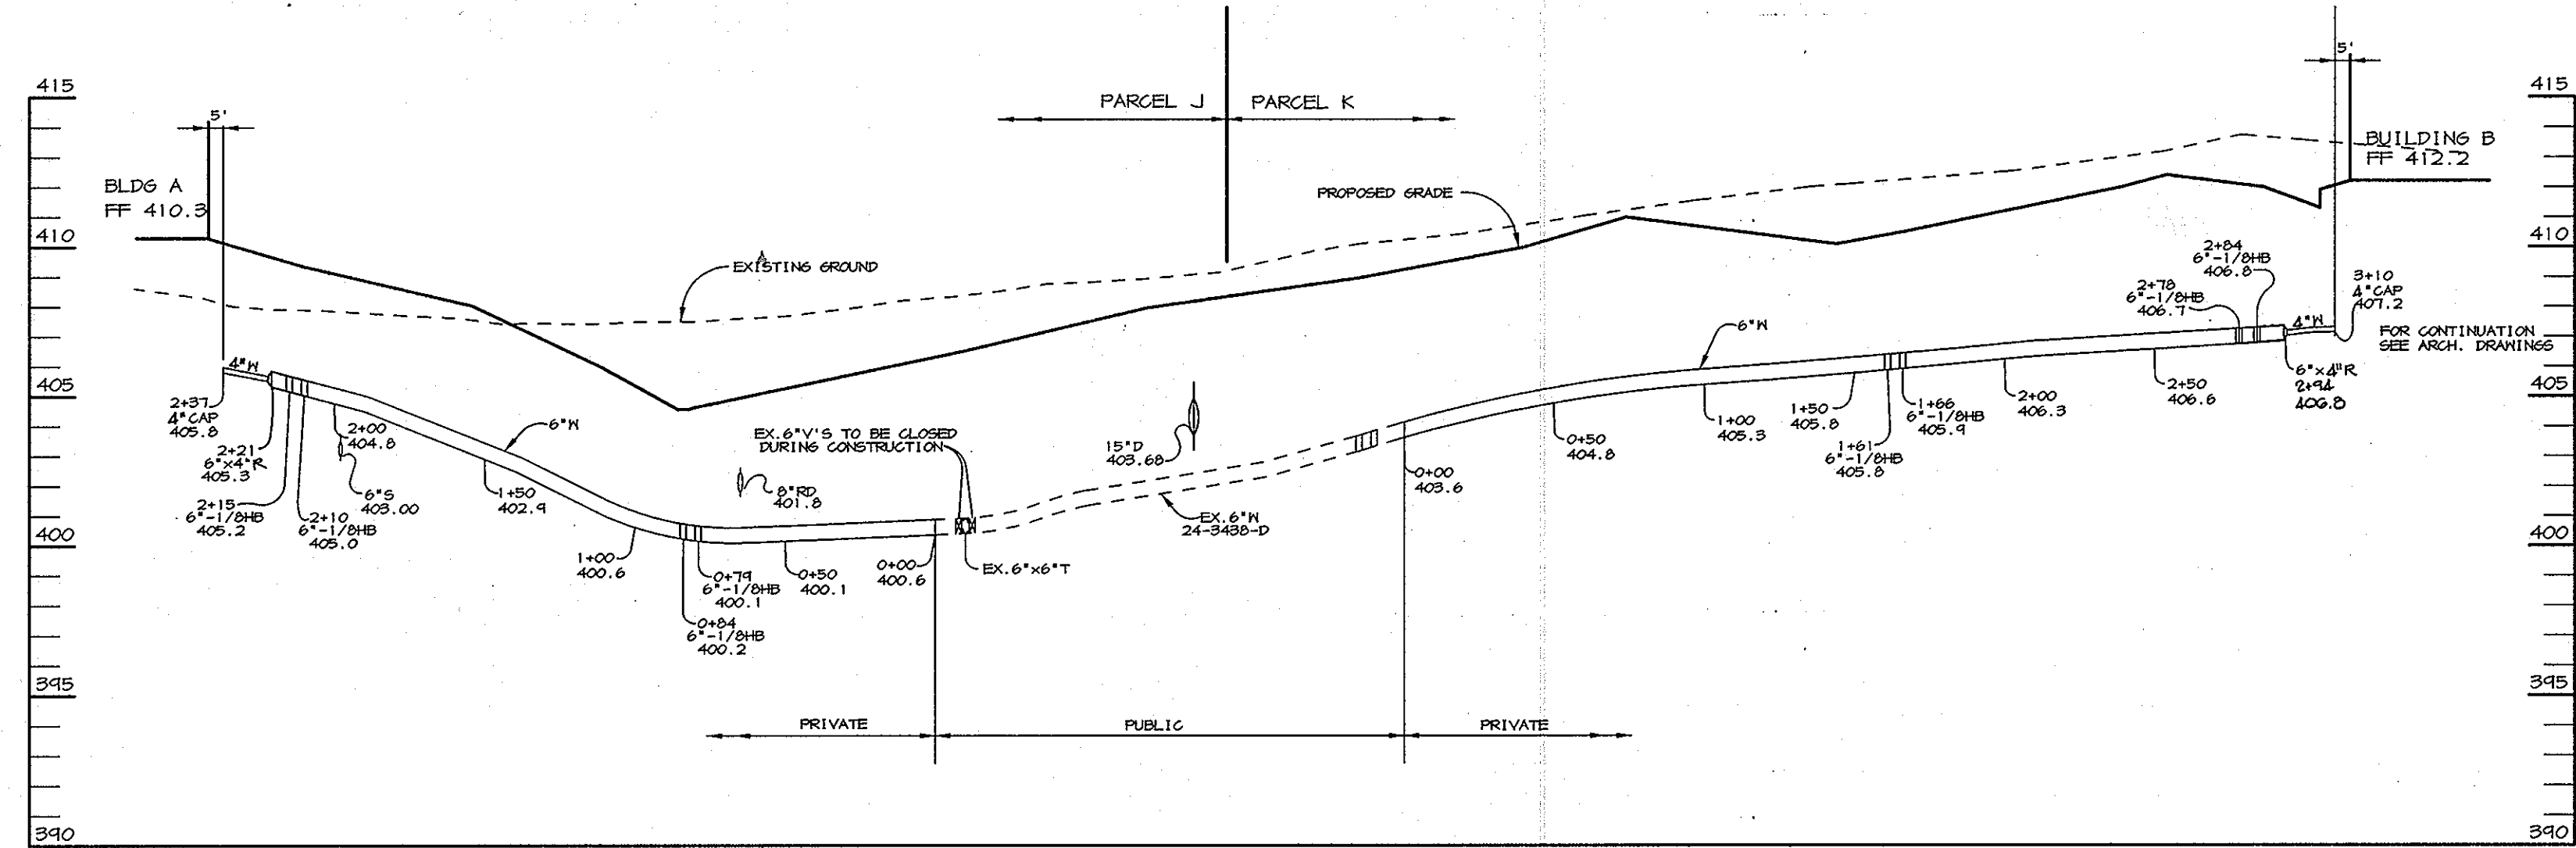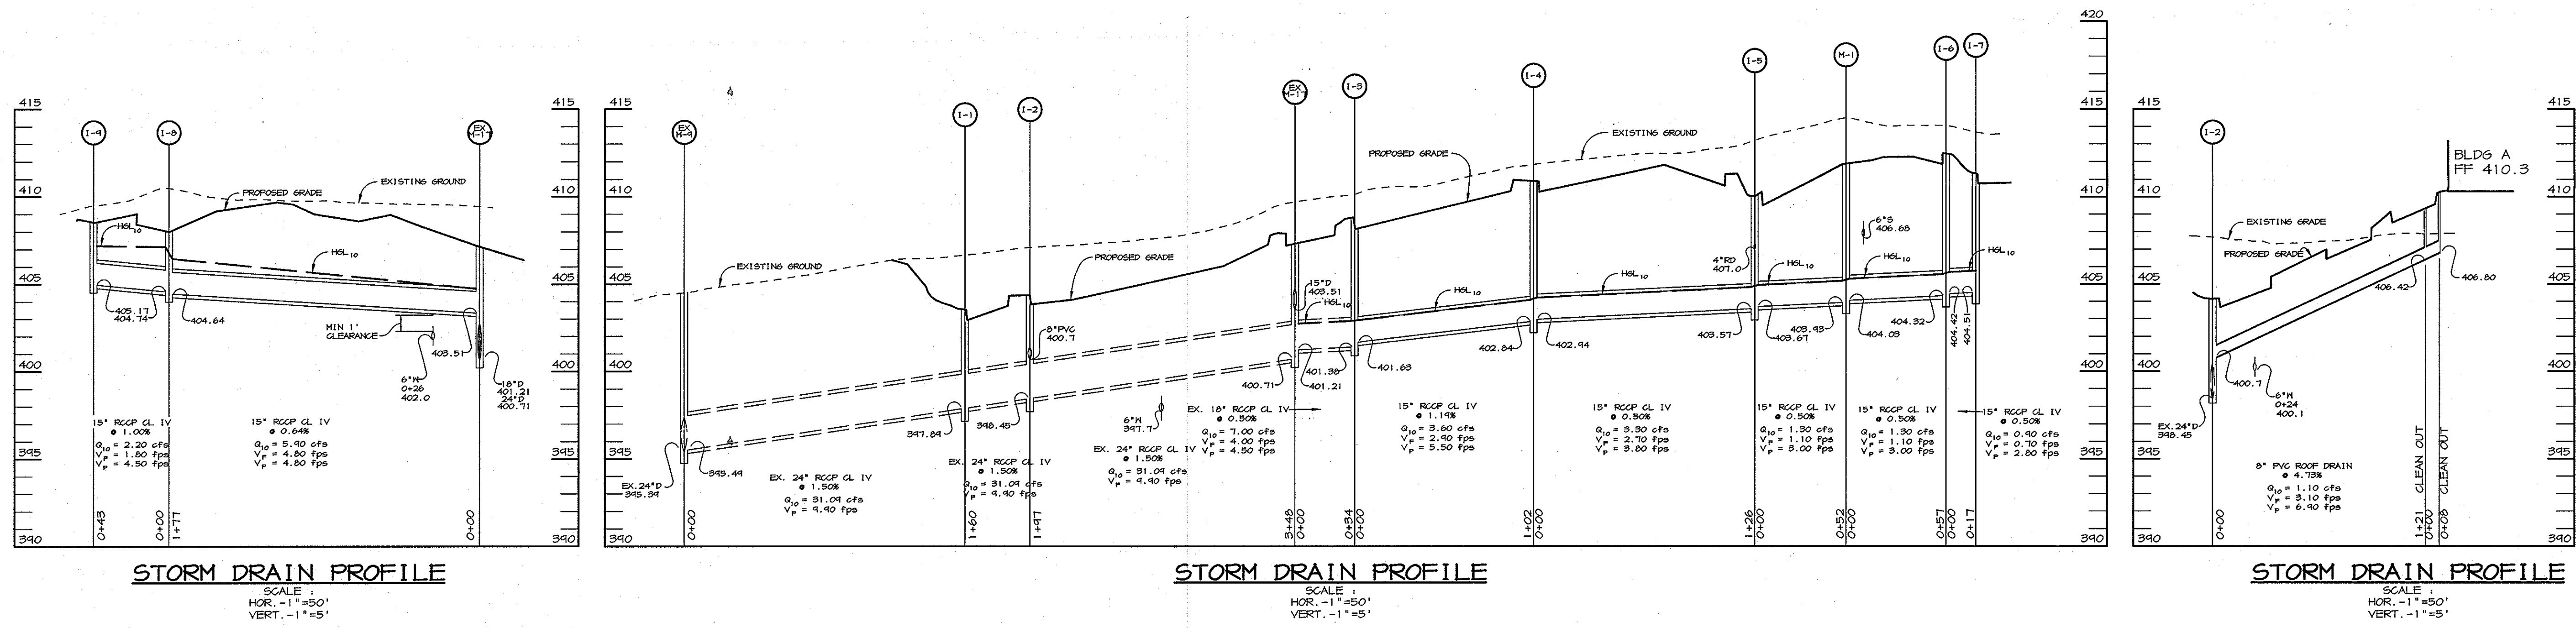

WATER PROFILE
SCALE: HOR. - 1"=50', VERT. - 1"=5'

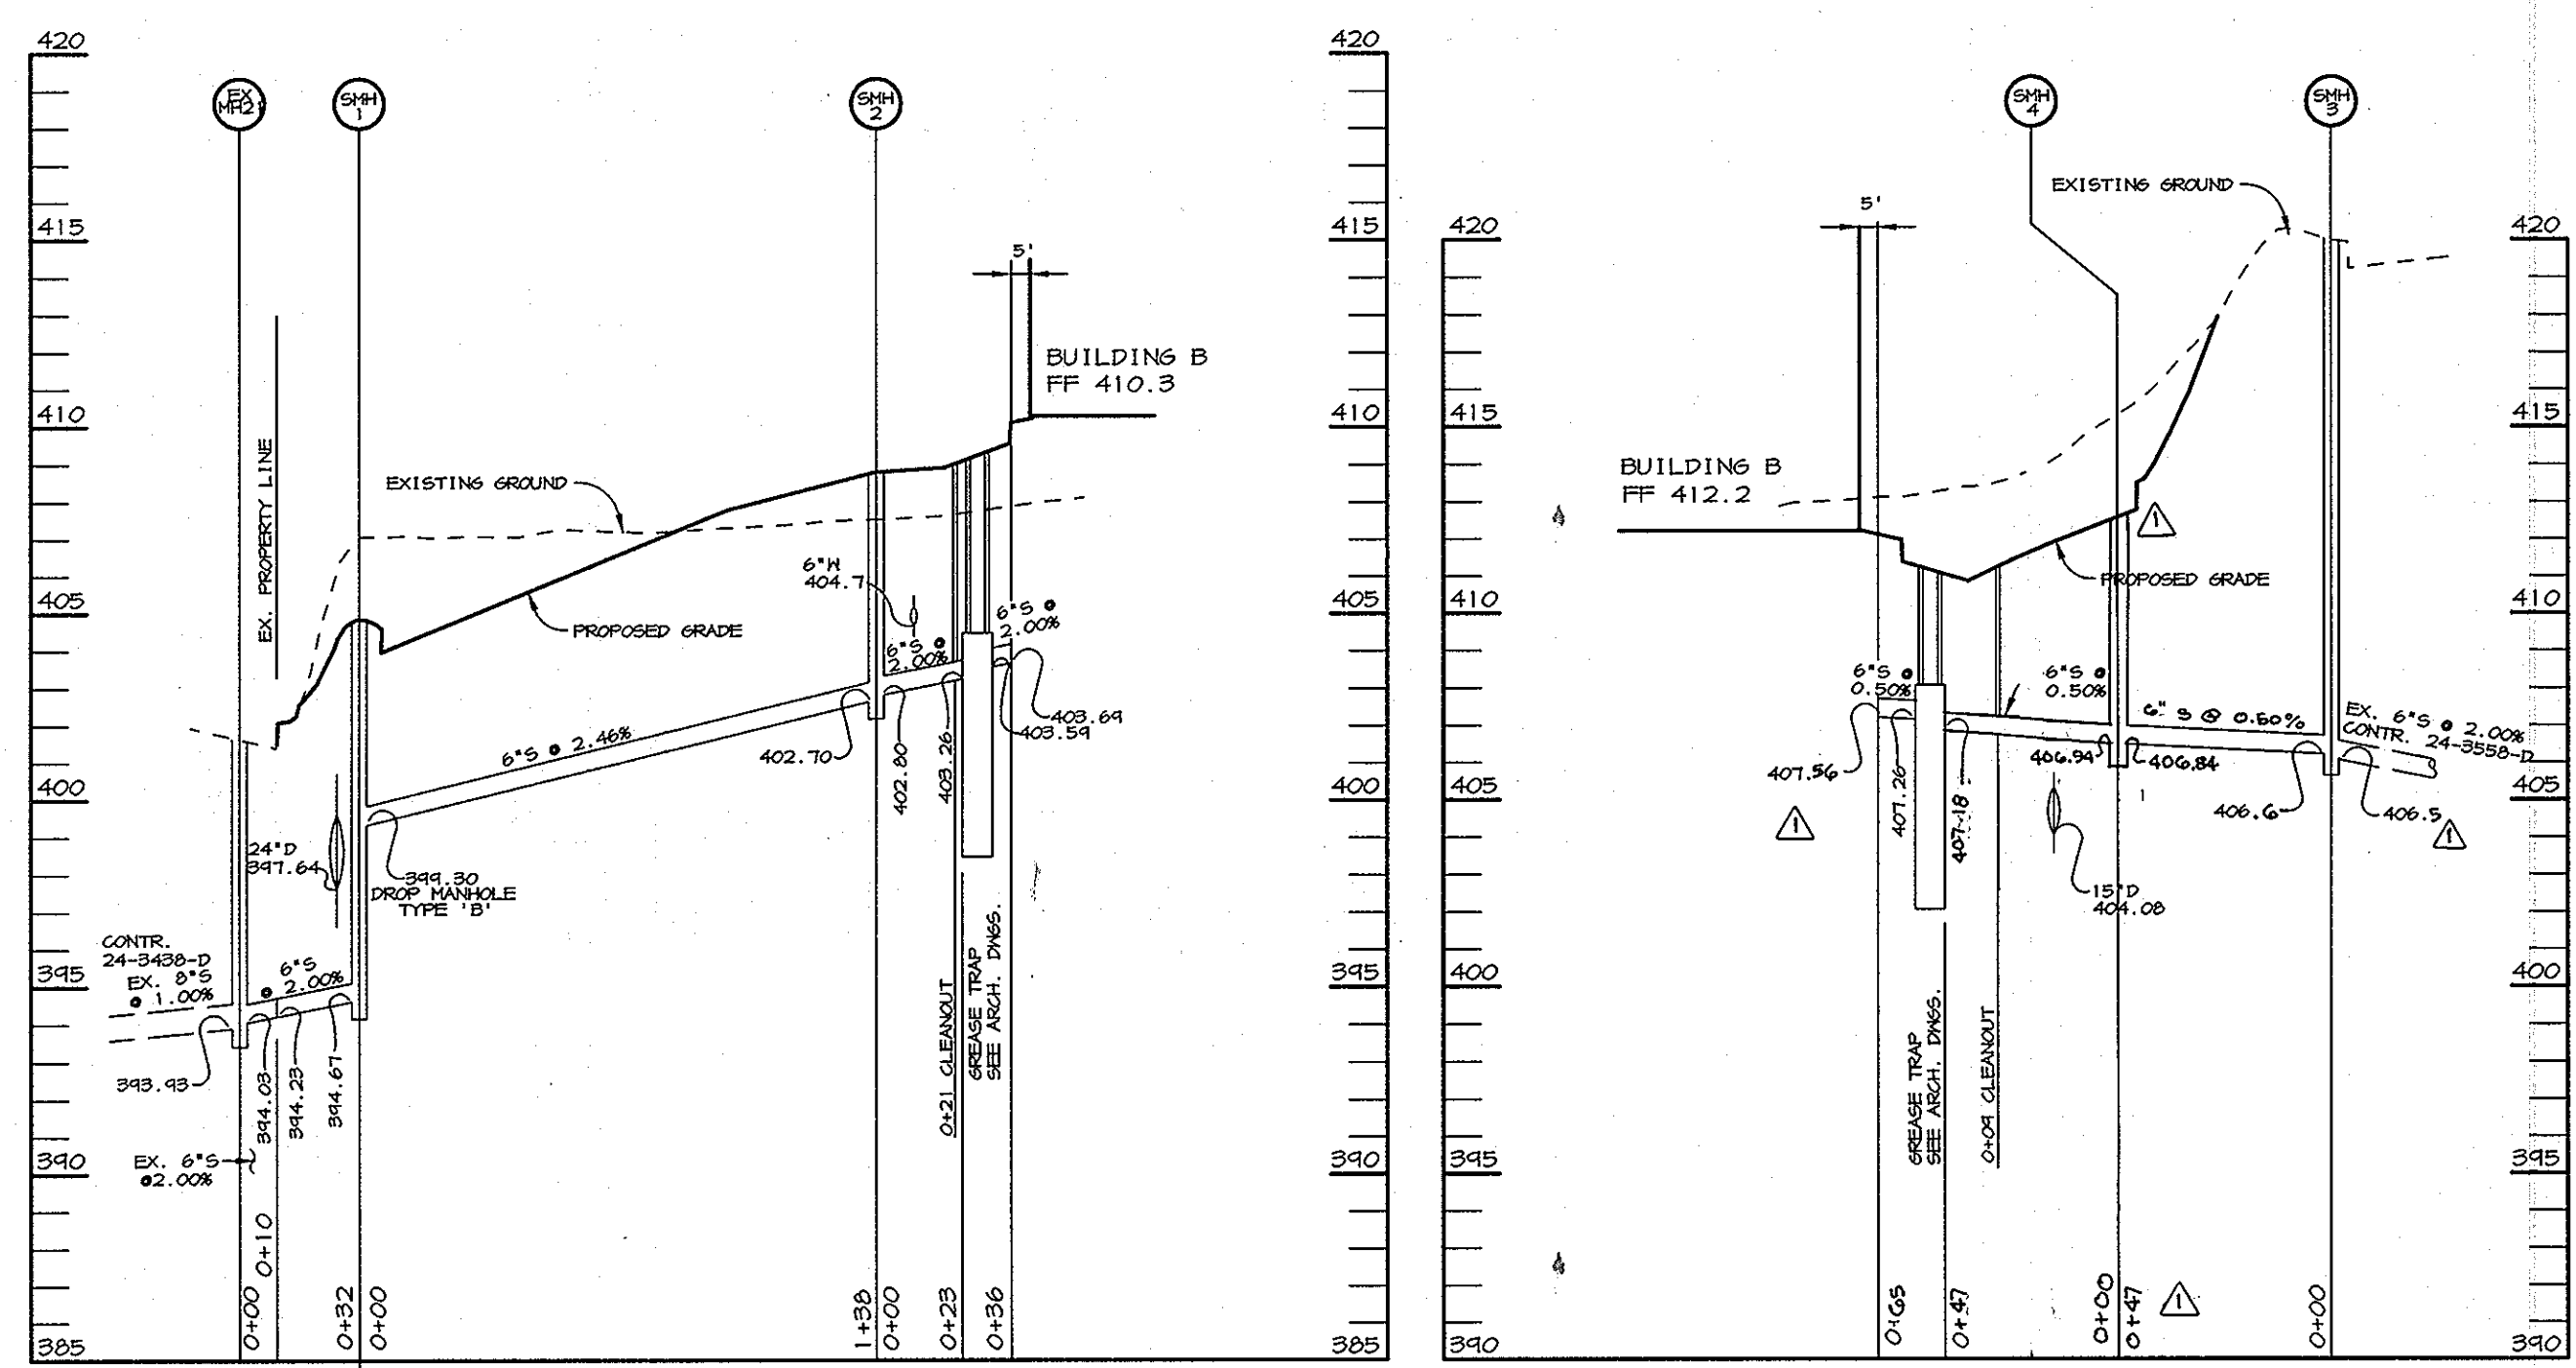

STORM DRAIN STRUCTURE SCHEDULE

NO.	TYPE	LOCATION	INV. IN	INV. OUT	TOP ELEV.	REMARKS
I-1	A-5	SEE PLAN	-	397.84	403.4	HOCO STD. DETAIL SD 4.01
I-2	A-5	SEE PLAN	-	398.45	404.3	HOCO STD. DETAIL SD 4.01
I-3	A-5	SEE PLAN	401.63	401.38	408.6	HOCO STD. DETAIL SD 4.01
I-4	A-5	SEE PLAN	402.94	402.84	410.6	HOCO STD. DETAIL SD 4.01
I-5	A-5	SEE PLAN	403.67	403.57	409.4	HOCO STD. DETAIL SD 4.01
I-6	A-5	SEE PLAN	404.42	404.32	412.3	HOCO STD. DETAIL SD 4.01
I-7	A-5	SEE PLAN	-	404.51	411.2	HOCO STD. DETAIL SD 4.01
I-8	S INLET IV RET. GRATE	SEE PLAN	404.74	404.64	408.0*	HOCO STD. DETAILS SD 4.22, 4.93
I-9	A-5	SEE PLAN	-	405.17	408.4	HOCO STD. DETAIL SD 4.01
M-1	4" MH	SEE PLAN	404.03	403.93	411.7	HOCO STD. DETAIL SD 5.12

* DENOTES TOP OF GRATE ELEVATION

SANITARY SEWER STRUCTURE SCHEDULE

NO.	TYPE	LOCATION	INV. IN	INV. OUT	TOP ELEV.	REMARKS
SMH-1	4" MH	SEE PLAN	399.30	394.67	404.80	HOCO STD. DETAIL SD 5.12
SMH-2	4" MH	SEE PLAN	402.80	402.70	408.9	HOCO STD. DETAIL SD 5.12
SMH-3	4" MH	SEE PLAN	406.6	406.5	420.0	HOCO STD. DETAIL SD 5.12
SMH-4	4" MH	SEE PLAN	406.94	406.84	411.75	HOCO STD. DETAIL SD 5.12

APPROVED: FOR PUBLIC WATER AND PUBLIC SEWERAGE SYSTEMS, HOWARD COUNTY HEALTH DEPARTMENT.

Donce M. Boyd M.D. (C) 10/19/96
COUNTY HEALTH OFFICER *MR* DATE

APPROVED: HOWARD COUNTY DEPARTMENT OF PLANNING AND ZONING.

James S. Smith 10/23/96
DIRECTOR DATE

Chris Deussen 10/17/96
CHIEF, DEVELOPMENT ENGINEERING DIVISION DATE

Richard Blouel 10/23/96
CHIEF, DIVISION OF LAND DEVELOPMENT AND RESEARCH DATE

12-13-96 MODIFIED SEWER PROFILE SAN SEWER STRUC. SCHED TO REFLECT RELOC. OF SM# 6 3&4.

DATE	NO.	REVISION

OWNER: OPUS EAST, L.L.C. 6707 DEMOCRACY BLVD. SUITE 510 BETHESDA, MD 20817 (301) 493-4464

DEVELOPER: OUTBACK STEAKHOUSE 550 NORTH REO ST. SUITE 200 TAMPBA, FL 33609 (813) 282-1225

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8818 Centre Park Drive, Columbia, Maryland 21045
tel 410.997.8900 fax 410.997.9282

DATE: 10.10.96

DESIGNED BY: CJR
DRAWN BY: RFP/DAM
PROJECT NO: HOCO96E4701 C-4.DWG
DATE: OCTOBER 10, 1996
SCALE: AS SHOWN
DRAWING NO. 4 OF 6

J. Parekh
JAYKANT D. PAREKH #19148