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	SHEET INDEX							
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SITE DEVELOPMENT PLAN SECOND DISTRICT FIRE STATION

2nd ELECTION DISTRICT HOWARD COUNTY, MARYLAND CAPITAL PROJECT NO. F-5247

N 517650 SCALE: 1"=100'

WATER AND SEWER GENERAL NOTES

- SHALL TAKE ALL NECESSARY PRECAUTIONS TO PROTECT EXISTING MAINS AND SERVICES AND MAINTAIN UNINTERRUPTED SUPPLY. ANY DAMAGE INCURRED SHALL BE REPAIRED IMMEDIATELY TO THE SATISFACTION OF THE ENGINEER AT THE CONTRACTOR'S EXPENSE.
- 2. ALL HORIZONTAL CONTROLS ARE BASED ON MARYLAND STATE COORDINATES.
- 3. ALL VERTICAL CONTROLS ARE BASED ON U.S.G.S. DATA.
- 4. ALL PIPE ELEVATIONS SHOWN () ARE INVERT ELEVATIONS.
- 5. CLEAR ALL UTILITIES BY A MINIMUM OF 6". CLEAR ALL POLES BY 2'-0" MINIMUM OR TUNNEL AS REQUIRED. THE OWNER HAS CONTACTED THE UTILITY COMPANIES AND HAS MADE ARRANGEMENTS FOR BRACING OF POLES AS SHOWN ON THE DRAWINGS. IN THE EVENT THE CONTRACTOR'S WORK REQUIRES THE BRACING OF ADDITIONAL POLES, ANY COST INCURRED BY THE OWNER FOR BRACING OF ADDITIONAL POLES OR DAMAGES SHALL BE DEDUCTED FROM MONEY OWED THE CONTRACTOR. THE CONTRACTOR SHALL COORDINATE WITH THE UTILITY COMPANIES TO SCHEDULE THE BRACING OF THE POLES.
- 6. FOR DETAILS NOT SHOWN ON THE DRAWINGS, AND FOR MATERIALS AND CONSTRUCTION METHODS USE HOWARD COUNTY DESIGN MANUAL, VOLUME IV, STANDARD SPECIFICATIONS AND DETAIL FOR CONSTRUCTION. (LATEST EDITION). THE CONTRACTOR SHALL HAVE A COPY OF VOLUME IV ON THE JOB.
- WHERE TEST PITS HAVE BEEN MADE ON EXISTING UTILITIES, THEY ARE NOTED BY AT THE LOCATION OF THE TEST PIT. A NOTE OR NOTES CONTAINING THE RESULTS OF THE TEST PIT OR PITS IS INCLUDED ON THE DRAWINGS. EXISTING UTILITIES IN THE VICINITY OF THE PROPOSED WORK FOR WHICH TEST PITS HAVE NOT BEEN DUG SHALL BE LOCATED BY THE CONTRACTOR TWO WEEKS IN ADVANCE OF CONSTRUCTION OPERATIONS AT HIS OWN EXPENSE.
- 8. CONTRACTOR SHALL NOTIFY THE FOLLOWING UTILITY COMPANIES OR AGENCIES AT LEAST FIVE (5) WORKING DAYS BEFORE STARTING WORK SHOWN ON THESE PLANS:
- STATE HIGHWAY ADMINISTRATION BALTIMORE GAS & ELECTRIC CO. CONTRACTOR SERVICES 850-4620 BALTIMORE GAS & ELECTRIC CO. UNDERGROUND DAMAGE CONTROL
- UTILITIES, HOWARD COUNTY DEPARTMENT OF PUBLIC WORKS 313-4900 9. TREES AND SHRUBS ARE TO BE PROTECTED FROM DAMAGE TO MAXIMUM EXTENT.
- TREES AND SHRUBS LOCATED WITHIN THE CONSTRUCTION STRIP ARE NOT TO BE REMOVED OR DAMAGED BY THE CONTRACTOR. 10. CONTRACTOR SHALL REMOVE TREES, STUMPS AND ROOTS ALONG LINE OF
- EXCAVATION. PAYMENT FOR SUCH REMOVAL SHALL BE INCLUDED IN THE UNIT PRICE BID FOR CONSTRUCTION OF THE MAIN. 11. ALL WATER MAINS TO BE D.I.P. CLASS 52 UNLESS OTHERWISE NOTED.
- 12. TOPS OF ALL WATER MAINS TO HAVE A MINIMUM OF 3-1/2' COVER UNLESS OTHERWISE NOTED.
- 13. VALVES ADJACENT TO TEES SHALL BE STRAPPED TO TEES.
- 14. ALL FITTINGS SHALL BE BUTTRESSED OR ANCHORED WITH CONCRETE IN ACCORDANCE WITH THE STANDARD DETAILS UNLESS OTHERWISE PROVIDED FOR ON THE DRAWINGS.
- 15. FIRE HYDRANTS SHALL BE SET TO THE BURY LINE ELEVATIONS SHOWN ON THE DRAWINGS, ALL FIRE HYDRANTS SHALL BE RESTRAINED AND BUTTRESSED WITH CONCRETE IN ACCORDANCE WITH STANDARD DETAILS. SOIL AROUND THE FIRE HYDRANT SHALL BE COMPACTED IN ACCORDANCE WITH SECTION 1000 AND 1005 OF THE STANDARD SPECIFICATIONS.
- 16. THE CONTRACTOR SHALL NOT OPERATE ANY WATER MAIN VALVES OF THE EXISTING
- 17. ALL WATER HOUSE CONNECTIONS SHALL BE FOR INSIDE METER SETTING UNLESS OTHERWISE NOTED ON PLANS OR IN SPECIFICATIONS.
- 18. ALL SEWER MAINS SHALL BE DIP OR PVC UNLESS OTHERWISE NOTED.
- 20. MANHOLES SHOWN WITH 12" AND 16" WELLS ARE FOR BRICK MANHOLES ONLY. CONTRACTOR SHALL HAVE AN OPTION TO PROVIDE PRE-CAST MANHOLES IN ACCORDANCE WITH DESIGN VOL. 14.
- 21. MANHOLES CAN BE EITHER BRICK OR PRECAST CONCRETE STRUCTURES. 22. CONTRACTOR IS SOLELY RESPONSIBLE FOR CONSTRUCTION MEANS, METHODS, TECHNIQUES, SEQUENCES, PROCEDURES, AND SAFETY PRECAUTIONS AND

PROGRAMS

23. THE CONTRACTOR SHALL NOTIFY THE BUREAU OF HIGHWAYS, HOWARD COUNTY, AT (410) 313-2450 AT LEAST MFIVE (5) WORKING DAYS BEFORE ANY OPEN CUT OF ANY COUNTY ROAD OR BORING/JACKING OPERATION IN COUNTY ROADS FOR LAYING WATER/SEWER MAINS OR HOUSE CONNECTIONS. THE APPROVAL OF THESE DRAWINGS WILL CONSTITUTE COMPLIANCE WITH DPW REQUIREMENTS PER SECTION 18.114(A) OF THE HOWARD COUNTY CODE.

> AREA OF PROPERTY PRESENT ZONING:

PARKING REQUIRED:

PARKING PROVIDED:

PAVEMENT/ROOF AREA:

PROPOSED:

COVERAGE(% OF SITE):

EXISTING USE-

PROPOSED USE:

SITE ANALYSIS

BUILDING COVERAGE (% OF SITE): 15.1%

AS REQUIRED BY HOWARD COUNTY

(INCLUDES 2 HANDICAP SPACES)

DEPARTMENT OF FIRE AND RESCUE

COMMERCIAL

20,300 S.F.

32 SPACES


COMMERCIAL/FIRE STATION

SHEET

<u>VICINITY MAP</u>

BENCH MARK

- HOWARD COUNTY CONTROL STATION # 3043001 N. 516549.548, E. 853656.506 (NAD27) CONC. MON. 32.26' NE OF NW CORNER OF BG&E TOWER #276-A AND 58.41' NW OF NE CORNER BG&E TOWER #276-A.
- HOWARD COUNTY CONTROL STATION # 2943002 N. 513,205.902, E. 857,478.687 (NAD27) CONC. MON. IS LOCATED ON THE TRANSMISSION LINE 1700± NORTH OF INTERSECTION OF RT. 103 AND NEW CUT ROAD AND 1150± EAST OF

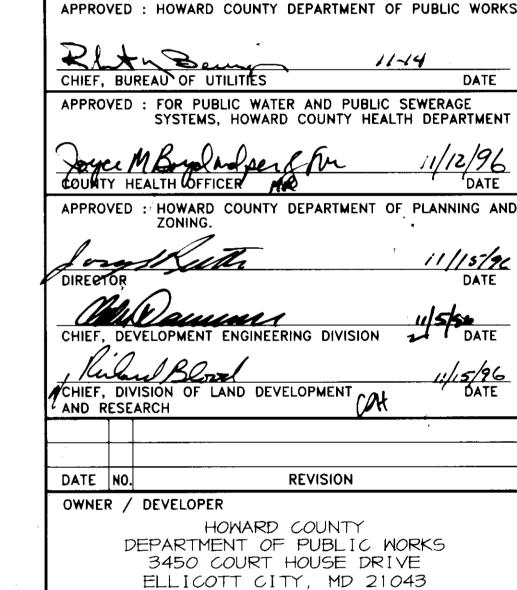

SECOND DISTRICT FIRE STATION

AREA TAX MAP 24 BLOCK 23\$24 ZONED B-2 2nd ELECTION DISTRICT, PARCEL A-2 HOWARD COUNTY, MARYLAND

TITLE SHEET

RIEMER MUEGGE & ASSOCIATES, INC. ENGINEERING ● ENVIRONMENTAL SERVICES ● PLANNING ● SURVEYING 8818 Centre Park Drive, Columbia, Maryland 21045





tel 410.997.8900 fax 410.997.9282 DESIGNED BY : A.A.P. DRAWN BY : WEJ PROJECT NO : 96_001/ SDP_C-1.DWO DATE: October 18, 1996 SCALE : 1" = 30"

GENERAL NOTES

ALL CONSTRUCTION SHALL BE IN ACCORDANCE WITH THE PROJECT SPECIFICATIONS AND THE LATEST STANDARDS AND SPECIFICATIONS OF HOWARD COUNTY AND MSHA. THE CONTRACTOR SHALL NOTIFY THE DEPARTMENT OF PUBLIC WORKS/BUREAU OF ENGINEERING/

CONSTRUCTION INSPECTION DIVISION AT (410) 313-1880 AT LEAST FIVE (5) WORKING DAYS PRIOR

- THE CONTRACTOR SHALL NOTIFY "MISS UTILITY" AT 1-800-257-7777 AT LEAST 48 HOURS PRIOR
- TRAFFIC CONTROL DEVICES, MARKINGS, AND SIGNING SHALL BE IN ACCORDANCE WITH THE LATEST EDITION OF THE MANUAL ON UNIFORM TRAFFIC CONTROL DEVICES (MUTCD). ALL STREET AND REGULATORY SIGNS SHALL BE IN PLACE PRIOR TO THE PLACEMENT OF ANY ASPHALT.
- ALL PLAN DIMENSIONS ARE TO FACE OF CURB UNLESS OTHERWISE NOTED.
- THE EXISTING ONSITE TOPOGRAPHY IS TAKEN FROM A FIELD RUN SURVEY WITH MAXIMUM TWO FOOT CONTOUR INTERVALS PREPARED BY RIEMER MUEGGE AND ASSOC. DATED SEPTEMBER 1995.
- THE COORDINATES SHOWN HEREON ARE BASED UPON THE HOWARD COUNTY GEODETIC CONTROL WHICH IS BASED UPON THE MARYLAND STATE PLANE COORDINATE SYSTEM. HOWARD COUNTY
- MONUMENT NOS. 3043001 AND 2943002 WERE USED FOR THIS PROJECT. STORMWATER MANAGEMENT QUANTITY IS ADDRESSED BY PROVIDING OFFSITE STREAM IMPROVEMENTS
- BY OTHERS. STORMWATER MANAGEMENT QUALITY IS ADDRESSED WITH A STORMCEPTOR AND WILL APPROXIMATE LOCATION OF EXISTING UTILITIES ARE SHOWN. THE CONTRACTOR SHALL TAKE ALL NECESSARY PRECAUTIONS TO PROTECT THE EXISTING UTILITIES AND MAINTAIN UNINTERRUPTED
- SERVICE, ANY DAMAGE INCURRED DUE TO CONTRACTOR'S OPERATION SHALL BE REPAIRED IMMEDIATELY AT THE CONTRACTOR'S EXPENSE. EXISTING UTILITIES ARE SHOWN BASED ON THE BEST
- THERE IS NO FLOODPLAIN ON THIS SITE, PER FIRM PANEL NO.2400440023B, DATED DECEMBER 4, 1986.
- THE WETLANDS DELINEATION STUDY FOR THIS PROJECT WAS PREPARED BY ESA, INC.
- 12. THE TRAFFIC STUDY FOR THIS PROJECT IS NOT REQUIRED.
- THE GEOTECHNICAL STUDY FOR STORMWATER MANAGEMENT AND PAVEMENT DESIGN FOR THIS PROJECT WAS PREPARED BY ROBERT B. BALTER CO, DATED JULY 19, 1996.
- THE BOUNDARY SURVEY FOR THIS PROJECT WAS PREPARED BY RIEMER MUEGGE AND ASSOC. DATED JULY 1991 AND UPDATED PER F-97-11.
- 15. SUBJECT PROPERTY IS ZONED B-2.
- ALL ELEVATIONS SHOWN ARE BASED ON THE U.S.C. AND G.S. MEAN SEA LEVEL DATUM, 1929.
- 17. SEE DEPARTMENT OF PLANNING AND ZONING FILE NO'S: ZB 959M, F-94-72, F-96-03, F-97-11, AA-96-20.
- THE CONTRACTOR SHALL TEST PIT EXISTING UTILITIES AT LEAST (5) DAYS BEFORE STARTING WORK SHOWN ON THESE DRAWINGS.

OF FINISHED GRADE.

- CONTRACTOR IS SOLELY RESPONSIBLE FOR CONSTRUCTION MEANS, METHODS, TECHNIQUES,
- PIPE SHALL NOT BE INSTALLED BY THE CONTRACTOR UNTIL THE LENGTH CALLED FOR AT EACH STATION HAS BEEN APPROVED BY THE ENGINEER IN THE FIELD.
- NO PIPE SHALL BE LAID UNTIL LINES OF EXCAVATION HAVE BEEN BROUGHT WITHIN 6"
- ALL STORM DRAIN PIPE BEDDING SHALL BE CLASS 'C' AS SHOWN IN FIG. 11.4,

SEQUENCES, PROCEDURES, AND SAFETY PRECAUTIONS AND PROGRAMS.

- VOLUME 1 OF HOWARD COUNTY DESIGN MANUAL UNLESS OTHERWISE NOTED.
- ALL PIPE ELEVATIONS SHOWN ARE INVERT O ELEVATIONS.

ALL INLETS SHALL BE CONSTRUCTED IN ACCORDANCE WITH HOWARD COUNTY STANDARDS.


- STORM DRAIN TRENCHES WITHIN ROAD RIGHT OF WAY SHALL BE BACKFILLED AND
- COMPACTED IN ACCORDANCE WITH THE HOWARD COUNTY DESIGN MANUAL, VOLUME IV, i.e., STANDARD SPECIFICATIONS AND DETAILS FOR CONSTRUCTION, LATEST AMENDMENTS.
- PROFILE STATIONS SHALL BE ADJUSTED AS NECESSARY TO CONFORM TO PLAN DIMENSIONS.
- ALL FILL AREAS WITHIN ROADWAY AND UNDER STRUCTURES TO BE COMPACTED TO A MINIMUM OF 95% COMPACTION OF AASHTO T-180. SEE ARCHITECTURAL PLANS FOR COMPACTION
- EXISTING INLET NUMBERS WERE ASSIGNED FOR THIS PROJECT AND ARE NOT BASED ON
- PROVIDE GRADUAL 10' TRANSITION WHEN CONNECTING STANDARD AND REVERSE CURB. ALL CURBING IN MD 103 R\W SHALL BE; STANDARD MSHA TYPE "A" CURB. PROVIDE 10' TRANSITION WHEN CONNECTING HOWARD COUNTY 7" CURB TO MSHA CURB. ALL TRANSITIONS TO BE ON-SITE.
- ALL SOIL TO BE USED ON THIS SITE MUST BE FROM AN APPROVED BORROW SITE.
- WHEN REMOVING EXISTING CURB, REMOVE TO NEAREST JOINT.
- ADMINISTRATIVE ADJUSTMENT AA-96-20 MODIFIED ZONING MAP LINE WHICH REZONED THE R-20 PORTION TO B-2 BY DECISION AND ORDER DATED AUGUST 1, 1996


EAST BUILDING VIEW


NORTH BUILDING VIEW NO SCALE

ADDRESS CHART BUILDING AREA: PARCEL NUMBER STREET ADDRESS 4150 MONTGOMERY ROAD Second Dutrict Fire Station 2nd 24+23 B-2 6023.02 5750601 F-09

DRAWING NO. 1 OF 7

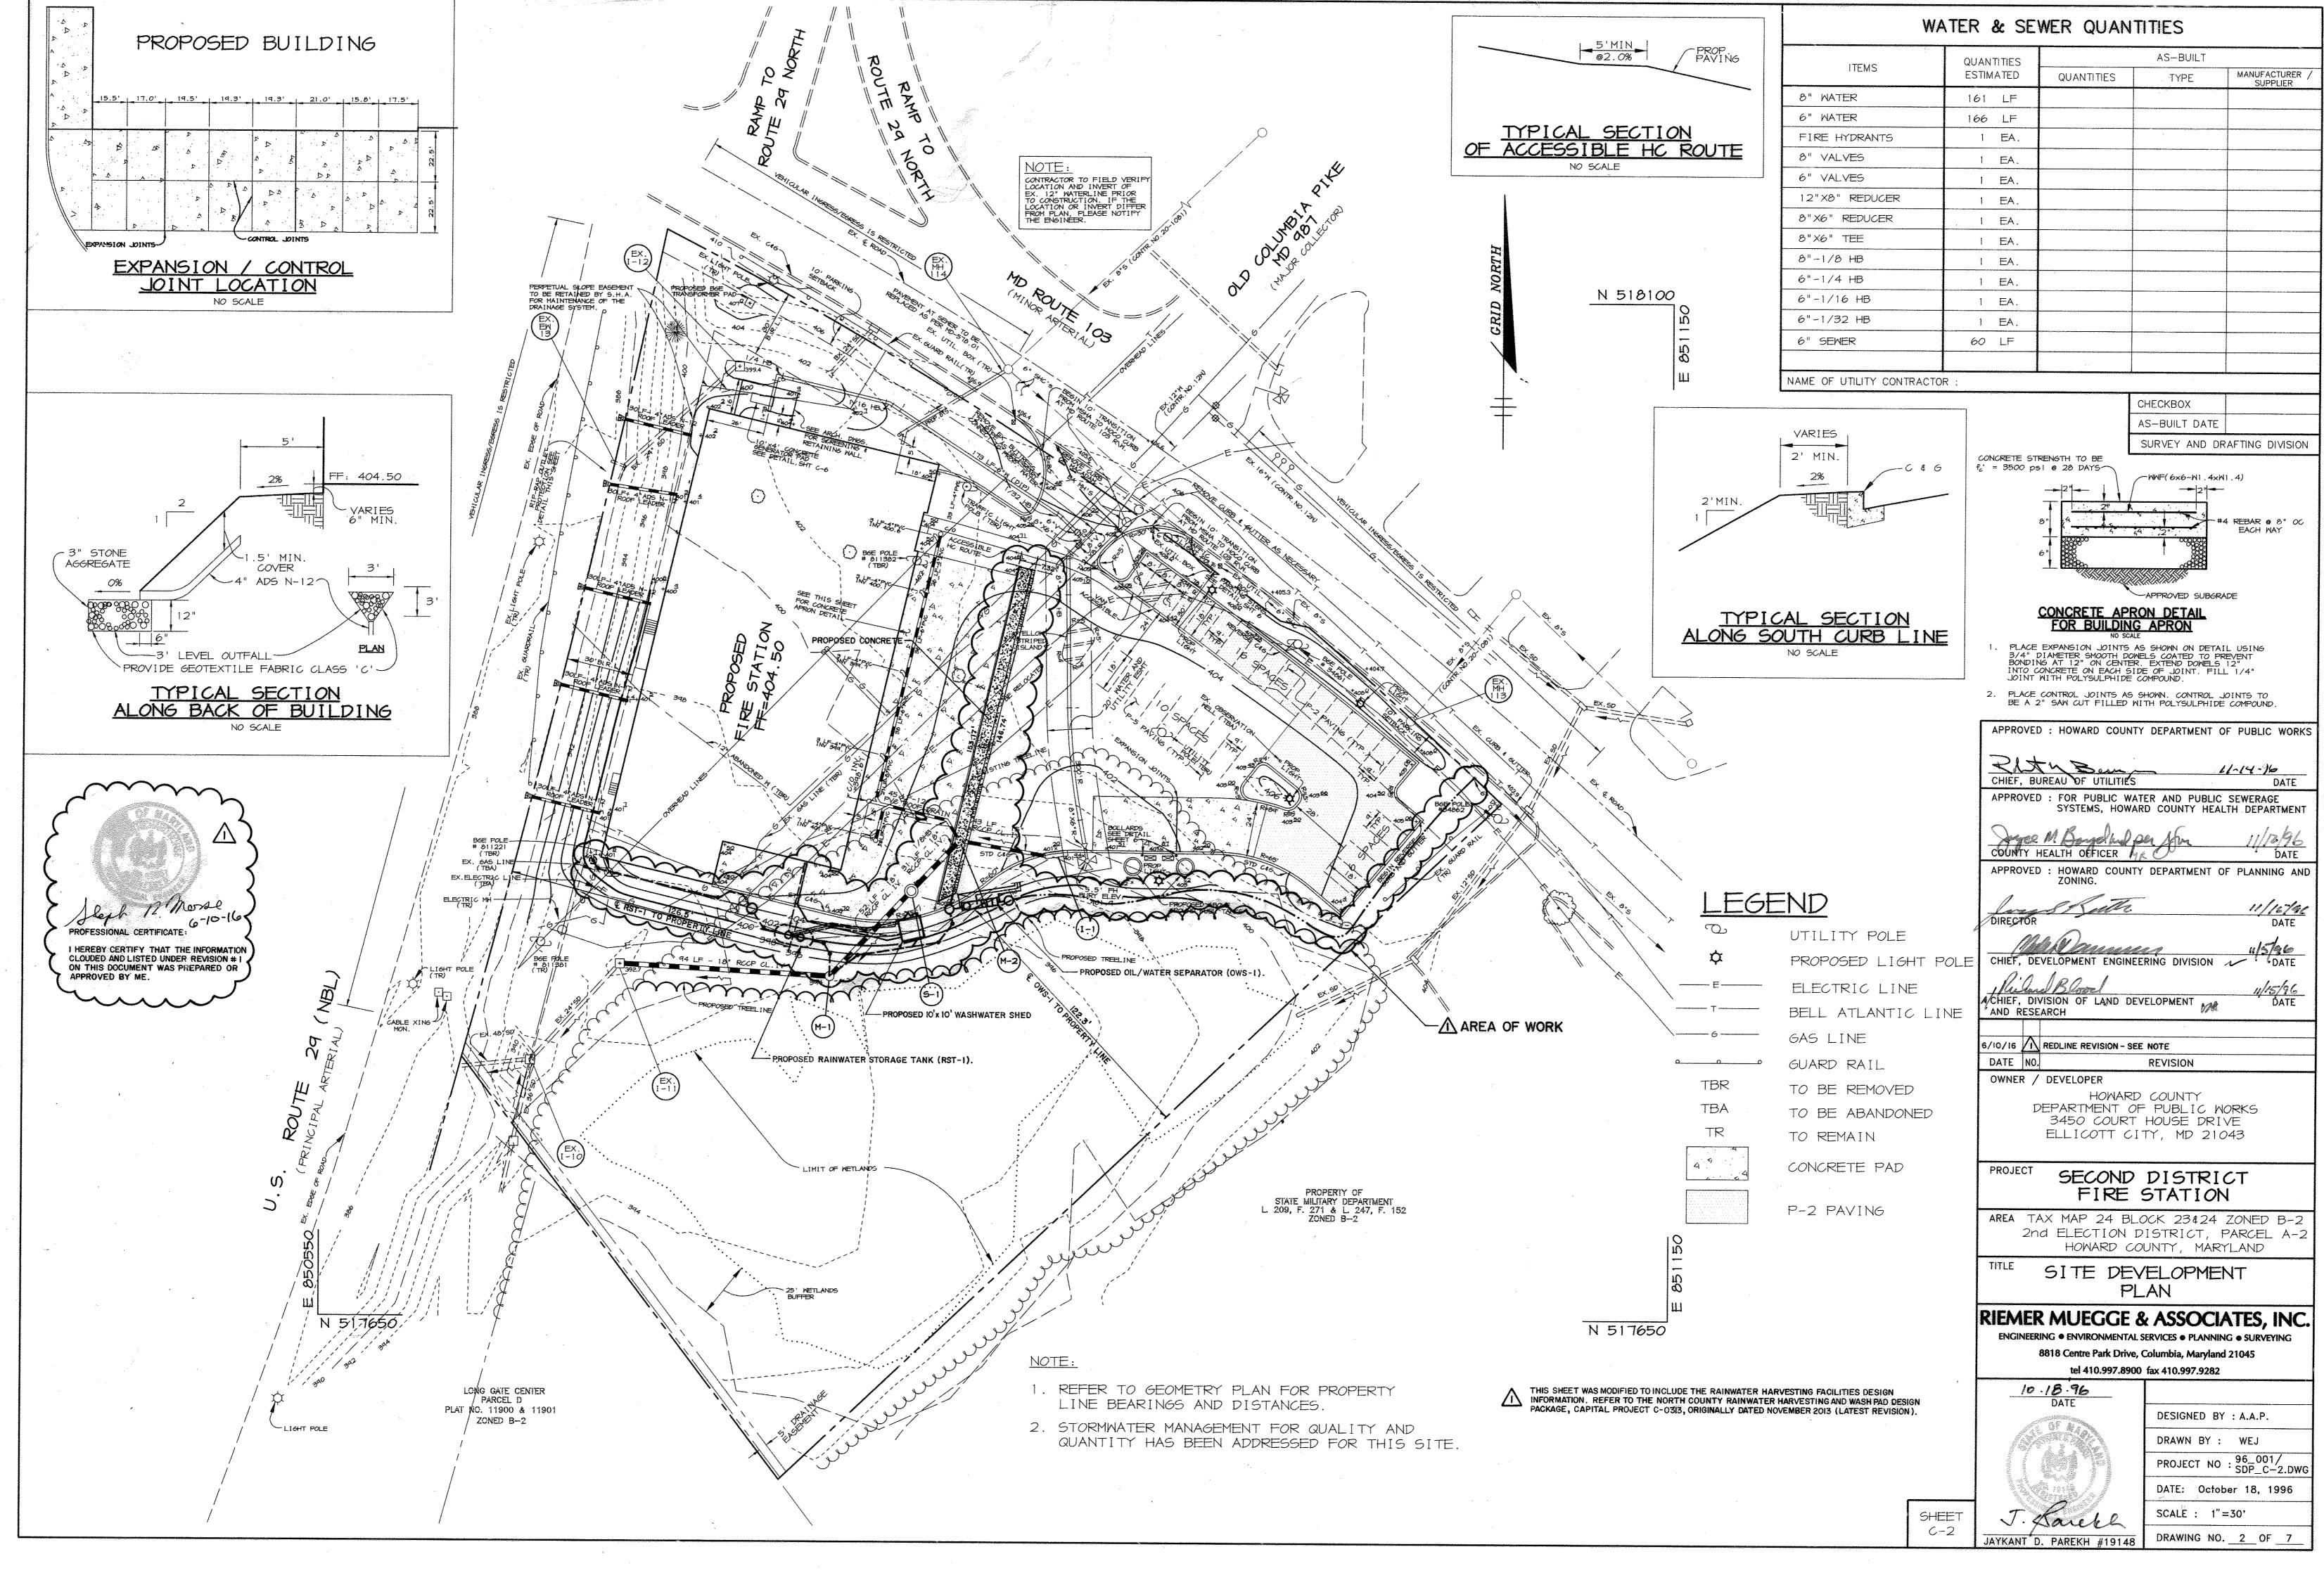

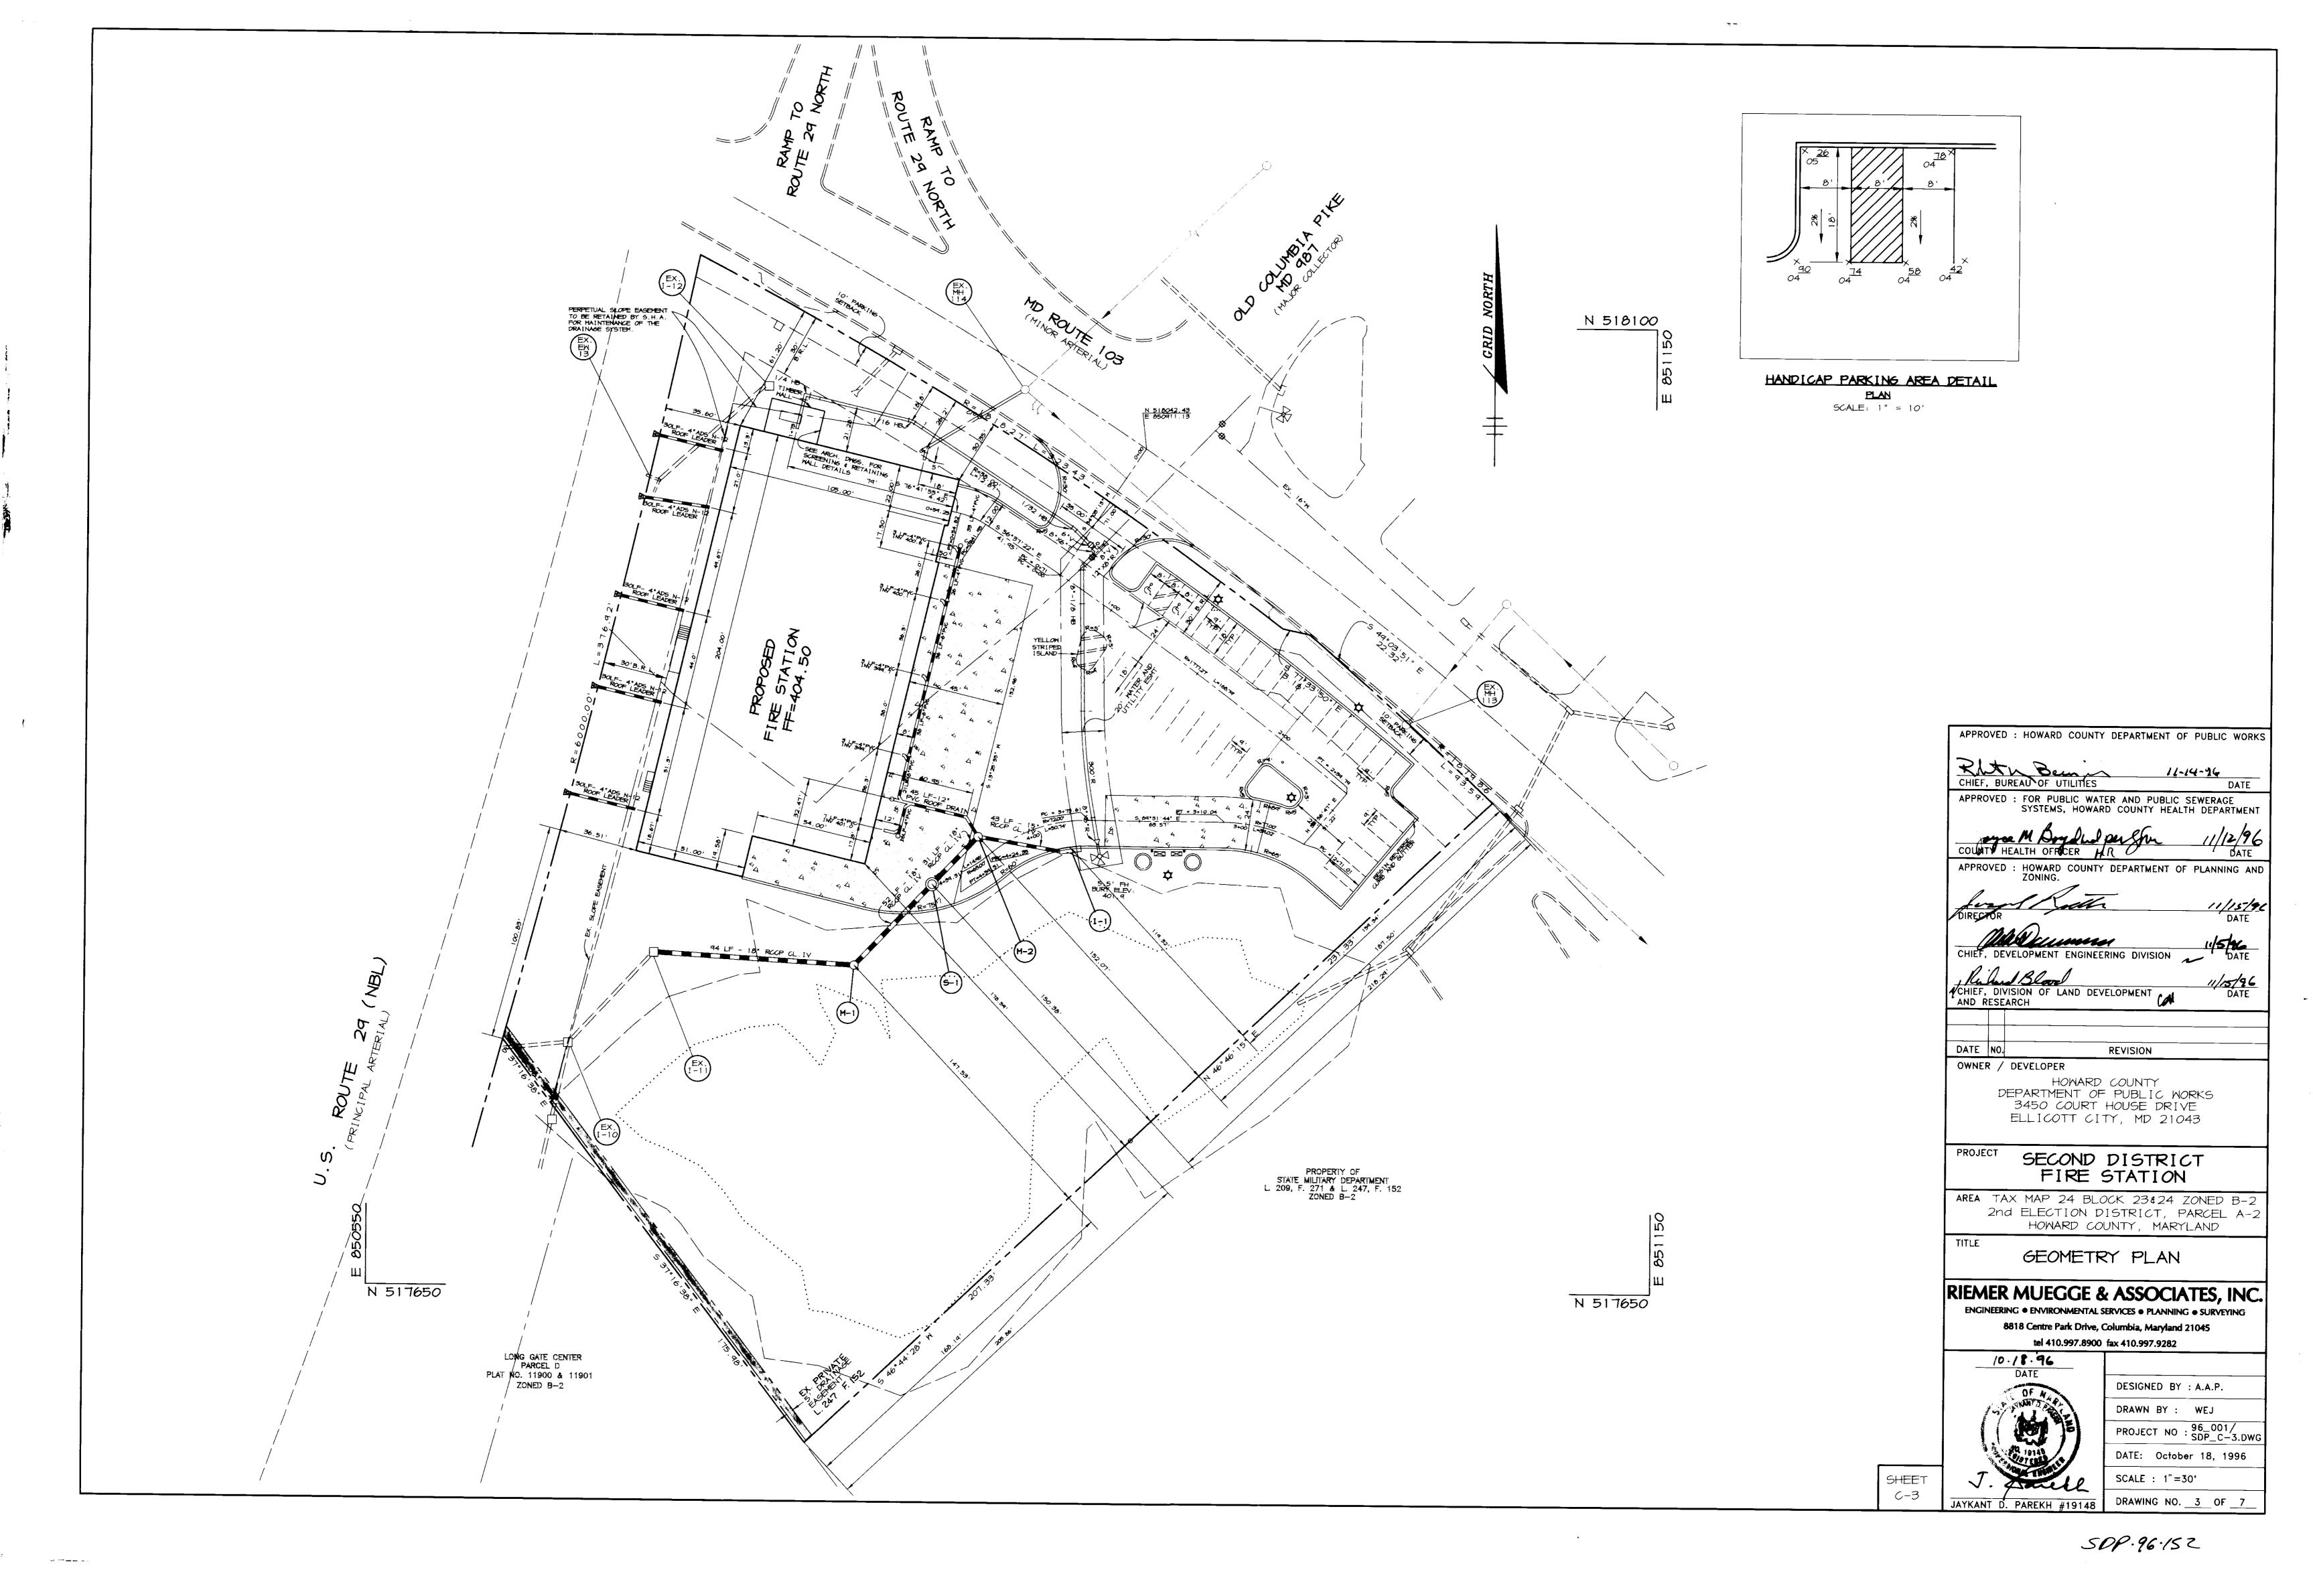

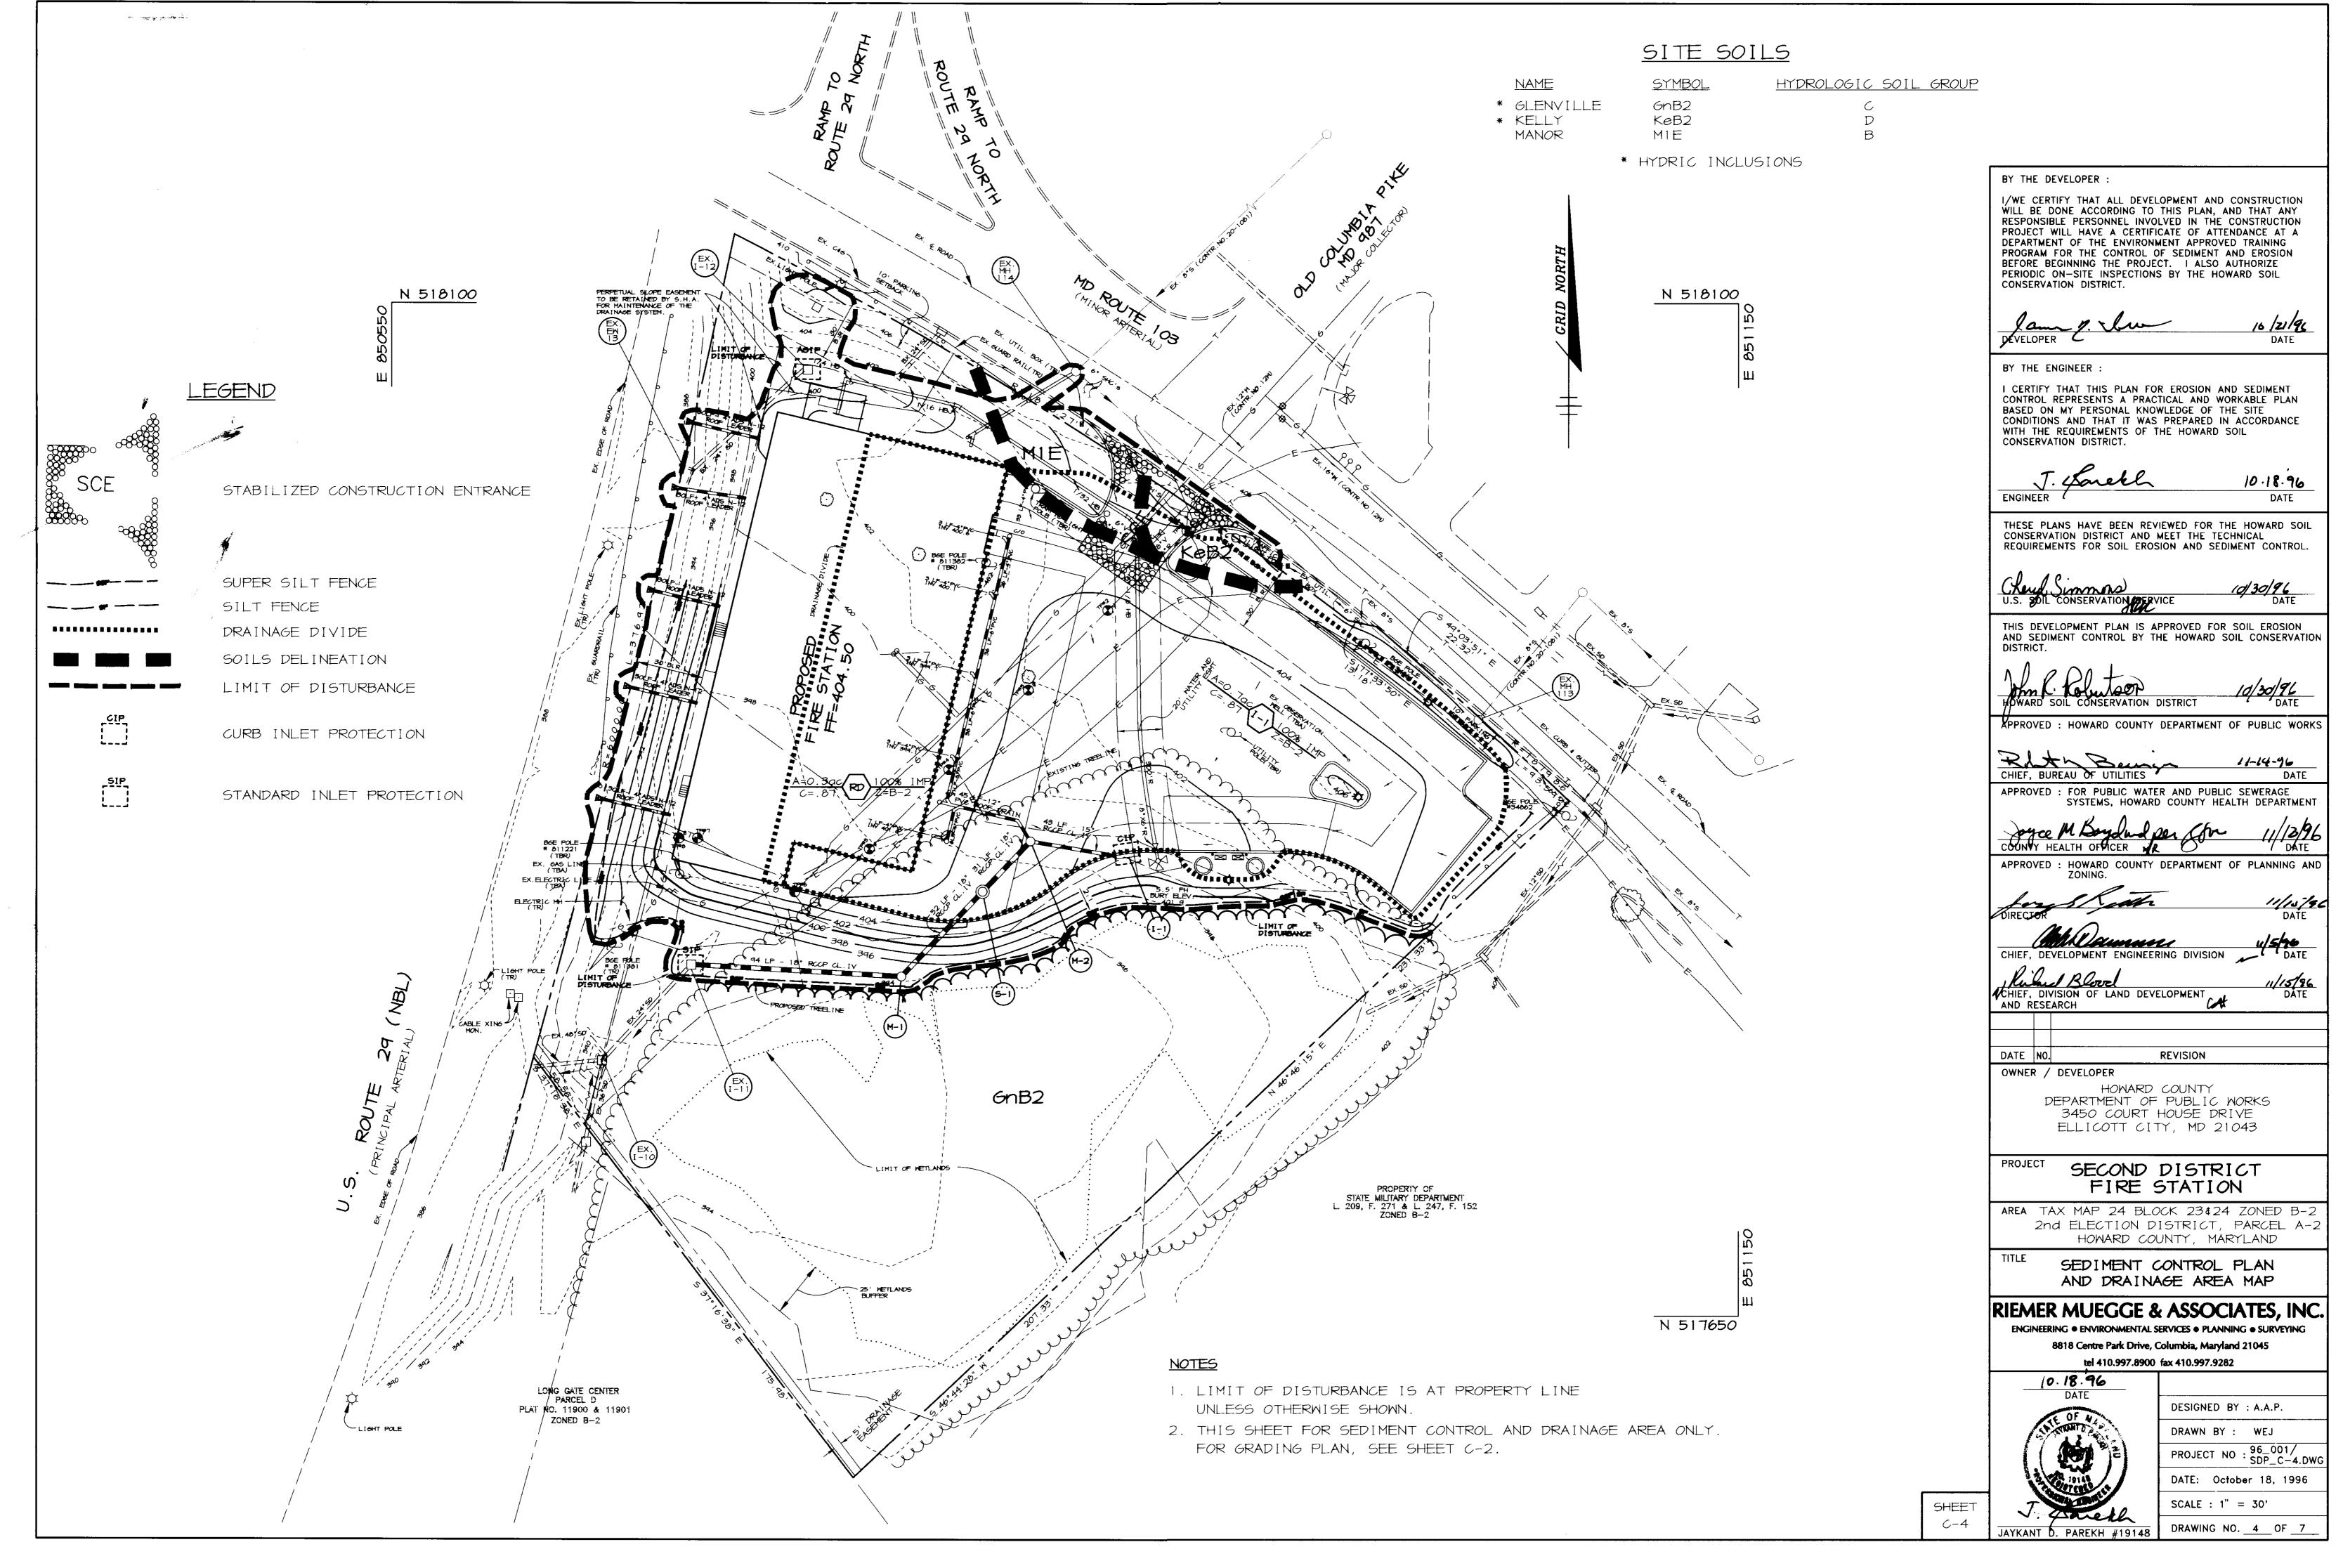

TEMPORARY SEEDING NOTES

Apply to graded or cleared areas likely to be redisturbed where a short-term vegetative cover is needed.

Seedbed Preparation: Loosen upper three inches of soil by raking, discing or other acceptable means before seeding, if not previously

5011 Amendments: Apply 600 lbs. per acre 10-10-10 fertilizer (14

Seeding: For periods March 1 thru April 30 and from August 15 thru November 15, seed with 2-1/2 bushels per acre of annual rye (3.2 lbs. per 1000 sq.ft.). For the period May 1 thru August 14, seed with 3 lbs. per acre of weeping lovegrass (0.07 lbs. per 1000 sq.ft.). For the period November 16 thru February 28, protect site by applying 2 tons per acre of well anchored straw mulch and seed as soon as possible in the spring, or use sod.

Mulching: Apply 1-1/2 to 2 tons per acre (70 to 90 lbs. per 1000 sq.ft.) of unrotted small grain straw immediately after seeding.
Anchor mulch immediately after application using mulch anchoring tool or 218 gal. per acre (5 gal. per 1000 sq.ft.) of emulsified asphalt on flat areas. On slopes, 8 ft. or higher, use 347 gal. per acre (8 gal. per 1000 sq.ft.) for anchoring.

Refer to the 1983 MARYLAND STANDARDS AND SPECIFICATIONS FOR SOIL EROSION AND SEDIMENT CONTROL for rate and methods not covered.

PERMANENT SEEDING NOTES

Apply to graded or cleared areas not subject to immediate further disturbance where a permanent long-lived vegetative cover is needed.

Seedbed Preparation: Loosen upper three inches of soil by raking. discing or other acceptable means before seeding, if not previously

Soil Amendments: In lieu of soil test recommendations, use one of the following schedules

- Preferred Apply 2 tons per acre dolomitic limestone (92 lbs. per 1000 sq.ft.) and 600 lbs. per acre 10-10-10 fertilizer (14 lbs. per 1000 sq.ft.) before seeding. Harrow or disc into upper three inches of soil. At time of seeding, apply 400 lbs. per acre 30-0-0 ureaform fertilizer (9 lbs. per 1000 sq.ft.).
- 2) Acceptable Apply 2 tons per acre dolomitic limestone (92 lbs. per 1000 sq.ft.) and 1000 lbs. per acre 10-10-10 fertilizer (23 ibs. per 1000 sq.ft.) before seeding. Harrow or disc into upper three Inches of soll.

Seeding: For the period March 1 thru April 30 and from August 1 thru October 15, seed with 60 lbs. per acre (1.4 lbs. per 1000 sq.ft. of Kentucky 31 Tall Fescue. For the period May 1 thru July 31, seed with 60 lbs. Kentucky 31 Tall Fescue per acre and 2 lbs. per acre (0.05 lbs. per 1000 sq.ft.) of weeping lovegrass. During the period October 16 thru February 28, protect site by one of the following


- 1) 2 tons per acre of well-anchored mulch straw and seed as soon as possible in the spring.
- 2) Use sod.
- 3) Seed with 60 lbs. per acre Kentucky 31 Tall Fescue and mulch with 2 tons per acre well anchored straw.

Mulching: Apply 1-1/2 to 2 tons per acre (70 to 90 lbs. per 1000 sq.ft.) of unrotted small grain straw immediately after seeding. Anchor mulch immediately after application using mulch anchoring tool or 218 gal. per acre (5 gal. per 1000 sq.ft.) of emulsified asphalt on flat areas. On slopes, 8 ft. or higher, use 347 gal. per acre (8 gal. per 1000 sq.ft.) for anchoring.


<u>Maintenance</u>: <u>Inspect all seeded areas and make needed repairs</u>, replacements and reseedings

SEDIMENT CONTROL NOTES


- 1. A MINIMUM OF 48 HOURS NOTICE MUST BE GIVEN TO THE HOWARD COUNTY DEPARTMENT OF INSPECTIONS AND PERMITS PRIOR TO THE START OF ANY CONSTRUCTION (313-1855)
- 2. ALL VEGETATIVE AND STRUCTURAL PRACTICES ARE TO BE INSTALLED ACCORDING TO THE PROVISIONS OF THIS PLAN AND ARE TO BE IN CONFORMANCE WITH THE MARYLAND STANDARDS AND SPECIFICATIONS FOR SOIL AND EROSION CONTROL, AND REVISIONS THERETO.
- 3. FOLLOWING INITIAL SOIL DISTURBANCE OR REDISTURBANCE, PERMANENT OR TEMPORARY STABILIZATION SHALL BE COMPLETED WITHIN: A) 7 CALENDAR DAYS FOR ALL PERIMETER SEDIMENT CONTROL STRUCTURES, DIKES, PERIMETER SLOPES AND ALL SLOPES AND ALL SLOPES GREATER THAN 3:1, B) 14 DAYS AS TO OTHER DISTURBED OR GRADED AREAS ON THE PROJECT SITE.
- 4. ALL SEDIMENT TRAPS/BASINS SHOWN MUST BE FENCED AND WARNING SIGNS POSTED AROUND THE PERIMETER IN ACCORDANCE WITH VOL. 1, CHAPTER 12, OF THE HOWARD COUNTY DESIGN MANUAL, STORM DRAINAGE.
- 5. ALL DISTURBED AREAS MUST BE STABILIZED WITHIN THE TIME PERIOD SPECIFIED ABOVE IN ACCORDANCE WITH THE 1991 MARYLAND STANDARDS AND SPECIFICATIONS FOR SOIL AND EROSION CONTROL FOR PERMANENT SEEDINGS (SEC. 51), SOD (SEC. 54), TEMPORARY SEEDING (SEC. 50) AND MULCHING (SEC. 52). TEMPORARY STABILIZATION WITH MULCH ALONG CAN ONLY BE DONE WHEN RECOMMENDED SEEDING DATES DO NOT ALLOW FOR PROPER GERMINATION AND ESTABLISHMENT OF GRASSES.
- 6. ALL SEDIMENT CONTROL STRUCTURES ARE TO REMAIN IN PLACE AND ARE TO BE MAINTAINED IN OPERATIVE CONDITION UNTIL PERMISSION FOR THEIR REMOVAL HAS BEEN OBTAINED FROM THE HOWARD COUNTY SEDIMENT CONTROL INSPECTOR.
- 7. SITE ANALYSIS: TOTAL AREA OF SITE
- AREA ON-SITE DISTURBED AREA OFF-SITE DISTURBED AREA TO BE ROOFED OR PAVED AREA TO BE VEGETATIVELY STABILIZED
- 3.08 ACRES 1.69 ACRES 0.00 ACRES 1.19 ACRES 0.50 ACRES
- 667 CU. YARDS 3627 CU. YARDS 8. ANY SEDIMENT CONTROL PRACTICE WHICH IS DISTURBED BY GRADING ACTIVITY FOR PLACEMENT OF UTILITIES MUST BE REPAIRED ON THE SAME DAY OF
- 9. ADDITIONAL SEDIMENT CONTROLS MUST BE PROVIDED, IF DEEMED NECESSARY BY THE HOWARD COUNTY SEDIMENT CONTROL INSPECTOR.
- 10. SITE GRADING WILL BEGIN ONLY AFTER ALL PERIMETER SEDIMENT CONTROL MEASURES HAVE BEEN INSTALLED AND ARE IN A FUNCTIONING CONDITION.
- 11. SEDIMENT WILL BE REMOVED FROM TRAPS WHEN ITS DEPTH REACHES CLEAN OUT ELEVATION SHOWN ON THE PLANS.
- 12. CUT AND FILL QUANTITIES PROVIDED UNDER SITE ANALYSIS DO NOT REPRESENT BID QUANTITIES. THESE QUANTITIES DO NOT DISTINGUISH BETWEEN TOPSOIL, STRUCTURAL FILL OR EMBANKMENT MATERIAL. NOR DO THEY REFLECT CONSIDERATION OF UNDERCUTTING OR REMOVAL OF UNSUITABLE MATERIAL. THE CONTRACTOR SHALL FAMILIARIZE HIMSELF WITH SITE CONDITIONS WHICH MAY AFFECT THE WORK.
- 13. ON ALL SITES WITH DISTURBED AREAS IN EXCESS OF 2 AC., APPROVAL OF THE INSPECTION AGENCY SHALL BE REQUESTED UPON COMPLETION OF INSTALLATION OF PERIMETER EROSION AND SEDIMENT CONTROLS. BUT BEFORE PROCEEDING WITH ANY OTHER EARTH DISTURBANCE OR GRADING. OTHER BUILDING OR GRADING INSPECTION APPROVALS MAY NOT BE AUTHORIZED UNTIL THIS INITIAL APPROVAL BY THE INSPECTION AGENCY IS MADE.
- 14. TRENCHES FOR THE CONSTRUCTION OF UTILITIES IS LIMITED TO THREE PIPE LENGTHS OR THAT WHICH CAN BE BACKFILLED AND STABILIZED WITHIN ONE WORKING DAY, WHICHEVER IS SHORTER.
- 15. BORROW SITE TO BE PRE-APPROVED BY THE SEDIMENT CONTROL INSPECTOR, OR IN CASE OF EXCESS MATERIAL, AN APPROVED SEDIMENT CONTROL PLAN WILL BE NEEDED TO DEPOSIT EXCESS OFF-SITE.

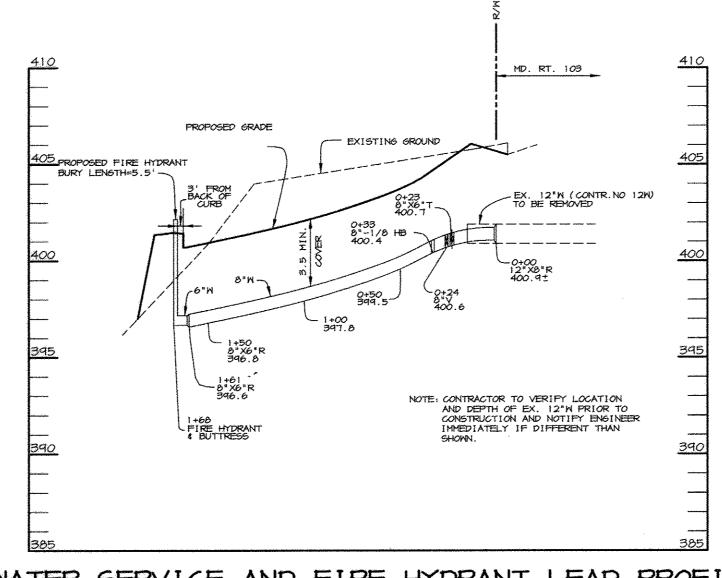

WATER SERVICE AND FIRE HYDRANT LEAD PROFILE SCALE :

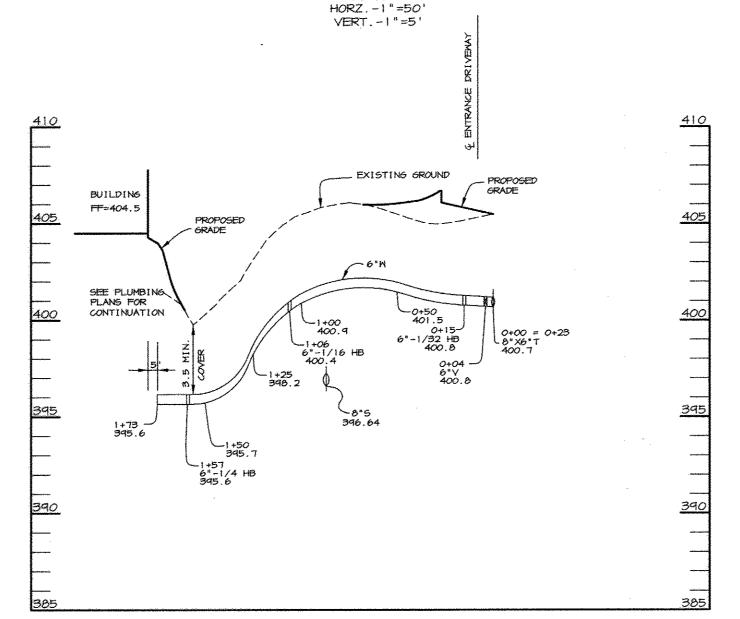

WATER SERVICE PROFILE SCALE : HORZ.-1"=50'

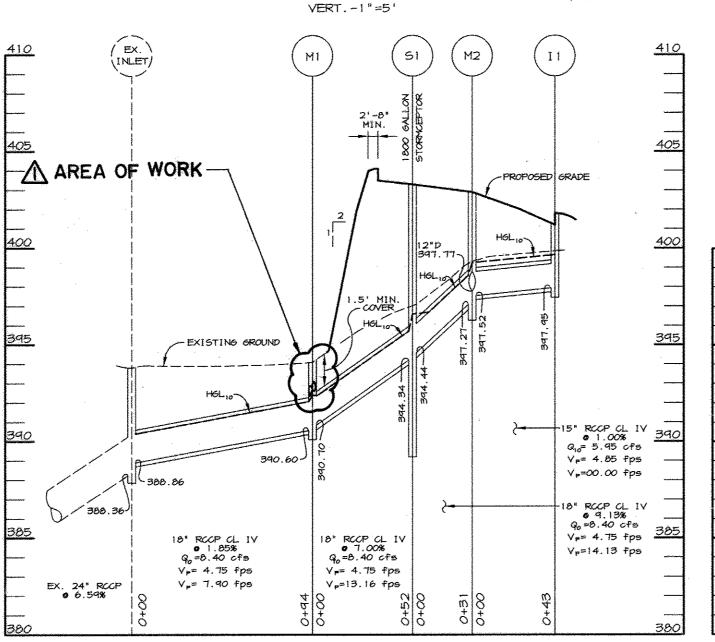

STORM DRAIN PROFILE


HORZ . -1"=50'

VERT. -1"=5'

BUILDING 405 FF=404.50 EXISTING -SERVICE STA. 0+36 INV.=401.4 CLEANOUT -PLUG END 396.75 SEWER PROFILE

HORZ . -1"=50'

VERT.-1"=5"

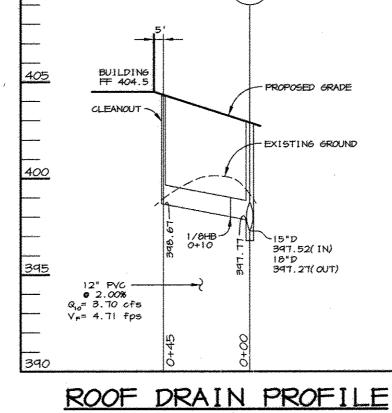


HORZ.;-1"=50'

WATER MAIN FITTING LOCATION SCHEDULE FIRE HYDRANT LEAD WATER LINE STATION COORDINATES FITTING 12"X8" R N 517998.88 E 850892.81 0+15 N 517994.52 E 850888.49 8"x6" TEE 0+23 ව" ∨ 0+24 N 517992.05 E 850886.00 8"-1/8 HB 0+33 N 517987.44 E 850881.42 N 517860.07 E 850889.43 8"×6" R 1+61 N 517852.42 E 850890.80 FIRE HYDRANT 1+68 WATER SERVICE WATER LINE STATION COORDINATES FITTING 6" V 0+04 N 517997.57 E 850885.35 6"-1/32 HB 0+15 N 518004.98 E 850877.73 6"-1/16 HB N 518054.42 E 850801.49 1+06 6"-1/4 HB 1+57 N 518066.19 E 850751.72

SEQUENCE OF CONSTRUCTION

- I. OBTAIN A GRADING PERMIT AND LETTER OF AUTHORIZATION
- (LOA) TO DISTURB WETLAND BUFFER. 2. INSTALL STABILIZED CONSTRUCTION ENTRANCE,
- SILT FENCE AND SUPER SILT FENCE. (I WEEK)
- 3. BEGIN ROUGH GRADING OF SITE. AS SUBGRADE ELEVATION IS REACHED, INSTALL UTILITIES AND STORM DRAINS INSTALL INLET PROTECTION AS SHOWN. (2 WEEKS)
- 4. BEGIN BUILDING CONSTRUCTION, STABILIZE DISTURBED AREAS IN ACCORDANCE WITH PERMANENT AND TEMPORARY SEEDING NOTES. (3 WEEKS)
- 5. INSTALL CURB AND GUTTER AND PAVEMENT. (2 WEEKS)
- 6. COMPLETE REMAINING CONSTRUCTION. (AS NECESSARY)
- 7. UPON APPROVAL OF HOWARD COUNTY D.I.L.P. SEDIMENT CONTROL INSPECTOR, REMOVE SEDIMENT CONTROL DEVICES AND STABILIZE REMAINING DISTURBED AREAS IN ACCORDANCE WITH PERMANENT SEEDING NOTES. (2 DAYS)

STORM DRAIN STRUCTURE SCHEDULE											
NO.	<u>TYPE</u>	LOCATION	INV. IN	TOP CURB/ INV. OUT RIM ELEV.		REMARKS					
I-1	A-10	SEE GEOMETRY PLAN	_	397.95	401.78	HOCO STD: DETAIL SD 4:02					
M-1	4' MH	SEE GEOMETRY PLAN	390.70	390.60	394.10	HOCO STD. DETAIL 6 5.12					
M-2	4' MH	SEE GEOMETRY PLAN	397.52	397.27	402.90	HOCO STD. DETAIL 6 5.12					
5-1	1800 GAL. STORMCEPTOR	SEE GEOMETRY PLAN	394.44	394.34	403.30	SEE DETAIL, SHEET C-6					
	BY THE DEVELOPER :										

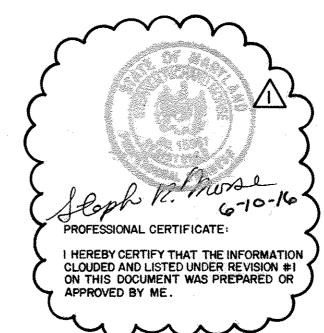

I/WE CERTIFY THAT ALL DEVELOPMENT AND CONSTRUCTION WILL BE DONE ACCORDING TO THIS PLAN. AND THAT ANY RESPONSIBLE PERSONNEL INVOLVED IN THE CONSTRUCTION PROJECT WILL HAVE A CERTIFICATE OF ATTENDANCE AT A DEPARTMENT OF THE ENVIRONMENT APPROVED TRAINING PROGRAM FOR THE CONTROL OF SEDIMENT AND EROSION

CONSERVATION DISTRICT. 10/21/91

BEFORE BEGINNING THE PROJECT. I ALSO AUTHORIZE

PERIODIC ON-SITE INSPECTIONS BY THE HOWARD SOIL

BY THE ENGINEER:

CERTIFY THAT THIS PLAN FOR EROSION AND SEDIMENT CONTROL REPRESENTS A PRACTICAL AND WORKABLE PLAN BASED ON MY PERSONAL KNOWLEDGE OF THE SITE CONDITIONS AND THAT IT WAS PREPARED IN ACCORDANCE WITH THE REQUIREMENTS OF THE HOWARD SOIL CONSERVATION DISTRICT.

ENGINEER

THESE PLANS HAVE BEEN REVIEWED FOR THE HOWARD SOIL CONSERVATION DISTRICT AND MEET THE TECHNICAL REQUIREMENTS FOR SOIL EROSION AND SEDIMENT CONTROL.

10.18.96

THIS DEVELOPMENT PLAN IS APPROVED FOR SOIL EROSION AND SEDIMENT CONTROL BY THE HOWARD SOIL CONSERVATION DISTRICT.

HOWARD SOIL CONSERVATION DISTRICT

APPROVED : HOWARD COUNTY DEPARTMENT OF PUBLIC WORKS

RIM B_ 11-14-26 CHIEF. BUREAU OF UTILITIES APPROVED: FOR PUBLIC WATER AND PUBLIC SEWERAGE

SYSTEMS, HOWARD COUNTY HEALTH DEPARTMENT

COUNTY HEALTH OFFICER HOWARD COUNTY DEPARTMENT OF PLANNING AND

11/13/92 DATE 11/5/56 MAN MAN CONTRACTOR CHIEF. DEVELOPMENT ENGINEERING DIVISION CHIEF, DIVISION OF LAND DEVELOPMENT

6/10/16 /1 REDLINE REVISIONS - SEE NOTES SHEET C-2, DRAWING 2 OF 7. REVISION

HOWARD COUNTY

OWNER / DEVELOPER

AND RESEARCH

DEPARTMENT OF PUBLIC WORKS 3450 COURT HOUSE DRIVE ELLICOTT CITY, MD 21043

SECOND DISTRICT FIRE STATION


AREA TAX MAP 24 BLOCK 23 \$24 ZONED B-2 2nd ELECTION DISTRICT, PARCEL A-2 HOWARD COUNTY, MARYLAND

TITLE

PROFILES AND NOTES


RIEMER MUEGGE & ASSOCIATES, INC


ENGINEERING • ENVIRONMENTAL SERVICES • PLANNING • SURVEYING 8818 Centre Park Drive, Columbia, Maryland 21045 tel 410.997.8900 fax 410.997.9282

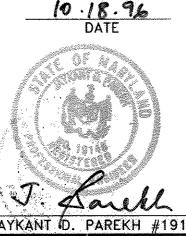

DESIGNED BY : A.A.P. DRAWN BY : WEJ PROJECT NO :96_001/ SDP_C-5.DW DATE: October 18, 1996

SCALE : AS SHOWN DRAWING NO. 5 OF 7

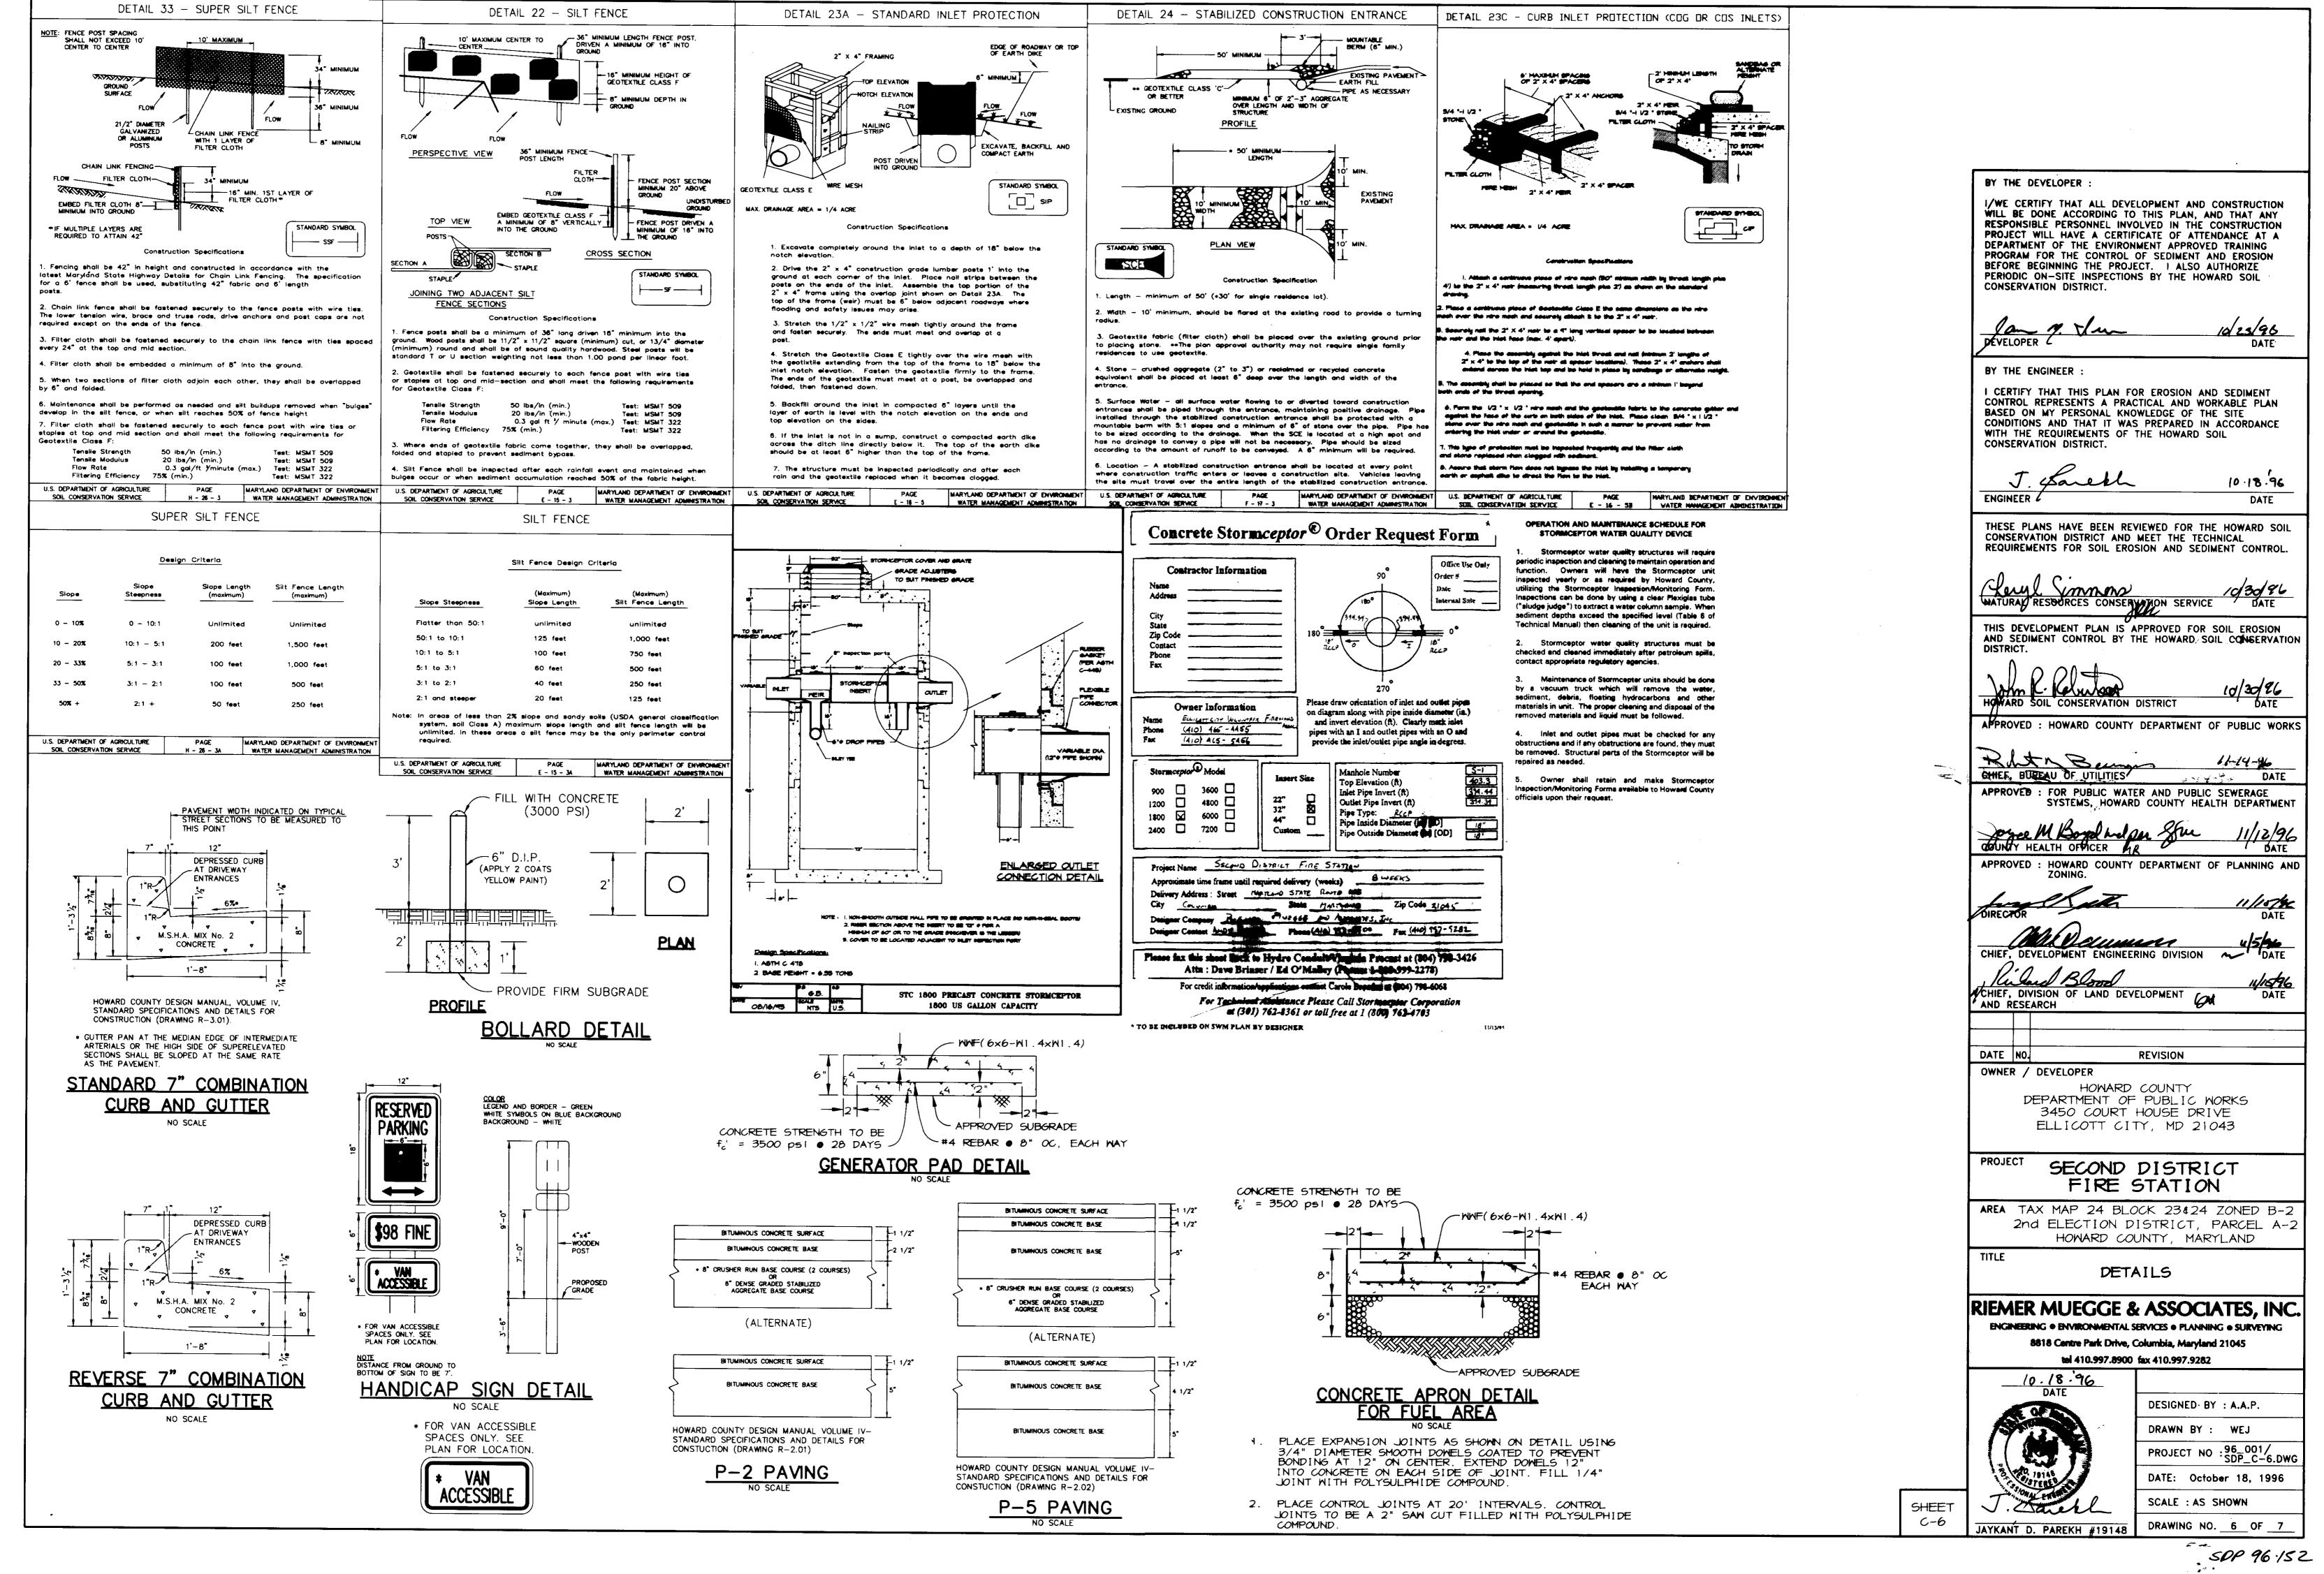

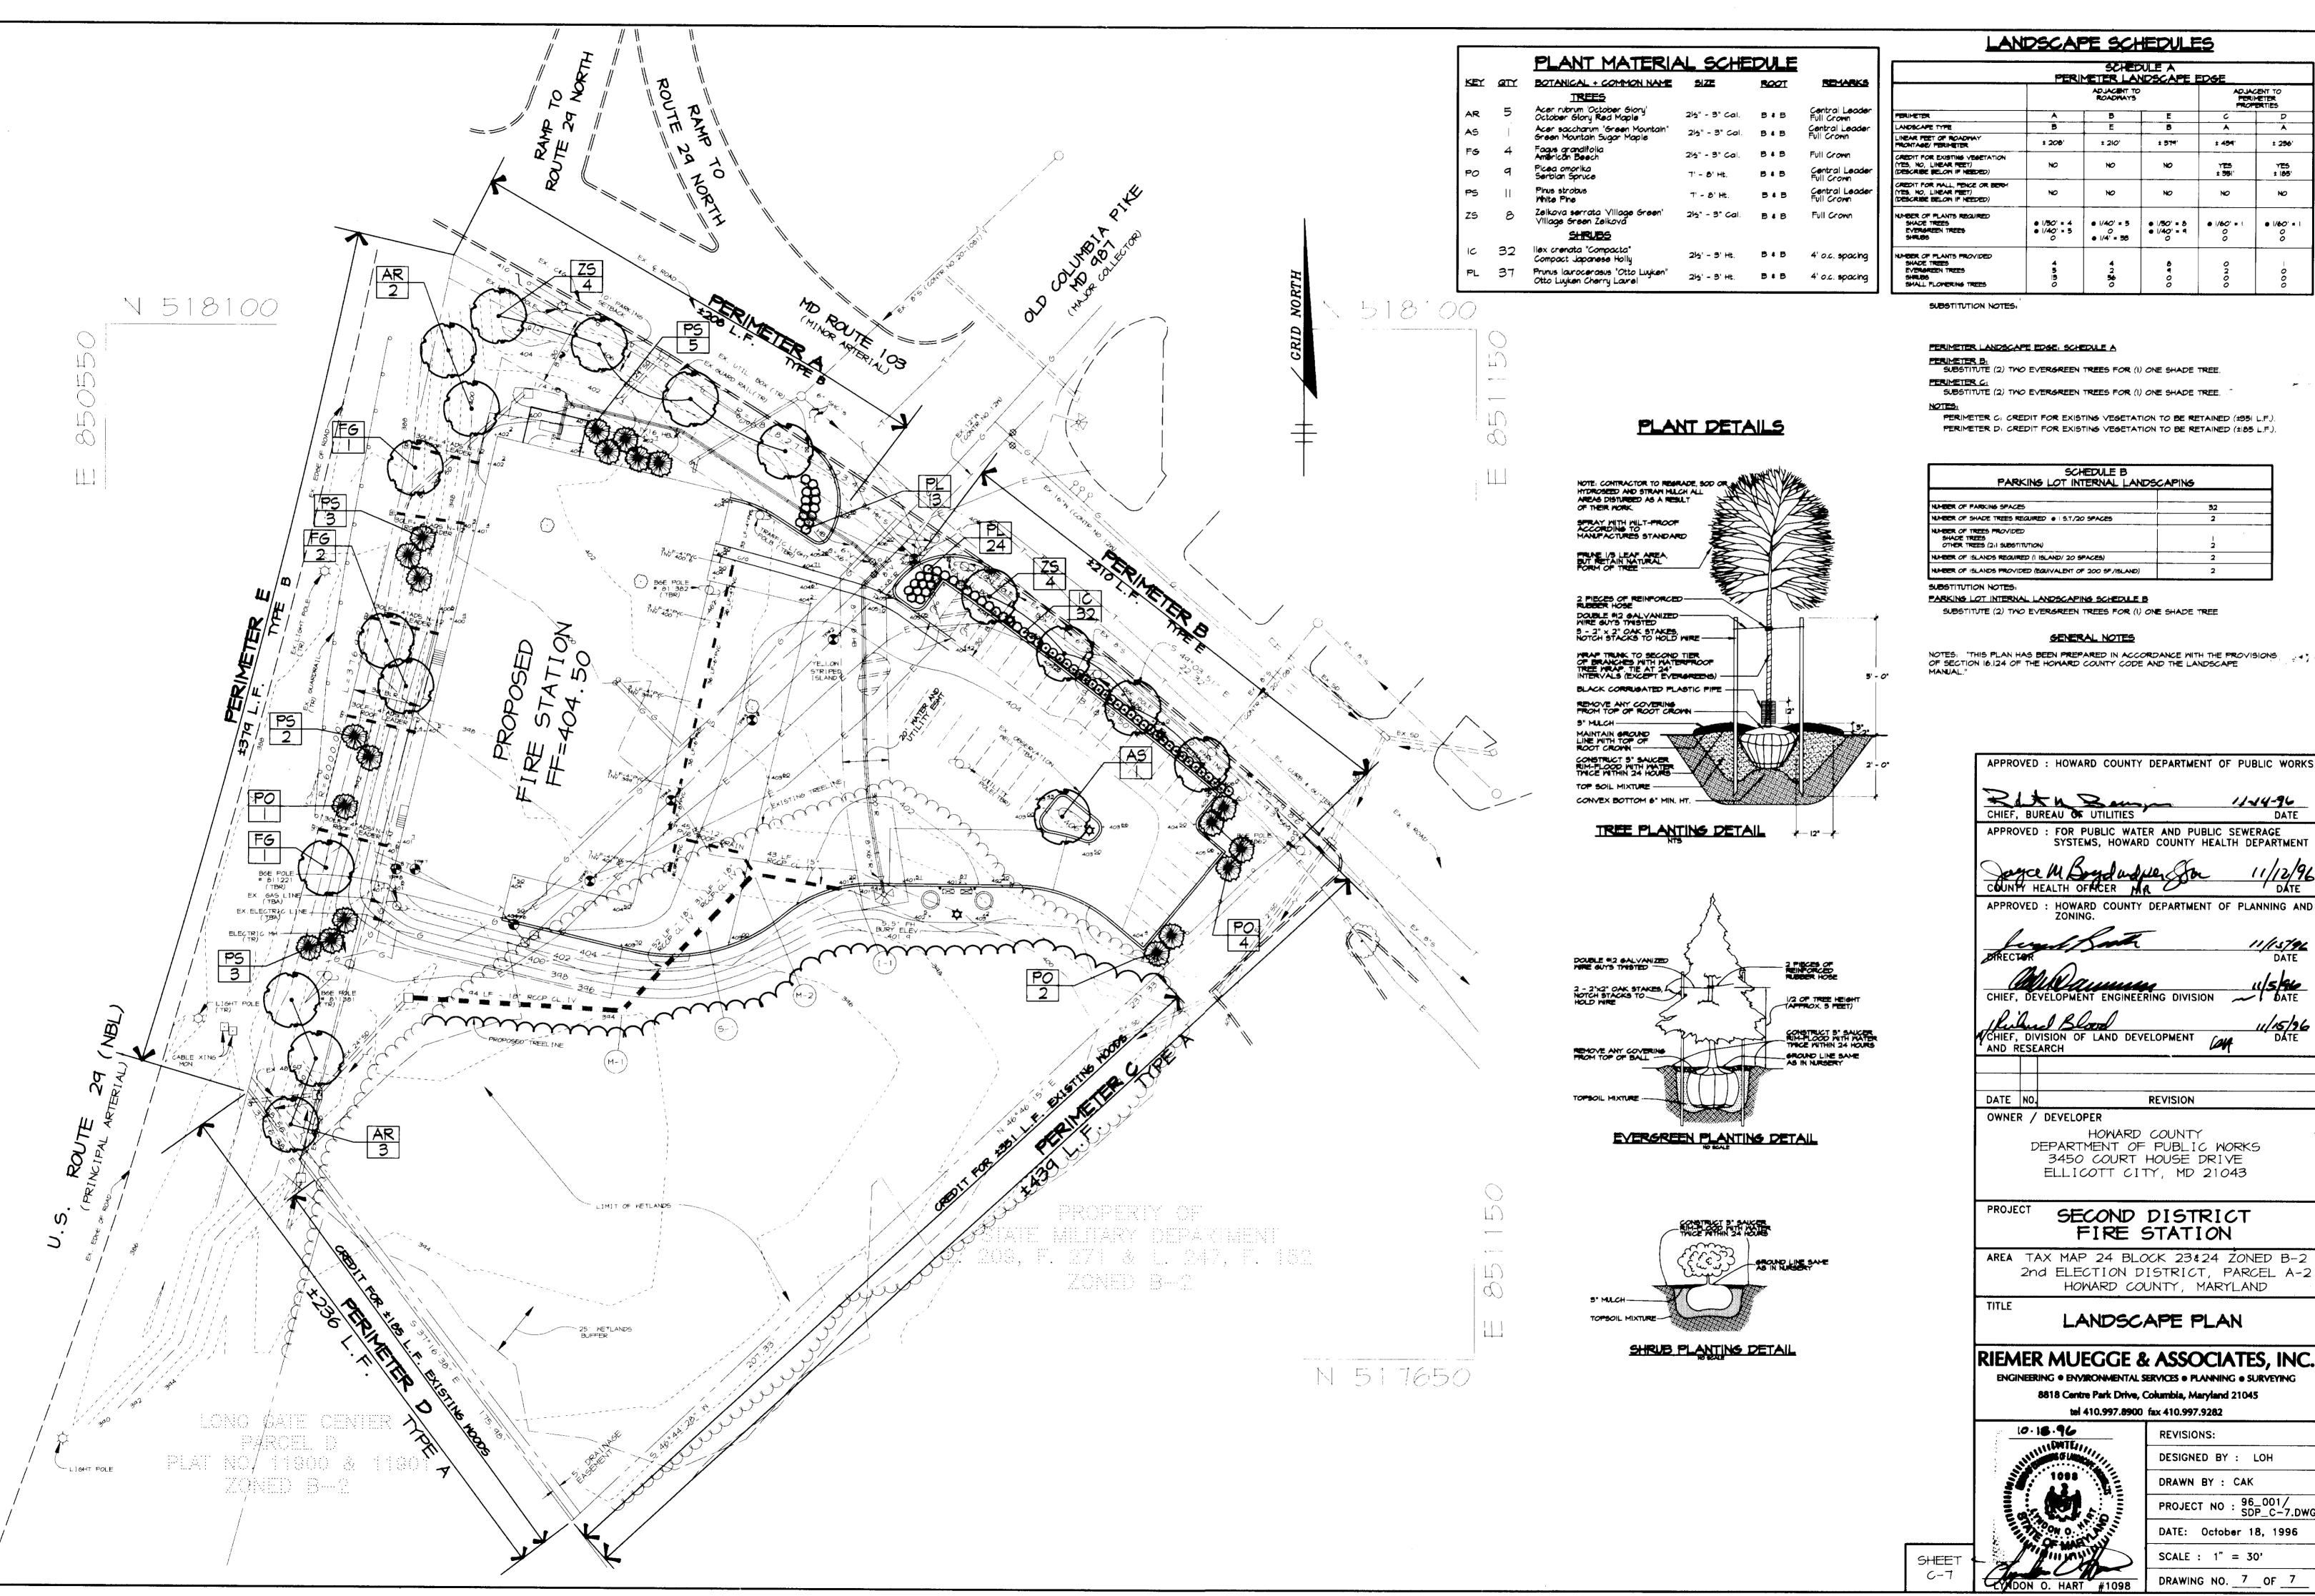

SCHEDULE A PERIMETER LANDSCAPE EDGE								
		ADJACENT TO ROADWAYS	ADJACENT TO PERIMETER PROPERTIES					
BRIMETER	A	B	E	c	D			
ANDSCAPE TYPE	5	E	В					
NEAR FEET OF ROADWAY RONTAGE/ FERIMETER	± 206'	± 210'	± 374'	± 454'	± 256'			
REDIT FOR EXISTING VEGETATION 725, NO. LINEAR FEET) RESCRIBE BELOW IF NEEDED)	No	ж	NO	YES ± 351'	YE5 ± 185'			
REDIT FOR WALL, PENCE OR BERM 125, NO, LINEAR MEET) 255CRIBE BELOW IF NEEDED)	No	NO	NO	NO	NO			
IMBER OF PLANTS REGUIRED SHADE TREES EVERGREEN TREES SHRUBS	• 1/50' = 4 • 1/40' = 5	• 1/40' = 5 0 • 1/4' = 56	• 1/50' = 8 • 1/40' = 9	• 1/60' = 1 0 0	• 1/60' = 1 0 0			
MODER OF PLANTS PROVIDED SHADE TREES SHRUBS SHALL FLORERING TREES	4 5 15 0	4 2 56 0	8 9 00	0 2 0 0	-000			

PERIMETER C: CREDIT FOR EXISTING VEGETATION TO BE RETAINED (±951 L.F.).

NOTES: "THIS PLAN HAS BEEN PREPARED IN ACCORDANCE WITH THE PROVISIONS OF SECTION 16.124 OF THE HOWARD COUNTY CODE AND THE LANDSCAPE

11-14-96 APPROVED : FOR PUBLIC WATER AND PUBLIC SEWERAGE SYSTEMS, HOWARD COUNTY HEALTH DEPARTMENT 11/15/96 11/15/96 DATE

AREA TAX MAP 24 BLOCK 23\$24 ZONED B-2 2nd ELECTION DISTRICT, PARCEL A-2

8818 Centre Park Drive, Columbia, Maryland 21045

DESIGNED BY : LOH DRAWN BY : CAK PROJECT NO : 96_001/ SDP_C-7.DWG DATE: October 18, 1996 SCALE : 1" = 30'

50P 96.15Z