WARSAW AUTOMOBILE DEALERSHIP

SOIL CONSERVATION DISTRICT.


- Cour Occo


ROBERT H. VOGEL

SIGNATURE OF ENGINEER

1/16/76

SIGNATURE OF DEVELOPER

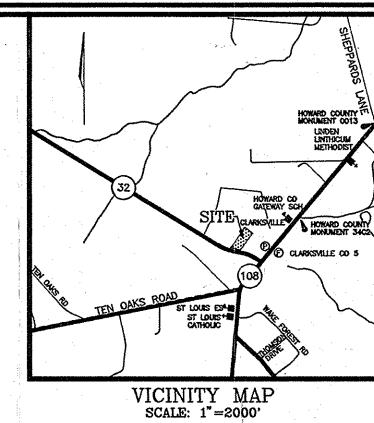

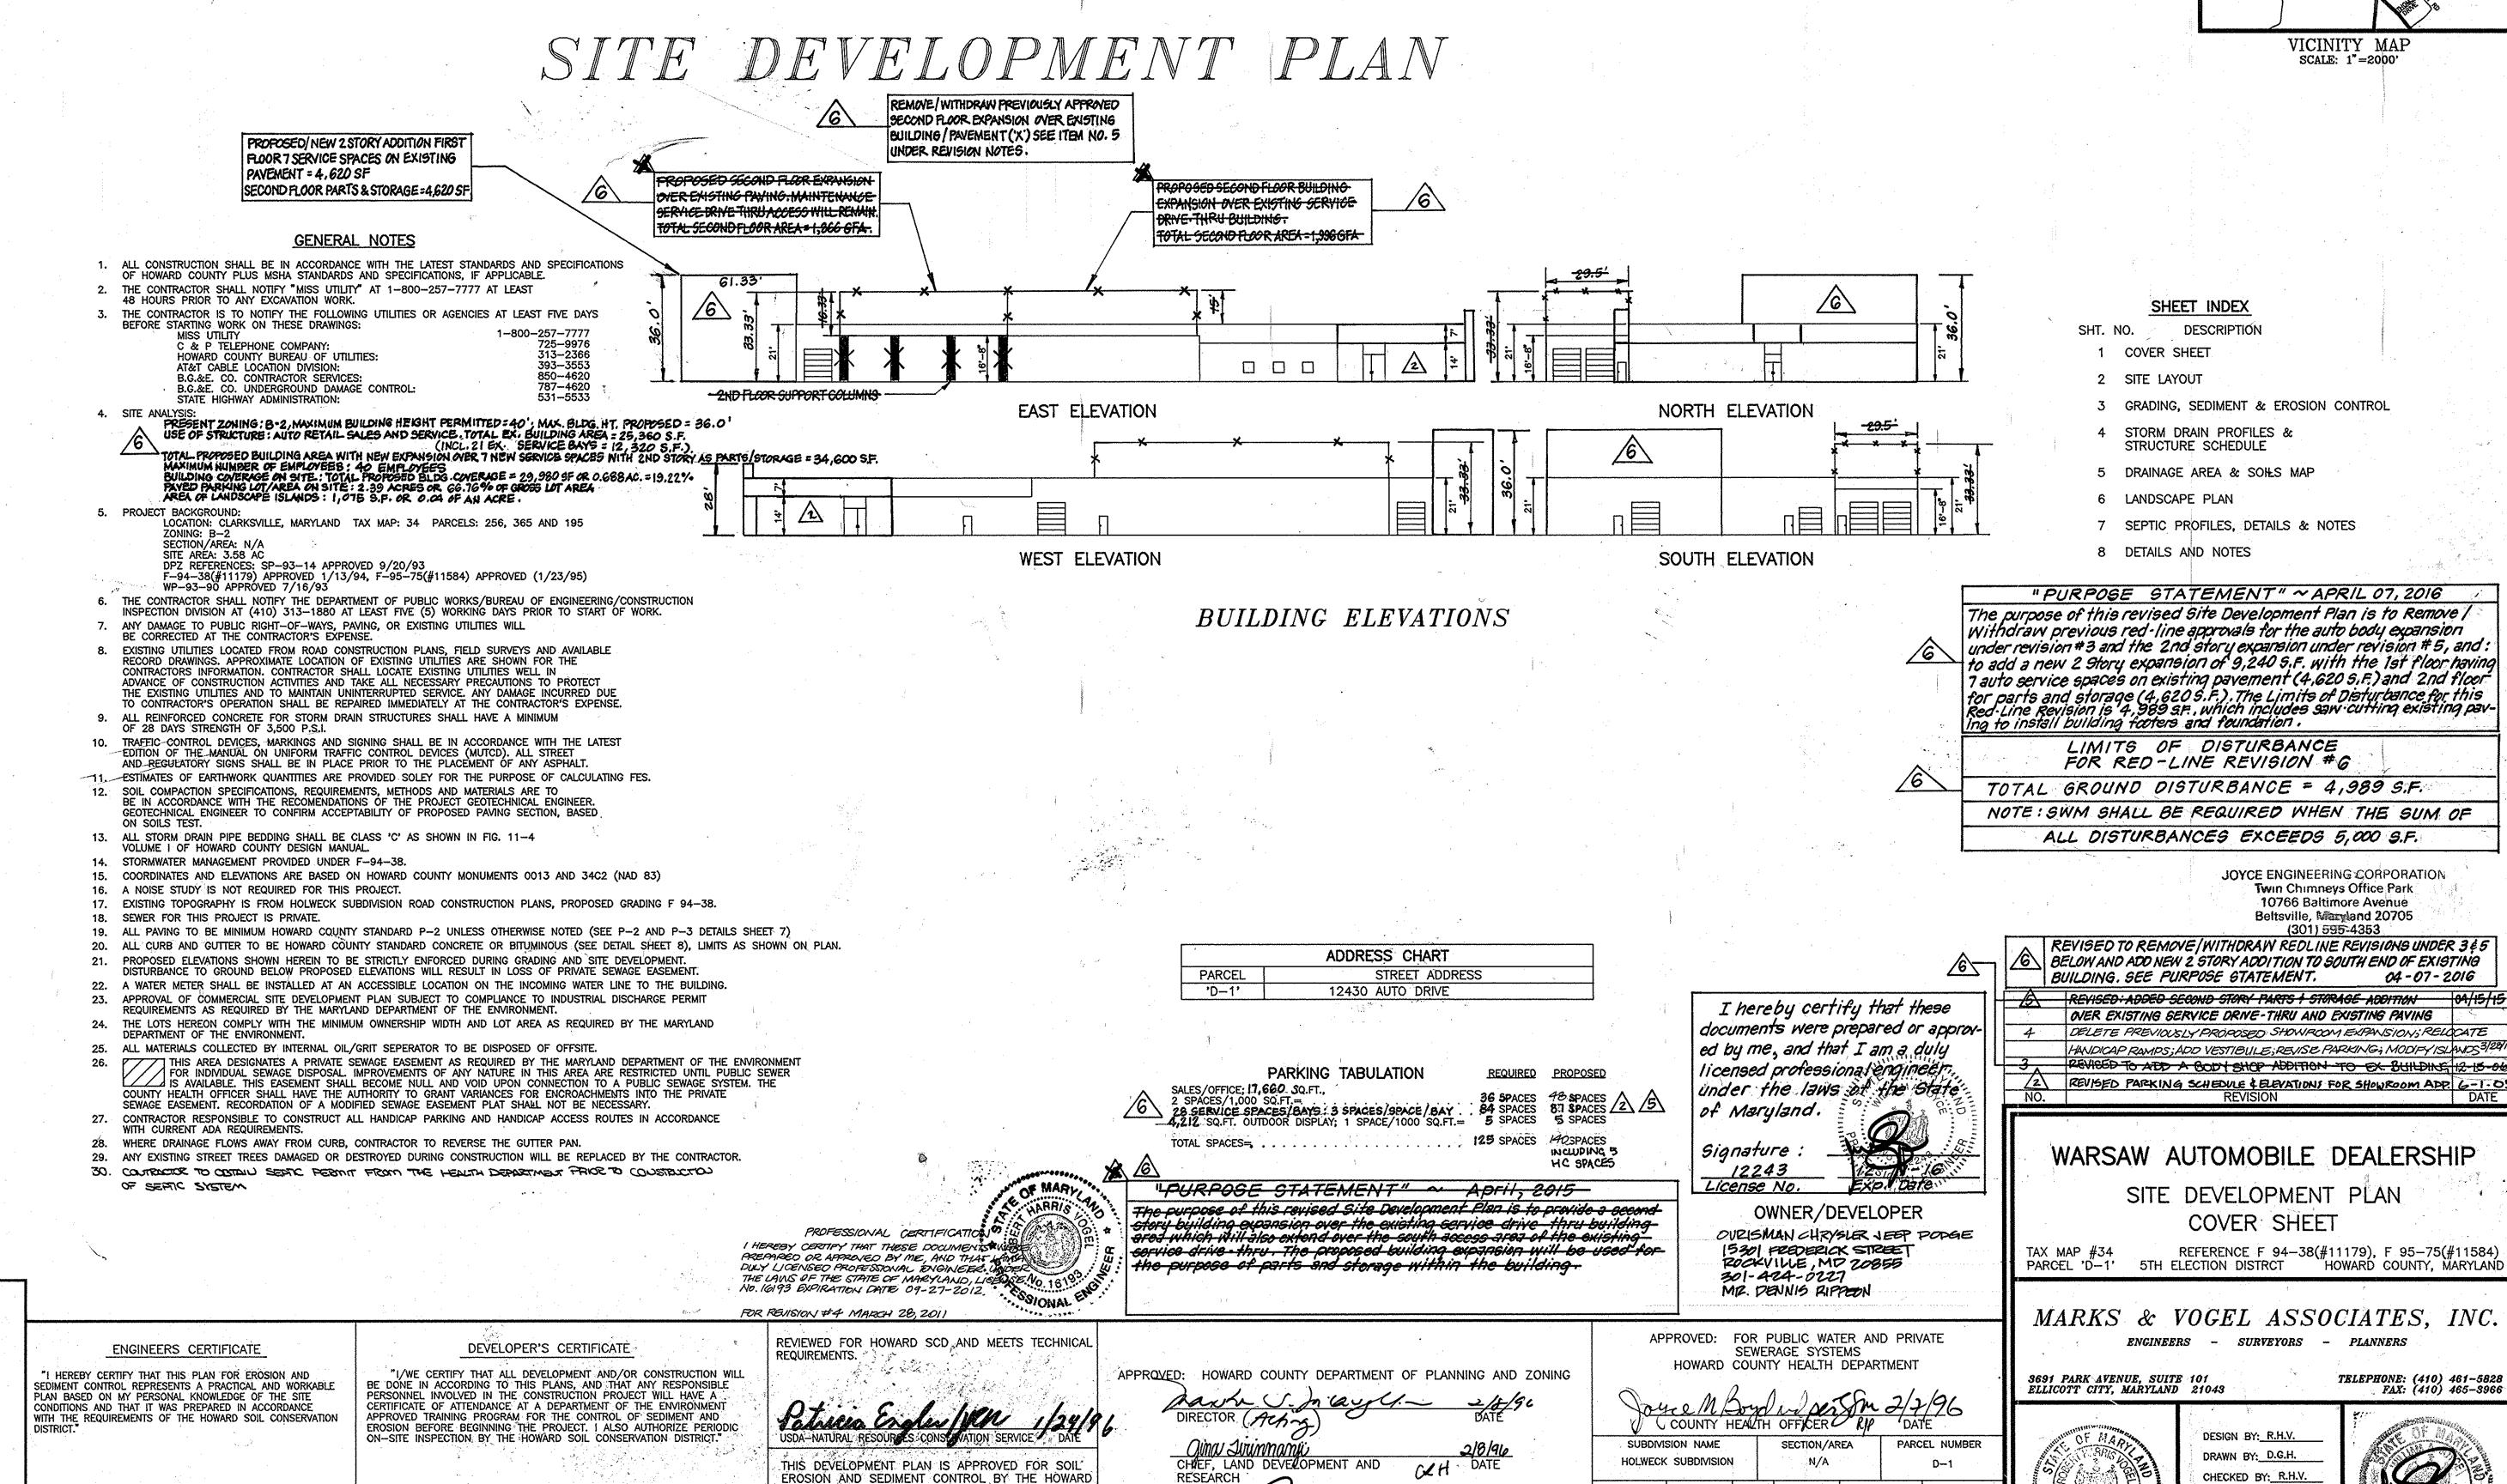

DATE: NOVEMBER, 1995

w.o. No.: 95-60

SCALE: 1"=30"

ELECT. DIST.

SEWER CODE

PRIVATE

CENSUS TR


6051.01


BLOCK NO. | ZONE | TAX/ZONE |


6


J 07

WATER CODE

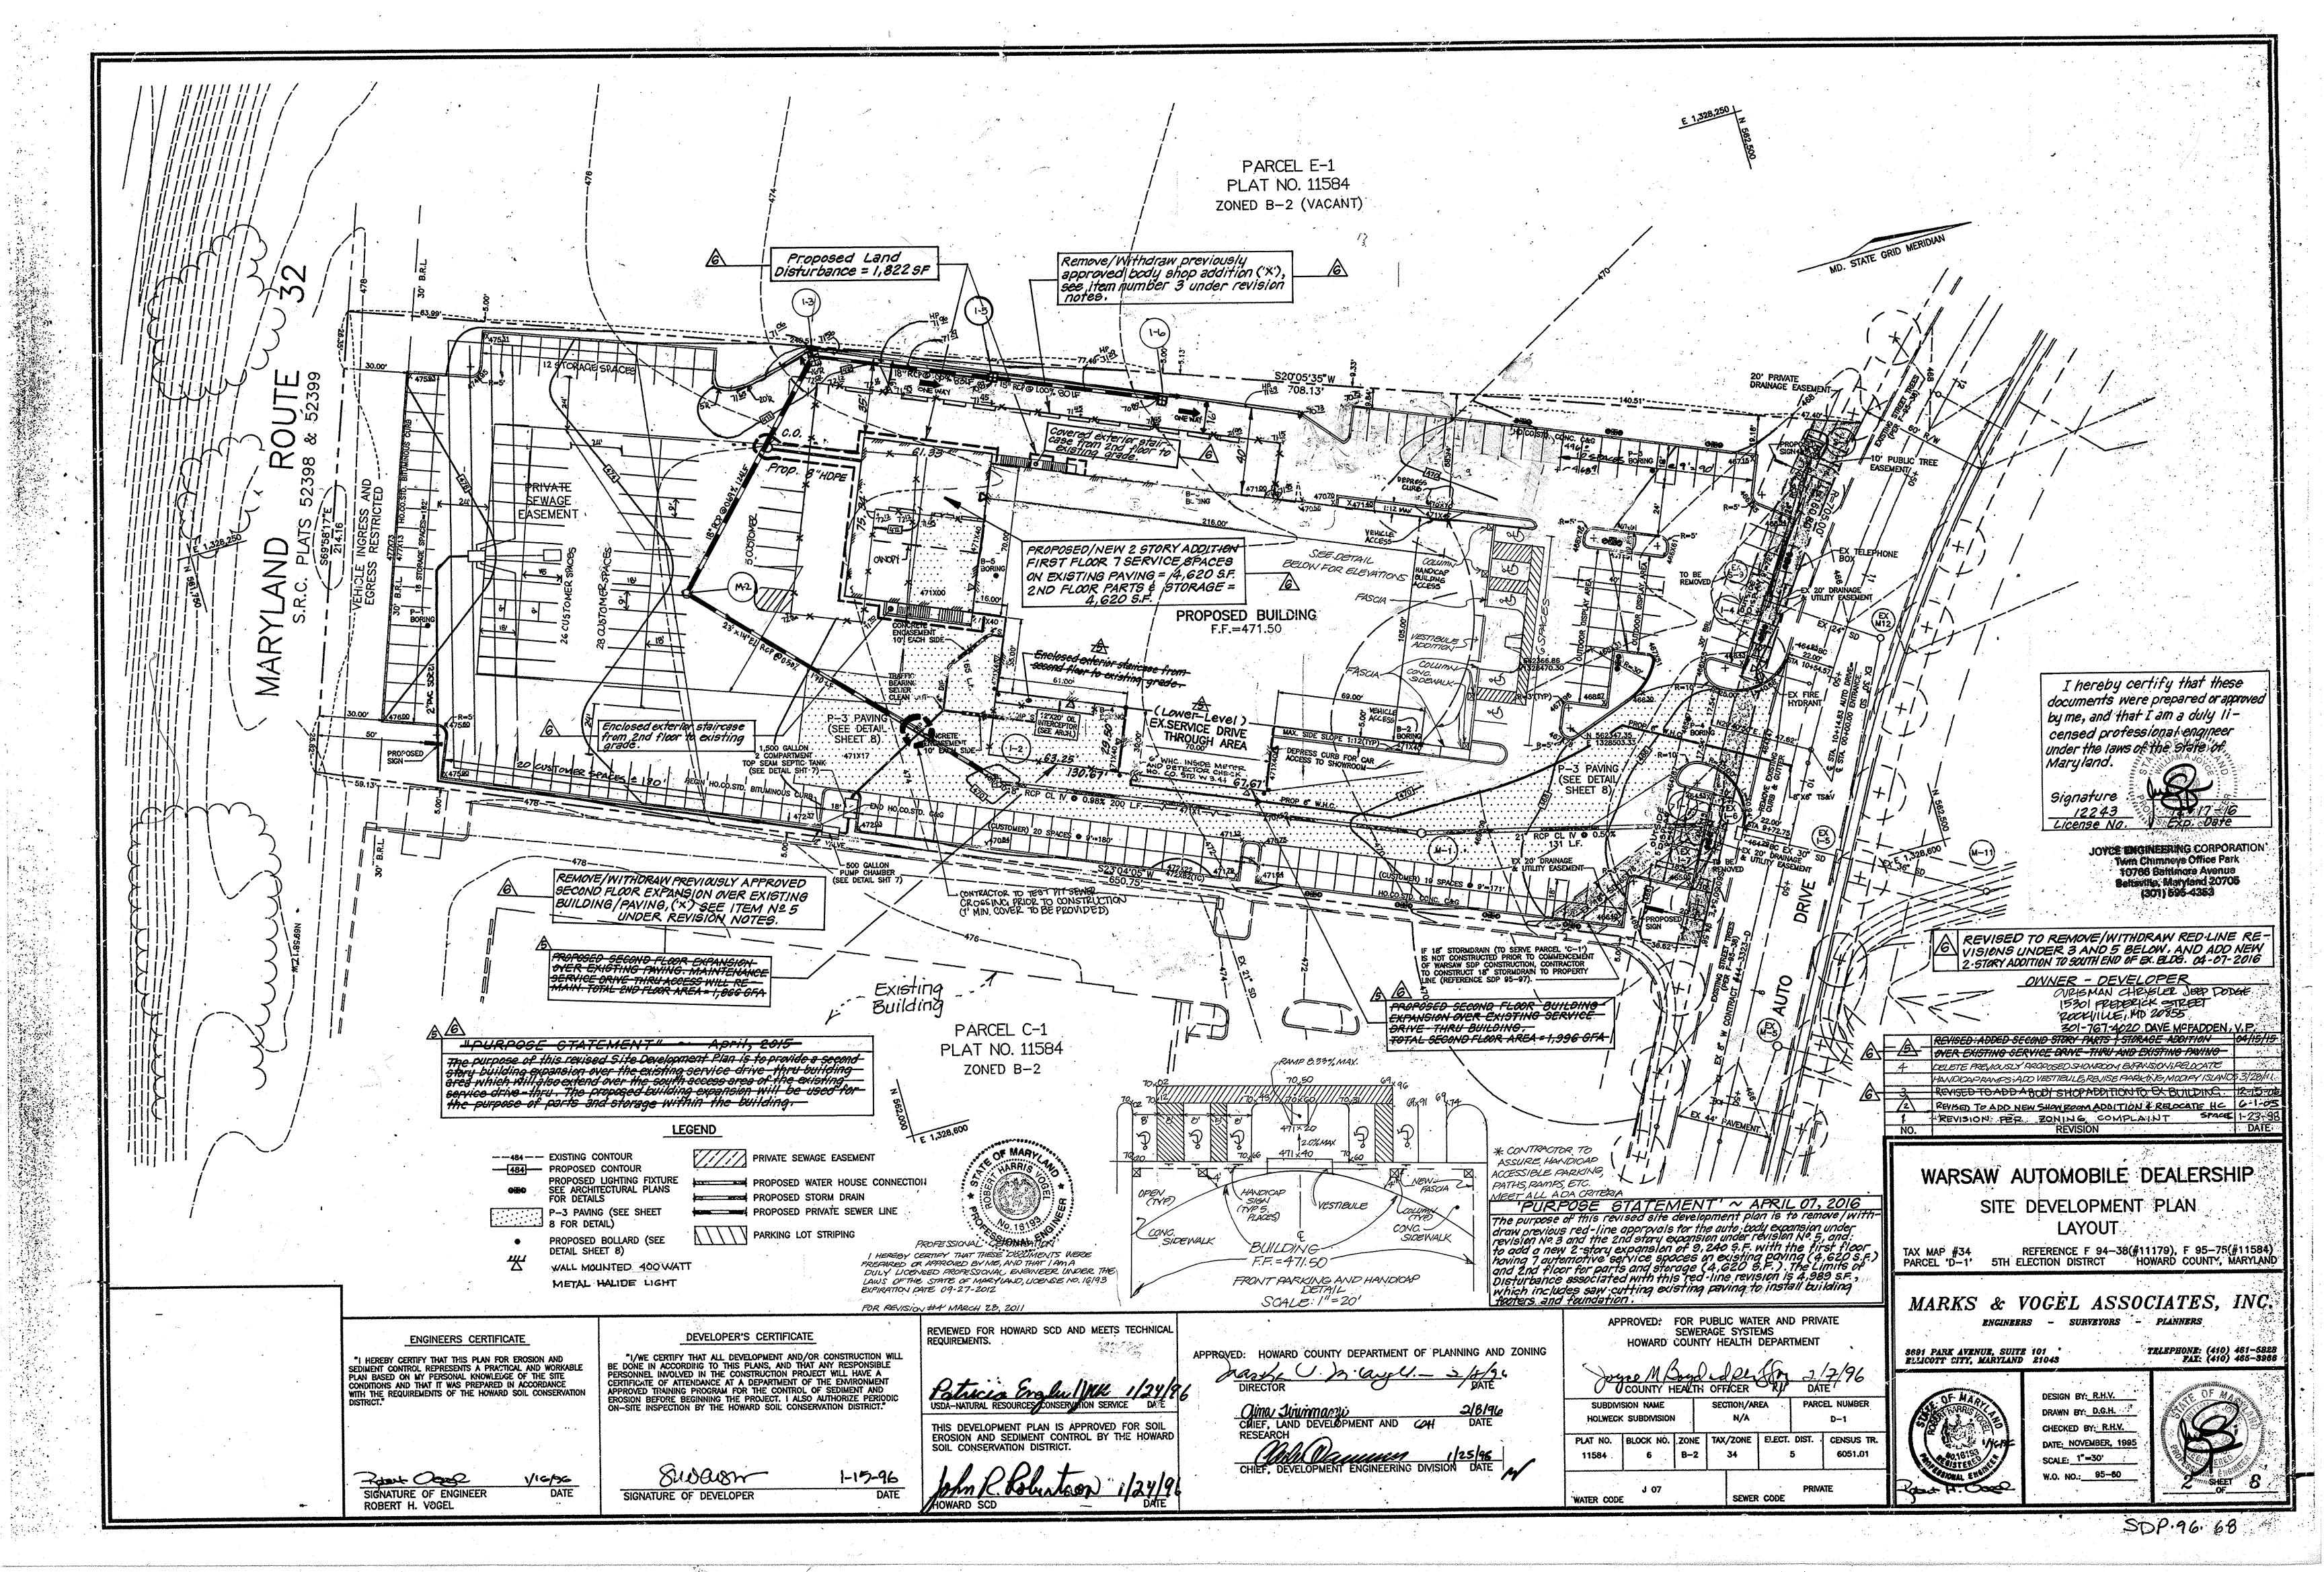

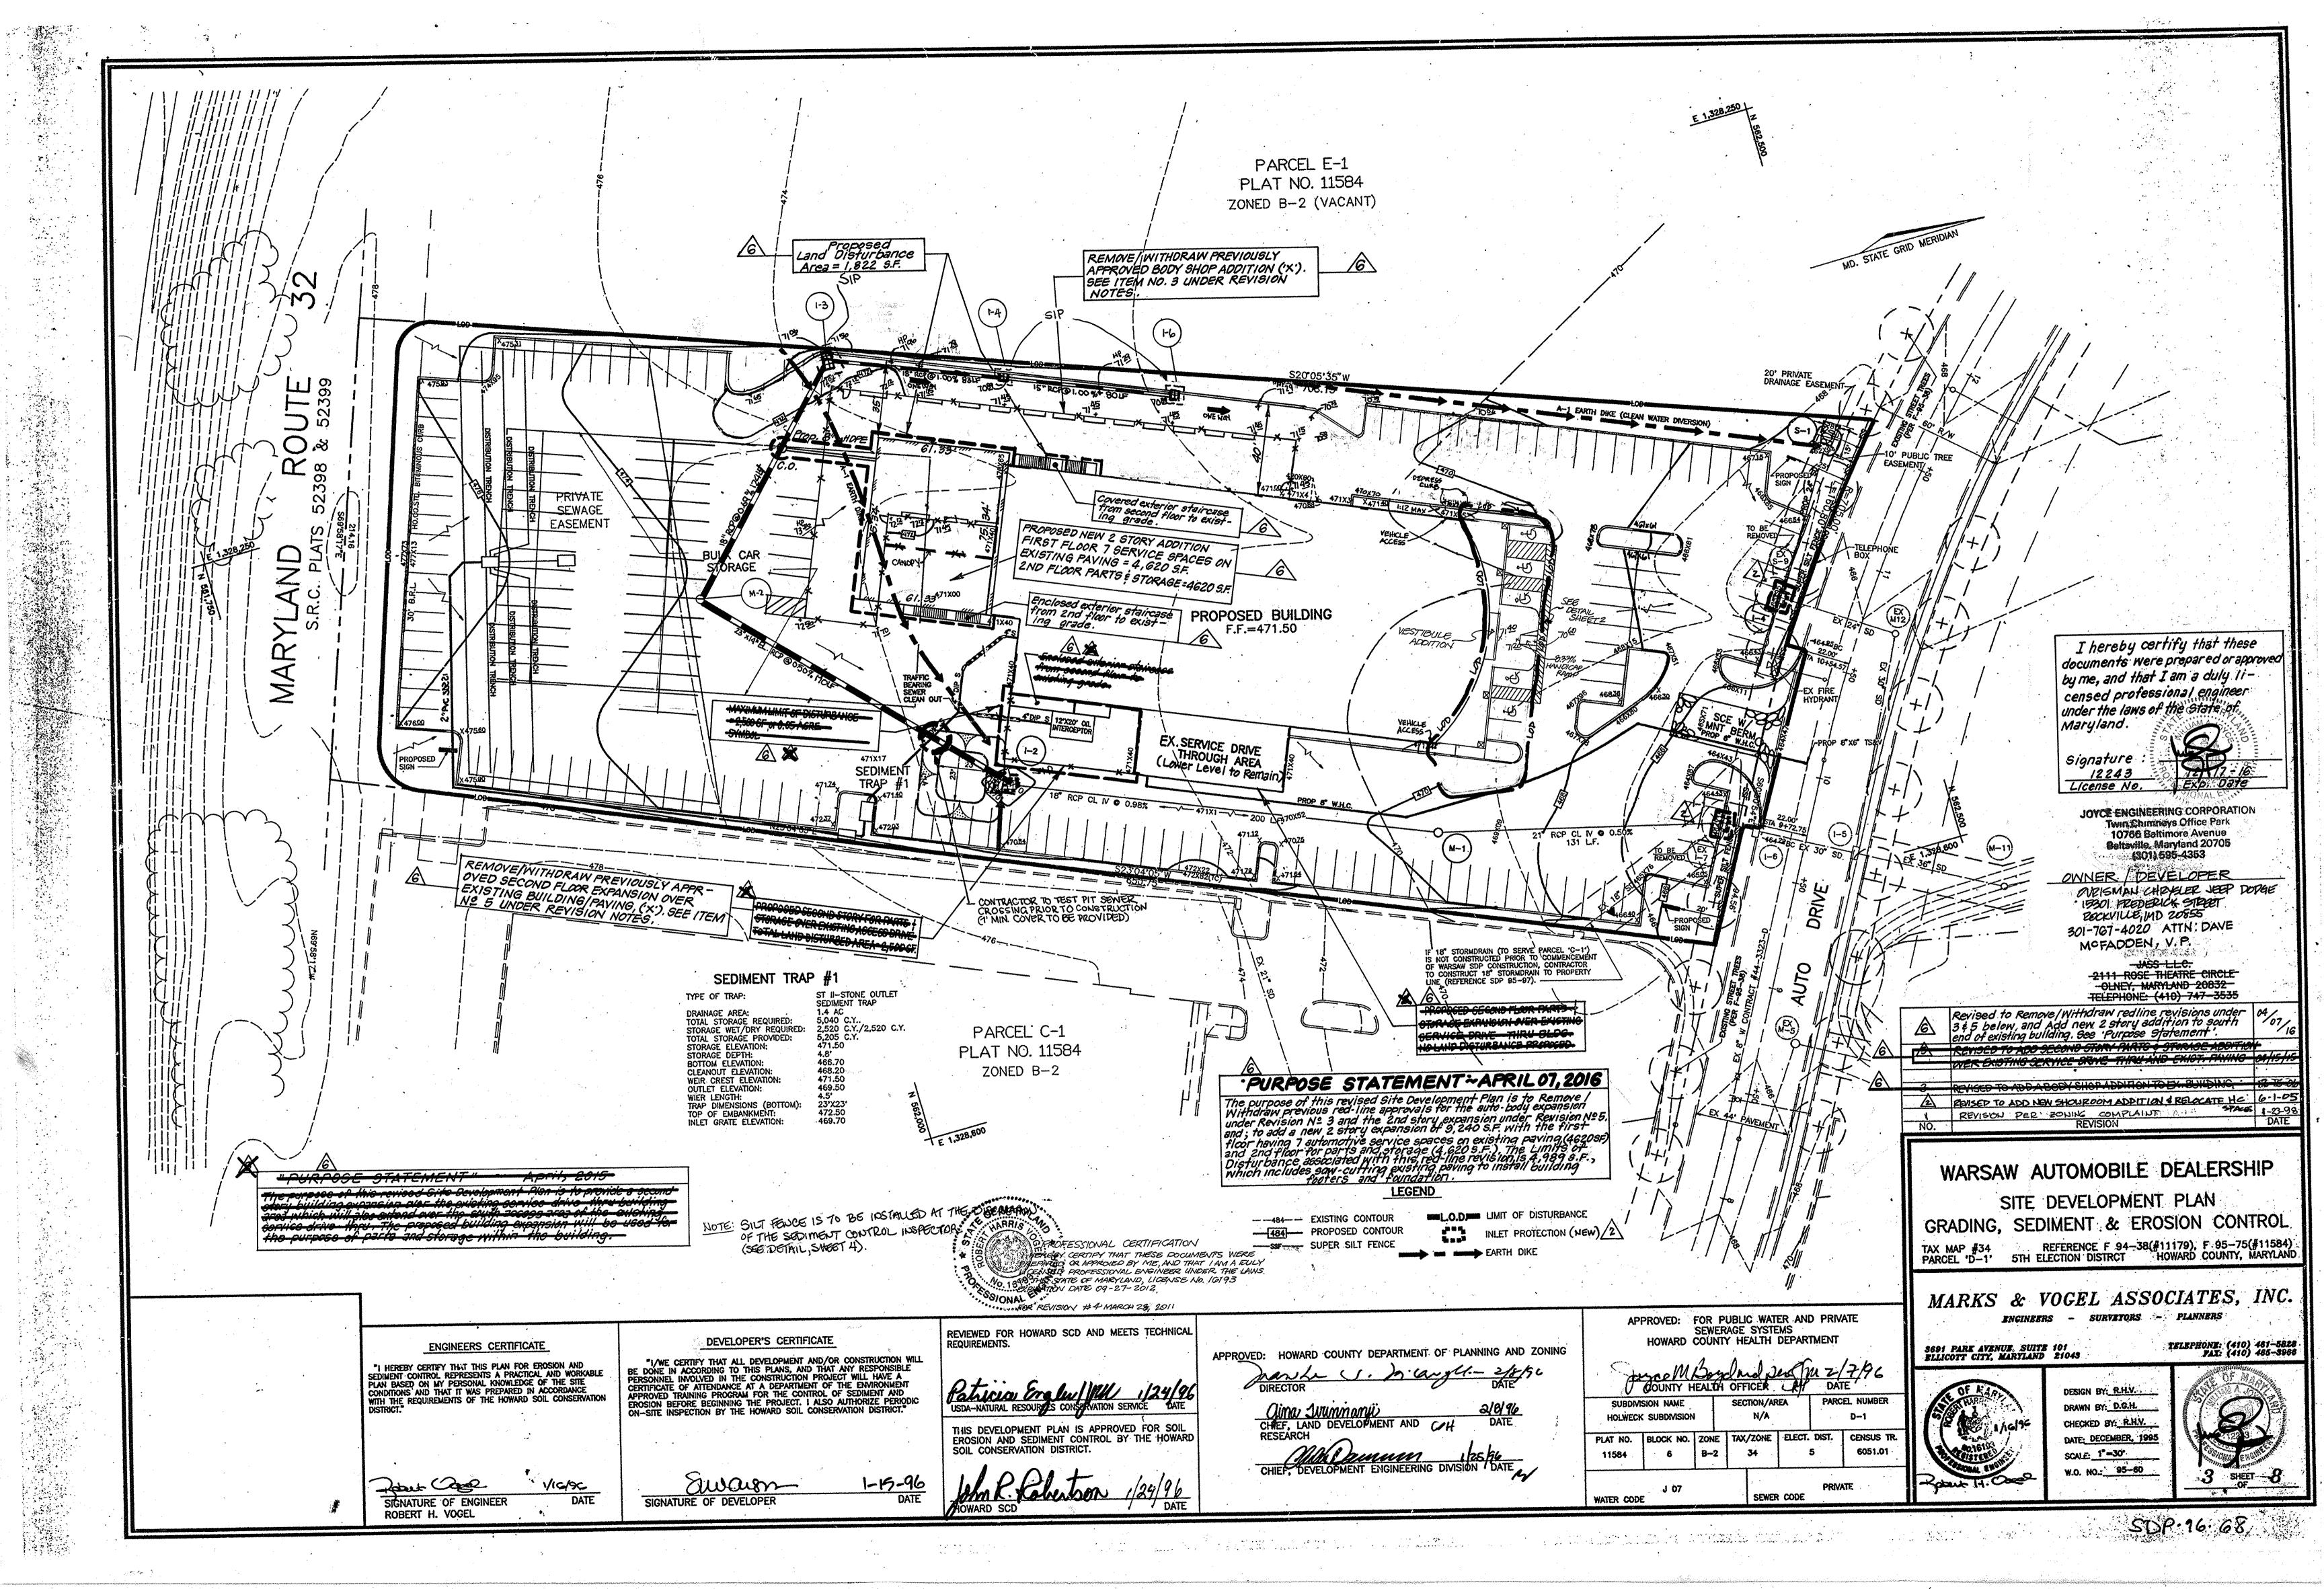

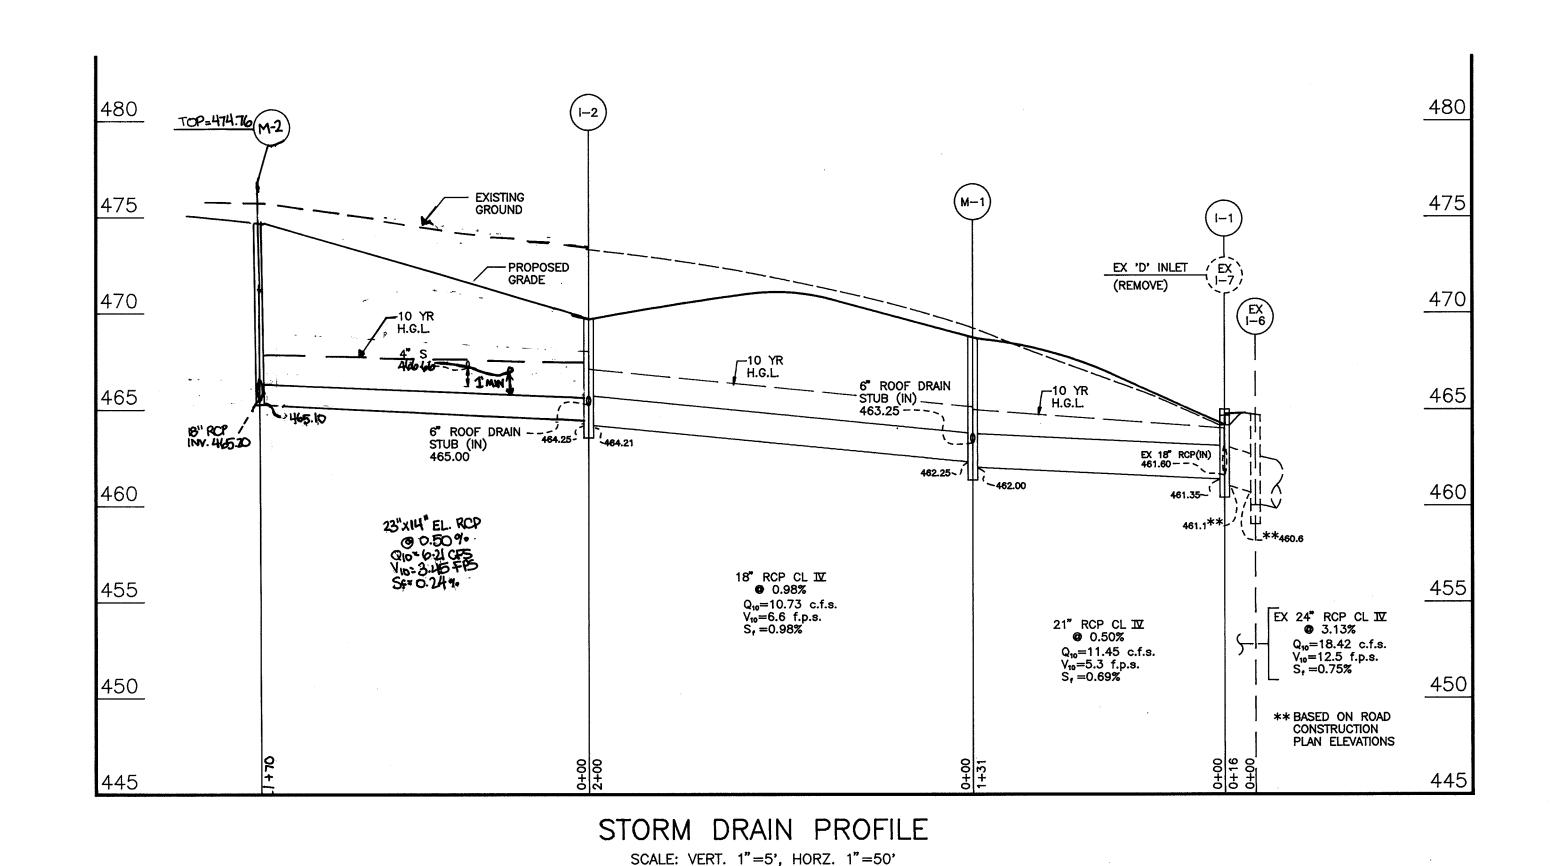

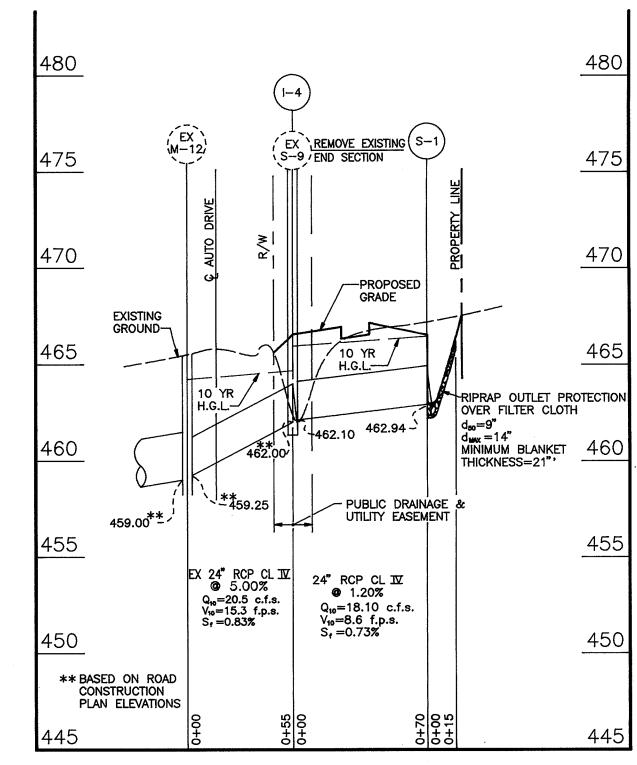

STORM DRAIN PROFILE SCALE: VERT. 1"=5', HORZ. 1"=50'


STRUCTURE SCHEDULE

+ TOP OF GRATE.


110.	TYPE	TOP ELEVATION	ROADWAY SLOPE	CROSS SLOPE	LOCATION	INV IN	INV OUT	REMARKS
i-1	PRECAST STD TYPE A-5 INLET	464.75	SUMP	SEE GRADING PLAN	N 562,395.2 E 1,328,563.2	461.35	461.10	HOWARD COUNTY STD. DTL. SD 4.40
I-2	DOUBLE S INLET	469.70 ⁺	SUMP	SEE GRADING PLAN	N 562,082.8 E 1,328,453.6	464.25	464.21	HOWARD COUNTY STD. DTL. SD 4.23
			4.7		200		,	
I-4	PRECAST STD TYPE A-5 INLET	466.55	SUMP	SEE GRADING PLAN	N 562,450.7 E 1,328,470.6	462.10	462.00	HOWARD COUNTY STD. DTL. SD 4.40
M-1	PRECAST STD MANHOLE	469.50	-	SEE GRADING PLAN	N 562,267.62 E 1,328,530.5	462.25	462.00	HOWARD COUNTY STD. DTL. G 5.12
S-1	STANDARD END SECTION	N/A	<u> </u>	_	N 562,489.1 E 1,328,413.0	462.94	_	HOWARD COUNTY STD. DTL. SD 5.52

۵ و	CROSS SECTIONS
NE .	Standard symbol
	1

STRUCTURE SCHEDULE								
No.	TYPE	LOCATION	TOP ELEY.	INV.	INV. OUT	COMMENTS		
1-3	DOUBLE TYPE'S'COMB. INTET(NORMAL)	N 582055 E 1328241	471.06	466.15	166.05	HO.CO.STDSD-4.3		
1-5	TYPE'S' COMB. INVET	N 582132E1328272	470.89	46699	466.74	Ho.Co.STD 6D-4.3		
1-6	TYPE 'S' COMB. INLET	N582206 E 1328302	47089		467.39	HO-CO. STD SD-4:3		
MH-2	STANDARD 4" MANHOLE	N 581968 E 1328170						

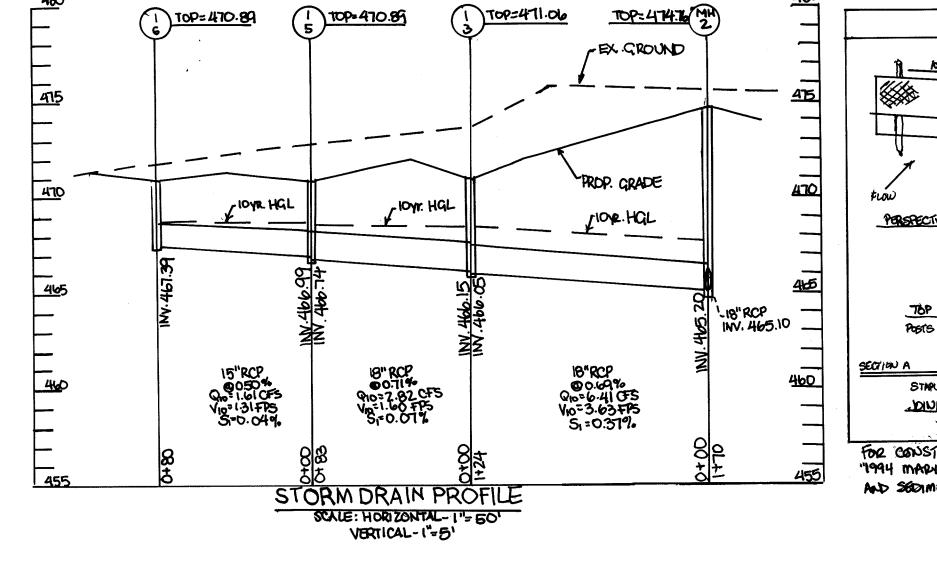

ROBERT H. VOGEL

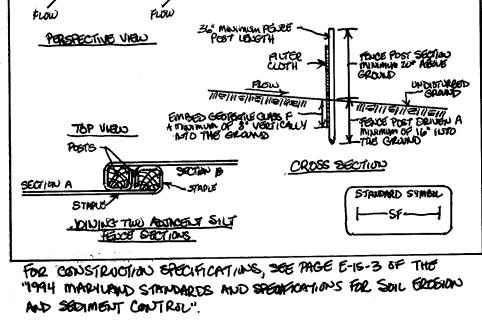

SILT FONCEL

DEVELOPER'S CERTIFICATE ENGINEERS CERTIFICATE "I HEREBY CERTIFY THAT THIS PLAN FOR EROSION AND SEDIMENT CONTROL REPRESENTS A PRACTICAL AND WORKABLE PLAN BASED ON MY PERSONAL KNOWLEDGE OF THE SITE CONDITIONS AND THAT IT WAS PREPARED IN ACCORDANCE WITH THE REQUIREMENTS OF THE HOWARD SOIL CONSERVATION DISTRICT." SIGNATURE OF ENGINEER 1/16/96

"I/WE CERTIFY THAT ALL DEVELOPMENT AND/OR CONSTRUCTION WILL BE DONE IN ACCORDING TO THIS PLANS, AND THAT ANY RESPONSIBLE PERSONNEL INVOLVED IN THE CONSTRUCTION PROJECT WILL HAVE A CERTIFICATE OF ATTENDANCE AT A DEPARTMENT OF THE ENVIRONMENT APPROVED TRAINING PROGRAM FOR THE CONTROL OF SEDIMENT AND EROSION BEFORE BEGINNING THE PROJECT. I ALSO AUTHORIZE PERIODIC ON—SITE INSPECTION BY THE HOWARD SOIL CONSERVATION DISTRICT." SIGNATURE OF DEVELOPER

REVIEWED FOR HOWARD SCD AND MEETS TECHNICAL

THIS DEVELOPMENT PLAN IS APPROVED FOR SOIL EROSION AND SEDIMENT CONTROL BY THE HOWARD SOIL CONSERVATION DISTRICT.

APPROVED: HOWARD COUNTY DEPARTMENT OF PLANNING AND ZONING

OHIEF, LAND DEVELOPMENT AND COH

APPROVED: FOR PUBLIC WATER AND PRIVATE SEWERAGE SYSTEMS HOWARD COUNTY HEALTH DEPARTMENT

SEWER CODE

SUBDIVISION NAME SECTION/AREA HOLWECK SUBDIVISION PLAT NO. BLOCK NO. ZONE TAX/ZONE ELECT. DIST. CENSUS TO 6051.01 6 B-2

WATER CODE

SEQUENCE OF CONSTRUCTION

1. OBTAIN GRADING PERMIT.

11. INSTALL LANDSCAPING.

- 2. NOTIFY HOWARD COUNTY BUREAU OF INSPECTIONS AND PERMITS (313-1880) AT LEAST 24 HOURS BEFORE STARTING ANY WORK.
- 3. CONSTRUCT STABILIZED CONSTRUCTION ENTRANCE. 1 DAY
- 2 DAYS 4. INSTALL PERIMETER SEDIMENT CONTROL MEASURES,
- 5. CONSTRUCT STORM DRAINAGE SYSTEM AND INSTALL INLET PROTECTION AND INLET SEDIMENT TRAPS (#1) 1 WEEK
- 2 DAYS 6. PERFORM FINAL SITE GRADING. 7. BEGIN BUILDING CONSTRUCTION 8 WEEKS
- 8. INSTALL PRIVATE SEWAGE DISPOSAL SYSTEM. CONTACT HEALTH DEPARTMENT FOR INSPECTION 2 DAYS PRIOR TO COVERING TRENCHES.
- 9. CONSTRUCT WATER HOUSE CONNECTION 1 WEEK
- 10. CONSTRUCT PARKING LOTS AND DRIVES. REMOVE SEDIMENT
- 2 WEEKS INSPECTOR.

TRAPS PRIOR TO PAVING WITH APPROVAL OF SEDIMENT

- 12. DURING GRADING AND AFTER EACH RAINFALL, THE CONTRACTOR SHALL INSPECT AND PROVIDE NECESSARY MAINTENANCE ON THE
- SEDIMENT AND EROSION CONTROL MEASURES SHOWN HEREON. 13. FOLLOWING INITIAL SOIL DISTURBANCE OR REDISTURBANCE.
 - PERMANENT OR TEMPORARY STABILIZATION SHALL BE COMPLETED
 - A. 7 CALENDAR DAYS FOR ALL PERIMETER SEDIMENT CONTROL STRUCTURES, DIKES, SWALES, DITCH PERIMETER SLOPES AND ALL SLOPES GREATER THAN 3:1.
 - B. 14 CALENDER DAYS FOR ALL OTHER DISTURBED AREAS.
- 14. UPON STABILIZATION OF ALL DISTURBED AREAS AND WITH THE APPROVAL OF THE SEDIMENT CONTROL INSPECTOR, REMOVE ALL SEDIMENT CONTROL DEVICES.

OWNER/DEVELOPER

JASS L.L.C. 2111 ROSE THEATRE CIRCLE OLNEY, MARYLAND 20832 TELEPHONE: (410) 747-3535

REVISED TO ADD A BODY SHOP ADDITION TO EX. BUILDING 12-15-06

WARSAW AUTOMOBILE DEALERSHIP

SITE DEVELOPMENT PLAN STORMDRAIN PROFILES & STRUCTURE SCHEDULE

TAX MAP #34 5TH ELECTION DISTRICT

PARCEL 'D-1' HOWARD COUNTY, MARYLAND

1 DAY

MARKS & VOGEL ASSOCIATES, INC. ENGINEERS - SURVEYORS - PLANNERS

3691 PARK AVENUE, SUITE 101 ELLICOTT CITY, MARYLAND 21043

TELEPHONE: (410) 461-5828 FAX: (410) 465-3966



DESIGN BY: R.H.V. DRAWN BY: D.G.H. CHECKED BY: R.H.V. DATE: DECEMBER, 1995 SCALE: 1"=30' W.O. NO.: 95-60

4 SHEET 8

