	SHEET INDEX
NO.	DESCRIPTION
1	TITLE SHEET
2	SITE DEVELOPMENT PLAN
3	SITE DEVELOPMENT PLAN
4	SITE DEVELOPMENT PLAN
5	GRADING AND SEDIMENT CONTROL PLAN
6	GRADING AND SEDIMENT CONTROL PLAN
7	GRADING AND SEDIMENT CONTROL PLAN

## **GENERAL NOTES**

- THE WETLAND / STREAM BUFFERS SHOWN ON THESE PLANS DO NOT AFFECT THE INITIAL CONSTRUCTION OF A RESIDENTIAL UNIT ON ANY LOT. IT DOES PROHIBIT SUBSEQUENT CLEARING, GRADING OR CONSTRUCTION IN THE BUFFER AREA. MAINTENANCE OF RESIDENCES, LANDSCAPING AND UTILITIES IS PERMITTED.
- ALL WATER LINES SHALL BE CONSTRUCTED A MINIMUM OF 42" COVER BELOW FINISHED
- ALL WORK SHALL BE PERFORMED IN ACCORDANCE WITH THE HOWARD COUNTY DESIGN MANUAL, VOLUME IV, i.e., STANDARD SPECIFICATIONS AND DETAILS FOR CONSTRUCTION, LATEST AMENDMENTS.
- APPROXIMATE LOCATION OF EXISTING UTILITIES ARE SHOWN FROM BEST AVAILABLE INFORMATION. THE CONTRACTOR SHALL TAKE ALL NECESSARY PRECAUTIONS TO PROTECT THE EXISTING UTILITIES AND MAINTAIN UNINTERRUPTED SERVICE. ANY DAMAGE INCURRED DUE TO CONTRACTOR'S OPERATION SHALL BE REPAIRED IMMEDIATELY AT THE CONTRACTOR'S EXPENSE.
- THE CONTRACTOR SHALL TEST PIT EXISTING UTILITIES AT LEAST (5) DAY BEFORE STARTING WORK SHOWN ON THESE DRAWINGS TO VERIFY THEIR LOCATION AND ELEVATION. THE CONTRACTOR SHALL NOTIFY THE ENGINEER IMMEDIATELY IF LOCATION OF UTILTIES IS OTHER THAN SHOWN.
- CONTRACTOR TO NOTIFY THE FOLLOWING UTILITIES OR AGENCIES AT LEAST FIVE DAYS BEFORE STARTING WORK SHOWN ON THESE DRAWINGS:

C&P TELEPHONE COMPAN	IY .	725-9976
HOWARD COUNTY BUREAU	J OF UTILITIES	313-4900
AT&T CABLE LOCATION	DIVERSION	393-3553
BALTIMORE GAS & ELEC	TRIC COMPANY	685-0123
STATE HIGHWAY ADMINI	STRATION	531-5533
HOWARD COUNTY	CONSTRUCTION INSPECTION	313-1880
DIVISION (24 HOURS N	NOTICE PRIOR TO	_
COMMENCEMENT OF WORK		-

- THE CONTRACTOR TO NOTIFY "MISS UTILITY" AT 1-800-257-7777 AT LEAST 48 HOURS PRIOR TO ANY EXCAVATION WORK.
- EX. TOPO IS PROPOSED GRADING TAKEN FROM F-89-232 PREPARED BY AMERICAN ENGINEERING, INC. AND IS AT 2 FOOT INTERVALS.
- ALL PLAN DIMENSIONS ARE TO FACE OF CURB UNLESS OTHERWISE NOTED.
- 10. THE DEVELOPER IS RESPONSIBLE FOR THE ACQUISITION OF ALL EASEMENTS, RIGHTS AND/OR RIGHTS-OF-WAY THAT MAY BE REQUIRED FOR THE SEDIMENT AND EROSION CONTROL PRACTICES, STORM WATER MANAGEMENT PRACTICES AND THE DISCHARGE OF STORM WATER ONTO OR ACROSS ADJACENT OR DOWNSTREAM PROPERTIES INCLUDED IN THIS PLAN. HE IS ALSO RESPONSIBLE FOR THE ACQUISITION OF ALL EASEMENTS, RIGHTS AND/OR WORK ON ADJACENT PROPERTIES INCLUDED IN THIS PLAN.
- 11. SEE DEPARTMENT OF PLANNING AND ZONING FILE No.'s WP-89-184, S-89-06, P-89-52 F-89-232, F-93-08, AND F-93-137.
- 12. F-93-137 WAS APPROVED BY THE HOWARD COUNTY DEPARTMENT OF PLANNING AND CCCI, S TOUDUA NO DNINOS.
- 13. STORMWATER MANAGEMENT IS PROVIDED FOR THIS DEVELOPMENT UNDER F-89-232 AND IT IS A RETENTION FACILITY.

14. ANY DAMAGE TO THE COUNTY'S RIGHT-OF-WAY SHALL BE CORRECTED AT THE CONTRACTOR'S

- 15. PUBLIC WATER AND SEWER FOR THESE LOTS IS PROVIDED UNDER CONTRACT DRAWINGS NO. 14-3309-D WHICH WERE APPROVED ON DECEMBER 20, 1903.
- WP-89-184 IS A WAIVER FOR EXCEEDING THE ALLOWABLE 1200 FEET LENGTH FOR A CUL-DE-SAC STREET. THE WAIVER WAS APPROVED FOR SUNNY FIELD COURT.
- DRIVEWAYS TO BE CONSTRUCTED IN ACCORDANCE WITH HOWARD COUNTY STD. DETAIL R G.O.I.

## SITE ANALYSIS

TOTAL AREA OF SUBMISSION

EXISTING ZONING

PROPOSED USE

SINGLE FAMILY DETACHED HOMES

36.14 Ac.

NO. OF DWELLING UNITS PROPOSED


MUMI	I LOT	SIZE	<b>TABULAT</b>	10N
GROSS AREA	LESS PIPESTEM	LESS FLOODPLAIN	LESS STEEP SLOPES	MIN LOT
16,482	1,999	0	0	14,483
15,875	410	0	0	15,465
16,923	2,902	0	0	14,021
23,354	3,208	0	0	20,146
23,158	3,158	0	0	20,000
	GROSS AREA 16,482 15,875 16,923 23,354	GROSS LESS AREA PIPESTEM 16,482 1,999 15,875 410 16,923 2,902 23,354 3,208	GROSS LESS LESS AREA PIPESTEM FLOODPLAIN  16,482 1,999 0  15,875 410 0  16,923 2,902 0  23,354 3,208 0	AREA         PIPESTEM         FLOODPLAIN         STEEP SLOPES           16,482         1,999         0         0           15,875         410         0         0           16,923         2,902         0         0           23,354         3,208         0         0

# 'GENERIC' SITE DEVELOPMENT PLAN

## SUNNY FIELD ESTATES

SECTION 3, LOTS 68 - 99

1st ELECTION DISTRICT HOWARD COUNTY, MARYLAND

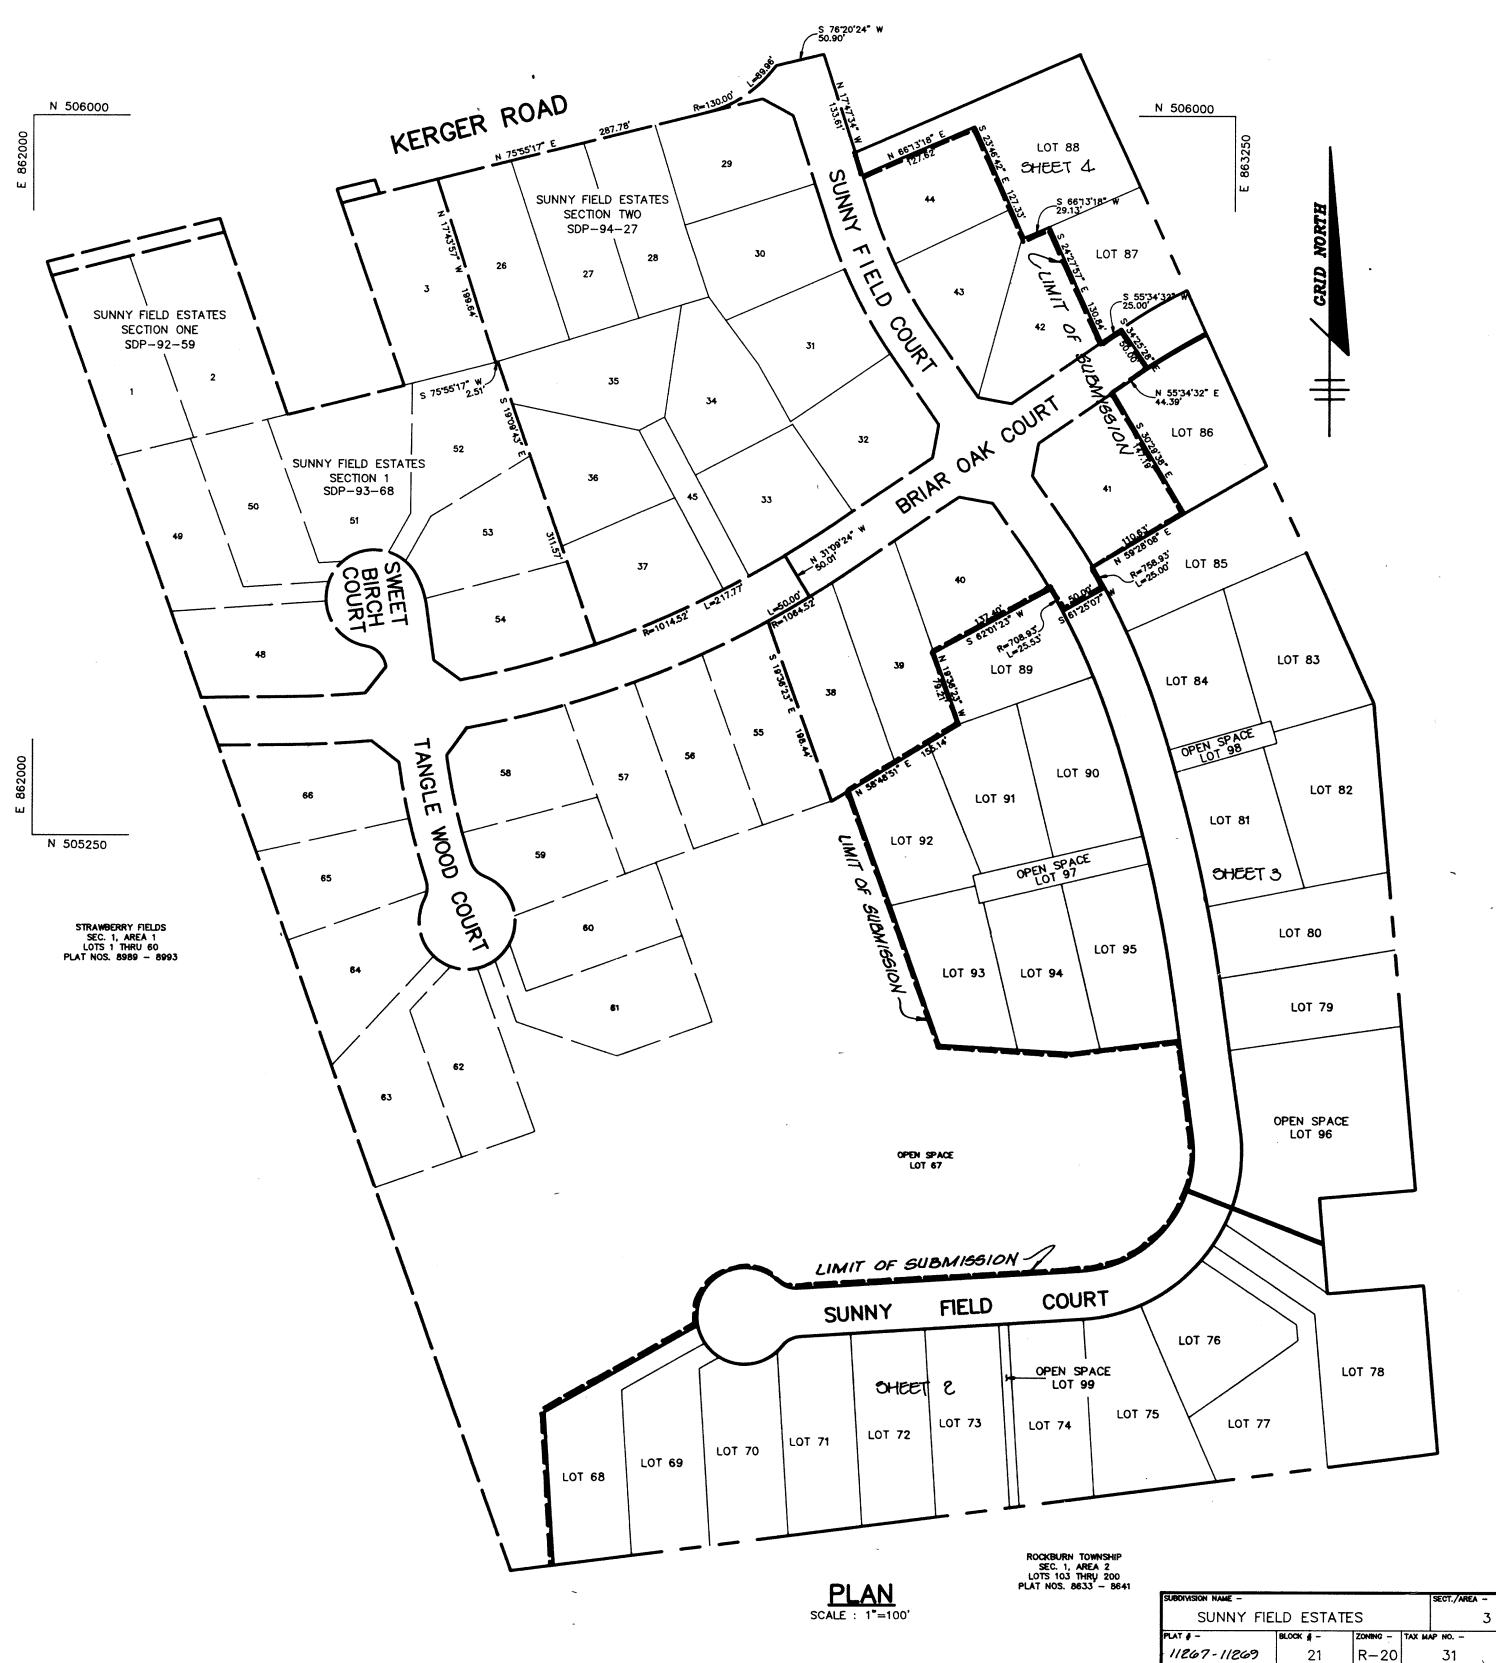

ADDRESS CHART			
LOT NUMBER	STRE	EET ADDRESS	
· 68	<b>33</b> 99	SUNNY FIELD COURT	
69	5395	SUNNY FIELD COURT	
70	539/	SUNNY FIELD COURT	
71	5987	SUNNY FIELD COURT	
72	5383	SUNNY FIELD COURT	
73	5379	SUNNY FIELD COURT	
74	5375	SUNNY FIELD COURT	
75	. 537/	SUNNY FIELD COURT	
76	5347	SUNNY FIELD COURT	
77	5363	SUNNY FIELD COURT	
78	5359	SUNNY FIELD COURT	
79	5347	SUNNY FIELD COURT	
80	.5313	SUNNY FIELD COURT	
- 81	<i>5</i> 339	SUNNY FIELD COURT	
82	5335	SUNNY FIELD COURT	
83	5331	SUNNY FIELD COURT	
84	5327	SUNNY FIELD COURT	
85	5523	SUNNY FIELD COURT	
86	5326	BRIAR OAK COURT	
87	3327	BRIAR OAK COURT	
88	5301	SUNNY FIELD COURT	
<sup>(89</sup>	5324	SUNNY FIELD COURT	
90	5328	SUNNY FIELD COURT	
91	5338	SUNNY FIELD COURT	
92	5336	SUNNY FIELD COURT	
93	5310	SUNNY FIELD COURT	
94	5344	SUNNY FIELD COURT	
95	<i>5348</i>	SUNNY FIELD COURT	
96		OPEN SPACE	
97		OPEN SPACE	
98		OPEN SPACE	
99		OPEN SPACE	

LOTS 68-99


6011.01

**FIRST** 

2155000

11267-11269

D 03

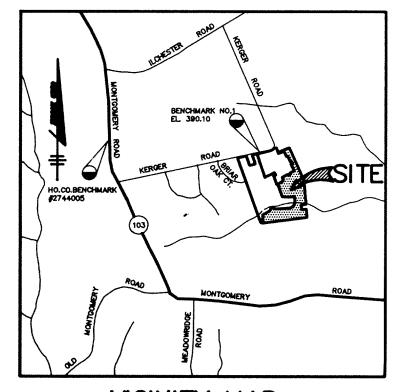

VICINITY MAP

BENCH MARKS

B.M. #1 EL. 390.10
TOP OF BONNET BOLT ON EXISTING FIRE HYDRANT, NORTH SIDE OF KERGER ROAD STATION 3+24

## SHC CHART

LOT NO. 68 69 70 71 72 73 74 75 76 77 78 79 80 81 82 83 84 85 86 87 88 89 90 91 92 93 94	M.C.E. 344.16 344.87 343.69 342.18 340.84 339.56 339.09 337.07 335.91 337.22 336.70 343.75 345.16 349.33 358.36 359.65 358.82 370.89 376.27 375.55 374.04 370.05 352.20 352.35 350.00 351.25 348.38	INV. @ PL 339.76* 339.37 339.09 337.48 336.04 335.06 334.29 332.17 331.41* 331.72* 332.00* 340.35 340.86 344.63 354.61* 354.75* 353.92* 365.79 371.47 371.15 366.54 365.55 346.90* 347.35* 347.74* 347.57*
95 * ELEV AT	345.38 EASEMENT	340.28

APPROVED: HOWARD COUNTY DEPARTMENT OF PLANNING AND

CHUF, DIVISION OF LAND DEVELOPMENT

APPROVED: FOR PUBLIC WATER, PUBLIC SEWERAGE, STORM DRAINAGE SYSTEMS AND PUBLIC ROADS.

DATE BUREAU OF ENGINEERING CO 11/4/44

DATE NO.

OWNER / DEVELOPER

R.G.M. DEVELOPMENT CORPORATION c/o KOREN DEVELOPMENT CORPORATION 8815 CENTRE PARK DRIVE SUITE 304 COLUMBIA, MARYLAND 21045

410-740-1010

SECTION 3, LOTS 68 - 99

## SUNNY FIELD ESTATES

SECTION 3 ZONED R-20 TAX MAP NO. 31 PARCELS 57 & 757 1st ELECTION DISTRICT, HOWARD COUNTY, MARYLAND

TITLE SHEET

#### RIEMER MUEGGE & ASSOCIATES, INC Planners • Engineers • Surveyors 8818 Centre Park Drive • Suite 200 • Columbia, Md 21045 410-997-8900 FAX: 410-997-9282





-79-59, S-89-06, P-89-52, WP-89-184, DESIGNED BY : W.C.W. DRAWN BY : W.C.W. PROJECT NO: 79710


DATE: OCTOBER 24, 1004

SCALE : AS SHOWN


DRAWING NO. 1 OF 7 SDP-95-07

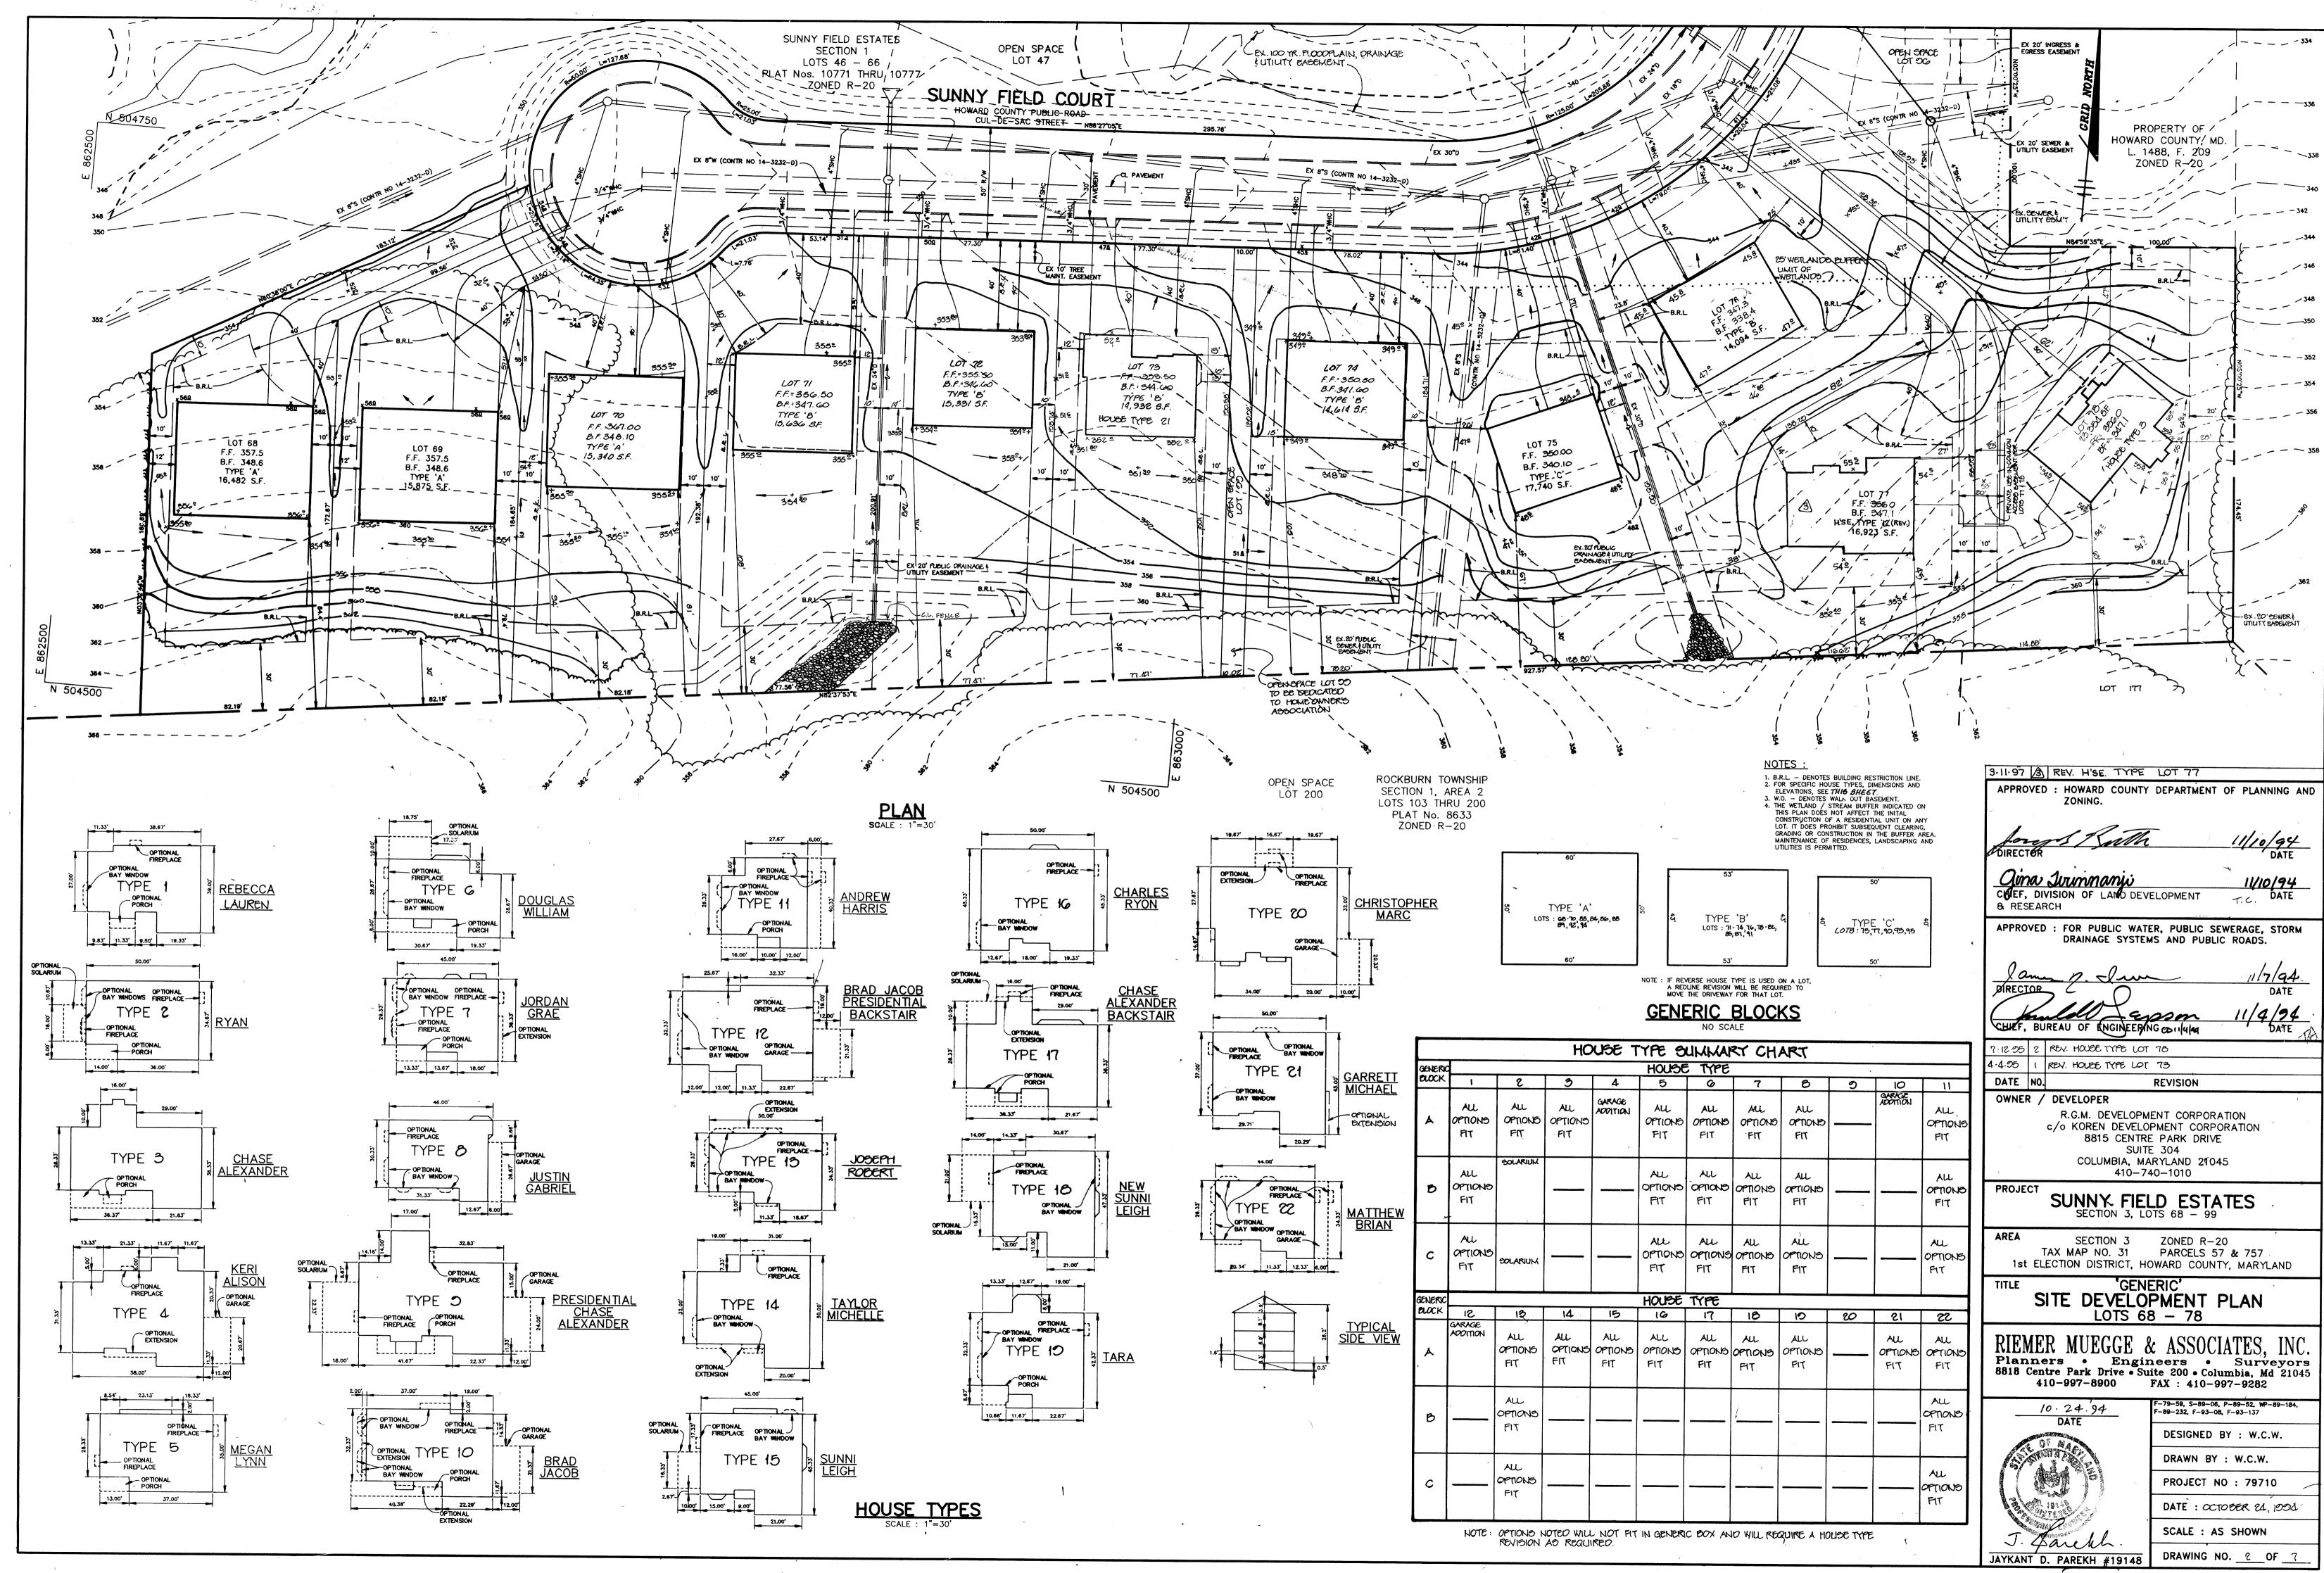

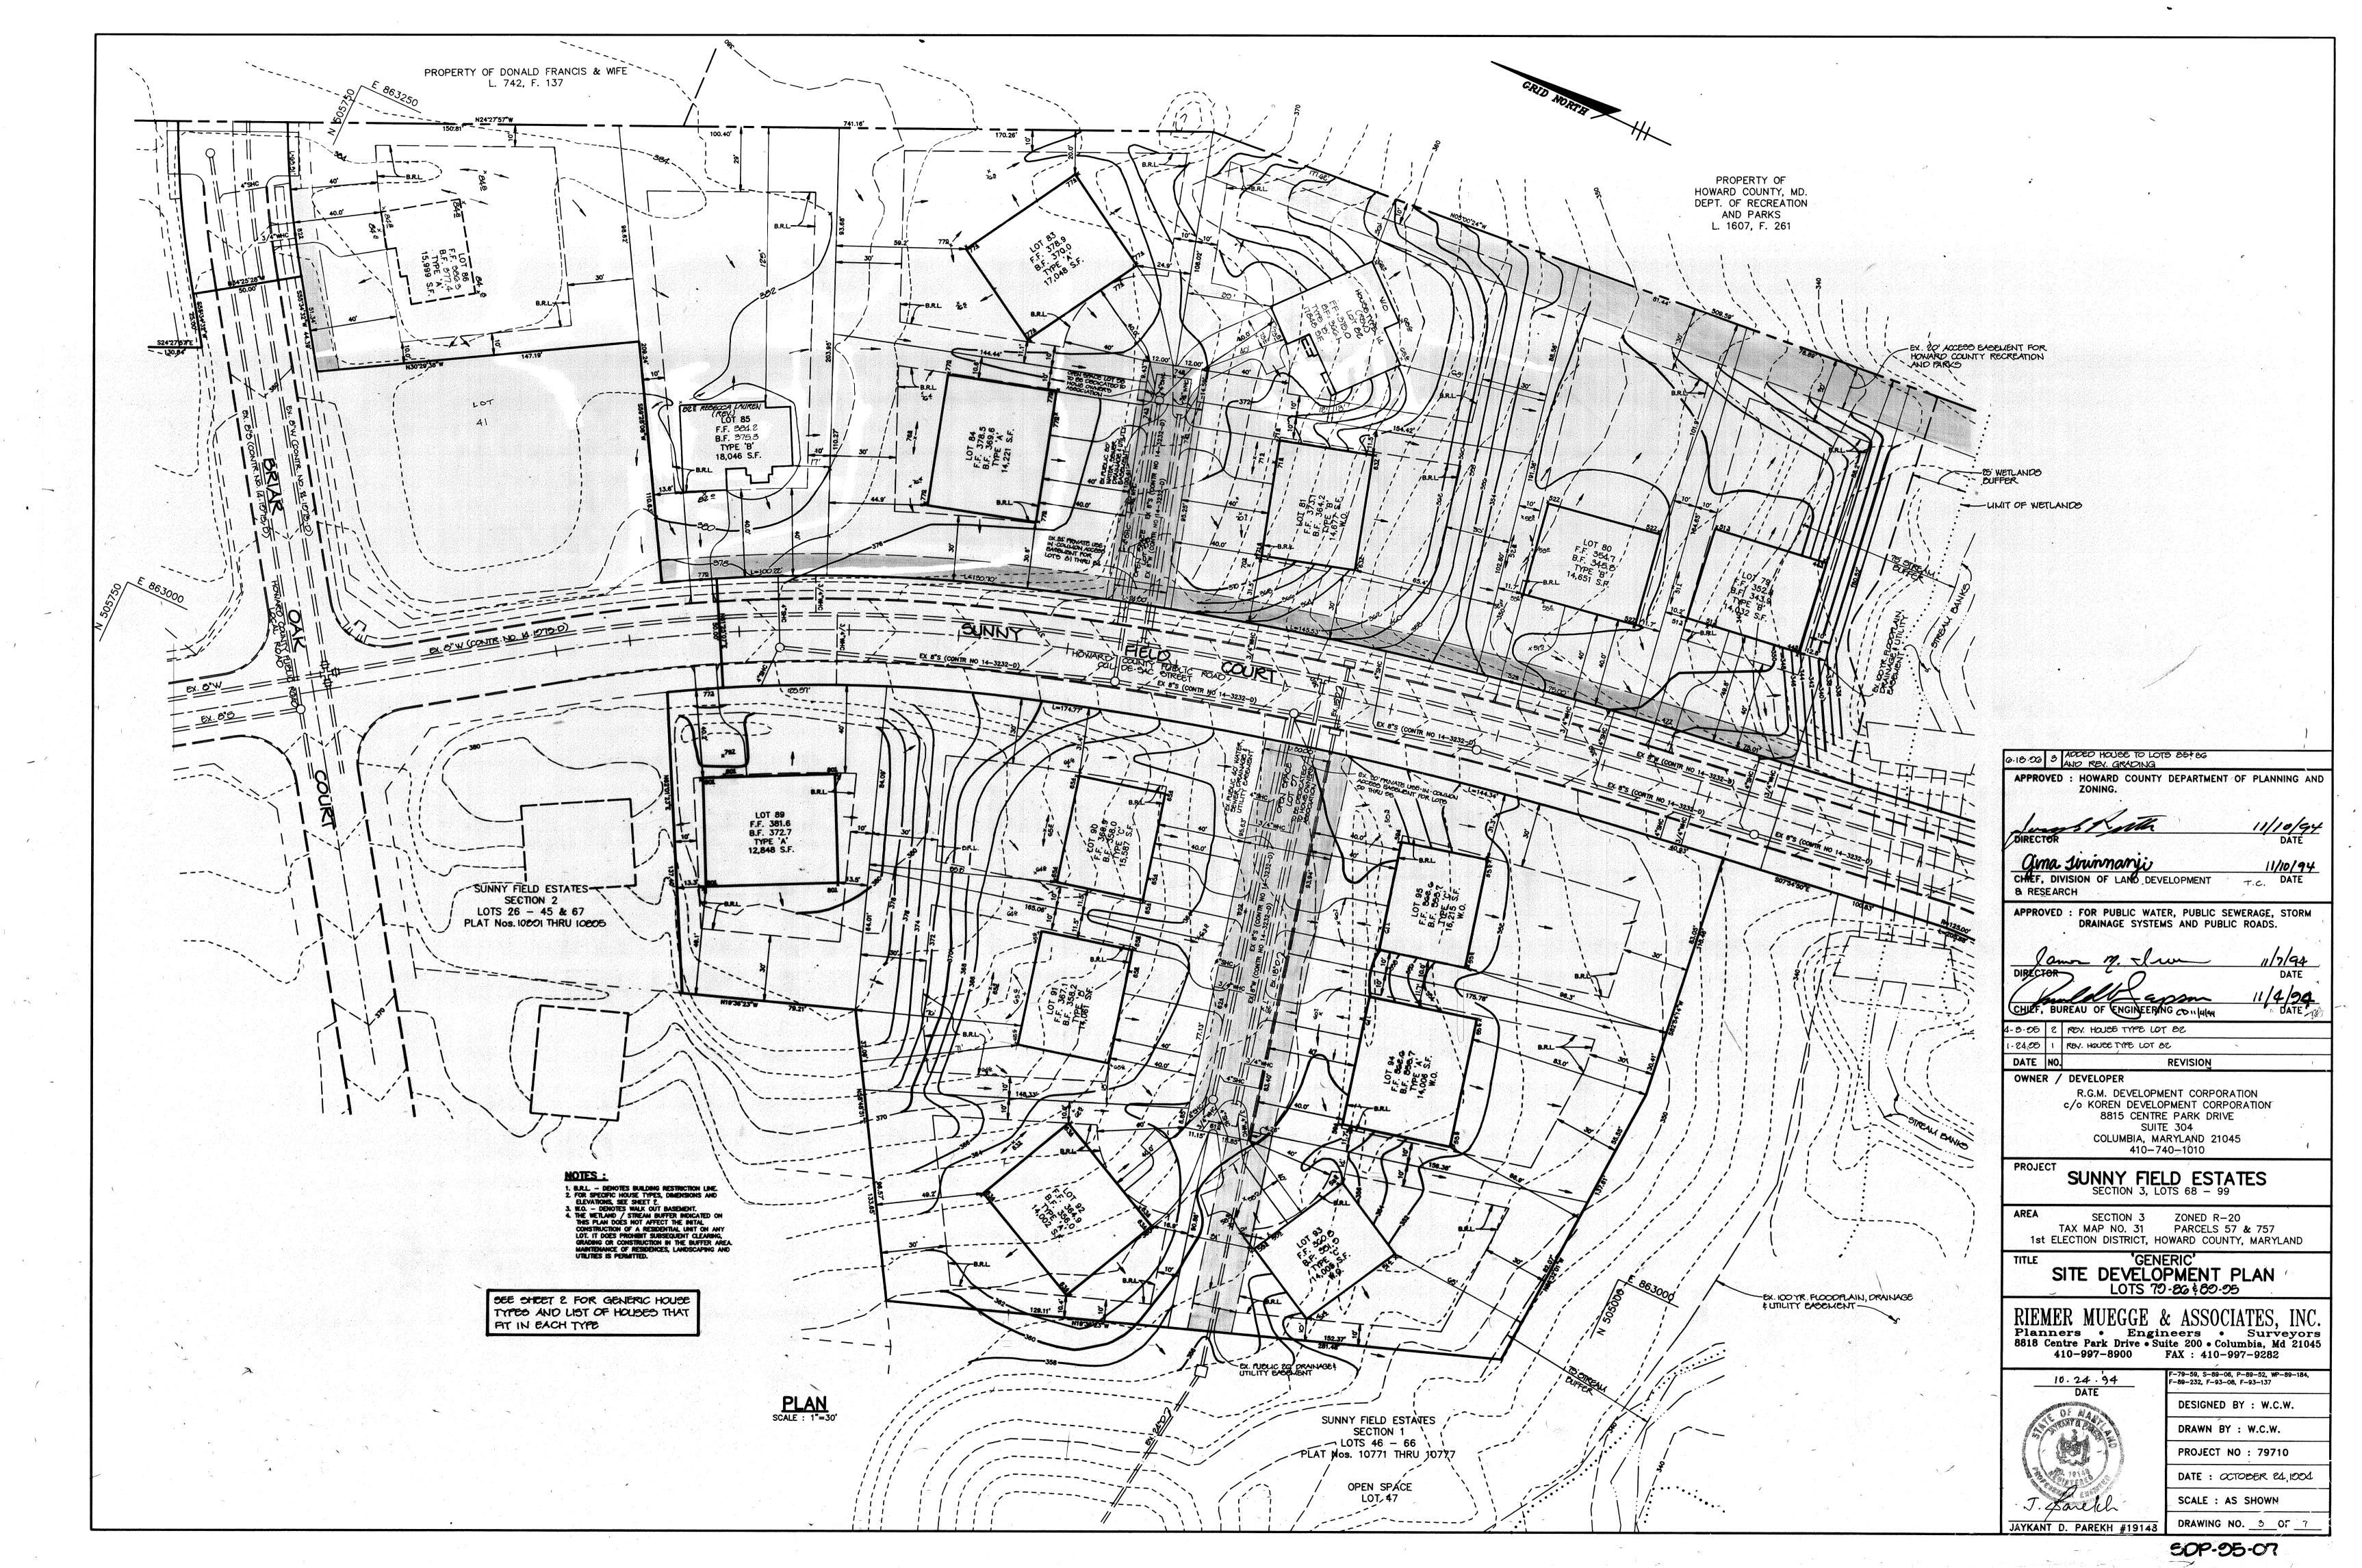


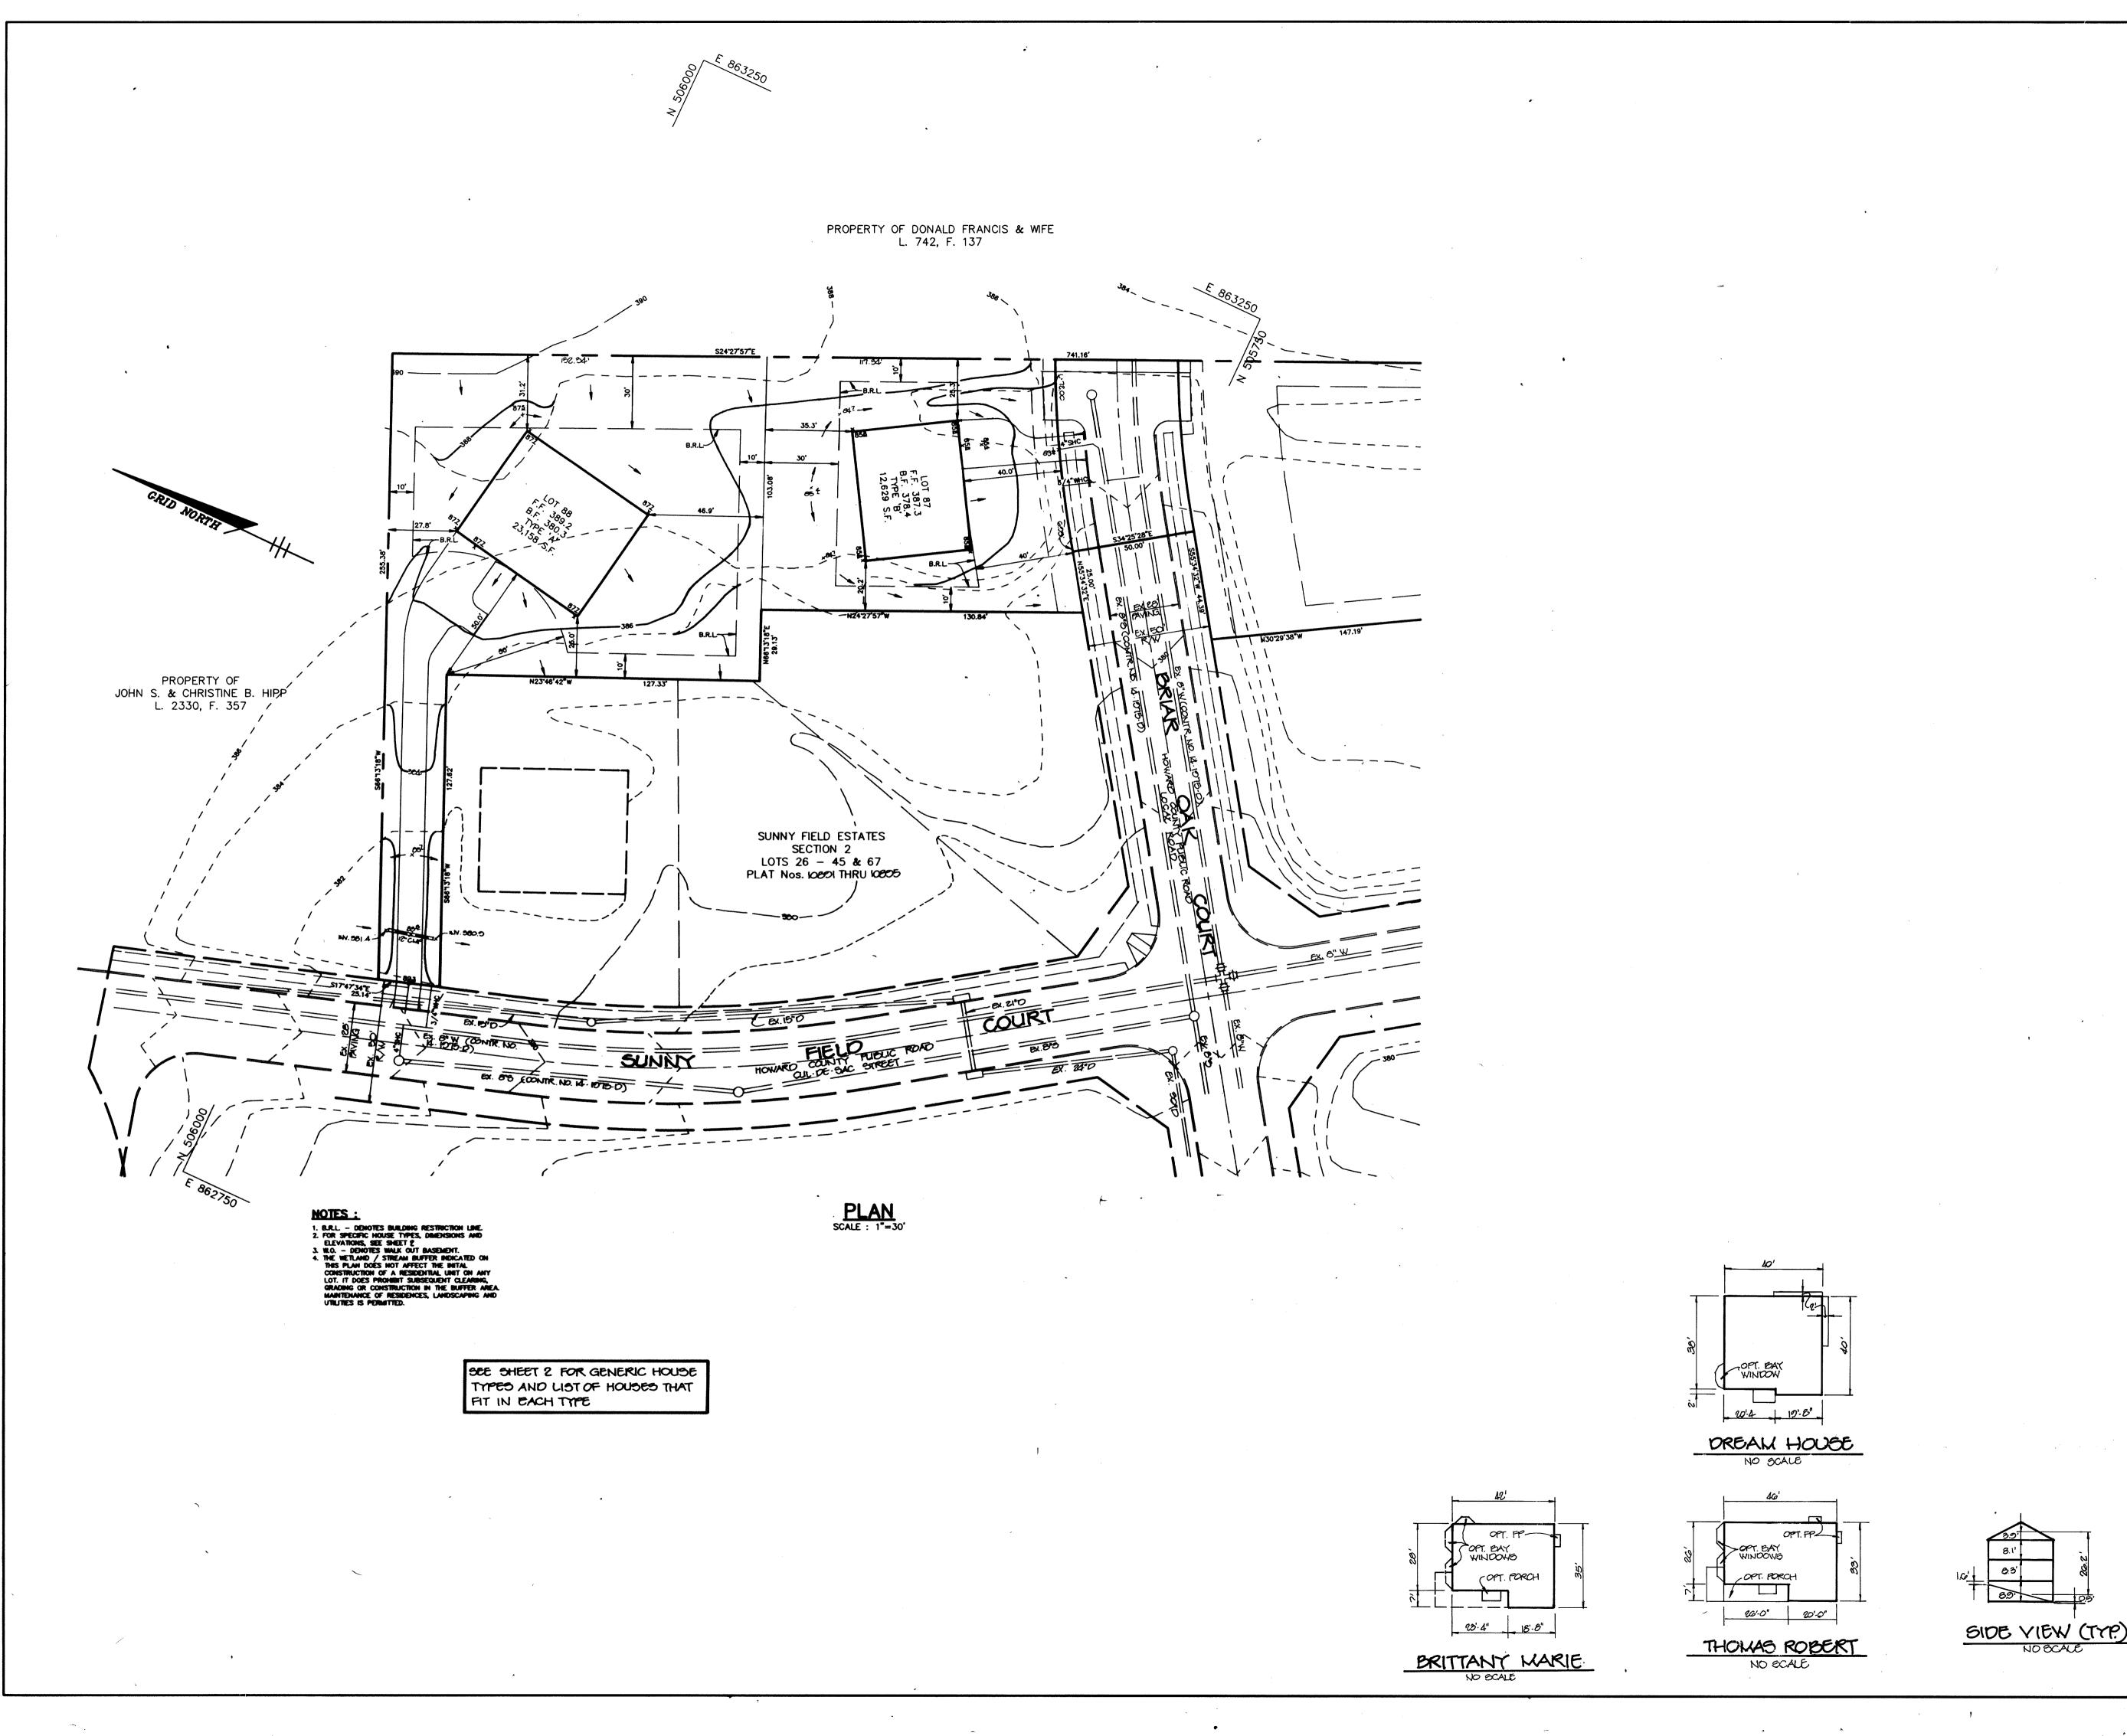


APPROVED: HOWARD COUNTY DEPARTMENT OF PLANNING AND ZONING. CHEF, DIVISION OF LAND DEVELOPMENT & RESEARCH 11/10/94 DATE T.C. APPROVED: FOR PUBLIC WATER, PUBLIC SEWERAGE, STORM DRAINAGE SYSTEMS AND PUBLIC ROADS. DATE 11.8.05 1 ADDED HOUSE TYPES DATE NO. **REVISION** OWNER / DEVELOPER R.G.M. DEVELOPMENT CORPORATION c/o KOREN DEVELOPMENT CORPORATION 8815 CENTRE PARK DRIVE SUITE 304 COLUMBIA, MARYLAND 21045 410-740-1010 PROJECT SUNNY FIELD ESTATES
SECTION 3, LOTS 68 - 99 AREA REA SECTION 3 ZONED R-20
TAX MAP NO. 31 PARCELS 57 & 757
1st ELECTION DISTRICT, HOWARD COUNTY, MARYLAND 'GENERIC' SITE DEVELOPMENT PLAN LOTS 67 & 68 RIEMER MUEGGE & ASSOCIATES, INC.
Planners • Engineers • Surveyors
8818 Centre Park Drive • Suite 200 • Columbia, Md 21045
410-997-8900 FAX: 410-997-9282 F-79-59, S-89-06, P-89-52, WP-89-184, F-89-232, F-93-08, F-93-137 10.24.94 DESIGNED BY : W.C.W. DRAWN BY : W.C.W. PROJECT NO: 79710 DATE: OCTOBER 24, 1994 SCALE : AS SHOWN DRAWING NO. 4 OF 7 JAYKANT D. PAREKH #19148

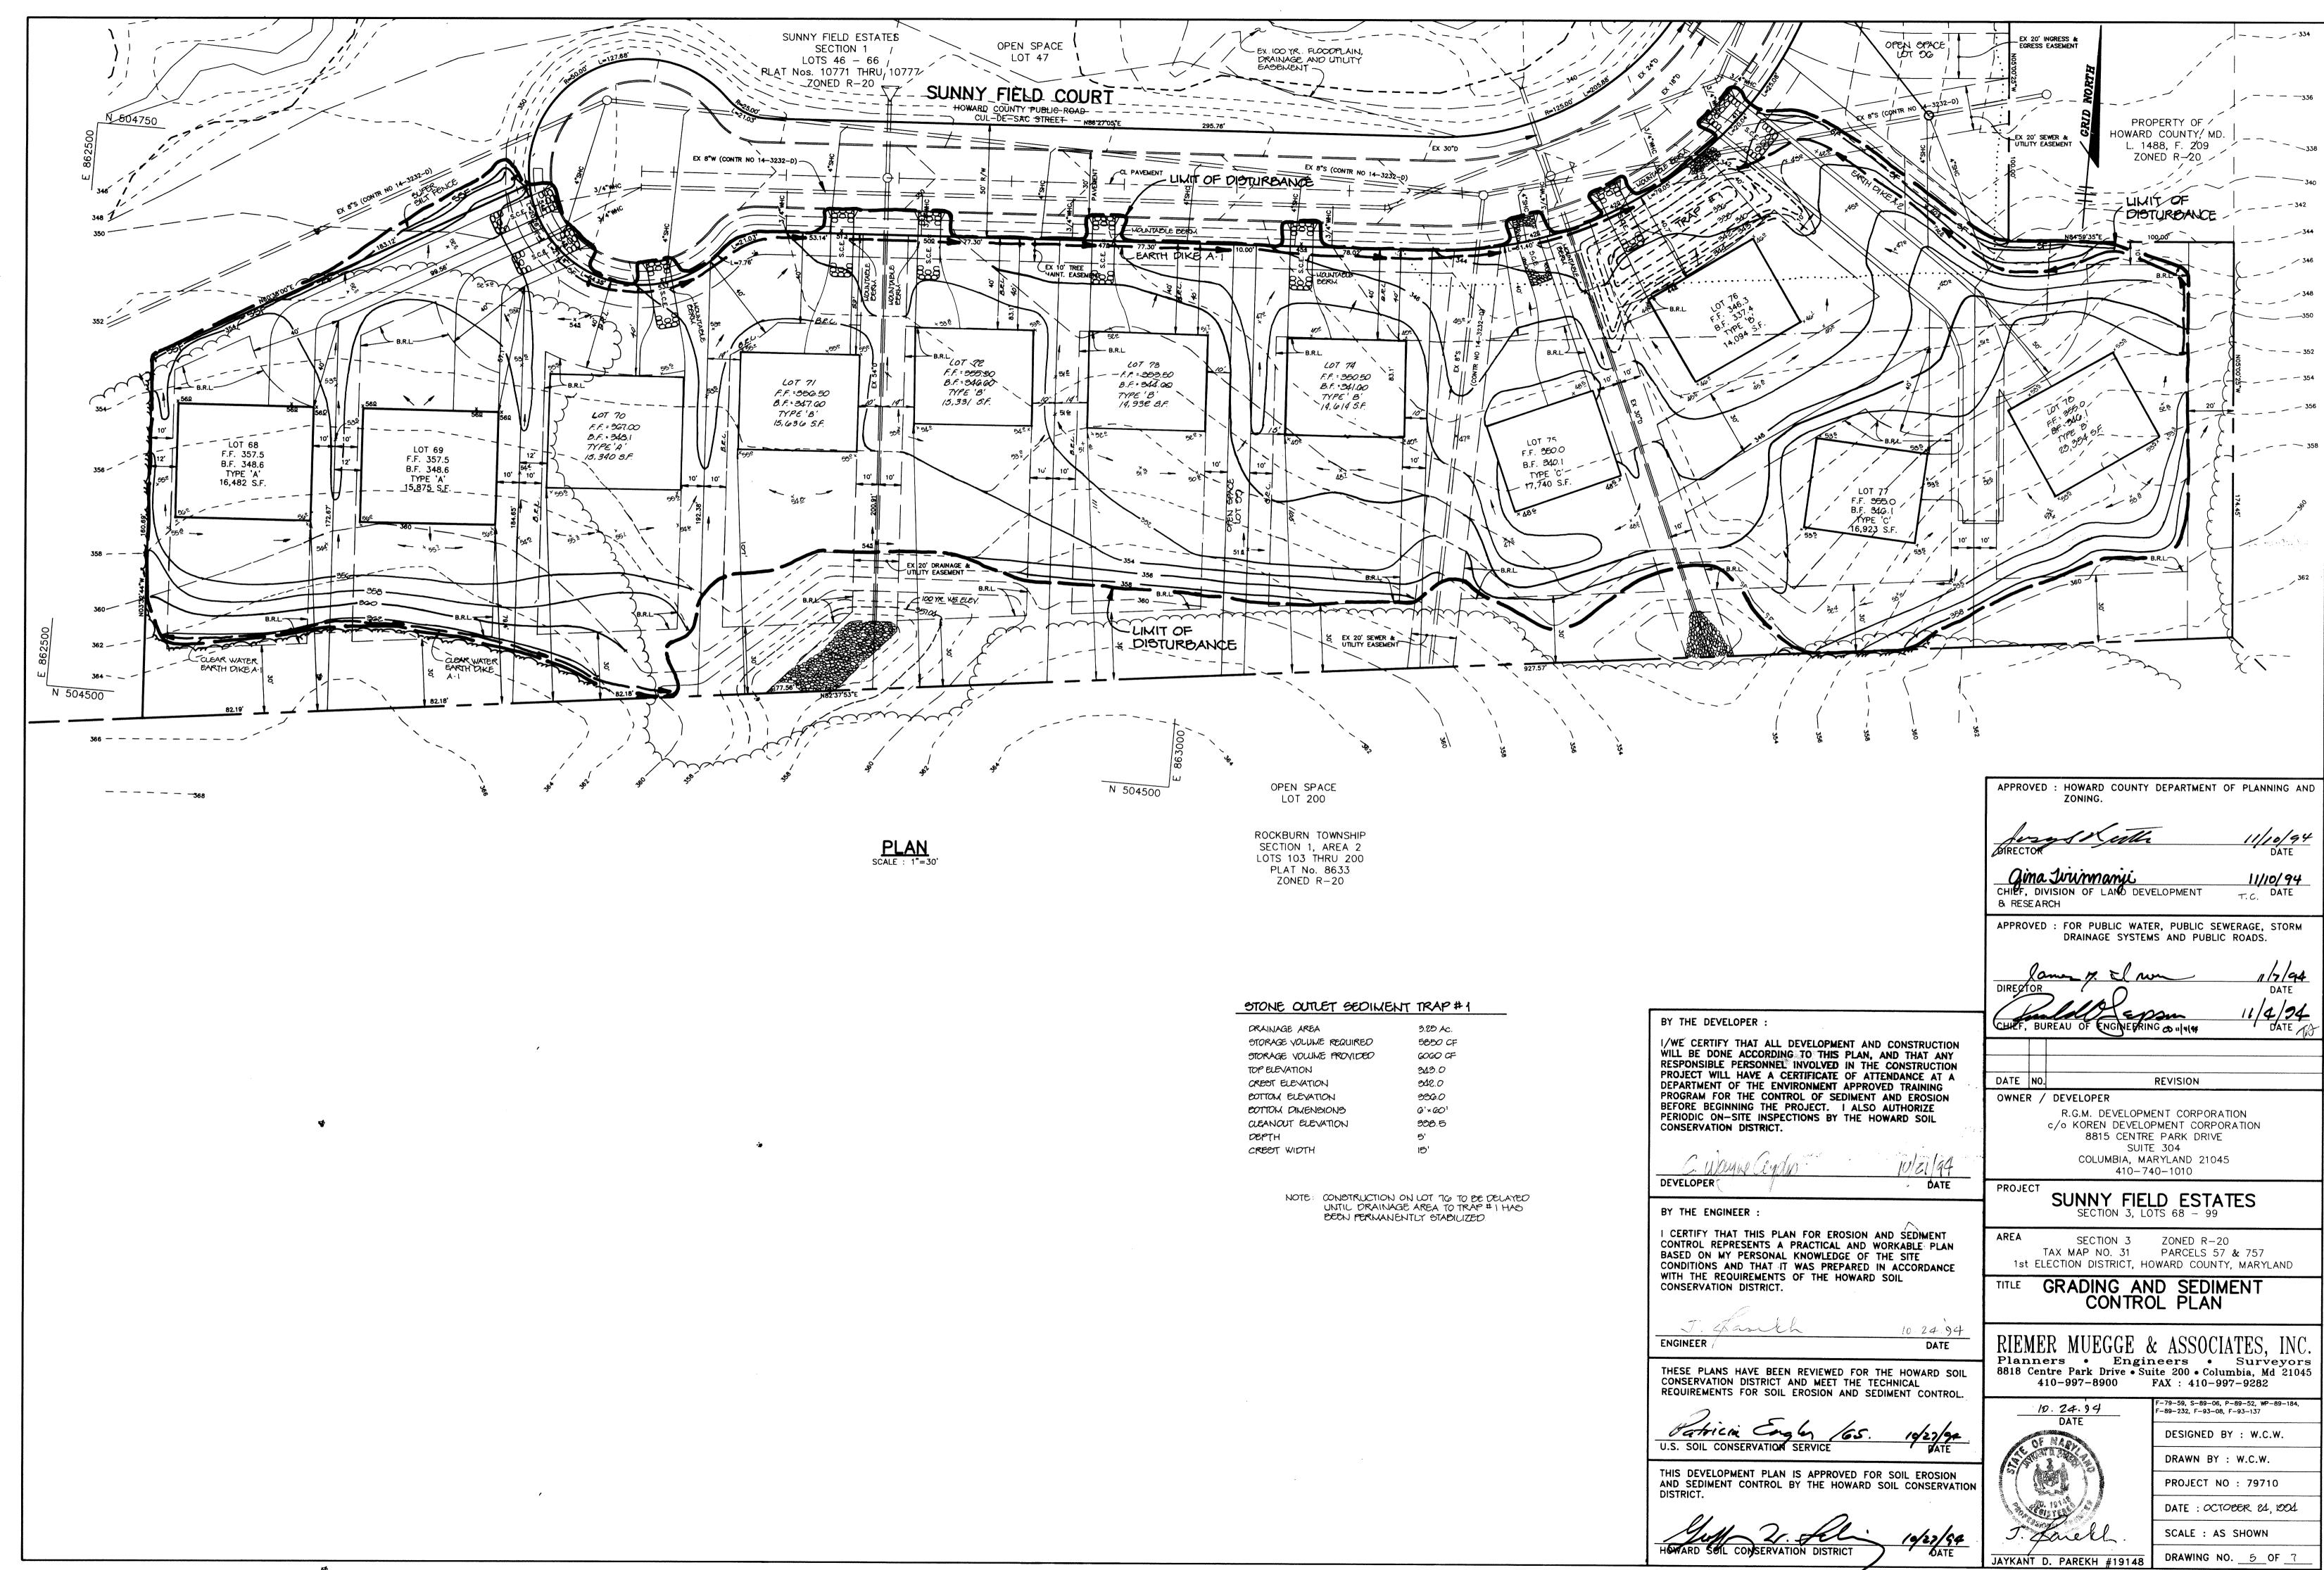

50P-95-07

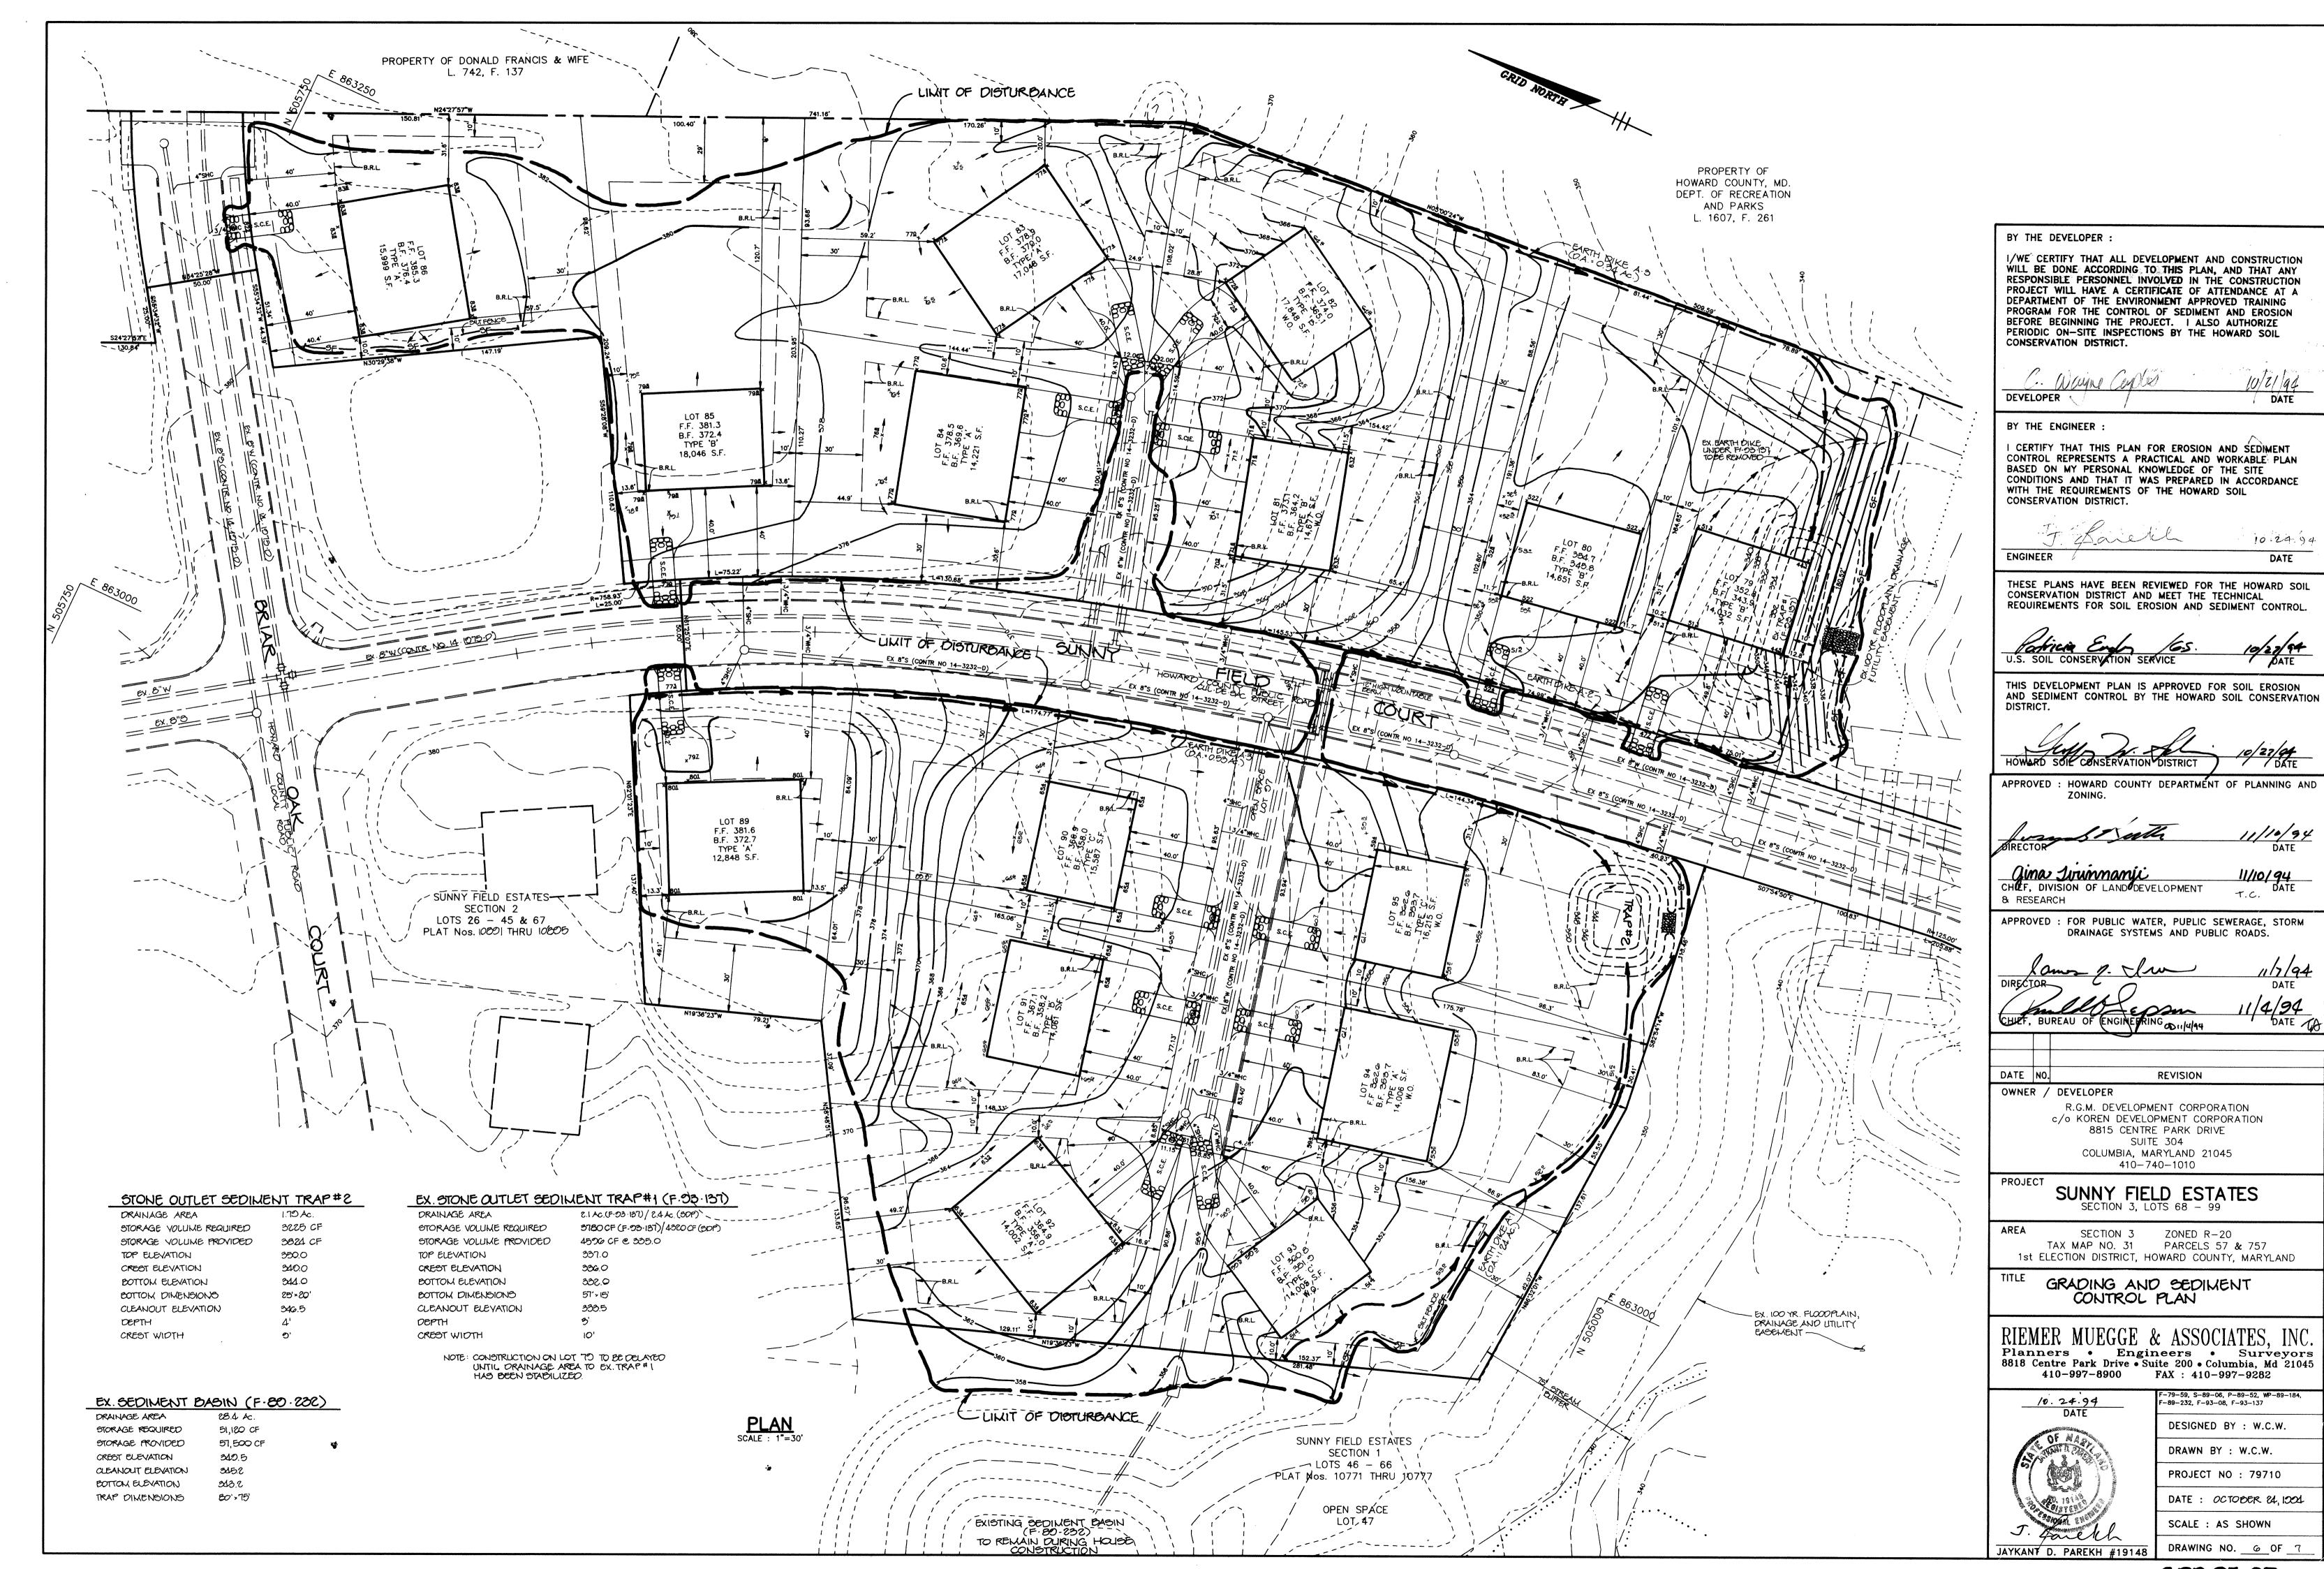

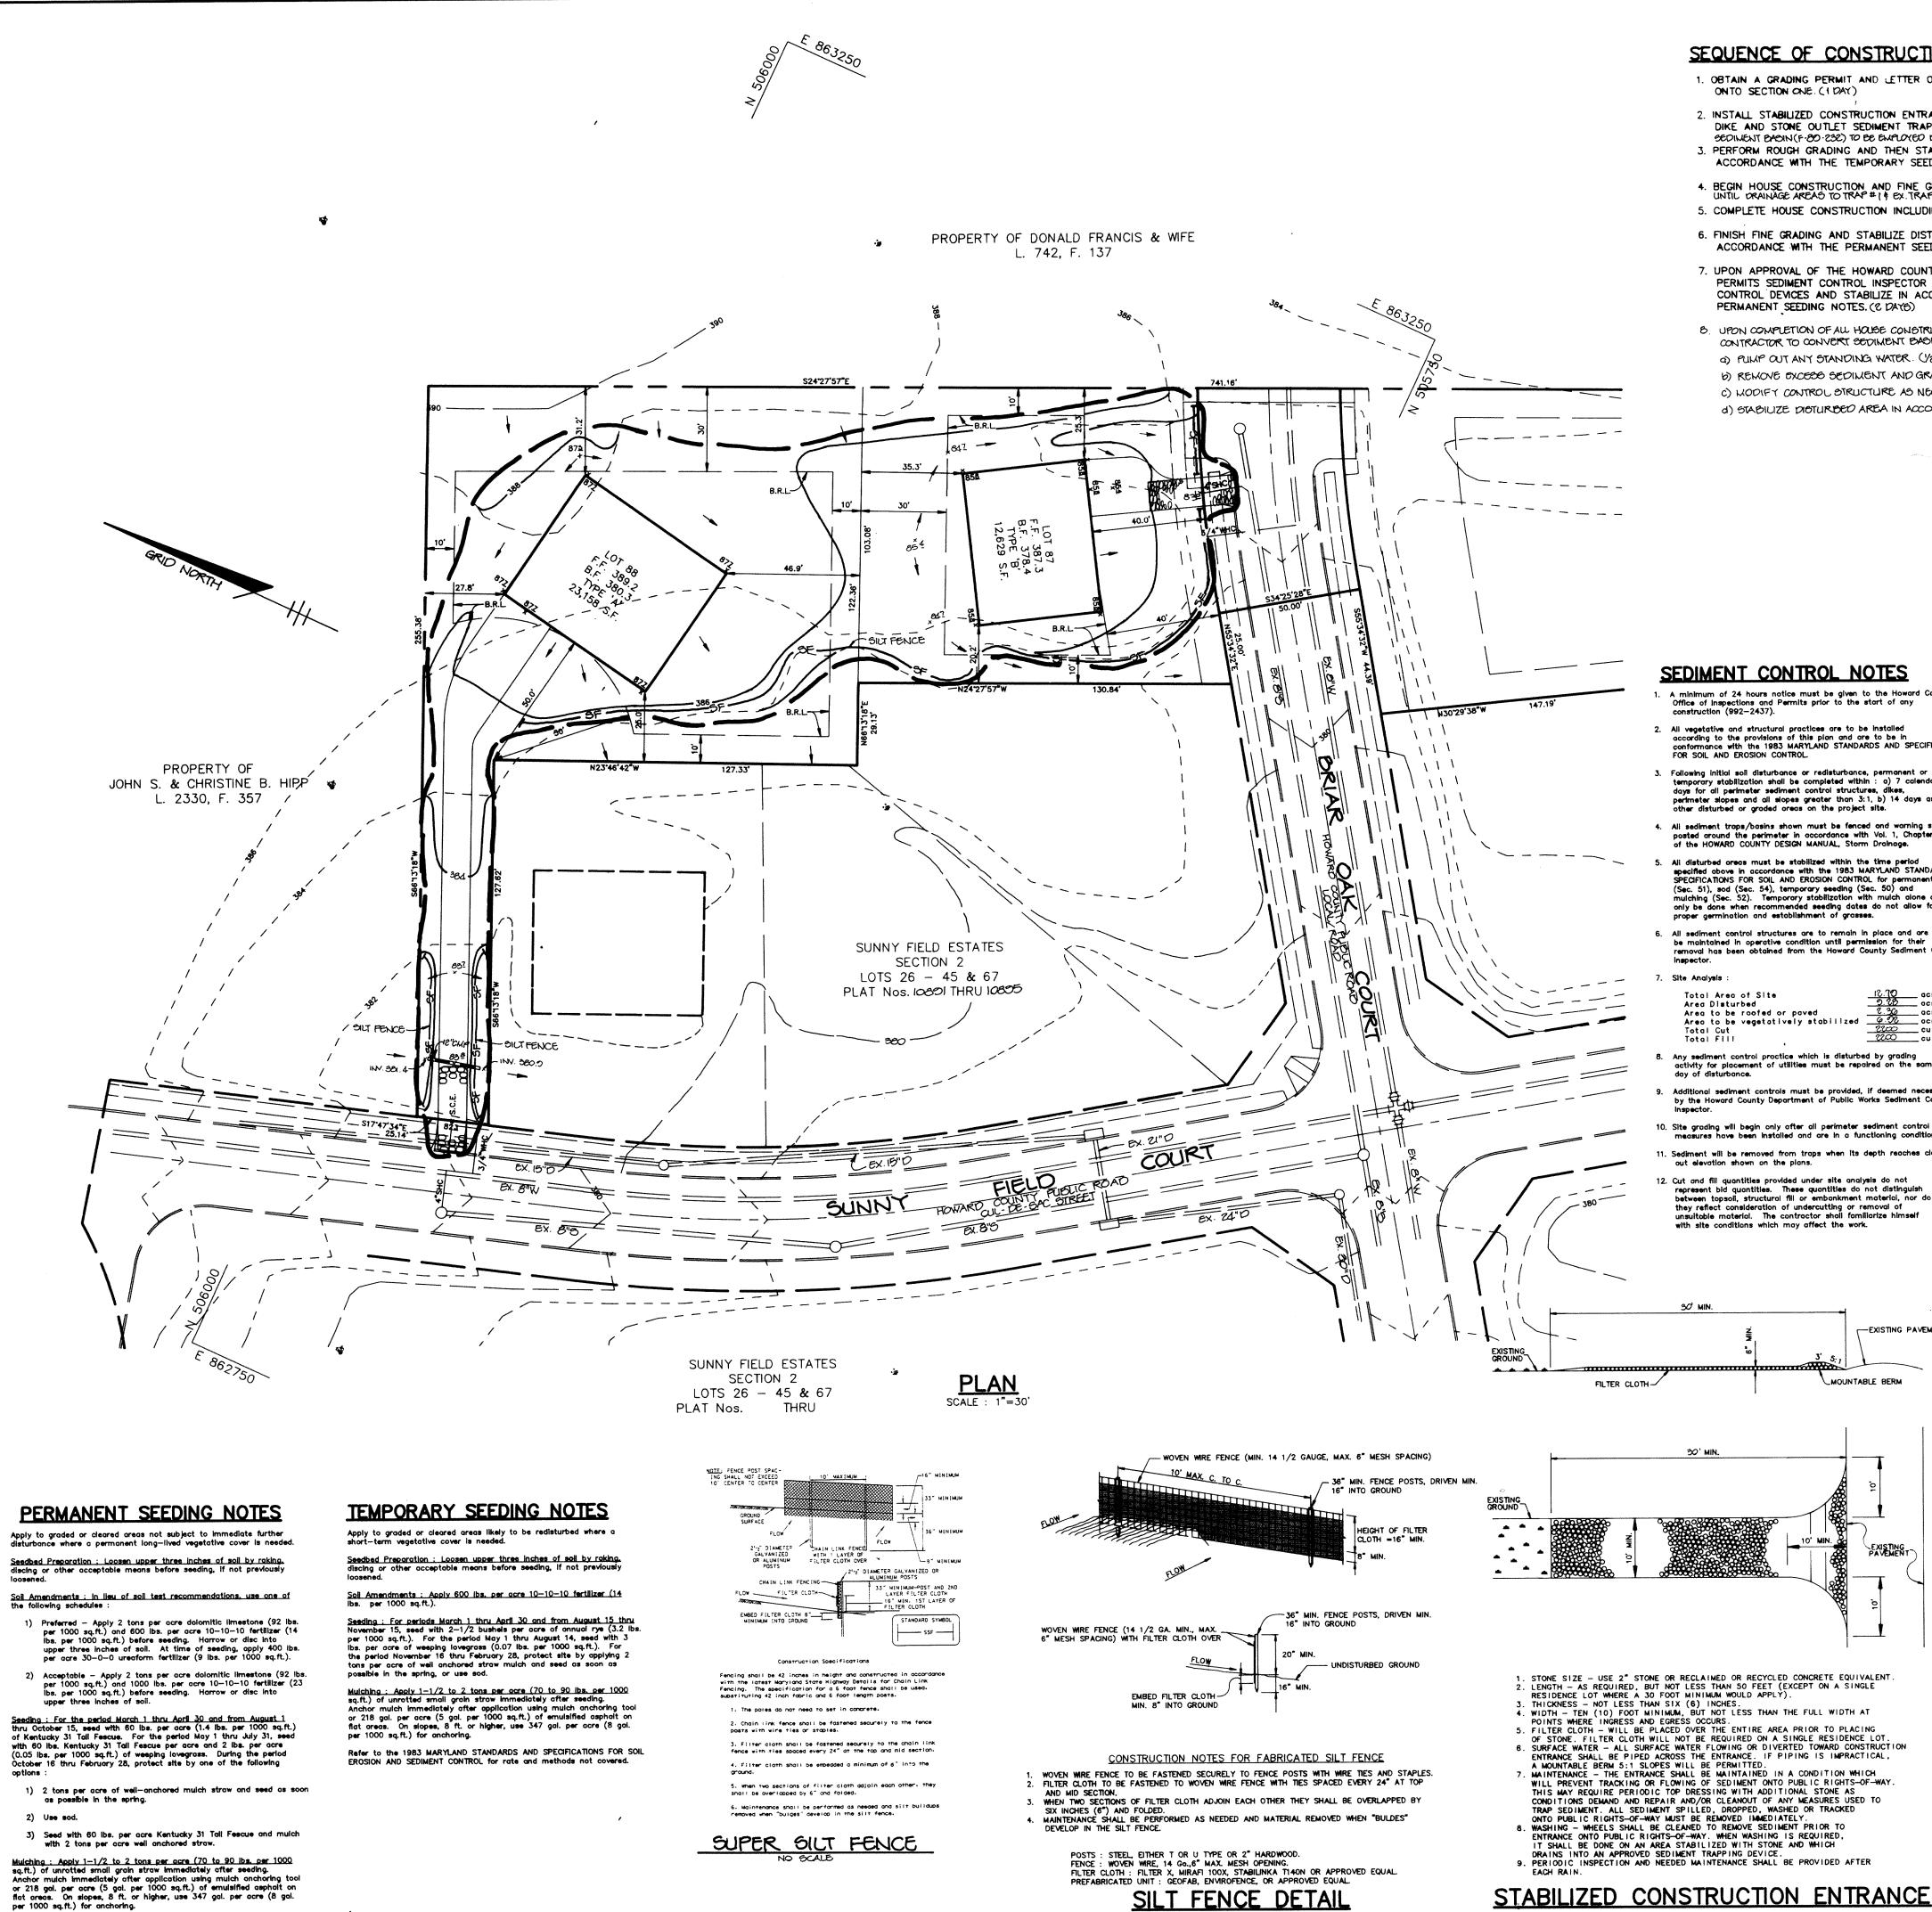

Maintenance: inspect all seeded areas and make needed repairs. replacements and reseedings.

SEQUENCE OF CONSTRUCTION

- 1. OBTAIN A GRADING PERMIT AND LETTER OF PERMISSION TO GRADE ONTO SECTION ONE (1 DAY)
- 2. INSTALL STABILIZED CONSTRUCTION ENTRANCES, SILT FENCE, EARTH DIKE AND STONE OUTLET SEDIMENT TRAP #1, #8 AND #3.(10 DAYS) SEDIMENT BASIN (F-80-232) TO BE EMPLOYED DURING HOUSE CONSTRUCTION. 3. PERFORM ROUGH GRADING AND THEN STABILIZE DISTURBED AREAS IN


ACCORDANCE WITH THE TEMPORARY SEEDING NOTES. (4 WEEKS)

- 4. BEGIN HOUSE CONSTRUCTION AND FINE GRADING. LOTS TO \$ 70 CONSTRUCTION IS TO BE DELAYED UNTIL BRAINAGE AREAS TO TRAP#1 \$ EX.TRAP#1 HAS BEEN COMPLETELY STABULIZED.
- 5. COMPLETE HOUSE CONSTRUCTION INCLUDING UTILITY INSTALLATION.
- 6. FINISH FINE GRADING AND STABILIZE DISTURBED AREAS IN ACCORDANCE WITH THE PERMANENT SEEDING NOTES. (30AYS)

a) PUMP OUT ANY STANDING WATER. (1/2 DAY)

PERMANENT SEEDING NOTES. (& DAYS)

- 7. UPON APPROVAL OF THE HOWARD COUNTY DEPARTMENT OF LICENSES AND PERMITS SEDIMENT CONTROL INSPECTOR REMOVE ALL SEDIMENT CONTROL DEVICES AND STABILIZE IN ACCORDANCE WITH THE
- B. UPON COMPLETION OF ALL HOUSE CONSTRUCTION THAT DRAINS TO SWMF (F-80-232), CONTRACTOR TO CONVERT SEDIMENT BASIN TO SWMF AS PER THE FOLLOWING:
- b) REMOVE EXCESS SEDIMENT AND GRADE TO FINAL GRADES AS SHOWN ON F-85-232. C) MODIFY CONTROL STRUCTURE AS NECESSARY PER F.80.232.
- d) STABILIZE DISTURBED AREA IN ACCORDANCE W/ PERMANENT SEEDING NOTES.

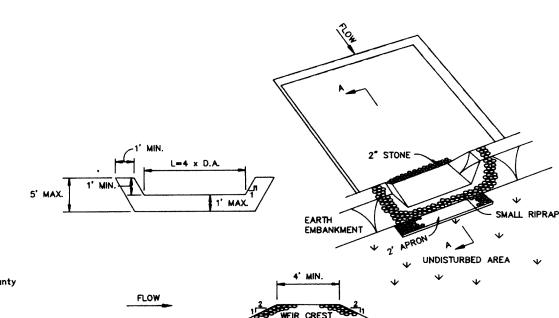

OPTION: A ONE FOOT LAYER OF 2° STONE MAY BE PLACED ON THE UPSTREAM SIDE OF THE RIPRAP IN PLACE OF THE EMBEDDED FILTER CLOTH.

THE FILL MATERIAL FOR THE EMBANKMENT SHALL BE FREE OF ROOTS AND OTHER WOODY VEGETATION AS WELL AS OVER-SIZED STONES, ROCKS, ORGANIC MATERIAL OR OTHER OBJECTIONABLE MATERIAL. THE EMBANKMENT SHALL BE COMPACTED BY TRAVERSING WITH EQUIPMENT WHILE IT IS BEING CONSTRUCTED.

AREA UNDER EMBANKMENT SHALL BE CLEARED, GRUBBED AND STRIPPED OF ANY VEGETATION AND ROOT MAT. THE POOL AREA SHALL BE CLEARED.

THE STONE USED IN THE OUTLET SHALL BE SMALL RIPRAP 4"-8" ALONG WITH A 1"

5. SEDIMENT SHALL BE REMOVED AND TRAP RESTORED TO ITS ORIGINAL DIMENSIONS WHEN

6. THE STRUCTURE SHALL BE INSPECTED AFTER EACH RAIN AND REPAIRS MADE AS NEEDED.

THICKNESS OF 2" AGGREGATE PLACED ON THE UP-GRADE SIDE ON THE SMALL RIPRAP OR EMBEDDED FILTER CLOTH IN THE RIPRAP.

CONSTRUCTION OPERATIONS SHALL BE CARRIED OUT IN SUCH A MANNER THAN EROSION

8. THE STRUCTURE SHALL BE REMOVED AND THE AREA STABILIZED WHEN THE DRAINAGE AREA HAS BEEN PROPERLY STABILIZED.

STONE OUTLET SEDIMENT TRAP

3. ALL CUT AND FILL SLOPES SHALL BE 2:1 OR FLATTER.

AND WATER POLLUTION IS MINIMIZED

### SEDIMENT CONTROL NOTES

A minimum of 24 hours notice must be given to the Howard County Office of inspections and Permits prior to the stort of any construction (992–2437).

All vegetative and structural practices are to be installed according to the provisions of this plan and are to be in conformance with the 1983 MARYLAND STANDARDS AND SPECIFICATION

 Following initial soil disturbance or redisturbance, permanent or temporary stabilization shall be completed within: a) 7 calendar days for all perimeter sediment control structures, dises, perimeter slopes and all slopes greater than 3:1, b) 14 days as to

All sediment trops/basins shown must be fenced and warning signs
posted around the perimeter in accordance with Vol. 1, Chapter 12,
of the HOWARD COUNTY DESIGN MANUAL, Storm Drainage.

All disturbed crecs must be stabilized within the time period specified above in accordance with the 1983 MARYLAND STANDARDS AND SPECIFICATIONS FOR SOIL AND EROSION CONTROL for permonent seedings (Sec. 51), sod (Sec. 54), temporary seeding (Sec. 50) and mulching (Sec. 52). Temporary stabilization with mulch alone can only be done when recommended seeding dates do not allow for


i. All sediment control structures are to remain in place and are to be maintained in operative condition until permission for their removal has been obtained from the Howard County Sediment Control

Total Area of Site Area to be roofed or paved Area to be vegetatively stabilized  $\frac{\cancel{Q}.\cancel{Q}}{\cancel{Q}.\cancel{Q}}$  acres Total Cut  $\frac{\cancel{Q}.\cancel{Q}}{\cancel{Q}.\cancel{Q}}$  cu.yds cu.yds

Any sediment control practice which is disturbed by grading activity for placement of utilities must be repaired on the same day of disturbance.

- additional sediment controls must be provided, if deemed necessar by the Howard County Department of Public Works Sediment Control
- ). Site grading will begin only after all perimeter sediment control leasures have been installed and are in a functioning condition
- Sediment will be removed from traps when its depth reaches clear
- 12. Cut and fill quantities provided under site analysis do not represent bid quantities. These quantities do not distinguish between topsoil, structural fill or embankment material, nor do

---EXISTING PAVEMENT

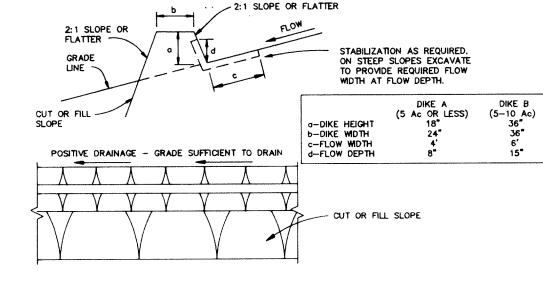

1. ALL DIKES SHALL BE COMPACTED BY EARTH-MOVING EQUIPMENT.

2. ALL DIKES SHALL HAVE POSITIVE DRAINAGE TO AN OUTLET.

CONSTRUCTION EQUIPMENT.

- 3. TOP WIDTH MAY BE WIDER AND SIDE SLOPES MAY BE FLATTER IF DESIRED TO
- 4. FIELD LOCATION SHOULD BE ADJUSTED AS NEEDED TO UTILIZE A STABILIZED SAFE OUTLET.
- 5. EARTH DIKES SHALL HAVE AN OUTLET THAT FUNCTIONS WITH A MINIMUM OF EROSION. RUNOFF SHALL BE CONVEYED TO A SEDIMENT TRAPPING DEVICE SUCH AS A SEDIMENT TRAP OR SEDIMENT BASIN WHERE EITHER THE DIKE CHANNEL OR STABILIZATION SHALL BE: (A) IN ACCORDANCE WITH STANDARD SPECIFICATIONS
  FOR SEED AND STRAW MULCH OR STRAW MULCH IF NOT IN SEEDING SEASON, (B)
  FLOW CHANNEL AS PER THE CHART BELOW:

FLOW CHANNEL STABILIZATION				
TYPE OF TREATMENT	CHANNEL GRADE	DIKE A	DIKE B	
1	0.5-3.0%	SEED & STRAW MULCH	SEED & STRAW MULCH	
2	3.1-5.0%	SEED & STRAW MULCH	SEED USING JUTE, OR EXCELSIOR; SOD; 2" STONE	
3	5.1-8.0%	SEED WITH JUTE, OR SOD; 2" STONE	LINED RIPRAP 4-8"	
4	8.1-20%	LINED RIPRAP 4-8"	ENGINEERED DESIGN	
		ONE, OR RECYCLED CONCRET HICKNESS AND BE PRESSED	TE EQUIVALENT, IN A LAYER INTO THE SOIL WITH	

B. RIPRAP TO BE 4-8 INCHES IN A LAYER AT LEAST 8 INCHES THICKNESS AND PRESSED INTO THE SOIL. C. APPROVED EQUIVALENTS CAN BE SUBSTITUTED FOR ANY OF THE ABOVE MATERIALS.

EARTH DIKE

7. PERIODIC INSPECTION AND REQUIRED MAINTENANCE MUST BE PROVIDED AFTER EACH

#### BY THE DEVELOPER:

I/WE CERTIFY THAT ALL DEVELOPMENT AND CONSTRUCTION WILL BE DONE ACCORDING TO THIS PLAN, AND THAT ANY RESPONSIBLE PERSONNEL INVOLVED IN THE CONSTRUCTION PROJECT WILL HAVE A CERTIFICATE OF ATTENDANCE AT A DEPARTMENT OF THE ENVIRONMENT APPROVED TRAINING PROGRAM FOR THE CONTROL OF SEDIMENT AND EROSION BEFORE BEGINNING THE PROJECT. I ALSO AUTHORIZE PERIODIC ON-SITE INSPECTIONS BY THE HOWARD SOIL CONSERVATION DISTRICT.

DATE **DEVELOPER** 

#### BY THE ENGINEER:

I CERTIFY THAT THIS PLAN FOR EROSION AND SEDIMENT CONTROL REPRESENTS A PRACTICAL AND WORKABLE PLAN BASED ON MY PERSONAL KNOWLEDGE OF THE SITE CONDITIONS AND THAT IT WAS PREPARED IN ACCORDANCE WITH THE REQUIREMENTS OF THE HOWARD SOIL CONSERVATION DISTRICT.

10.24.94 ENGINEER DATE

THESE PLANS HAVE BEEN REVIEWED FOR THE HOWARD SOIL CONSERVATION DISTRICT AND MEET THE TECHNICAL REQUIREMENTS FOR SOIL EROSION AND SEDIMENT CONTROL



THIS DEVELOPMENT PLAN IS APPROVED FOR SOIL EROSION AND SEDIMENT CONTROL BY THE HOWARD SOIL CONSERVATION



ZONING.

APPROVED : HOWARD COUNTY DEPARTMENT OF PLANNING AND

11/10/94 DATE 11/10/94

CHIEF, DIVISION OF LAND DEVELOPMENT T.C. & RESEARCH

APPROVED : FOR PUBLIC WATER, PUBLIC SEWERAGE, STORM DRAINAGE SYSTEMS AND PUBLIC ROADS.

11/7/94 DATE BUREAU OF ENGINEERING ON 1444

DATE NO. REVISION OWNER / DEVELOPER

R.G.M. DEVELOPMENT CORPORATION c/o KOREN DEVELOPMENT CORPORATION 8815 CENTRE PARK DRIVE SUITE 304 COLUMBIA, MARYLAND 21045


410-740-1010

## SUNNY FIELD ESTATES SECTION 3, LOTS 68 - 99

SECTION 3 ZONED R-20 TAX MAP NO. 31 PARCELS 57 & 757 1st ELECTION DISTRICT, HOWARD COUNTY, MARYLAND

TITLE GRADING, SEDIMENT CONTROL & DETAIL SHEET

RIEMER MUEGGE & ASSOCIATES, INC. Planners • Engineers • Surveyors 8818 Centre Park Drive • Suite 200 • Columbia, Md 21045 410-997-8900 FAX: 410-997-9282

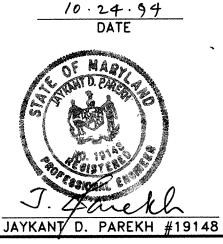

-79-59, S-89-06, P-89-52, WP-89-184, -89-232, F-93-08, F-93-137 DESIGNED BY : W.C.W. DRAWN BY : W.C.W. PROJECT NO: 79710 DATE: OCTOBER 24, 1994 SCALE : AS SHOWN DRAWING NO. 7 OF 7