
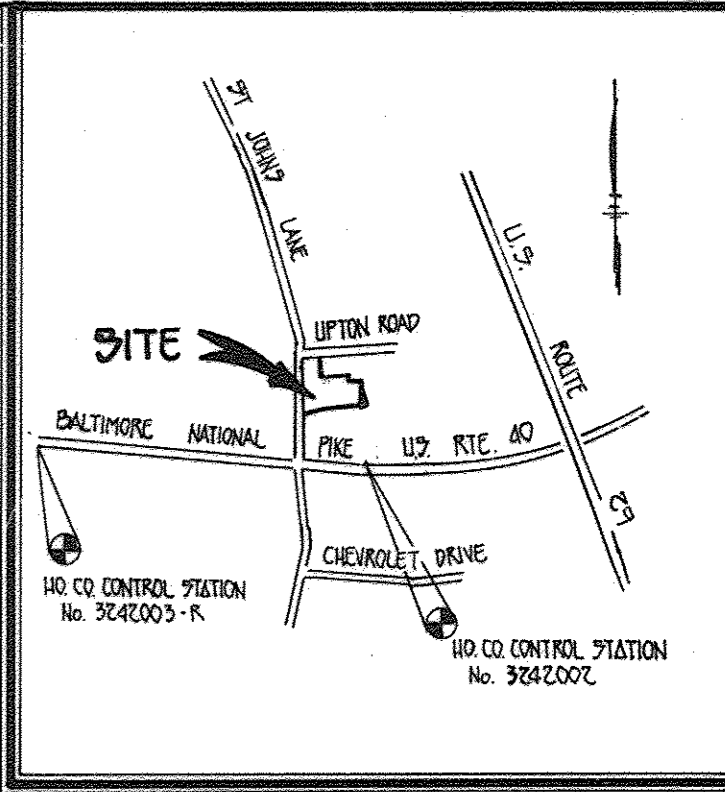


UPTON ROAD  
PUBLIC ROAD & EXISTING ROAD

BOARD OF COUNTY COMMISSIONERS  
OF HOWARD COUNTY, MARYLAND  
L. 305, F. 130

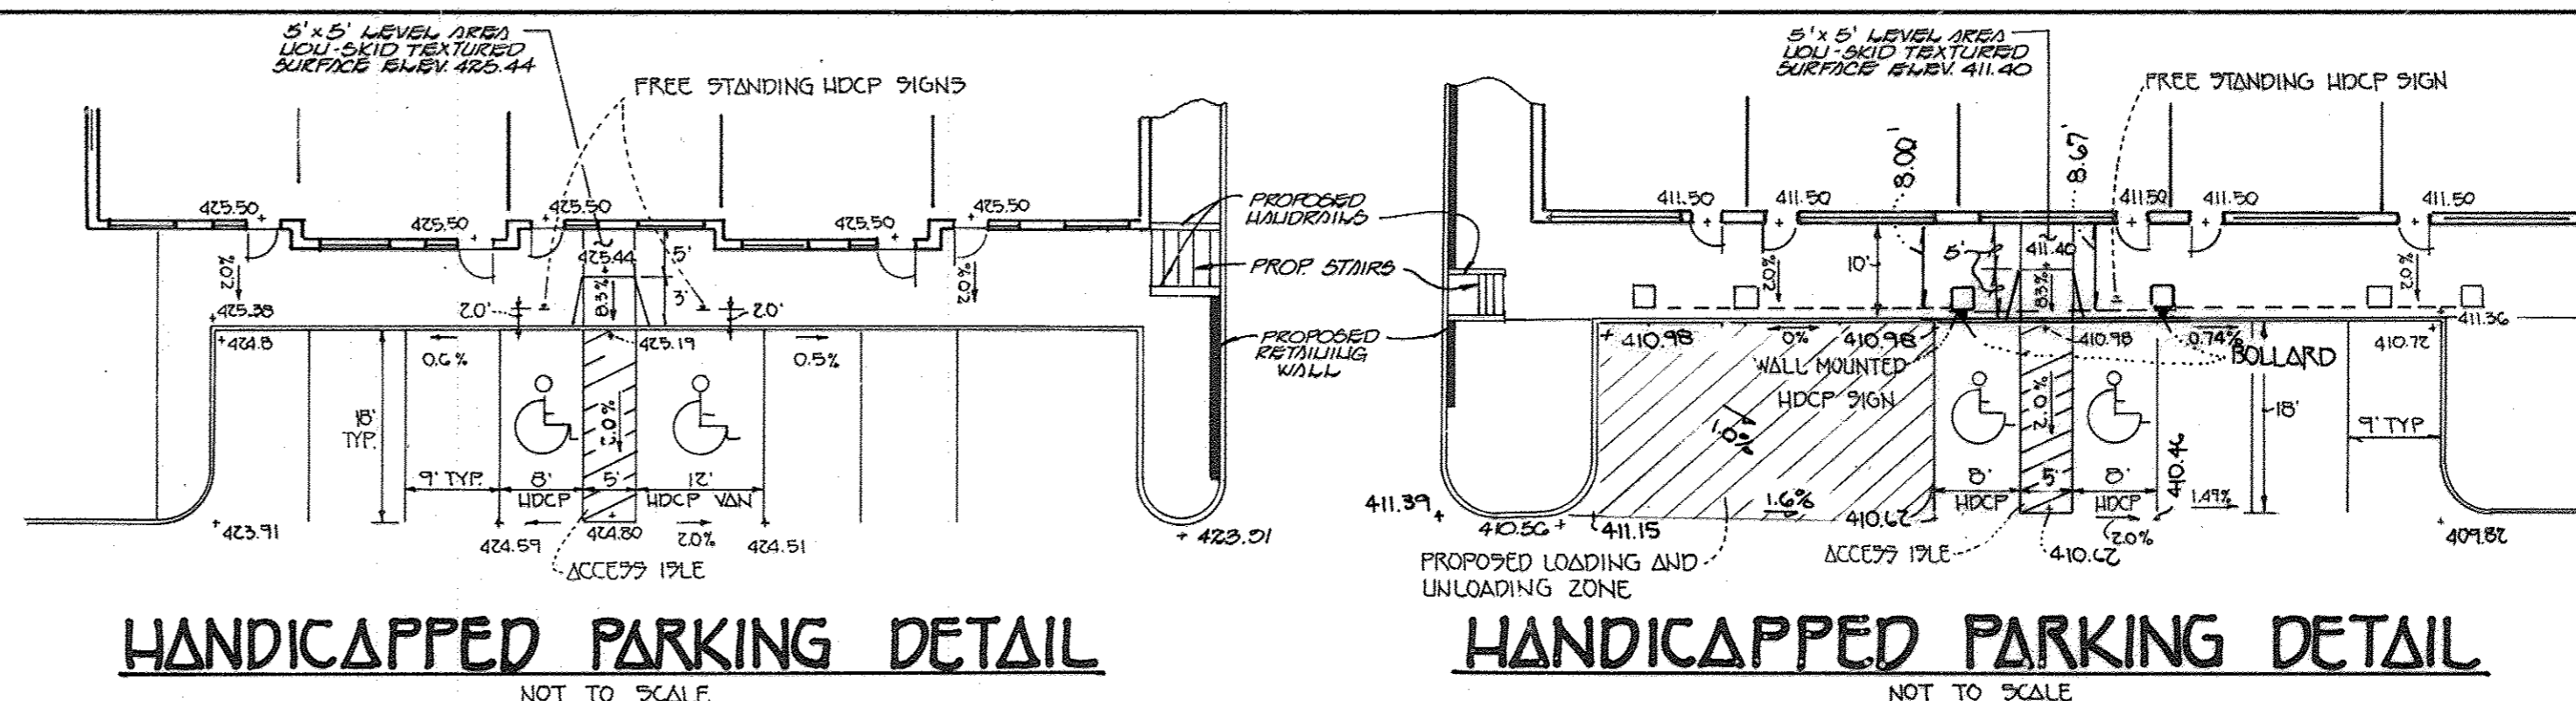

LAND DEDICATED TO HOWARD COUNTY MARYLAND FOR THE PURPOSE OF A PUBLIC ROADWAY. AREA 0.144 AC.

NOTE:  
CONTRACTOR SHALL VERIFY THE EXISTING INVERT AT THE EXISTING CLEANOUT PRIOR TO INSTALLATION OF THE G POWER SERVICE CONNECTION.

ST. JOHNS LANE  
(PUBLIC ROAD)  
(AVAILOR COLLECTION)

MATCH LINE SEE SHEET No. 2 of 2

PARCEL #	STREET ADDRESS
39	3355 ST. JOHNS LANE

**ENGINEER'S CERTIFICATE**  
I HEREBY CERTIFY THAT THIS PLAN FOR EROSION AND SEDIMENT CONTROL REPRESENTS A PRACTICAL AND WORKABLE PLAN BASED ON MY PERSONAL KNOWLEDGE OF THE SITE CONDITIONS AND THAT IT WAS PREPARED IN ACCORDANCE WITH THE REQUIREMENTS OF THE HOWARD SOIL CONSERVATION DISTRICT.

SIGNATURE OF ENGINEER: *Chad A. Fisher*  
DATE: 11/19/94

**DEVELOPER'S CERTIFICATE**  
I/WE CERTIFY THAT ALL DEVELOPMENT AND CONSTRUCTION WILL BE DONE ACCORDING TO THIS PLAN OF DEVELOPMENT AND PLAN FOR EROSION AND SEDIMENT CONTROL AND THAT ALL RESPONSIBLE PERSONNEL INVOLVED IN THE CONSTRUCTION PROJECT WILL HAVE A CERTIFICATE OF ATTENDANCE AT A DEPARTMENT OF THE ENVIRONMENT APPROVED TRAINING PROGRAM FOR THE CONTROL OF SEDIMENT AND EROSION BEFORE BEGINNING THE PROJECT. I ALSO AUTHORIZE PERIODIC ON-SITE INSPECTION BY THE HOWARD SOIL CONSERVATION DISTRICT OR THEIR AUTHORIZED AGENTS, AS ARE DEEMED NECESSARY.

SIGNATURE OF DEVELOPER: *Orville Mellor*  
DATE: 11/1/94

NO.	REVISION	DATE
1	REVISE SITE ANALYSIS PARKING REQUIRED	11/17

REVIEWED FOR HOWARD SOIL CONSERVATION DISTRICT AND MEETS TECHNICAL REQUIREMENTS

*Patricia Inf* 2/1/95  
U.S. SOIL CONSERVATION SERVICE DATE

THIS DEVELOPMENT IS APPROVED FOR EROSION AND SEDIMENT CONTROL BY THE HOWARD SOIL CONSERVATION DISTRICT.

APPROVED: *John R. Robertson* 2/1/95  
DISTRICT DATE  
HOWARD SOIL CONSERVATION DISTRICT

APPROVED: DEPT. OF PLANNING AND ZONING

*James J. ...* 3/3/95  
PLANNING DIRECTOR DATE

*John J. ...* 3/7/95  
CHIEF, DIVISION OF LAND DEVELOPMENT AND RESEARCH DATE

APPROVED: HOWARD COUNTY HEALTH DEPARTMENT FOR PUBLIC WATER AND SEWERAGE SYSTEMS

*James M. ...* 3/3/95  
HEALTH OFFICER DATE

APPROVED: DEPARTMENT OF PUBLIC WORKS, FOR PUBLIC WATER & SEWER AND STORM DRAINAGE SYSTEMS AND ROADS.

*James J. ...* 2/22/95  
DIRECTOR, PUBLIC WORKS DATE


*Charles J. ...* 2/22/95  
CHIEF, BUREAU OF ENGINEERING DATE









PROPERTY/SUBDIVISION	SECTION/AREA	PARCEL
ST. JOHN'S STATION	24	39
PLAT NO./L.F.	BLOCK NO.	ZONE
2015/526	5	B-1
TAX/ZONE	ELEC. DIST.	CENSUS TR.
24	24	GOB2
WATER CODE	SEWER CODE	
F OG	1403700	

**SITE DEVELOPMENT PLAN**  
**OFFICE RETAIL CENTER**  
**ST. JOHN'S STATION**

TAX MAP 24 LIBER 2015, FOLIO 526 PARCEL 39  
2ND ELECTION DIST. HOWARD COUNTY, MARYLAND  
SCALE: 1" = 20' DATE: SEPTEMBER, 1994  
SHEET NO. 1 OF 2

**FISHER, COLLINS & CARTER, INC.**  
CIVIL ENGINEERING CONSULTANTS & LAND SURVEYORS  
9717 BALTIMORE NATIONAL PIKE, SUITE 100  
ELICOTT CITY, MARYLAND 21042  
(410) 461-2855

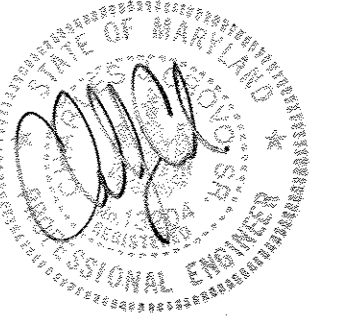

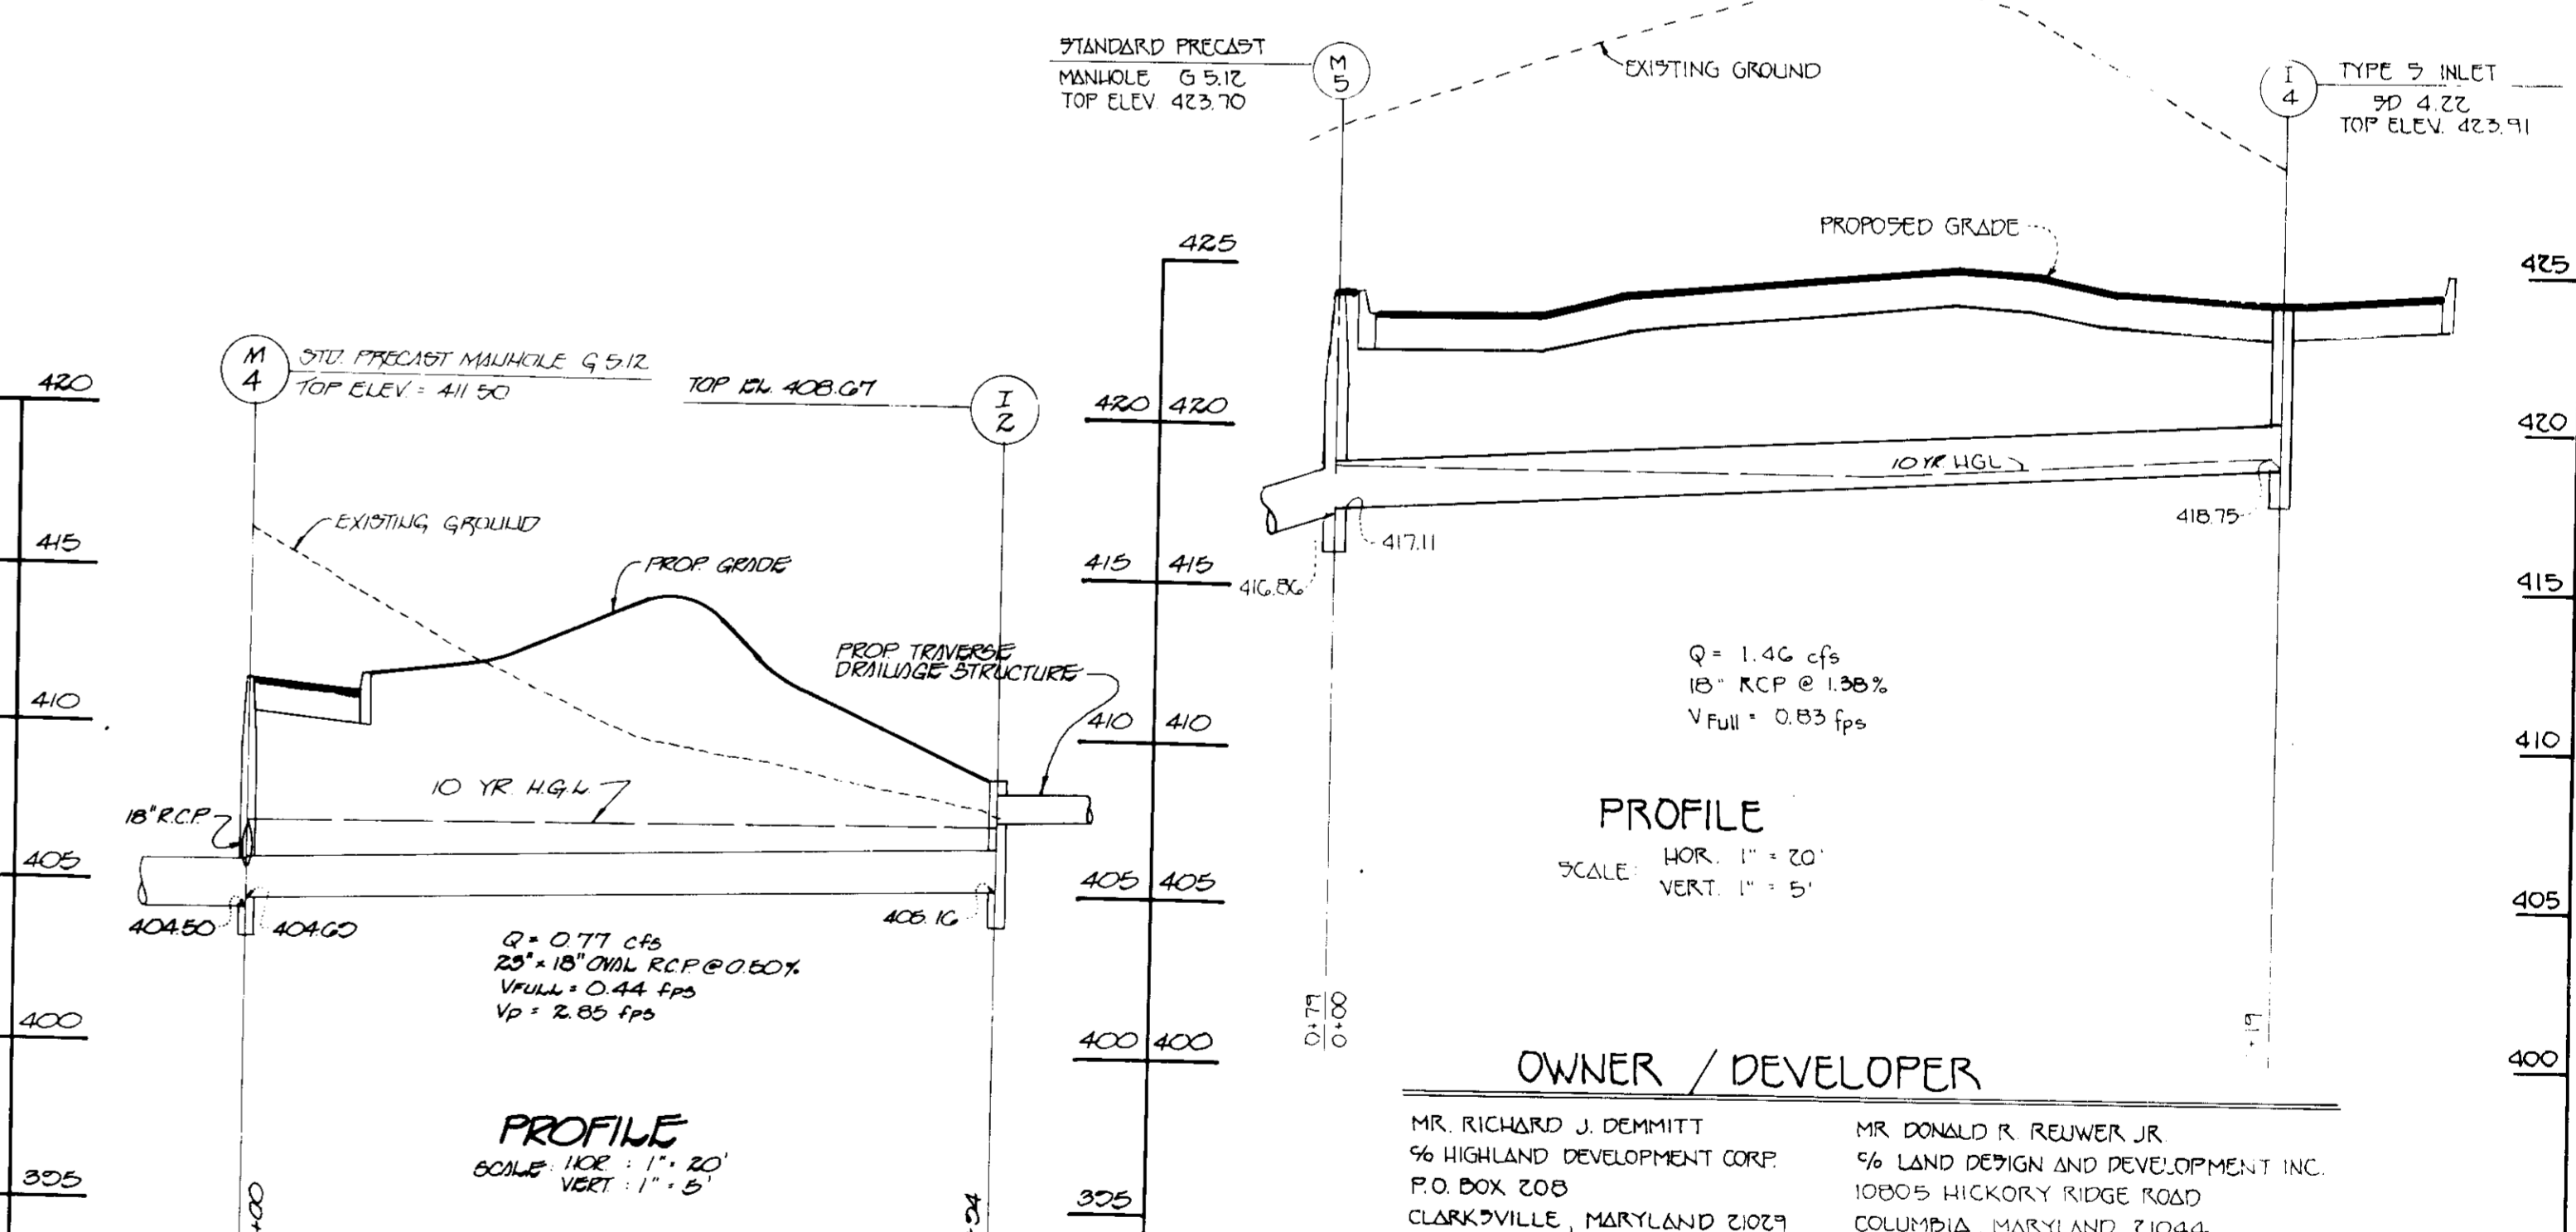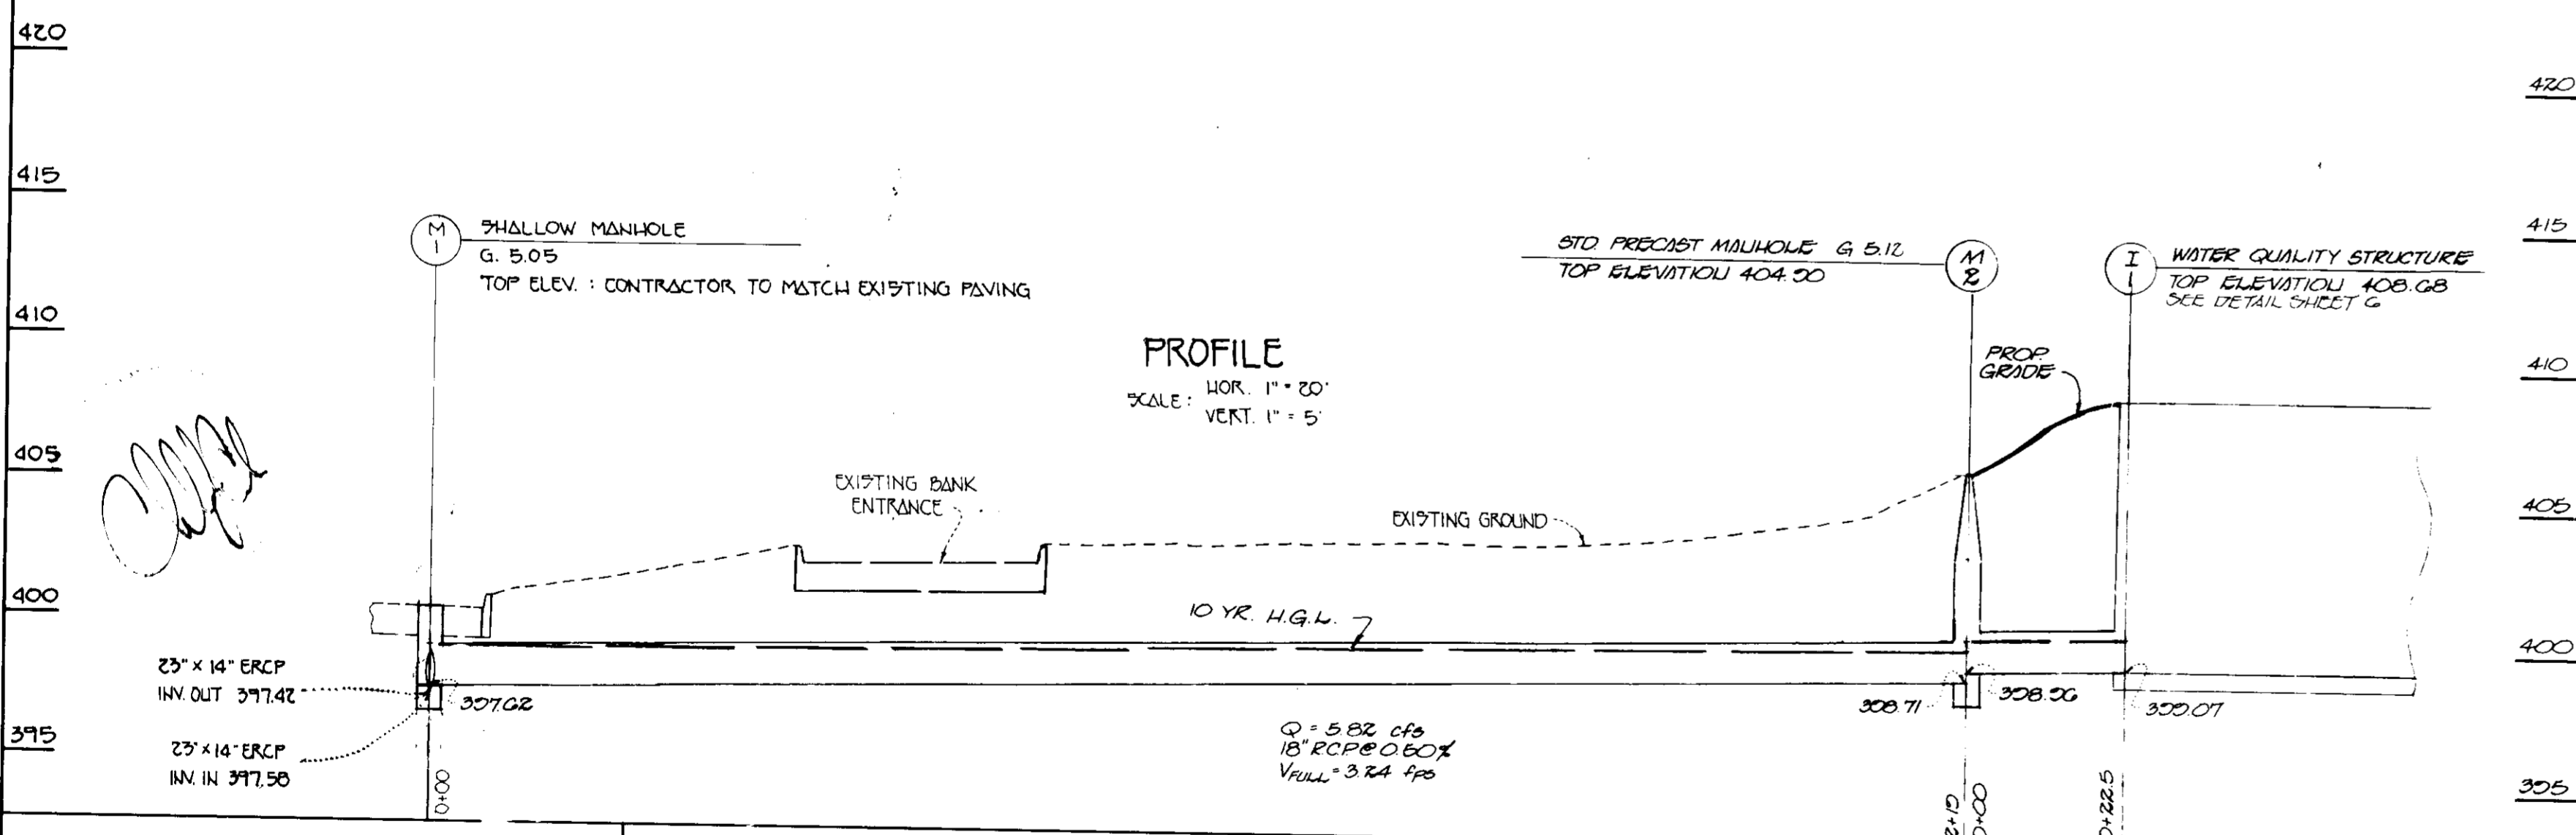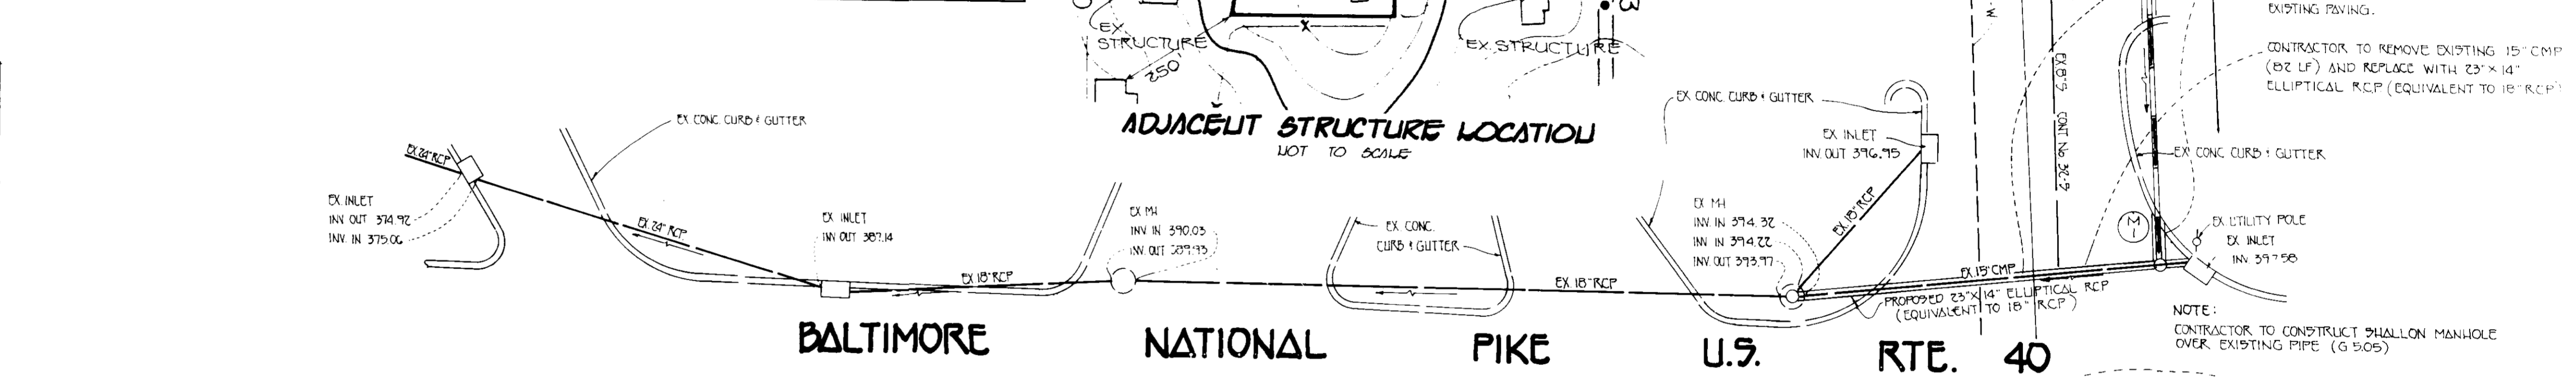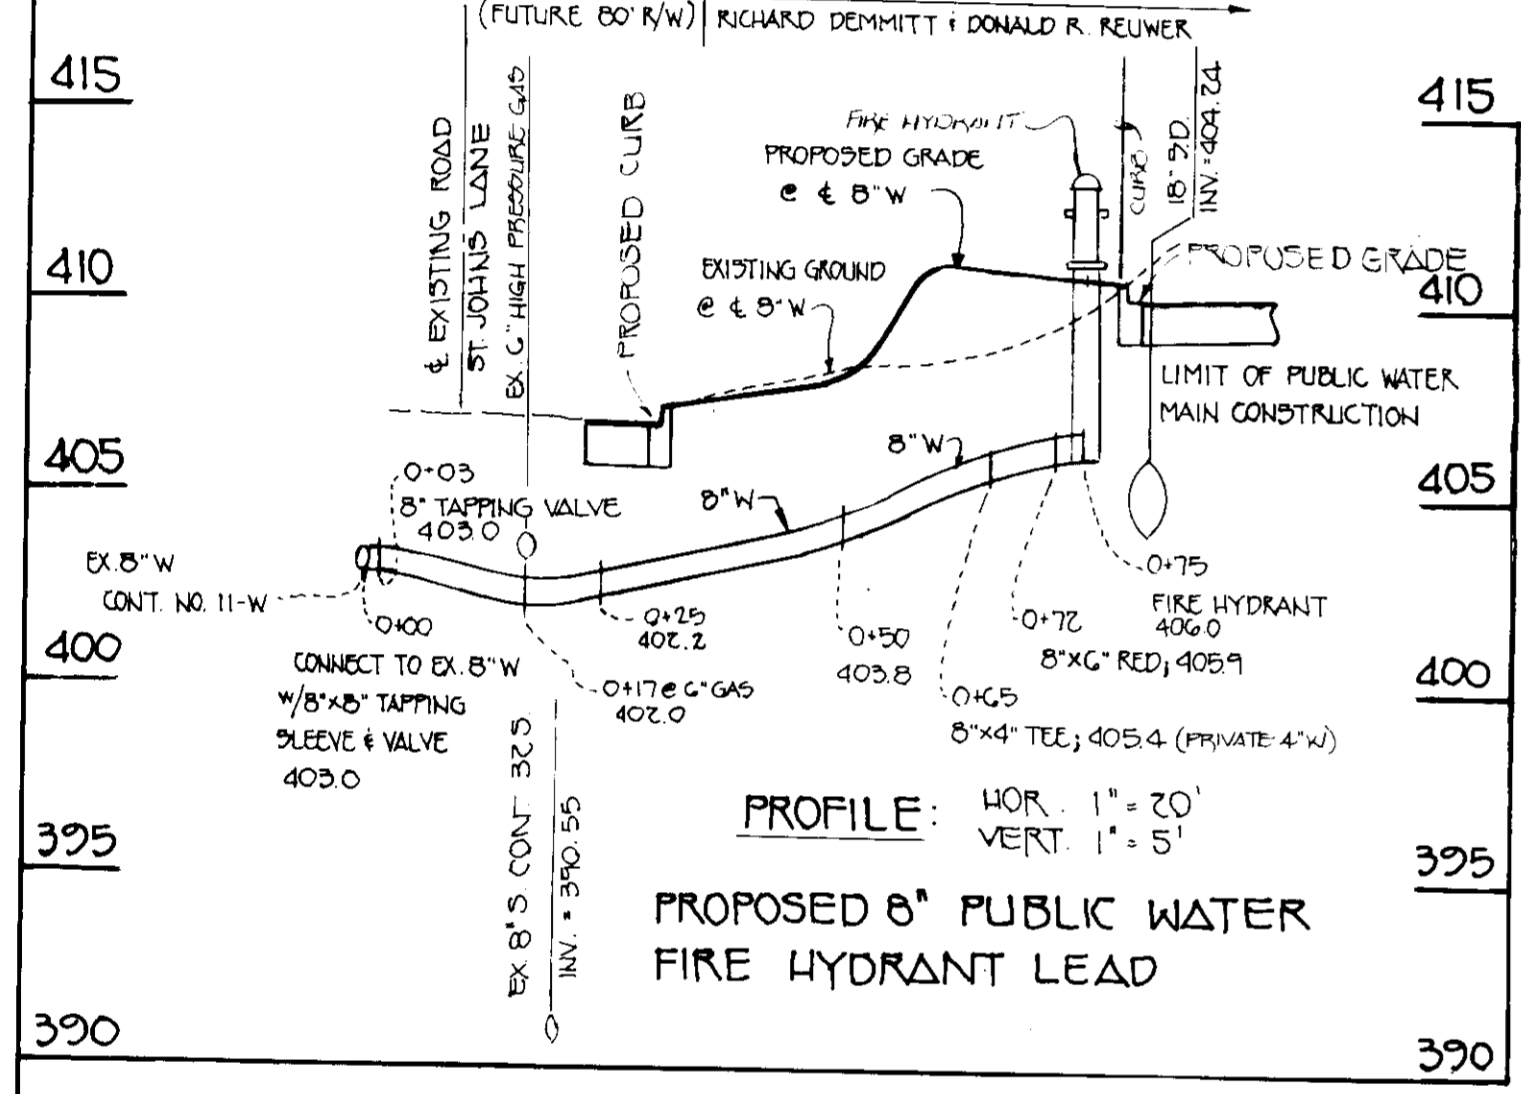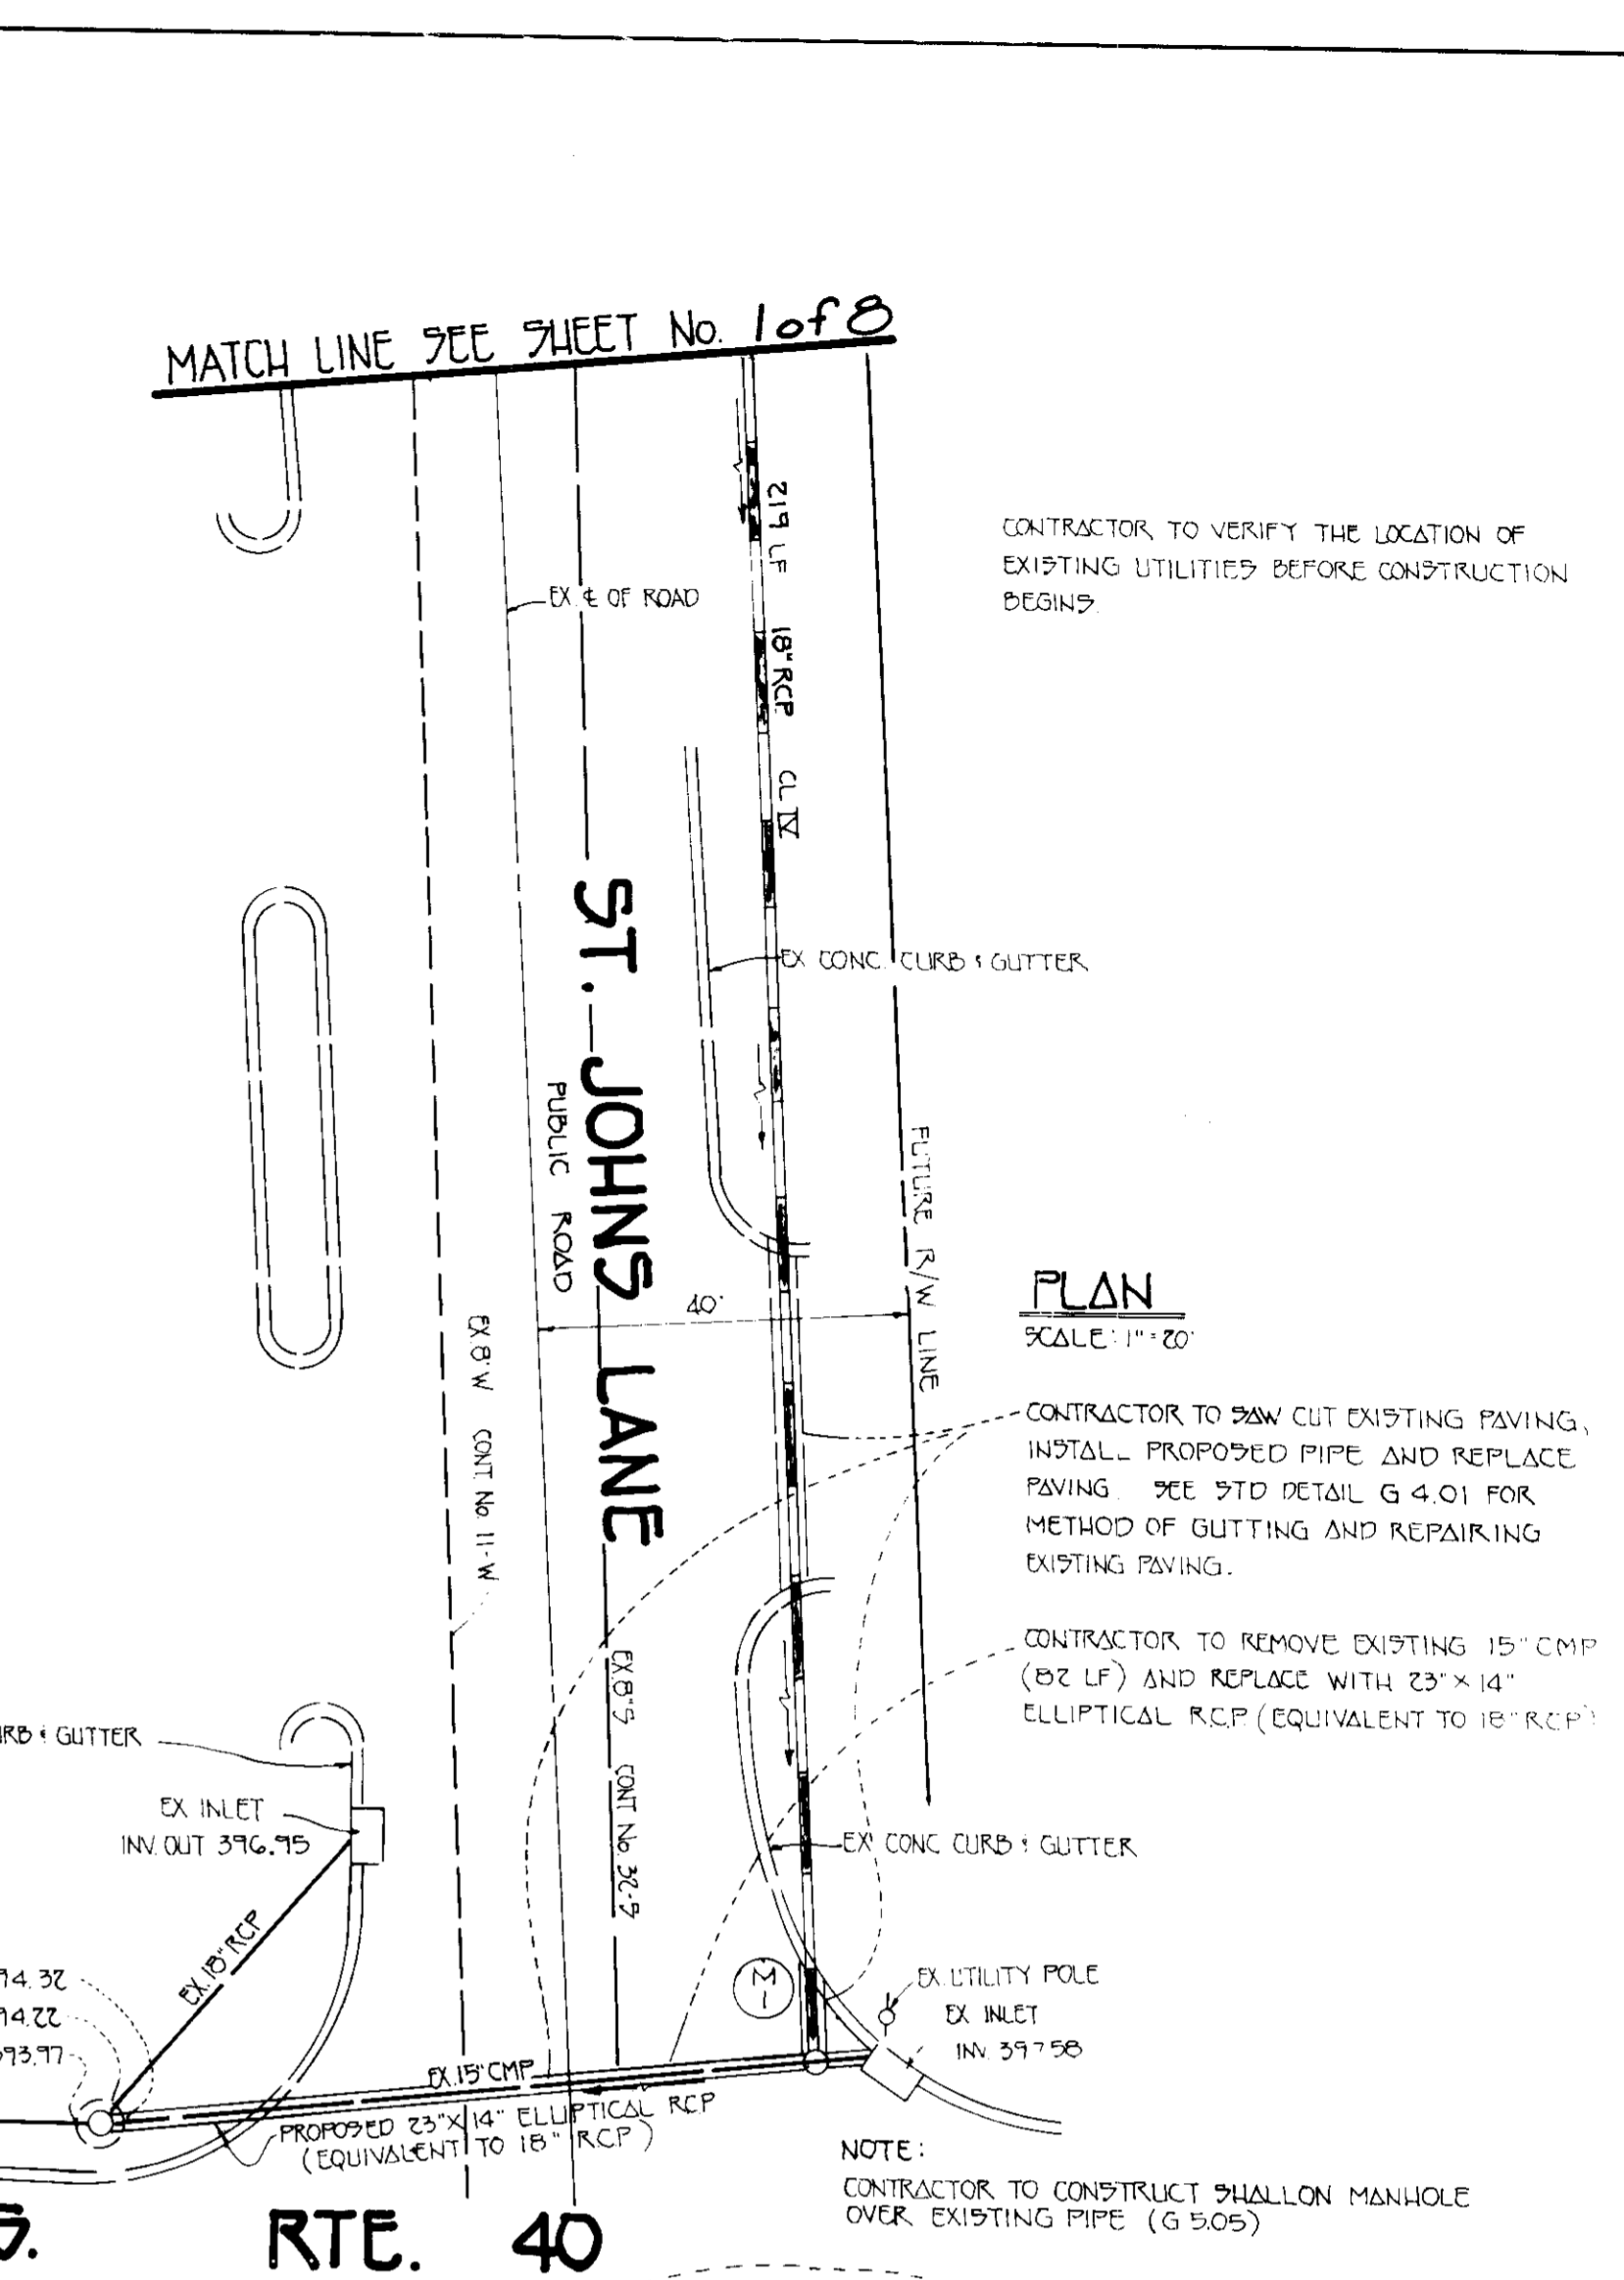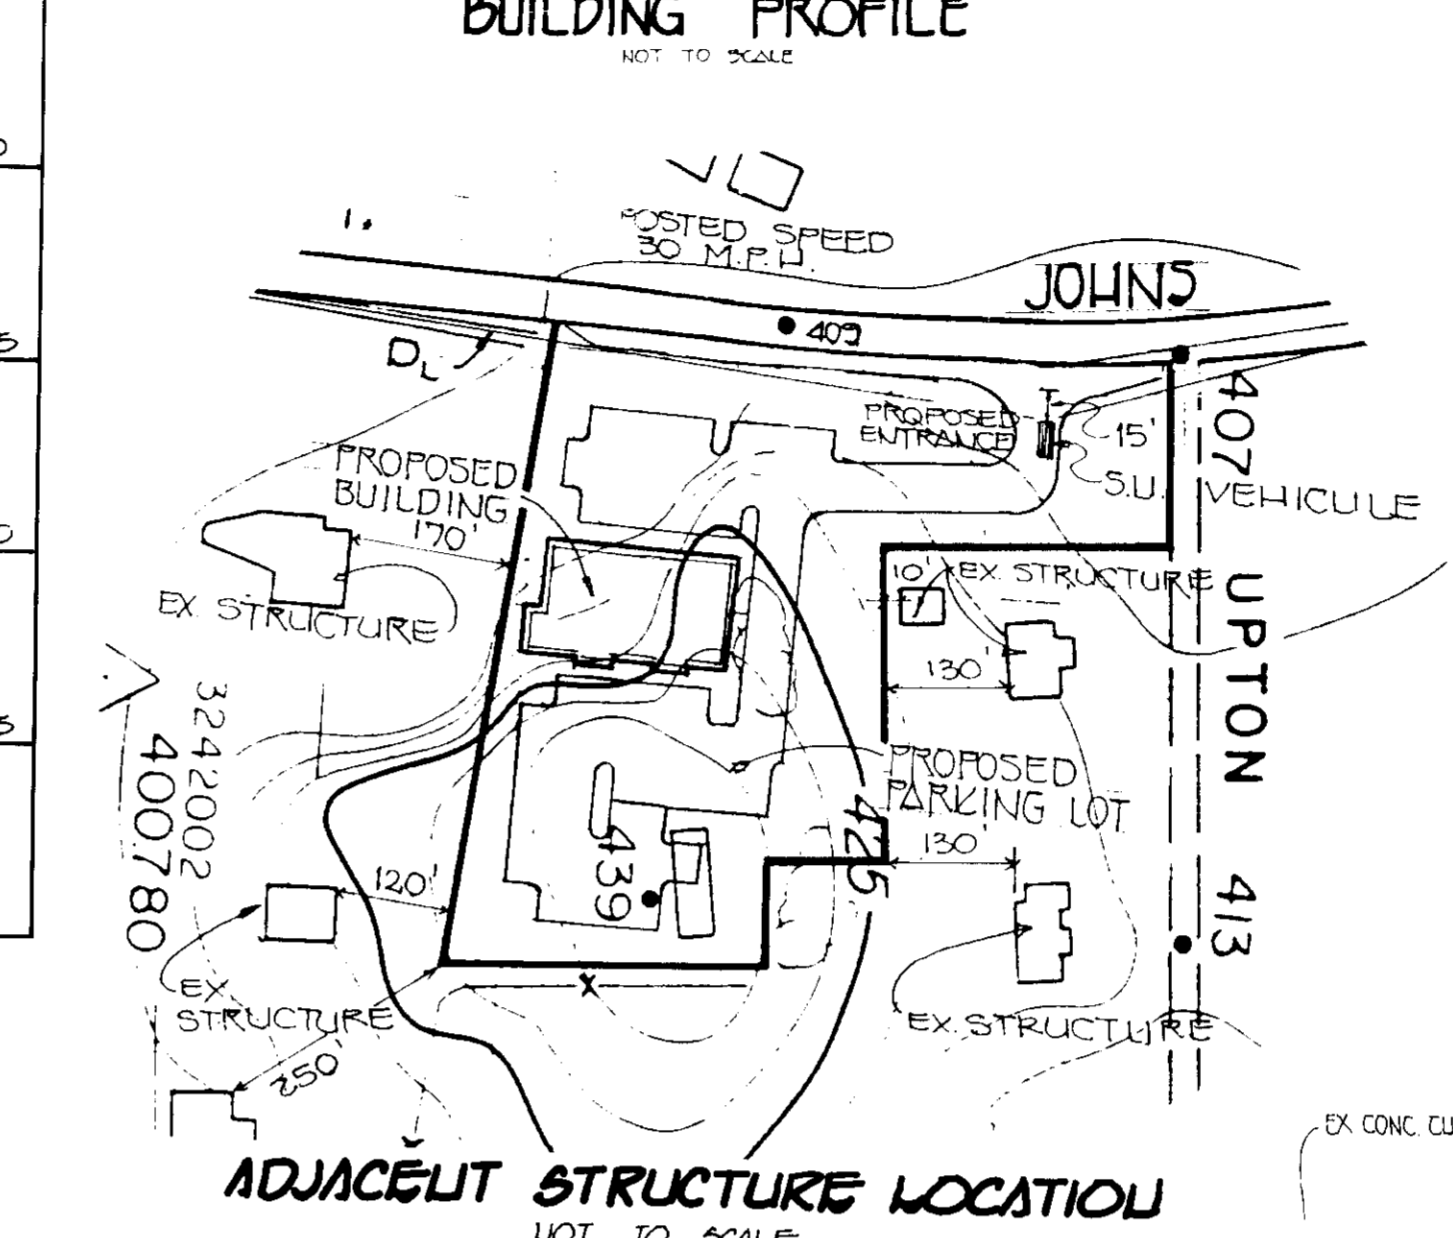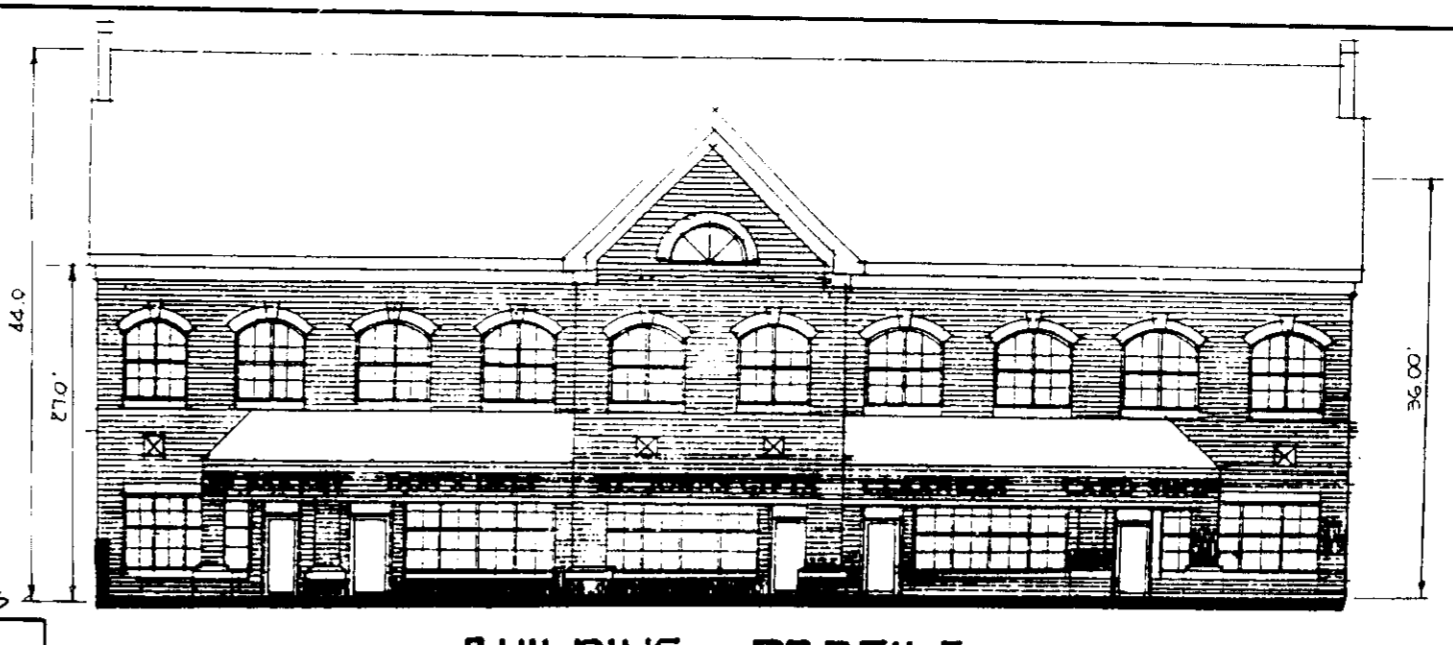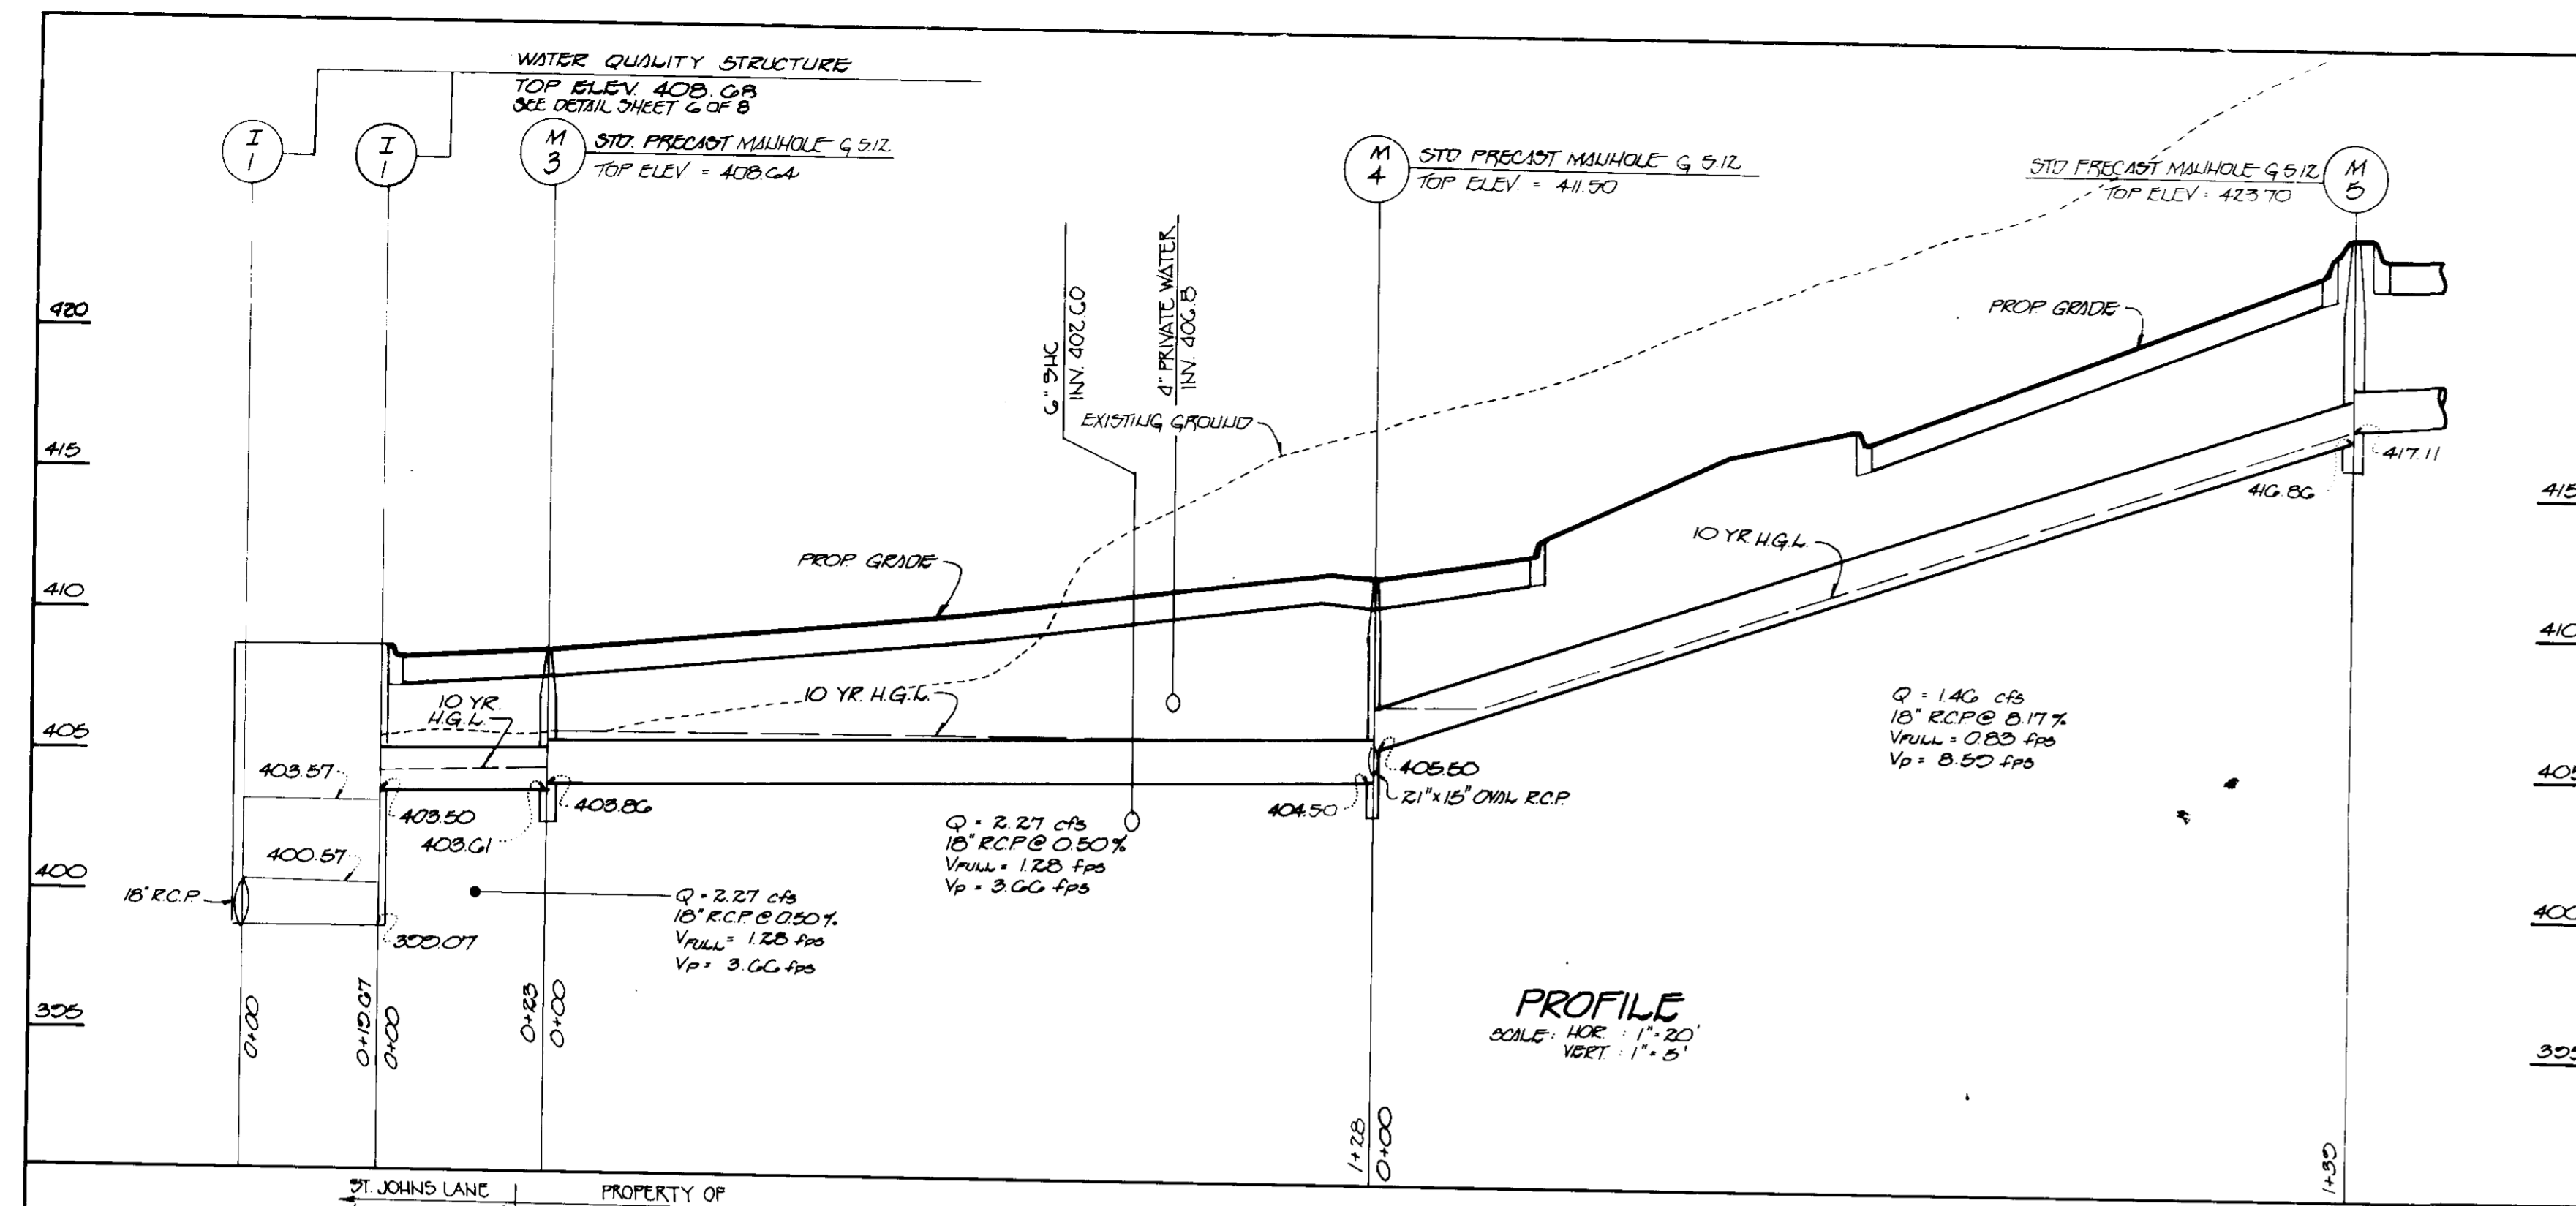

**FISHER, COLLINS & CARTER, INC.**  
 CIVIL ENGINEERS, CONSULTANTS & LAND SURVEYORS  
 971 BALTIMORE NATIONAL PIKE, SUITE 100  
 ELLICOTT CITY, MARYLAND 21042  
 (410) 461-2955

**ENGINEER'S CERTIFICATE**  
 I HEREBY CERTIFY THAT THIS PLAN FOR EROSION AND SEDIMENT CONTROL REPRESENTS A PRACTICAL AND WORKABLE PLAN BASED ON MY PERSONAL KNOWLEDGE OF THE SITE CONDITIONS AND THAT IT WAS PREPARED IN ACCORDANCE WITH THE REQUIREMENTS OF THE HOWARD SOIL CONSERVATION DISTRICT.  
 SIGNATURE OF ENGINEER: [Signature] DATE: 11/1/94

**DEVELOPER'S CERTIFICATE**  
 I/WE CERTIFY THAT ALL DEVELOPMENT AND CONSTRUCTION WILL BE DONE ACCORDING TO THIS PLAN OF DEVELOPMENT AND PLAN FOR EROSION AND SEDIMENT CONTROL AND THAT ALL RESPONSIBLE PERSONNEL INVOLVED IN THE CONSTRUCTION PROJECT WILL HAVE A CERTIFICATE OF ATTENDANCE AT A DEPARTMENT OF THE ENVIRONMENT APPROVED TRAINING PROGRAM FOR THE CONTROL OF SEDIMENT AND EROSION BEFORE BEGINNING THE PROJECT. I ALSO AUTHORIZE PERIODIC ON-SITE INSPECTION BY THE HOWARD SOIL CONSERVATION DISTRICT OR THEIR AUTHORIZED AGENTS, AS ARE DEEMED NECESSARY.  
 SIGNATURE OF DEVELOPER: [Signature] DATE: 11/1/94

REVIEWED FOR HOWARD SOIL CONSERVATION DISTRICT AND METS TECHNICAL REQUIREMENTS  
 [Signature] 2/1/95  
 U.S. SOIL CONSERVATION SERVICE  
 THIS DEVELOPMENT IS APPROVED FOR EROSION AND SEDIMENT CONTROL BY THE HOWARD SOIL CONSERVATION DISTRICT.  
 APPROVED: [Signature] 2/1/95  
 DISTRICT HOWARD SOIL CONSERVATION DISTRICT

APPROVED: DEPT. OF PLANNING AND ZONING  
 [Signature] 3/8/95  
 PLANNING DIRECTOR  
 [Signature] 3/7/95  
 CHIEF, DIVISION OF LAND DEVELOPMENT AND RESEARCH  
 APPROVED: HOWARD COUNTY HEALTH DEPARTMENT FOR PUBLIC WATER AND SEWERAGE SYSTEMS  
 [Signature] 3/3/95  
 4TH OFFICER

APPROVED: DEPARTMENT OF PUBLIC WORKS FOR PUBLIC WATER & SEWER AND STORM DRAINAGE SYSTEMS AND ROADS.  
 [Signature] 2/22/95  
 DIRECTOR PUBLIC WORKS  
 [Signature] 2/22/95  
 CHIEF, BUREAU OF ENGINEERING  
 PROPERTY/SUBDIVISION: ST. JOHN'S STATION  
 SECTION/AREA: PARCEL 39  
 PLAT/NO./L.F.: 2015 / SEC 5  
 BLOCK NO.: B-1  
 ZONE: Z-4  
 TAX/ZONING: 24  
 ELEC. DIST.: 2ND  
 CENSUS TR.: 6022  
 WATER CODE: FOG  
 SEWER CODE: 1403700

**SITE DEVELOPMENT PLAN**  
**STORM DRAIN PROFILES**  
**ST. JOHN'S STATION**  
 TAX MAP 24 LIBEX 2015, FOLIO 52G PARCEL 39  
 2ND ELECTION DIST. HOWARD COUNTY, MARYLAND  
 SCALE: AS SHOWN DATE: SEPTEMBER 1994  
 SHEET No. 2 OF 8  
 JDP-94-79


UPTON ROAD

ST. JOHNS LANE


3355 ST. JOHNS LANE  
SHARED PARKING ANALYSIS

TENANT/USE	PARKING REQUIRED	MORNING 6AM-9AM	MID-DAY 9AM-12PM	AFTERNOON 1PM-5PM	EVENING 5PM-12AM
SECOND FLOOR OFFICES 6,000 SQ. FT. 3.5 PER 1,000	21	80% 17	100% 21	100% 21	10% 3
M1 CASH RESTAURANT 2,400 SQ. FT. 14 PER 1,000	35	90% 18	90% 18	90% 18	100% 35
TEA-NO-CARRYOUT 1,210 SQ. FT. 5 PER 1,000	8	90% 4	90% 4	90% 4	100% 8
HAND CLEANERS RETAIL 1,210 SQ. FT. 5 PER 1,000	6	20% 1	60% 3	60% 3	90% 6
VOUCHER'S PIZZA CARRY OUT 1,210 SQ. FT. 5 PER 1,000	8	50% 4	50% 4	50% 4	100% 8
<b>TOTAL REQUIRED</b>	<b>78</b>	<b>44</b>	<b>50</b>	<b>50</b>	<b>50</b>



WITHOUT SHARED ANALYSIS  
PARKING PROVIDED: 95 SPACES

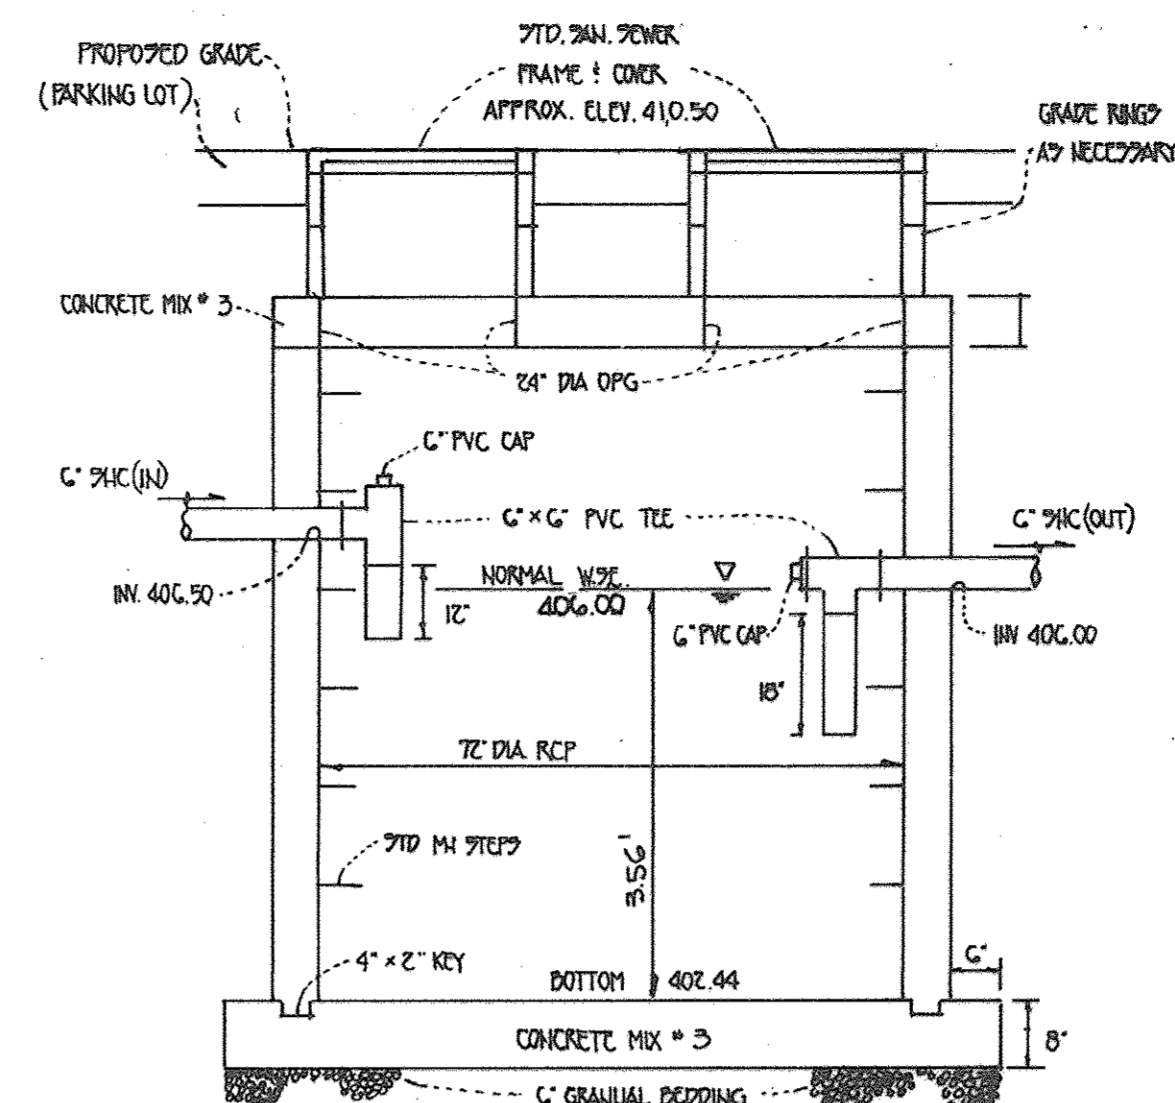


GREASE TRAP DETAIL  
NOT TO SCALE

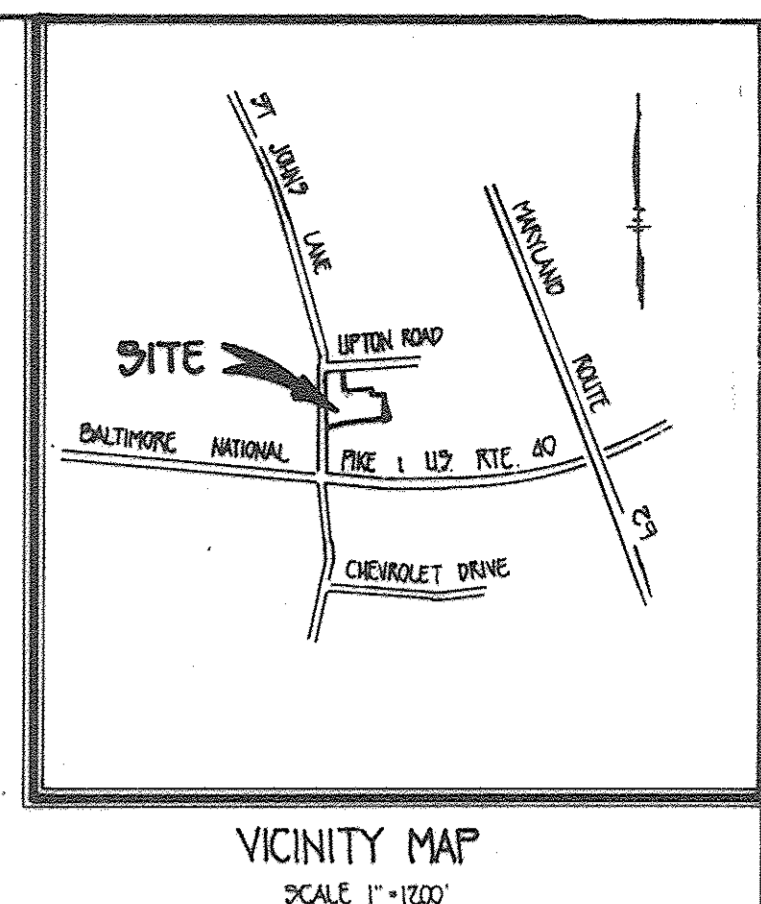


VICINITY MAP  
SCALE 1" = 100'

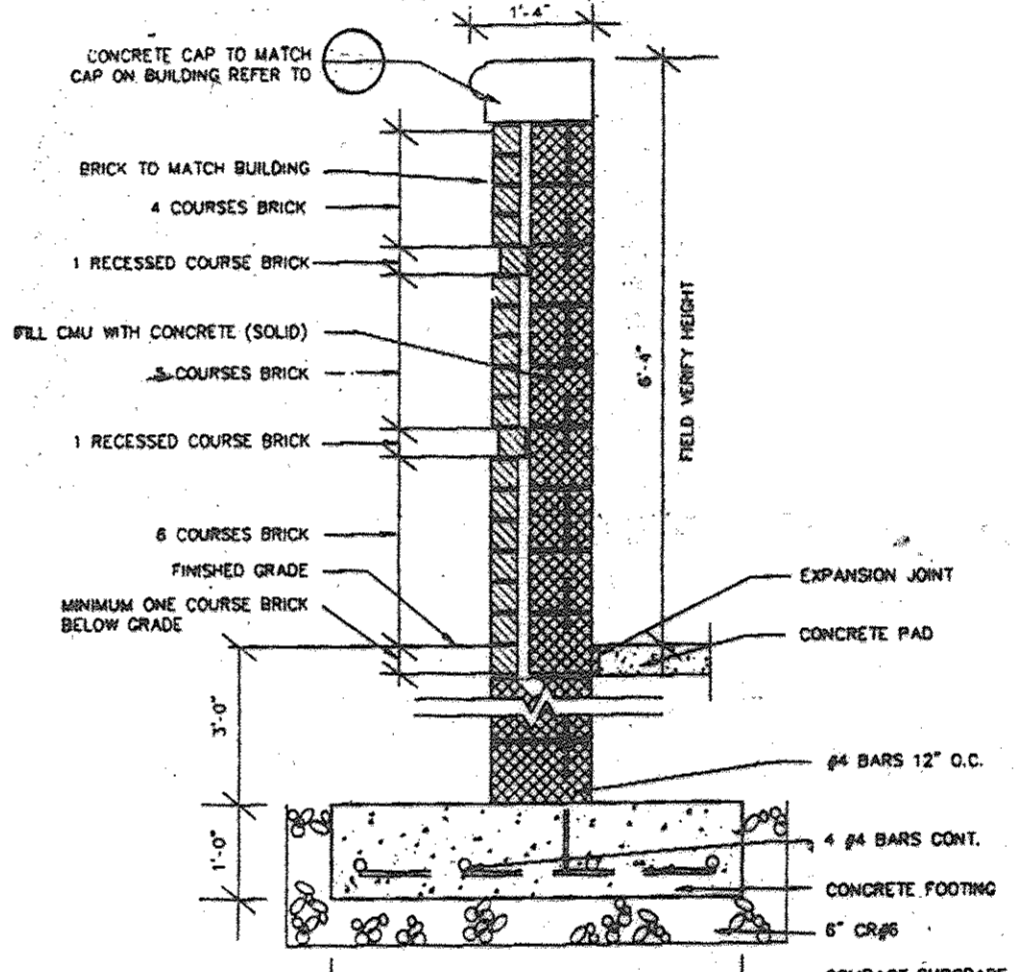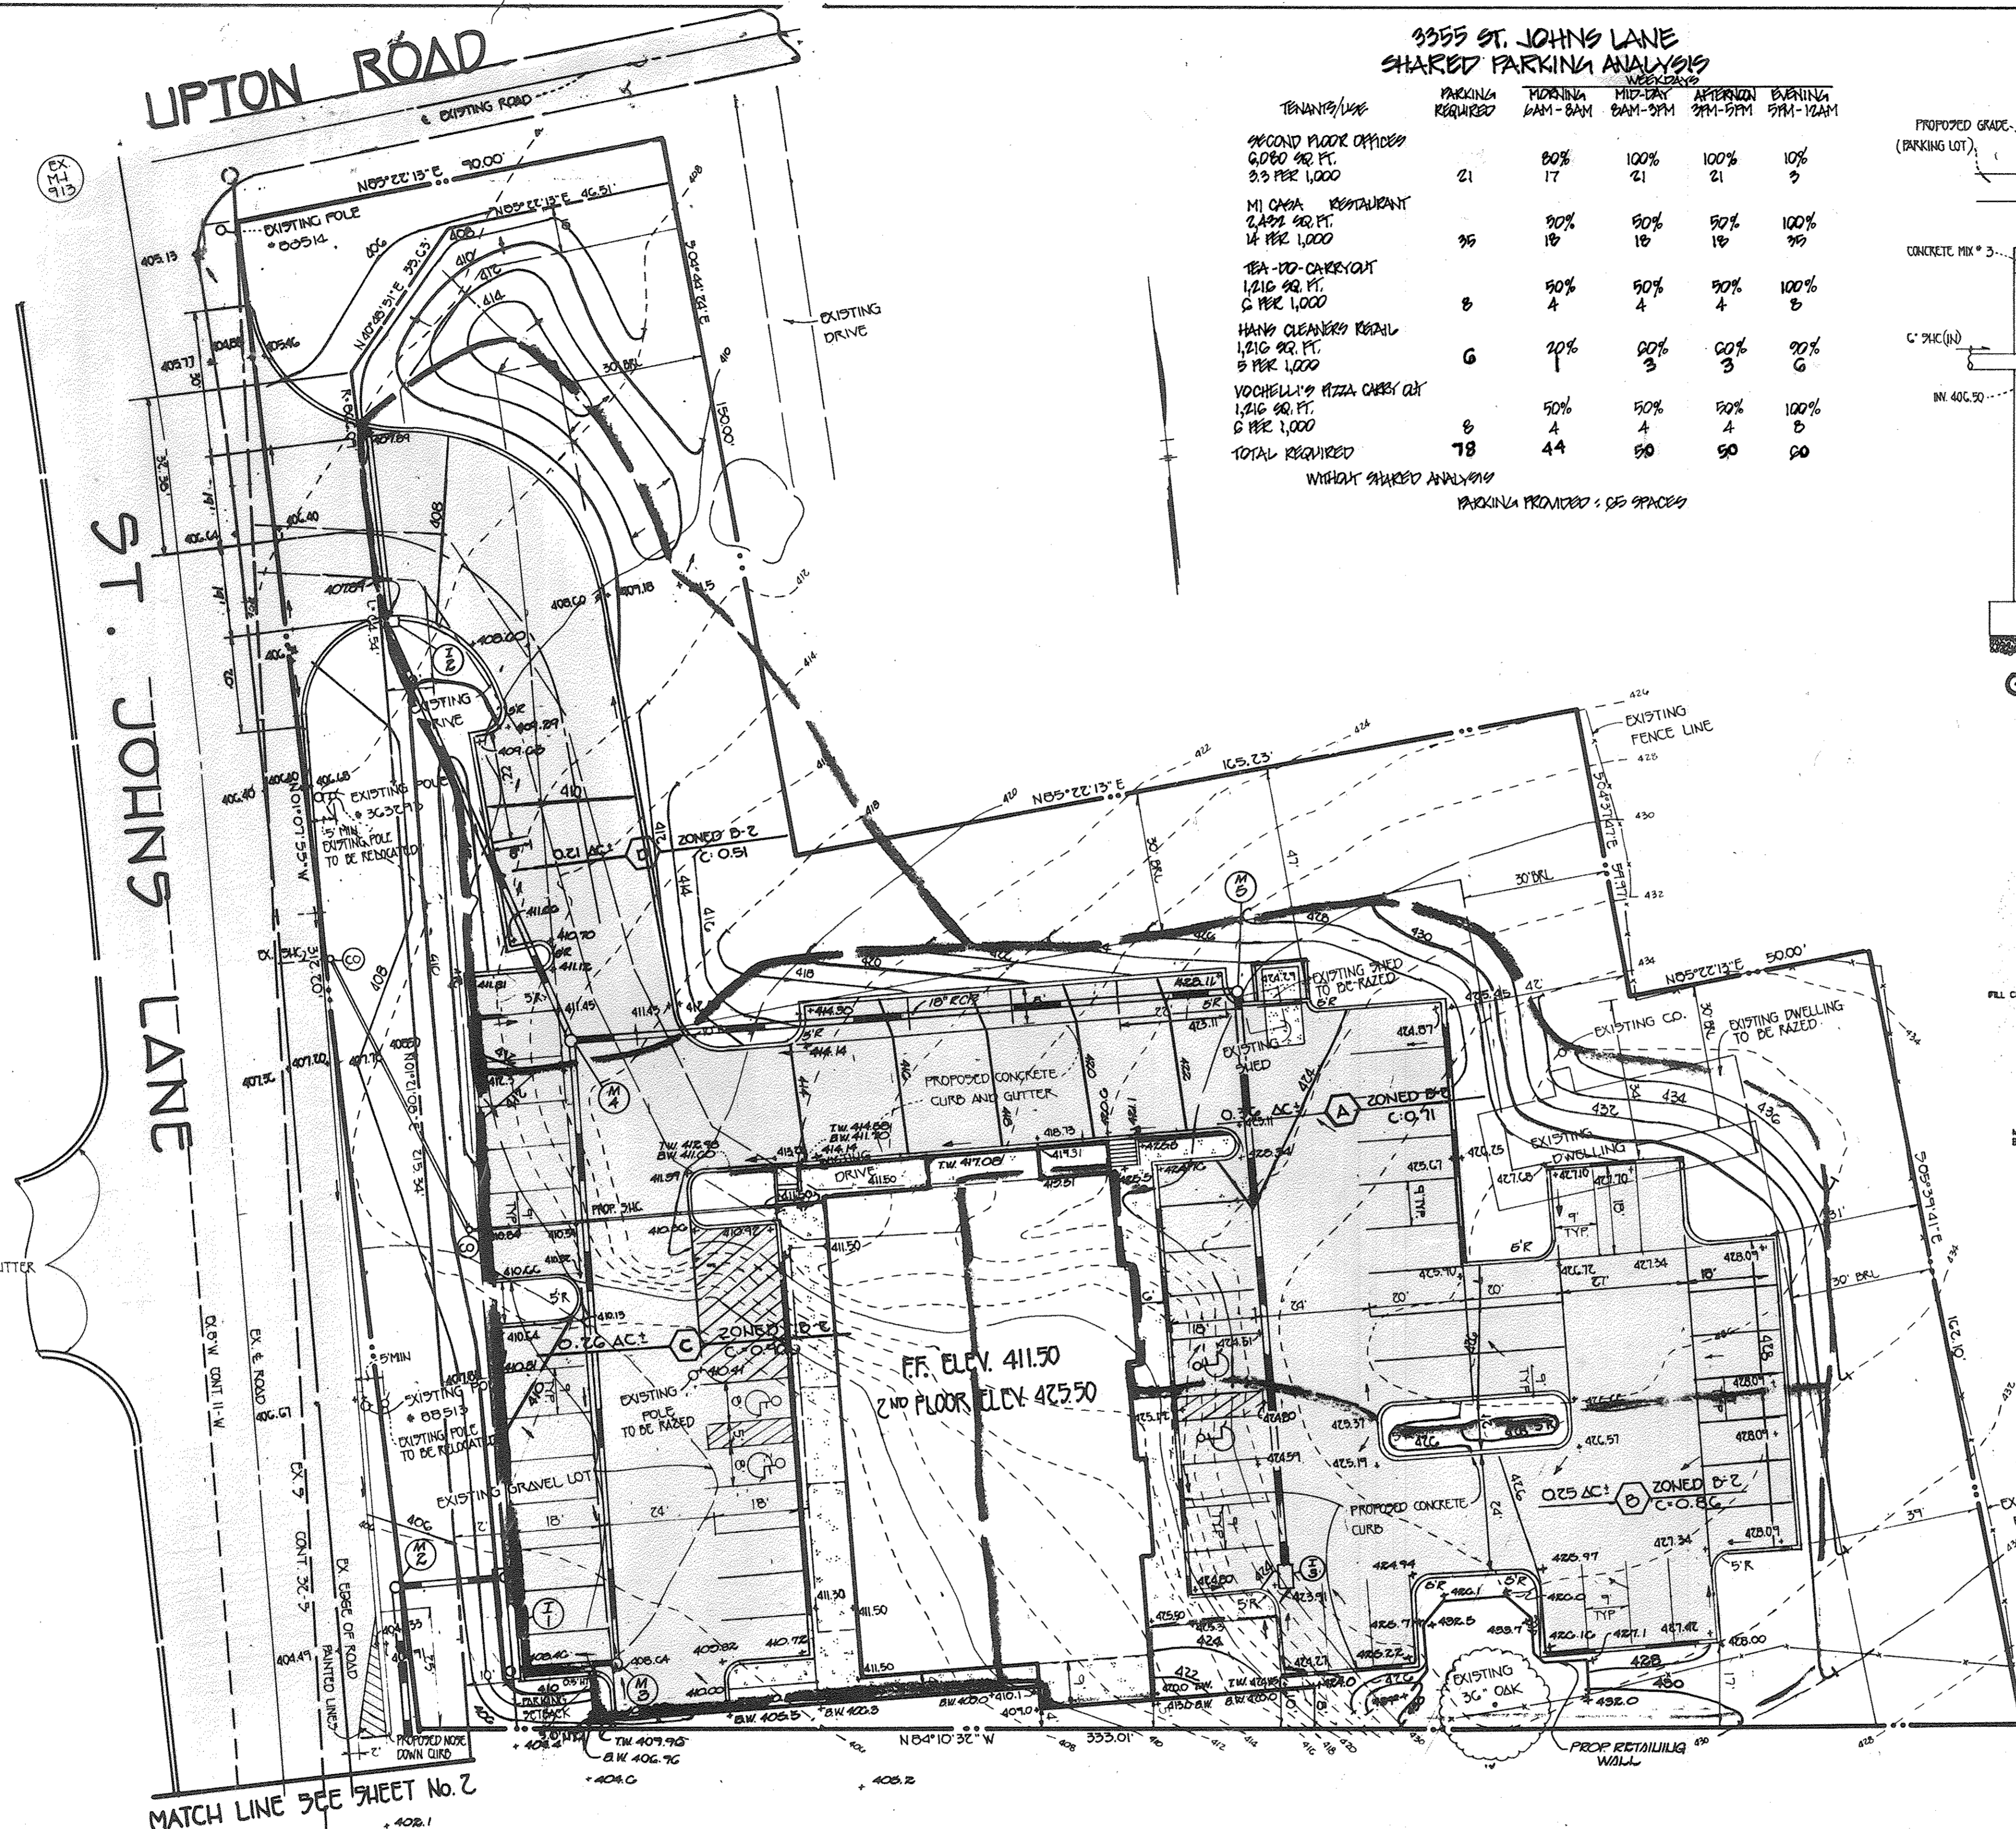

DUMPSTER ENCLOSURE WALL  
NOT TO SCALE

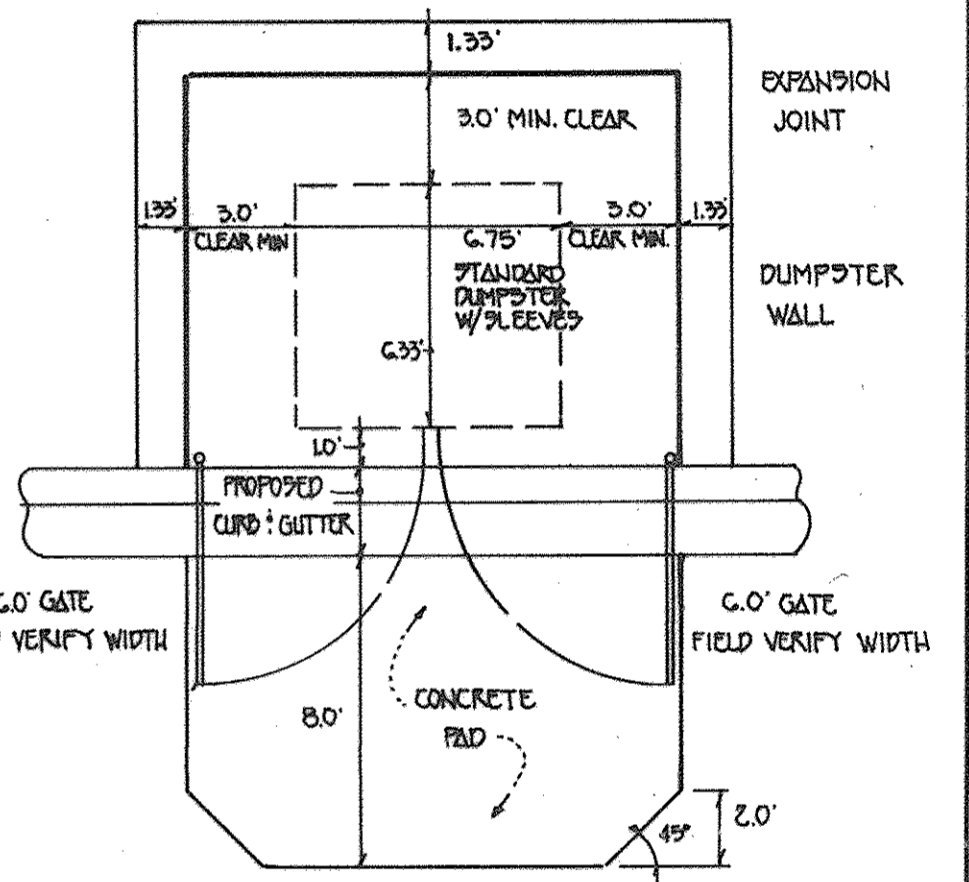

DUMPSTER ENCLOSURE DETAIL  
NOT TO SCALE

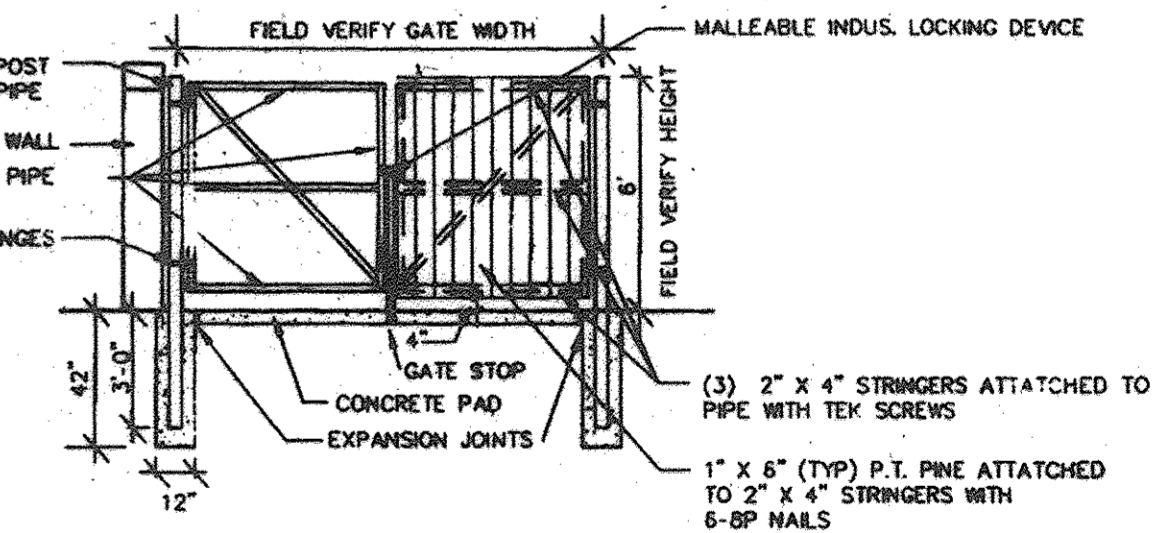

DUMPSTER GATE DETAIL  
NOT TO SCALE

ADDED SHARED PARKING ANALYSIS CHART

NO.	REVISION	DATE
1	ADDED SHARED PARKING ANALYSIS CHART	11/1/95

ENGINEER'S CERTIFICATE  
I HEREBY CERTIFY THAT THIS PLAN FOR EROSION AND SEDIMENT CONTROL REPRESENTS A PRACTICAL AND WORKABLE PLAN BASED ON MY PERSONAL KNOWLEDGE OF THE SITE CONDITIONS AND THAT IT WAS PREPARED IN ACCORDANCE WITH THE REQUIREMENTS OF THE HOWARD SOIL CONSERVATION DISTRICT.

*[Signature]*  
SIGNATURE OF ENGINEER

11/1/95  
DATE

DEVELOPER'S CERTIFICATE  
I/WE CERTIFY THAT ALL DEVELOPMENT AND CONSTRUCTION WILL BE DONE ACCORDING TO THIS PLAN OF DEVELOPMENT AND PLAN FOR EROSION AND SEDIMENT CONTROL AND THAT ALL RESPONSIBLE PERSONNEL INVOLVED IN THE CONSTRUCTION PROJECT WILL HAVE A CERTIFICATE OF ATTENDANCE AT A DEPARTMENT OF THE ENVIRONMENT APPROVED TRAINING PROGRAM FOR THE CONTROL OF SEDIMENT AND EROSION BEGINNING THE PROJECT. I ALSO AUTHORIZE PERIODIC ONSITE INSPECTION BY THE HOWARD SOIL CONSERVATION DISTRICT OR THEIR AUTHORIZED AGENTS, AS ARE DEEMED NECESSARY.

*[Signature]*  
SIGNATURE OF DEVELOPER

11/1/95  
DATE

REVIEWED FOR HOWARD SOIL CONSERVATION DISTRICT AND METS TECHNICAL REQUIREMENTS.  
*[Signature]* 2/1/95  
U.S. SOIL CONSERVATION SERVICE

THIS DEVELOPMENT IS APPROVED FOR EROSION AND SEDIMENT CONTROL BY THE HOWARD SOIL CONSERVATION DISTRICT.  
*[Signature]* 2/1/95  
DISTRICT HOWARD SOIL CONSERVATION DISTRICT

APPROVED: DEPT. OF PLANNING AND ZONING  
*[Signature]* 3/8/95  
PLANNING DIRECTOR

*[Signature]* 3/17/95  
CHIEF, DIVISION OF LAND DEVELOPMENT AND RESEARCH

APPROVED: HOWARD COUNTY HEALTH DEPARTMENT FOR PUBLIC WATER AND SEWERAGE SYSTEMS  
*[Signature]* 3/3/95  
HEALTH OFFICER

APPROVED: DEPARTMENT OF PUBLIC WORKS FOR PUBLIC WATER & SEWER AND STORM DRAINAGE SYSTEMS AND ROADS.  
*[Signature]* 2/23/95  
DIRECTOR, PUBLIC WORKS

*[Signature]* 2/22/95  
CHIEF, BUREAU OF ENGINEERING AND RESEARCH

PROPERTY/SUBDIVISION: ST. JOHNS STATION  
SECTION/AREA: 37  
PARCEL: 37

PLAT-NO./L.F.: 2015/26C  
BLOCK NO.: 5  
ZONE: B-1  
TAX/ZONE: 64  
ELEC. DIST.: 2  
CENSUS TR.: 0022

WATER CODE: FOG  
SEWER CODE: 1403700

OWNER / DEVELOPER  
MR. RICHARD J. DEMMITT  
% HIGHLAND DEVELOPMENT CORP.  
P.O. BOX 200  
CLARKSVILLE, MARYLAND 21029

MR. DONALD R. REINWER, JR.  
% LAND DESIGN AND DEVELOPMENT INC.  
10605 LICKORY RIDGE ROAD  
COLUMBIA, MARYLAND 21044

GRADING PLAN  
DRAINAGE AREA MAP  
ST. JOHNS STATION

TAX MAP 24 LIBER 2015, FOLIO 56C  
2ND ELECTION DIST.  
SCALE: 1" = 20'

PARCEL 37  
HOWARD COUNTY, MARYLAND  
DATE: SEPTEMBER 1974

SHEET NO. 3 OF 6

FISHER, COLLINS & CARTER, INC.  
CIVIL ENGINEERING CONSULTANTS & LAND SURVEYORS  
9771 BALTIMORE NATIONAL PIKE, SUITE 100  
ELLCOTT CITY, MARYLAND 21042  
410-481-2222

UPTON ROAD

ST. JOHNS LANE

SEQUENCE OF CONSTRUCTION

1. OBTAIN GRADING PERMIT (7 DAYS)
2. INSTALL SEDIMENT CONTROL DEVICES AS SHOWN ON PLAN (2 DAYS)
3. CLEAR AND GRUB SITE (7 DAYS)
4. ROUGH GRADE SITE (14 DAYS)
5. CONSTRUCT BUILDING (60 DAYS)
6. CONSTRUCT CURB, GUTTER AND UTILITIES (10 DAYS)
7. CONSTRUCT STORM DRAIN (10 DAYS)
8. FINE GRADE SITE AND INSTALL SUB-BASE PAVING (7 DAYS)
9. CONSTRUCT SIDEWALKS AND DUMPSTER (5 DAYS)
10. INSTALL PERMANENT SEEDING AND SIGNAGE (3 DAYS)
11. CONSTRUCT STORM DRAIN TO ROUTE 40 (5 DAYS)
12. REMOVE LANDSCAPING (3 DAYS)
13. REMOVE SEDIMENT CONTROL DEVICES AS PERMISSION IS GRANTED BY E/P INSPECTOR. (3 DAYS)
14. INSTALL TACT COAT AND FINISHED PAVING. (3 DAYS)

**PERMANENT SEEDING NOTES:**  
 APPLY TO GRADED OR CLEARED AREAS WHERE A PERMANENT LONG-LIVED VEGETATIVE COVER IS REQUIRED.

**SEEDER PREPARATION:** LOOSEN UPPER THREE-INCHES OF SOIL BY RAKING, DISCING OR OTHER ACCEPTABLE MEANS BEFORE SEEDING. IF NOT PREVIOUSLY LOOSENED, SOIL AMENDMENTS: IN LIEU OF SOIL TEST RECOMMENDATIONS, USE ONE OF THE FOLLOWING SCHEDULES:

- 1) PREFERRE - APPLY 2 TONS PER ACRE BOLSOMITIC LIMESTONE (92 LBS/1000 SQ.FT.) BEFORE SEEDING.
- 2) ACCEPTABLE - APPLY 2 TONS PER ACRE FERTILIZER (92 LBS/1000 SQ.FT.) BEFORE SEEDING.

**SEEDING:** HARROW OR DISC INTO UPPER THREE-INCHES OF SOIL. AT TIME OF SEEDING, APPLY 400 LBS. PER ACRE OF 10-10-10 FERTILIZER (14 LBS/1000 SQ.FT.)

**MULCHING:** APPLY 1 1/2 TO 2 TONS PER ACRE (70 TO 90 LBS/1000 SQ.FT.) OF UNROTTED SMALL STRAW IMMEDIATELY AFTER SEEDING. ANCHOR MULCH IMMEDIATELY AFTER APPLICATION USING MULCH ANCHORING TOOL OR 210 GALLONS PER ACRE (5 GAL/1000 SQ. FT.) OF EMULSIFIED ASPHALT ON FLAT AREAS, ON SLOPES 8 FEET OR HIGHER, USE 348 GALLONS PER ACRE (8 GAL/1000 SQ.FT.) FOR ANCHORING.

**MAINTENANCE:** INSPECT ALL SEEDING AREAS AND MAKE NEEDED REPAIRS, REPLACEMENTS AND RESEEDINGS.

**TEMPORARY SEEDING NOTES:**  
 APPLY TO GRADED OR CLEARED AREAS LIKELY TO BE REDISTURBED WHERE A SHORT-TERM VEGETATIVE COVER IS NEEDED.

**SEEDER PREPARATION:** LOOSEN UPPER THREE-INCHES OF SOIL BY RAKING, DISCING OR OTHER ACCEPTABLE MEANS BEFORE SEEDING. IF NOT PREVIOUSLY LOOSENED, SOIL AMENDMENTS: APPLY 400 LBS PER ACRE 10-10-10 FERTILIZER (14 LBS/1000 SQ.FT.)

**SEEDING:** FOR PERIODS MARCH 1 THRU APRIL 30, AND FROM AUGUST 15 THRU NOVEMBER 15, SEED WITH 2 1/2 BUSHELS PER ACRE OF ANNUAL RYE (3.2 LBS/1000 SQ.FT.). FOR THE PERIOD MAY 1 THRU JULY 31, SEED WITH 40 LBS. KENTUCKY 31 TALL FESCUE PER ACRE AND 2 LBS. PER ACRE OF 10-10-10 FERTILIZER (14 LBS/1000 SQ.FT.). FOR THE PERIOD OF OCTOBER 15 THRU FEBRUARY 28, LONGGRASS (1.0 BUSHEL PER ACRE OF ANNUAL RYE (3.2 LBS/1000 SQ.FT.)) PROJECT SITE BY OPTION (1) 2 TONS SPRING, OPTION (2) USE SOO, OPTION (3) SEED WITH 60 LBS/ACRE KENTUCKY 31 TALL FESCUE AND MULCH WITH 2 TONS/ACRE WILL ANCHORED STRAW.

**MULCHING:** APPLY 1 1/2 TO 2 TONS PER ACRE (70 TO 90 LBS/1000 SQ.FT.) OF UNROTTED SMALL STRAW IMMEDIATELY AFTER SEEDING. ANCHOR MULCH IMMEDIATELY AFTER APPLICATION USING MULCH ANCHORING TOOL OR 210 GALLONS PER ACRE (5 GAL/1000 SQ. FT.) OF EMULSIFIED ASPHALT ON FLAT AREAS, ON SLOPES 8 FEET OR HIGHER, USE 348 GALLONS PER ACRE (8 GAL/1000 SQ.FT.) FOR ANCHORING.



REFER TO THE 1983 MARYLAND STANDARDS AND SPECIFICATIONS FOR SOIL EROSION AND SEDIMENT CONTROL FOR RATE AND METHODS NOT COVERED.

**SEDIMENT CONTROL NOTES:**

- 1) A MINIMUM OF 24 HOURS NOTICE MUST BE GIVEN TO THE HOWARD COUNTY OFFICE OF INSPECTIONS AND PERMITS PRIOR TO THE START OF ANY CONSTRUCTION (1982-2023).
- 2) ALL VEGETATIVE AND STRUCTURAL PRACTICES ARE TO BE INSTALLED ACCORDING TO THE PROVISIONS OF THIS PLAN AND ARE TO BE IN CONFORMANCE WITH THE 1983 MARYLAND STANDARDS AND SPECIFICATIONS FOR SOIL EROSION AND SEDIMENT CONTROL.
- 3) FOLLOWING INITIAL SOIL DISTURBANCE OR REDISTURBANCE, PERMANENT OR TEMPORARY STABILIZATION SHALL BE COMPLETED WITHIN: (A) 7 CALENDAR DAYS FOR ALL PERIMETER SEDIMENT CONTROL STRUCTURES, DICES, PERIMETER SLOPES AND ALL GREATER THAN 3:1; (B) 14 DAYS AS TO ALL OTHER DISTURBED OR GRADED AREAS ON THE PROJECT SITE.
- 4) ALL SEDIMENT CONTROL STRUCTURES MUST BE FENCED AND WARNING SIGNS POSTED AROUND THEIR PERIMETER IN ACCORDANCE WITH VOL. 1, CHAPTER 12 OF THE HOWARD COUNTY DESIGN MANUAL. STORM ARRANGES.
- 5) ALL DISTURBED AREAS MUST BE STABILIZED WITHIN THE TIME PERIOD SPECIFIED ABOVE IN ACCORDANCE WITH THE 1983 MARYLAND STANDARDS AND SPECIFICATIONS FOR SOIL EROSION AND SEDIMENT CONTROL. FOR PERMANENT SEEDINGS (SEC. 51) SOO (SEC. 54), TEMPORARY SEEDING (SEC. 50) AND MULCHING (SEC. 52). TEMPORARY STABILIZATION WITH MULCH ALONE CAN ONLY BE DONE WHEN RECOMMENDED SEEDING GRASSES DO NOT ALLOW FOR PROPER GERMINATION AND ESTABLISHMENT OF GRASSES.
- 6) ALL SEDIMENT CONTROL STRUCTURES ARE TO REMAIN IN PLACE AND ARE TO BE MAINTAINED IN OPERATIVE CONDITION UNTIL PERMISSION FOR THEIR REMOVAL HAS BEEN OBTAINED FROM THE HOWARD COUNTY SEDIMENT CONTROL INSPECTOR.
- 7) SITE ANALYSIS:
 

TOTAL AREA OF SITE	1.7	ACRES
AREA TO BE ROOFED OR PAVED	0.6	ACRES
AREA TO BE VEGETATIVELY STABILIZED	1.1	ACRES
TOTAL CUT	10,500	CU. YDS.
TOTAL FILL	12,500	CU. YDS.
- 8) ANY SEDIMENT CONTROL PRACTICE WHICH IS DISTURBED BY GRADING ACTIVITY FOR PLACEMENT OF UTILITIES MUST BE REPAIRED ON THE SAME DAY OF DISTURBANCE.
- 9) ADDITIONAL SEDIMENT CONTROLS MUST BE PROVIDED, IF DEEMED NECESSARY BY THE HOWARD COUNTY OFFICE OF SEDIMENT CONTROL INSPECTOR.
- 10) ON ALL SITES WITH DISTURBED AREAS IN EXCESS OF 2 ACRES, APPROVAL OF THE HOWARD COUNTY OFFICE OF SEDIMENT CONTROL INSPECTOR, COMPLETION OF INSTALLATION OF PERIMETER EROSION AND SEDIMENT CONTROLS, BUT BEFORE PROCEEDING WITH ANY OTHER EARTH DISTURBANCE OR GRADING, OTHER BUILDING OR GRADING INSPECTION APPROVALS MAY NOT BE AUTHORIZED UNTIL THIS INITIAL APPROVAL BY THE INSPECTION AGENCY IS MADE.


\* OFFSITE WASTE AREAS TO BE APPROVED BY EROSION AND SEDIMENT CONTROL INSPECTOR.

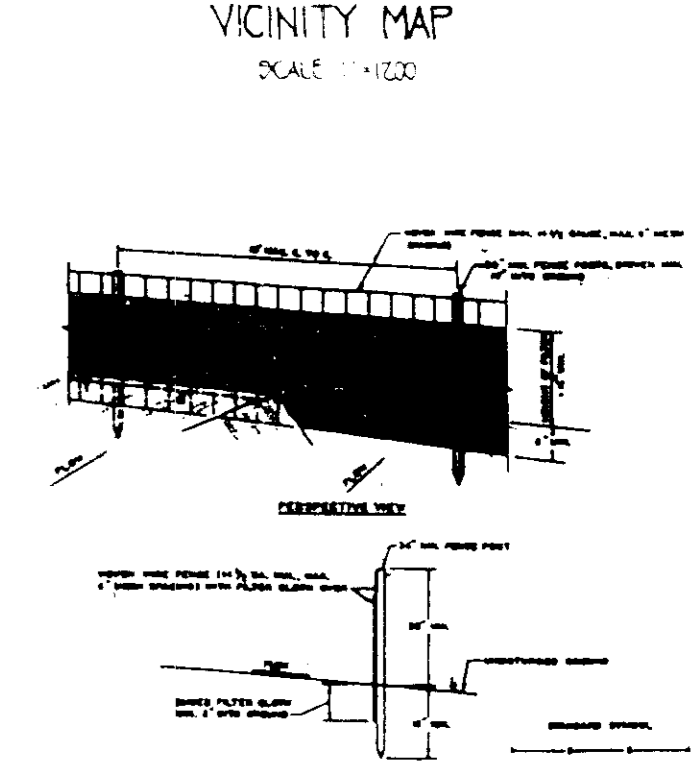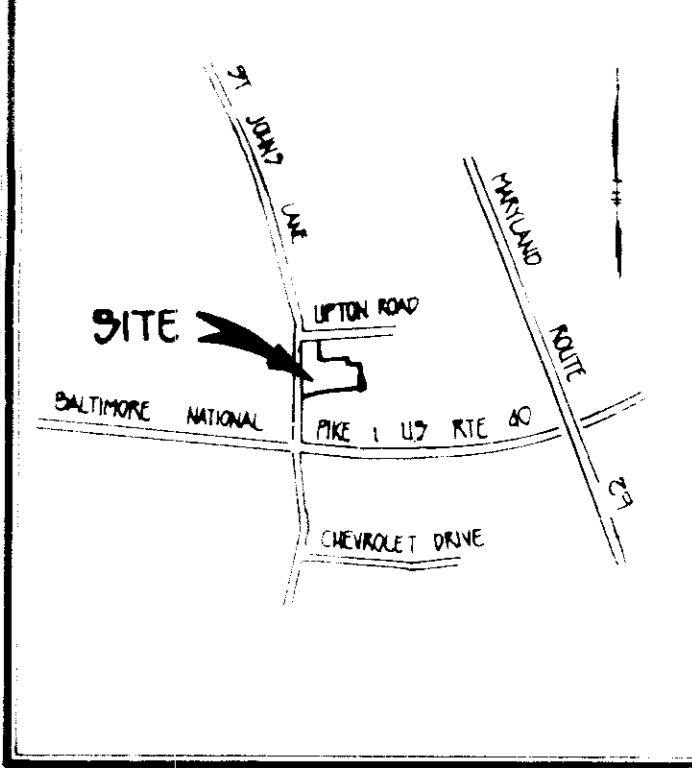

1. FILL SHALL BE PLACED IN 6" LAYERS WITH A MINIMUM OF 10% MOISTURE.
2. FILL SHALL BE PLACED IN 6" LAYERS WITH A MINIMUM OF 10% MOISTURE.
3. FILL SHALL BE PLACED IN 6" LAYERS WITH A MINIMUM OF 10% MOISTURE.
4. FILL SHALL BE PLACED IN 6" LAYERS WITH A MINIMUM OF 10% MOISTURE.


SILT FENCE

LOT 5 SILT FENCE IS TO BE STAKED AT 3 TO 5 FOOT INTERVALS.

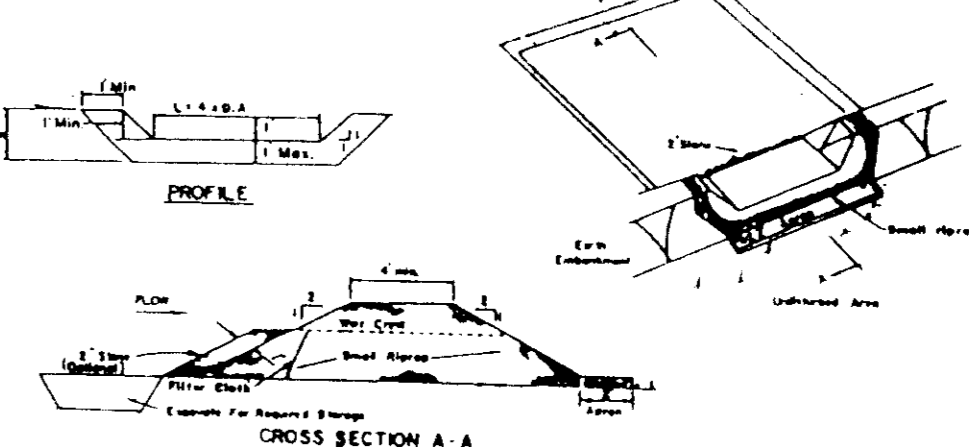

1. Area under embankment shall be cleared of brush and other woody vegetation as well as overland streams, rocks, debris material or other obstructions. The embankment shall be completed by traversing with equipment while it is being constructed.
2. All cut and fill slopes shall be 3:1 or flatter.
3. The area used in the embankment shall be small slopes 4:1 along with a 1" minimum of 2" aggregate stone on the top surface of the embankment.
4. Retention shall be removed and trap returned to its original condition when the retention has accumulated to 2/3 the design height.
5. The structure shall be inspected after each rain and repairs made as needed.
6. Construction operations shall be carried out in such a manner that erosion and water pollution is minimized.
7. The structure shall be removed and the area stabilized when the design area has been properly stabilized.


STONE OUTLET SEDIMENT TRAP DETAIL

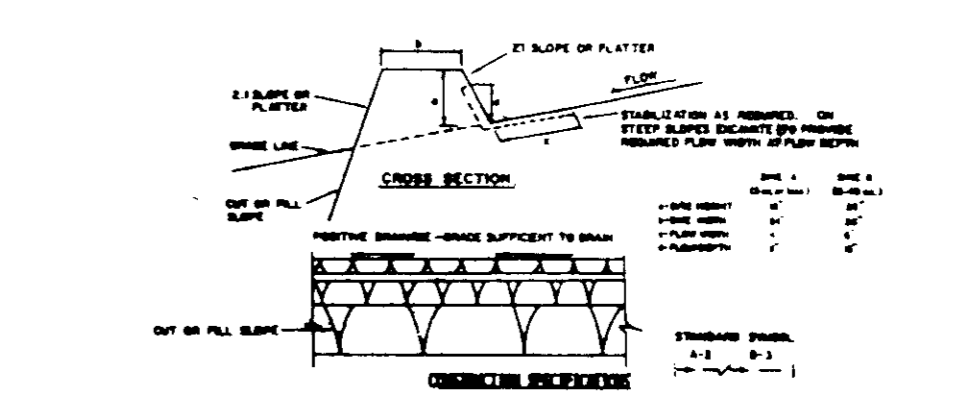

1. Stone shall be 3/4" diameter or larger and shall be placed in layers to facilitate filling and shall be replaced as it is washed out.
2. Stone shall be 3/4" diameter or larger and shall be placed in layers to facilitate filling and shall be replaced as it is washed out.
3. Stone shall be 3/4" diameter or larger and shall be placed in layers to facilitate filling and shall be replaced as it is washed out.
4. Stone shall be 3/4" diameter or larger and shall be placed in layers to facilitate filling and shall be replaced as it is washed out.
5. Stone shall be 3/4" diameter or larger and shall be placed in layers to facilitate filling and shall be replaced as it is washed out.
6. Stone shall be 3/4" diameter or larger and shall be placed in layers to facilitate filling and shall be replaced as it is washed out.

EARTH DIKE

NOT TO SCALE

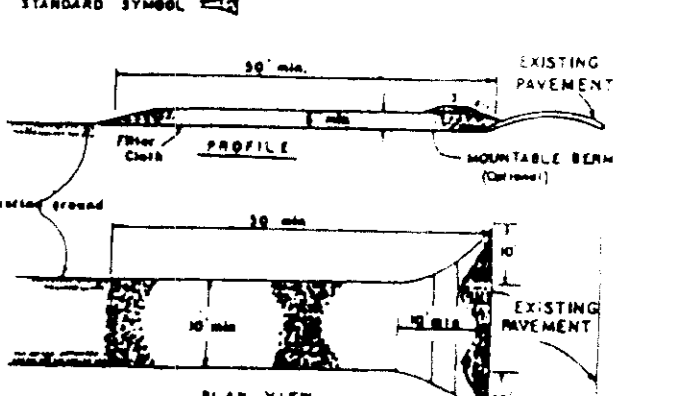

1. Stone shall be 3/4" diameter or larger and shall be placed in layers to facilitate filling and shall be replaced as it is washed out.
2. Stone shall be 3/4" diameter or larger and shall be placed in layers to facilitate filling and shall be replaced as it is washed out.
3. Stone shall be 3/4" diameter or larger and shall be placed in layers to facilitate filling and shall be replaced as it is washed out.
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5. Stone shall be 3/4" diameter or larger and shall be placed in layers to facilitate filling and shall be replaced as it is washed out.
6. Stone shall be 3/4" diameter or larger and shall be placed in layers to facilitate filling and shall be replaced as it is washed out.

STABILIZED CONSTRUCTION ENTRANCE

NOT TO SCALE

**STONE OUTLET SEDIMENT TRAP**  
 DRAINAGE AREA: 1.1  
 STORAGE REQ.: 73 CY  
 STORAGE PROVIDED: 74 CY  
 TOP EMBANKMENT ELEV.: 406.0  
 WEIR CREST ELEV.: 405.5  
 WEIR LENGTH: 10'  
 BOTTOM ELEV.: 402.5  
 DEPTH: 3.0'  
 CLEANOUT ELEV.: 404.0  
 SIDE SLOPES: 1:1

MATCH LINE SEE SHEET No. 2

**OWNER / DEVELOPER**  
 MR. RICHARD J. DEMMITT  
 56 HIGHLAND DEVELOPMENT CORP.  
 P.O. BOX 208  
 CLARKSVILLE, MARYLAND 21024

MR. DONALD R. REUWER, JR.  
 5% LAND DESIGN AND DEVELOPMENT INC.  
 10805 HICKORY RIDGE ROAD  
 COLUMBIA, MARYLAND 21044

**FISHER, COLLINS & CARTER, INC.**  
 CIVIL ENGINEERING CONSULTANTS & LAND SURVEYORS  
 971 BALTIMORE NATIONAL PKWY. SUITE 100  
 ELLICOTT CITY, MARYLAND 21042  
 (410) 461-2855

**ENGINEER'S CERTIFICATE**  
 I HEREBY CERTIFY THAT THIS PLAN FOR EROSION AND SEDIMENT CONTROL REPRESENTS A PRACTICAL AND WORKABLE PLAN BASED ON MY PERSONAL KNOWLEDGE OF THE SITE CONDITIONS AND THAT IT WAS PREPARED IN ACCORDANCE WITH THE REQUIREMENTS OF THE HOWARD SOIL CONSERVATION DISTRICT.

Signature: [Signature]  
 DATE: 11/19

**DEVELOPER'S CERTIFICATE**  
 I/WE CERTIFY THAT ALL DEVELOPMENT AND CONSTRUCTION WILL BE DONE ACCORDING TO THIS PLAN OF DEVELOPMENT AND PLAN FOR EROSION AND SEDIMENT CONTROL AND THAT ALL RESPONSIBLE PERSONNEL INVOLVED IN THE CONSTRUCTION PROJECT WILL HAVE A CERTIFICATE OF ATTENDANCE AT A DEPARTMENT OF THE ENVIRONMENT APPROVED TRAINING PROGRAM FOR THE CONTROL OF SEDIMENT AND EROSION BEFORE BEGINNING THE PROJECT. I ALSO AUTHORIZE PERIODIC ON-SITE INSPECTION BY THE HOWARD SOIL CONSERVATION DISTRICT OR THEIR AUTHORIZED AGENTS, AS ARE DEEMED NECESSARY.

Signature: [Signature]  
 DATE: 11/11

REVIEWED FOR HOWARD SOIL CONSERVATION DISTRICT AND METS TECHNICAL REQUIREMENTS.  
 Signature: [Signature]  
 DATE: 2/1/95

THIS DEVELOPMENT IS APPROVED FOR EROSION AND SEDIMENT CONTROL BY THE HOWARD SOIL CONSERVATION DISTRICT.  
 Signature: [Signature]  
 DATE: 2/1/95

APPROVED: DEPT. OF PLANNING AND ZONING  
 Signature: [Signature]  
 DATE: 3/8/95

Signature: [Signature]  
 DATE: 3/7/95

APPROVED: HOWARD COUNTY HEALTH DEPARTMENT FOR PUBLIC WATER AND SEWERAGE SYSTEMS  
 Signature: [Signature]  
 DATE: 3/3/95

APPROVED: DEPARTMENT OF PUBLIC WORKS FOR PUBLIC WATER & SEWER AND STORM DRAINAGE SYSTEMS AND ROADS.  
 Signature: [Signature]  
 DATE: 2/22/95

Signature: [Signature]  
 DATE: 2/22/95

PROPERTY/SUBDIVISION: ST. JOHNS STATION  
 SECTION/AREA: 37  
 PARCEL: 37

TAX MAP 24 LIBER 2015, FOLIO 562  
 PARCEL 39  
 SCALE: 1" = 30'



DATE: SEPTEMBER, 1994  
 SHEET NO. 4 OF 23  
 SDP 94-79

**SEDIMENT/EROSION CONTROL PLAN**  
**ST. JOHNS STATION**

UPTON ROAD

ST. JOHNS LANE

SCHEDULE A PERIMETER LANDSCAPE EDGE										
PERIMETER	A	B	C	D	E	F	G	H	I	
CATEGORY	Adjacent to Roadways	Adjacent to Perimeter Properties	Adjacent to Perimeter Properties	Adjacent to Residential Properties	Adjacent to Residential Properties	Adjacent to Residential Properties	Adjacent to Residential Properties	Adjacent to Residential Properties	Adjacent to Residential Properties	Adjacent to Residential Properties
LANDSCAPE TYPE	E	B	B	C	C	C	C	C	C	A
LINEAR FEET OF PERIMETER	146	134	35.63'	46.51'	150'	166'	60'	50'	182'	333'
CREDIT FOR EXISTING VEGETATION (YES, NO, LINEAR FEET)	-	-	-	-	-	-	-	-	-	-
CREDIT FOR WALL, FENCE OR BERM (YES, NO, LINEAR FEET)	-	-	-	-	-	-	-	-	-	-
NUMBER OF PLANTS REQUIRED	3	2	1	1	3	4	1	1	4	8
SHADE TREES	3	2	1	1	3	4	1	1	4	8
EVERGREEN TREES	36	3	1	1	7	8	3	2	1	5
SHRUBS	36	3	1	1	7	8	3	2	1	5
NUMBER OF PLANTS PROVIDED	3	2	1	1	3	4	1	1	4	8
SHADE TREES	3	2	1	1	3	4	1	1	4	8
EVERGREEN TREES	36	3	1	1	7	8	3	2	1	5
OTHER TREES (2:1 SUBSTITUTION)	36	3	1	1	7	8	3	2	1	5
SHRUBS (2:1 SUBSTITUTION)	36	3	1	1	7	8	3	2	1	5
DESCRIBE PLANT SUBSTITUTION CREDITS BELOW IF NEEDED	-	-	-	-	-	-	-	-	-	-

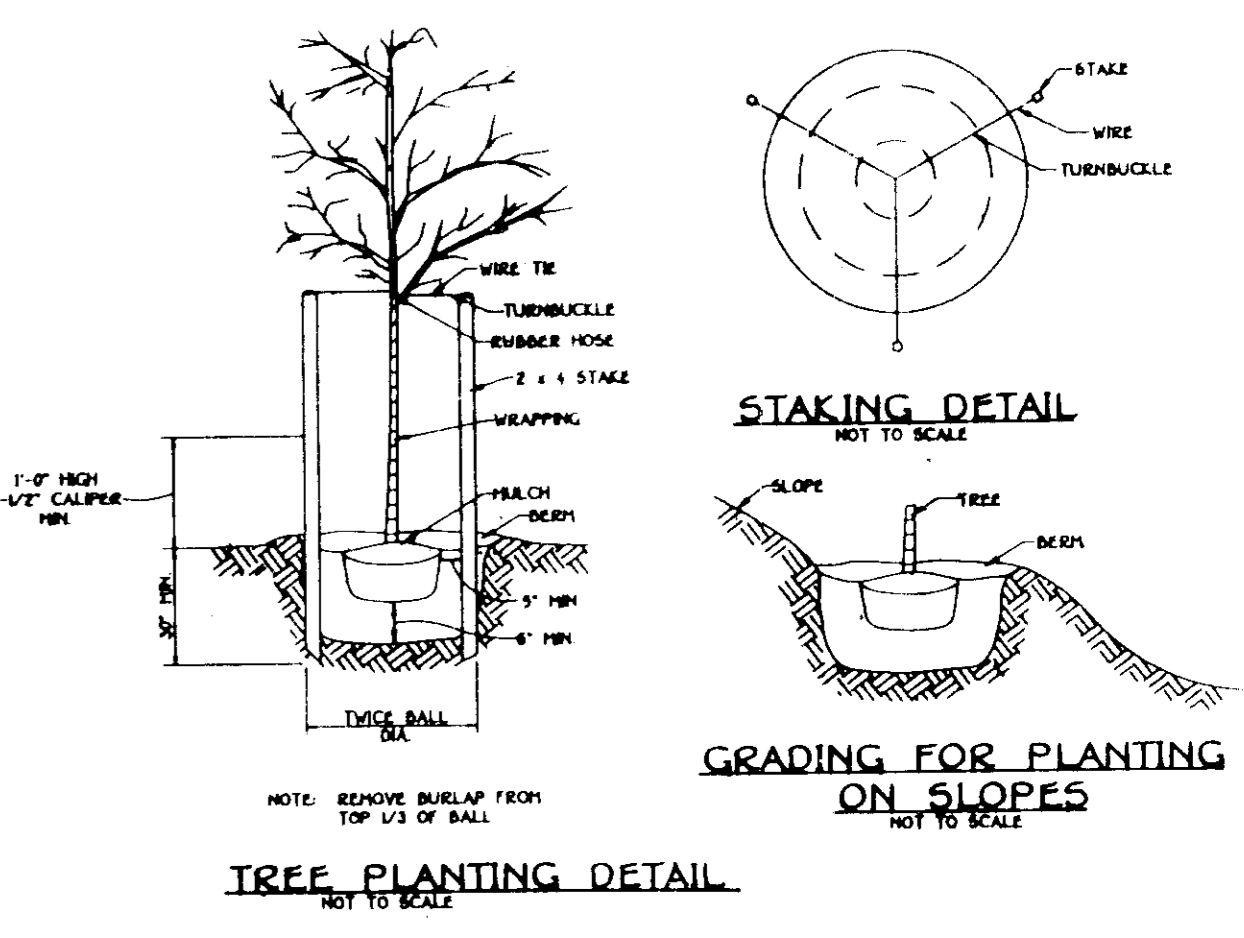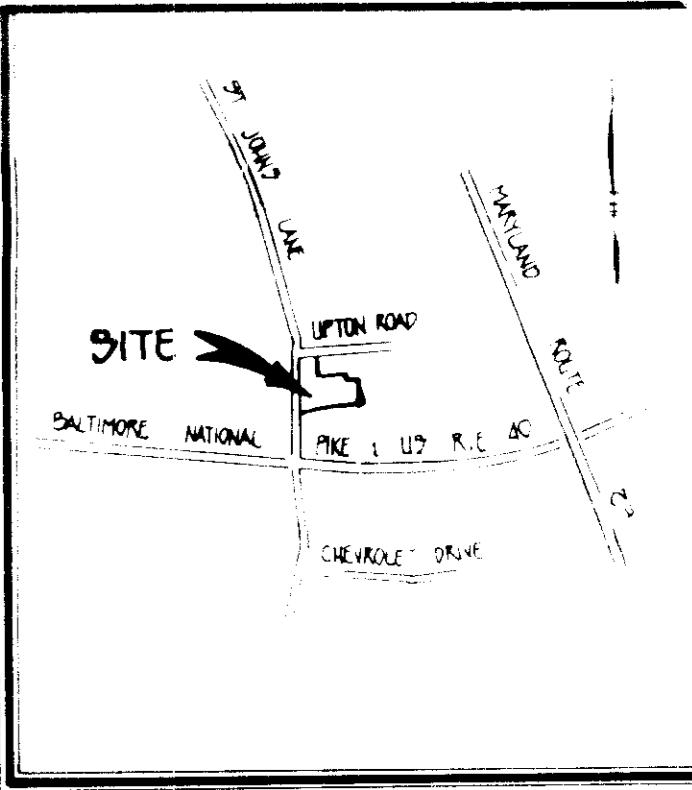

NOTE: Hatched area DENOTES EXISTING STEEP SLOPES 25% AND GREATER

SCHEDULE B PARKING LOT INTERNAL LANDSCAPING	
Number of Parking Spaces	63
Number of Trees Required	1:20 3
Number of Trees Provided	3
Shade Trees	—
Other Trees (2:1 substitution)	—

LANDSCAPE LEGEND			
SYMBOL	QUANTITY	BOTANICAL / COMMON NAME	SIZE
⊙	25	QUERCUS TRIACANTHOS INERMIS IMPERIAL / IMPERIAL THORNLESS HONEYLOCUST	2 1/2" - 5" CAL
⊗	36	PINUS STROBUS EASTERN WHITE PINE	6" - 8" HT
○	36	QUONIAMUS ALATUS COMPACTA / DWARF WING QUONIAMUS	2" - 2 1/2" HT

DEVELOPER'S/BUILDER'S CERTIFICATE

I/WE CERTIFY THAT THE LANDSCAPING SHOWN ON THIS PLAN WILL BE DONE ACCORDING TO THE PLAN, SECTION 16.124 OF THE HOWARD COUNTY CODE AND THE HOWARD COUNTY LANDSCAPE MANUAL. I/WE FURTHER CERTIFY THAT UPON COMPLETION A CERTIFICATION OF LANDSCAPE INSTALLATION ACCOMPANIED BY AN EXECUTED ONE YEAR GUARANTEE OF PLANT MATERIALS WILL BE SUBMITTED TO THE DEPARTMENT OF PLANNING AND ZONING.

SIGNATURE \_\_\_\_\_ DATE \_\_\_\_\_

OWNER/DEVELOPER  
MR. DONALD R. REUWER, JR.  
% LAND DESIGN AND DEVELOPMENT INC.  
10005 HICKORY RIDGE ROAD  
COLUMBIA, MARYLAND 21044

OWNER/DEVELOPER  
MR. RICHARD J. DEMMITT  
% HIGHLAND DEVELOPMENT CORP.  
P.O. BOX 206  
CLARKSVILLE, MARYLAND 21029

FINANCIAL SURETY FOR THE REQUIRED LANDSCAPING HAS BEEN POSTED AS PART OF THE DPW DEVELOPER'S AGREEMENT IN THE AMOUNT OF \$ 6100.00.

ORVILLE MELLOW  
L 140, P 441

NOTE: THIS PLAN HAS BEEN PREPARED IN ACCORDANCE WITH THE PROVISIONS OF SECTION 16.124 OF THE HOWARD COUNTY CODE AND THE LANDSCAPE MANUAL.

FISHER, COLLINS & CARTER, INC.  
CIVIL ENGINEERING CONSULTANTS & LAND SURVEYORS  
971 BALTIMORE NATIONAL PIKE, SUITE 100  
ELLCOTT CITY, MARYLAND 21042  
(410) 461-2255

ENGINEER'S CERTIFICATE  
I HEREBY CERTIFY THAT THIS PLAN FOR EROSION AND SEDIMENT CONTROL REPRESENTS A PRACTICAL AND WORKABLE PLAN BASED ON MY PERSONAL KNOWLEDGE OF THE SITE CONDITIONS AND THAT IT WAS PREPARED IN ACCORDANCE WITH THE REQUIREMENTS OF THE HOWARD SOIL CONSERVATION DISTRICT.  
SIGNATURE OF ENGINEER: [Signature] DATE: 11/1/99


DEVELOPER'S CERTIFICATE  
I/WE CERTIFY THAT ALL DEVELOPMENT AND CONSTRUCTION WILL BE DONE ACCORDING TO THIS PLAN OF DEVELOPMENT AND PLAN FOR EROSION AND SEDIMENT CONTROL AND THAT ALL RESPONSIBLE PERSONNEL INVOLVED IN THE CONSTRUCTION PROJECT WILL HAVE A CERTIFICATE OF ATTENDANCE AT A DEPARTMENT OF THE ENVIRONMENT APPROVED TRAINING PROGRAM FOR THE CONTROL OF SEDIMENT AND EROSION BEFORE BEGINNING THE PROJECT. I ALSO AUTHORIZE PERIODIC ON-SITE INSPECTION BY THE HOWARD SOIL CONSERVATION DISTRICT OR THEIR AUTHORIZED AGENTS, AS ARE DEEMED NECESSARY.  
SIGNATURE OF DEVELOPER: [Signature] DATE: 11/1/99

REVIEWED FOR HOWARD SOIL CONSERVATION DISTRICT AND MEETS TECHNICAL REQUIREMENTS  
[Signature] DATE: 2/1/95  
SOIL CONSERVATION SERVICE  
THIS DEVELOPMENT IS APPROVED FOR EROSION AND SEDIMENT CONTROL BY THE HOWARD SOIL CONSERVATION DISTRICT  
[Signature] DATE: 2/1/95  
DISTRICT  
HOWARD SOIL CONSERVATION DISTRICT


APPROVED: DEPT. OF PLANNING AND ZONING  
[Signature] DATE: 2/8/95  
PLANNING DIRECTOR  
[Signature] DATE: 3/7/95  
CHIEF, DIVISION OF LAND DEVELOPMENT AND SEARCH  
APPROVED: HOWARD COUNTY HEALTH DEPARTMENT FOR PUBLIC WATER AND SEWERAGE SYSTEMS  
[Signature] DATE: 3/3/95  
HEALTH OFFICER

APPROVED: DEPARTMENT OF PUBLIC WORKS FOR PUBLIC WATER & SEWER AND STORM DRAINAGE SYSTEMS AND ROADS  
[Signature] DATE: 2/22/95  
DIRECTOR, PUBLIC WORKS  
[Signature] DATE: 2/22/95  
CHIEF, BUREAU OF ENGINEERING  
PROPERTY/SUBDIVISION: ST. JOHNS STATION  
SECTION/AREA: 39  
PARCEL: 39  
TAX MAP 24 LIBER 2015, FOLIO 52C PARCEL 39  
2015/52C BLOCK NO. 5 ZONE D-1 TAX/ZONE 24 ELEC. DIST. 2 MD CENSUS TR. 0022  
WATER CODE P.02 SEWER CODE 1403700


LANDSCAPE PLAN  
ST. JOHNS STATION  
TAX MAP 24 LIBER 2015, FOLIO 52C PARCEL 39  
2015/52C BLOCK NO. 5 ZONE D-1 TAX/ZONE 24 ELEC. DIST. 2 MD CENSUS TR. 0022  
DATE: DECEMBER 1, 1994  
SHEET NO. 5 OF 8  
ZDP 94-79

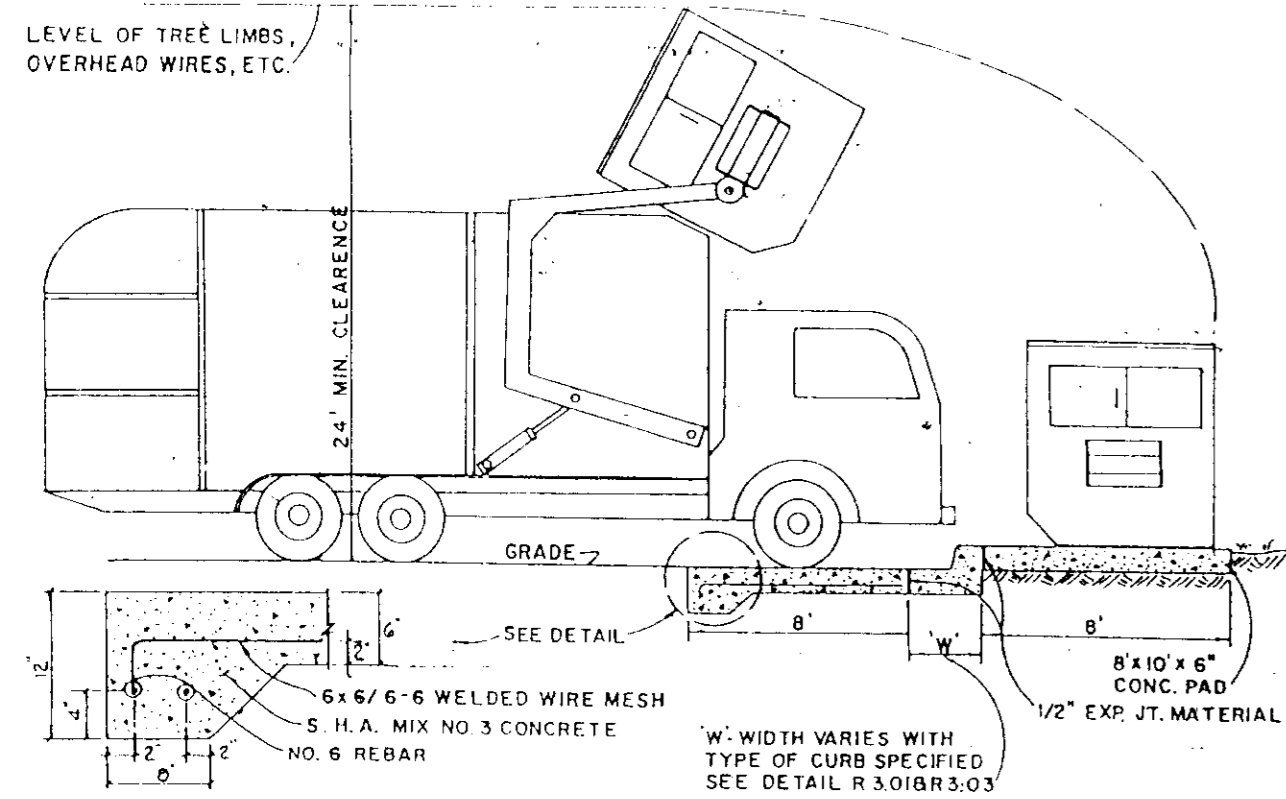

**SOLID WASTE SERVICE PAD**  
NOT TO SCALE

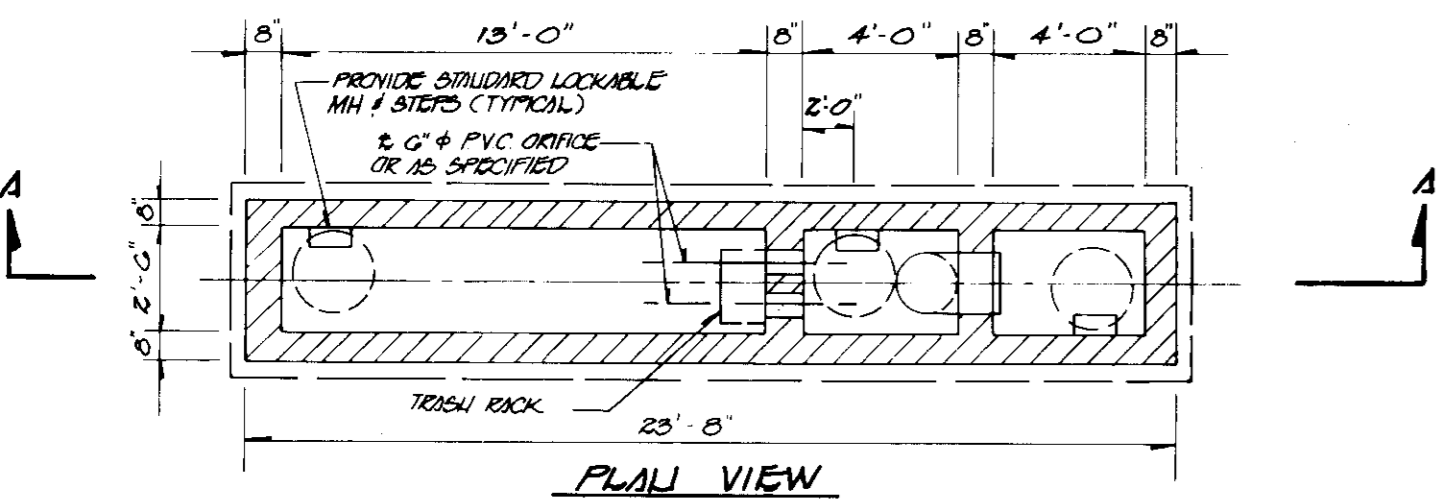

**PLAN VIEW**

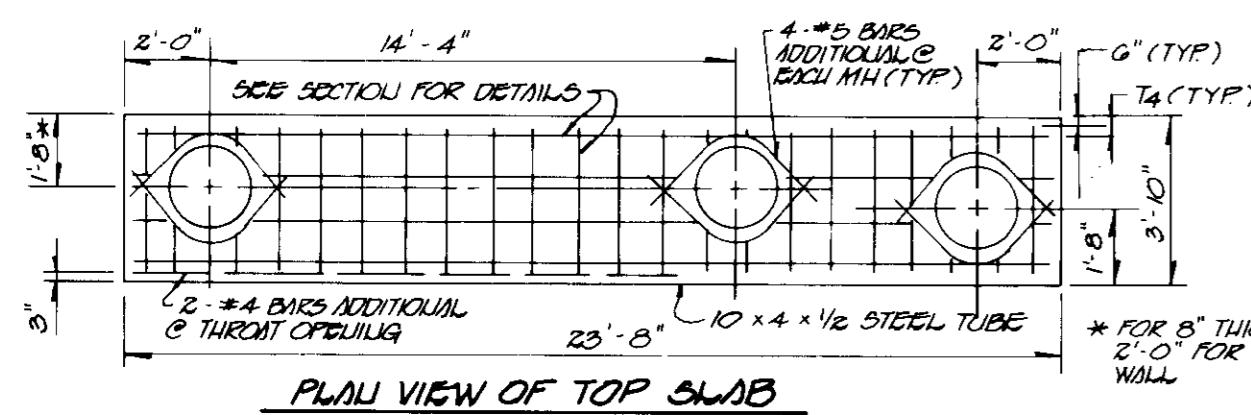


**PLAN VIEW OF TOP SLAB**

BASE SLAB	PARTITION WALLS		TOP SLAB		OUTER WALLS	
1/16	1/8	1/4	1/2	3/4	1	1 1/2
0"	#5 @ 7"	#4 @ 12"	#4 @ 6"	#4 @ 6"	#4 @ 6"	#4 @ 6"

CURT IN PLACE CONCRETE F-14000 @ 1 @ 28 DAYS. REINFORCING STEEL IN ACCORDANCE WITH ASTM A630 GRADE 60  
NOTE: FOR SECTION AND DETAILS REFER TO 50170 & 50170B


MADE ONE LAYER OF POLYURETHANE PREPARED. PLACE THE REBAR AT THE CENTER OF WALL.

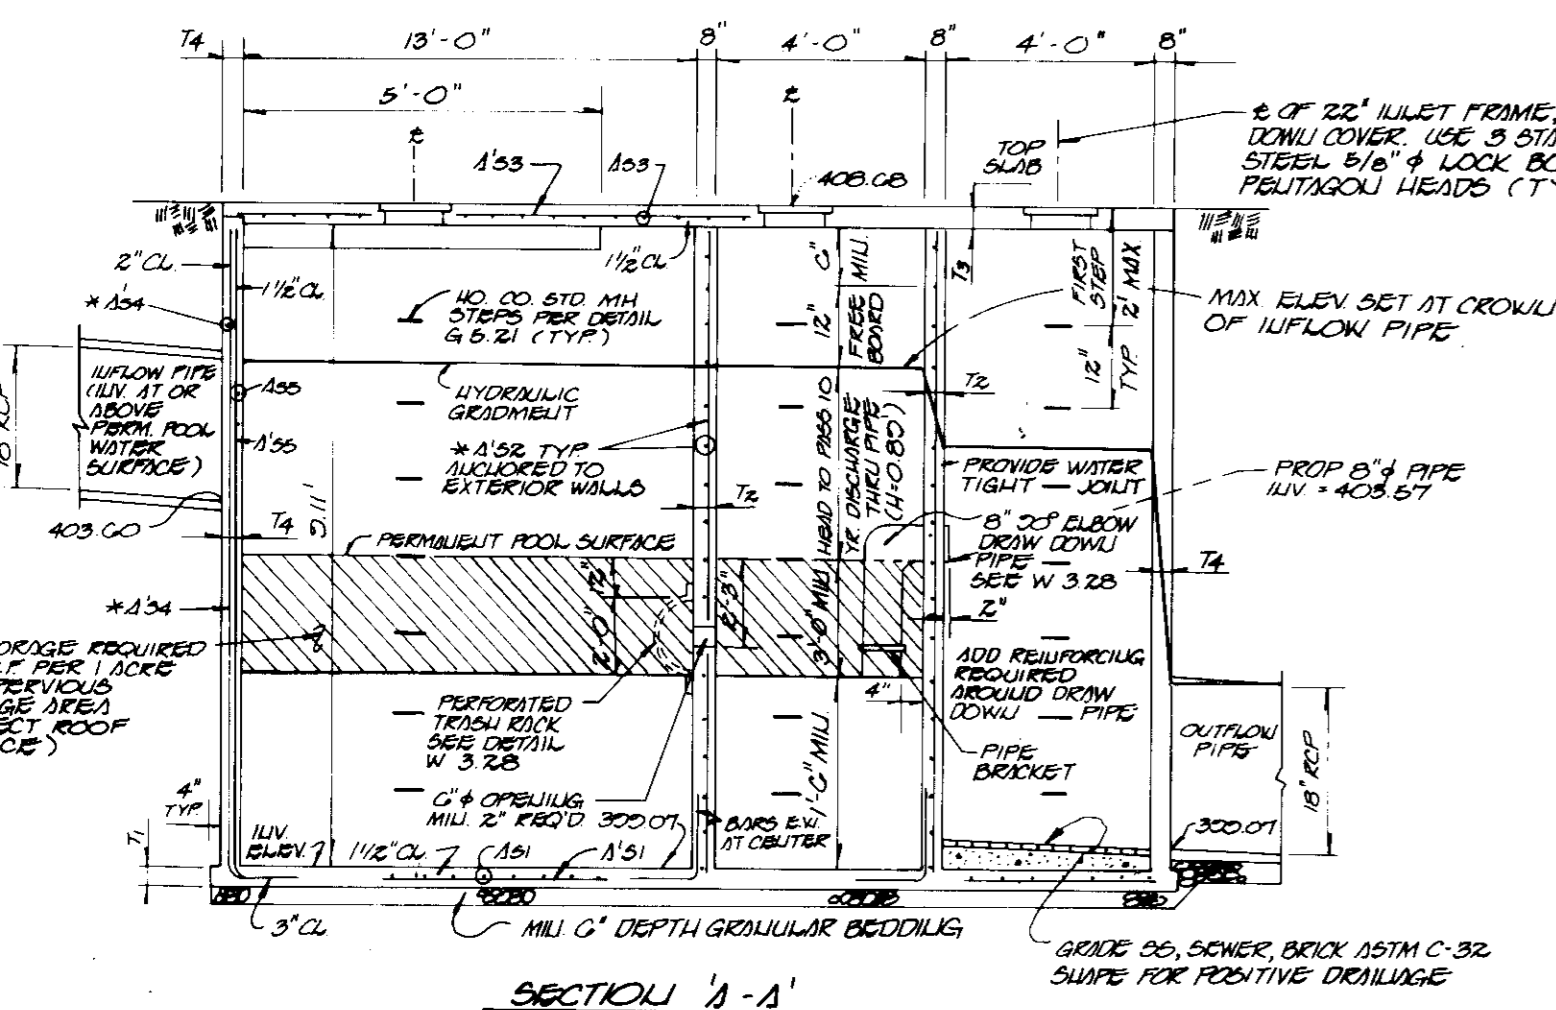



**SECTION A-A**  
**WATER QUALITY INLET**  
NOT TO SCALE

NOTE: THIS DETAIL IS SITE SPECIFIC FOR MINIMUM STANDARD. SEE HOWARD DESIGN MANUAL VOL. IV, WATER QUALITY INLET (P. 3D & 4E)

**DRAW DOWN PIPE**  
NOT TO SCALE

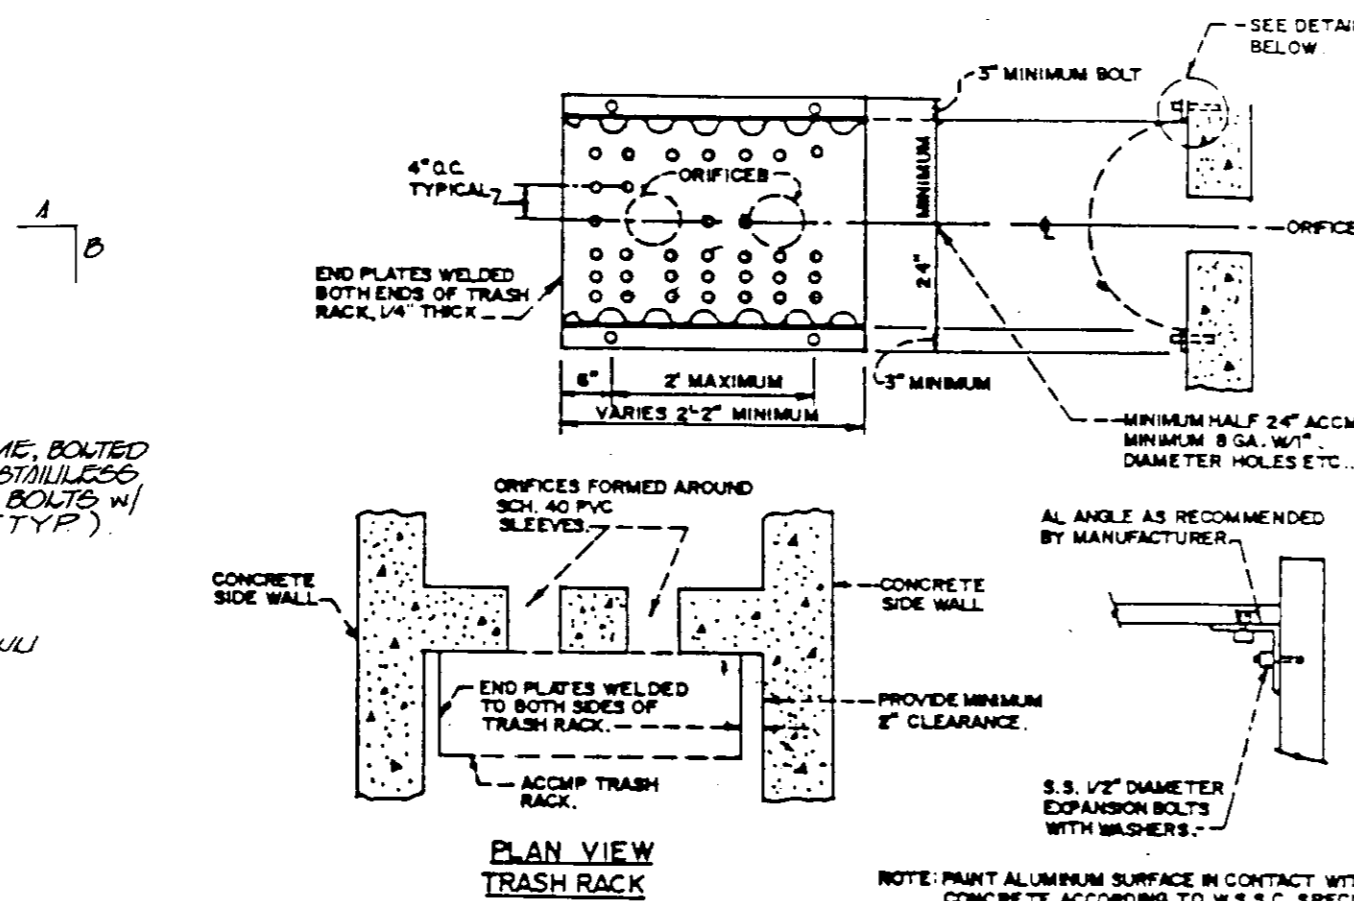

**PLAN VIEW TRASH RACK**

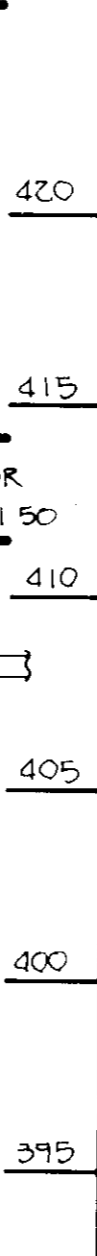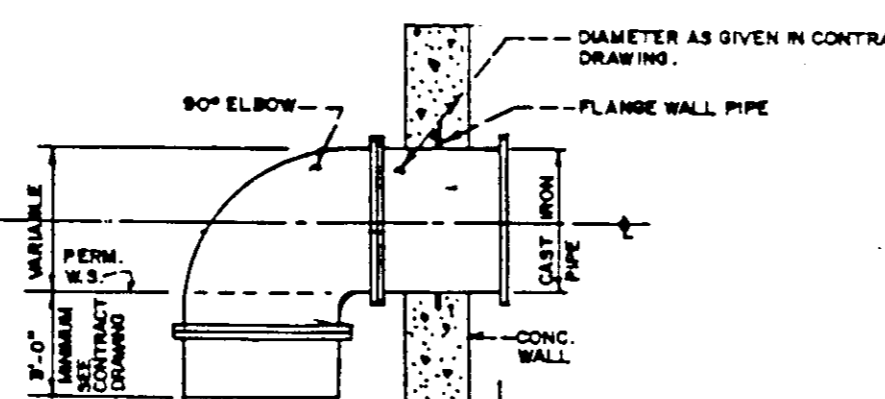

**PROFILE**  
SCALE: 1"=20' HORIZ.  
1"=5' VERT.


**PRIVATE 4 INCH WATER CONNECTION**

PAVEMENT MATERIALS	
FULL DEPTH BIT. CONC. ALTERNATE	GRANULAR BASE ALTERNATES
1 1/2" BIT. CONC. SURFACE	1 1/2" BIT. CONC. SURFACE
1 1/2" BIT. CONC. BASE	4 1/2" BIT. CONC. BASE
5" BIT. CONC. BASE	5" GRADED AGGREGATE BASE (GAB)


**P-3 PAVING SECTION DETAIL**  
NOT TO SCALE



**RESERVED HANDICAPPED PARKING SIGN DETAIL**  
NOT TO SCALE

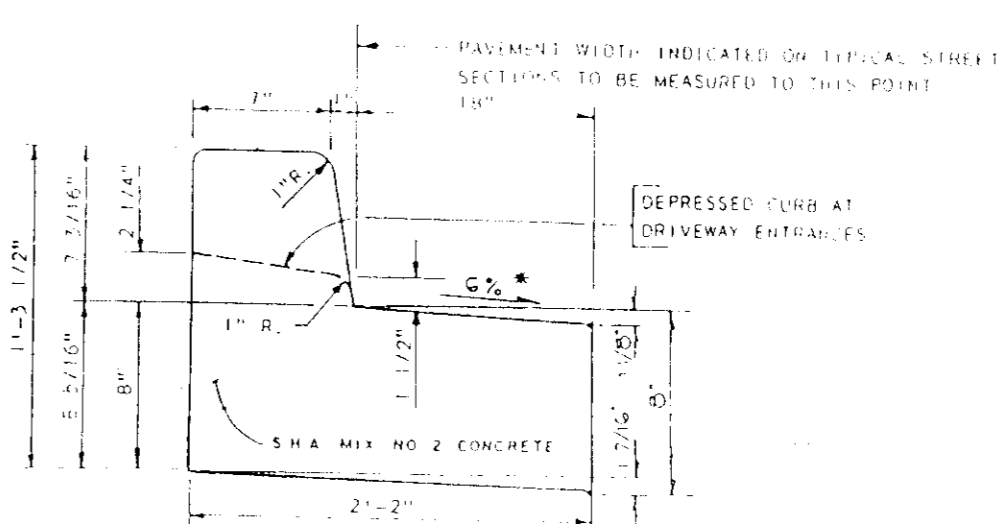


**STANDARD COMBINATION CURB & GUTTER w/ REVERSE SLOPE DETAIL**  
NOT TO SCALE

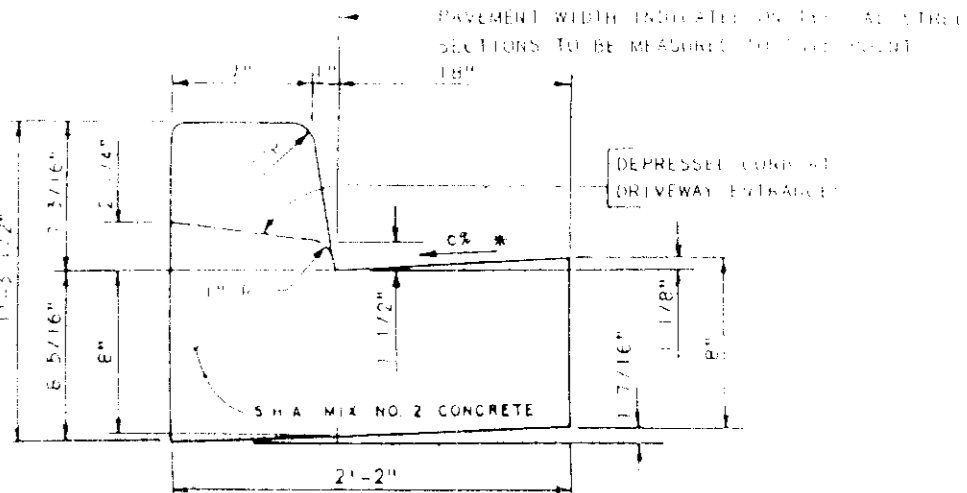


**STANDARD COMBINATION CURB & GUTTER**  
NOT TO SCALE

NOTES:  
1. LONGITUDINAL JOINT BETWEEN SIDEWALK AND CURB SHALL BE CONTINUOUS AND TO A DEPTH OF 1/4" THE SIDEWALK THICKNESS OR 1" MAX. LATTITUDINAL JOINTS SHALL RUN FROM BACK SIDE OF SIDEWALK CONTINUOUS TO THE BOTTOM FACE OF CURB TO A DEPTH OF 1/4" AND SPACED 5' APART.  
2. PROVIDE UP EXPANSION JOINTS AT 15' INTERVALS. IN LATTITUDINAL JOINTS TO FULL CROSS SECTION.

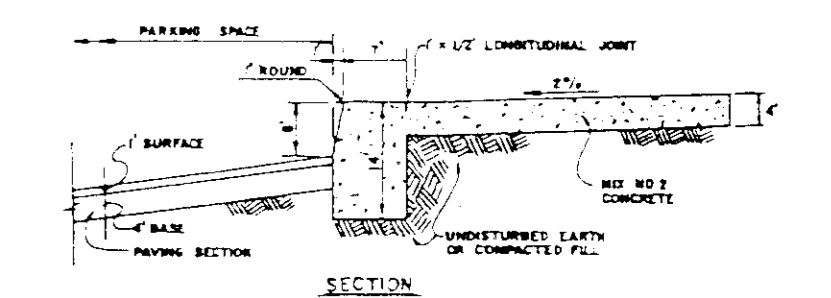

**ALTERNATE SECTION**

**MONOLITHIC CURB/SIDEWALK DETAIL**  
NOT TO SCALE

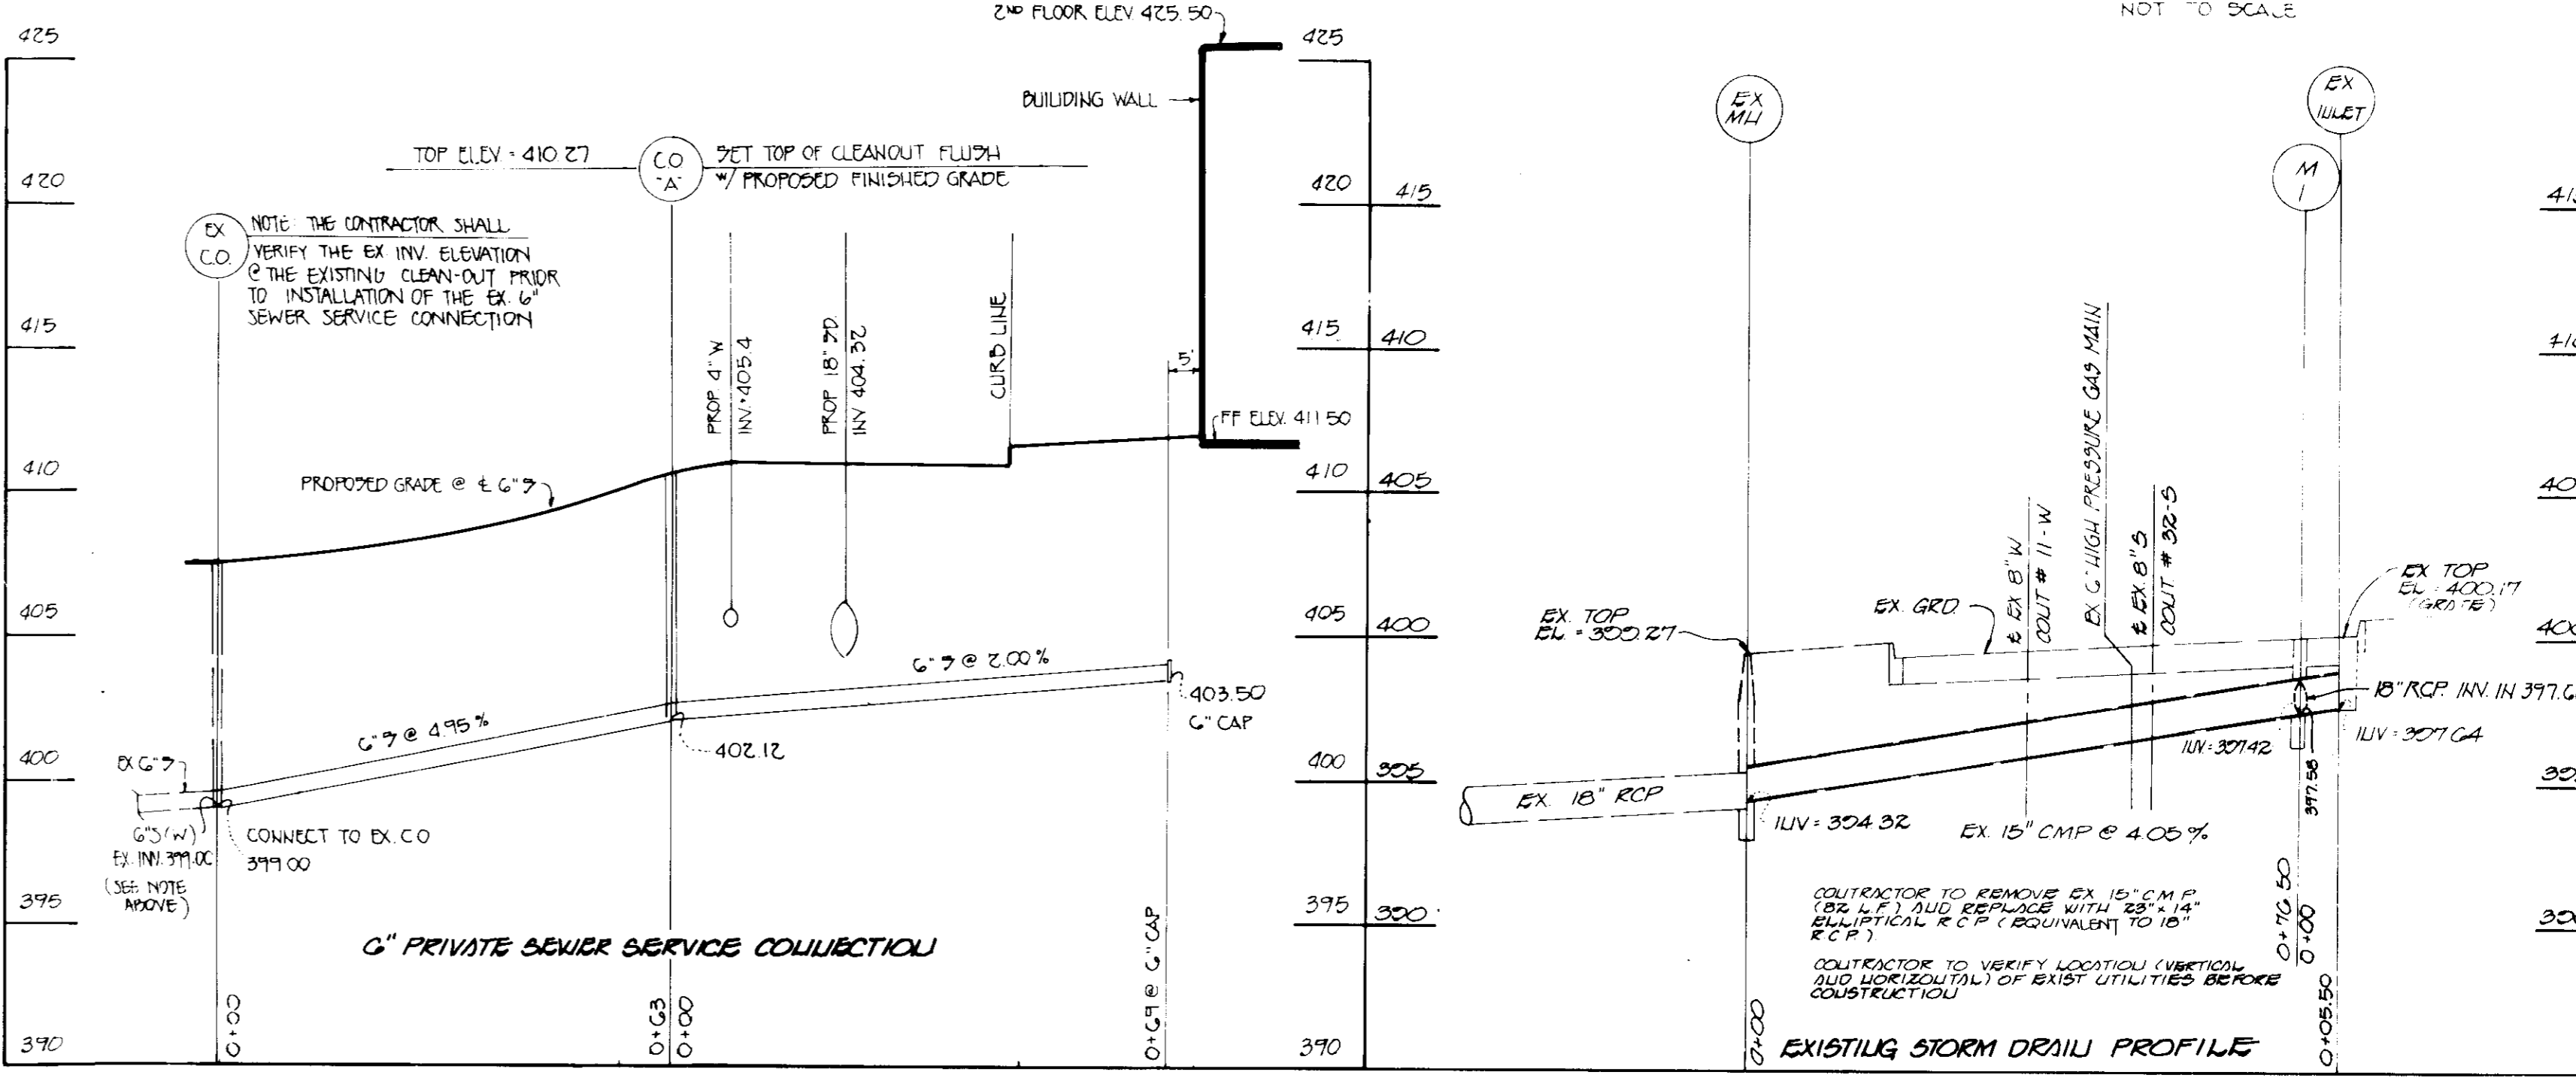

**PROFILES**  
SCALE: HOR: 1"=20'  
VER: 1"=5'

**FISHER, COLLINS & CARTER, INC.**  
CIVIL ENGINEERING CONSULTANTS & LAND SURVEYORS  
977 BALTIMORE NATIONAL PIKE, SUITE 100  
ELICOTT CITY, MARYLAND 21042  
(410) 461-2855

ENGINEER'S CERTIFICATE  
I HEREBY CERTIFY THAT THIS PLAN FOR EROSION AND SEDIMENT CONTROL REPRESENTS A PRACTICAL AND WORKABLE PLAN BASED ON MY PERSONAL KNOWLEDGE OF THE SITE CONDITIONS AND THAT IT WAS PREPARED IN ACCORDANCE WITH THE REQUIREMENTS OF THE HOWARD SOIL CONSERVATION DISTRICT.  
SIGNATURE OF ENGINEER: [Signature] DATE: 11/1/95


DEVELOPER'S CERTIFICATE  
I/WE CERTIFY THAT ALL DEVELOPMENT AND CONSTRUCTION WILL BE DONE ACCORDING TO THIS PLAN OF DEVELOPMENT AND PLAN FOR EROSION AND SEDIMENT CONTROL, AND THAT ALL RESPONSIBLE PERSONNEL INVOLVED IN THE CONSTRUCTION PROJECT WILL HAVE A CERTIFICATE OF ATTENDANCE AT A DEPARTMENT OF THE ENVIRONMENT APPROVED TRAINING PROGRAM FOR THE CONTROL OF SEDIMENT AND EROSION BEFORE BEGINNING THE PROJECT. I ALSO AUTHORIZE PERIODIC ON-SITE INSPECTION BY THE HOWARD SOIL CONSERVATION DISTRICT OR THEIR AUTHORIZED AGENTS, AS ARE DEEMED NECESSARY.  
SIGNATURE OF DEVELOPER: [Signature] DATE: 11/1/95

REVIEWED FOR HOWARD SOIL CONSERVATION DISTRICT AND METS TECHNICAL REQUIREMENTS  
[Signature] DATE: 11/1/95  
THIS DEVELOPMENT IS APPROVED FOR EROSION AND SEDIMENT CONTROL BY THE HOWARD SOIL CONSERVATION DISTRICT.  
APPROVED: [Signature] DATE: 2/11/95  
HOWARD SOIL CONSERVATION DISTRICT


APPROVED: DEPT. OF PLANNING AND ZONING  
[Signature] DATE: 3/8/95  
PLANNING DIRECTOR  
[Signature] DATE: 3/7/95  
CHIEF, DIVISION OF LAND DEVELOPMENT AND RESEARCH  
APPROVED: HOWARD COUNTY HEALTH DEPARTMENT FOR PUBLIC WATER AND SEWERAGE SYSTEMS  
[Signature] DATE: 3/3/95  
HEALTH OFFICER

APPROVED: DEPARTMENT OF PUBLIC WORKS FOR PUBLIC WATER & SEWER AND STORM DRAINAGE SYSTEMS AND ROADS.  
[Signature] DATE: 2/22/95  
DIRECTOR, PUBLIC WORKS  
[Signature] DATE: 2/22/95  
CHIEF, BUREAU OF ENGINEERING  
PROPERTY/SUBDIVISION: ST. JOHNS STATION SECTION/AREA: PARCEL 39  
PART NO./L.F. BLOCK NO. ZONE TAX/ZONE ELEC. DIST. CENSUS TR.  
2015/52G 5 0-1 24 2 NO 0022  
WATER CODE: F-FOG SEWER CODE: 1403700


DETAIL SHEET  
**ST. JOHNS STATION**  
TAX MAP 24 LIBER 2015, FOLIO 52G PARCEL 39  
2ND ELECTION DIST HOWARD COUNTY, MARYLAND  
SCALE: AS SHOWN DATE: SEPTEMBER, 1974  
SHEET NO. 6 OF 8

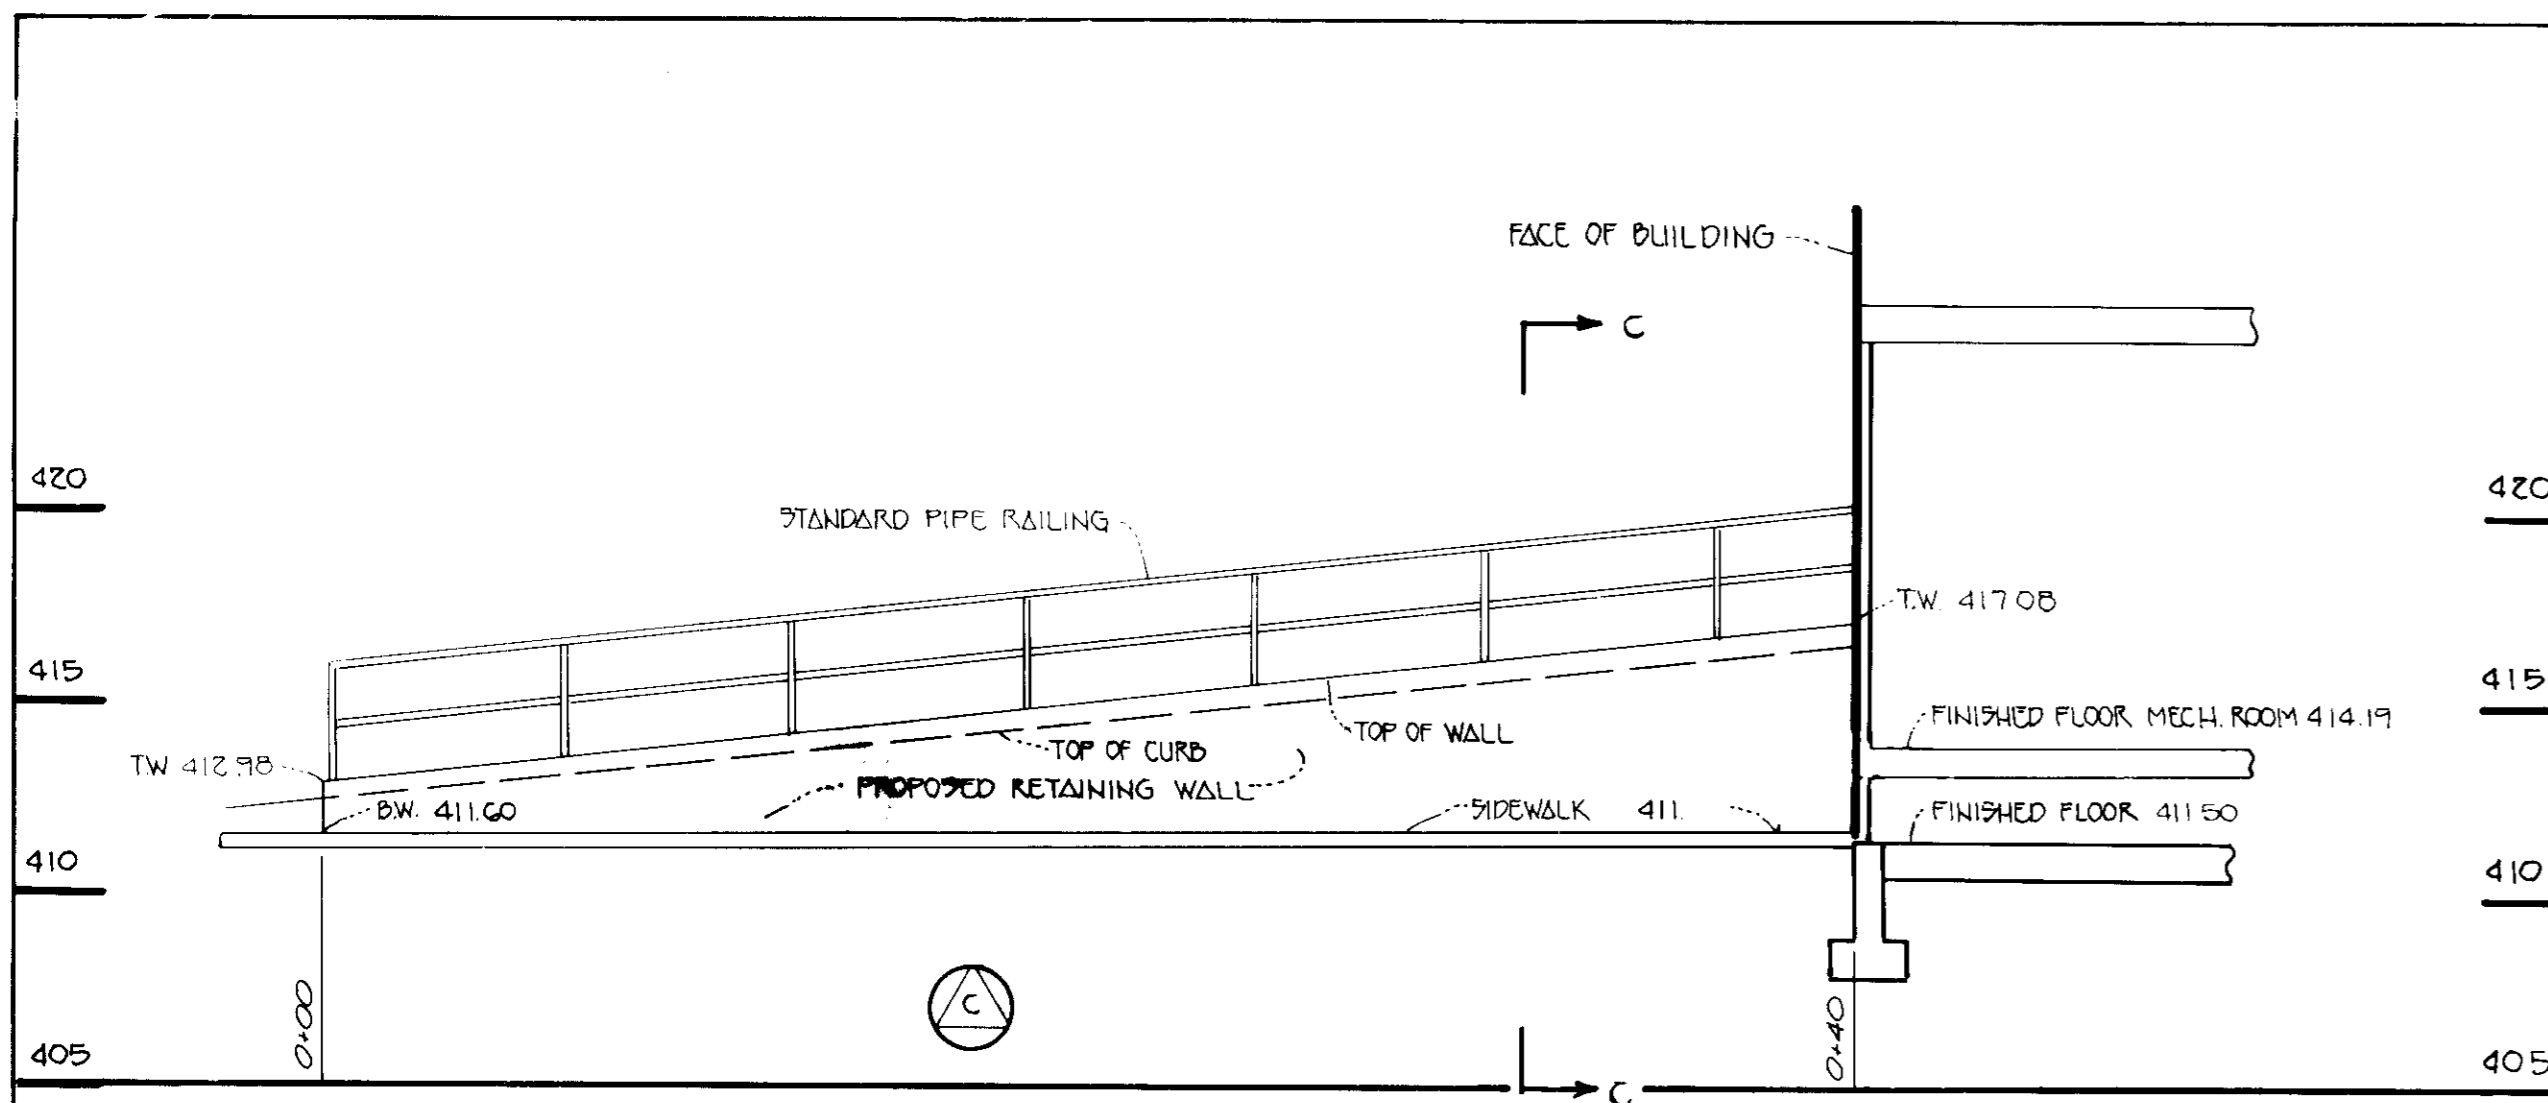


SCALE: HOR 1"=5'  
VER 1"=5'

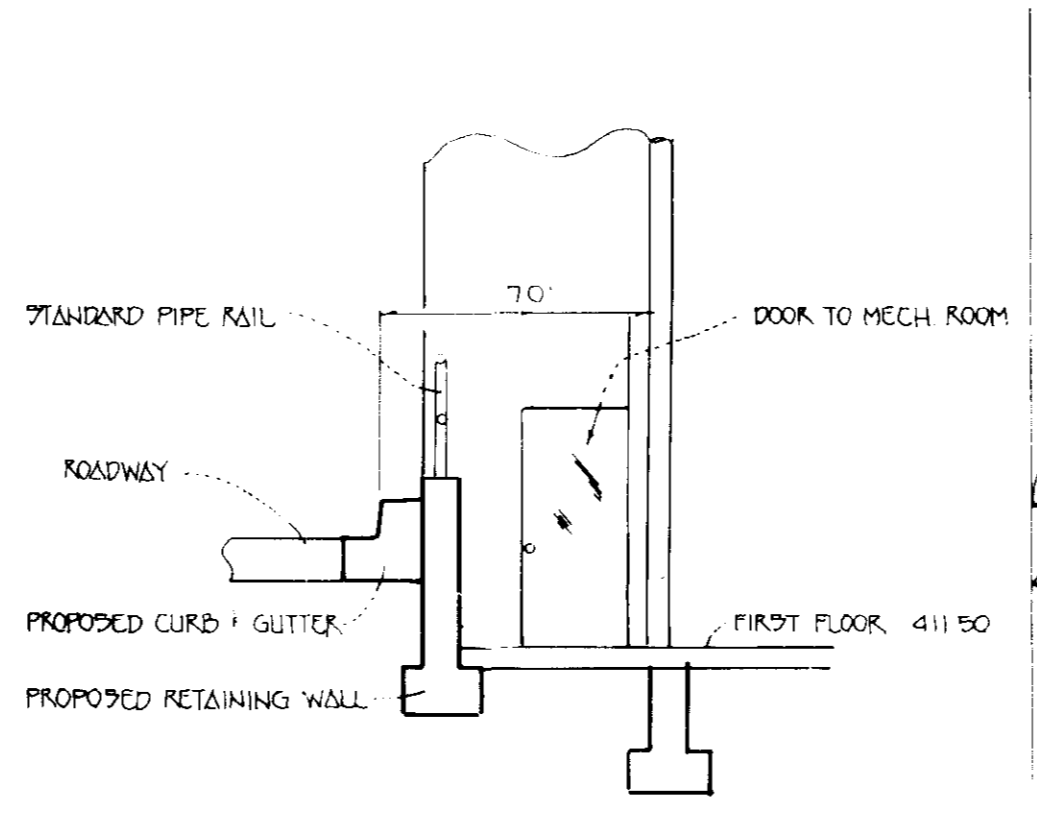


SECTION 'C-C'

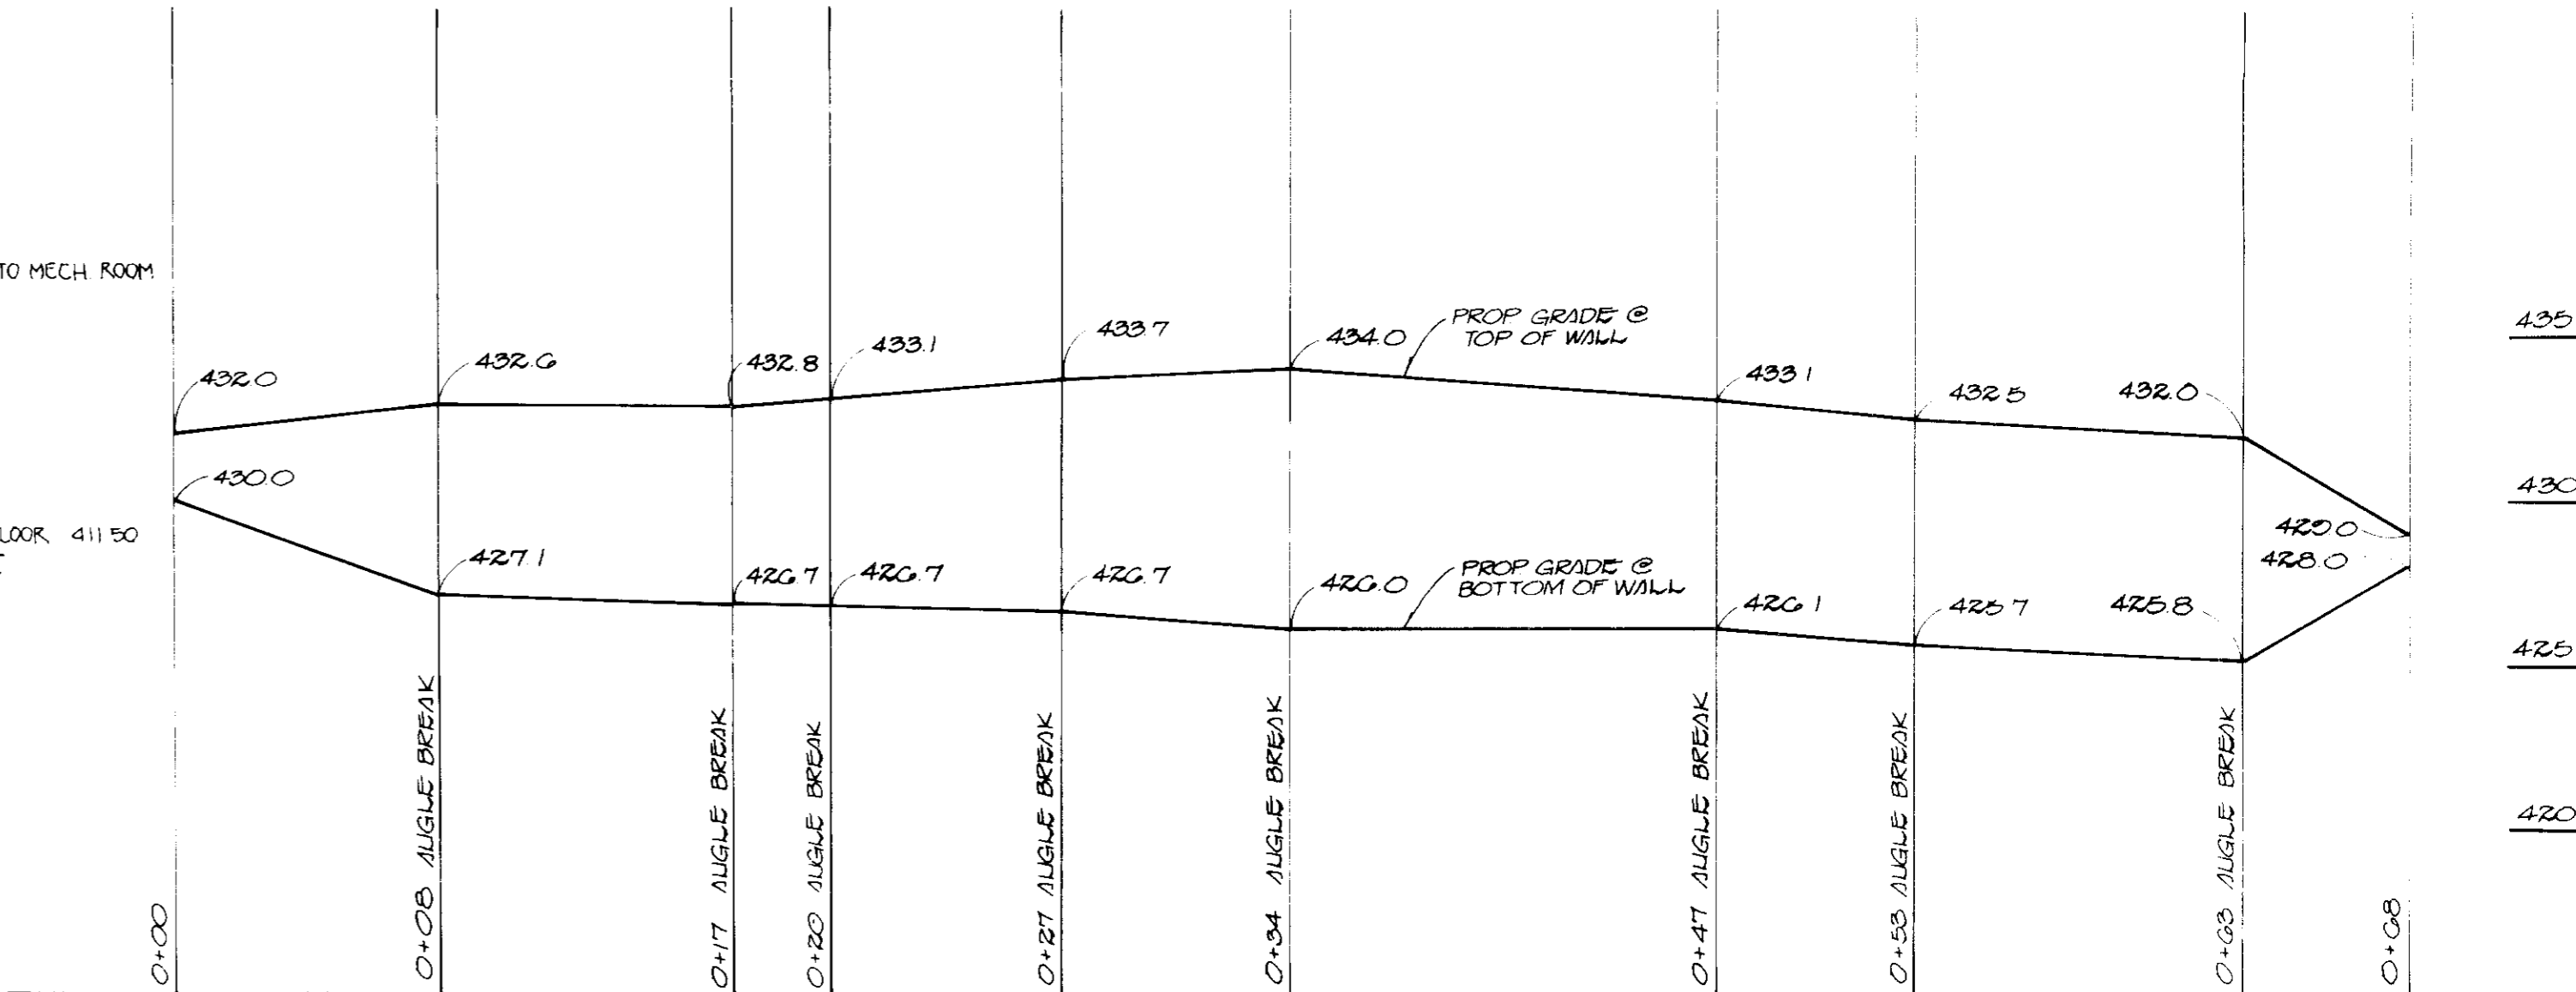


PROFILE ALONG TIMBER RETAINING WALL  
SCALE: HOR 1"=5'  
VER 1"=5'

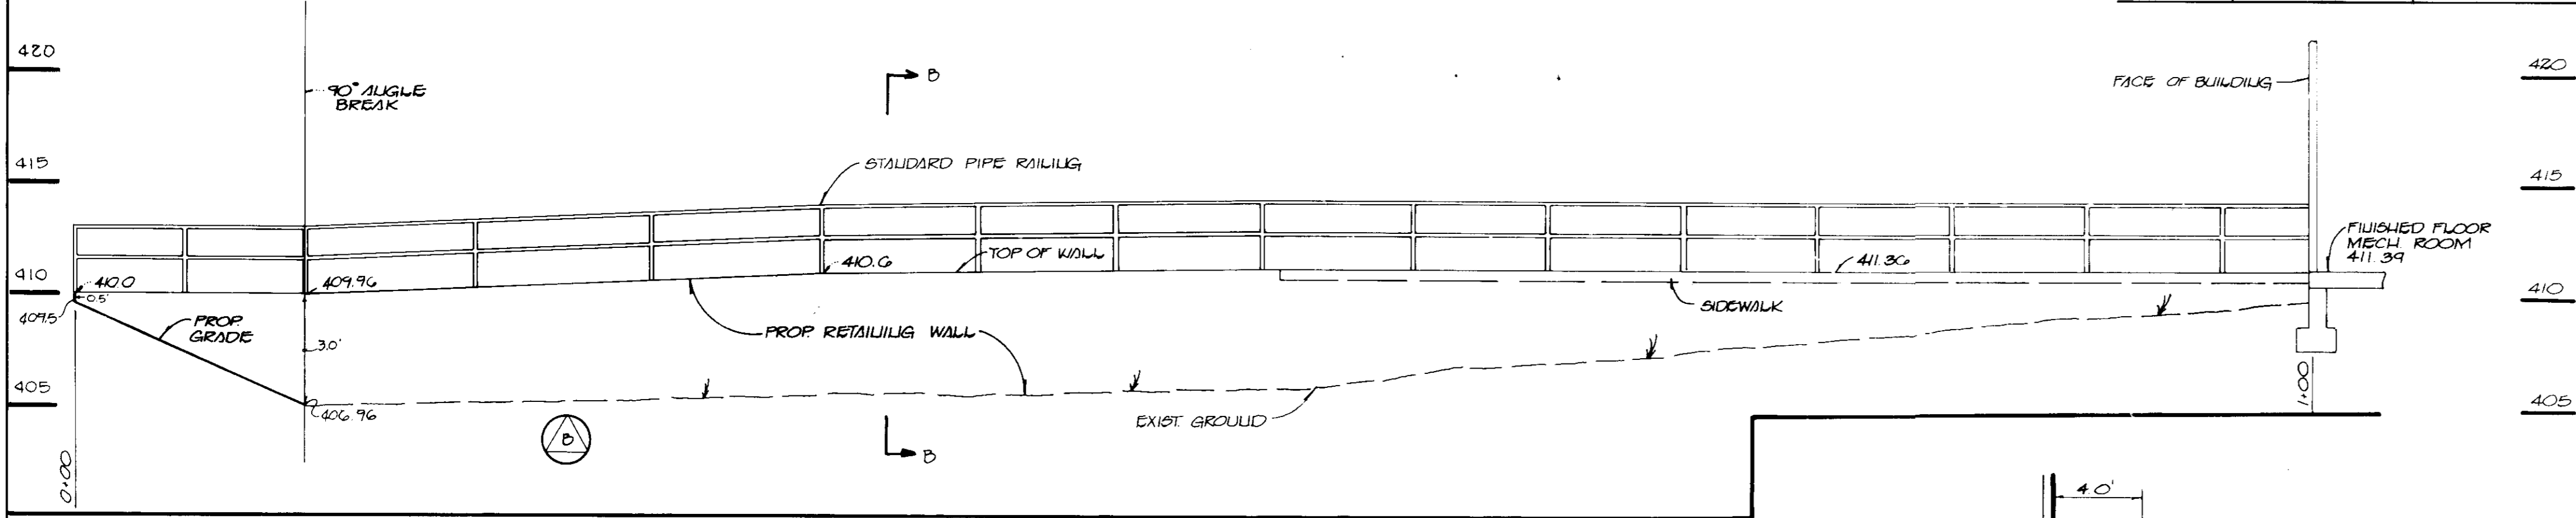


SECTION 'D-D'

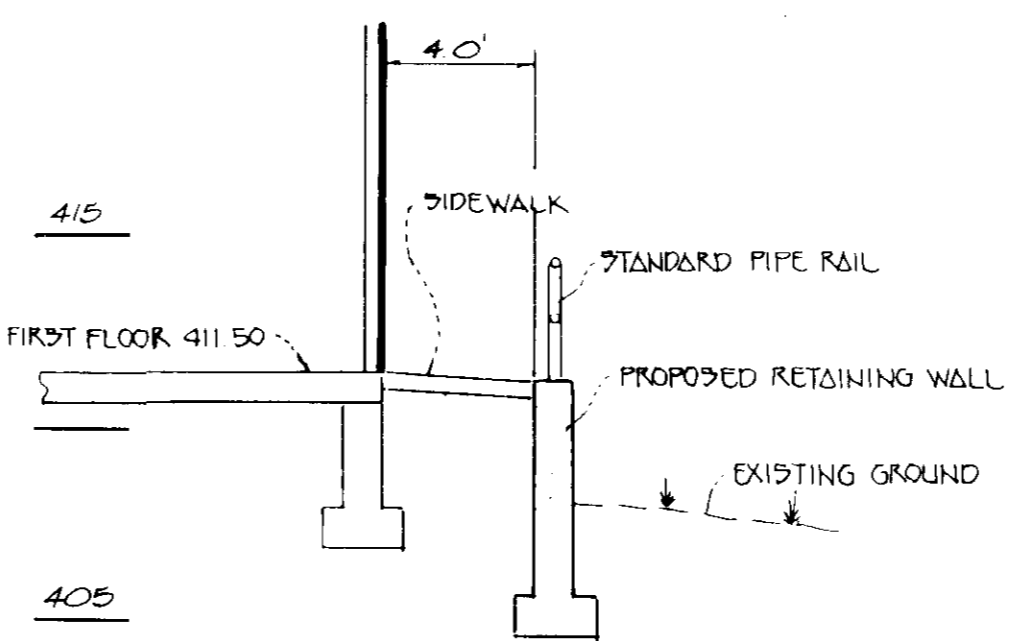

SECTION 'D-D' (TYPICAL)

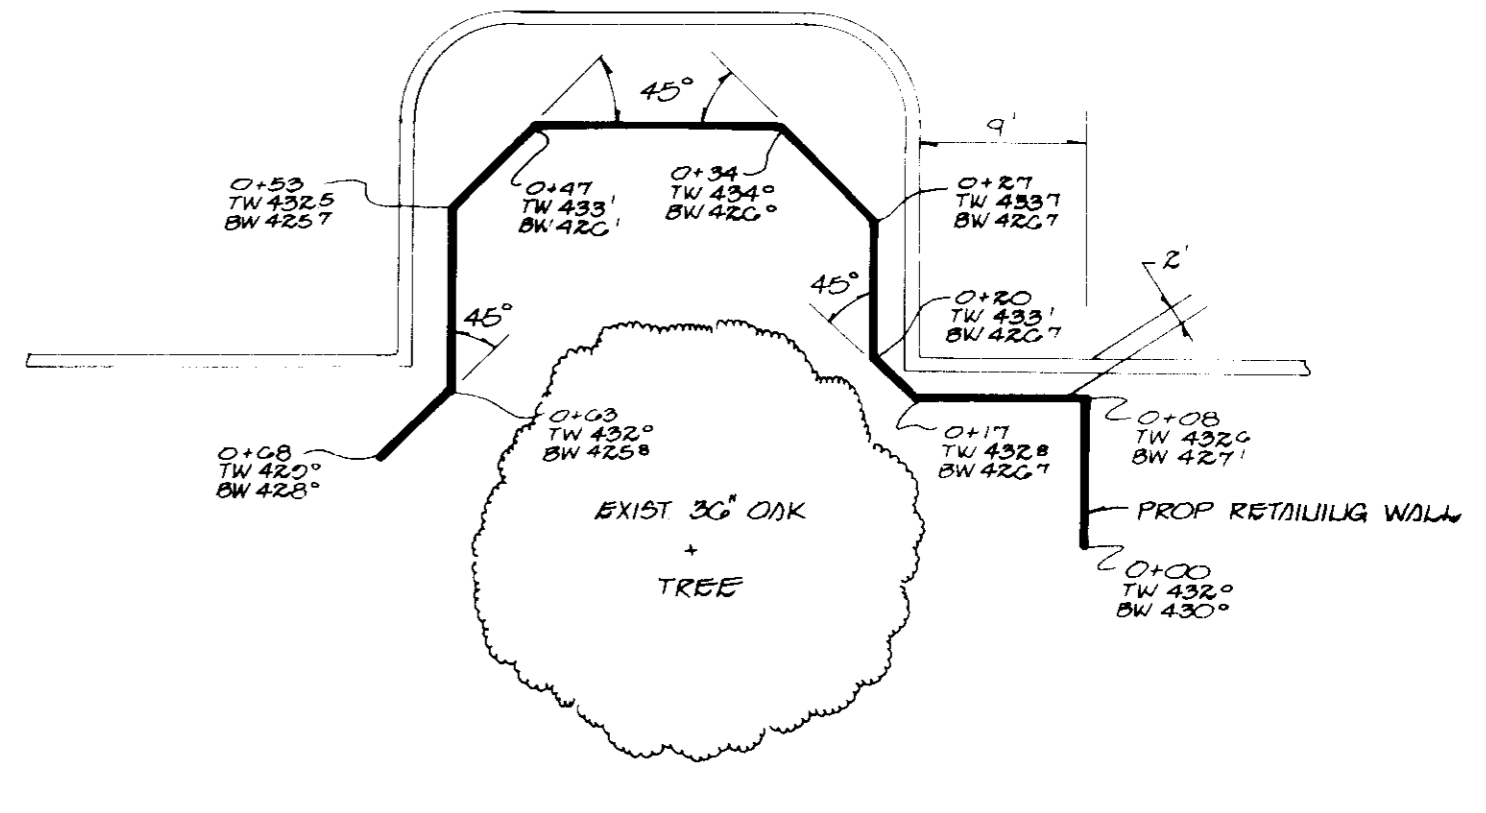


TIMBER RETAINING WALL  
SCALE 1"=10'

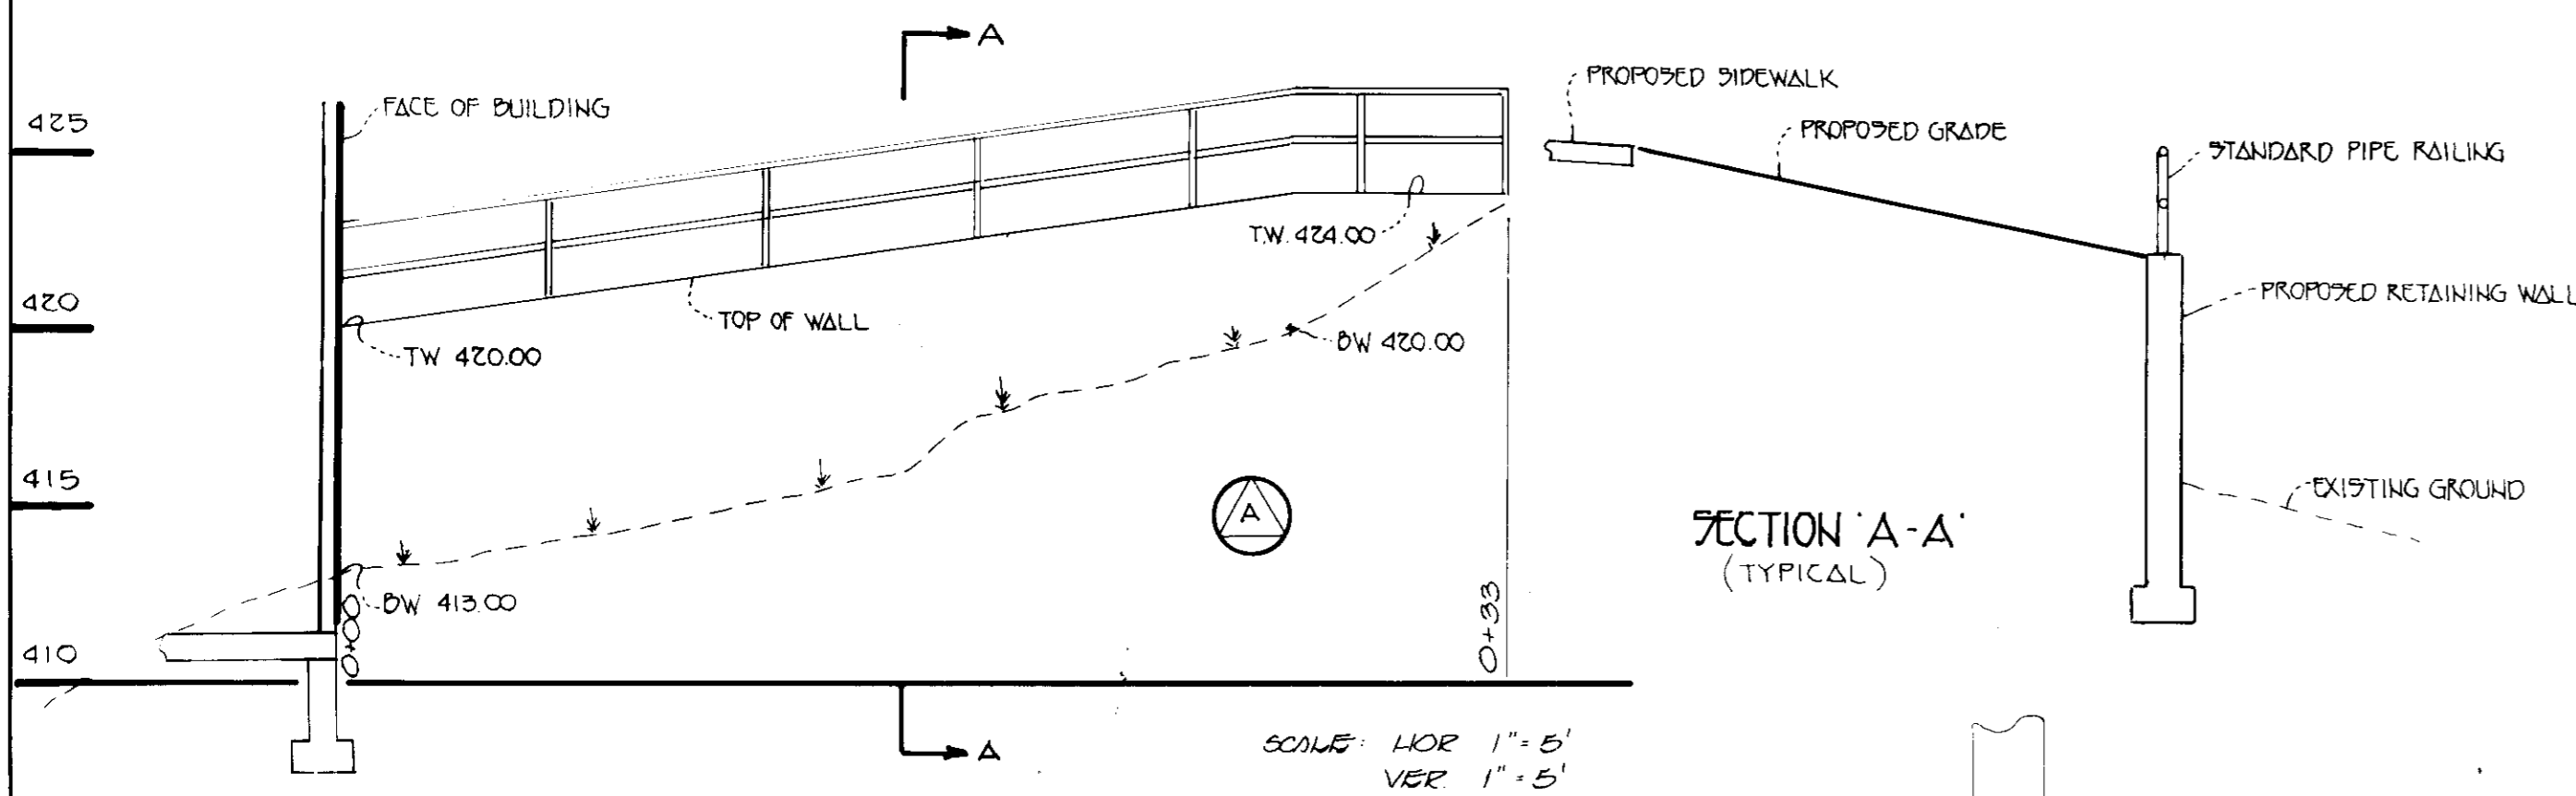


SECTION 'A-A' (TYPICAL)


SCALE: HOR 1"=5'  
VER 1"=5'

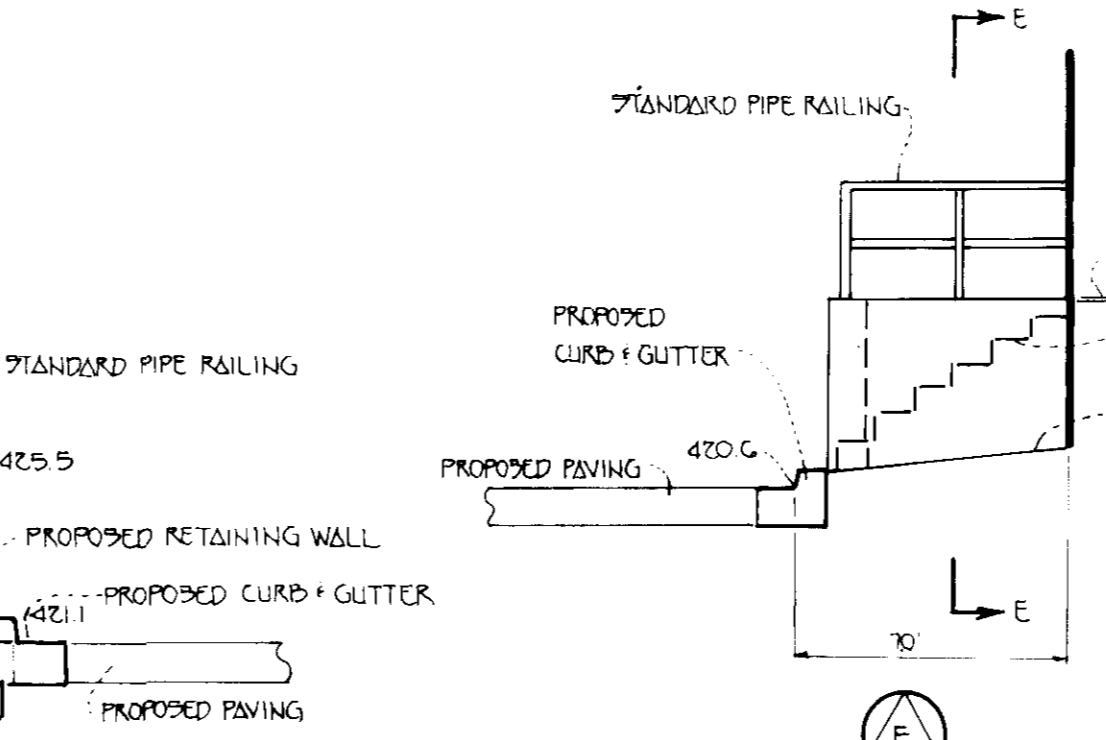


SECTION 'A-A'

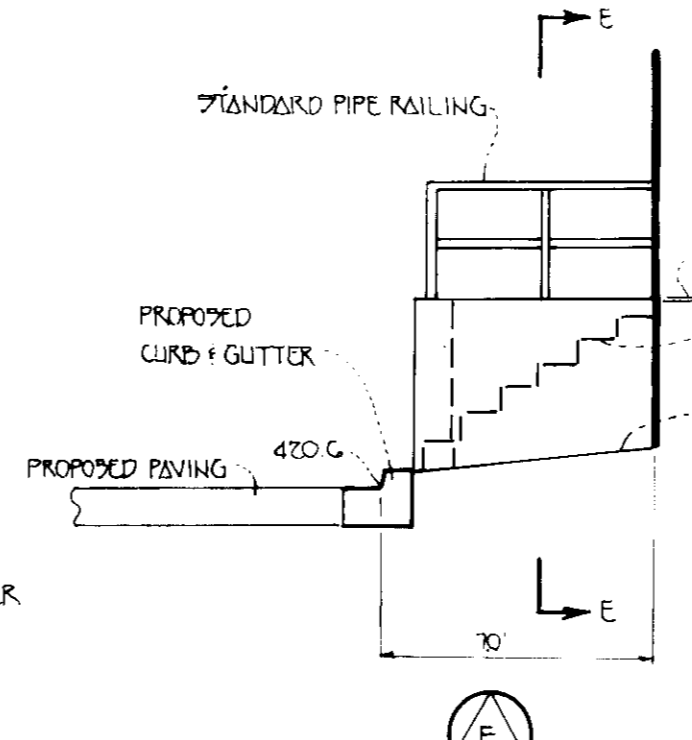

SECTION 'D-D'

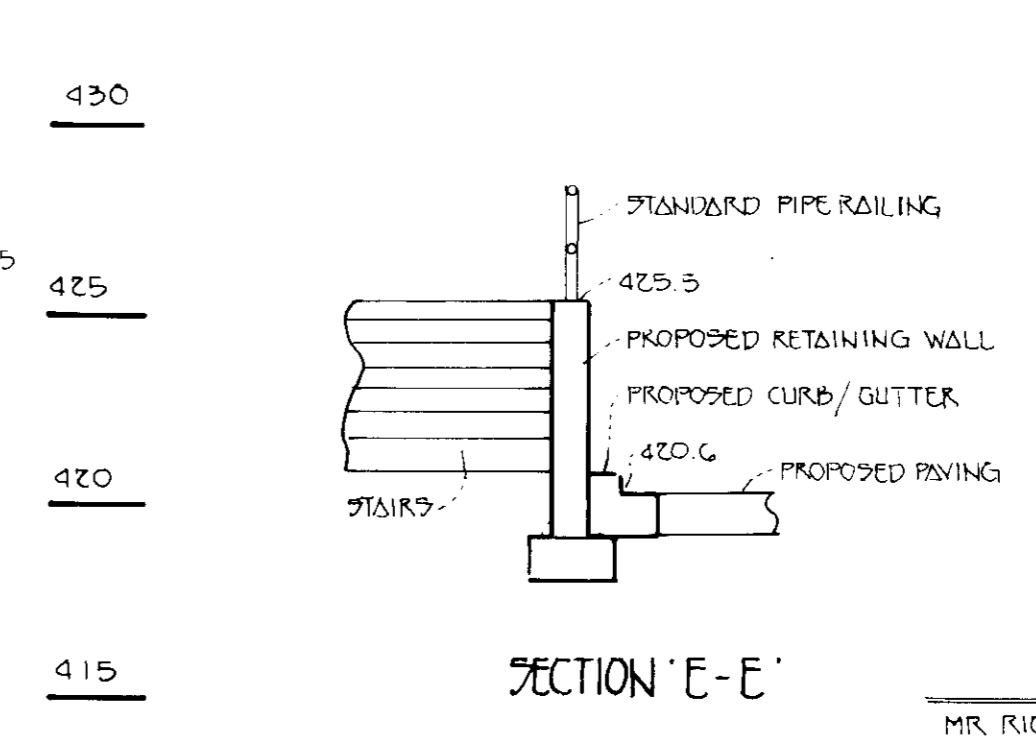

SECTION 'E-E'

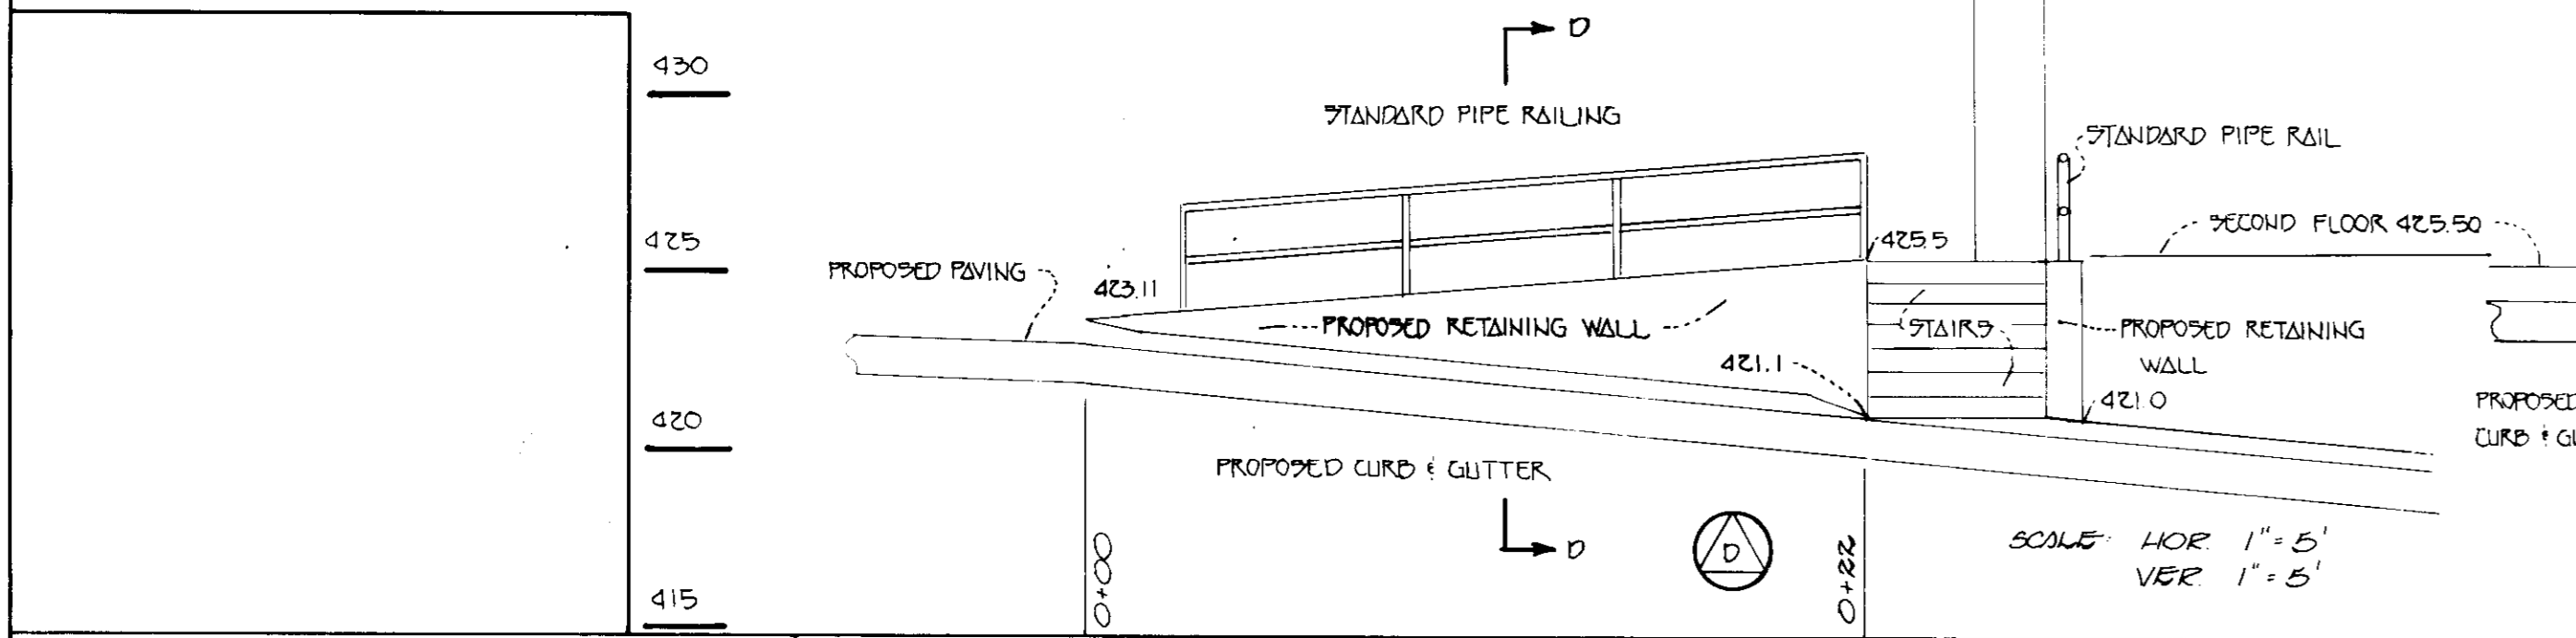

SECTION 'D-D'

SCALE: HOR 1"=5'  
VER 1"=5'

OWNER / DEVELOPER  
MR. RICHARD J. DEMMITT  
% HIGHLAND DEVELOPMENT CORP.  
P.O. BOX 203  
CLARKSVILLE, MARYLAND 21029  
MR. DONALD R. REINER JR.  
% LAND DESIGN AND DEVELOPMENT INC.  
10805 LICKORY RIDGE ROAD  
COLUMBIA, MARYLAND 21044

**FISHER, COLLINS & CARTER, INC.**  
CIVIL ENGINEERING CONSULTANTS & LAND SURVEYORS  
977 BALTIMORE NATIONAL PIKE, SUITE 100  
ELKROTT CITY, MARYLAND 21018  
(410) 481-2855

ENGINEER'S CERTIFICATE  
I HEREBY CERTIFY THAT THIS PLAN FOR EROSION AND SEDIMENT CONTROL REPRESENTS A PRACTICAL AND WORKABLE PLAN BASED ON MY PERSONAL KNOWLEDGE OF THE SITE CONDITIONS AND THAT IT WAS PREPARED IN ACCORDANCE WITH THE REQUIREMENTS OF THE HOWARD SOIL CONSERVATION DISTRICT.  
  
SIGNATURE OF ENGINEER: [Signature]  
DATE: 11/19/94


DEVELOPER'S CERTIFICATE  
I/WE CERTIFY THAT ALL DEVELOPMENT AND CONSTRUCTION WILL BE DONE ACCORDING TO THIS PLAN OF DEVELOPMENT AND PLAN FOR EROSION AND SEDIMENT CONTROL AND THAT ALL RESPONSIBLE PERSONNEL INVOLVED IN THE CONSTRUCTION PROJECT WILL HAVE A CERTIFICATE OF ATTENDANCE AT A DEPARTMENT OF THE ENVIRONMENT APPROVED TRAINING PROGRAM FOR THE CONTROL OF SEDIMENT AND EROSION BEFORE BEGINNING THE PROJECT. I ALSO AUTHORIZE PERIODIC ONSITE INSPECTION BY THE HOWARD SOIL CONSERVATION DISTRICT OR THEIR AUTHORIZED AGENTS, AS ARE DEEMED NECESSARY.  
  
SIGNATURE OF DEVELOPER: [Signature]  
DATE: 11/19/94

REVIEWED FOR HOWARD SOIL CONSERVATION DISTRICT AND METS TECHNICAL REQUIREMENTS  
[Signature] 2/11/95  
U.S. SOIL CONSERVATION SERVICE  
  
THIS DEVELOPMENT IS APPROVED FOR EROSION AND SEDIMENT CONTROL BY THE HOWARD SOIL CONSERVATION DISTRICT.  
APPROVED: [Signature] 2/11/95  
DISTRICT ENGINEER  
HOWARD SOIL CONSERVATION DISTRICT


APPROVED: DEPT. OF PLANNING AND ZONING  
[Signature] 3/8/95  
PLANNING DIRECTOR  
[Signature] 3/7/95  
CHIEF, DIVISION OF LAND DEVELOPMENT AND RESEARCH  
  
APPROVED: HOWARD COUNTY HEALTH DEPARTMENT FOR PUBLIC WATER AND SEWERAGE SYSTEMS  
[Signature] 3/3/95  
HEALTH OFFICER

APPROVED: DEPARTMENT OF PUBLIC WORKS FOR PUBLIC WATER & SEWER AND STORM DRAINAGE SYSTEMS AND ROADS.  
[Signature] 2/22/95  
DIRECTOR, PUBLIC WORKS  
[Signature] 2/22/95  
CHIEF, BUREAU OF ENGINEERING  
  
PROPERTY/SUBDIVISION: ST. JOHN'S STATION  
SECTION/AREA: [Blank]  
PARCEL/LOT NO.: 39  
PLAT/NO./A.F.: 2015/52G  
BLOCK NO.: B  
ZONE: D-1  
TAX/ZONE: 24  
ELEC. DIST: 2ND  
CENSUS TR.: G022  
WATER CODE: FOG  
SEWER CODE: 1403700


TYPICAL RETAINING WALL PROFILES & CROSS SECTION  
**ST. JOHN'S STATION**  
TAX MAP 24 LIBER 2015, FOLIO 52G PARCEL 39  
2ND ELECTION DIST HOWARD COUNTY, MARYLAND  
SCALE: AS SHOWN DATE: SEPTEMBER, 1994  
SHEET NO 7 OF 8

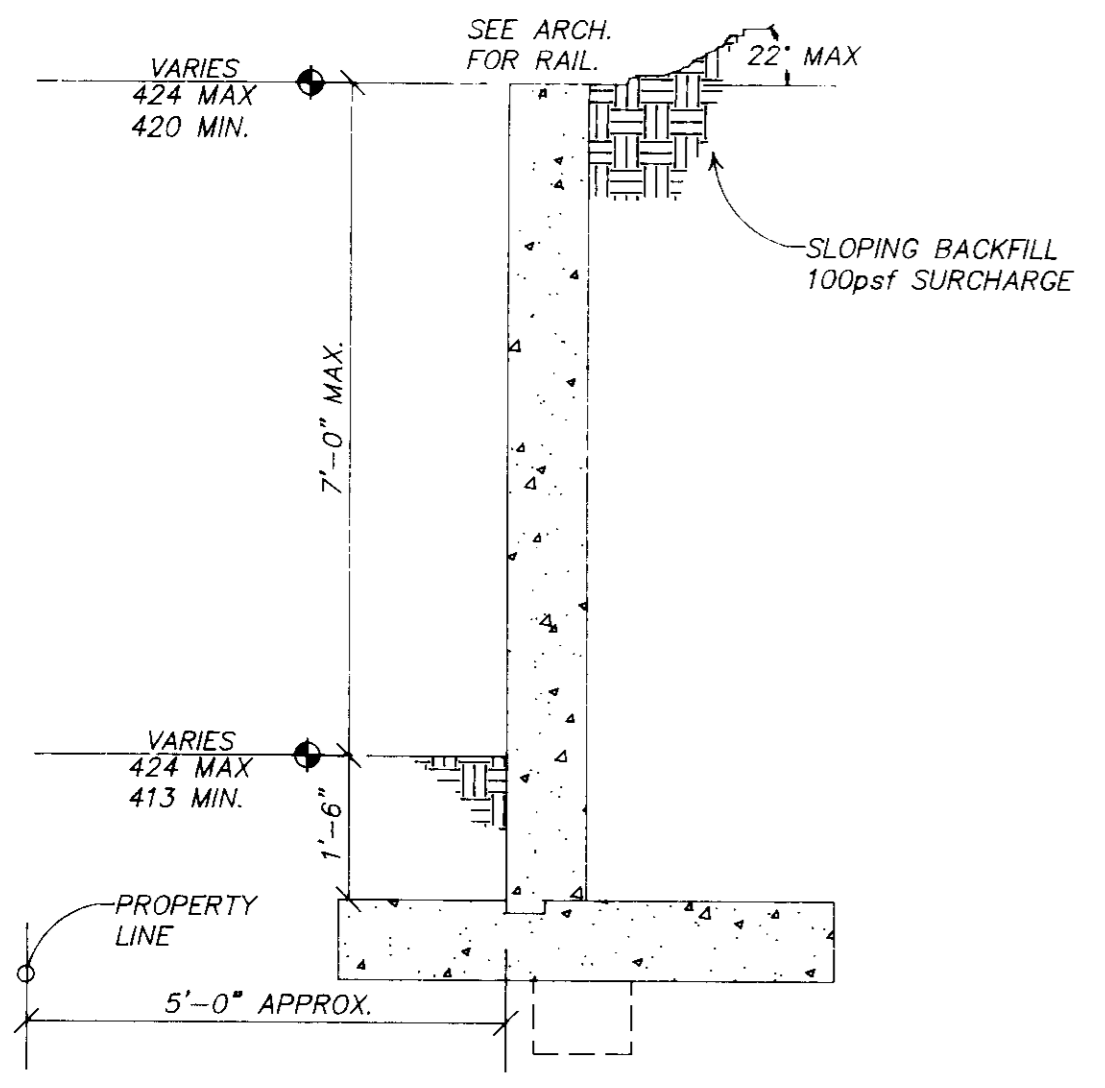


**WALL A**  
SCALE: 1/2" = 1'-0"  
A  
S1

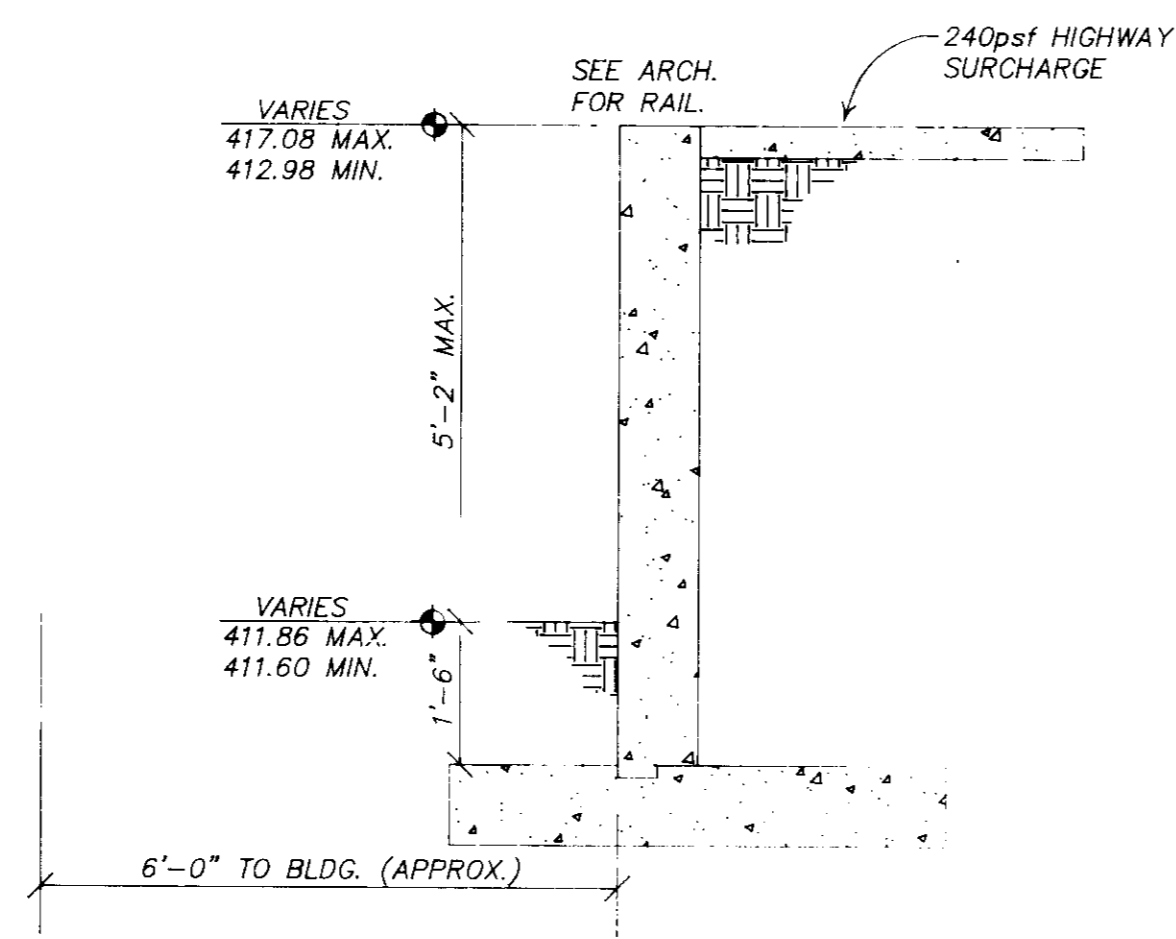


**WALL C**  
SCALE: 1/2" = 1'-0"  
C  
S1

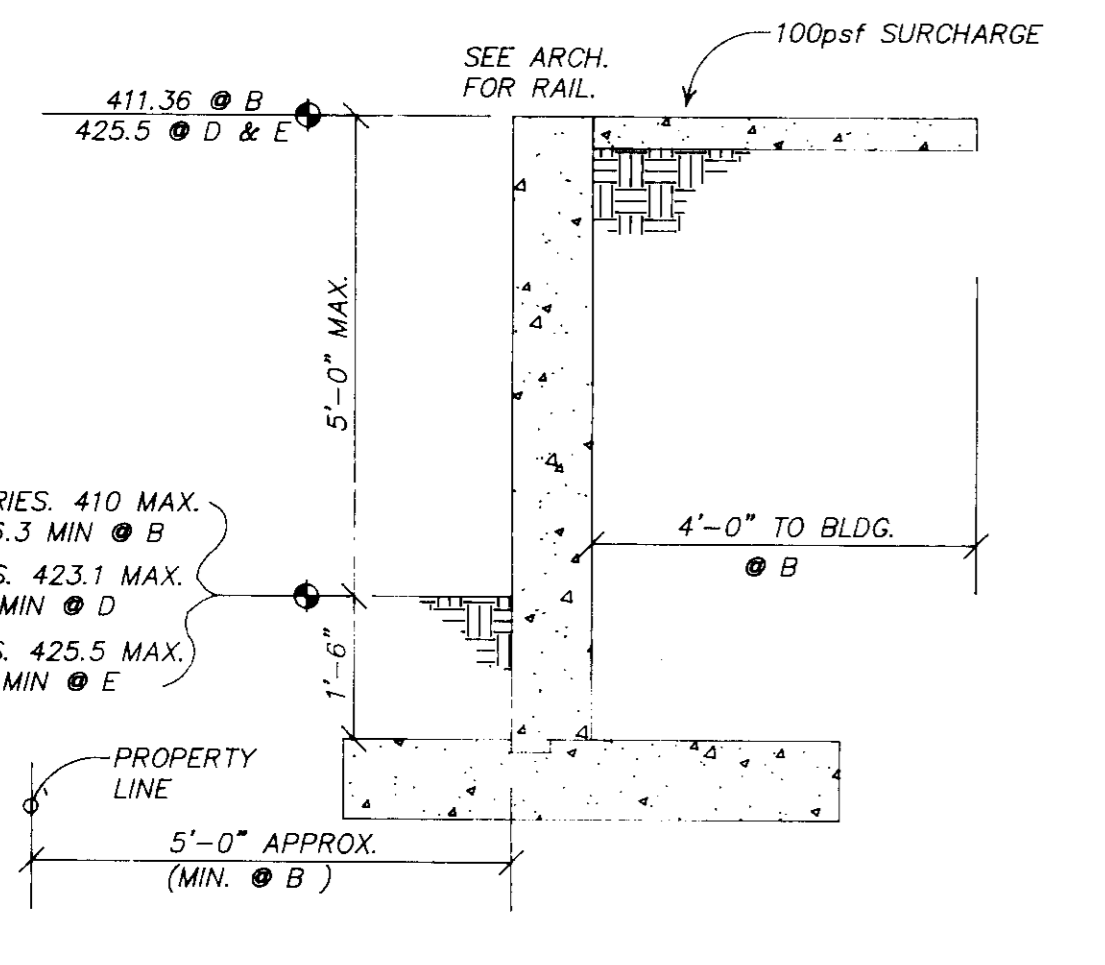

**WALL B, D & E**  
SCALE: 1/2" = 1'-0"  
B  
S1

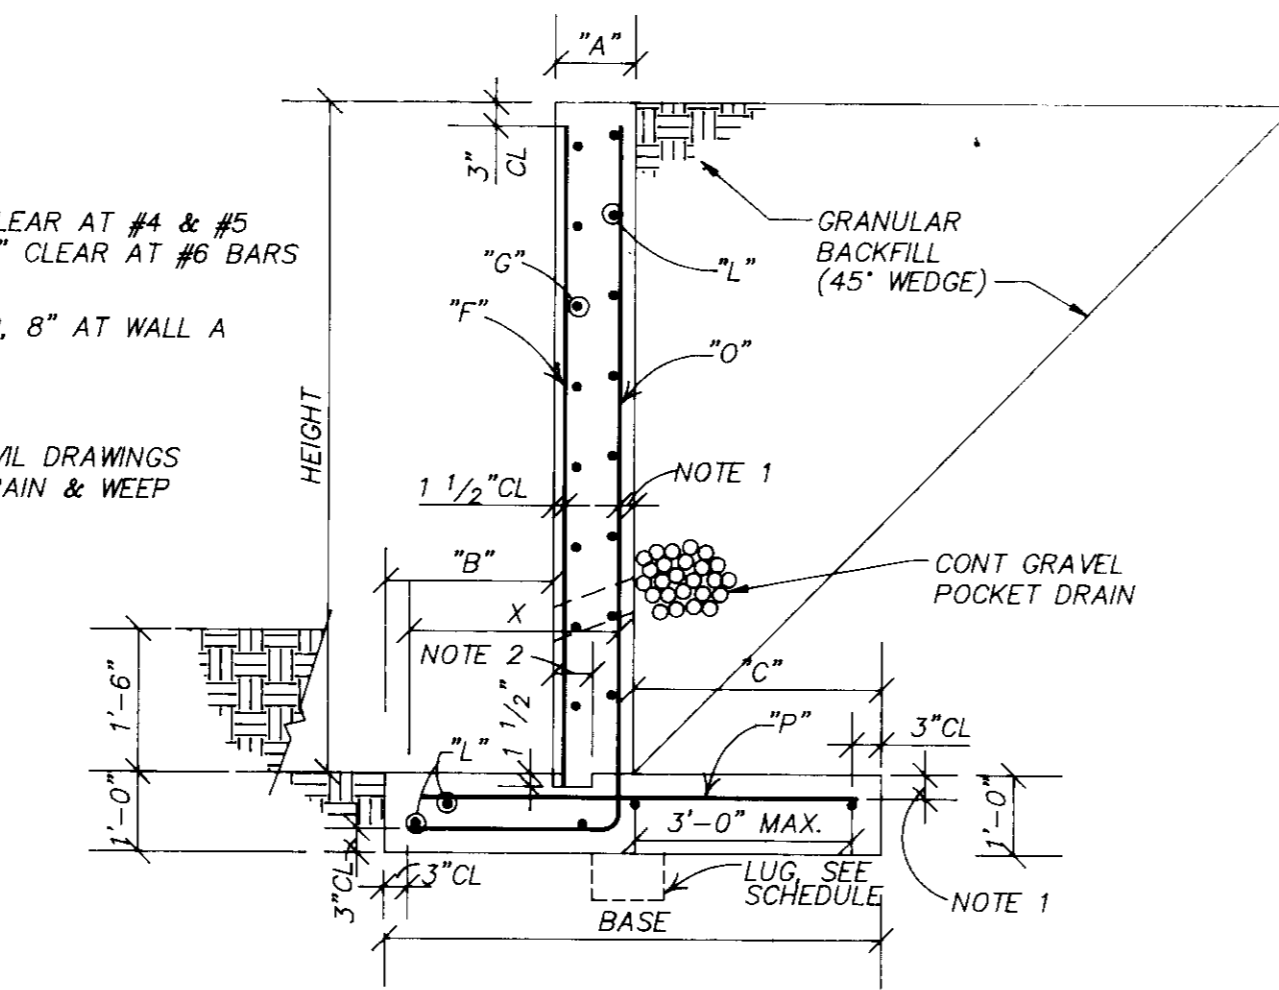

**TYPICAL RETAINING WALL DETAIL**  
SCALE: 1/2" = 1'-0"  
D  
S1

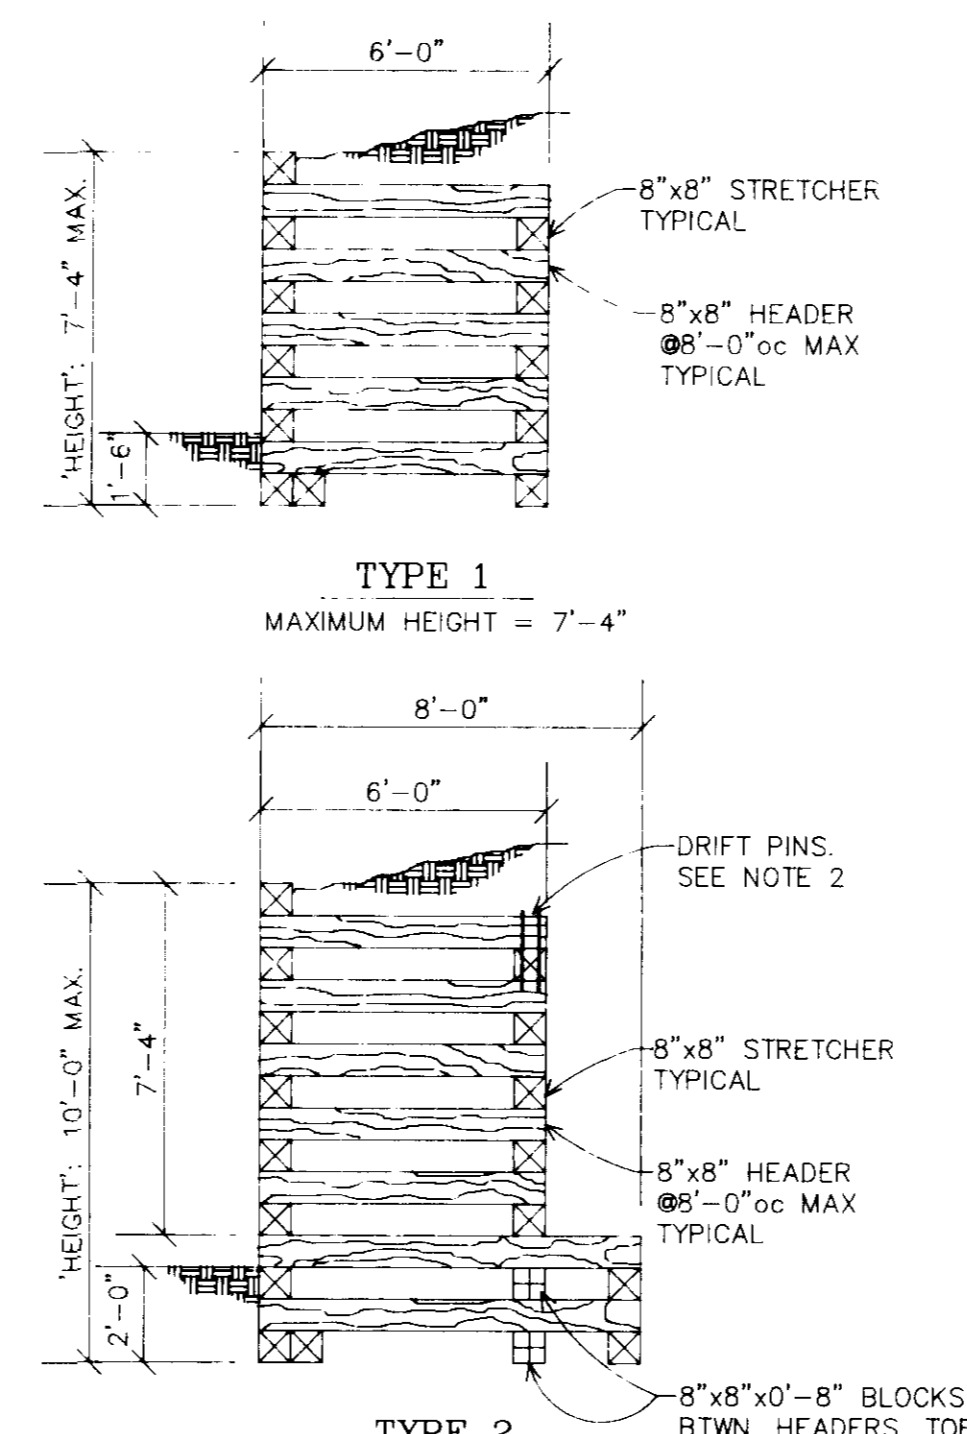

**TIMBER RETAINING WALL**  
SCALE: 1/4" = 1'-0"  
E  
S1

**NOTES FOR BOTH TYPE 1 AND TYPE 2 RETAINING WALLS**

- ALL TIMBERS TO BE 8"x8" SOUTHERN PINE #2 PRESSURE TREATED TIMBERS. ALL FABRICATION, ERECTION, OTHER PROCEDURES, AND MIN. UNIT STRESSES SHALL CONFORM TO THE CURRENT "NATIONAL DESIGN SPECIFICATION FOR WOOD CONSTRUCTION".
- PROVIDE 4" x 3/4" GALVANIZED DRIFT PINS @ INTERSECTION OF ALL HEADERS AND STRETCHERS. DRIFT PINS TO BE OF SUFFICIENT LENGTH TO PENETRATE THRU 2 MEMBERS AND 4" MIN. INTO THE THIRD MEMBER. DRIFT PIN HOLES TO BE 3/4" S.P. PROVIDE 2" EDGE DISTANCE FOR ALL PINS. PROVIDE 3/8" GAP @ ALL BUTT JOINTS.

WALL TYPE	MAX HEIGHT (ft.)	BASE	B	A	C	REINFORCEMENT					LUG REQ'D	
						O-BARS	F-BARS	P-BARS	L-BARS	G-BARS		
						SIZE/SPACING	SIZE/SPACING	SIZE/LENGTH/SPACING	SIZE/SPACING	SIZE/SPACING		
A	4'-0"	5'-0"	1'-6"	1'-0"	2'-6"	#4@9	2'-1"	#4@18	#4@9x4'-6"	#4@18	#4@12	NONE
A	8'-6"	8'-0"	2'-6"	1'-0"	4'-6"	#6@8	3'-1"	#4@18	#6@8x7'-6"	#4@18	#4@12	12"x16" DP
B,D,E	4'-0"	3'-4"	1'-0"	0'-10"	1'-6"	#4@9	1'-5"	#4@18	#4@9x2'-6"	#4@18	#4@12	NONE
B,D,E	6'-7"	4'-4"	1'-0"	0'-10"	2'-6"	#4@9	1'-5"	#4@18	#4@9x3'-10"	#4@18	#4@12	NONE
C	4'-0"	4'-0"	1'-0"	1'-0"	2'-0"	#4@9	1'-7"	#4@18	#4@9x3'-6"	#4@18	#4@12	NONE
C	6'-8"	5'-0"	1'-6"	1'-0"	2'-6"	#4@9	2'-1"	#4@18	#4@9x4'-6"	#4@18	#4@12	NONE

**1. GENERAL**

A. ALL CONSTRUCTION SHALL CONFORM WITH THE PROVISIONS OF THE BOCA NATIONAL BUILDING CODE/1990 AND ITS SUPPLEMENTS AND ANY ADDITIONAL SUPPLEMENTS ADOPTED BY HOWARD COUNTY, MARYLAND.

B. RETAINING WALL DESIGN LOADS:

THE RETAINING WALLS SHOWN ON THIS SHEET HAVE BEEN DESIGNED ASSUMING THAT THE BACKFILL MATERIAL WILL HAVE THE FOLLOWING PROPERTIES:

A GRANULAR, NON-COHESSIVE MATERIAL PRODUCING A TRIANGULAR PRESSURE DIAGRAM  $K_a = .35$  MAXIMUM; A CORRESPONDING  $K_p = 2.85$  UNIT WEIGHT = 120 PCF; EQUIVALENT FLUID PRESSURE = 42 PCF COEFFICIENT OF FRICTION, SOIL TO CONCRETE FOOTING = .50 (WITHOUT SF)

THE EXISTING GEOTECHNICAL REPORT BY ITE, INC., BALTIMORE MARYLAND DATED 6 JANUARY 1994 DOES NOT EVALUATE THE ON-SITE SOILS FOR USE AS A BACKFILL MATERIAL BEHIND THE SITE RETAINING WALLS. THEREFORE THE ON-SITE SOIL MAY NOT BE SUITABLE FOR BACKFILL BEHIND THE RETAINING WALLS. THE SERVICES OF A MARYLAND LICENSED GEOTECHNICAL ENGINEER SHALL BE OBTAINED TO SELECT A SUITABLE GRANULAR BACKFILL MATERIAL SUCH THAT THE ASSUMED PRESSURES FOR WHICH THE WALLS HAVE BEEN DESIGNED WILL NOT BE EXCEEDED.

WALLS A, B, D, AND E HAVE BEEN DESIGNED FOR A SURCHARGE LOAD APPLIED AT THE UPPER SOIL SURFACE OF 100 PSF. WALL C HAS BEEN DESIGNED FOR A HIGHWAY SURCHARGE LOAD OF 240 PSF.

ALL WALLS HAVE BEEN DESIGNED TO SUSTAIN A HORIZONTAL LOAD OF 50 POUNDS PER FOOT (OR A SINGLE CONCENTRATED LOAD OF 200 POUNDS) APPLIED AT THE TOP OF A 2'-6" TALL RAILING MOUNTED ON TOP OF THE WALLS. THE WALLS HAVE NOT BEEN DESIGNED FOR ANY OTHER IMPACT LOADS APPLIED TO THE RAILINGS (FOR EXAMPLE FROM CARS OR TRUCKS).

THE WALLS HAVE BEEN DESIGNED FOR THE DIFFERENCES IN GRADE SHOWN ON THE CIVIL ENGINEER'S DRAWINGS AND SUMMARIZED HEREIN. SHOULD THE GRADE DIFFERENCES EXCEED THE MAXIMUMS INDICATED ON THIS SHEET, NOTIFY MCCORMAC ENGINEERING ASSOCIATES IN ORDER THAT THE WALL(S) MAY BE REDESIGNED.

C. ALL STRUCTURAL COMPONENTS HAVE BEEN DESIGNED FOR THE DEAD LOADS SHOWN ON THE PLANS AND THE LIVE LOADS SHOWN ABOVE. IT IS THE CONTRACTOR'S RESPONSIBILITY TO DETERMINE ALLOWABLE CONSTRUCTION LOADS AND TO PROVIDE PROPER DESIGN AND CONSTRUCTION OF THOSE ITEMS NECESSARY TO FACILITATE CONSTRUCTION INCLUDING BUT NOT LIMITED TO FALSEWORK, FORMWORK, STAGING, BRACING, SHEETING AND SHORING, ETC.

D. THE CONTRACTOR SHALL FIELD CHECK AND VERIFY ALL DIMENSIONS AND ELEVATIONS OF EXISTING WORK PRIOR TO FABRICATION OF ANY NEW MATERIALS. THE CONTRACTOR SHALL COORDINATE WITH ALL NEW AND EXISTING UTILITIES.

E. LOADS GREATER THAN THE DESIGN LIVE LOADS SHALL NOT BE PLACED ON THE STRUCTURE. A CONCRETE STRUCTURE MAY NOT SUPPORT ITS DESIGN LIVE LOADS FOR 28 DAYS. CONTRACTOR SHALL SUPPORT ADJACENT STRUCTURES, UTILITIES, AND EXCAVATIONS.

F. DO NOT BACKFILL AGAINST WALLS UNTIL THE WALLS HAVE BEEN PROPERLY CURED AND THE CONCRETE HAS ATTAINED THEIR FULL 28 DAY STRENGTH.

G. ALL WORK SPECIFIED HEREIN SHALL BE INSPECTED IN ACCORDANCE WITH THE BUILDING CODE AND ALL LOCAL ORDINANCES. THE OWNER OR CONTRACTOR (SEE SPECIFICATIONS) SHALL HIRE AN EXPERIENCED, QUALIFIED INSPECTOR TO PERFORM ALL THE REQUIRED INSPECTION WORK. MCCORMAC ENGINEERING ASSOCIATES (THE ENGINEER) WILL NOT PERFORM THE REQUIRED INSPECTION AS A PART OF THEIR DESIGN SERVICE. THE ENGINEER MAY VISIT THE SITE TO ASCERTAIN GENERAL CONFORMANCE WITH THE CONTRACT DOCUMENTS. SUCH SITE VISITS ARE NOT TO BE CONSTRUED AS MEETING ANY INSPECTION REQUIREMENTS UNLESS THE ENGINEER SPECIFICALLY SO STATES IN WRITING.

H. ALL RAILINGS SHALL BE DESIGNED FOR ALL APPLICABLE DEAD LOADS AND FOR ALL LIVE, WIND, AND SEISMIC LOADS AS SPECIFIED IN THE LOCAL BUILDING CODE.

2. SHOP DRAWINGS

A. ANY REVIEW OF STRUCTURAL ITEM SHOP DRAWINGS BY MCCORMAC ENGINEERING ASSOCIATES (THE ENGINEER) IS FOR GENERAL CONFORMANCE WITH THE DESIGN CONCEPT AS PRESENTED BY THE CONTRACT DOCUMENTS. NO DETAILED CHECK OF QUANTITIES OR DIMENSIONS WILL BE MADE.

B. AT THE TIME OF SHOP DRAWING SUBMISSION, THE GENERAL CONTRACTOR SHALL STATE IN WRITING ANY DEVIATIONS OR OMISSIONS FROM THE CONTRACT DOCUMENTS. THE GENERAL CONTRACTOR SHALL REVIEW ALL SHOP DRAWINGS BEFORE SUBMISSION AND MAKE ALL CORRECTIONS AS HE DEEMS NECESSARY AND SHALL CERTIFY ON EACH DRAWING AS FOLLOWS:

"I CERTIFY THAT THE CONTRACT DOCUMENT REQUIREMENTS HAVE BEEN MET AND ALL DIMENSIONS, CONDITIONS, AND QUANTITIES ARE VERIFIED AS SHOWN AND/OR AS CORRECTED ON THIS DRAWING."

SIGNED: \_\_\_\_\_ (FOR GENERAL CONTRACTOR)

C. SUBMIT SHOP DRAWINGS FOR SPECIFIC AREAS IN THEIR ENTIRETY. SUBMIT A SUITABLE NUMBER OF COPIES OF SHOP DRAWINGS SO THAT MCCORMAC ENGINEERING ASSOCIATES WILL RECEIVE ONE REPRODUCIBLE AND TWO BLUELINE PRINTS. THE REPRODUCIBLE AND ONE PRINT WILL BE RETURNED AFTER REVIEW.

D. ALL CHANGES AND ADDITIONS MADE ON RE-SUBMITTALS MUST BE CLEARLY FLAGGED AND NOTED THE PURPOSE OF THE RE-SUBMITTALS MUST BE CLEARLY NOTED ON THE LETTER OF TRANSMITTAL. THE REVIEW OF THE RE-SUBMITTALS WILL BE LIMITED TO THOSE ITEMS CAUSING THE RE-SUBMISSION.

E. THE STRUCTURAL CONTRACT DOCUMENTS ARE NOT TO BE REPRODUCED FOR USE AS SHOP DRAWINGS.

F. SHOP DRAWINGS FOR ALL STRUCTURAL ELEMENTS SHOWN ON THE CONTRACT DOCUMENTS MUST BE SUBMITTED BY THE GENERAL CONTRACTOR. IF A CONTRACTOR OR OWNER FAILS TO SUBMIT THE SHOP DRAWINGS, MCCORMAC ENGINEERING ASSOCIATES WILL NOT BE RESPONSIBLE FOR THE STRUCTURAL CERTIFICATION OR FOR THE DESIGN OF THE PROJECT.

3. FOUNDATIONS

A. IT IS THE CONTRACTOR'S RESPONSIBILITY TO SATISFY HIMSELF AS TO THE LOCATION OF ANY UTILITIES IN THE VICINITY OF CONSTRUCTION SO AS TO PREVENT DAMAGE TO THE UTILITIES AND/OR ANY CONSEQUENTIAL DAMAGES. SHOULD ANY SUCH DAMAGE OCCUR THE CONTRACTOR SHALL BE REQUIRED TO REPAIR SUCH DAMAGE AT HIS OWN EXPENSE AND TO THE SATISFACTION OF THE OWNER.

B. WALLS HAVE BEEN DESIGNED TO PRODUCE FOOTINGS CONFORMING TO THE ALLOWABLE BEARING PRESSURE INDICATED IN THE GEOTECHNICAL REPORT SUBMITTED BY ITE, INC. DATED 6 JANUARY 1994. THE REQUIRED SOIL BEARING CAPACITY IS 4,000 PSF. FOOTINGS SHALL BEAR ON NATURAL UNDISTURBED SOIL, 1'-0" BELOW ORIGINAL GRADE OR CONTROLLED STRUCTURAL FILL. THE BOTTOM OF FOOTINGS SHALL BE 2'-6" BELOW FINISHED GRADE ON THE LOW SIDE OF THE WALL. CONTRACTOR SHALL HIRE A MARYLAND LICENSED GEOTECHNICAL ENGINEER TO VERIFY THE ALLOWABLE SOIL PRESSURE IN THE FIELD. IF FOUND TO BE LESS THAN 4,000 PSF, THE WALLS WILL HAVE TO BE REDESIGNED.

C. SLABS FOR SIDEWALKS AND PAVEMENTS AND FILL UNDER THESE ELEMENTS ARE NOT PART OF THIS DESIGN. REFER TO THE CIVIL ENGINEER'S DRAWINGS.

4. CAST IN PLACE CONCRETE

A. ALL CONCRETE WORK SHALL CONFORM TO THE LATEST APPROVED (BY LOCAL GOVERNMENT) EDITIONS OF THE FOLLOWING A.C.I. AND A.S.T.M. DOCUMENTS:

- ACI-301 SPECIFICATIONS FOR STRUCTURAL CONCRETE FOR BUILDINGS
- ACI-302.1R FLOOR AND SLAB CONSTRUCTION
- ACI-318 BUILDING CODE REQUIREMENTS FOR REINFORCED CONCRETE
- ACI-214 COMPRESSION TESTS
- ACI-306 COLD WEATHER
- ACI-315 DETAILING
- ACI-347 FORMWORK
- ACI-305 HOT WEATHER
- ACI-211 PROPORTIONS OF CONCRETE
- ACI-304 PLACING CONCRETE
- ACI-ASCE 423 UNBONDED TENDONS
- ASTM C94 READY-MIX CONCRETE

B. ALL FIELD AND LAB TESTING OF CONCRETE SHALL CONFORM TO THE LATEST APPROVED (BY LOCAL GOVERNMENT) EDITIONS OF ASTM:

- ASTM C31 FIELD CYLINDER SPECIMENS
- ASTM C143 SLUMP TEST
- ASTM C231 AIR CONTENT (WHEN REQUIRED)
- ASTM C39 LAB TESTING CYLINDERS
- ASTM C172 SAMPLING FRESH CONCRETE
- ASTM C42 HARDENED CORES (WHEN REQUIRED)

UPON COMPLETION OF CONCRETE TESTING, THE AGENCY SHALL CERTIFY THEIR RESULTS AS FOLLOWS:

"I CERTIFY THAT THE FIELD AND LAB TESTING CONFORMS TO THE ASTM DOCUMENTS AND GOOD PRACTICE."

SIGNED: \_\_\_\_\_ P.E. (FOR AGENCY)

C. ALL CONCRETE, EXCEPT AS NOTED, SHALL BE (F'c=3,000 PSI) STONE AGGREGATE CONCRETE AT 28 DAYS. ALL CONCRETE SHALL BE AIR ENTRAINED.

D. AT INTERVALS NOT EXCEEDING 25 FEET, PROVIDE WEAKENED PLANE CONTROL JOINTS FULL HEIGHT OF THE STEM. AT THESE JOINTS, STOP ALTERNATE HORIZONTAL BARS (EACH FACE) SO THAT ONLY ALTERNATE HORIZONTAL BARS CONTINUE THROUGH THE JOINT. THE JOINT MAY BE FORMED OR SAW CUT AT THE PROPER TIME LATER. THE JOINTS SHALL BE SEALED WITH APPROPRIATE CAULKING MATERIAL.

E. ALL FORMWORK SHALL BE IN ACCORDANCE WITH THE AMERICAN CONCRETE INSTITUTE "FORMWORK FOR CONCRETE", SPECIAL PUBLICATION NO. 4 AND ACI'S "STANDARD RECOMMENDED PRACTICE FOR CONCRETE FORMWORK" (ACI-347, LATEST LOCAL APPROVED EDITION).

5. REINFORCING STEEL

A. EXCEPT AS NOTED, ALL REINFORCING SHALL BE HIGH STRENGTH NEW BILLET STEEL CONFORMING TO ASTM DESIGNATION A-615 (LATEST LOCAL APPROVED EDITION). GRADE 60 ALL REINFORCING SHALL BE DETAILED, FABRICATED, AND PLACED IN ACCORDANCE WITH THE ACI'S "MANUAL OF STANDARD PRACTICE FOR DETAILING CONCRETE STRUCTURES" (ACI 315, LATEST LOCAL APPROVED EDITION).

B. BEND HORIZONTAL WALL REINFORCING 1'-0" MINIMUM AROUND ALL CORNERS OR PROVIDE 4'-0" LONG CORNER BARS TO MATCH HORIZONTAL REINFORCING.

C. UNLESS OTHERWISE NOTED IN STRUCTURAL DRAWINGS, PROVIDE CONCRETE PROTECTION FOR REINFORCING AS FOLLOWS:

- CAST AGAINST EARTH EXPOSED TO EARTH OR WEATHER: 3"
- NO. 6 AND LARGER BARS: 1'-2"
- NO. 5 AND SMALLER BARS: 1'-1/2"

*McCormac*

STATE OF MARYLAND  
REGISTERED PROFESSIONAL ENGINEER  
No. 2715  
2 Nov 94

MCCORMAC ENGINEERING ASSOCIATES  
STRUCTURAL ENGINEERS  
8289 MAIN STREET SUITE 202  
ELICOTT CITY, MARYLAND 21043  
(410)756-3502 FAX (410)756-0678  
PROJECT # 9404

**OWNER**  
MR. RICHARD J. DEMITTT  
56 HIGHLAND DEVELOPMENT CORP.  
P.O. BOX 208  
CLARKSVILLE, MARYLAND 21029

**DEVELOPER**  
MR. DONALD R. REUWER JR.  
16 LAND DESIGN AND DEVELOPMENT INC.  
10005 HICKORY RIDGE ROAD  
COLUMBIA, MARYLAND 21044

**FISHER, COLLINS & CARTER, INC.**  
CIVIL ENGINEERING CONSULTANTS & LAND SURVEYORS  
971 BALTIMORE NATIONAL PARK, SUITE 100  
ELICOTT CITY, MARYLAND 21042  
(410) 461 - 2855

**ENGINEER'S CERTIFICATE**

I HEREBY CERTIFY THAT THIS PLAN FOR EROSION AND SEDIMENT CONTROL REPRESENTS A PRACTICAL AND WORKABLE PLAN BASED ON MY PERSONAL KNOWLEDGE OF THE SITE CONDITIONS AND THAT IT WAS PREPARED IN ACCORDANCE WITH THE REQUIREMENTS OF THE HOWARD SOIL CONSERVATION DISTRICT.

*[Signature]*  
SIGNATURE OF ENGINEER

11/94  
DATE

**DEVELOPER'S CERTIFICATE**

I/WE CERTIFY THAT ALL DEVELOPMENT AND CONSTRUCTION WILL BE DONE ACCORDING TO THIS PLAN OF DEVELOPMENT AND PLAN FOR EROSION AND SEDIMENT CONTROL AND THAT ALL RESPONSIBLE PERSONNEL INVOLVED IN THE CONSTRUCTION PROJECT WILL HAVE A CERTIFICATE OF ATTENDANCE AT A DEPARTMENT OF THE ENVIRONMENT APPROVED TRAINING PROGRAM FOR THE CONTROL OF SEDIMENT AND EROSION BEFORE BEGINNING THE PROJECT. I ALSO AUTHORIZE PERIODIC ONSITE INSPECTION BY THE HOWARD SOIL CONSERVATION DISTRICT OR THEIR AUTHORIZED AGENTS, AS ARE DEEMED NECESSARY.

*[Signature]*  
SIGNATURE OF DEVELOPER

11/1/94  
DATE

REVIEWED FOR HOWARD SOIL CONSERVATION DISTRICT AND METS TECHNICAL REQUIREMENTS

*[Signature]* 2/1/95  
DATE

U.S. SOIL CONSERVATION SERVICE

THIS DEVELOPMENT IS APPROVED FOR EROSION AND SEDIMENT CONTROL BY THE HOWARD SOIL CONSERVATION DISTRICT.

APPROVED:  
*[Signature]* 2/1/95  
DATE

DIRECTOR  
HOWARD SOIL CONSERVATION DISTRICT

APPROVED: DEPT. OF PLANNING AND ZONING

*[Signature]* 3/8/95  
PLANNING DIRECTOR DATE

*[Signature]* 3/7/95  
CHIEF, DIVISION OF COMMUNITY PLANNING AND LAND DEVELOPMENT DATE

APPROVED: HOWARD COUNTY HEALTH DEPARTMENT FOR PUBLIC WATER AND SEWERAGE SYSTEMS

*[Signature]* 3/3/95  
HEALTH OFFICER DATE

APPROVED: DEPARTMENT OF PUBLIC WORKS FOR PUBLIC WATER & SEWER AND STORM DRAINAGE SYSTEMS AND ROADS.

*[Signature]* 2/22/95  
DIRECTOR, PUBLIC WORKS DATE

*[Signature]* 2/22/95  
CHIEF, BUREAU OF ENGINEERING DATE

PROPERTY/SUBDIVISION: ST JOHN'S STATION  
SECTION/AREA: 39  
PARCEL/LOT NO: 39

PLAT NO./LF: 2015/52G  
BLOCK NO: 5  
ZONE: D-1  
TAX/ZONE: 24  
ELEC. DIST: 24  
CENSUS TR: 6022

WATER CODE: FOG  
SEWER CODE: 1403700

**RETAINING WALL DETAILS**

**ST JOHN'S STATION**

TAX MAP 24 LIDER 2015 FOLIO 52G PARCEL 39  
2ND ELECTION DIST. HOWARD COUNTY, MARYLAND  
SCALE: AS SHOWN DATE: SEPTEMBER 1994  
SHEET 8 OF 8