GENERAL NOTES

- BE BONDED AND UNDER THE TERMS OF A DPW DEVELOPER AGREEMENT. EXECUTION OF THE DPW DEVELOPER

- TOTAL ADDITIONAL DISTURBANCES FROM THE ORIGIONAL SITE PLAN EXCEED 5,000SF OF NEW IMPERVIOUS AREA, (REDLINE #2 ADDS 2,946 SF OF NEW IMPERVIOUS AREA, NETTING 2,054 OF NEW
- 10. OH 5/31/22 THE HOWARD COUNTY BOARD OF APPEALS HEARING EXAMINER APPROVED CASE NO BA-21-643C FOR A CONDITIONAL USE FOR A PRIVATE SCHOOL (ACADEMIC) SEC. 131_O.H.48 FOR K-8th GRADE.
- cla 5565 : 8:30 mm 3:15 pm DISMISSAI : 3:15pm - 3:30 pm AFTERCARE: 3:30pm-6:00pm
- OPERATING HOURES MONDAY THROUGH FRIDAY: MORNING DROP-OFF: 7:30 -8:30am
- ** 11. PARKING REQUIREMENTS FOR SCHOOL:
- FOR A MAXIMUM 120 STUDENTS, AT 1 SPACE PER G STUDENTS
 A TOTAL OF SPACES REQUIRED = 20 SPACES
- TOTAL NUMBER OF SPACES AVAILABLE = 109 SPACES. THE SCHOOL OPERATING HOURS DO NOT OVERLAP WITH THE RELIGIOUS OPERATING TIMES OF THE FACILITY. 12 TRAFFIC STUDY:
- A. DATE OF REPORT: AUGUST 2022
- 8. DATE OF COUNTS: 11/8/2018 HARRIET TUBMAN/CEDAR LANE, 5/3/2022 HARRIET TUBMAN / FREETOWN
- C. REPORT SUBMITTED AS PART OF PLAY No: SDP- 94-031 D SCHOOLS WERE IN SEGSION ON COUNT DATES
 - E. INTERSECTIONS STUDIED: HARRIST TUBMAN / CEDAR LANE, HARRIST TUBMAN / FREETOWN LOS FOR BOTH 15 'A'

SITE DEVELOPMENT PLAN

TEMPLE BETH SHALOM

5TH ELECTION DISTRICT


TAX MAP 35 BLOCK 24 PARCEL 256

HOWARD COUNTY, MARYLAND

SHEET INDEX

	· ar
SHEET NO.	TITLE / DESCRIPTI

- COVER SHEET
- SITE DEVELOPMENT PLAN
- SWM OUTFALL PLAN
- SITE DETAILS & LANDSCAPE DETAILS
- STORMWATER MANAGEMENT PROFILES & DETAILS
- STORMWATER MANAGEMENT PROFILES & DETAILS
- STORMWATER MANAGEMENT PROFILES & DETAILS
- SEDIMENT CONTROL PLAN
- SEDIMENT CONTROL PLAN
- SEDIMENT CONTROL DETAILS & NOTES
- LANDSCAPE PLAN
- CLASS ROOM ADDITION PLAN

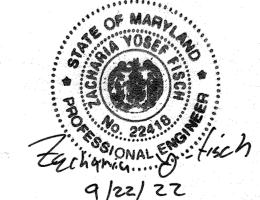

FOR REVISION 8 ONLY

BLDG.

					PARC 25	CEL NO.
PLAT NO. OR L/F L. 2548 F 388	BLOCK NO. 24	ZONE R-20	TAX/ZONE 35	MAP	ELEC. DIST. 5+h	CENSUS TR
WATER CODE:	E 29			SEV	WER CODE: 53225	

COLUMBIA

PATUXENT RIVER

Table B.1: Temporary Seeding for Site Stabilization

Seeding rates for the warm-season grasses are in pounds of Pure Live Seed (PLS). Actual planting rates shall be adjusted to reflect percent seed germination and purity, as

seeding mix. Cereal rye generally should not be used as a nurse crop, unless planting will occur in very late fall beyond the seeding dates for other temporary seedings. Cereal rye has allelopathic properties that inhibit the germination and growth of other plants. If it must be used as a nurse crop, seed at 1/3 of the rate listed above.

The planting dates listed are averages for each Zone and may require adjustment to reflect local conditions, especially near the boundaries of the zone

Seeding rates listed above are for temporary seedings, when planted alone. When planted as a nurse crop with permanent seed mixes, use 1/3 of the seeding rate listed above for barley, oats, and wheat. For smaller-seeded grasses (annual ryegrass, pearl millet, foxtail millet), do not exceed more than 5% (by weight) of the overall permanent

lb/ac lb/1000 ft²

Oats are the recommended nurse crop for warm-season grasses

2/ For sandy soils, plant seeds at twice the depth listed above.

ADDRESS CHART

OWNER/DEVELOPER

4221 EAGLESWING COURT &

ELLICOTT CITY, MD. ZIO4Z

% DAVID ISENBERG

(410) AG1-59ZO

BETH SHALOM CONGREGATION

8070 HARRIET TUBMAN LANE

SIMPSONVILLE

IN LIBER Z548 / FOLIO 388

Recommended Seeding Dates by Plant Hardiness Zone

May 16 to Jul 31

May 1 to Aug 14

0.5 Mar 15 to May 31; Aug 1 to Sep 30 Mar 1 to May 15; Aug Feb 15 to Apr 30; Au 1 to Oct 15 Feb 15 to Nov 30

VICINITY MAP

SCALE: 1"= 2000'

-TITLE REFERENCE: PROPERTY SHOWN HEREON WAS CONVEYED BY ROLAND FAIRCHILD TO TEMPLE BETH SHALOM OF HOWARD COUNTY BY DEED DATED JUNE 29, 1991 RECORDED

FOLLOWING HOWARD COUNTY CONTROL

STA 2439001 EL: 418.62 N 494415.124 E 833503.03

STA. 2440001 EL: 420.85 N493066.296 E 834257.523 STA . 2340005 EL .: 376.62 N 490322.089 E 835244.758

-HORIZONTAL AND VERTICAL CONTROLS SHOWN HEREON IS BASED ON THE

TEMPLE BETH SHALOM

COVER SHEET

SDP-94-31

KCI TECHNOLOGIES, INC **ENGINEERS - PLANNERS - SURVEYORS** 8308 PATUXENT RANGE ROAD JESSUP, MARYLAND 20794-8609

(410) 792-8088 (BALT.) DATE: JULY 1993 SCALE:

SHEET NO. OF 12

PHONE: (301) 953-1821 (WASH.)

HOWARD COUNTY BOARD OF APPEALS

1. The Petitioner shall comply with all applicable

2. All exterior lighting shall be directed downward and

3. The exterior walls of the proposed structure are to be

4. No private bus service shall be provided to students

5. Phase II approval for the religious facility shall be void unless Phase II construction is completed within ten (10) years of the date of this Decision and Order.

constructed as indicated in the testimony presented or with similar materials or of other materials compatible with the

inward so as not to shine onto vicinal properties or roads.

SUPERCEDED BY BA 93-40E

APPROVAL CONDITIONS:

Temple Beth Shalom, Petitioner

Case No. BA 93-40E

TANGUE STATES

SPECIAL EXCEPTION BA 93-04E APPROVED JUNE 4, 1991

SPECIAL EXCEPTION BA 93-40E APPROVED JAN. 25, 1994

DATE

PLANNING AND ZONING DATE Gima Duunnany CHIEF, DIVISION OF LAND

APPROVED: HOWARD COUNTY DEPARTMENT OF

DATE DEVELOPMENT AND REGEARCH ZYF 8 ADD GEP. NOTES 10, 11 & 12. 9/22/22 RHV 7 ADD DETAIL FOR ELEVATED WALK 02/06/ 6 ADD PROPOSED CLASS ROOM ACCOUNTION TO EX BUILDING RHV 5 REVISE TO INCORPORATE PROPOSED IMPROVEMENTS 2/24/14

REVISION

BY NO.

APPROVED: FOR PUBLIC WATER AND PUBLIC SEWERAGE STORM DRAINAGE SYSTEMS AND PUBLIC ROADS. HOWARD COUNTY DEPARTMENT OF PUBLIC WORKS

DIRECTOR DATE

5/13/94 CHIEF BUREAU OF ENGINEERING SING

COUNTY HEALTH OFFICER

APPROVED: FOR PUBLIC WATER AND PUBLIC SEWERAGE SYSTEMS, HOWARD COUNTY HEALTH DEPARTMENT

THESE PLANS HAVE BEEN REVIEWED FOR THE HOWARD SOIL CONSERVATION DISTRICT AND MEET THE TECHNICAL REQUIREMENTS FOR SOIL EROSION AND SEDIMENT

IMPROVEMENTS

FOREST CONSERVATION TRACT AREA

(REF: SDP-16-002)

SCALE: 1"=100"

THESE PLANS FOR SOIL EROSION AND SEDIMENT CONTROL MEET THE REQUIREMENTS OF THE HOWARD

CERTIFICATE BY DEVELOPER

I/WE CERTIFY THAT ALL DEVELOPMENT AND/OR CONSTRUCTION WILL BE DONE ACCORDING TO THESE PLANS, AND THAT ANY RESPONSIBLE PERSONNEL INVOLVED IN THE CONSTRUCTION PROJECT WILL HAVE A CERTIFICATE OF ATTENDANCE AT A DEPARTMENT OF THE ENVIRONMENT APPROVED TRAINING PROGRAM FOR THE CONTROL OF SEDIMENT AND EROSION BEFORE BEGINNING THE PROJECT. I AUTHORIZE PERIODIC ON-SITE INSPECTIONS BY THE HOWARD SOIL CONSERVATION DISTRICT.

(PRINT NAME BELOW SIGNATURE) DAVID I SENDENG

ENGINEER CERTIFICATE

Bolling W. Haxall Reg # 10242

WAS PREPARED IN ACCORDANCE WITH THE REQUIREMENTS


CERTIFY THAT THIS PLAN FOR EROSION AND


OF THE HOWARD SOIL CONSERVATION DISTRICT.


KNOWLEDGE OF THE SITE CONDITIONS. THIS PLAN


SEDIMENT CONTROL REPRESENTS A PRACTICAL

AND WORKABLE PLAN BASED ON MY PERSONAL

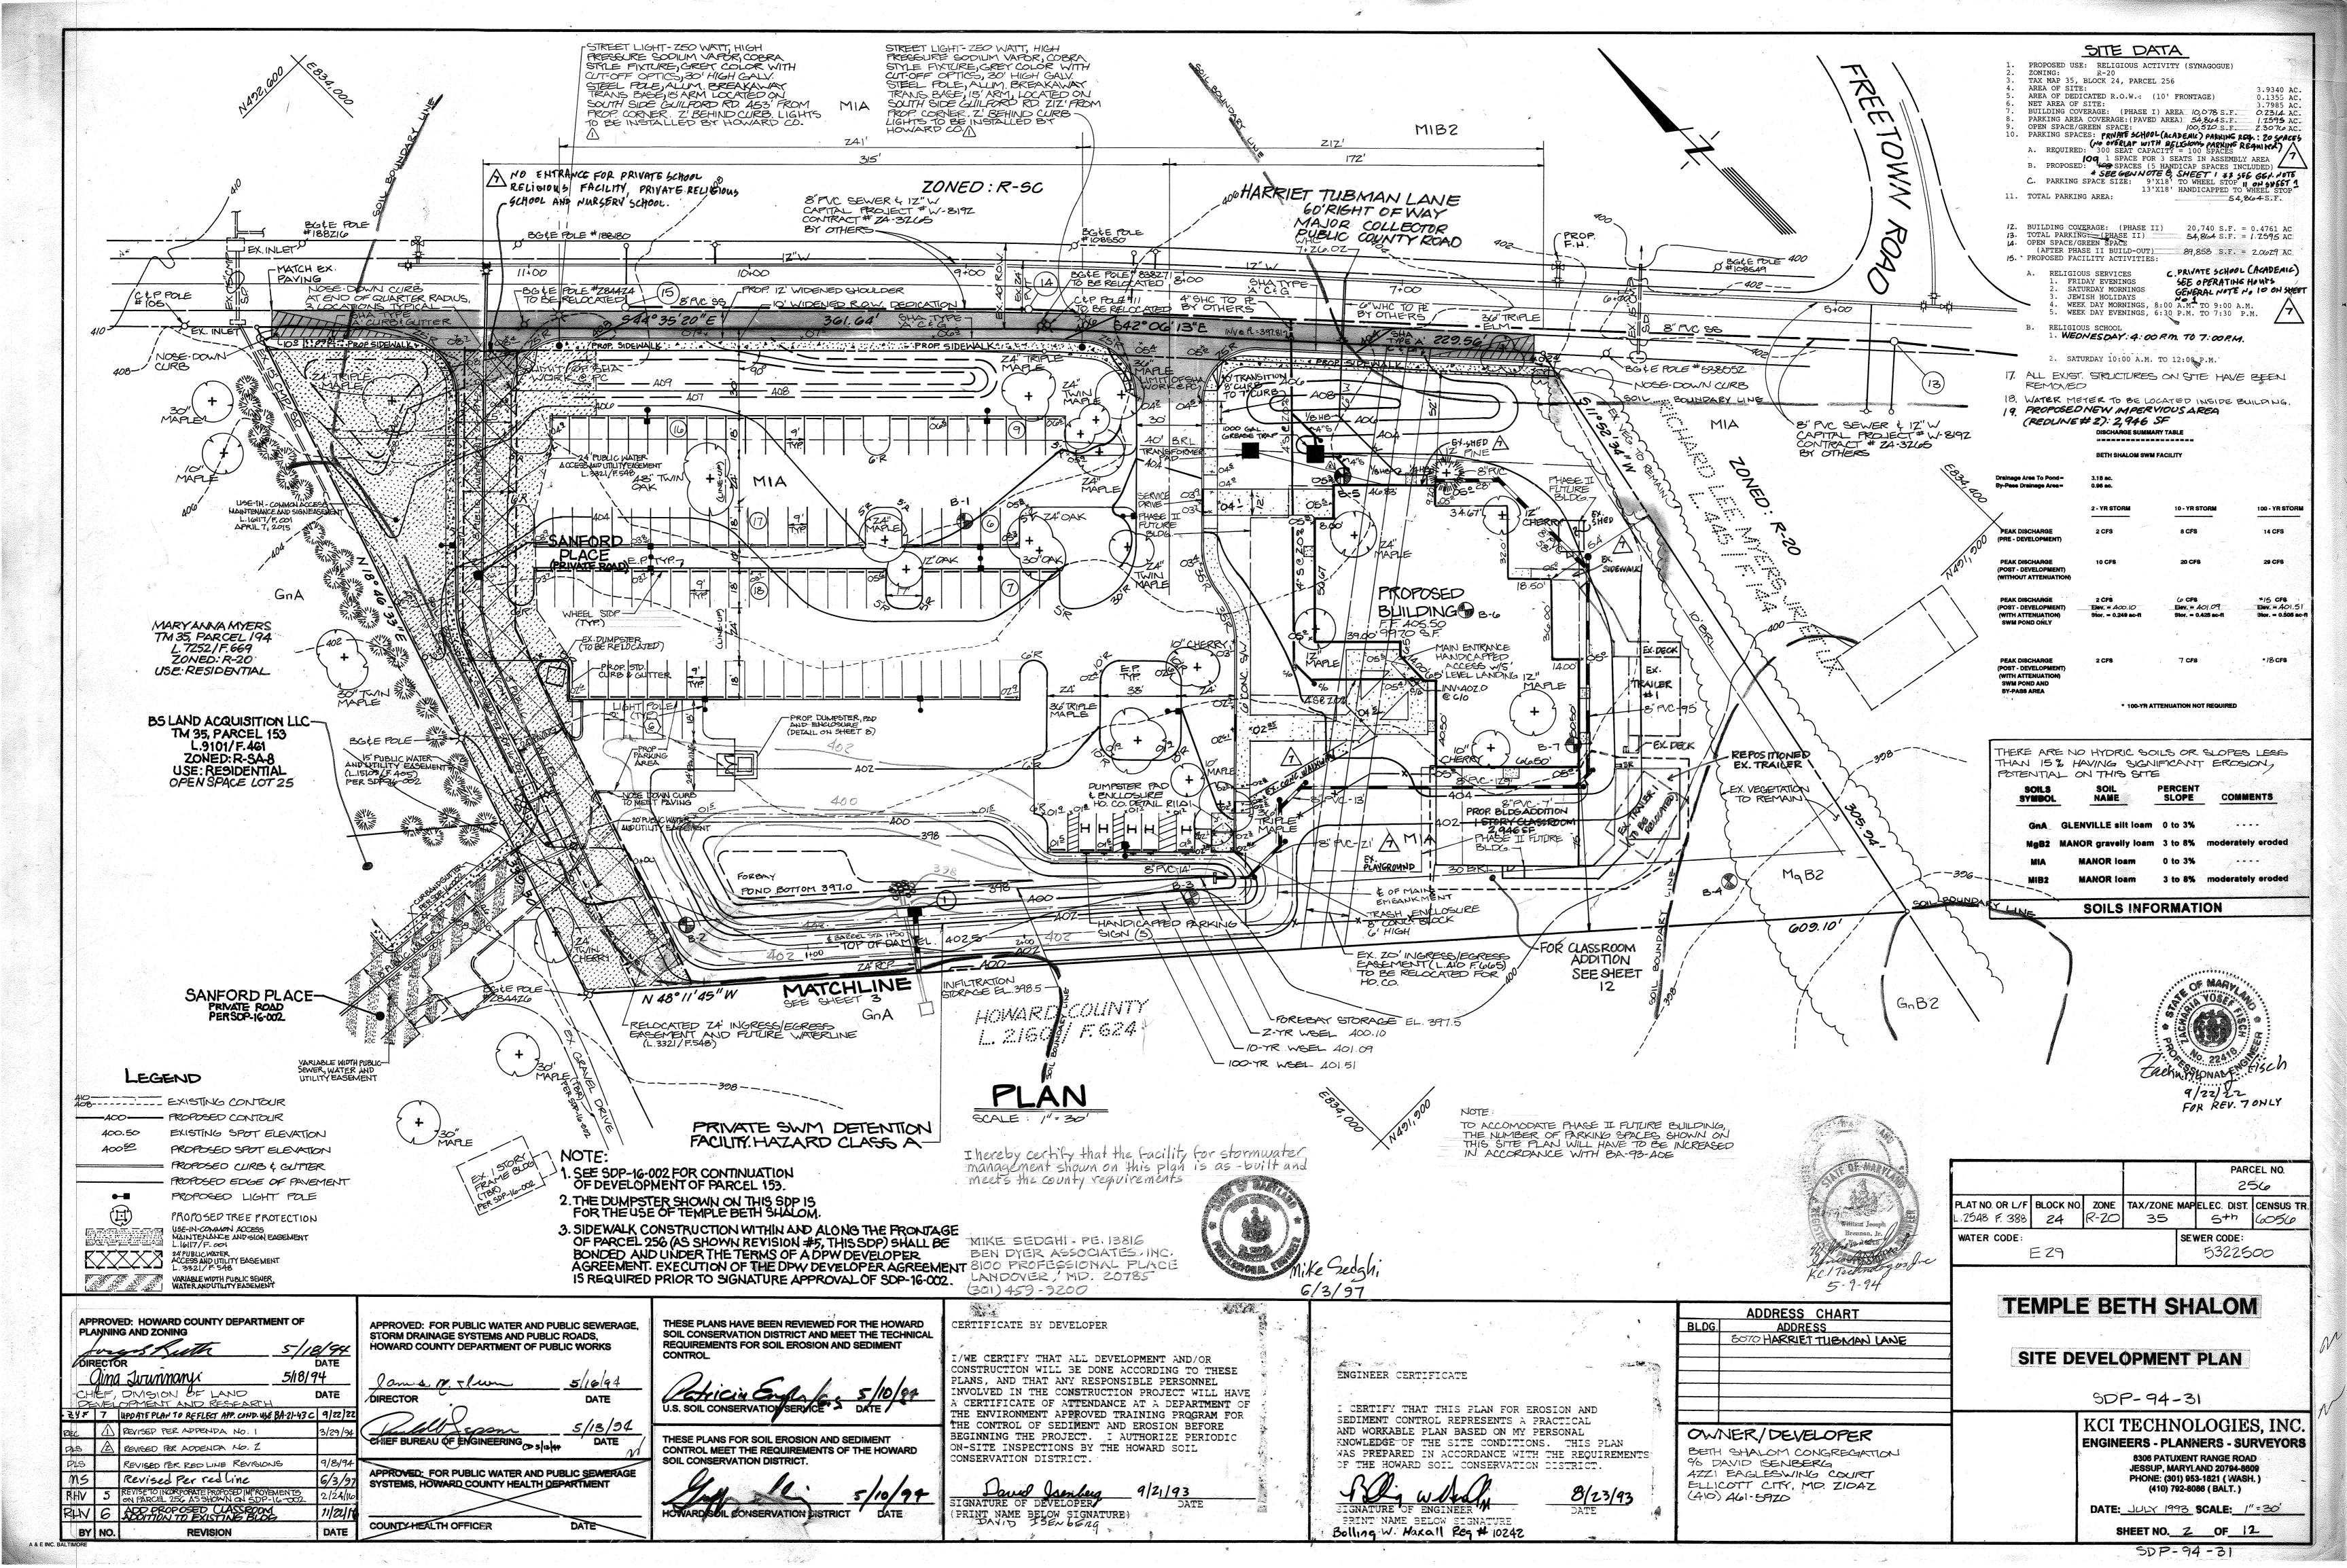

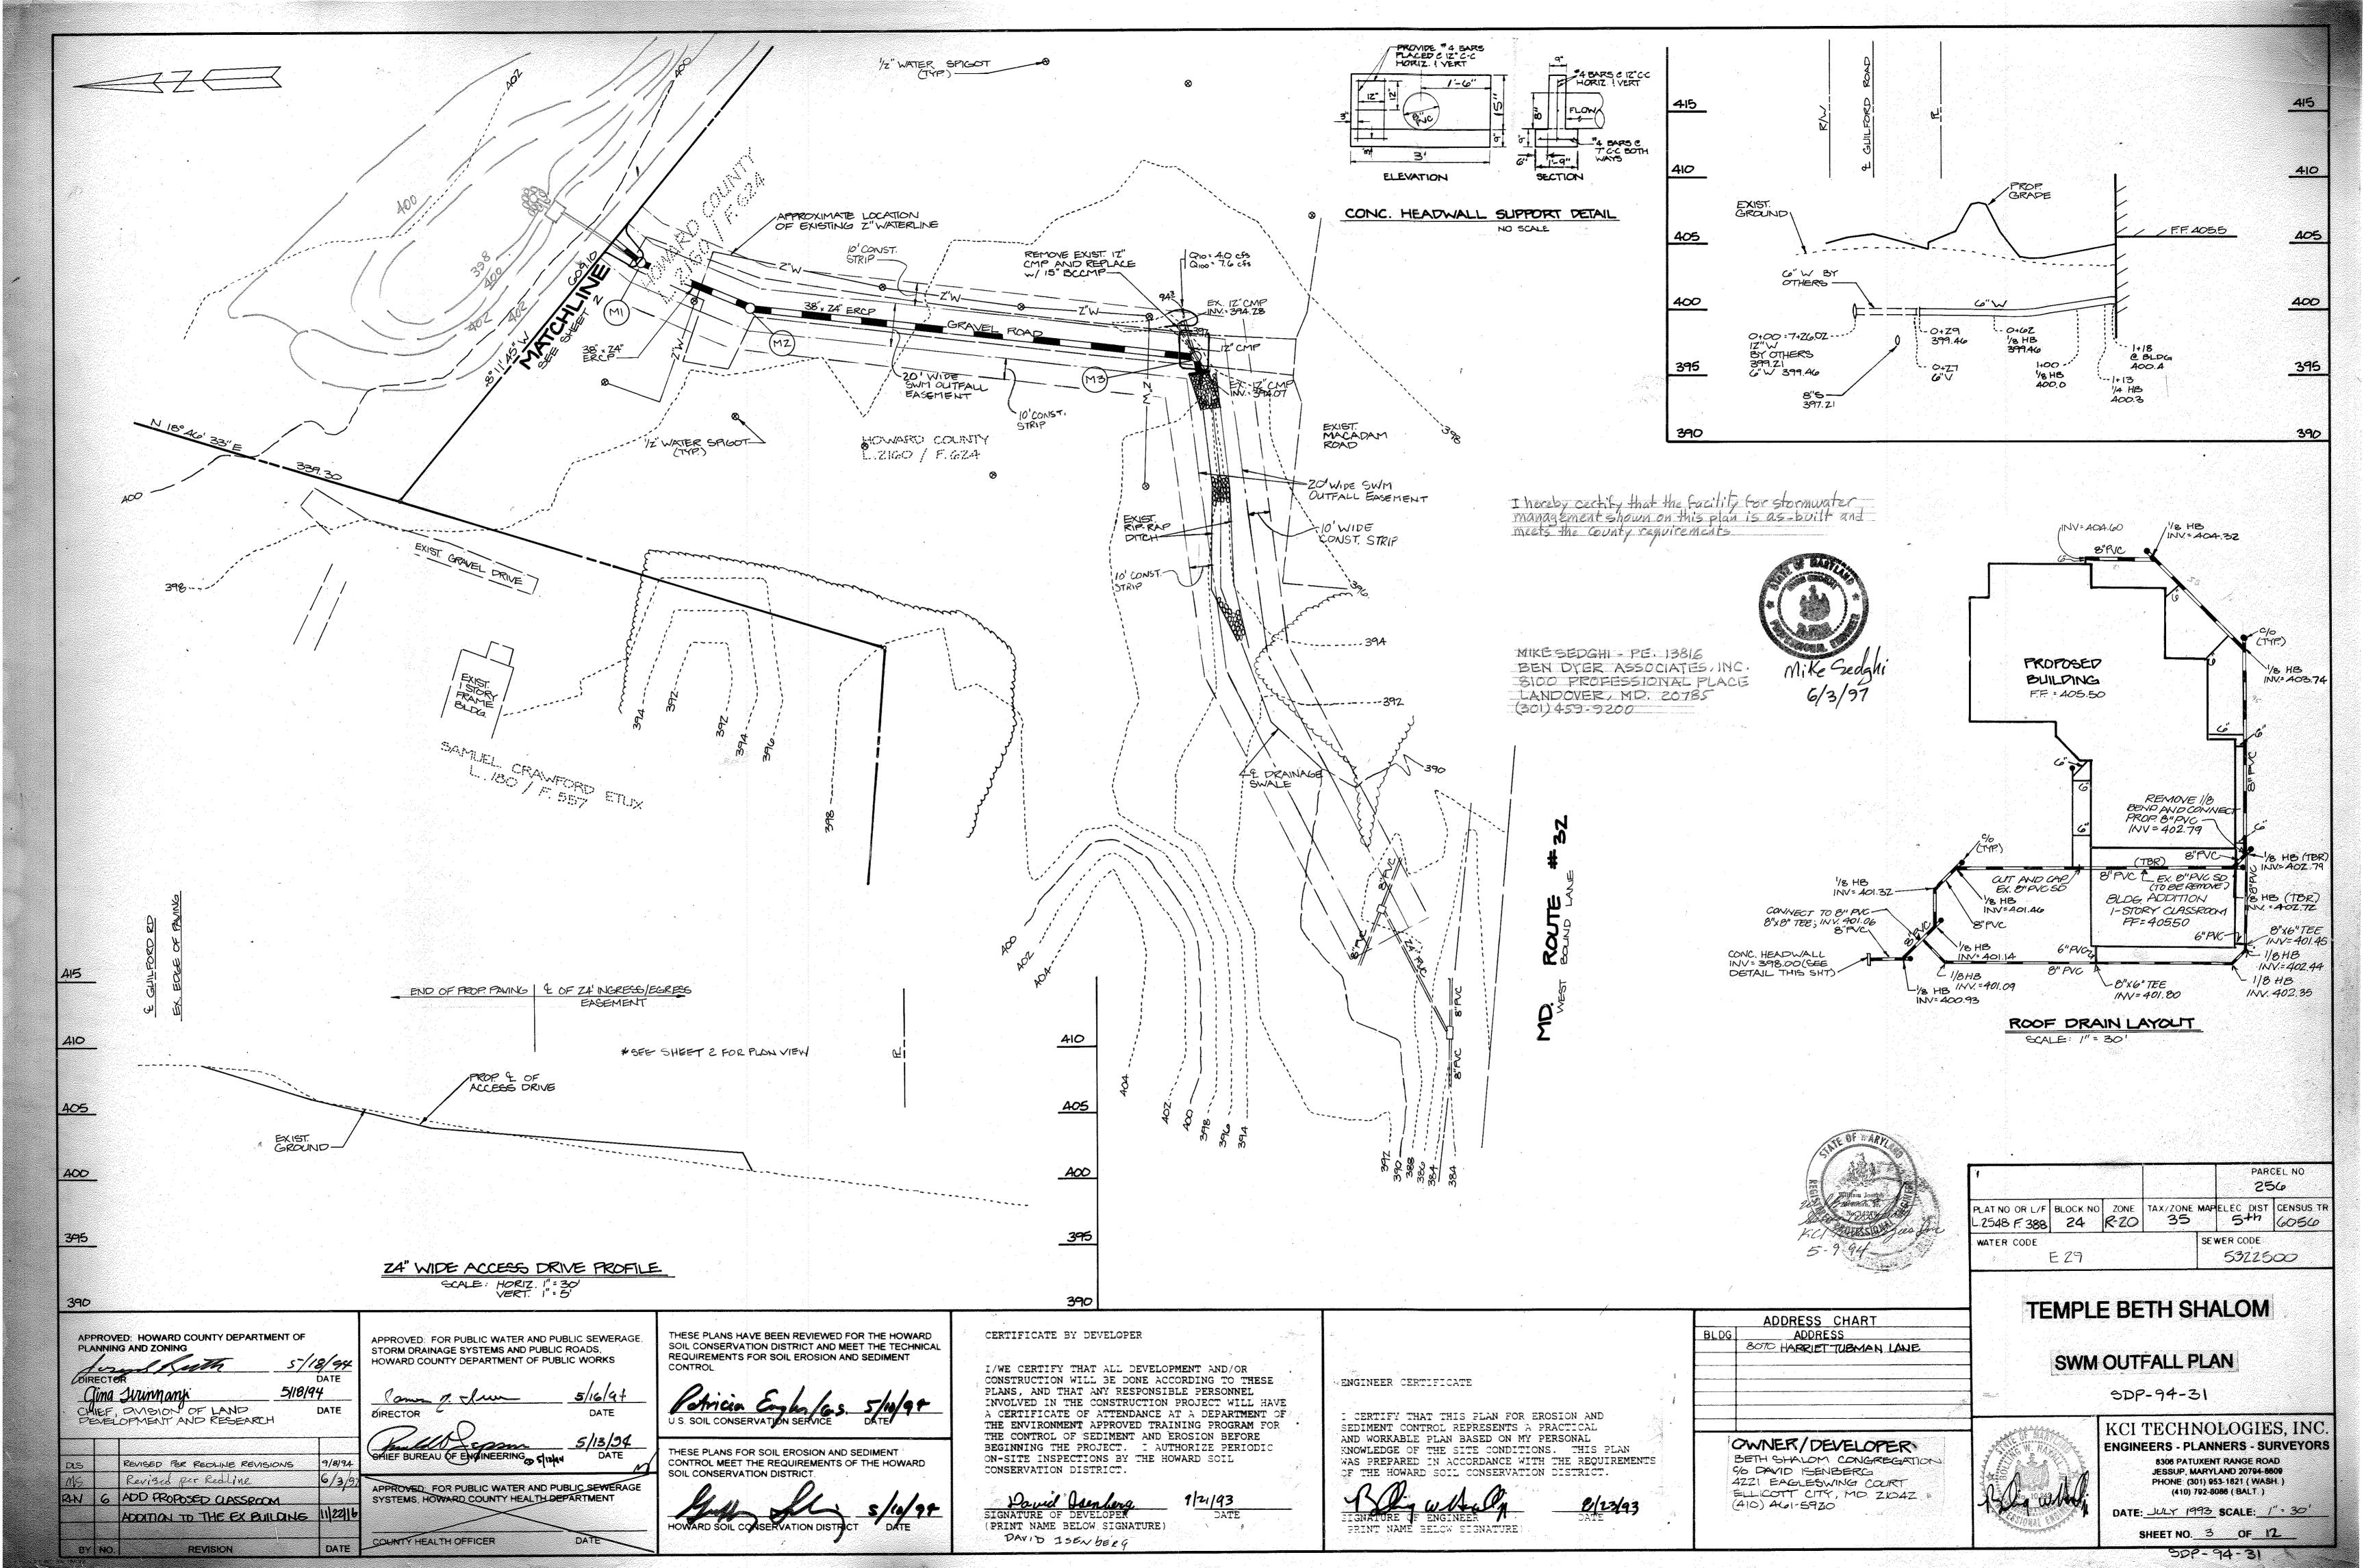

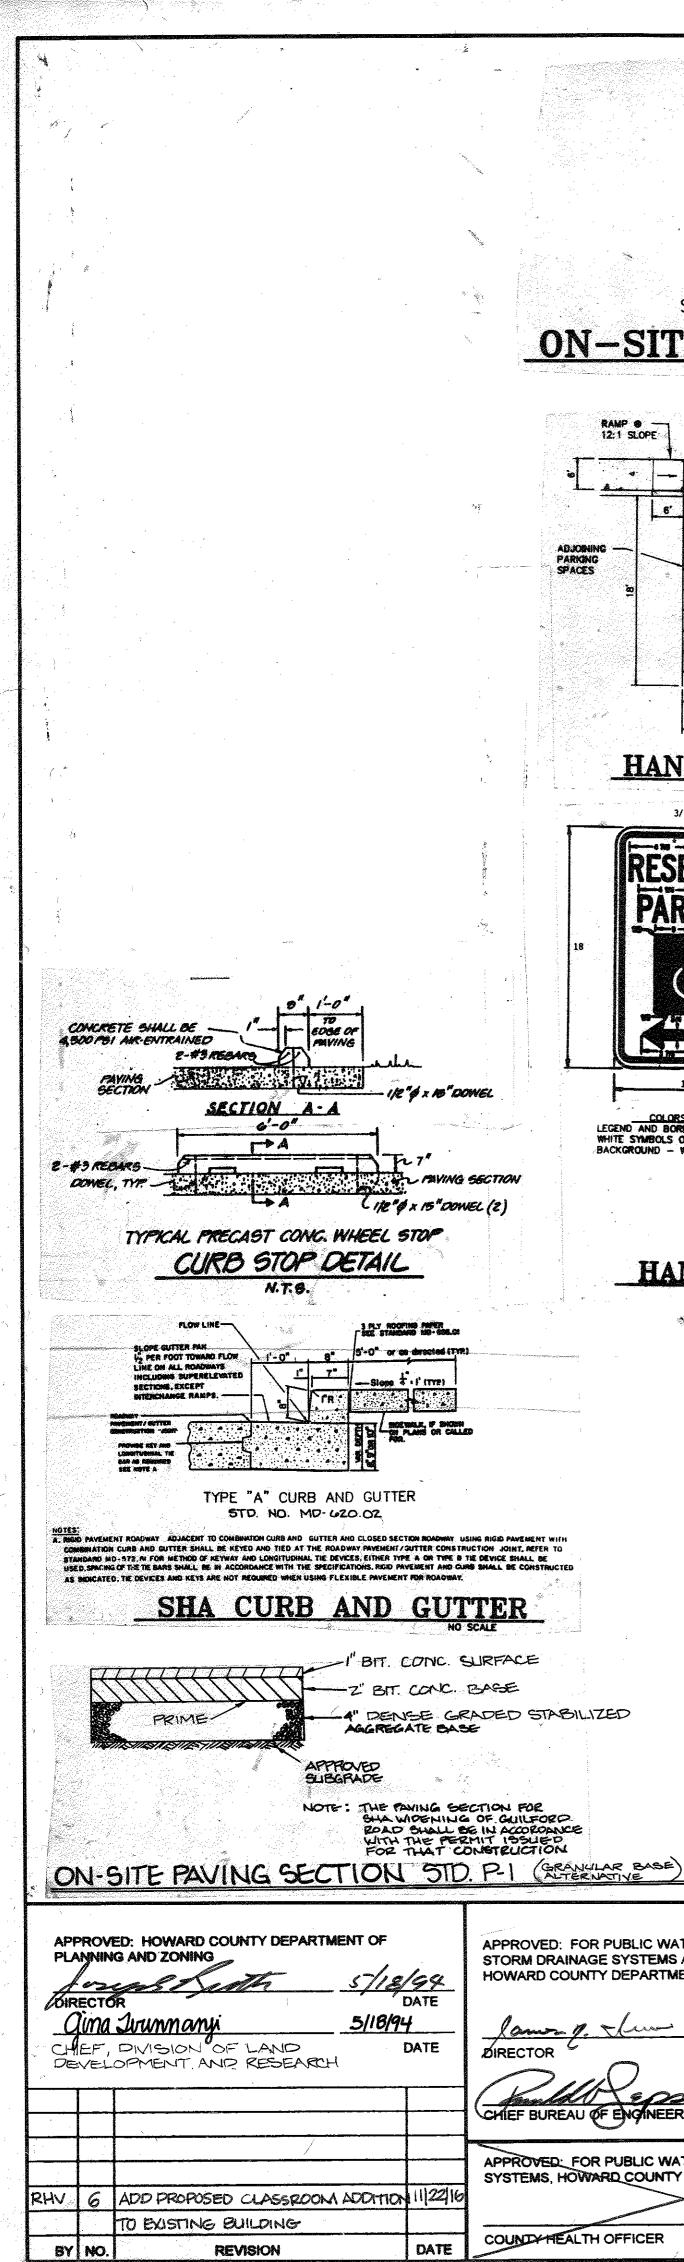

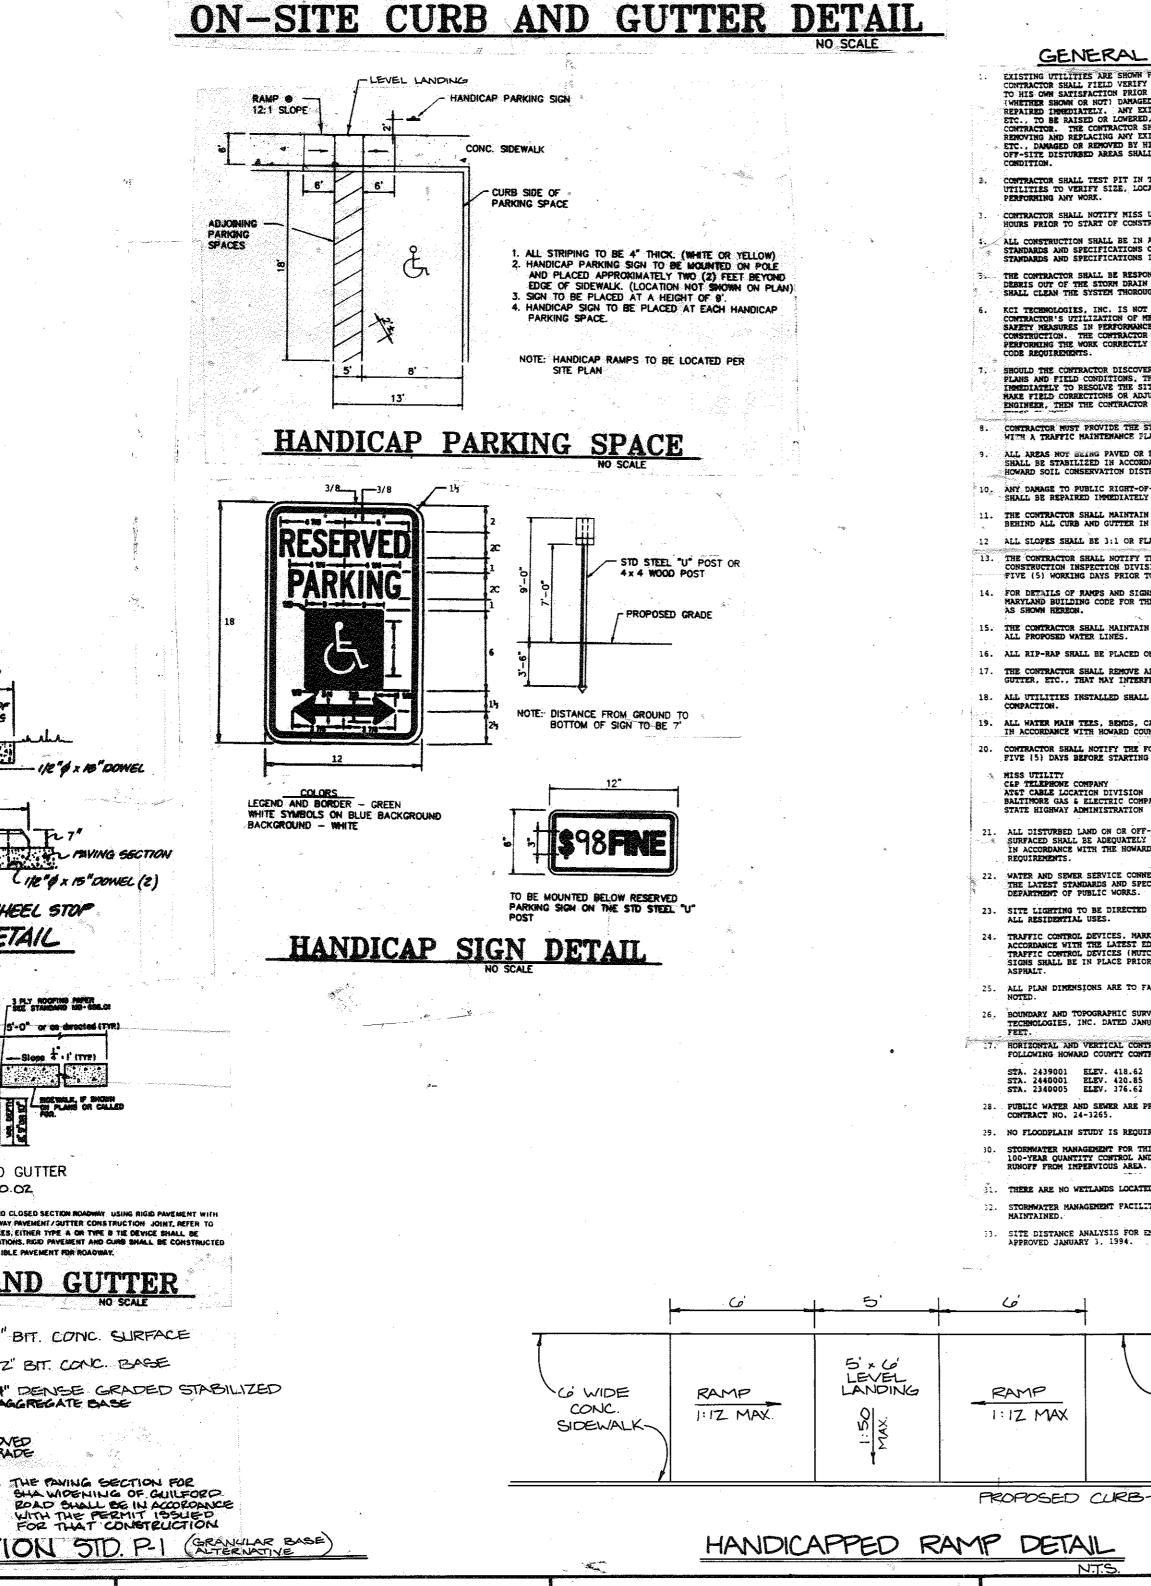

APPROVED: FOR PUBLIC WATER AND PUBLIC SEWERAGE,

APPROVED: FOR PUBLIC WATER AND PUBLIC SEWERAGE SYSTEMS, HOWARD COUNTY HEALTH DEPARTMENT

STORM DRAINAGE SYSTEMS AND PUBLIC ROADS,

CHIEF BUREAU OF ENGINEERING CO STOLLY

COUNTY HEALTH OFFICER

DIRECTOR

HOWARD COUNTY DEPARTMENT OF PUBLIC WORKS

THESE PLANS HAVE BEEN REVIEWED FOR THE HOWARD

REQUIREMENTS FOR SOIL EROSION AND SEDIMENT

THESE PLANS FOR SOIL EROSION AND SEDIMENT

IOWARD SOIL CONSERVATION DISTRICT

SOIL CONSERVATION DISTRICT.

CONTROL MEET THE REQUIREMENTS OF THE HOWARD

CONTROL.

DATE


SOIL CONSERVATION DISTRICT AND MEET THE TECHNICAL

PAVENENT MIOTH INDICATED ON TYPICAL STREET

DEPRESSED CURB AT

- S.M.A. BIE RS. 8 CONCRET

STANDARD 7" COMBINATION CURB AND GUTTER

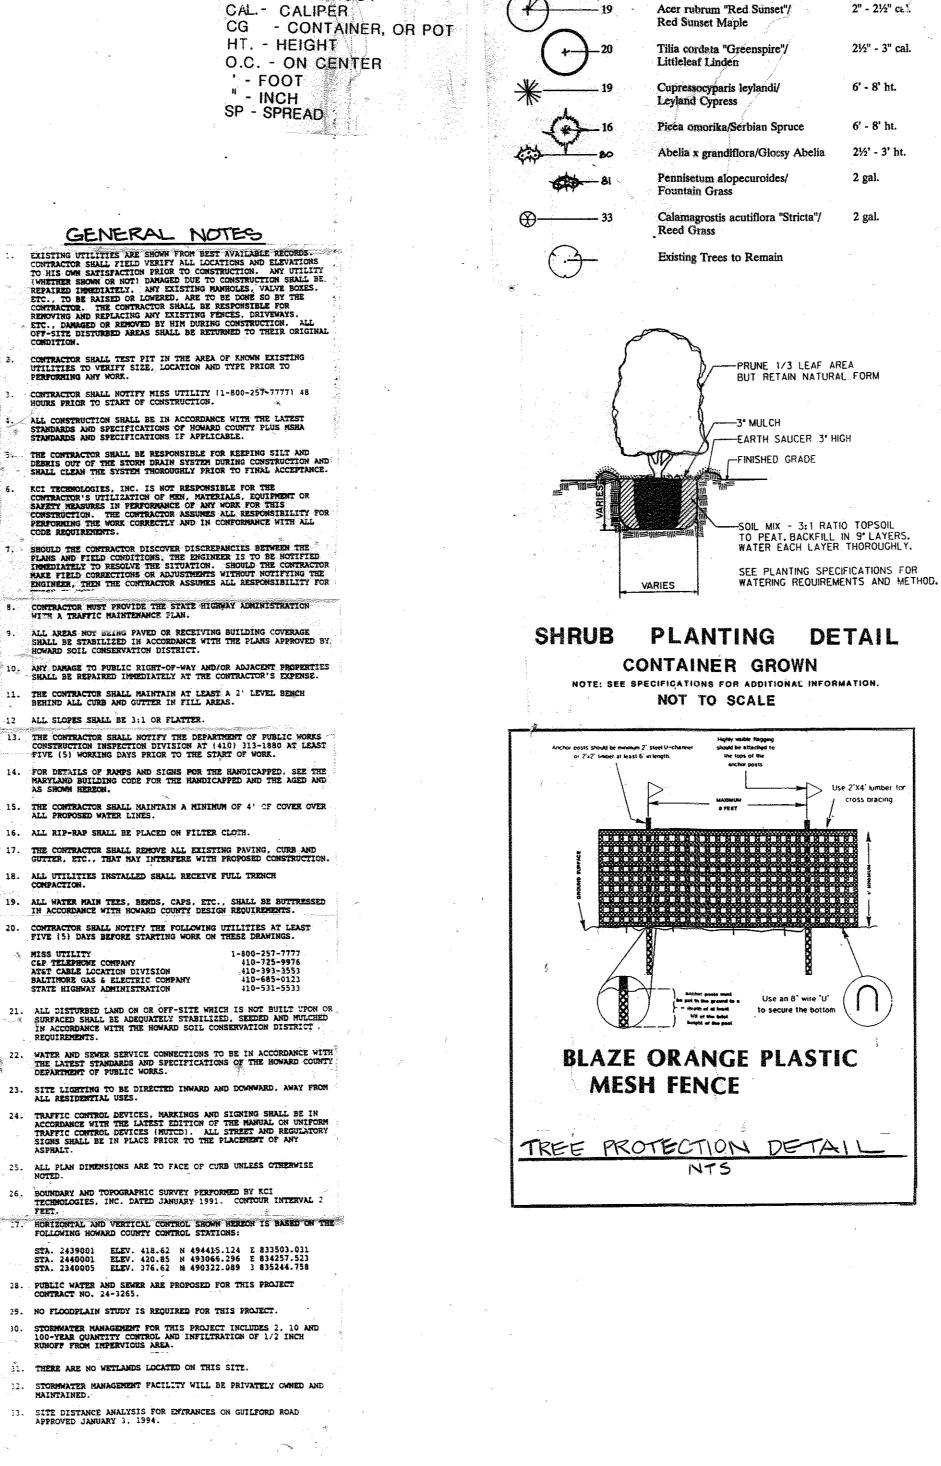

LIST OF ABBREVIATIONS

BB - BALLED IN BURLAP

AMER. - AMERICAN

B.R. - BARE ROOT

6 WIDE

CONC.

CERTIFICATE BY DEVELOPER

CONSERVATION DISTRICT.

(PRINT NAME BELOW SIGNATURE)

SIDEWALK -

I/WE CERTIFY THAT ALL DEVELOPMENT AND/OR

PLANS, AND THAT ANY RESPONSIBLE PERSONNEL

CONSTRUCTION WILL BE DONE ACCORDING TO THESE


INVOLVED IN THE CONSTRUCTION PROJECT WILL HAVE A CERTIFICATE OF ATTENDANCE AT A DEPARTMENT OF

THE ENVIRONMENT APPROVED TRAINING PROGRAM FOR


THE CONTROL OF SEDIMENT AND EROSION BEFORE

ON-SITE INSPECTIONS BY THE HOWARD SOIL


BEGINNING THE PROJECT. I AUTHORIZE PERIODIC

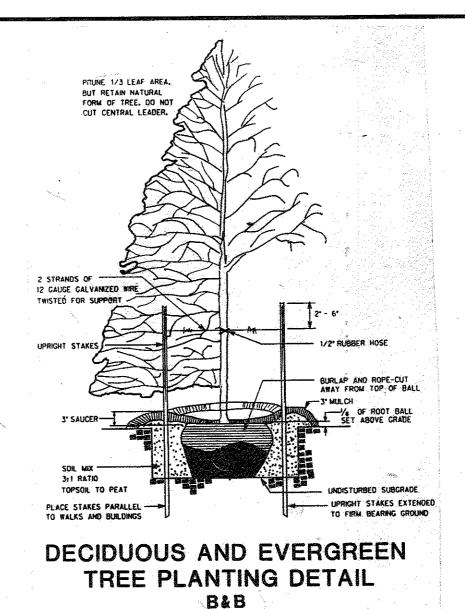

NOTE: SEE SPECIFICATIONS FOR ADDITIONAL INFORMATION NOT TO SCALE

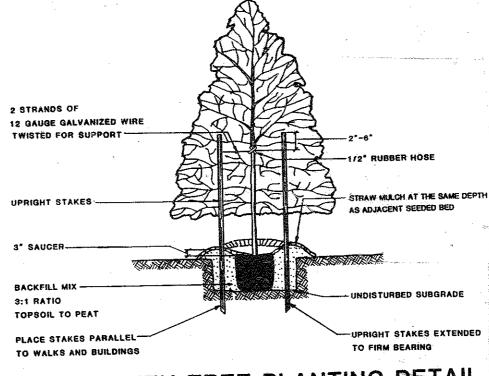

EVERGREEN TREE PLANTING DETAIL CONTAINER GROWN NOTE: SEE SPECIFICATIONS FOR ADDITIONAL INFORMATION NOT TO SCALE

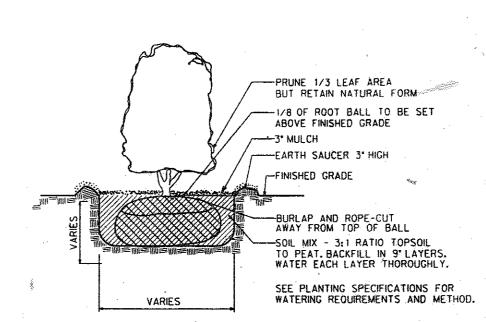

PLANTING DETAIL B&B

NOTE: SEE SPECIFICATIONS FOR ADDITIONAL INFORMATION NOT TO SCALE

deficiencies in the work and the necessary corrective measures. A reasonable amount of time will be given and another final inspection will be scheduled by the Owner's Representative. Owner Maintenance -- After the planting has been approved by the Owner's Representative and the Owner, the maintenance of watering and weeding of

PLANTING SPECIFICATIONS

necessary to complete the work as shown on the plans and details.

The Contractor shall furnish and install all plant materials, labor and other materials

A. The materials and methods shall comply with all the requirements of the current edition of the 'Landscape Specification Guidelines' as prepared by the Landscape Contractors Association (LCA) and as modified herein.

1. If a plant is found not to be suitable or available, the Landscape Contractor is to notify the Owner's Representative before bidding.

2. The Owner or Owner's Representative is then required to select a

The Landscape Contractor must verify the correct location of any existing utilities which are underground, prior to any excavation or plant installation. The Landscape Contractor shall call Miss Utility (1-800-257-7777) a minimum

D. Plant Material Sources - The Landscape Contractor shall, at least ten (10) days before beginning planting operations, submit a list of planting material sources giving the nursery address and phone number for each plant material

E. Total number of plants shall be as shown on the landscape plan. If this total

'Landscape Specification Guidelines' as prepared by LCA.

differs from the plant schedule, the Landscape Contractor is to notify the

Time of Planting - Planting season schedule shall be in accordance with the

Installation of pines and oaks shall be during spring planting season only. No

Mulch - Mulch shall be shredded hardwood bark. The Landscape Contractor

shall provide a one (1) lb. sample to the Owner's Representative for his

approval. Mulch shall be applied to a depth of three (3) inches within 24

The Landscape Contractor shall prune plant material within two (2) days of

installation in accordance with the details and as directed by the Owner's

All disturbed areas within the limit of contract which are not paved, sodded

or otherwise planted shall be seeded. The following seed mixture and rate of

100% Tall Fescue cultivars* - certified Apache, Arid, Bonanza, Houndog,

Jagura, Mustang, Olympic II, Rebel, Rebel II, Titan or other approved equal

* One or more of the above listed tall fescue cultivars must be chosen. If

more than one is chosen, each cultivar should account for a minimum of 10%

This mixture shall be applied at the rate of five to eight (5-8) pounds per

During the course of planting, excess and waste materials small be

continuously and promptly removed, lawn areas kept clear, and all

reasonable precautions taken to avoid damage of existing lawns,

pavements, sodded and planted areas, structures and substructures, not

specifically provided for in the Contract, which are disturbed by the

Landscape Contractor during planting operations. Such restoration

shall be in a manner satisfactory to the Owner's Representative and at

2. The Landscape Contractor shall restore to their original condition all

Water - Water for planting and maintenance purposes, will be supplied by the Owner. The Landscape Contractor shall provide all equipment necessary to

Contractor will be required to water all plants promptly, adequately and as

often as necessary to insure proper plant growth and to keep the soil moist and in a condition satisfactory to the Owner's Representative. The Landscape

Contractor will be responsible for watering all plants from the time of planting

Final Inspection - The Owner's Representative shall make a final inspection

and notify the Landscape Contractor in writing, when all work is satisfactorily

completed. If work is not satisfactorily completed, the Owner's Representative will notify the Landscape Contractor, in writing, as to the

port the water from source to required locations. The Landscap

1,000 s.f. sown in two (2) directions at right angles.

no additional cost to the Owner.

source of availability of the original plant.

of 48 hours prior to construction.

hours of installation of plant materials.

H. Tree wrap shall not be utilized.

of the mixture by weight.

Clean-Up and Restoration

until the final inspection.


reasonable alternate, or to inform all Landscape Contractors of the

DESCRIPTION

MATERIALS AND METHODS

such plants and planted areas shall be provided by the Owner. Since the plants are to be guaranteed by the Landscape Contractor for one year from final inspection, he should check the maintenance conducted by the Owner. The Landscape Contractor shall also make monthly site inspections after installation of trees during the guarantee period and shall right any trees that are not vertically true. If the Landscape Contractor is not satisfied with the maintenance of the plants, a written report, in triplicate, stating appropriate changes shall be given immediately to the Owner's Representative; two copies will be forwarded to the Owner.

O. Payment - Terms of payment shall be as specified in the bid package.

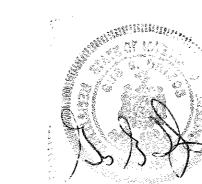




				PARCEL NO. 5		
PLAT NO OR L/F L.2548 F.388		ZONE R-20	TAX/ZONE ろう	MAP	ELEC DIST	CENSUS TR
WATER CODE:				SEWER CODE: 53ZZ500		

TEMPLE BETH SHALOM

LANDSCAPE AND SITE DETAILS

SDP-94-31

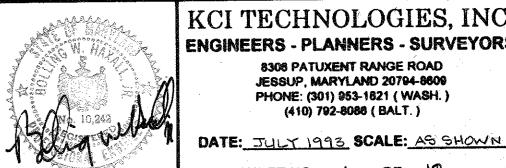

KCI TECHNOLOGIES, INC ENGINEERS - PLANNERS - SURVEYORS

> 8308 PATUXENT RANGE ROAD JESSUP, MARYLAND 20794-8609 PHONE: (301) 953-1621 (WASH.) (410) 792-8088 (BALT.)

SHEET NO. 4 OF 12 50P-94-31

FOR LANDSCAPE PURPOSES ONLY ADDRESS CHART ADDRESS BLDG. 8070 HARRIET TUBMAN LANE

CERTIFY THAT THIS PLAN FOR EROSION AND SEDIMENT CONTROL REPRESENTS A PRACTICAL AND WORKABLE PLAN BASED ON MY PERSONAL KNOWLEDGE OF THE SITE CONDITIONS. THIS PLAN WAS PREPARED IN ACCORDANCE WITH THE REQUIREMENTS

PLANT SCHEDULE

CG

CG


CG


KEY QUANTITY BOTANICAL/COMMON NAME

Kwanzan Cherry

ENGINEER CERTIFICATE

OF THE HOWARD SOIL CONSERVATION DISTRICT. OF ENGINEER PRINT NAME BELOW SIGNATURE

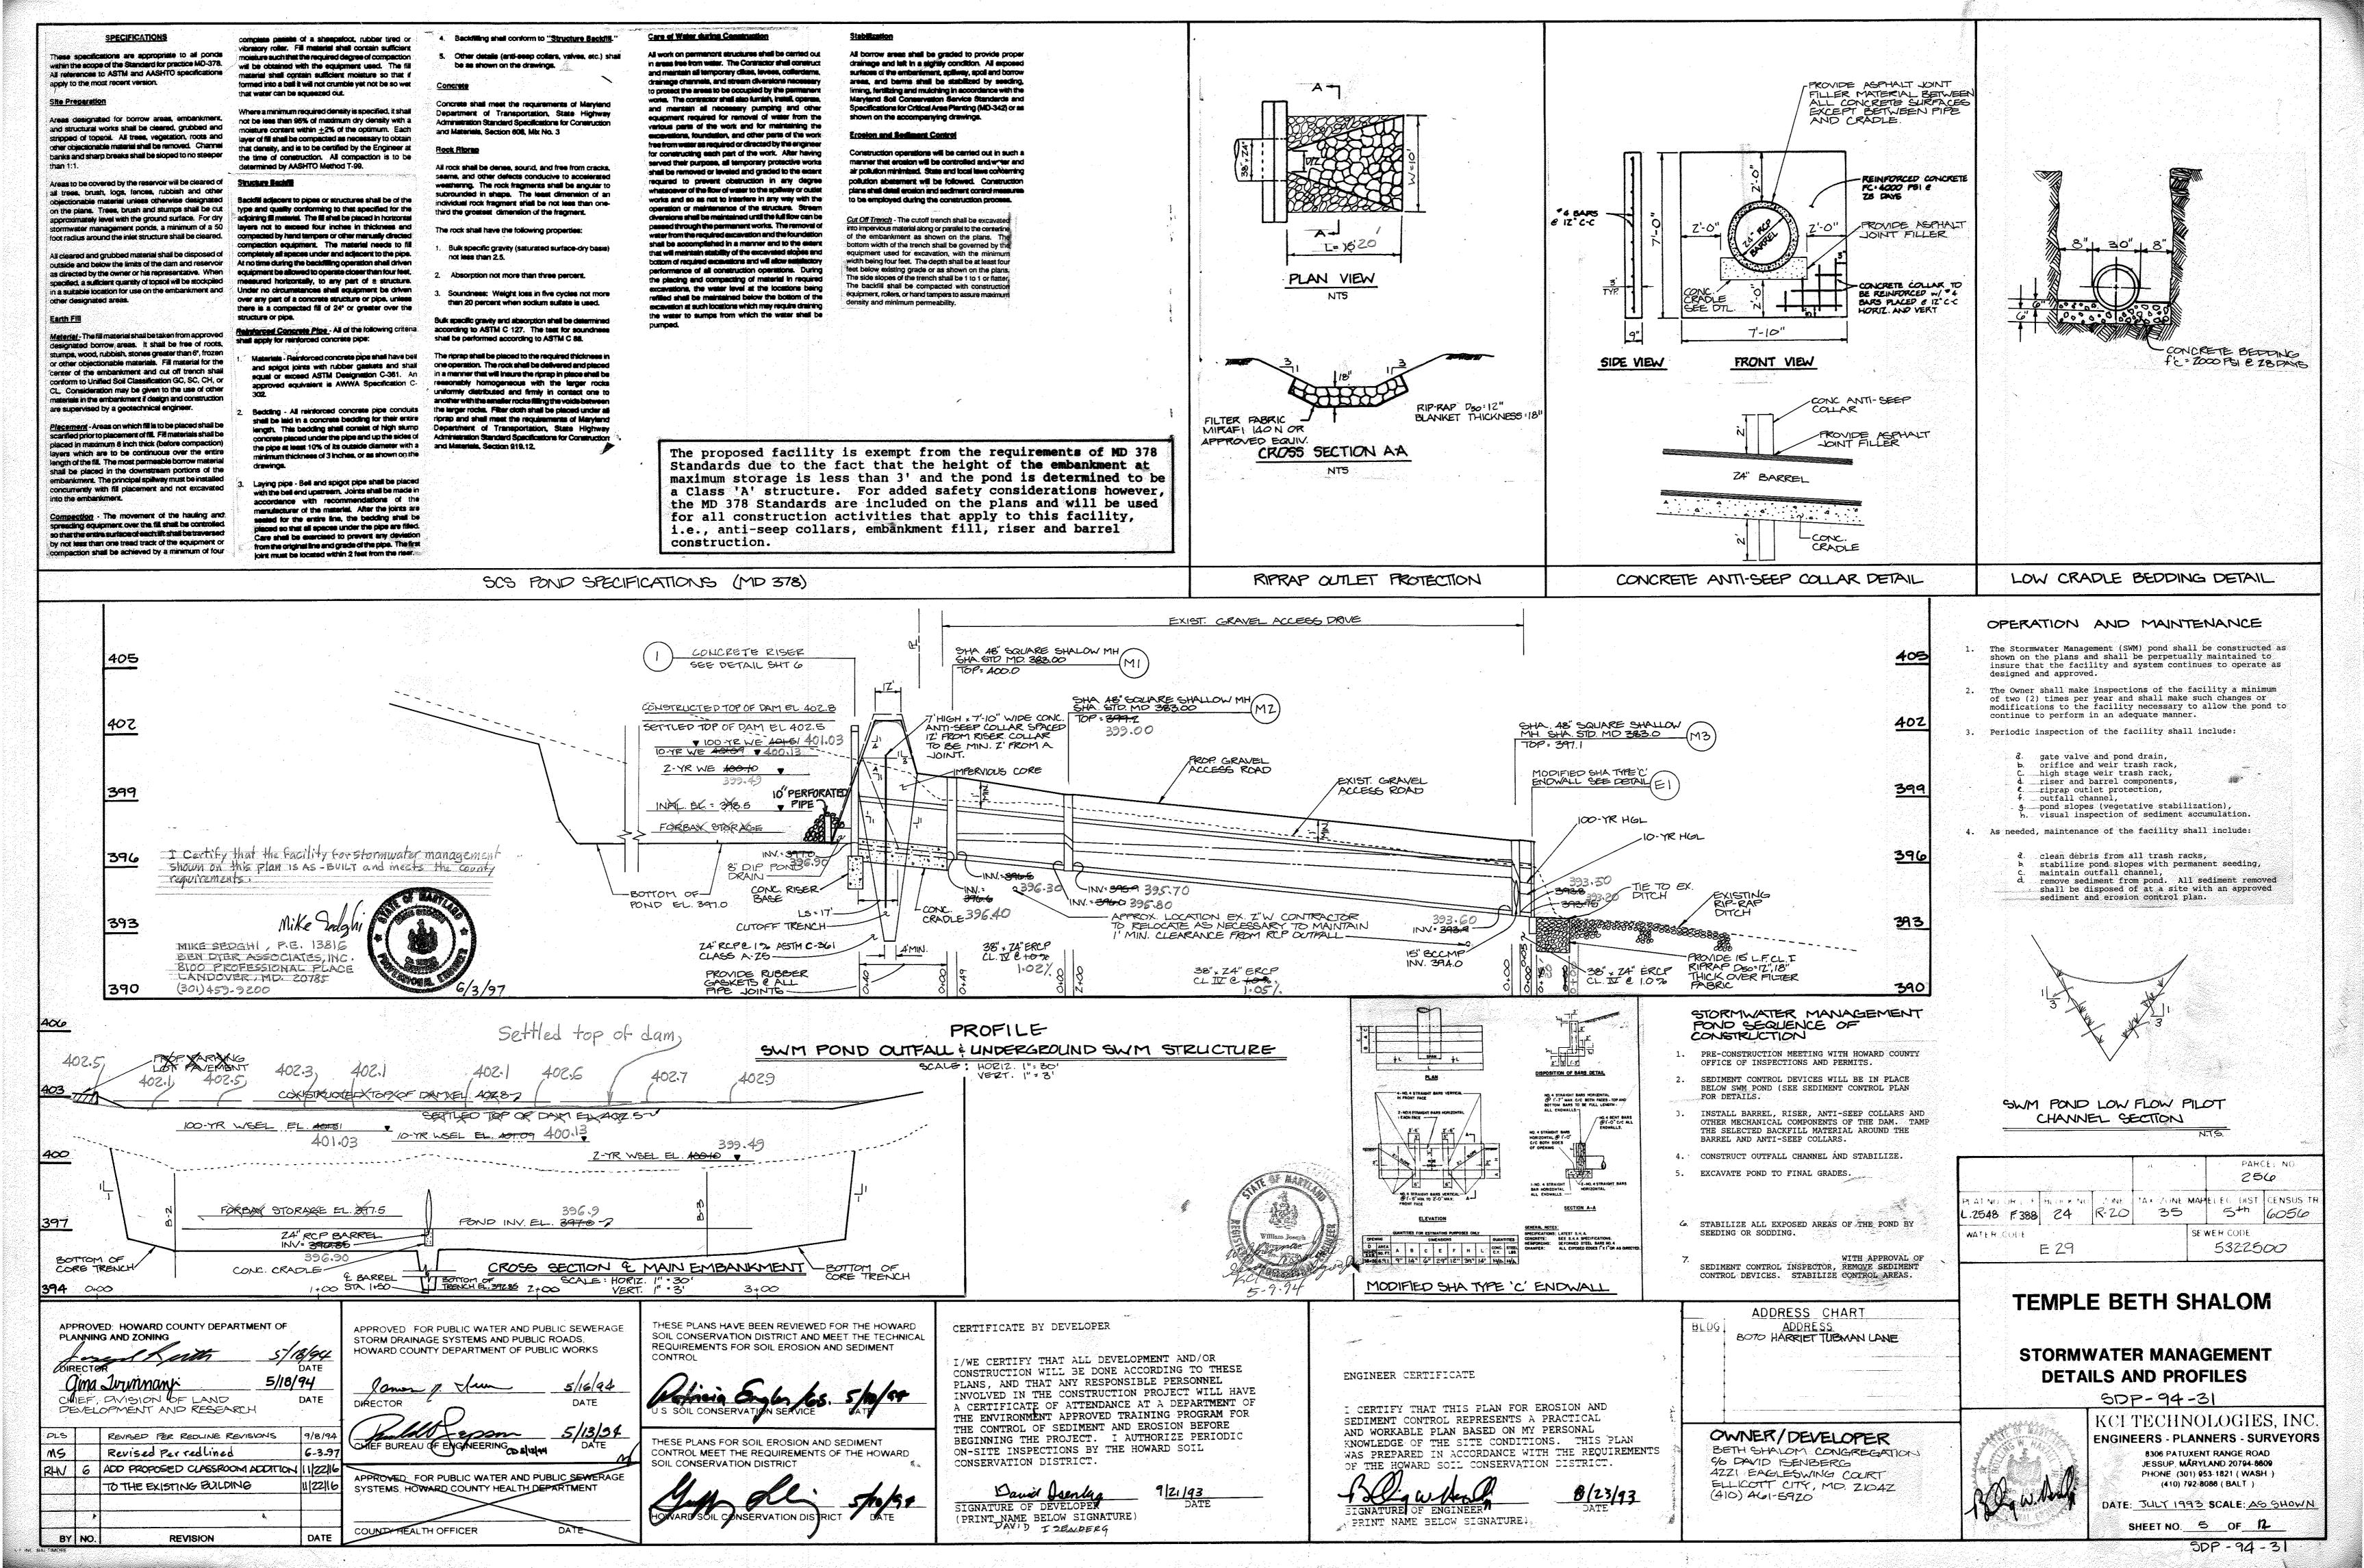

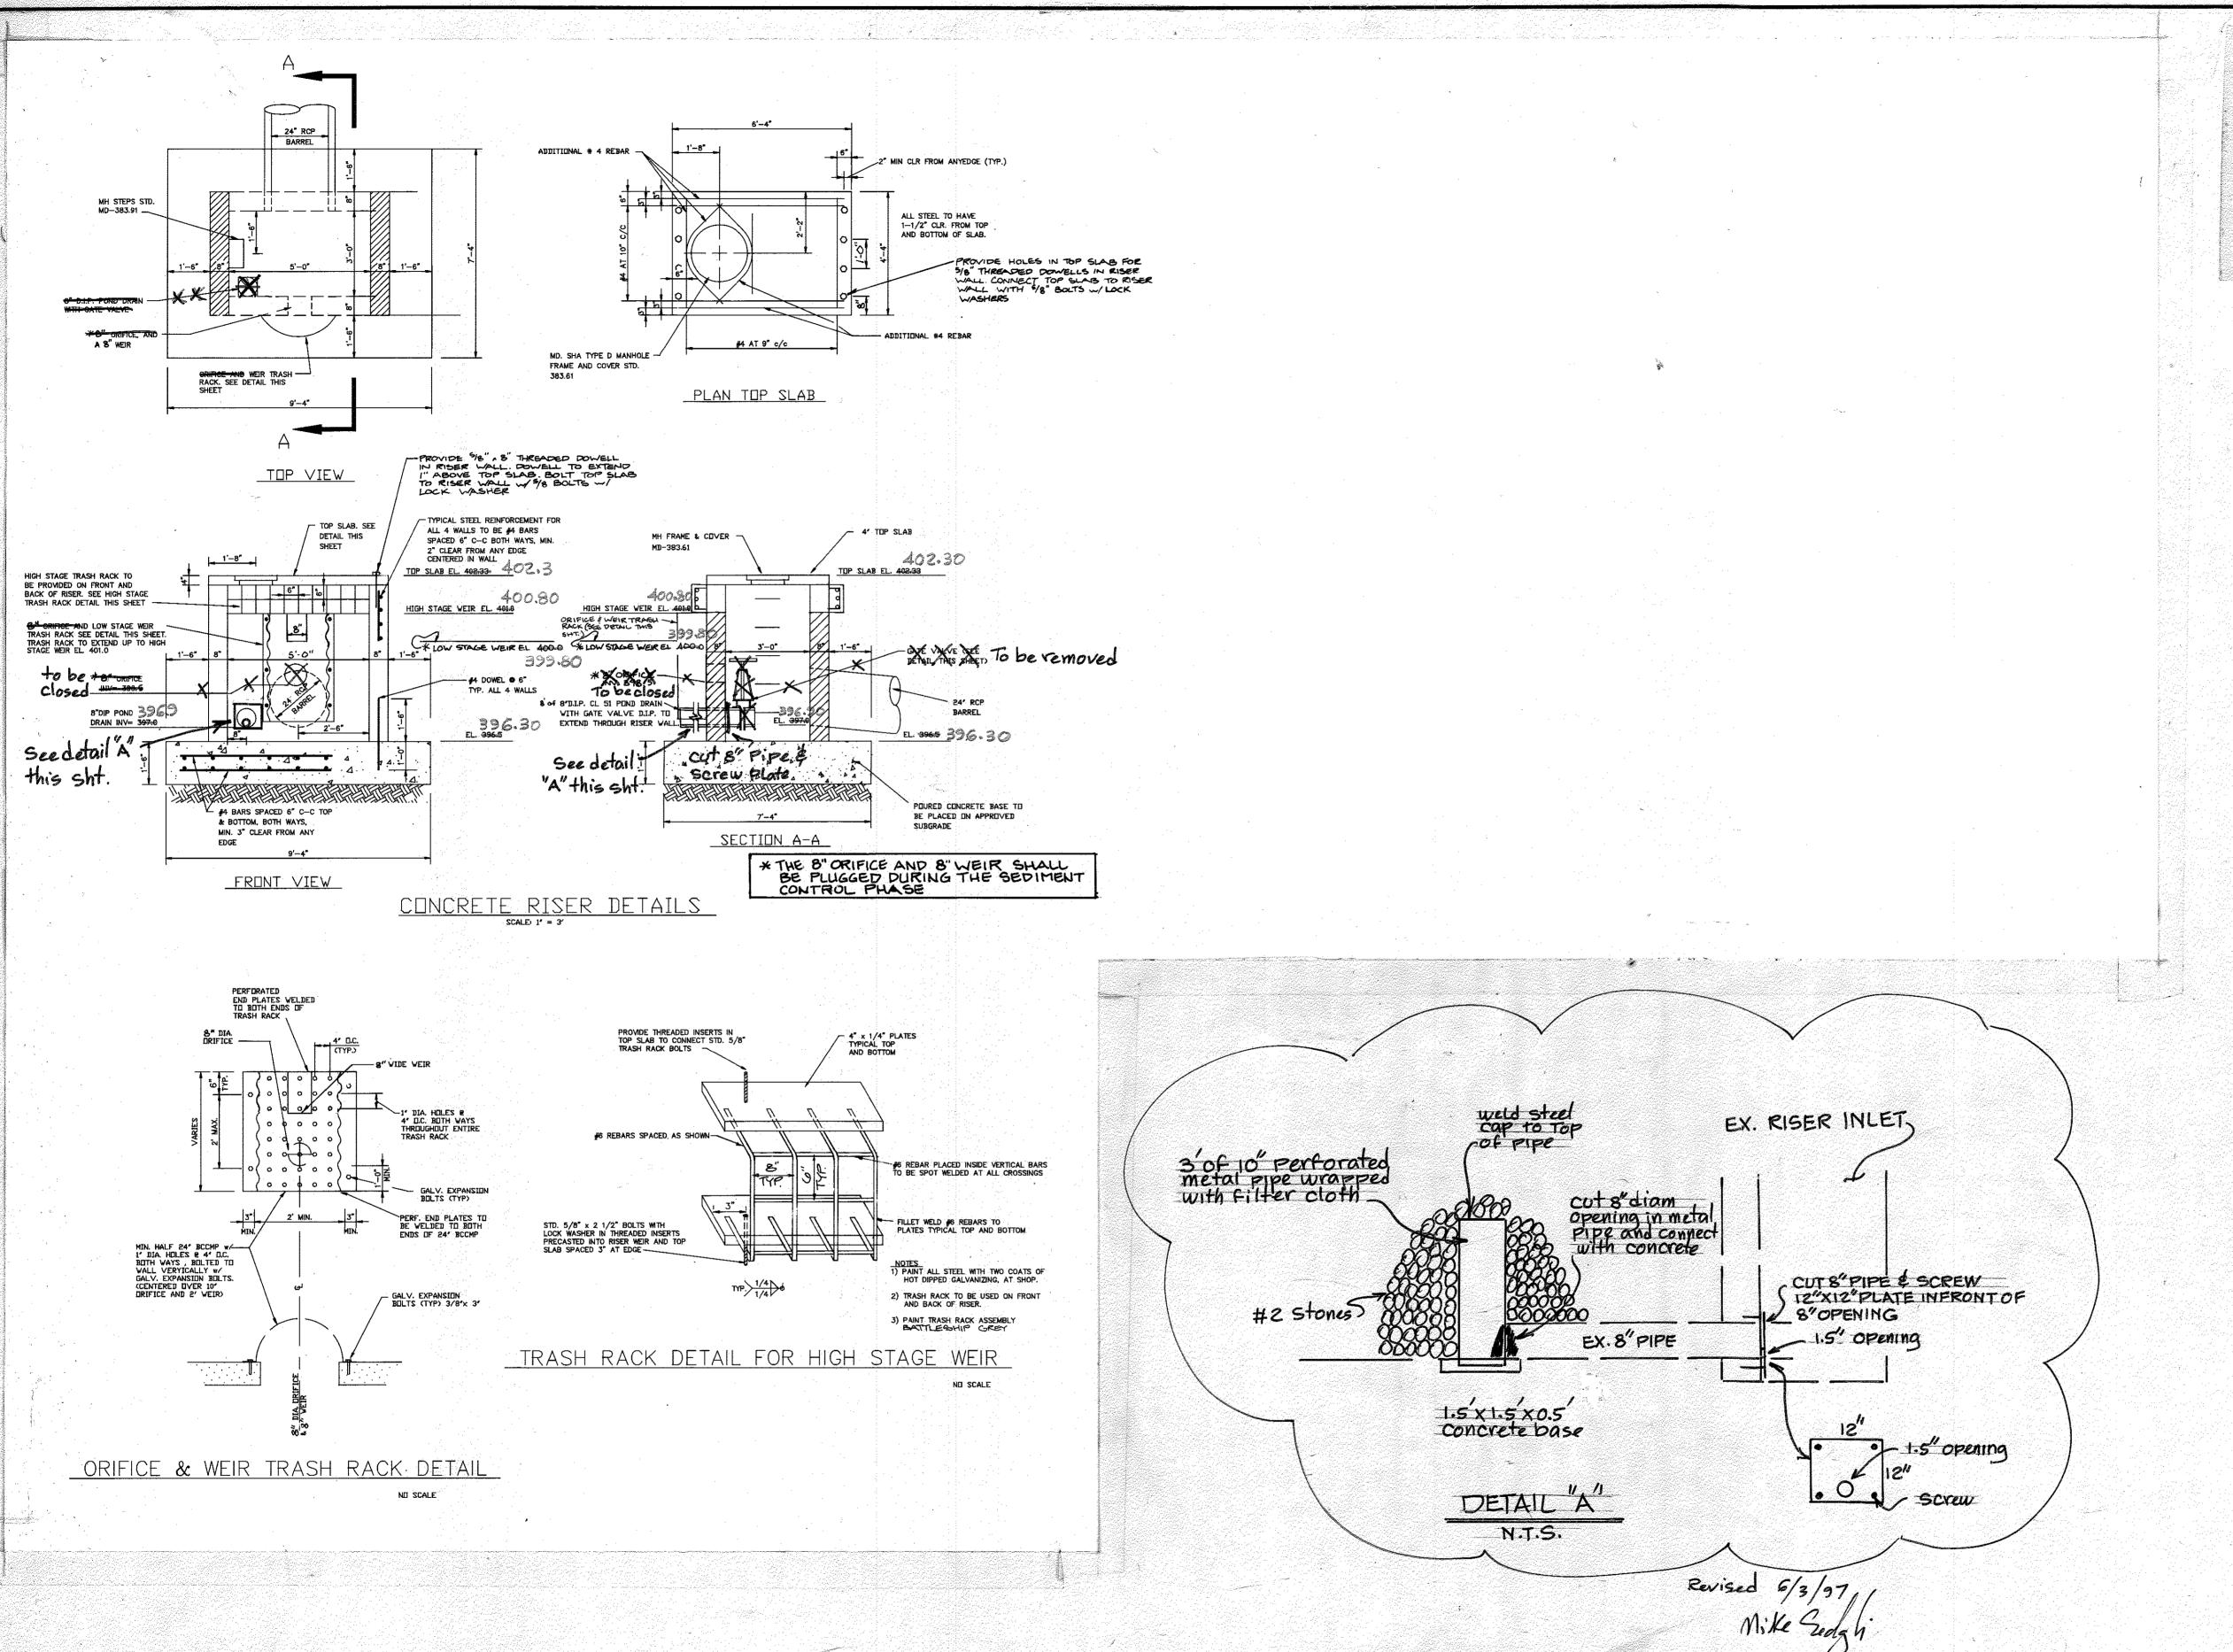

CERTIFICATE BY DEVELOPER

(PRINT NAME BELOW SIGNATURE)

I/WE CERTIFY THAT ALL DEVELOPMENT AND/OR CONSTRUCTION WILL BE DONE ACCORDING TO THESE

PLANS, AND THAT ANY RESPONSIBLE PERSONNEL INVOLVED IN THE CONSTRUCTION PROJECT WILL HAVE A CERTIFICATE OF ATTENDANCE AT A DEPARTMENT OF THE ENVIRONMENT APPROVED TRAINING PROGRAM FOR THE CONTROL OF SEDIMENT AND EROSION BEFORE BEGINNING THE PROJECT. I AUTHORIZE PERIODIC ON-SITE INSPECTIONS BY THE HOWARD SOIL CONSERVATION DISTRICT.

PLANS, AND THAT ANY RESPONSIBLE PERSONNEL

THESE PLANS HAVE BEEN REVIEWED FOR THE HOWARD

SOIL CONSERVATION DISTRICT AND MEET THE TECHNICAL

REQUIREMENTS FOR SOIL EROSION AND SEDIMENT

THESE PLANS FOR SOIL EROSION AND SEDIMENT CONTROL MEET THE REQUIREMENTS OF THE HOWARD

OIL CONSERVATION DISTRICT

APPROVED: FOR PUBLIC WATER AND PUBLIC SEWERAGE, STORM DRAINAGE SYSTEMS AND PUBLIC ROADS,

APPROVED: FOR PUBLIC WATER AND PUBLIC SEWERAGE SYSTEMS, HOWARD COUNTY HEALTH DEPARTMENT

DATE

HOWARD COUNTY DEPARTMENT OF PUBLIC WORKS

CHIEF BUREAU OF ENGINEERING CO S/12/44

COUNTY-HEALTH OFFICER

APPROVED: HOWARD COUNTY DEPARTMENT OF

CHIEF, DIVISION OF LAND DEVELOPMENT AND RESEARCH

2 Revised per redline

TO EXISTING BUILDING

REVISED PER REDLINE REVISIONS

REVISION

G ADD PROPOSE CLASSROOM ADDITION

DATE

DATE

9/8/94

6-3-97

DATE

5/18/94


PLANNING AND ZONING

aima Juunnanyi

I hereby certify that the facility for stormwater management shown on this plan is as built and meets the county requirements

GATE VALVE DETAIL

MIKE SEDGHE PE 13816 BEN DYER ASSOCIATES, INC. 8100 PROFESSIONAL PLACE LANDOVER , MD 20785 (301) 459-9200

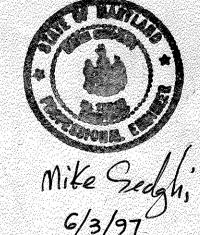

DEZURIK SERIES"L" KNIFE GATE VALVE OR APPROVED EQUAL WITH HANDWHEEL

PARCEL NO 256 PLAT NO OR L/F BLOCK NO ZONE TAX/ZONE MAPELEC DIST CENSUS TI 6050 .2548 F388 24 SEWER CODE: WATER CODE E 29 5322500

TEMPLE BETH SHALOM

STORMWATER MANAGEMENT **DETAILS AND PROFILES**

SDP - 94 -31

KCI TECHNOLOGIES, INC **ENGINEERS - PLANNERS - SURVEYORS** 8306 PATUXENT RANGE ROAD JESSUP, MARYLAND 20794-8609 PHONE: (301) 953-1821 (WASH.)

50P-94-31

I CERTIFY THAT THIS PLAN FOR EROSION AND SEDIMENT CONTROL REPRESENTS A PRACTICAL AND WORKABLE PLAN BASED ON MY PERSONAL KNOWLEDGE OF THE SITE CONDITIONS. THIS PLAN WAS PREPARED IN ACCORDANCE WITH THE REQUIREMENTS OF THE HOWARD SOIL CONSERVATION DISTRICT.

ENGINEER CERTIFICATE

PRINT NAME BELOW SIGNATURE)

BLDG


OWNER/DEVELOPER
BETH SHALOM CONGREGATION
% DAVID ISENBERG AZZI EAGLESWING COURT ELLICOTT CITY, MD ZIOAZ (410) AGI-59ZO


ADDRESS CHART


ADDRESS


8070 HARRIET TUBMAN LANE


(410) 792-8086 (BALT.) DATE: JULY 1993 SCALE: AS SHOWN SHEET NO. 6 OF 12

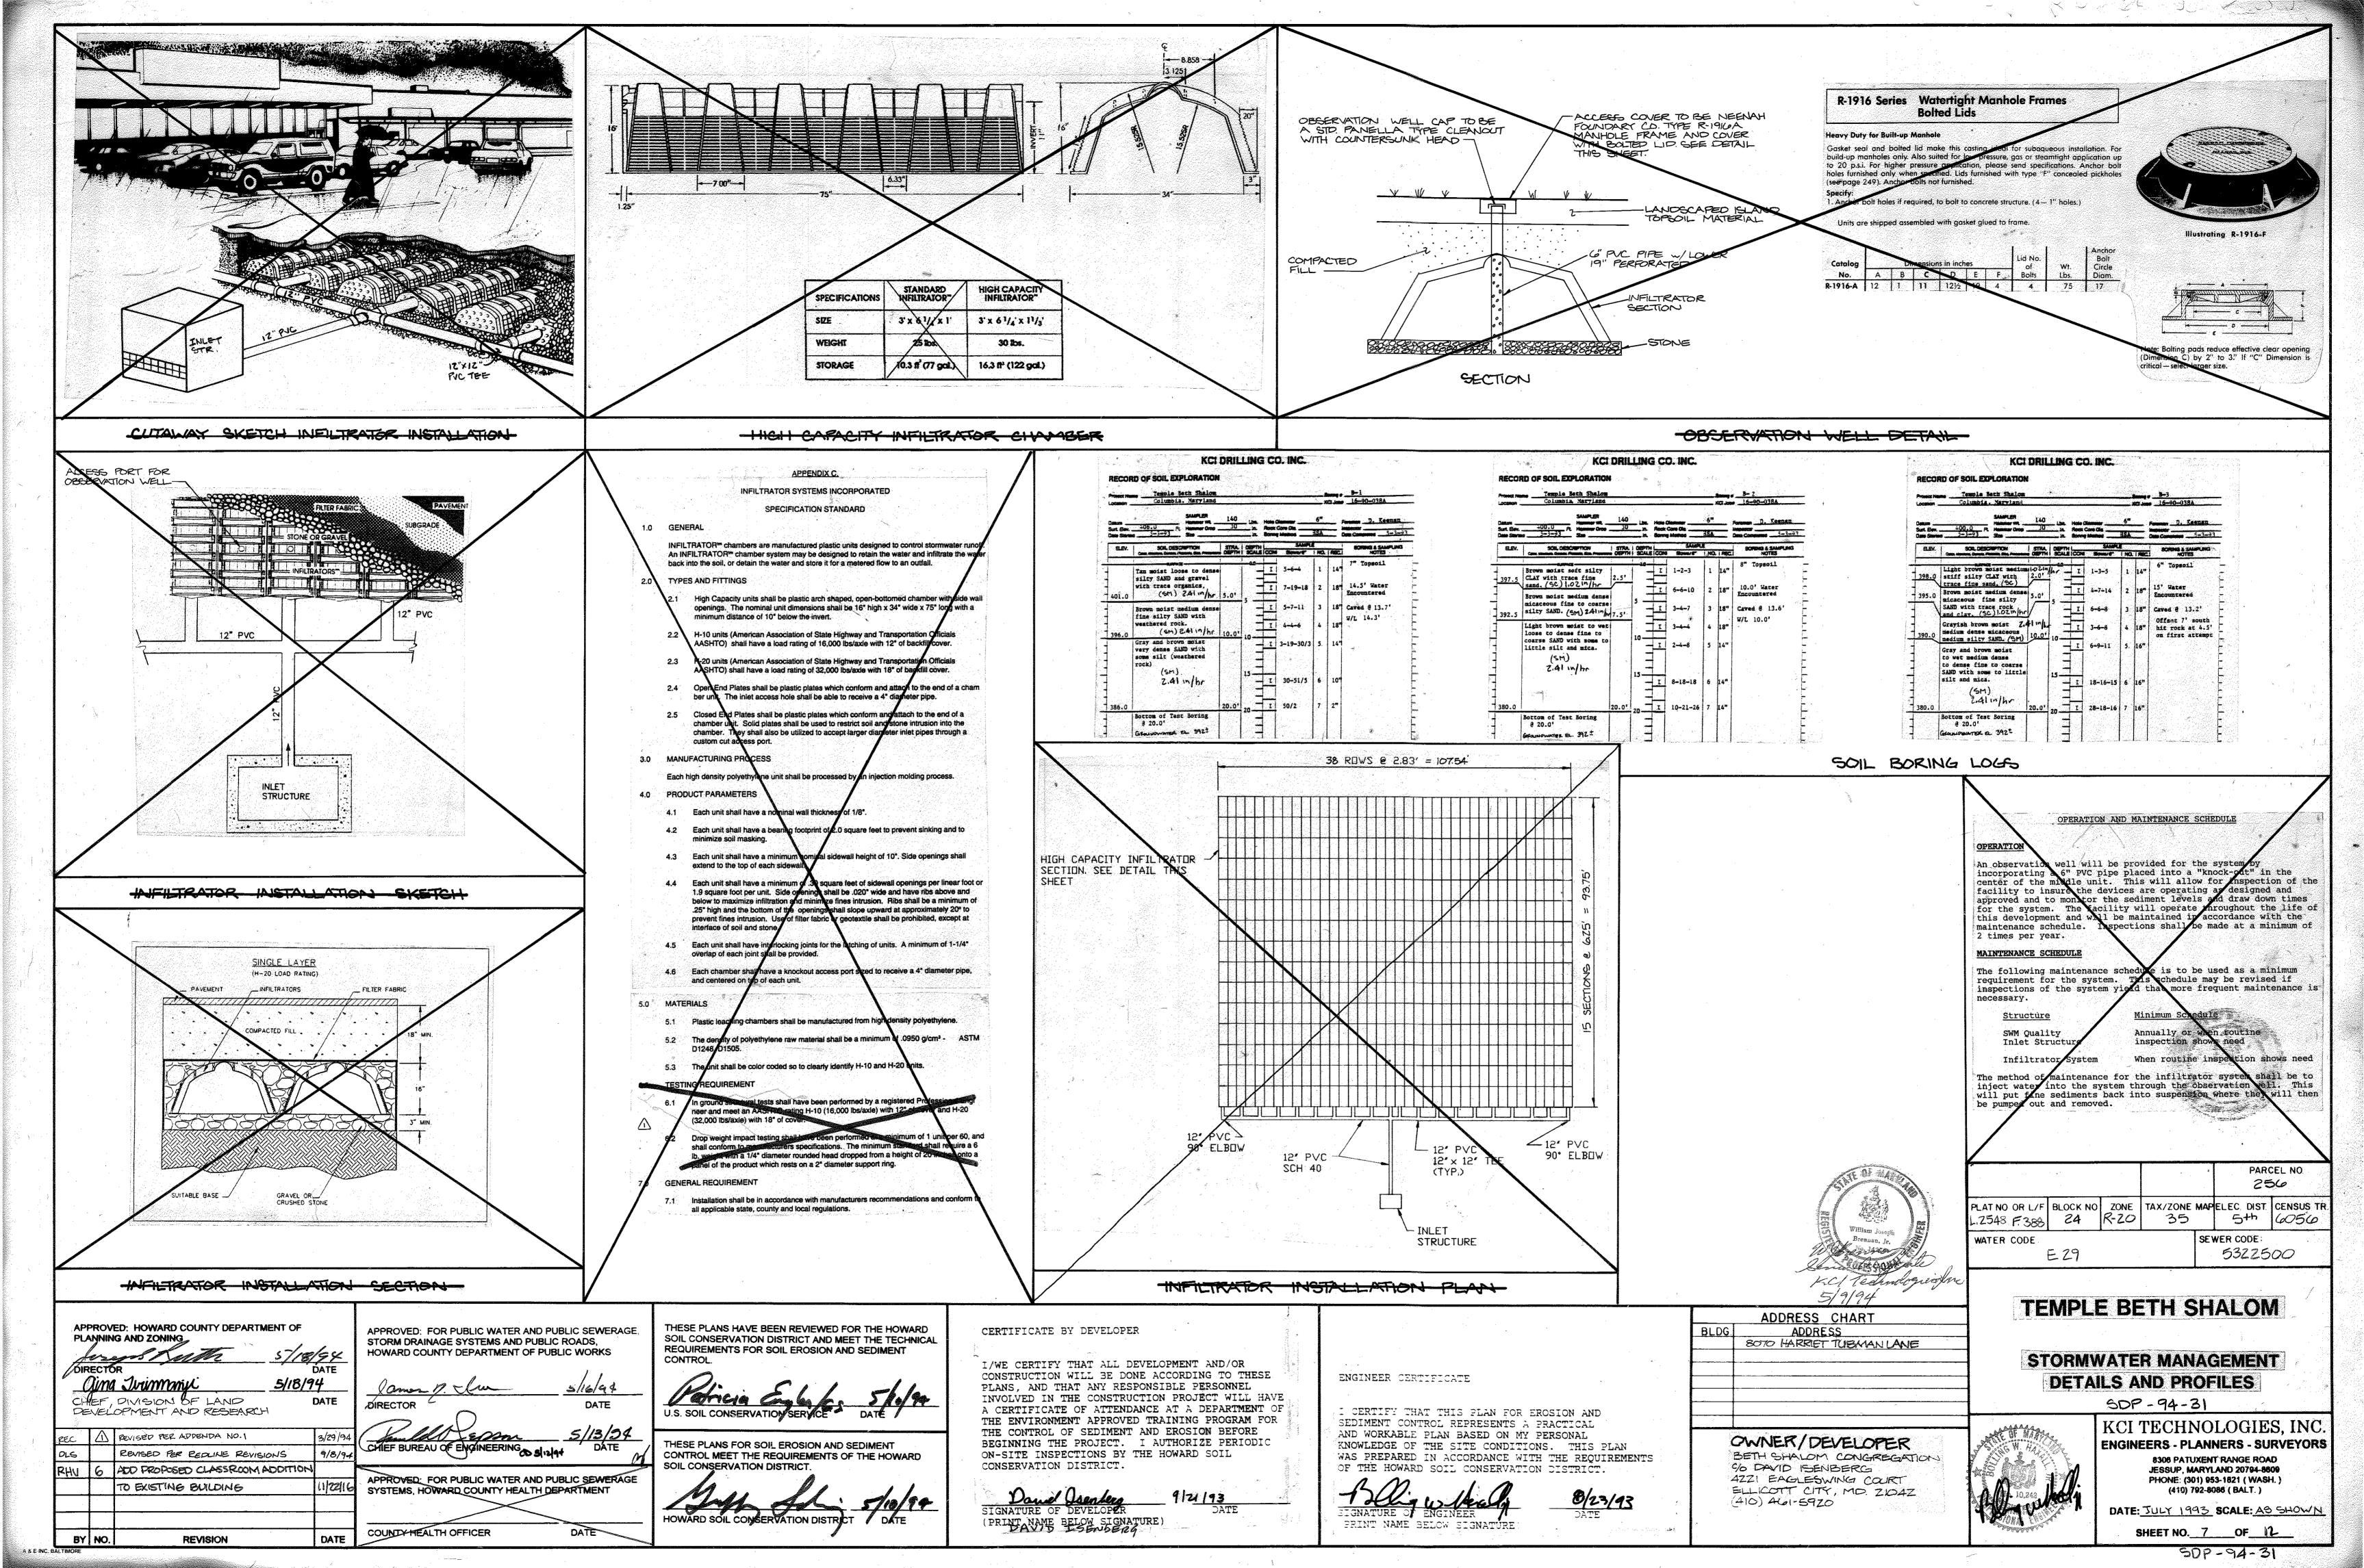


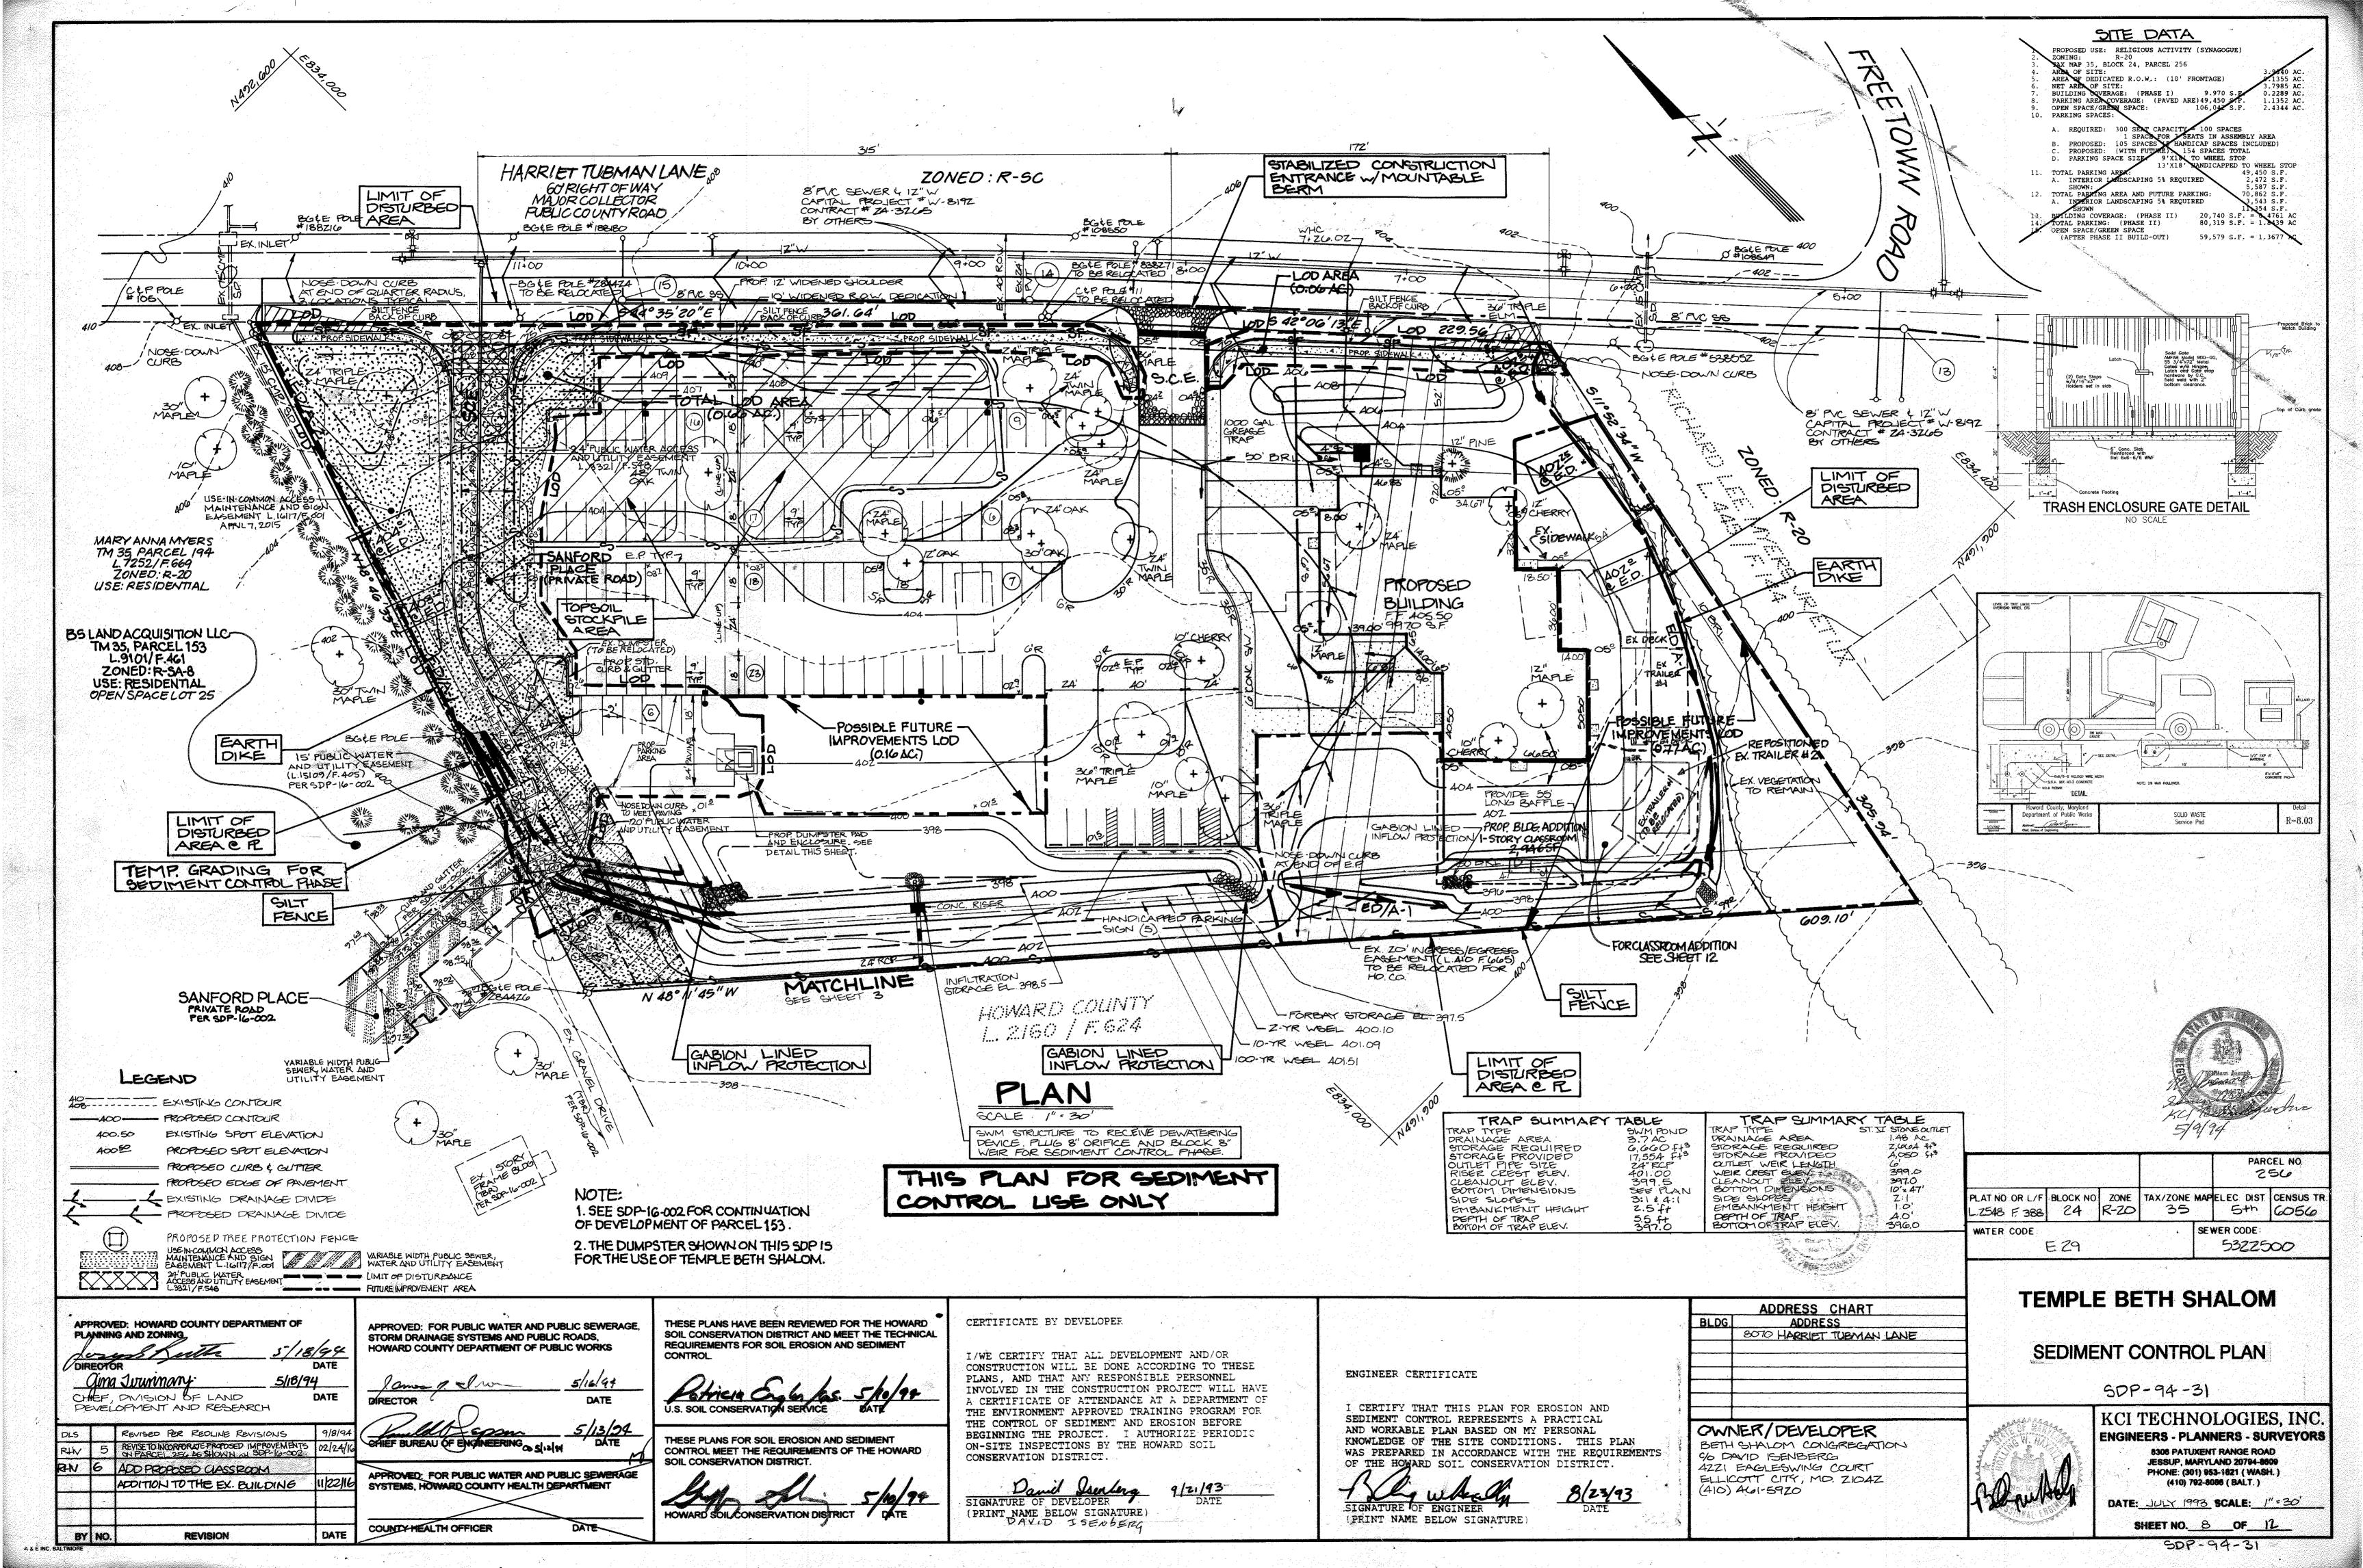


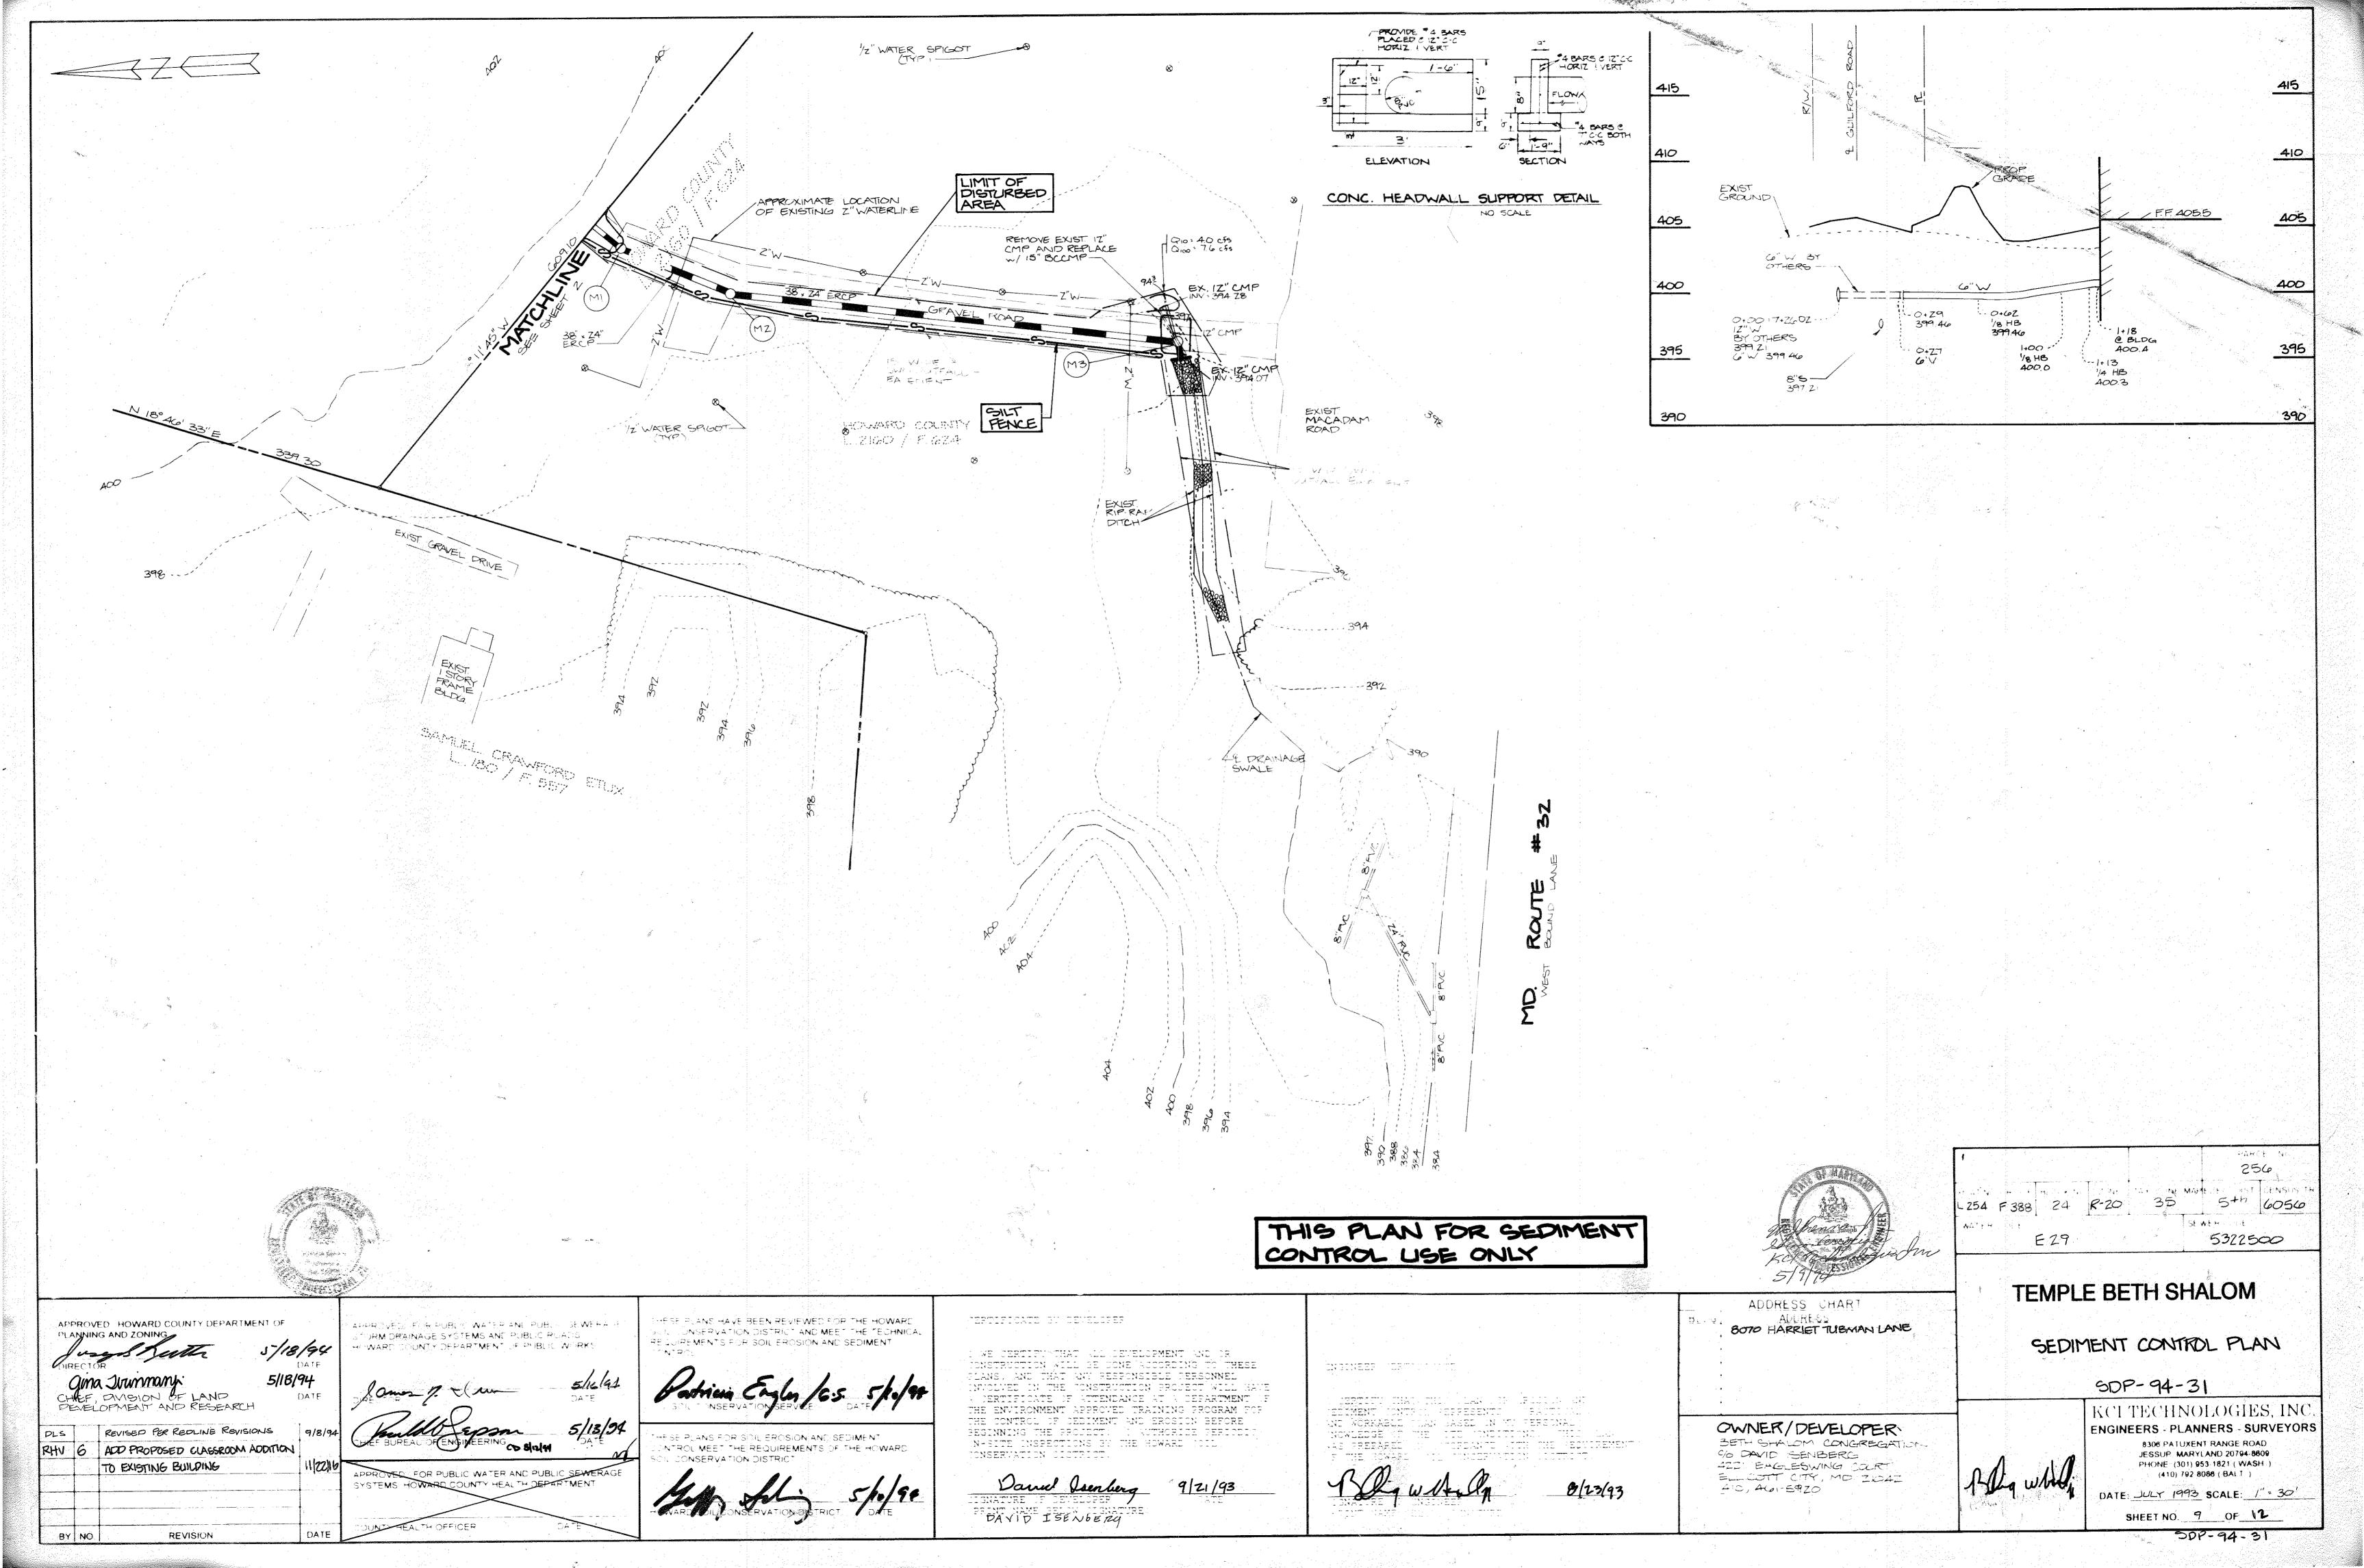


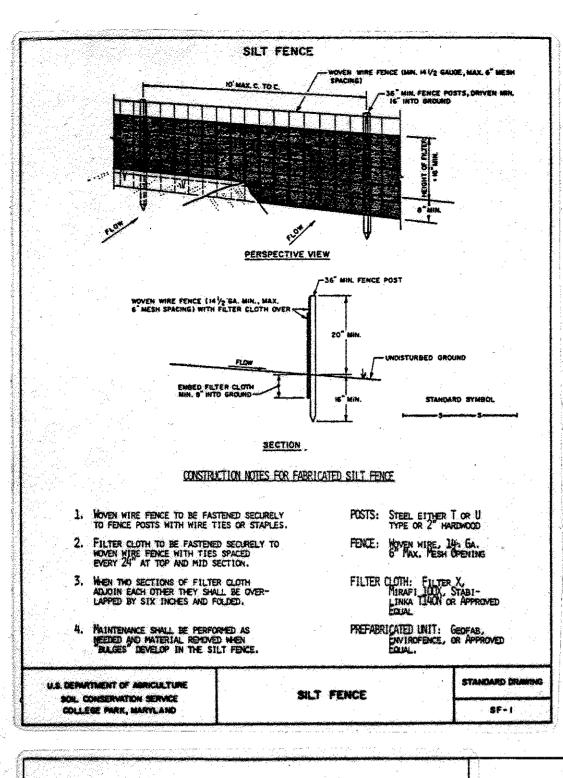

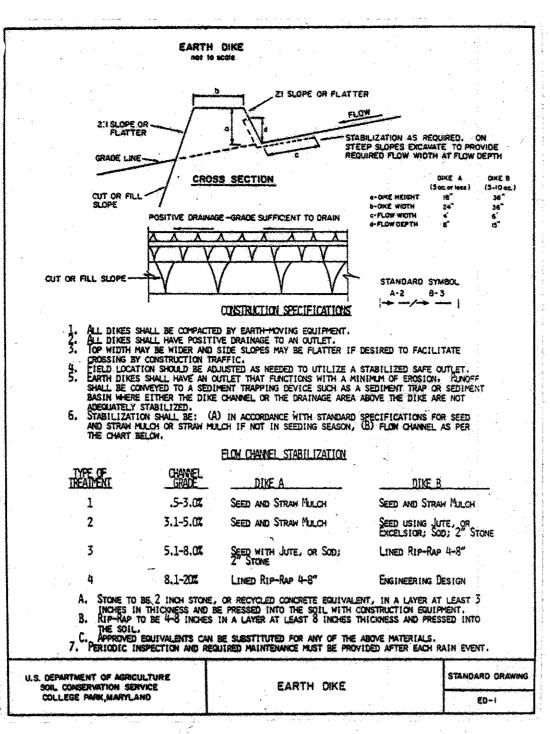

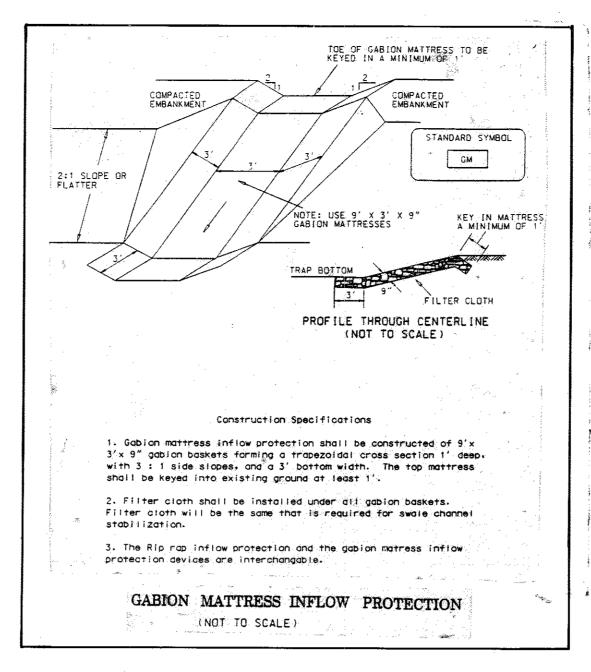

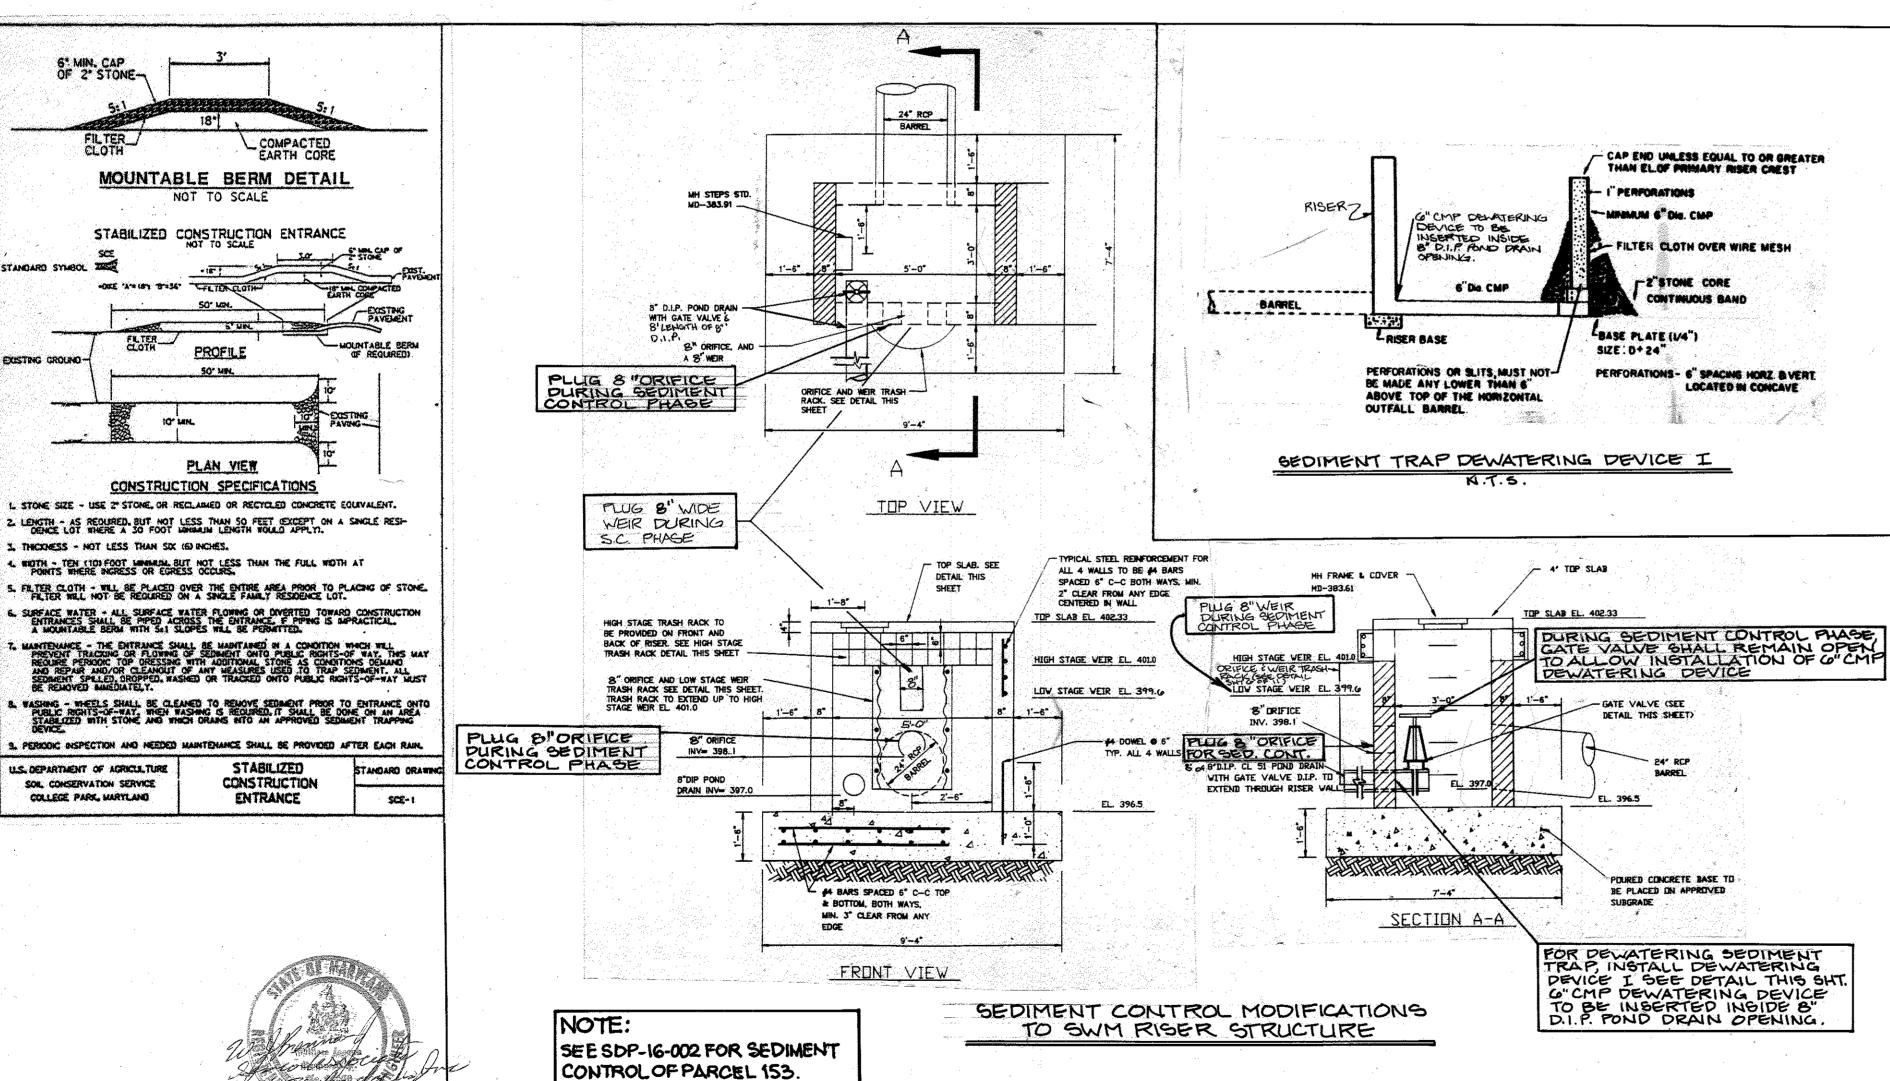

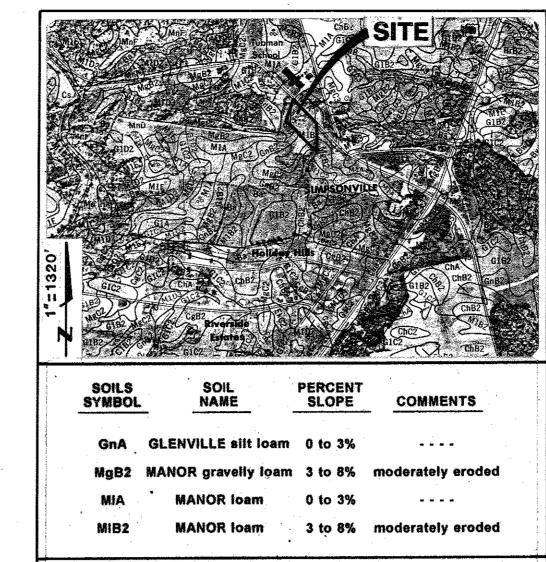

SEQUENCE OF CONSTRUCTION OBTAIN GRADING PERMIT. THE CONTRACTOR SHALL NOTIFY THE HOWARD COUNTY OFFICE OF INSPECTIONS AND PERMITS, SEDIMENT CONTROL DIVISION, AT LEAST 48 HOURS PRIOR TO STARTING WORK TO ARRANGE A PRE-CONSTRUCTION CONFERENCE (410) 313-2436. 1 DAY INSTALL TREE PROTECTION FENCE AND TREE PROTECTION DEVICES AS SHOWN ON SHEET 11. INSTALL SCE AND SILT FENCE BELOW SWM POND. CONSTRUCT SWM POND/SEDIMENT AND STONE OUTLET TRAP AS SHOWN. REFER TO SWM POND SPECIFICATIONS FOR CONSTRUCTION OF SWM POND/ SEDIMENT TRAP. INSTALL EARTH DIKES TO TRAP. INSTALL REMAINING SEDIMENT CONTROL DEVICES. INSTALL DEVICES PUG 8" OFFICE & BLOCK 8" WERE STRUCTURE. CLEAR AND GRUB REMAINDER OF SITE AS SHOWN. 4 DAYS ROUGH GRADE THE SITE. 1 WEEK BEGIN BUILDING CONSTRUCTION 3 MONTHS INSTALL CURB AND GUTTER AND BASE PAVE. NOTE: PAVING OF THE ACCESS DRIVE TO THE HOWARD COUNTY PROPERTY WILL INITIALLY EXTEND TO THE LIMITS SHOWN. THIS WILL ALLOW THE EARTH DIKE TO MAINTAIN POSITIVE FLOW TO THE SWM TRAP. 9. BEGIN SHA WIDENING OF GUILFORD ROAD. PERMANENTLY STABILIZE ALL UNPAVED AREAS. ONCE THE AREA FLOWING TO THE EARTH DIKE ALONG THE SOUTHWESTERN PROPERTY LINE IS STABILIZED, WITH THE SEDIMENT CONTROL INSPECTOR'S APPROVAL, REMOVE THE EARTH DIKE AND COMPLETE PAVING OF ACCESS ROAD



SOILS INFORMATION

ninsum of 24 hours notice must be given to the Howard Cou Office of Inspection and Permiss prior to the start of any construction provisions of this plant and are to be in conformance with the 1963 MARYLAND STANDARDS AND SPECIFICATIONS FOR SOIL EROSION AND SEDIMENT CONTROL.

All sediment control measures are to be adjusted to meet field condition at the time of construction, upon approval of a State Inspector. All sediment and erosion control facilities are to be constructed prior to grading and they shall be in an operational condition before grading

Contractor installing the above shall obtain and follow the 1983 MARYLAND STANDARDS AND SPECIFICATIONS FOR SOIL EROSION AND SEDIMENT CONTROL.

Following initial soil disturbance or redisturbance, permanent of temporary stabilization shall be completed within: a) 7 calendar days for all perimeter sediment control structures, dikes, perimeter slopes and a other slopes greater than 3:1; b) 14 days as to all other disturbed or

All disturbed areas must be stabilized within the time period specified in accordance with the 1983 MARYLAND STANDARDS AND SPECIFICATIONS FOR SOIL EROSION AND SEDIMENT CONTROL for permanent seedings (Sec. 51), sod (Sec. 54), temporary seeding (Sec. 50) and mulching (Sec. 52). Temporary stabilization with mulch alone can only be done when recommended seeding dates do no allow for proper germination and establishment of grasses.

On all sites with disturbed areas in excess of 2 acres, approval of the inspection agency shall be requested upon completion of installation of perimeter erosion and sediment controls, but before proceeding with any other earth disturbance or grading. Other building or grading inspection approvals may not be authorised until this initial approval be the ion agency is made.

All areas of ingress-egress are to be protected from tracking mud onto public right-of-way.

Grading and construction may begin upon completion and acceptance of all items shown, required or specified hereon.

All sediment trans/basins shown must be fenced and warning sign poster around their perimeter in accordance with Vol. 1, Chapter 12 of the HOWARD COUNTY DESIGN MANUAL, Storm Drainage. All sediment control structures are to remain in place and are to be

maintained in operative condition until permission for their removal habeen obtained from the Howard County Sediment Control Inspector. All sediment control structures shall be functional at the end of each day

14. Any sediment control practice which is disturbed by grading activity fo placement of utilities must be repaired on the same day of disturbance All disturbed areas shall be finally stabilized with permanent seedings upon completion of fine grading. See Pages 51.01 through 51.08 of referenced Standards and Specifications.

16. The Contractor shall not install concrete curb and gutter or sidewalk in he areas indicated until the uphill areas have been stabilized

Sediment control devices (ditches, dikes, traps, etc.) are to remain it place until contributing watershed has been stabilized. Maintenance to sediment control devices, overall grading, construction and development should be done as necessary. Removal of these devices shall be with the approval of the Howard county Department on Inspections, Licenses an Permits. After removal of sediment practices, shape and stabilize the

Additional sediment controls must be provided, if deemed necessary be the Howard County DPW Sediment Control Inspector.

19. Site Analysis Total Area of Site: Area Disturbed: Area to be Roofed or Paved: Area to be Vegetatively Stabilized:

All earthwork quantities shall not be used for bidding purposes. The Contractor shall make his own determination of the earthwork

Topsoil Waste: Offsite Borrow:

All borrow/waste material shall be from/to sites with approved Sediment Control Plans.

SOUTHERN MO: MARCH I TO MAYIS, AUGUST IS TO OCTOBER 15 (HARDINESS ZONES: 78,76 1.414 Acres 4954 Cu. Yds **SEE TABLEB. I (TEMPORARY SEEDING FOR STABILIZATION), LOCATED ON SHEET 16 ** STONE OUTLET SEDIMENT TRAP Y EQUIVALEN

PERMANENT SEEDING NOTES

APPLY TO CRADED OR CLEARED AREAS NOT SUBJECT TO IMMEDIATE FURTHER DISTURBANCE UNIERE A PERMANENT LONG-LIVED VEGETATIVE COVER IS REFRED.

SEEDBED PREPARATION: LOGSEN UPPER THREE INCHES OF SOIL BY RAKING, DISCING OF THREE ACCEPTABLE MEANS SEPONE SEEDING, IP NOT PREVIOUSLY LOGSENED.

OIL AMENDMENTS: LIEU OF SOIL TESTS RECONDENDATIONS, USE ONE OF THE POLLOWING

NULES.

1. PREFERRED - APPLY 2 TONS PER ACRE DOLONITIC LIMESTONE (92 LBS./
1000 SQ.FT.) AND 600 LBS PER ACRE 10-10-10 FERTILIZER (14 LBS./
1000 SQ.FT.) BEPORE SEEDING. MARROW OR DISC INTO UPPER THREE
INCHES OF SOIL AT TIME OF SEEDING. APPLY 400 LB. FER ACRE 10-0-0
URRAPOUN FERTILIZER (9 LBS./1000 SQ.FT.)
2. ACCEPTABLE - APPLY 2 TONS PER ACRE DOLONITIC LIMESTONE (92 LBS./
1000 SQ.FT.) BEPORE SEEDING. MARROW OR DISC INTO UPPER THREE

SEEDING - FOR THE PERIODS MARCH 1 THRU APRIL 30, AND AUGUST 1 THRU OCTOBER 15;

SEED WITH 60 LBS PER ACRE (1.4 LBS./1000 SQ.FT.) OF RENTUCKY 31 TALL

PESCUE. FOR THE PERIOD MAY 1 THRY JULY 31, SEED WITH 60 LBS. EMPTUCKY

31 TALL PESCUE PER ACRE AND 2 LBS. PER ACRE (.05 LBS./100 SQ.FT.) OF

WEEPING LOVEGRASS. DURING THE PERIOD OF OCTOBER 16 THRU PERMUARY 28.

PROTECT SITE BY: OPTION (1) 2 TOMS PER ACRE OF WELL AMCHORED STRAW

MULCH AND SEED AS SOON AS POSSIBLE IN THE SPRING. OPTION (2) USE

SOD. OPTION (3) SEED WITH 60 LBS /ACRE RESTUCKY 31 TALL PESCUE AND

MULCH WITH 2 TOMS/ACRE WELL AMCHORED STRAW.

MAINTERANCE - INSPECT ALL SEEDED AREAS AND MAKE NEEDED REPAIRS, REPLACEMENTS AND

APPLY TO CRADED OR CLEARED AREAS LIKELY TO BE REDISTURBED WHERE A SHORT-TERM

SEEDBED PREFARATION: LOOSEN UPPER THREE INCHES OF SOIL BY BAKING, DISCING OR OTHER ACCEPTABLE NEARS BAFFORE SEEDING, IF NOT PREVIOUSLY LOOSENED.

SOIL AMENOMENTS: APPLY 60 LBS PER ACRE 10-10-10 FERTILIZER (14 LBS./1000 SQ.FT.

HULCHING: APPLY 1 1/2 TO 2 TONS PER ACRE (70 TO 90 LBS./1000 SQ.FT.) OF UNBOTTED SHALL GRAIN STRAW INMEDIATELY AFTER SEEDING. AMCSON MELCH DESIDIATELY AFTER APPLICATION USING MULCH AMCSONING TOSL ON 215 CALLENS PER ACRE (5 GAL./1000 SQ.FT.) OF EMPLSIFYED ASPHALT ON FLAT AREAS. ON SLOTES 8 FRET OR RICHER, USE 148 CALLENS PER ACRE (2AL./1000 SQ.FT.)

1. DURING GRADING AND AFTER EACH RAINFALL, CONTRACTOR WILL INSPECT

IDEAL TIMES OF SEEDING FOR TURFGRASS MIXTURES:
WESTERNIMD: MARCH IS TO JUNE 1, AUGUST 1 TO OCTOBER 1 (HARDINESS ZONES 56,6

CENTRAL MD: MARCH I tO MAY IS, AUGUST IS TO OCTOBER IS (HARDINESS ZONE GL)

MEASURES ON THIS PLAN.

AND PROVIDE NECESSARY MAINTENANCE TO THE SEDIMENT CONTROL

2. FOLLOWING INITIAL SOIL DISTURBANCE SOR REDISTURBANCE PERMANENT OR TEMPORARY STABILIZATION SHALL BE COMPLETED WITH IN:

A. S CALENDAR DAYS FOR ALL PERIMETER SEPIMENT CONTROL B. 7 CALENDAR PAIS FOR ALL OTHER DISTURBED AREAS.

FOR THE PERIODS MARCH 1 THEN APRIL 30, AND AUGUST 15 THRU MOVEMBER 15, SEED WITH 2 1/2 BUSHEL PER ACRE OF ARMUAL RYE (3.2 LBS./100 50.FT.) FOR THE PERIOD OF MAY 1 THRU AUGUST 14, SEED WITH 3 LBS PER ACRE OF WEEPING LOVEGRASS (.07 LBS./1000 SQ.FT.) FOR THE PERIOD OF MOVEMBER 16 THRU FERRIARY 28, PROTECT SITE BY APPLYING 2 TORS PER ACRE OF WELL ANCHORED STRAW MULCH AND SEED AS SOON AS POSSIBLE IN THE SPRING, OR

- APPLY 1 1/Z TO 2 TONS PER ACRE (70 TO 90 LBS./1000 SQ.FT.) OF UNROTTED SHALL GRAIN STRAW IMMEDIATELY AFTER SEEDING. ARCHOR MULCH IMMEDIATELY AFTER APPLICATION USING MULCH ARCHORISC TOOL OR 218 GALLOWS PER ACRE (5 GAL/1000 SQ.FT.) OF IMMLESTRIED ASPRAIT ON FLAT AREAS. ON SLOPES 8 FEET OR HIGHER, USE 348 GALLOWS PER ACRE (8 GAL./1000 SQ.FT.)

OFTION: A one foot layer of 2" stone may be placed on the upstream side of the riprep is

4. The stone used in the outlet shall be small riprap 4"-8" along with a 1' thickness of 2" aggregate placed on the up-grade side on the small riprap on embedded filter cloth in the riprap.

Sediment shall be removed and trap restored to its original dimensions when the addisen-

Maximum Drainage Area: 5 Acres U.S. DEPARTMENT OF AGRICULTURE SOIL CONSERVATION SERVICE COLLEGE PARK, MARYLAND

ST-X PARCEL NO. 256 TAX/ZONE MAPELEC DIST CENSUS PLAT NO. OR L/F BLOCK NO. ZONE 5+4 35 24 R-20 6056 .2548 F. 388 SEWER CODE: WATER CODE

TEMPLE BETH SHALOM

SEDIMENT CONTROL **DETAILS AND NOTES**

SDP-94-31

KCI TECHNOLOGIES, INC 8308 PATUXENT RANGE ROAD JESSUP, MARYLAND 20794-8809 PHONE: (301) 953-1821 (WASH.) (410) 792-8066 (BALT.)

DATE: JULY 1993 SCALE: AS SHOWN SHEET NO. 10 OF 12

5322500

SDP-94-31

APPROVED: HOWARD COUNTY DEPARTMENT OF

5/18/94

DATE

DATE

9/8/94

1/22/14

APPROVED: FOR PUBLIC WATER AND PUBLIC SEWERAGE, STORM DRAINAGE SYSTEMS AND PUBLIC ROADS, HOWARD COUNTY DEPARTMENT OF PUBLIC WORKS

DIRECTOR DATE CHIEF BUREAU OF ENGINEERING (> STEAT DATE APPROVED: FOR PUBLIC WATER AND PUBLIC SEWERAGE SYSTEMS, HOWARD COUNTY HEALTH DEPARTMENT

COUNTY HEALTH OFFICER

THESE PLANS FOR SOIL EROSION AND SEDIMENT CONTROL MEET THE REQUIREMENTS OF THE HOWARD SOIL CONSERVATION DISTRICT

IL CONSERVATION DISTRICT DATE

CONTROL

CERTIFICATE BY DEVELOPER THESE PLANS HAVE BEEN REVIEWED FOR THE HOWARD SOIL CONSERVATION DISTRICT AND MEET THE TECHNICAL REQUIREMENTS FOR SOIL EROSION AND SEDIMENT

I/WE CERTIFY THAT ALL DEVELOPMENT AND/OR CONSTRUCTION WILL BE DONE ACCORDING TO THESE PLANS, AND THAT ANY RESPONSIBLE PERSONNEL INVOLVED IN THE CONSTRUCTION PROJECT WILL HAVE A CERTIFICATE OF ATTENDANCE AT A DEPARTMENT OF THE ENVIRONMENT APPROVED TRAINING PROGRAM FOR THE CONTROL OF SEDIMENT AND EROSION BEFORE BEGINNING THE PROJECT. I AUTHORIZE PERIODIC ON-SITE INSPECTIONS BY THE HOWARD SOIL CONSERVATION DISTRICT.

(PREAT NAME DESIGN, SIGNATURE)

ENGINEER CERTIFICATE

CERTIFY THAT THIS PLAN FOR EROSION AND SEDIMENT CONTROL REPRESENTS A PRACTICAL AND WORKABLE PLAN BASED ON MY PERSONAL KNOWLEDGE OF THE SITE CONDITIONS. THIS PLAN WAS PREPARED IN ACCORDANCE WITH THE REQUIREMENTS OF THE HOWARD SOIL CONSERVATION DISTRICT.

PRINT NAME BELOW SIGNATURE)

BETH SHALOM CONGREGATION % DAVID ISENBERG AZZI EAGLESWING COURT (410) AGI-5920

E 29

ENGINEERS - PLANNERS - SURVEYORS

PLANNING AND ZONING

aima Jurumany.

CHIEF, DIVISION OF LAND

PEVELOPMENT AND RESEARCH

REVISED PER ADDENDA NO. 1

REVISED PER REDLINE REVISIONS

6 ADD PROPOSED CLASSROOM ADDITION

TO THE EXISTING BUILDING

ON PARCEL 256 AS SHOWN ON SDP-16-002

REVISE TO INCORPORATE PROPOSED IMPROVEMENTS 02/24/16

REVISION

WITH THE PERMISSION OF THE SEDIMENT CONTROL INSPECTOR, REMOVE THE STONE OUTLET TRAP, SCE AND REMAINING PERIMETER CONTROLS. INSURE THAT ALL DISTURBED AREAS ARE PERMANENTLY

-Sheets of 4'x 8'x 1/2" exterior plywood or equivalent. — Riser crest elev. ⊢Posts-min. size 4" square or 5" round. Set at least 3' into the ground. 8' C-C

ELEVATION

BAFFLE TO BE USED ON STONE OUTLE SEDIMENT TRAP (SEE PLAN VIEW)

BAFFLE DETAIL

ADDRESS CHART BLDG. ADDRESS 8070 HARRIET TUBMAN LAKE

OWNER/DEVELOPER

ELLICOTT CITY, MD. ZIO4Z

