


DOT #1
 ST. N. 04.3
 ST. W. 04.3
 ST. ELEV. 51.3
 ST. ELEV. 51.3
 ST. ELEV. 51.3
 ST. ELEV. 51.3
 ST. ELEV. 51.3
 ST. ELEV. 51.3

LEGEND

- EX. CURB + GUTTER
- EX. CONCRETE WALK
- EX. PROPERTY LINE
- EX. CONTOUR
- PROP. SPOT GRADE
- PROP. CONTOUR
- LIMIT OF DISTURBANCE
- PROP. SWALE
- SILT FENCE
- STABILIZED CONSTRUCTION ENTRANCE
- PERIMETER DIKE/SWALE
- STEEL TREE
- TREES TO REMAIN
- STEEP SLOPES (15-25%)
- STEEP SLOPES > 25%
- TREE PROTECTION

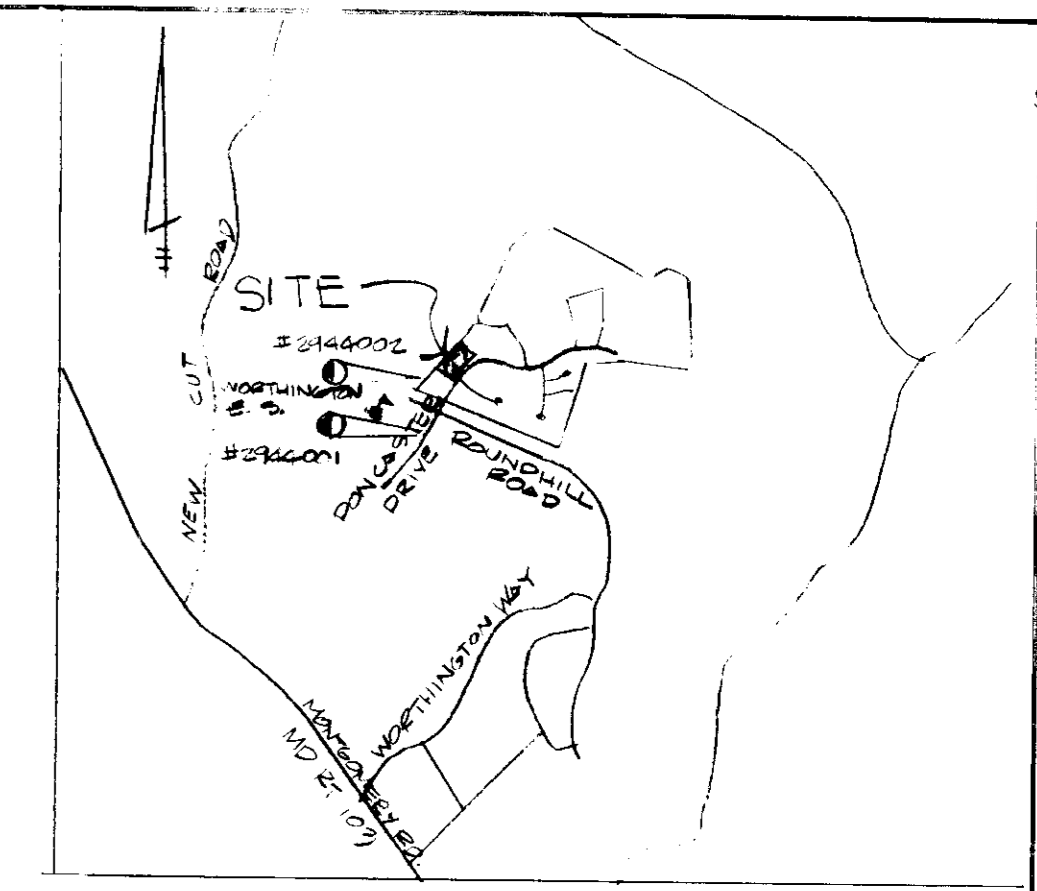

VICINITY MAP
 1" = 200'


General Notes

1. The land included is zoned R-20
2. Coordinates shown are extensions made from the Maryland State Plane Coordinate System. Bearings refer to the true north and are based on Howard County Geodetic Survey Point No. 2944001 and No. 2944002
3. The area covered in this submission is located on Tax Map 31
4. The Total Area on this Plan is 48,012 sq. ft. (1.10 ac.)
5. All roads are Public and Existing.
6. Any Damage to County Owned right-of-ways shall be corrected at the developer's expense.
7. Total Number of Lots in this submission is 3.
8. Street Trees will be provided in accordance with Section 16.124 of the Howard County Subdivision Regulations by the Developer per F-92-50
9. The Contractor shall notify the Department of Public Works, Bureau of Construction Inspection at (410) 312-1235 at least five (5) working days prior to the start of work.
10. The Contractor shall notify "Miss Utility" at 1-800-257-7777 at least 48 hours prior to any excavation work.
11. Topographic information shown on this plan was taken from the grading and sediment control plans for F-92-50. Plans were prepared by Riener Muegge + Associates, Inc. dated Jan. 21, 1992. The original topo was taken from a field run survey dated December 1988 by Dewberry and Davis and amended by TSA Group, Inc. May 1993. The contour interval shown is two feet.
12. All elevations shown are based on the USCGS mean sea level datum, 1929.
13. Benchmarks: #1 - Ho. Co. Control Pt. 2944002, Elev. 535.27, N-514,196.36, E-888,596.39; #2 - San. Sewer Manhole Rim in Roundhill Road, Elev. 509.93, N-513,618.7, E-899,325.9
14. Storm water management facilities are extended detention facilities and were approved under F-92-50 (Basin #1 & #2)
15. Existing utilities shown hereon were taken from Water and Sewer Extensions Contract # 14-3160-D and the Roadways, Storm Drain and SWM Plans for the Final Development Plan # F-92-50 and revised by TSA Group, Inc. May 1993
16. Porches or decks, open or closed, cannot project more than 10 feet into the required front or rear yard building restriction lines, per Section 12B of the Zoning Regulations.
17. All fireplace chimneys and bay windows not more than 10 feet in width may project not more than four feet into any required yard per Section 12B of the Zoning Regulations.
18. WP-91-178 was a waiver requesting to waive Section 16.120(A)(3), to extend the approved preliminary plan for six months (P-90-07) and to reactivate WP-90-20 (Waiving section 16.116(C)(6) grading adjacent to stream banks and wetlands). It was approved by letter dated June 13 1991.
19. WP-93-52 was approved on December 29, 1992 to waive Section 16.119 and 16.120 to not require submission of a sketch and preliminary plan for this re-subdivision.
20. This Site is 15% vegetated, which consists of 85% mature Tulip Poplar and 15% Cherry, Locust and Flowering Dogwood.
21. This submission is a revision of Lots 3-6 of SDP 92-106, which were re-subdivided into Lots 54 thru 56 by F-91-53
22. The Contractor/Builder shall verify the location and depth of sewer connection prior to dwelling construction.
23. Contractor/Builder shall verify road elevations at driveways prior to construction. Driveway grades shall not exceed 14%.
24. This plan is for house location, grading and sediment control only. Lot corners shall be staked from the approved final Record Plat # 10395
25. All Driveways to be built to meet Howard Co. DPW Standard, 26.14 & 26.25
27. WATER & SEWER CONTRACT # 14-3160-D

ADDRESS CHART	
LOT #	STREET ADDRESS
54	4586 DONCASTER DRIVE
55	4503 VINTER WAY
56	4504 VINTER WAY

- Sequence of Operations**
1. Obtain a grading permit (1 day)
 2. Clear and grub for sediment and erosion control measures only (1 day)
 3. Install all sediment and erosion control measures. Install tree protection fences. (1 day)
 4. Clear and Grub Remainder of Site. (2 days)
 5. Excavate foundations and rough grade site excluding lots. (4 weeks)
 6. Install Utilities. (2 weeks)
 7. Stabilize paving areas with aggregate. (1 week)
 8. Construct houses. (3 months)
 9. Fine grade, topsoil and seed all disturbed areas. (6 months, concurrent with steps 5-8)
 10. After turf is established and upon approval of the sediment control inspector, remove temporary sediment control measures and clean up site.
- Refurbish sediment basins #1 and #2 to their original dimensions per F-92-50 and install dewatering devices. Basin #2 riser crest to remain at elevation 482.3 until all upland areas are permanently stabilized.

REVISION BLOCK			
CHANGE #	LOT #	REASON FOR REVISION	DATE
1	56	MODEL CHANGE (15E)	11/2/93
2	54	"	11/2/93
3	55	"	3/22/94

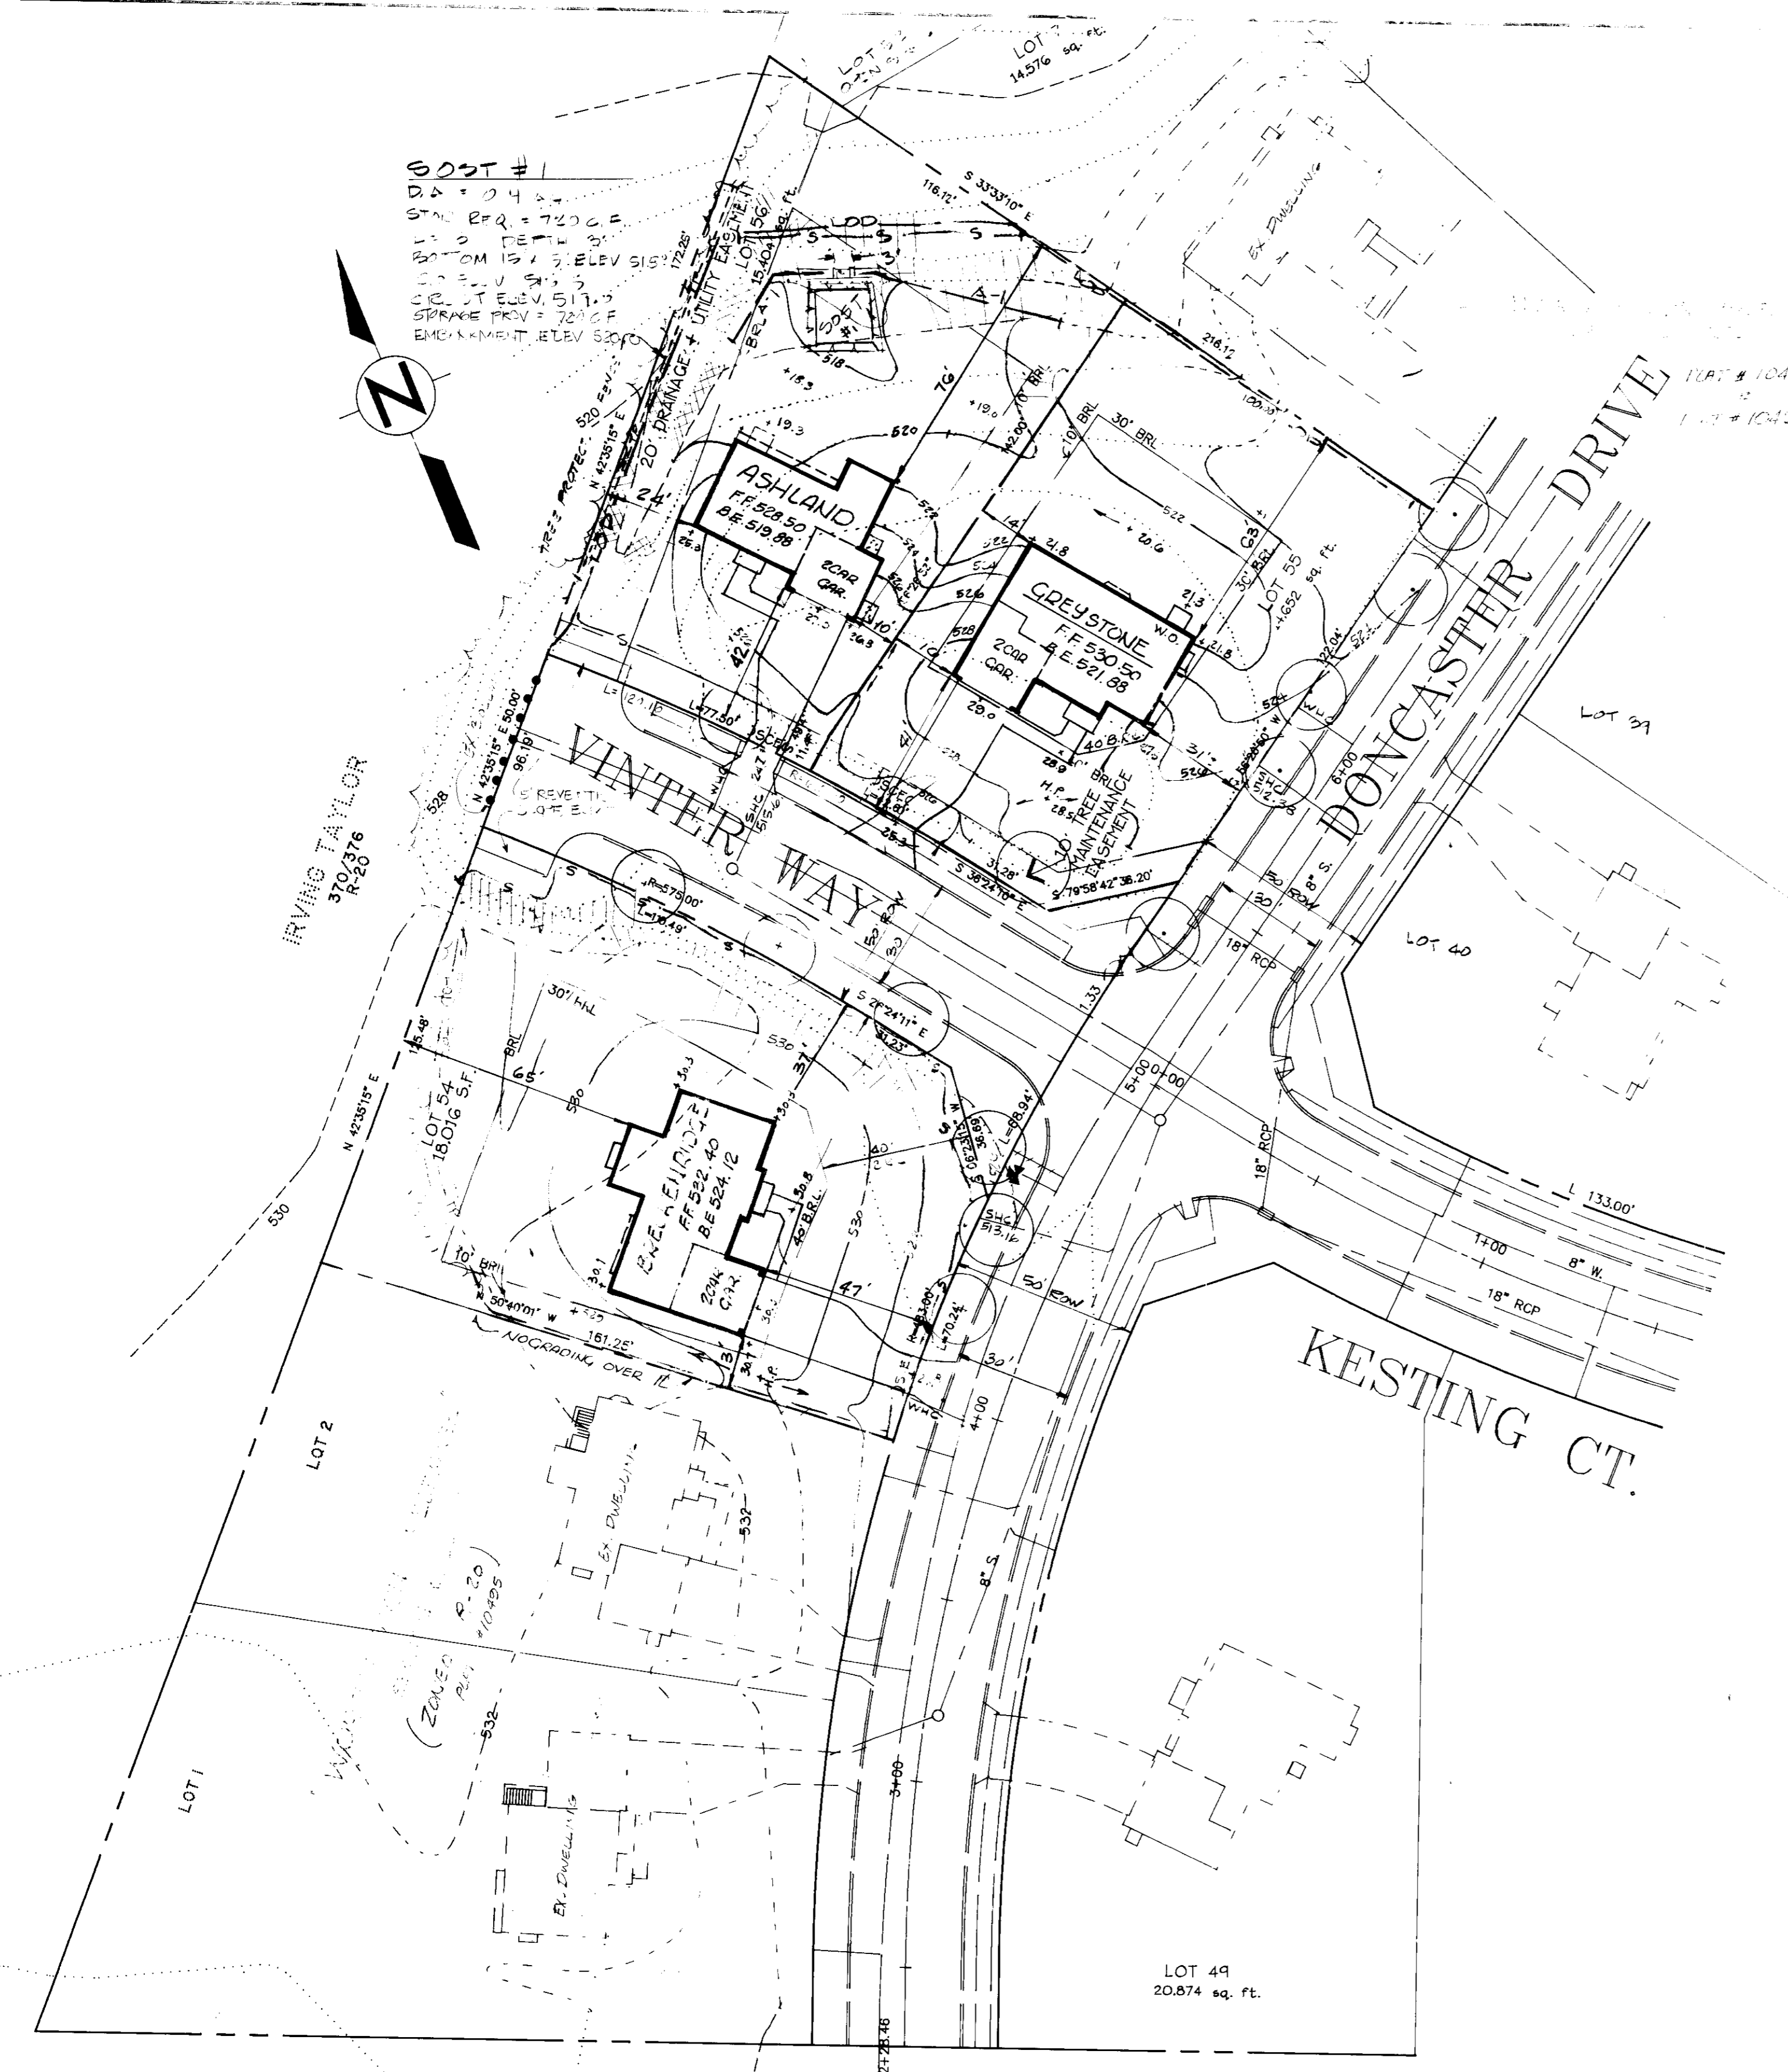

DEVELOPER/BUILDER'S CERTIFICATE
 I/WE CERTIFY THAT ALL DEVELOPMENT AND CONSTRUCTION WILL BE DONE ACCORDING TO THIS PLAN OF DEVELOPMENT AND PLAN FOR EROSION AND SEDIMENT CONTROL AND THAT ALL RESPONSIBLE PERSONS INVOLVED IN THE CONSTRUCTION PROJECT WILL HAVE A CERTIFICATE OF ATTENDANCE AT A MINIMUM OF TWO ENVIRONMENTALLY APPROVED TRAINING PROGRAMS FOR THE CONTROL OF SEDIMENT AND EROSION CONTROL BEFORE BEGINNING THE PROJECT. I ALSO AUTHORIZE PERIODIC ON-SITE INSPECTION BY THE HOWARD SOIL CONSERVATION DISTRICT OR THEIR AUTHORIZED AGENTS AS DEEMED NECESSARY.

[Signature]
 SIGNATURE OF DEVELOPER / BUILDER

6/23/93
 DATE

ENGINEER'S CERTIFICATE
 I CERTIFY THAT THIS PLAN FOR EROSION AND SEDIMENT CONTROL REPRESENTS A PRACTICAL AND WORKABLE PLAN BASED ON MY PERSONAL KNOWLEDGE OF SITE CONDITIONS AND THAT IT WAS PREPARED IN ACCORDANCE WITH THE REQUIREMENTS OF THE HOWARD SOIL CONSERVATION DISTRICT.

[Signature]
 ENGINEER

4/23/93
 DATE

APPROVED FOR PUBLIC WATER AND PUBLIC SEWAGE SYSTEMS HOWARD COUNTY HEALTH DEPARTMENT

[Signature] 9/29/93
 COUNTY HEALTH OFFICER DATE

APPROVED HOWARD COUNTY DEPT. OF PLANNING & ZONING

[Signature] 10/14/93
 PLANNING DIRECTOR DATE

[Signature] 10/14/93
 CHIEF, DIVISION OF LAND DEVELOPMENT & RESEARCH C.A.G. DATE

APPROVED FOR PUBLIC WATER AND PUBLIC SEWAGE STORM DRAINAGE SYSTEMS AND PUBLIC ROADS HOWARD COUNTY DEPARTMENT OF PUBLIC WORKS

[Signature] 9/22/93
 DIRECTOR DATE

[Signature] 9/22/93
 CHIEF BUREAU OF ENGINEERING DATE

THIS DEVELOPMENT PLAN IS APPROVED FOR SOIL EROSION AND SEDIMENT CONTROL BY THE HOWARD SOIL CONSERVATION DISTRICT.

[Signature] 9/15/93
 APPROVED DATE

REVIEWED FOR HOWARD S.C.D. AND MEETS TECHNICAL REQUIREMENTS.

[Signature] 9/15/93
 SIGNATURE DATE
 U.S. SOIL CONSERVATION SERVICE

LAND DESIGN ASSOCIATES
 718 HIGHWOOD DRIVE
 BALTIMORE, MD 21212
 TEL. 410-323-6344





SUBDIVISION NAME WORTHINGTON RESERVES	SECT. AREA SECTION 1	LOTS 54 THRU 56
PLAT # or L/F 12853	TAX/ZONE MAP 31	ELEC. DIST. 2ND
WATER CODE G01	SEWER CODE 1257013	CENSUS TR. 6027

PREVIOUS SUBMITTALS
 F-92-50 WP-90-20
 P-90-07 WP-91-178
 S-89-50 WP-93-52
 F-93-50 SDP-92-106

WORTHINGTON RESERVES
 SECTION ONE - LOTS 54 THRU 56
 2ND ELECTION DISTRICT
 HOWARD COUNTY, MD

SITE DEVELOPMENT AND SEDIMENT CONTROL

FOR: GRAYSON HOMES INC. 9025 CHEVROLET DRIVE ELLCOTT CITY, MD 21043	DESIGNED: DCB DRAWN: CAD CHECKED: ELP	SCALE: 1" = 30' SHEET 1 OF 2 DATE: JUNE 8, 1993
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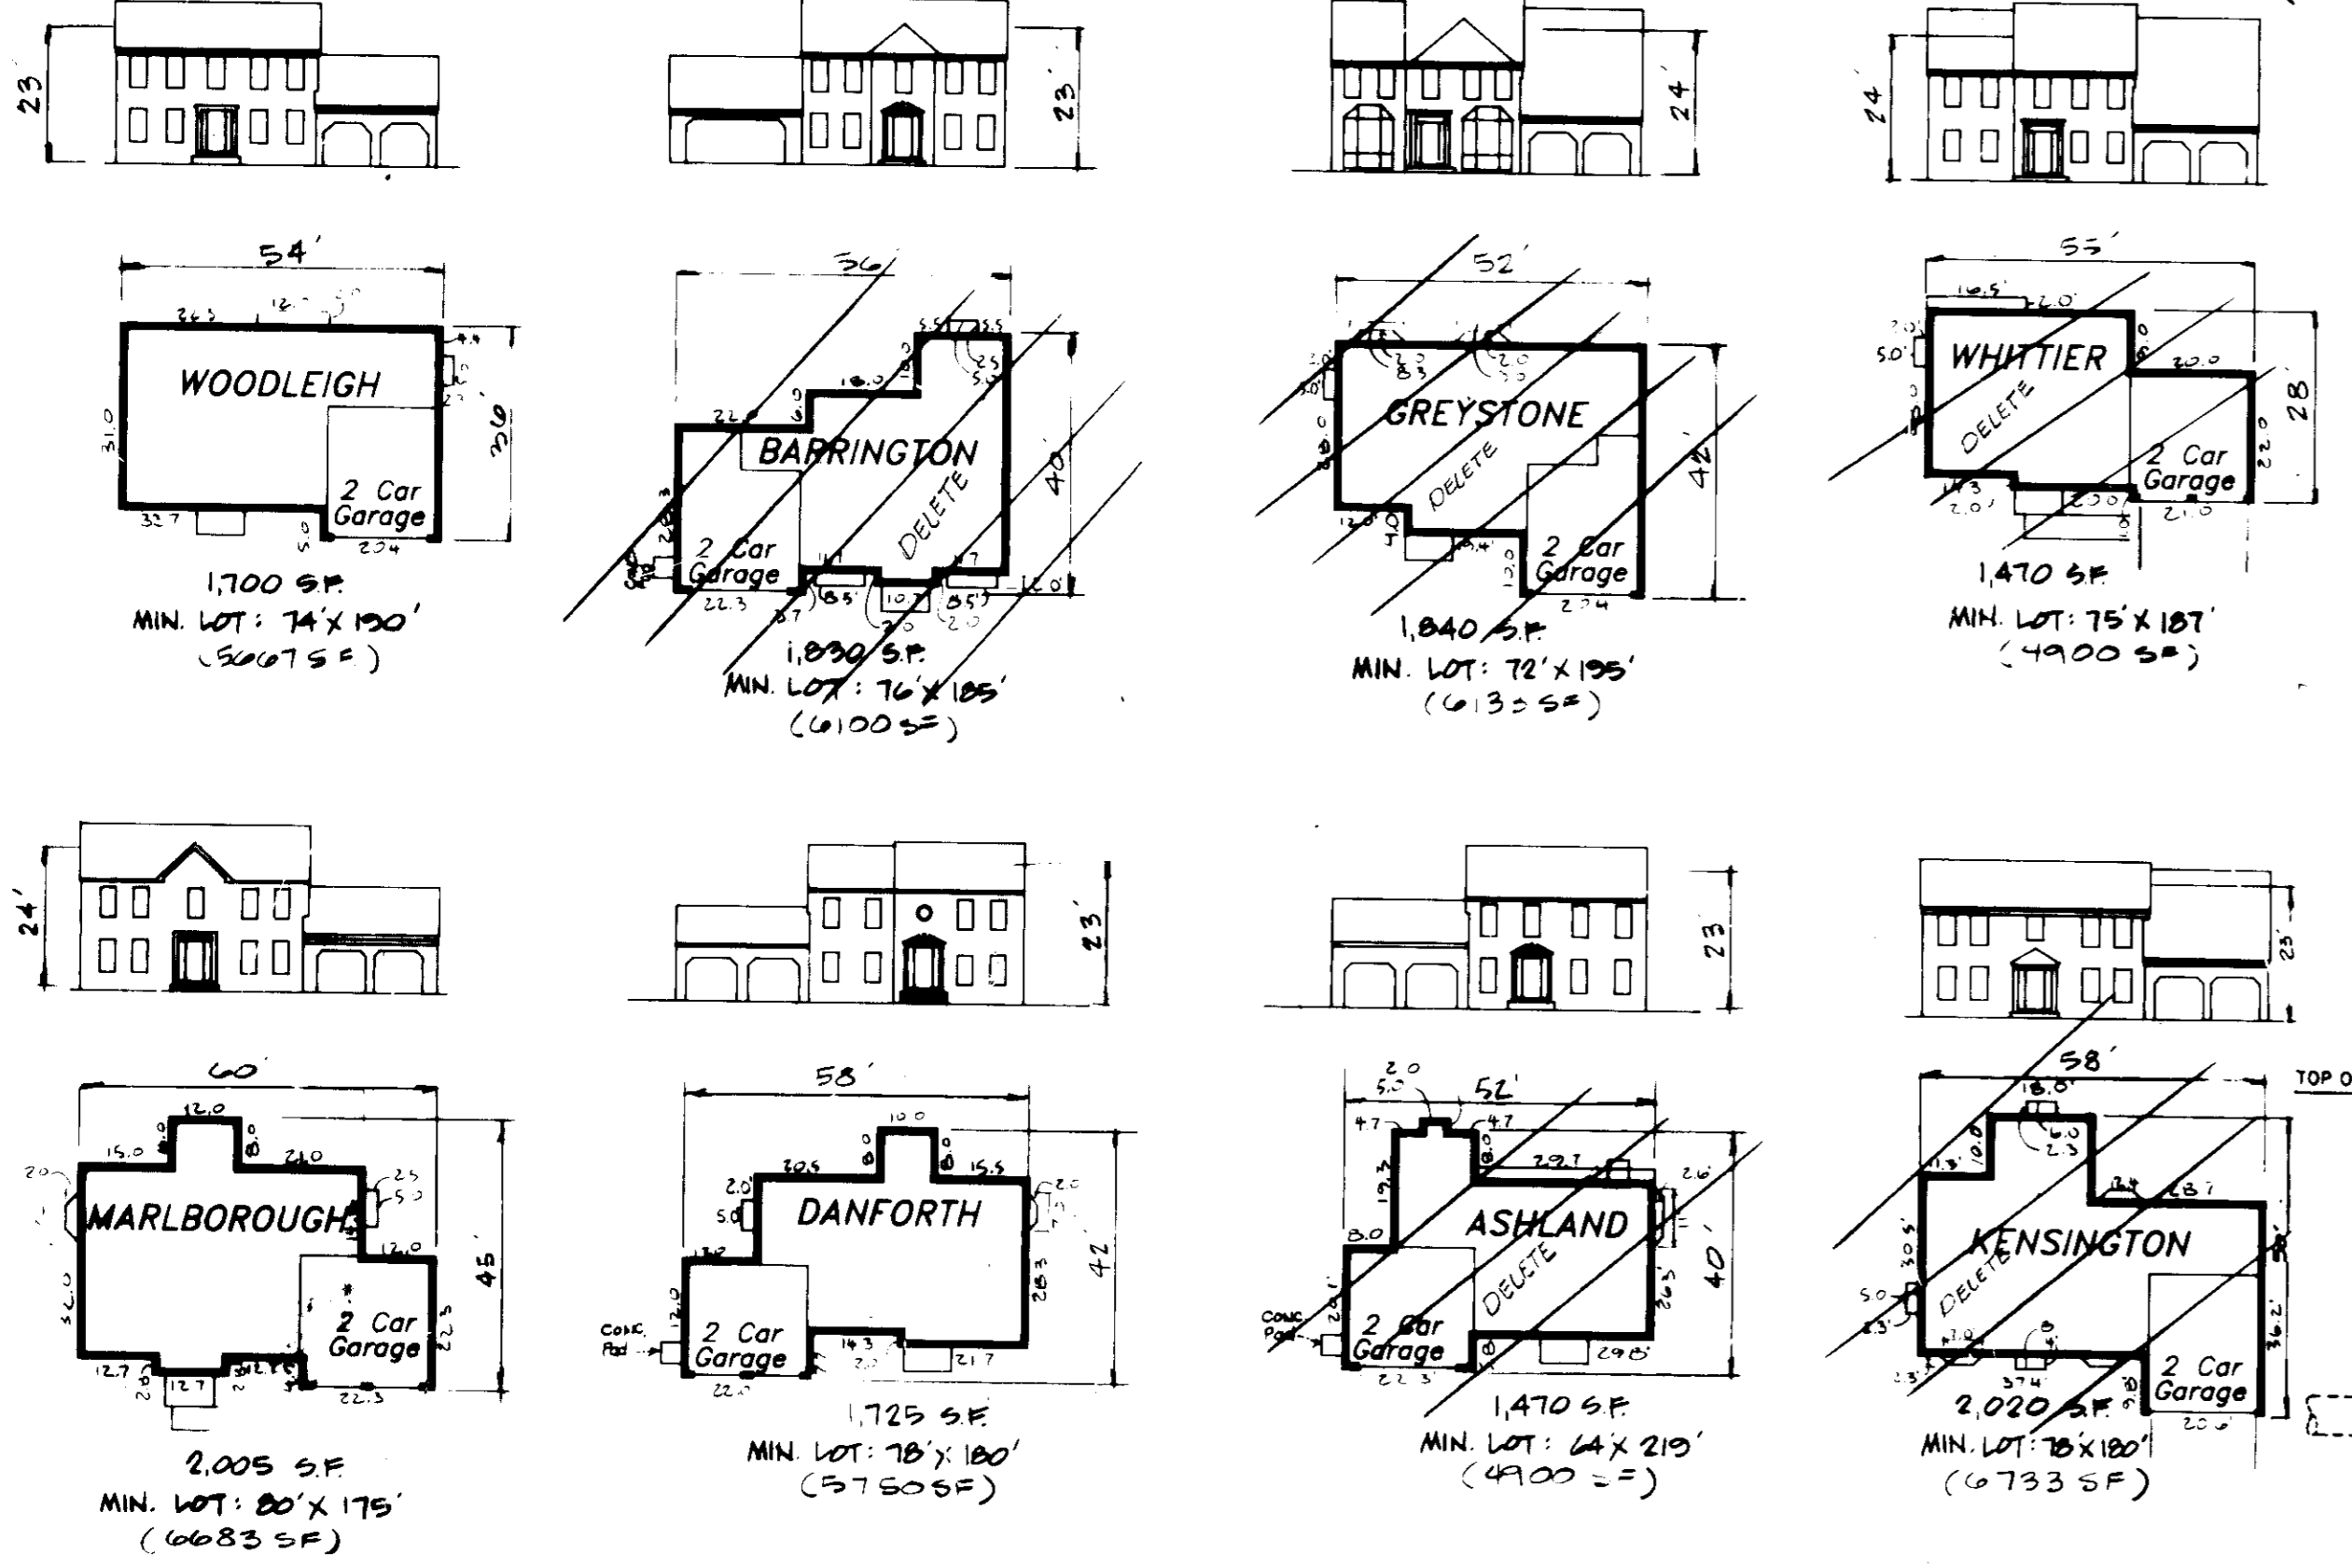


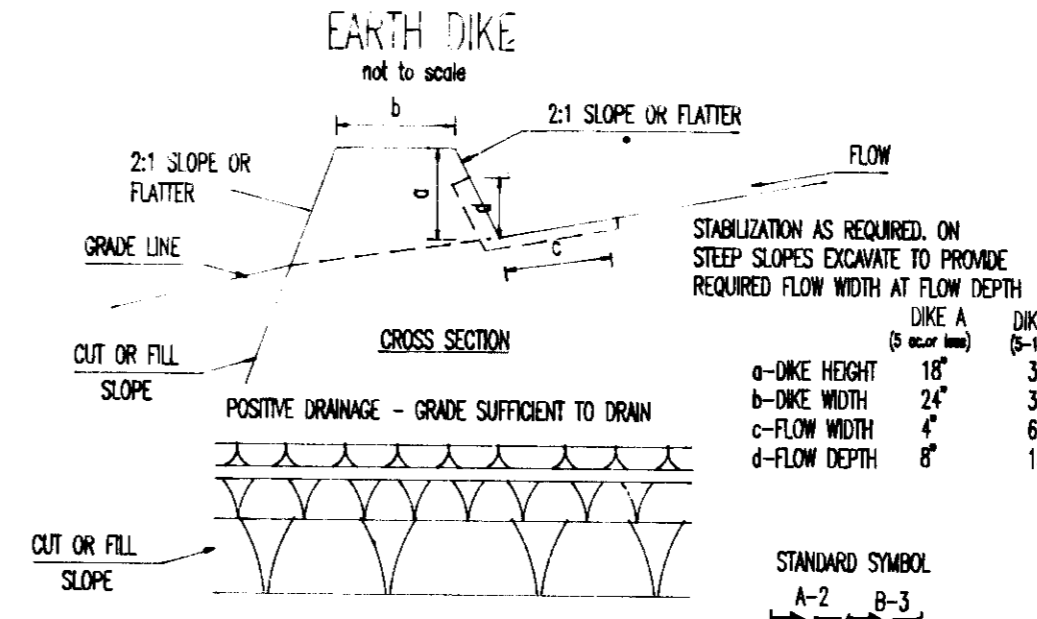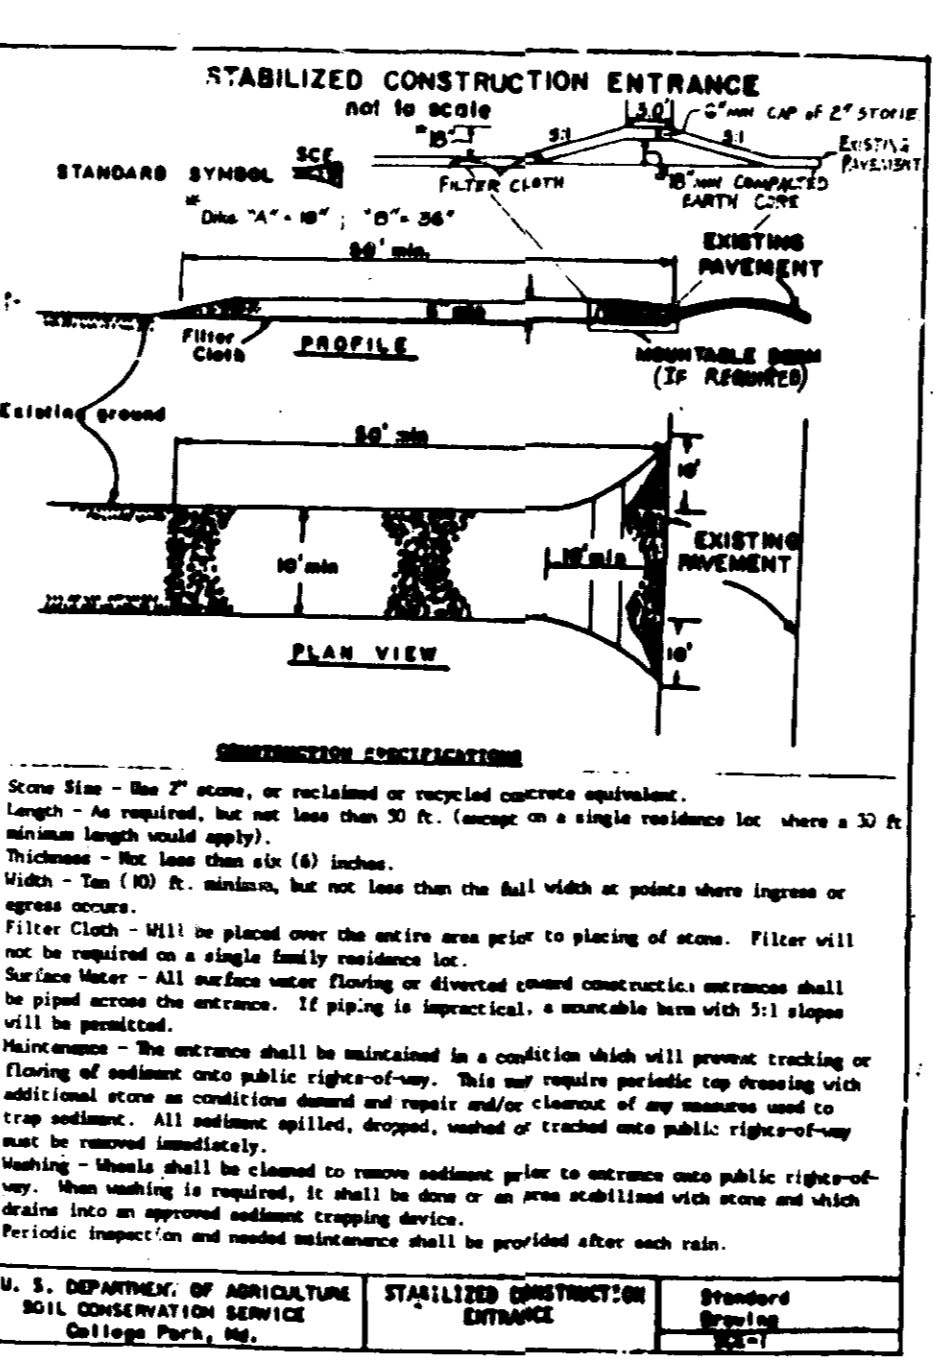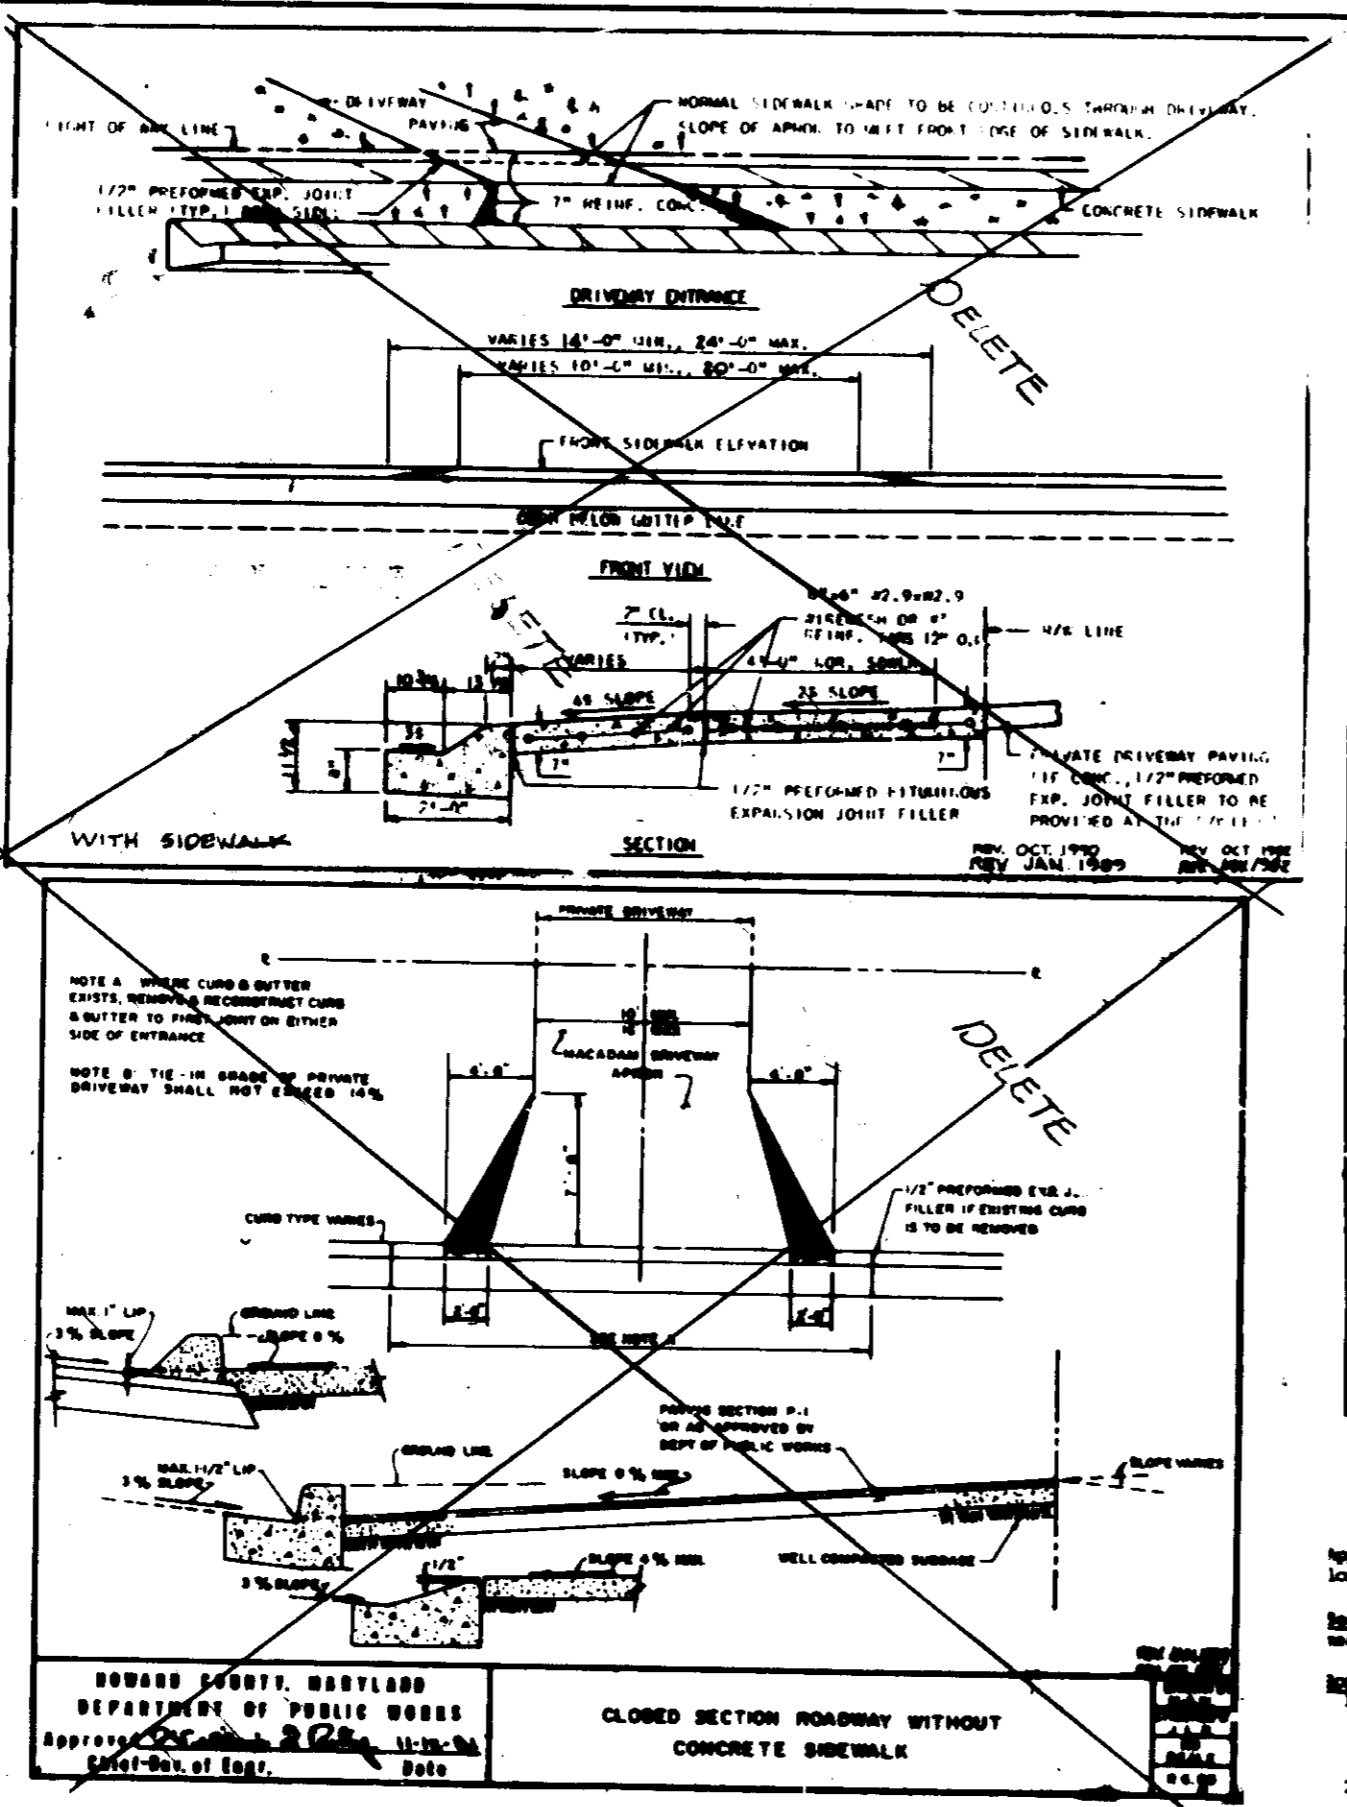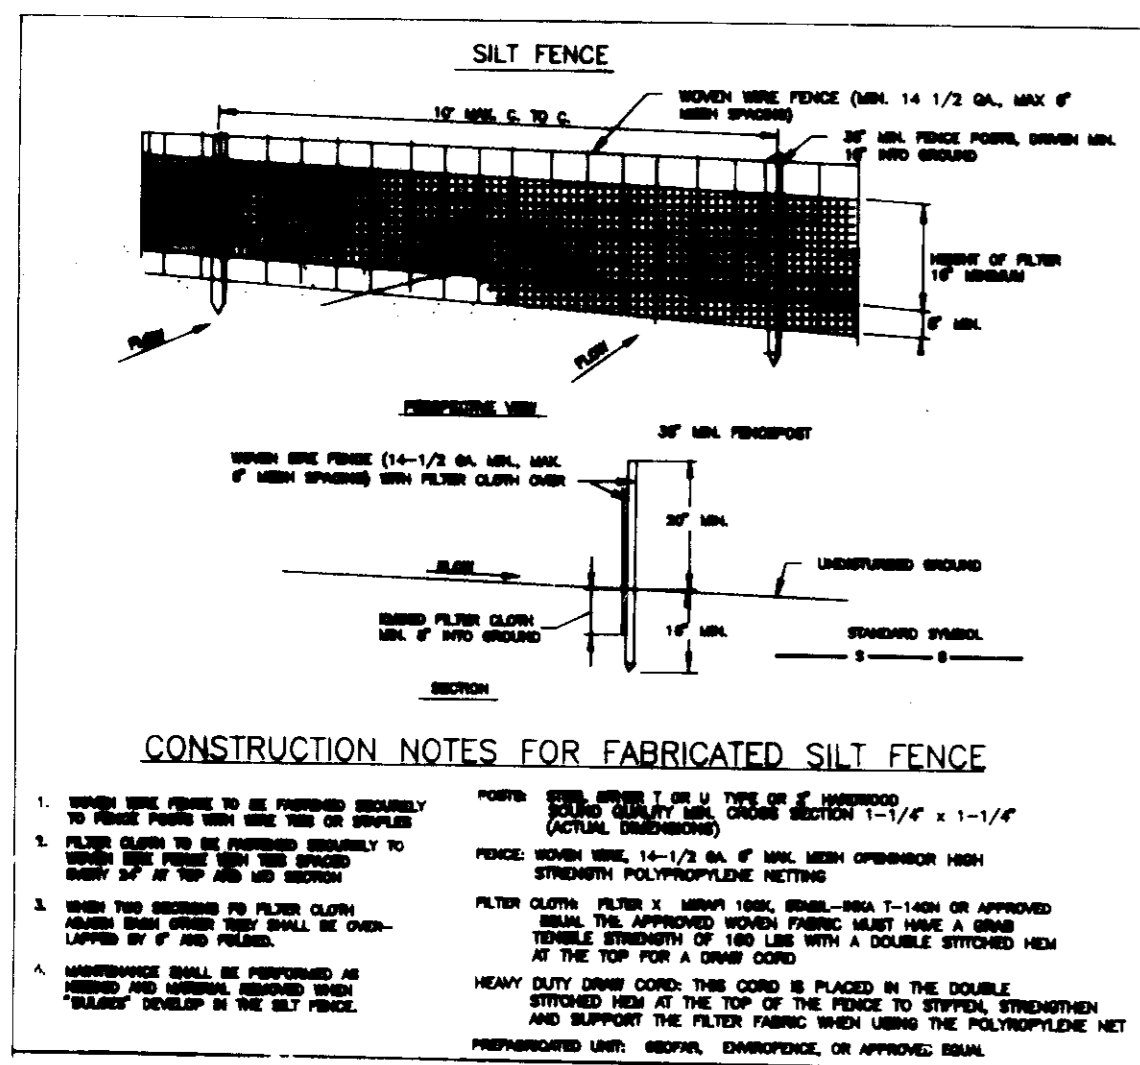SEDIMENT CONTROL NOTES

1. A minimum of 24 hours notice must be given to the Howard County Office of Inspection and Permits prior to the start of any construction (882-2437).
2. All vegetative and structural practices are to be installed according to the provisions of this plan and are to be in conformance with the 1983 MARYLAND STANDARDS AND SPECIFICATIONS FOR SOIL EROSION AND SEDIMENT CONTROL.
3. Following initial soil disturbance or reduction, permanent or temporary stabilization shall be completed within 7 calendar days for all perimeter sediment control structures, otherwise perimeter slopes and all slopes greater than 3:1, by 14 days as to all other disturbed or graded areas on the project site.
4. All sediment traps/basins shown must be fenced and warning signs posted around their perimeter in accordance with Vol. 1, Chapter 12, of the HOWARD COUNTY DESIGN MANUAL, Storm Drainage.
5. All disturbed areas must be stabilized within the time period specified above in accordance with the 1983 MARYLAND STANDARDS AND SPECIFICATIONS FOR SOIL EROSION AND SEDIMENT CONTROL for permanent seeding (Sec 51) and (Sec 54), temporary seeding (Sec 52) and mulching (Sec 53). Temporary stabilization with mulch alone can only be done when recommended seeding dates do not allow for proper germination and establishment of grasses.
6. All sediment control structures are to remain in place and are to be maintained in operative condition until permission for their removal has been obtained from the Howard County Sediment Control Inspector.
7. Site Analysis

Total Area of Site	1.1 Acres
Area Disturbed	1.0 Acres
Area to be vegetated or paved	0.2 Acres
Area to be temporarily stabilized	0.6 Acres
Total Cut	200.0 Cu yds
Total Fill	1,000.0 Cu yds
Offsite waste/borrow area location	N/A

8. Any sediment control practice which is disturbed by grading activity for placement of utilities must be repaired on the same day of disturbance.
9. Additional sediment controls must be provided, if deemed necessary by the Howard County DPW sediment control inspector.
10. On all sites with disturbed areas in excess of 2 acres, approval of the inspection agency shall be requested upon completion of installation of perimeter erosion and sediment control, but before proceeding with any other earth disturbance or grading. Other building or grading inspection approvals may not be authorized until this initial approval by the inspection agency is made.



TEMPORARY SEDIMENT CONTROL

Apply to cleared areas likely to be re-disturbed within a short-term vegetation cover 1 week.




Approved Vegetation: - Loosen upper three inches of soil by raking, disking or other acceptable means before seeding, if not previously loosened.

Soil Amendments: - Apply 400 lb per acre 13-18-18 Fertilizer (14 lbs/1000 sq. ft.).

Seeding: - For periods March 1 thru April 30 and from August 1 thru October 15, seed with 2-2 seed with 40 lbs/1000 sq. ft. of Kentucky 31 Tall Fescue. For the period May 1 thru July 31, seed with 40 lbs/1000 sq. ft. of Kentucky 31 Tall Fescue per acre and 2 lbs/1000 sq. ft. of 117 - 100 lbs per acre of well anchored straw mulch and seed as soon as possible in the spring. Option (2) - Use seed. Option (3) - Seed with 40 lbs/1000 sq. ft. of Kentucky 31 Tall Fescue and mulch with 2 tons/acre well anchored straw.

Mulching: - Apply 1-1/2 to 2 tons per acre (78 to 99 lbs/1000 sq. ft.) of untreated small grain straw immediately after seeding. Mulch must immediately after application with mulch mowing tool or 218 gal per acre (5 gal/1000 sq. ft.) of emulsified asphalt on flat areas. On slopes 8 ft. or higher, use 180 gal per acre (5 gal/1000 sq. ft.) for anchoring. Refer to the 1983 MARYLAND STANDARDS AND SPECIFICATIONS FOR SOIL EROSION AND SEDIMENT CONTROL for additional rates and methods not covered.

REV 1/91

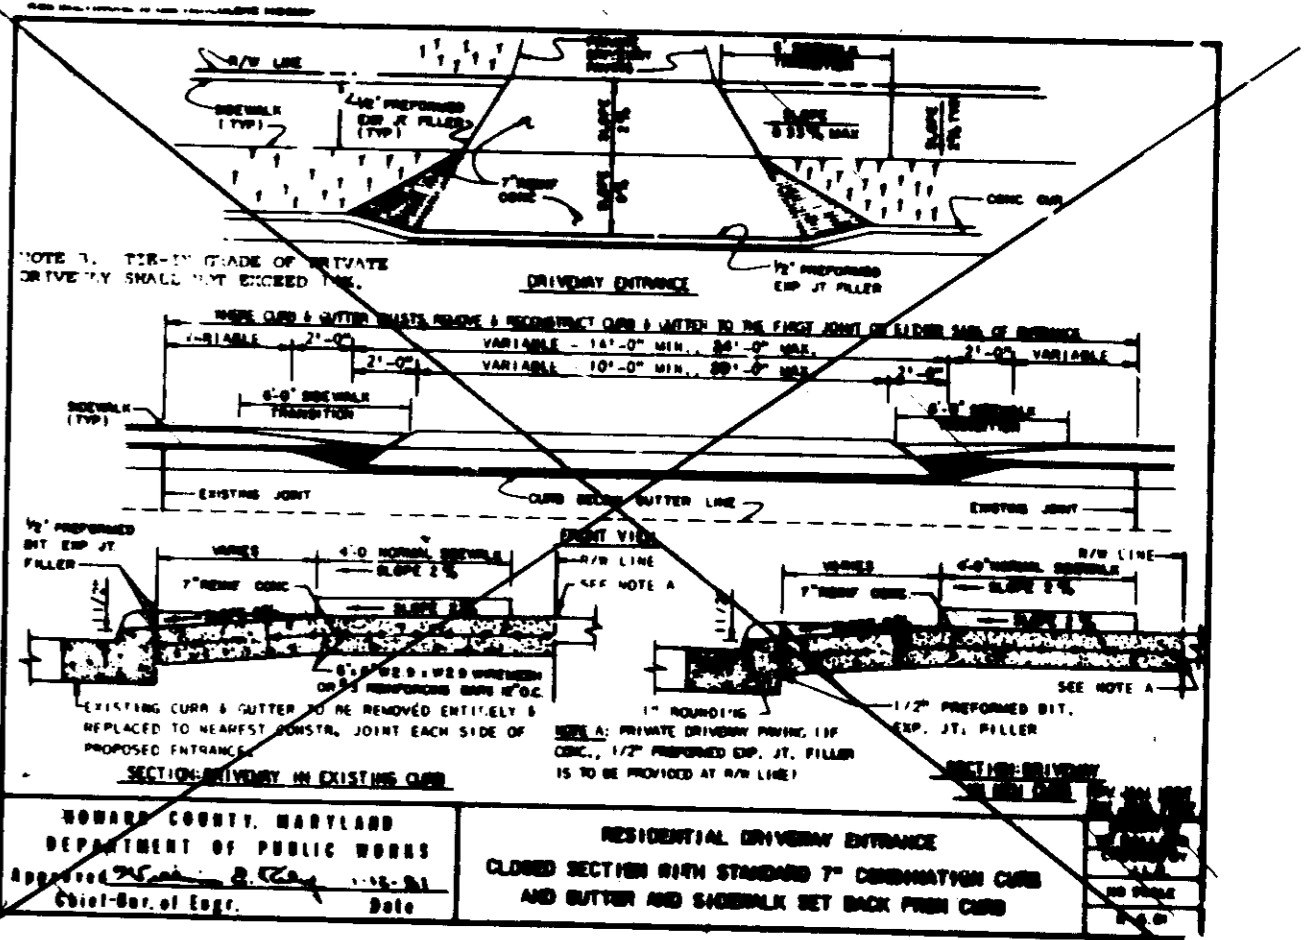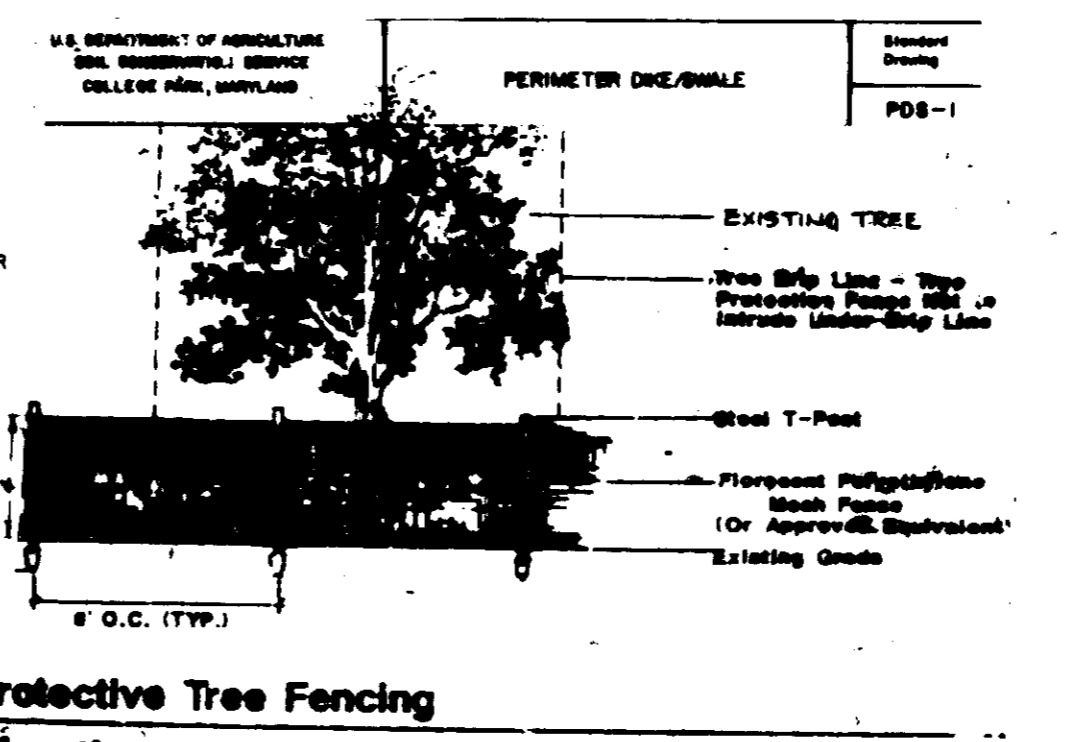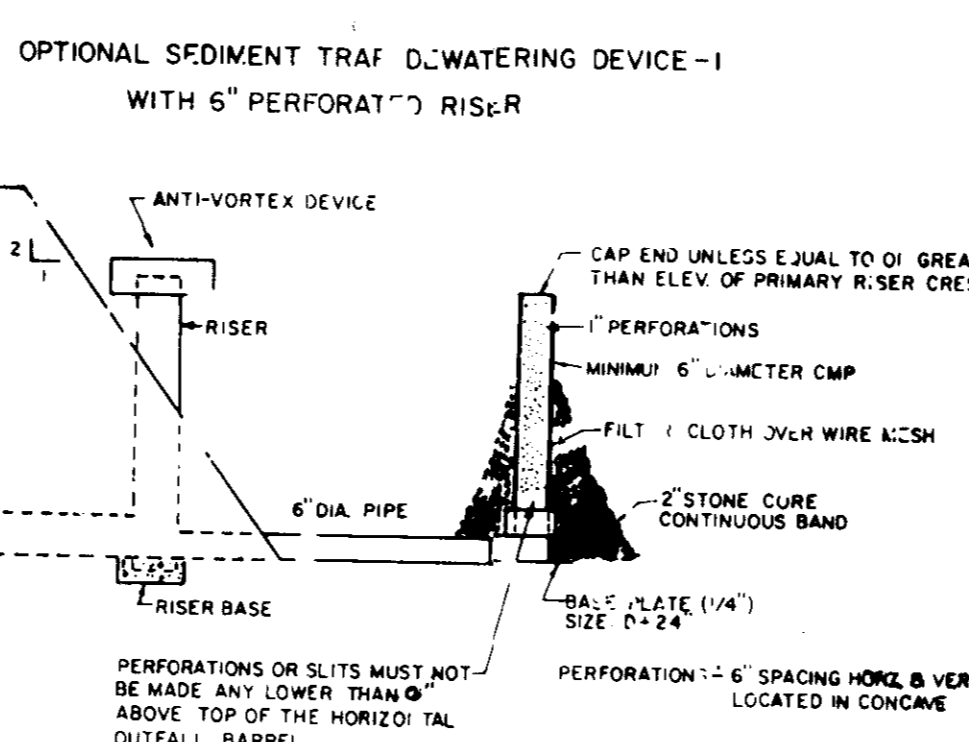

NOTE: THERE WILL BE NO LIBRARIES, SOLARIUMS OR COVERED DECK OPTIONS ON THIS DRG SUBMISSION.

DEVELOPERS/BUILDER'S CERTIFICATE

I/WE CERTIFY THAT ALL DEVELOPMENT AND CONSTRUCTION WILL BE DONE ACCORDING TO THIS PLAN OF DEVELOPMENT AND PLAN FOR EROSION AND SEDIMENT CONTROL AND THAT ALL RESPONSIBLE PERSONS INVOLVED IN THE CONSTRUCTION PROJECT WILL HAVE A CERTIFICATE OF ATTENDANCE AT A MIN. LEVEL OF THE ENVIRONMENT APPROVED TRAINING PROGRAM FOR THE CONTROL OF SEDIMENT AND EROSION CONTROL BEFORE BEGINNING THE PROJECT. I ALSO AUTHORIZE PERIODIC ON-SITE INSPECTION BY THE HOWARD SOIL CONSERVATION DISTRICT OR THEIR AUTHORIZED AGENTS AS DEEMED NECESSARY.

DATE: 6/22/93

ENGINEERS CERTIFICATE

I CERTIFY THAT THIS PLAN FOR EROSION AND SEDIMENT CONTROL REPRESENTS A PRACTICAL AND WORKABLE PLAN BASED ON MY PERSONAL KNOWLEDGE OF SITE CONDITIONS AND THAT IT WAS PREPARED IN ACCORDANCE WITH THE REQUIREMENTS OF THE HOWARD SOIL CONSERVATION DISTRICT.

DATE: 6/23/93

APPROVED FOR PUBLIC WATER AND PUBLIC SEWERAGE SYSTEMS HOWARD COUNTY HEALTH DEPARTMENT

DATE: 9-24-93

APPROVED HOWARD COUNTY DEPT. OF PLANNING & ZONING

DATE: 10/4/93

APPROVED FOR PUBLIC WATER AND PUBLIC SEWERAGE STORM DRAINAGE SYSTEMS AND PUBLIC ROADS HOWARD COUNTY DEPARTMENT OF PUBLIC WORKS

DATE: 9/22/93

THIS DEVELOPMENT PLAN IS APPROVED FOR SOIL EROSION AND SEDIMENT CONTROL BY THE HOWARD SOIL CONSERVATION DISTRICT.

DATE: 9/15/93

REVIEWED FOR HOWARD S.C.D. AND MEETS TECHNICAL REQUIREMENTS.

DATE: 9/15/93

LAND DESIGN ASSOCIATES

718 HIGHWOOD DRIVE
BALTIMORE, MD 21212
TEL. 410-323-6344

SUBDIVISION NAME	WORTHINGTON RESERVES	SECT./AREA	SECTION 1	LOTS	54-56	PREVIOUS SUBMITTALS	F-92-50 WP-90-20 P-90-07 WP-91-178 S-89-50
PLAT # or L/F	31	ZONE	R-20	ELEC. DIST.	2ND	CENSUS TR.	6-27
WATER CODE	G01	SEWER CODE	1257013				
WORTHINGTON RESERVES							
SECTION ONE							
2ND ELECTION DISTRICT		LOTS 54 - 56		HOWARD COUNTY, MD			
SITE DEVELOPMENT AND SEDIMENT CONTROL							
FOR:	GRAYSON HOMES INC. 9025 CHEVROLET DRIVE ELLCOTT CITY, MD 21043	DESIGNED:	EW	SCALE:	1"=30'	SHEET	2 OF 2
		DRAWN:	CD	DATE:	6-8-93		
		CHECKED:	EW				