SHEET INDEX				
NO.	DESCRIPTION			
i	TITLE SHEET			
	SITE DEVELOPMENT PLAN-SOUTH			
3	SITE DEVELOPMENT PLAN-NORTH			
4	PROFILES			
5	PROFILES			
6	CONSTRUCTION DETAILS			
an d	CONSTRUCTION DETAILS			
8	CONSTRUCTION DETAILS			
Э	EXISTING CONDITIONS, DRAINAGE AREAS, & ENVIRONMENTAL ANALYSIS PLAN			
10	O SEDIMENT CONTROL AND DRAINAGE AREA MAP			
	STORMWATER AND SEDIMENT CONTROL NOTES AND DETAILS			
[2]	LANDSCAPING PLAN			

GENERAL NOTES

ALL CONSTRUCTION SHALL BE IN ACCORDANCE WITH THE LATEST STANDARDS AND SPECIFICATIONS OF HOWARD COUNTY PLUS MSHA STANDARDS AND SPECIFICATIONS IF APPLICABLE.

THE CONTRACTOR SHALL NOTIFY THE DEPARTMENT OF PUBLIC WORKS/BUREAU OF CONSTRUCTION INSPECTION AT (301) 792-7272 AT LEAST FIVE (5) WORKING DAYS PRIOR TO THE START OF WORK.

THE CONTRACTOR SHALL NOTIFY "MISS UTILITY" AT 1-800-257-7777 AT LEAST 48 HOURS PRIOR TO ANY EXCAVATION WORK.

AN ORIGINAL RECORD PLAT, FILE NUMBER F-73-43, WAS APPROVED IN 1973 BY HOWARD COUNTY, MARYLAND, ON JULY 13, 1977, A SITE DEVELOPMENT PLAN APPROVAL WAS GRANTED BY HOWARD COUNTY. MARYLAND TO THEN OWNER AND DEVELOPER DIGNAN TRUCKING, INC THE COUNTY FILE NUMBER IS SDP-77-95 . IN 1986 , A RESUBDIVISION OF PARCELS "A" & "B" WAS APPROVED, THEREBY CREATING PARCEL "A-!" THE COUNTY FILE NUMBER IS F-86-165.

PARCEL "A-1" AND ALL ADJACENT PROPERTIES 40F ZONED M-1.

6. TRAFFIC CONTROL DEVICES, MARKINGS, AND SIGNING SHALL BE IN ACCORDANCE WITH THE LATEST EDITION OF THE MANUAL ON UNIFORM TRAFFIC CONTROL DEVICES (MUTCD). ALL STREET AND REGULATORY SIGNS SHALL BE IN PLACE PRIOR TO THE PLACEMENT OF ANY ASPHALT

7. ALL PLAN DIMENSIONS ARE TO THE FACE OF CURB UNLESS OTHERWISE NOTED

8. THE BOUNDARY AND TOPOGRAPHICAL SURVEY WAS PERFORMED BY HARRIS, SMARIGA, MATZ, INC. OF BALTIMORE, MARYLAND DURING NOVEMBER, 1991. THE CONTOUR INTERVAL CONTAINED ON THESE PLANS ARE ONE (1) FOOT. COORDINATES ARE BASED ON MARYLAND STATE GRID AS TAKEN FROM A PLAT OF RESUBDIVISION OF "HARWOOD INDUSTRIAL CENTER" PLAT 6755, HOWARD COUNTY, MARYLAND. VERTICAL CONTROL WAS BASED UPON THE FOLLOWING HOWARD COUNTY CONTROL POINTS:

- # 2445004 ELEVATION 192.59 ELEVATION 172.65 **- #** 2445*00*5

9. PARCEL "A-I" IS SERVED BY PUBLIC WATER AND SEWER. THE WATER AND SANITARY SEWER MAINS ARE LOCATED WITHIN THE RIGHT-OF-WAY OF SOUTH HANOVER ROAD THE CONTRACT NUMBER FOR THE WATER AND SEWER IS 256.

O. THE 100 YEAR FLOODPLAIN AND DRAINAGE EASEMENT AS SHOWN ON DWGS. NO. 2 & 3 of 12 WAS TAKEN FROM THE SITE DEVELOPMENT PLANS APPROVED IN 1977 WHICH WAS ORIGINALLY TAKEN FROM PLANS PREPARED BY PURDUM AND JESCHKE, CONSULTING ENGINEERS. THE 100 YEAR FLOOD ELEVATION CORRESPONDED TO THAT AS SHOWN ON THE APPROVED RESUBDIVISION OF PARCELS ' A & B", DATED, 1986.

APPROXIMATE LOCATIONS OF EXISTING UTILITIES ARE SHOWN FROM BEST AVAILABLE INFORMATION. THE CONTRACTOR SHALL TAKE ALL NECESSARY PRECAUTIONS TO PROTECT THE EXISTING UTILITIES AND MAINTAIN UNINTERRUPTED SERVICE. ANY DAMAGE INCURRED DUE TO CONTRACTOR'S OPERATION SHALL BE REPAIRED IMMEDIATELY AT THE CONTRACTOR'S EXPENSE.

INDICATION OF SLOPES 15-24.99% AND THOSE 25% OR GREATER ARE SHOWN ON DWG NO. 9 of 12

13. NORTH ARROW AS SHOWN ON THESE DRAWINGS REPRESENT MARYLAND GRID NORTH.

14. STORMWATER MANAGEMENT FACILITIES WILL BE PROVIDED FOR STORMWATER QUALITY AND RUNOFF RATE CONTROL THROUGH THE USE OF AN OIL/WATER SEPARATOR AND MODIFICATION OF AN EXISTING

15. A WETLANDS DELINEATION STUDY WAS CONDUCTED ON JANUARY 30, 1992. THE WETLANDS WERE IDENTIFIED AND DELINEATED USING THE ROUTINE DELINEATION METHODOLOGY PROCEDURE FOR DISTURBED AREAS AS DESCRIBED IN THE FEDERAL MANUAL FOR IDENTIFYING AND DELINEATING JURISDICTIONAL WETLANDS, U.S. ACOE, U.S. ENVIRONMENTAL PROTECTION AGENCY (EPA), U.S. FWS, AND THE U.S. DEPARTMENT OF AGRICULTURE SCS, 1989. A JOINT APPLICATION FOR THE ALTERATION OF A NONTIDAL WETLAND WAS SUBMITTED ON MARCH 11, 1992 TO WETLANDS AND WATERWAYS PROGRAM, HOWARD COUNTY DEPT. OF PLANNING AND ZONING AND HOWARD COUNTY CONSERVATION DISTRICT.

16. STORMWATER MANAGEMENT FACILITIES WILL BE PRIVATELY OWNED AND MAINTAINED.

17. AN OPEN-TOP, ROLL-OFF CONTAINER WITH A MAXIMUM CAPACITY OF 30 C.Y. WILL BE USED FOR ON-SITE REFUSE STORAGE. THE TYPICAL SIZE FOR THESE CONTAINERS IS 8 IN WIDTH AND 20 IN LENGTH. ADEQUATE SPACE FOR THE CONTAINER IS PROVIDED AT THE LOCATION IDENTIFIED ON DWG. NO. 3 of 12. 18. THE EXISTING AND PROPOSED BUILDINGS ON SITE SHALL BE EQUIPPED WITH AN

AUTOMATIC SPRINKLER SYSTEM 19. ALL TREES OUTSIDE OF THE LIMIT OF DISTURBANCE SHALL BE RETAINED FOLLOWING THE PROPOSED CONSTRUCTION. PROTECTIVE FENCING SHALL BE INSTALLED ALONG THE LIMIT OF DISTURBANCE WITHIN THE TREE AREA TO PROTECT THE TREES WHICH ARE TO REMAIN REFER TO PROTECTIVE FENCE DETAIL ON DWG. NO. 8 OF 12.

PROJECT BACKGROUND:

FLOOR SPACE PER USE

MAINTENANCE AREA:

TERMINAL

OFFICE (LOWER LEVEL):

OFFICE (UPPER LEVEL).

OFFICE (TERMINAL AREA)

BUILDING COVERAGE ON SITE:

NUMBER OF EMPLOYEES

OFFICE

OTHERS

TOTAL

ZONING.

SITE AREA (PARCEL "A-I"):

INTENDED USE OF STRUCTURES:

459,358 SQ. FT.±

OFFICE, MAINTENANCE,

& TRUCK TERMINAL

10.5454 AC.±

4,036 SQ. FT.

4,036 SQ. FT

1,020 SQ. FT

4,900 SQ. FT

18.713 SQ. FT

28.669 SQ. FT.

16 2% OF TOTAL SITE!

SITE DEVELOPMENT PLAN NEW PENN MOTOR EXPRESS, INC. TERMINAL EXPANSION PROJECT

HARWOOD INDUSTRIAL CENTER 6351 SOUTH HANOVER ROAD HOWARD COUNTY, MARYLAND

ADDRESS CHART

ZONING - TAX MAP NO -

M-I

PARCEL


HARWOOD INDUSTRIAL CENTER

STREET ADDRESS

6351 SOUTH HANOVER ROAD

2150519

PROFESSIONAL ENGINEER

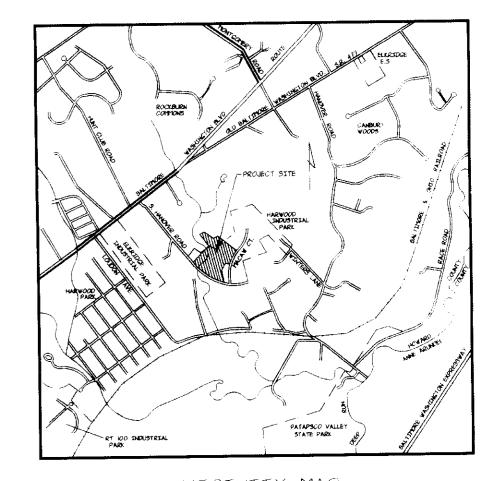


VICINITY MAP

THESE PLANS FOR SMALL POND CONSTRUCTION, SOIL EROSION AND

SEDIMENT CONTROL MEET THE REQUIREMENTS OF THE HOWARD SOLL

APPROVED: FOR PUBLIC WATER AND PUBLIC SEWERAGE SYSTEMS HOWARD COUNTY HEALTH DEPARTMENT

CONSERVATION DISTRICT

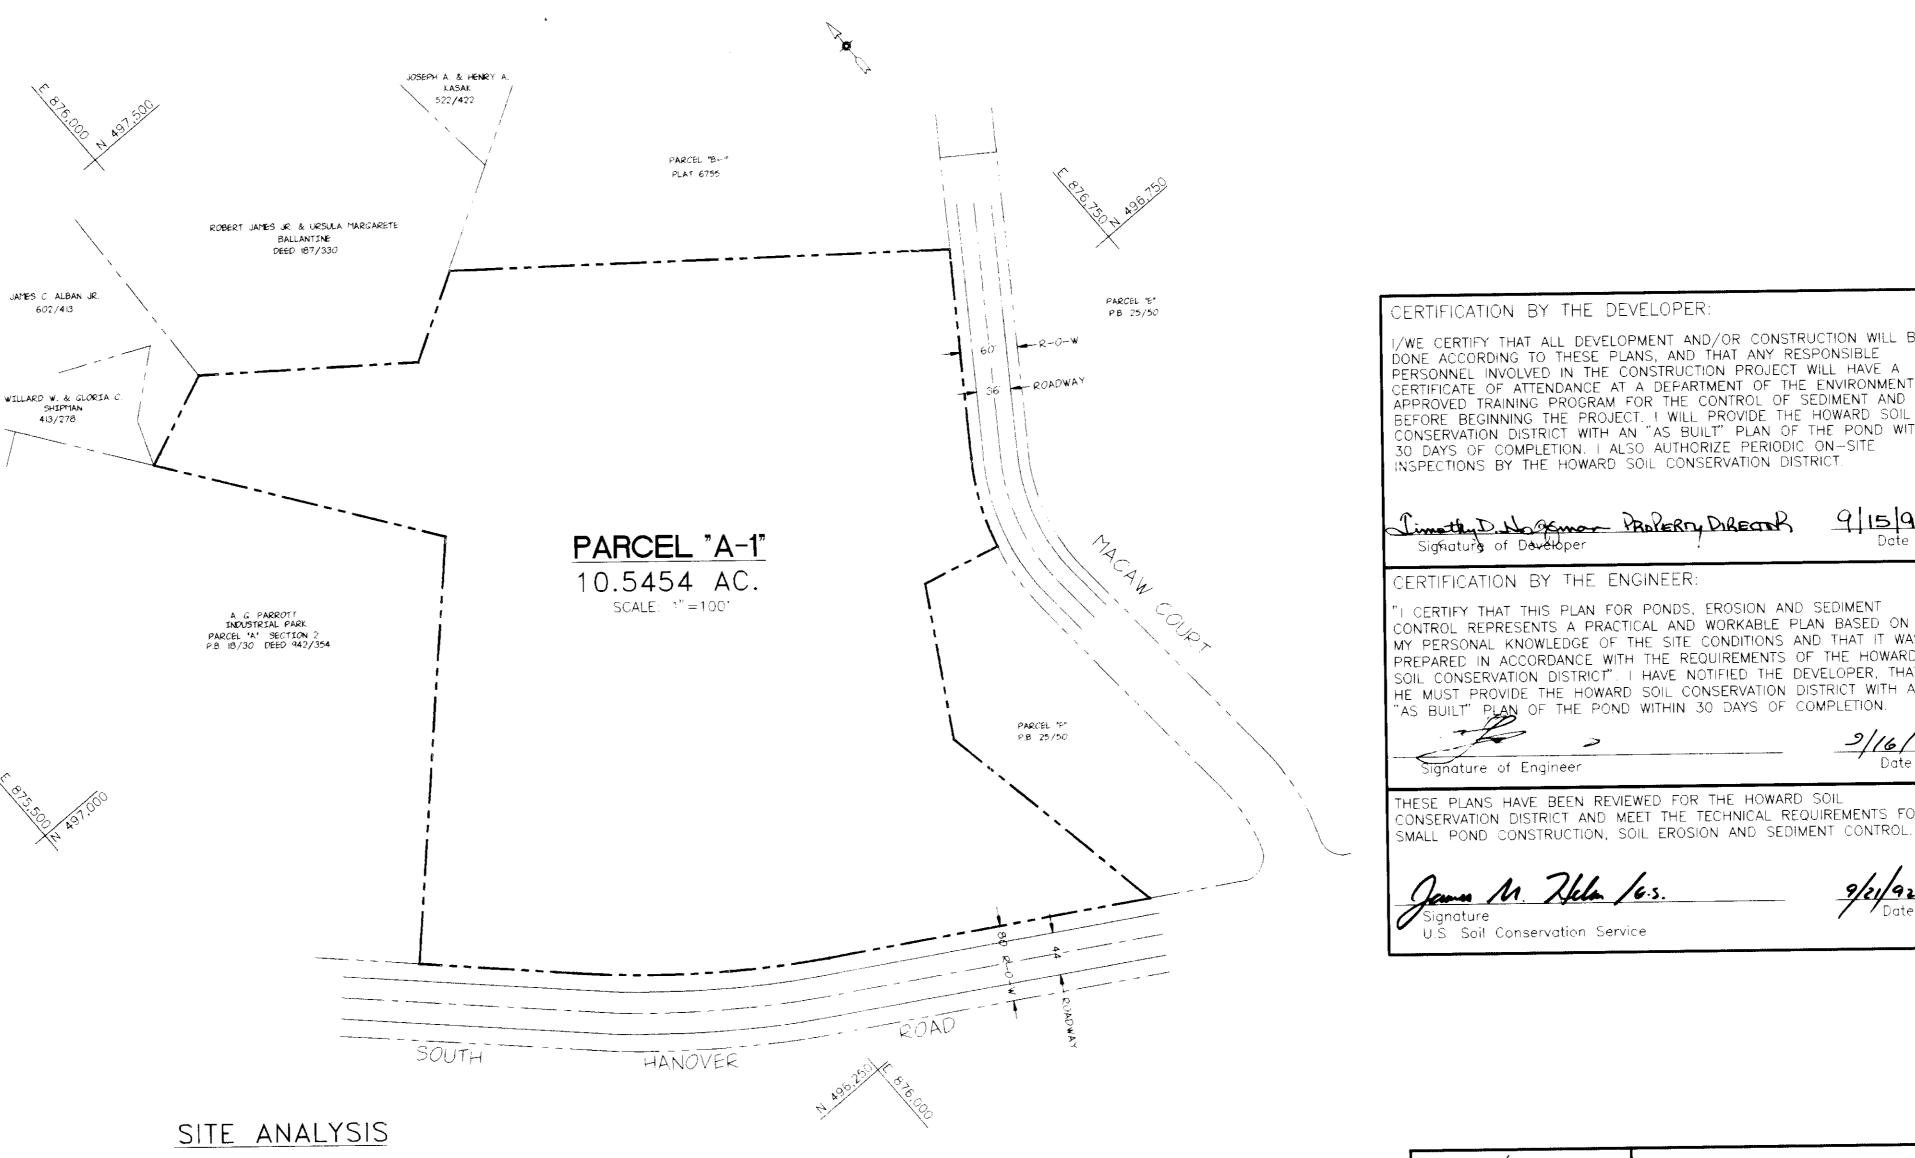

@I SPACE/500 SQ. FT

24,633 SQ. FT./500 - 49

@7 SPACES/10 EMPLOYEES

WORKING AT ONE TIME

 $7/10 \times 7 = 5$

49 + 5 = 54

53.427 SQ. FT.

2,671 SQ. FT. (5%)

4.455 SQ. FT. (8.3%)

PARKING REQUIRED (AS PER ZONING REGULATIONS)

127.B.2.b(7) MANUFACTURING

NUMBER OF PARKING SPACES PROVIDED:

LANDSCAPED ISLANDS REQUIRED:

LANDSCAPED ISLANDS PROVIDED

127.B.2.b.(13) OFFICES

TRACTOR:

TRAILER:

EMPLOYEES:

VISITORS:

HANDICAPPED.

AREA OF PARKING

County Health Officer APPROVED: HOWARD COUNTY DEPARTMENT OF PLANNING AND ZONING CERTIFICATION BY THE DEVELOPER: /WE CERTIFY THAT ALL DEVELOPMENT AND/OR CONSTRUCTION WILL BE DONE ACCORDING TO THESE PLANS, AND THAT ANY RESPONSIBLE PERSONNEL INVOLVED IN THE CONSTRUCTION PROJECT WILL HAVE A CERTIFICATE OF ATTENDANCE AT A DEPARTMENT OF THE ENVIRONMENT APPROVED TRAINING PROGRAM FOR THE CONTROL OF SEDIMENT AND BEFORE BEGINNING THE PROJECT. I WILL PROVIDE THE HOWARD SOIL CONSERVATION DISTRICT WITH AN "AS BUILT" PLAN OF THE POND WITHIN 30 DAYS OF COMPLETION. I ALSO AUTHORIZE PERIODIC ON-SITE APPROVED: FOR PUBLIC WATER AND PUBLIC SEWERAGE, STORM INSPECTIONS BY THE HOWARD SOIL CONSERVATION DISTRICT. DRAINAGE SYSTEMS AND PUBLIC ROADS HOWARD COUNTY DEPARTMENT OF PUBLIC WORKS Timethy D. Nogeman PROPERTY DIRECTOR 9 15 92 Signature of Developer CERTIFICATION BY THE ENGINEER: I CERTIFY THAT THIS PLAN FOR PONDS, EROSION AND SEDIMENT CONTROL REPRESENTS A PRACTICAL AND WORKABLE PLAN BASED ON MY PERSONAL KNOWLEDGE OF THE SITE CONDITIONS AND THAT IT WAS Chief, Bureau of Engineering Co Vichz PREPARED IN ACCORDANCE WITH THE REQUIREMENTS OF THE HOWARD SOIL CONSERVATION DISTRICT" I HAVE NOTIFIED THE DEVELOPER, THAT "AS BUILT" PLAN OF THE POND WITHIN 30 DAYS OF COMPLETION. HE MUST PROVIDE THE HOWARD SOIL CONSERVATION DISTRICT WITH AN Signature of Engineer THESE PLANS HAVE BEEN REVIEWED FOR THE HOWARD SOIL CONSERVATION DISTRICT AND MEET THE TECHNICAL REQUIREMENTS FOR

DESCRIPTION 1/2/92 ADD NOTES 18 AND 19, REVISE SITE ANALYSIS AND PERMIT BLOCK. REVISE SITE ANALYSIS BLOCK

OWNER AND DEVELOPER

NEW PENN MOTOR EXPRESS, INC.

625 SOUTH FIFTH AVENUE LEBANON, PENNSYLVANIA 17042 (717) 274-2521

TITLE SHEET


PARCEL A-1 RECORDED IN PLAT BOOK 6755 HARWOOD INDUSTRIAL CENTER FIRST FLECTION DISTRICT-HOWARD COUNTY, MARYLAND


FIRST ELECTI	ON DISTRICT-HOWARD	COOMIT,	1417-373-1
CENSUS TRAC	T NO. 6012	TAX	MAP
SCALE AS NOTED	SKELLY AND LO		AWN BY
DATE 4/15/192	ENGINEERS—CONSULTANTS 2601 N. FRONT STREET		ECKED BY
NO Y 72 <i>0008-0</i> 2	HARRISBURG, PENNSYLVANI (717) 232-0593	A 17110 DW	G. NO


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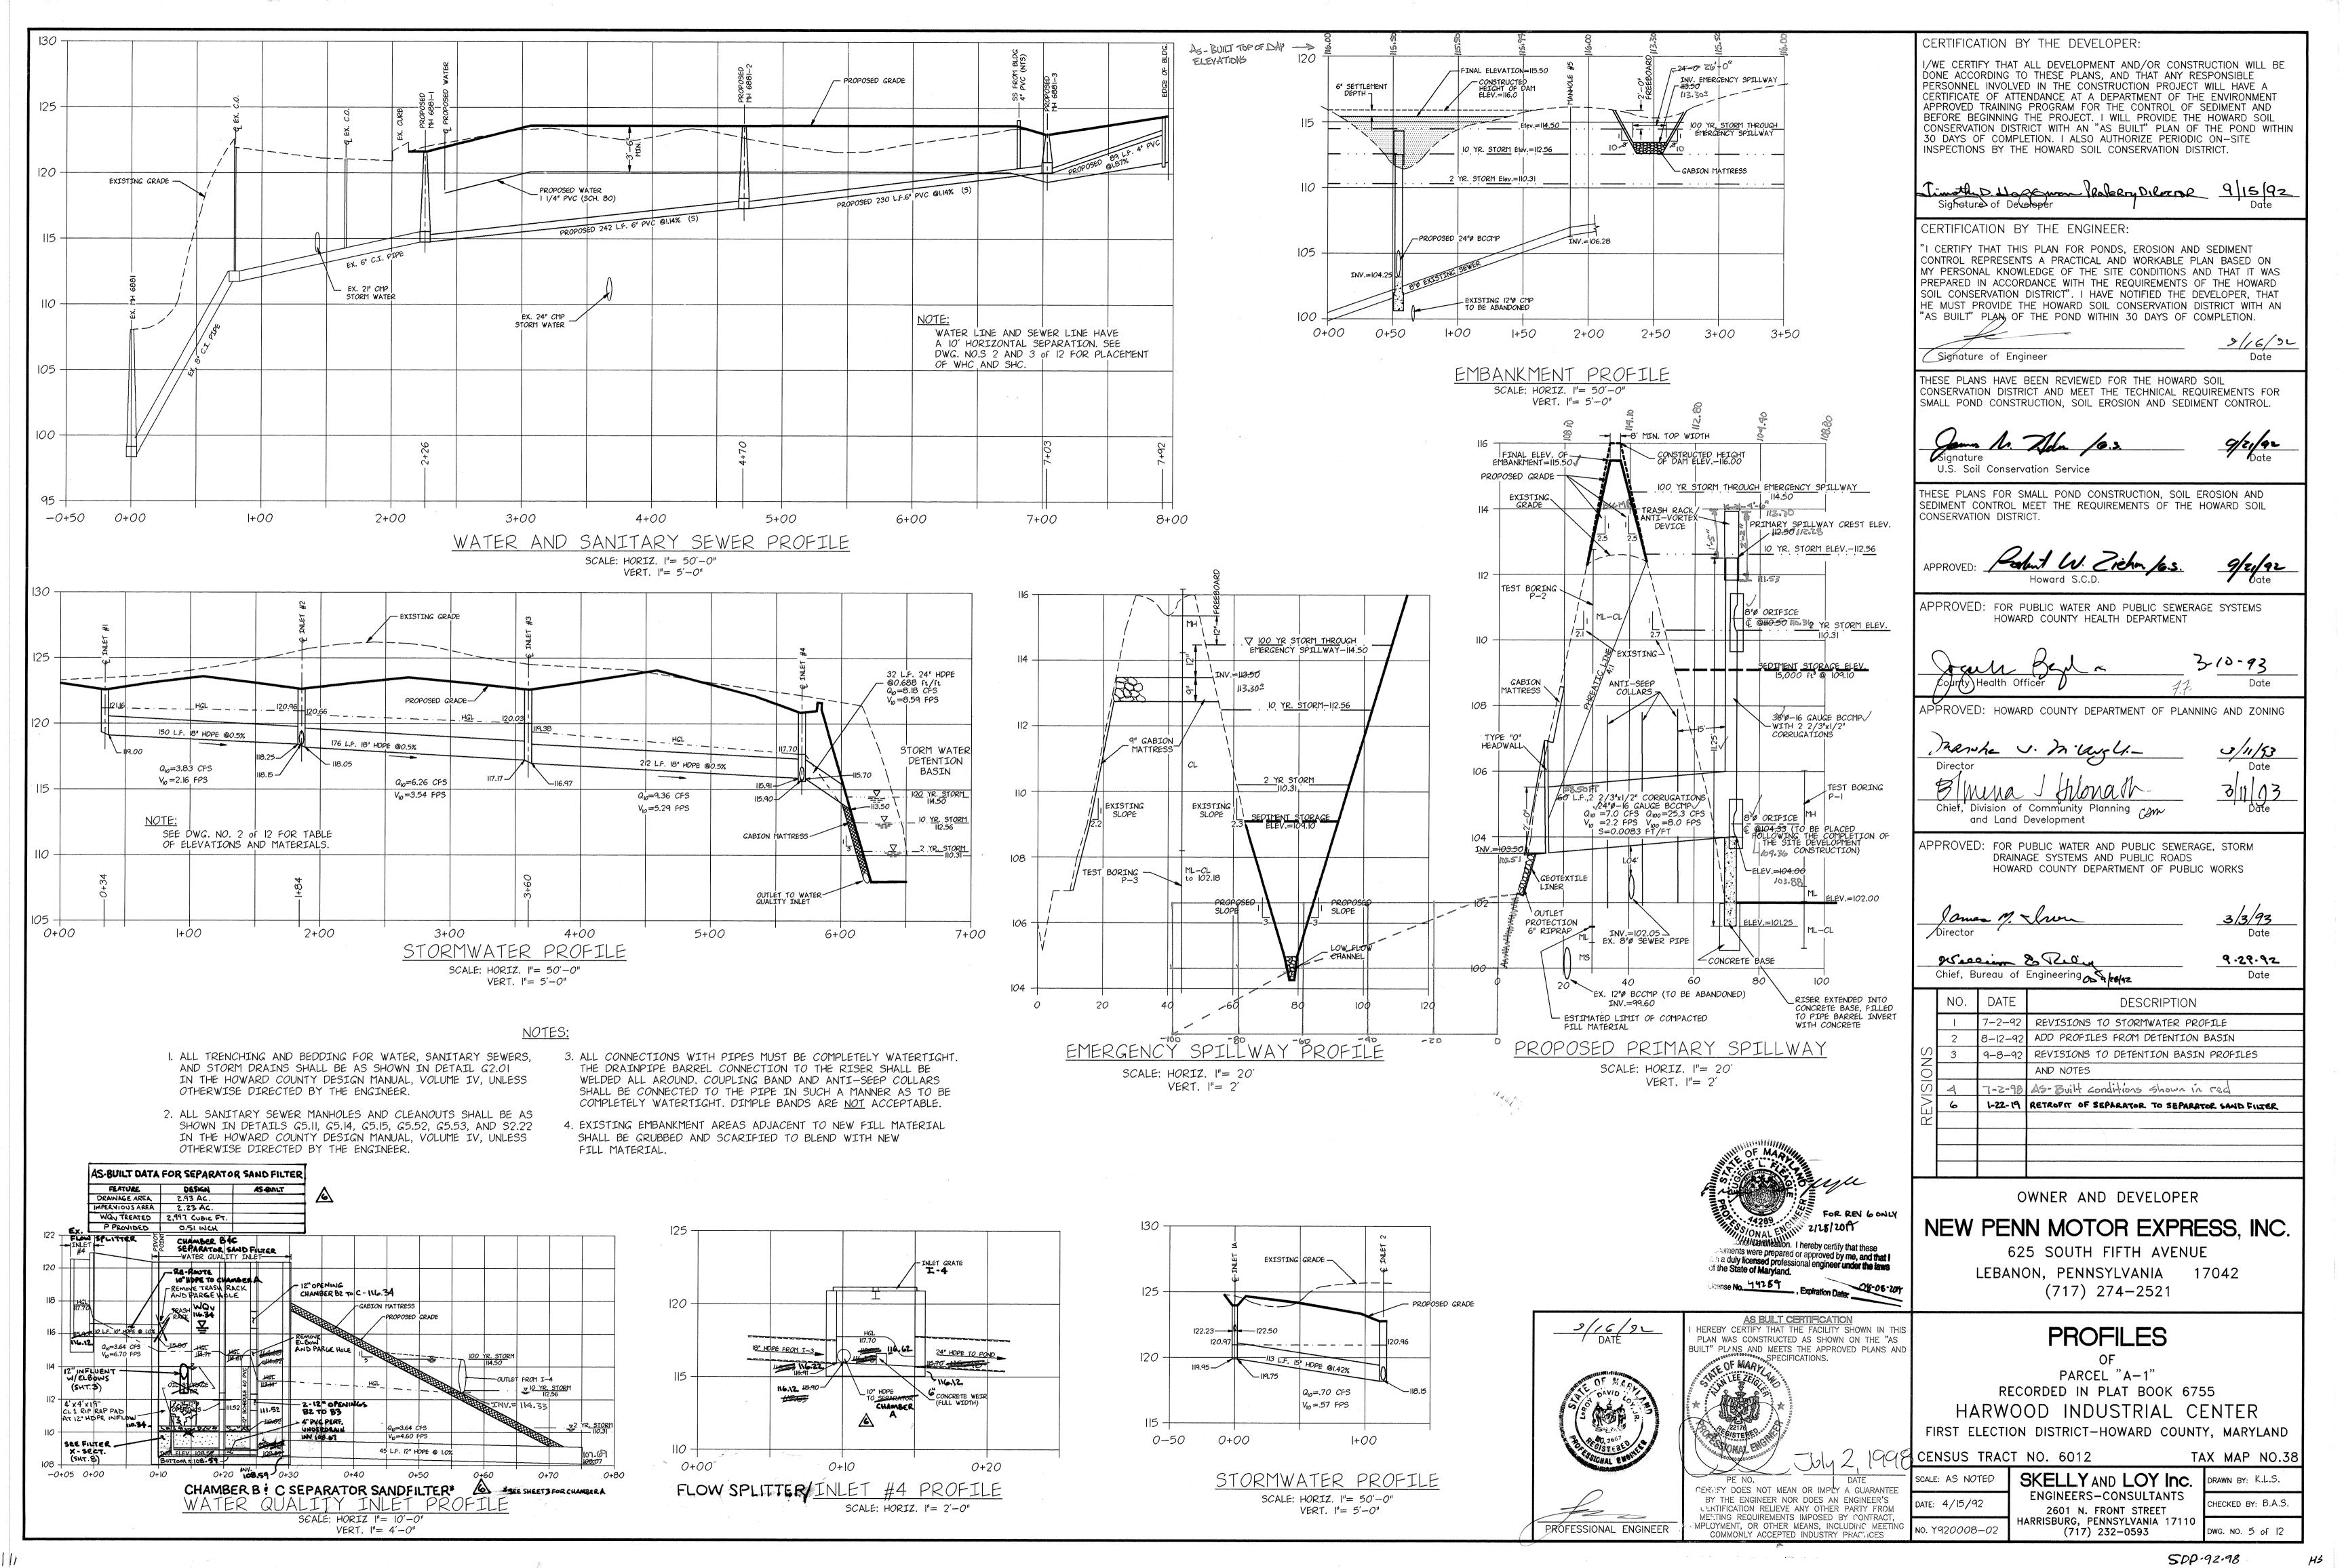
3/3/93


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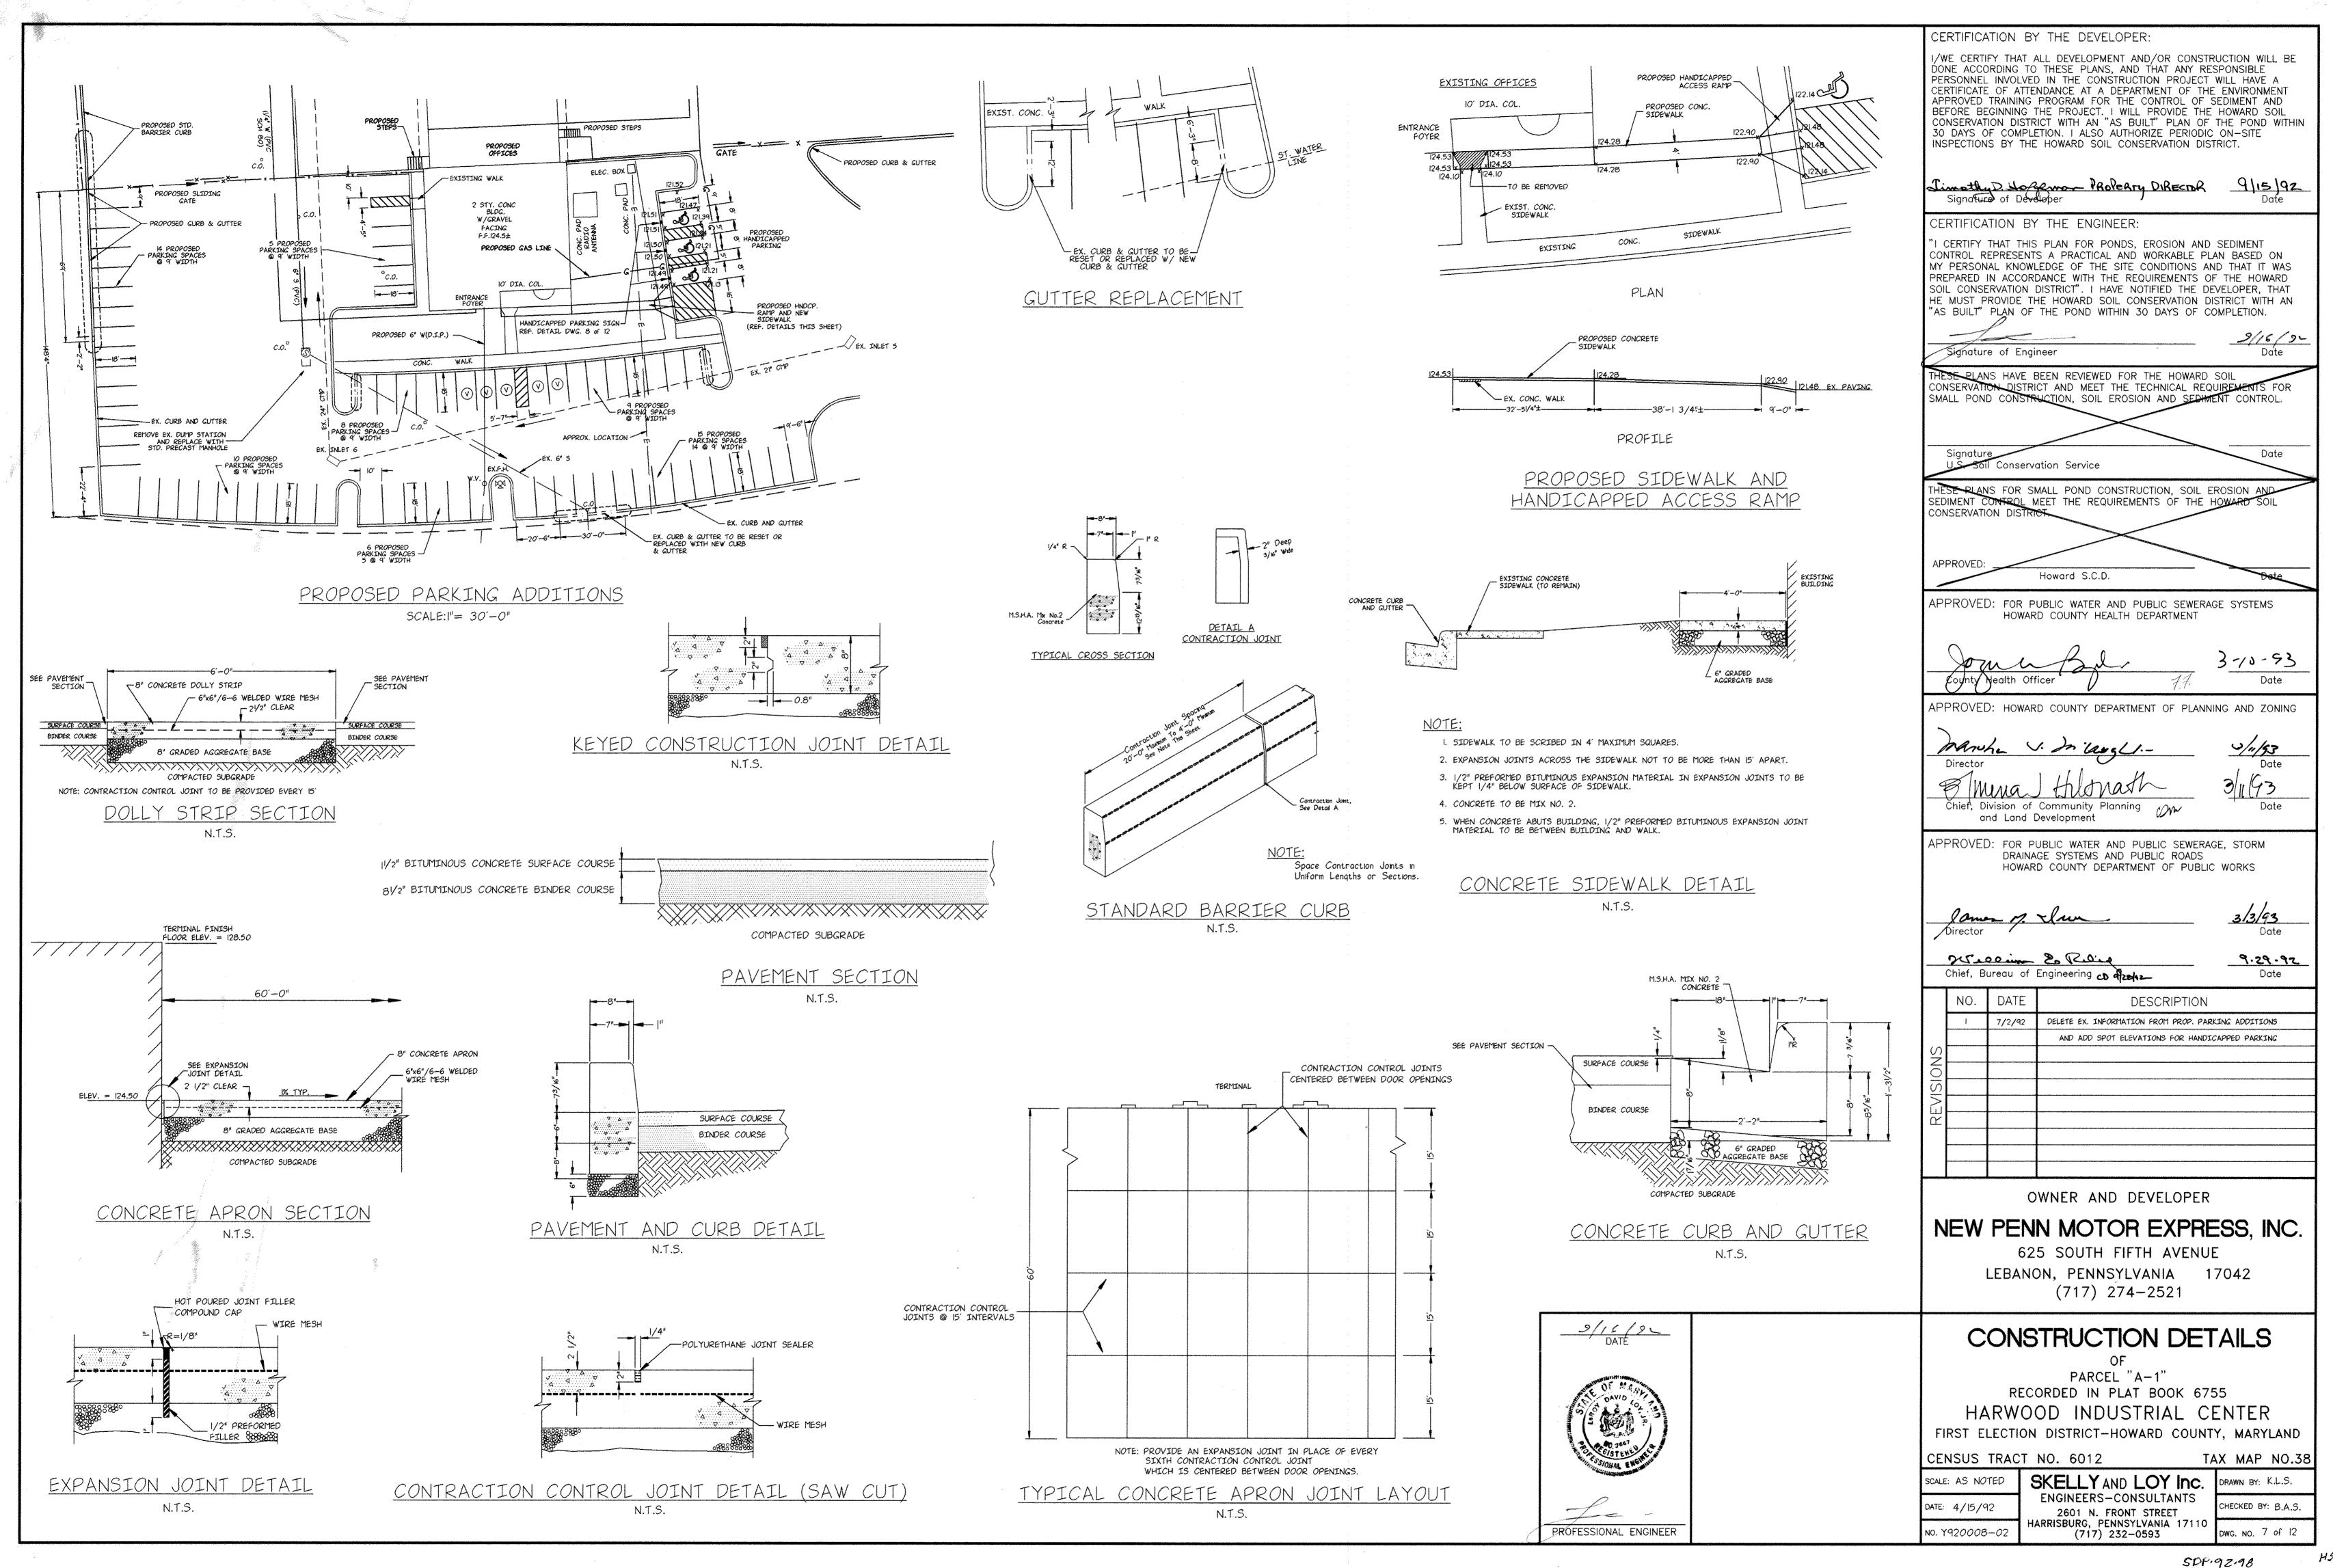





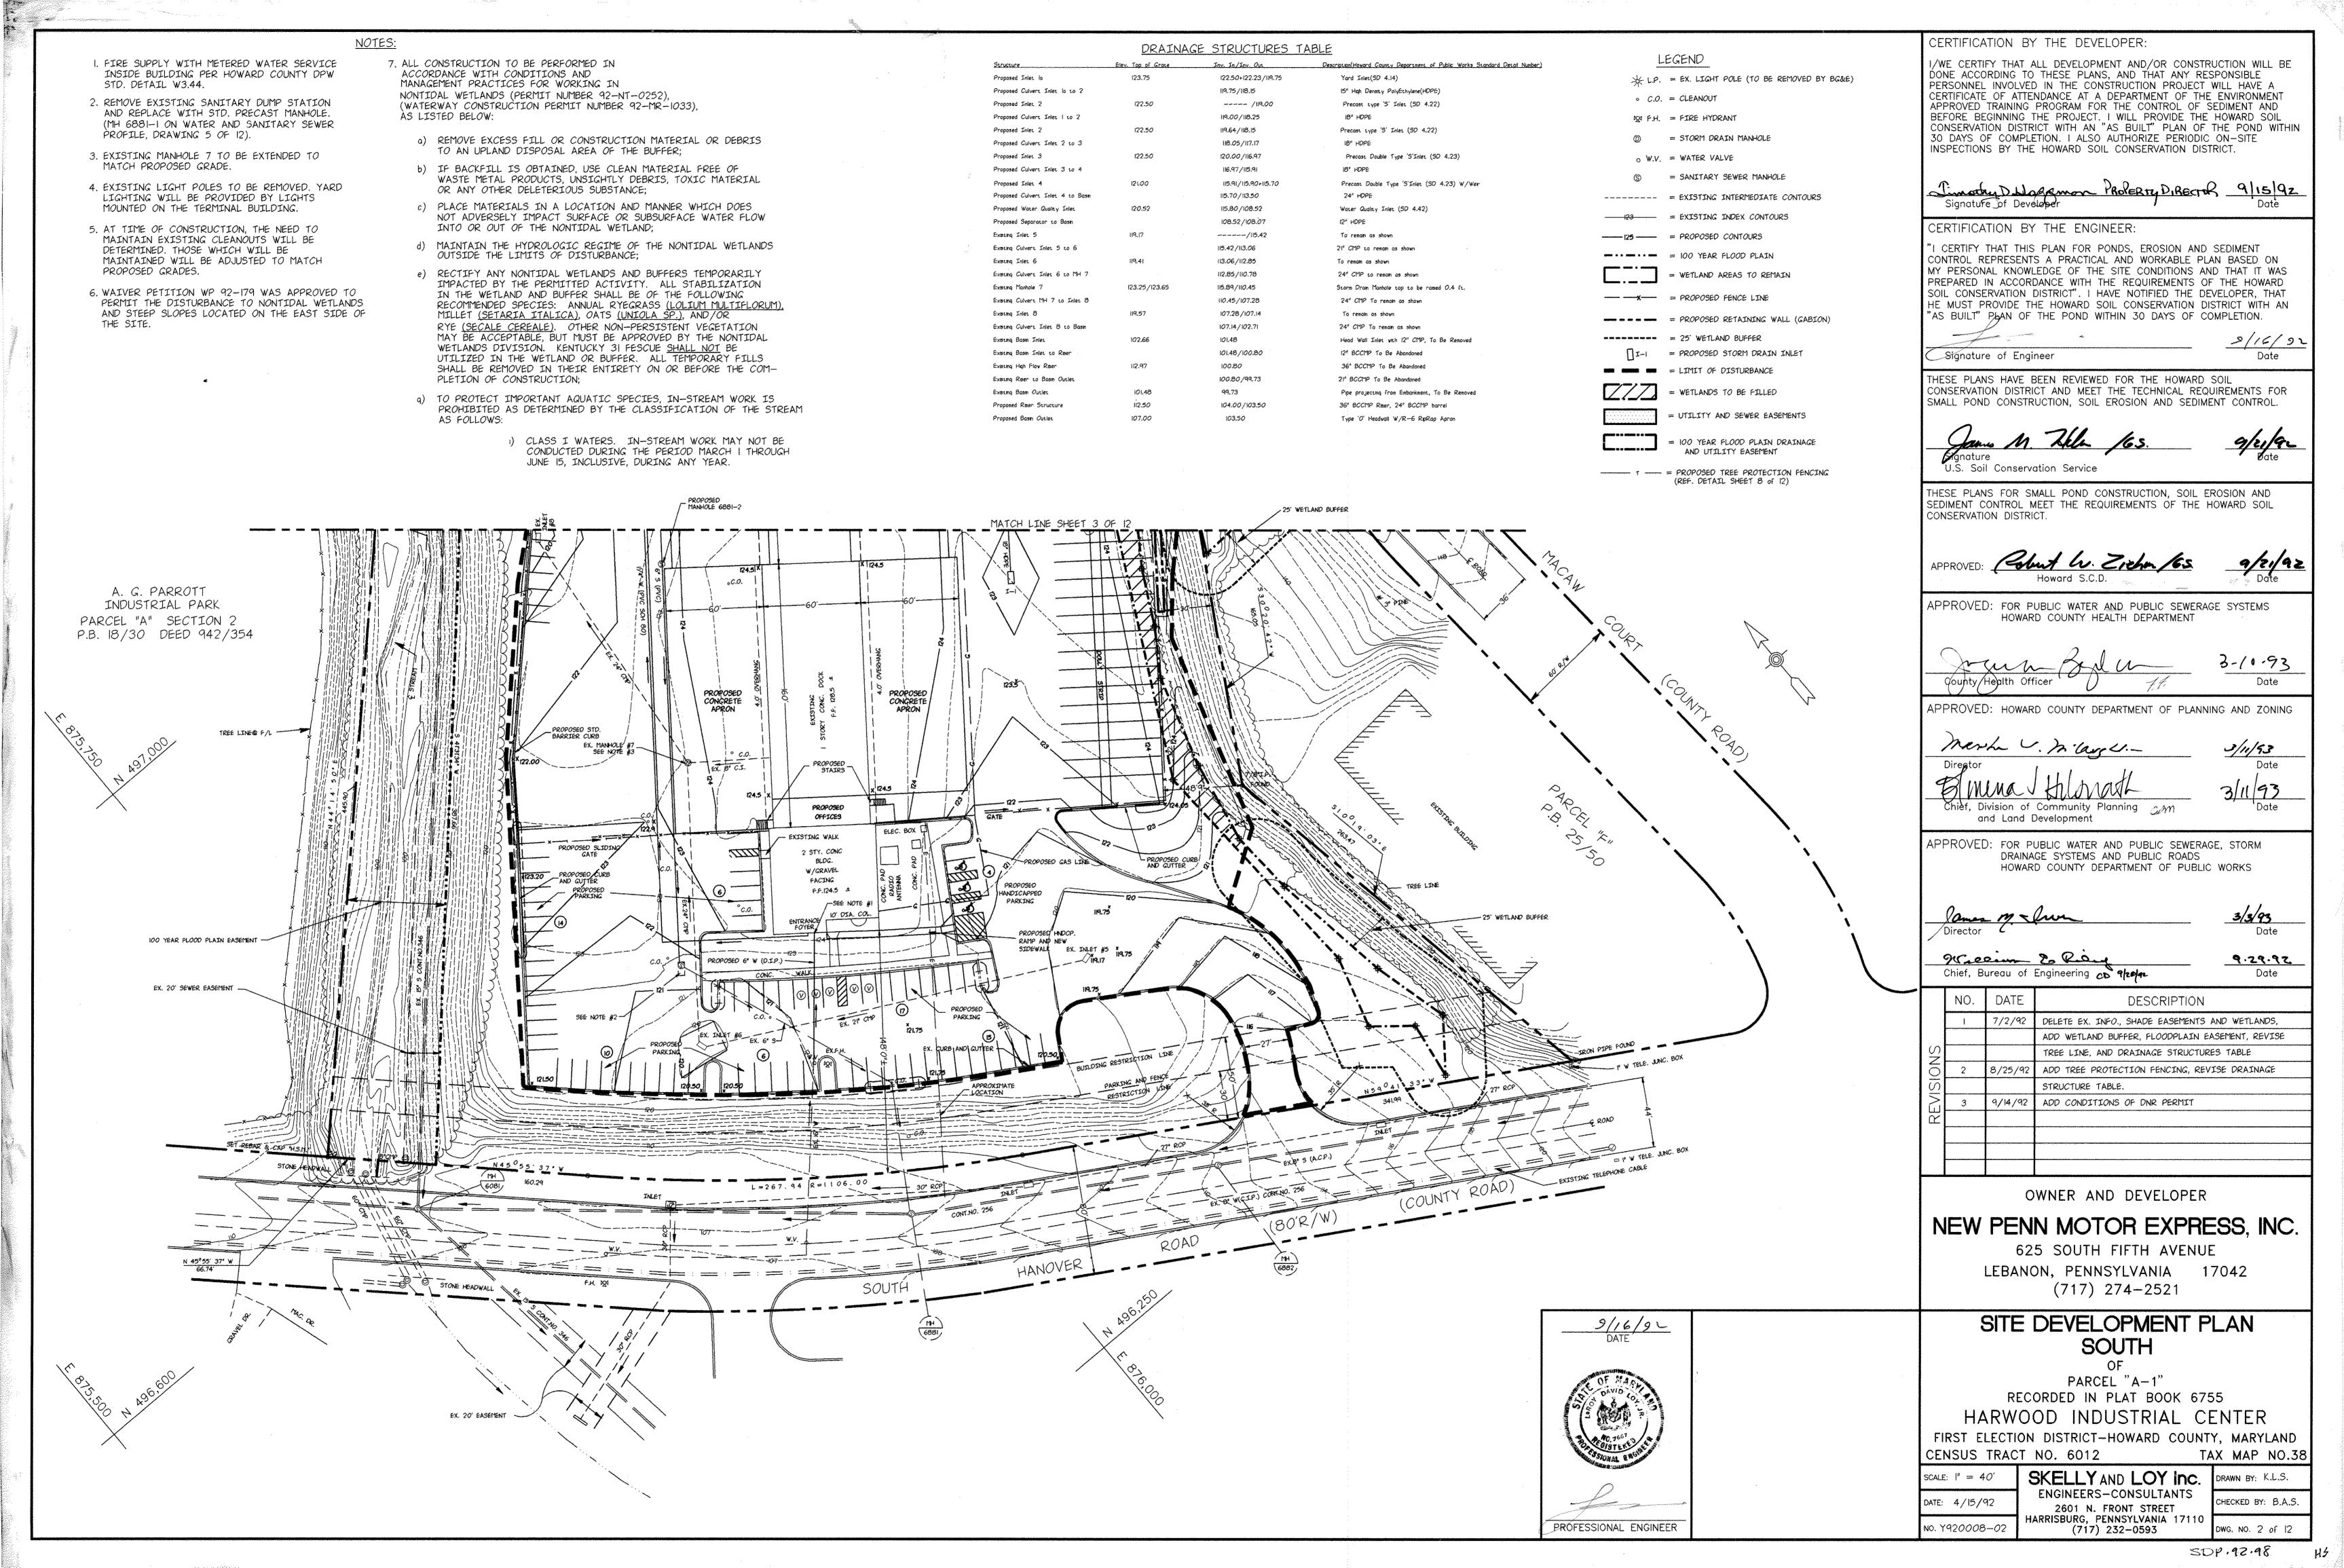


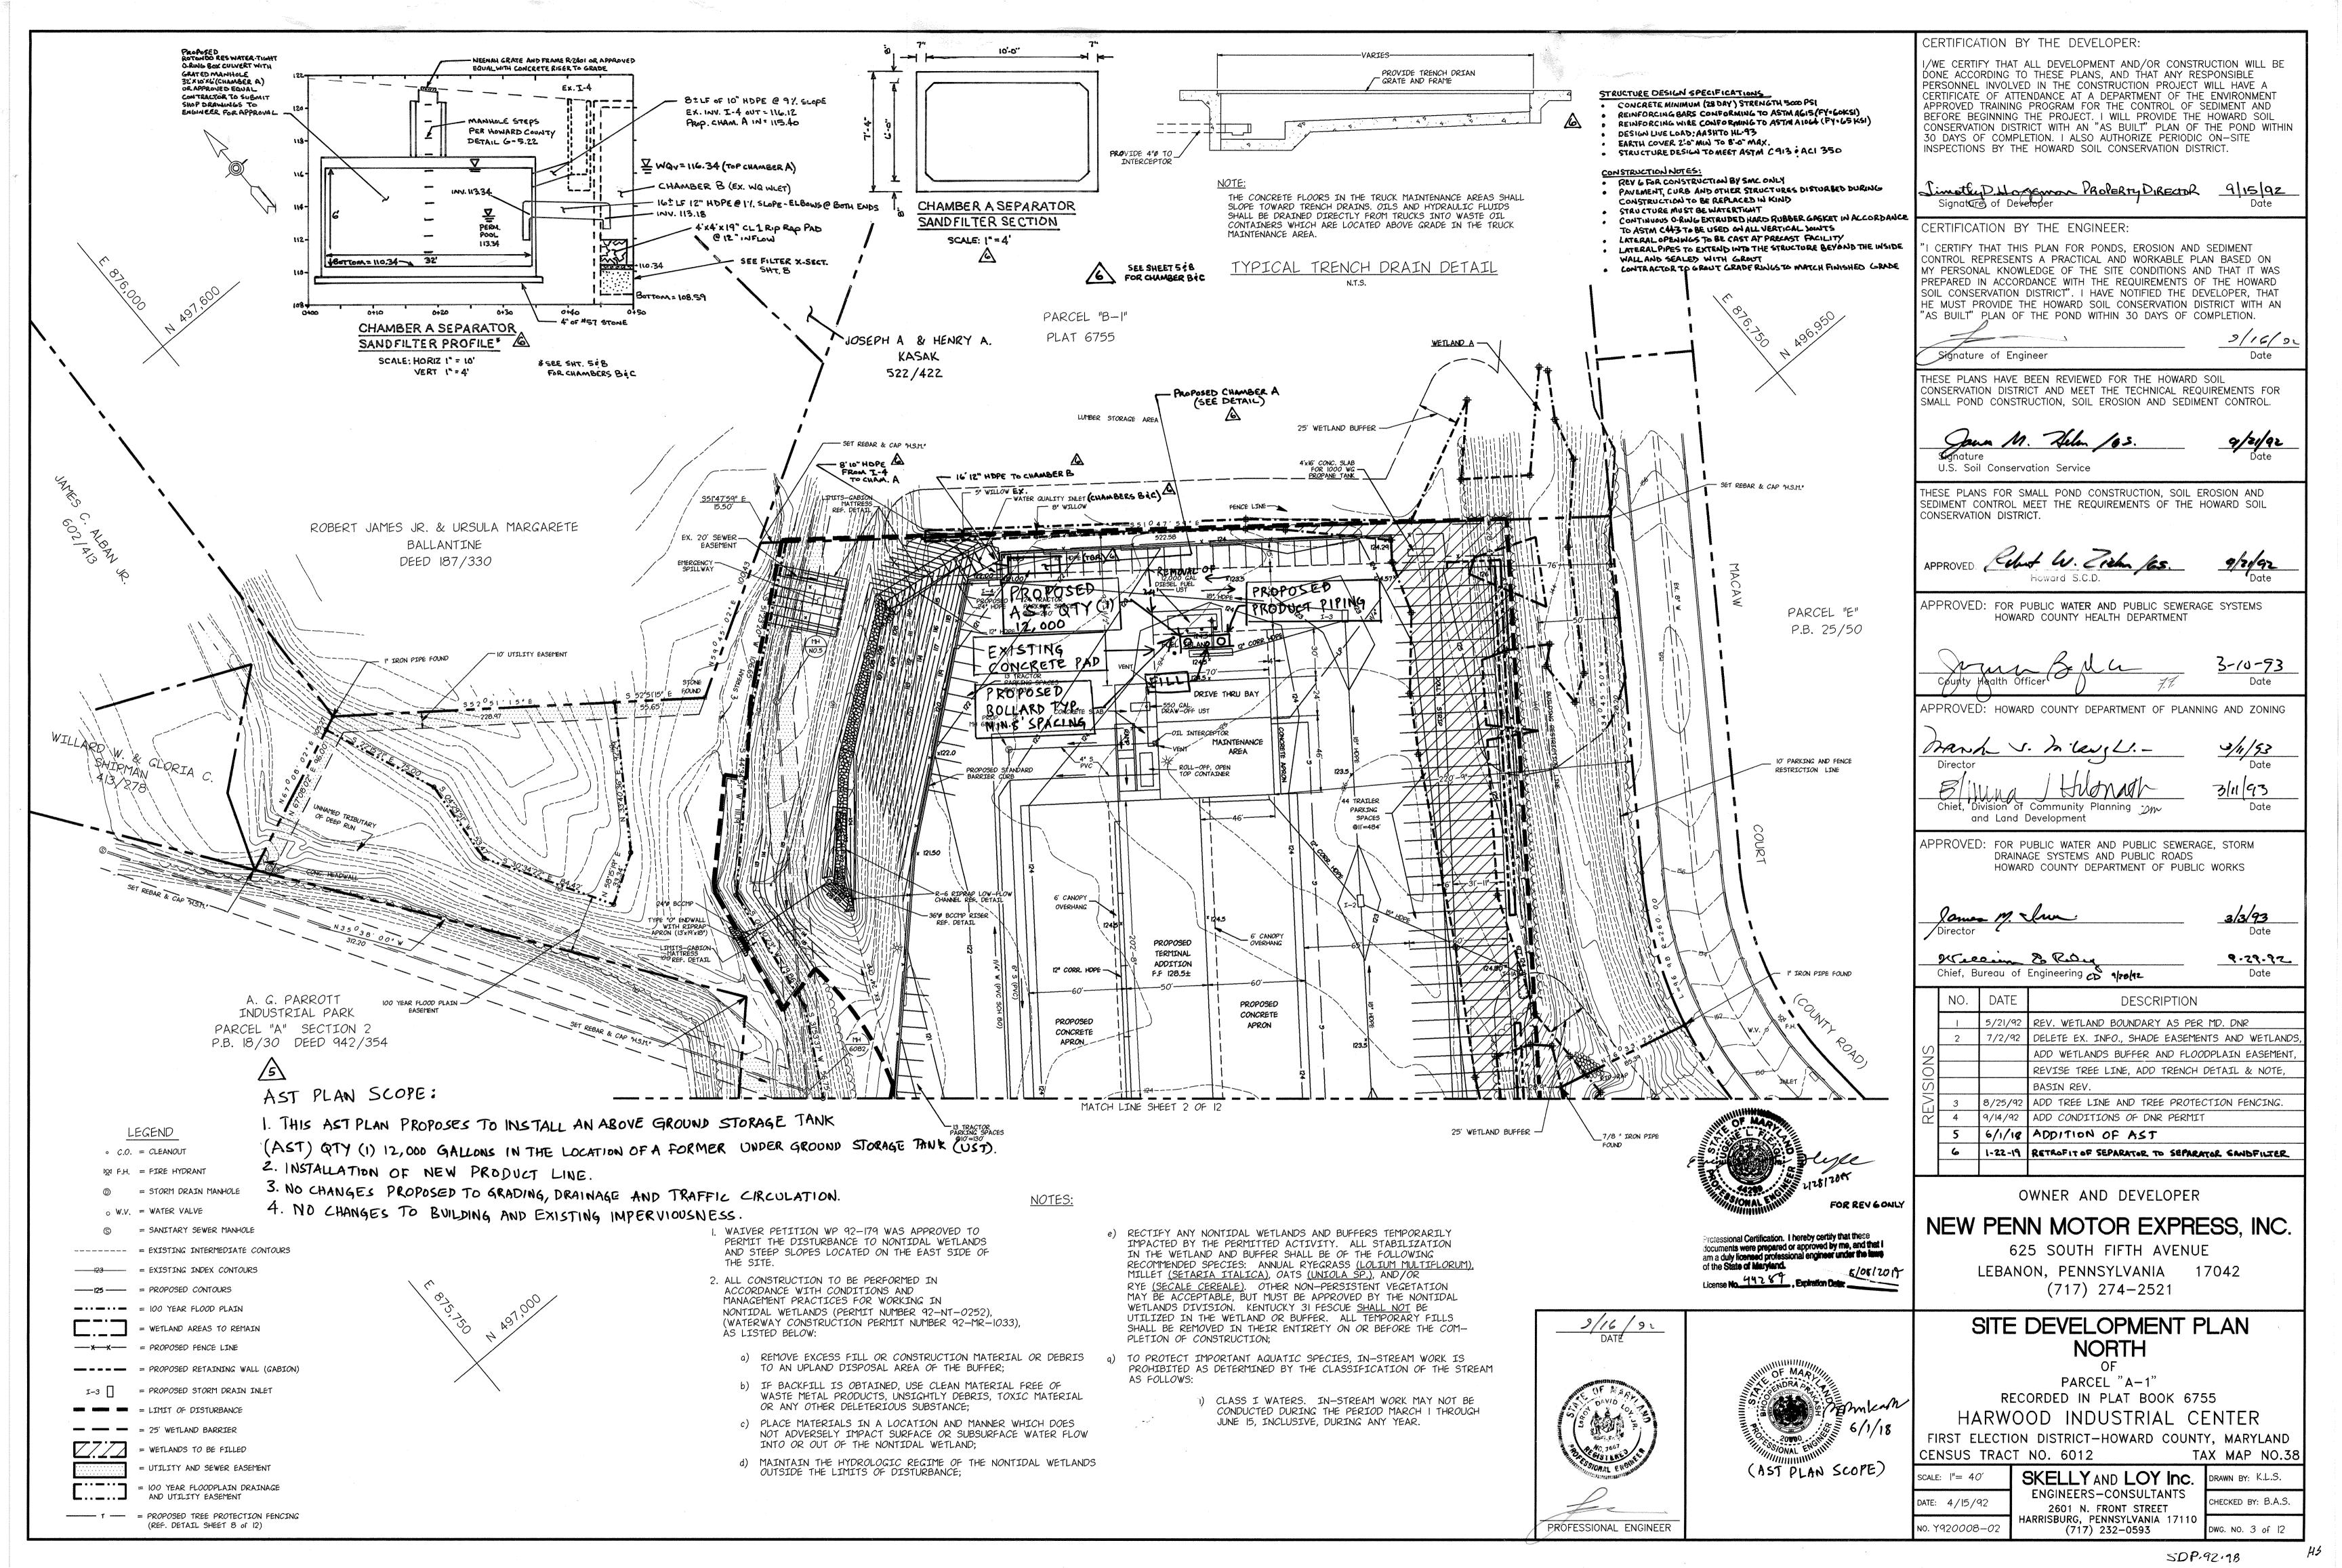


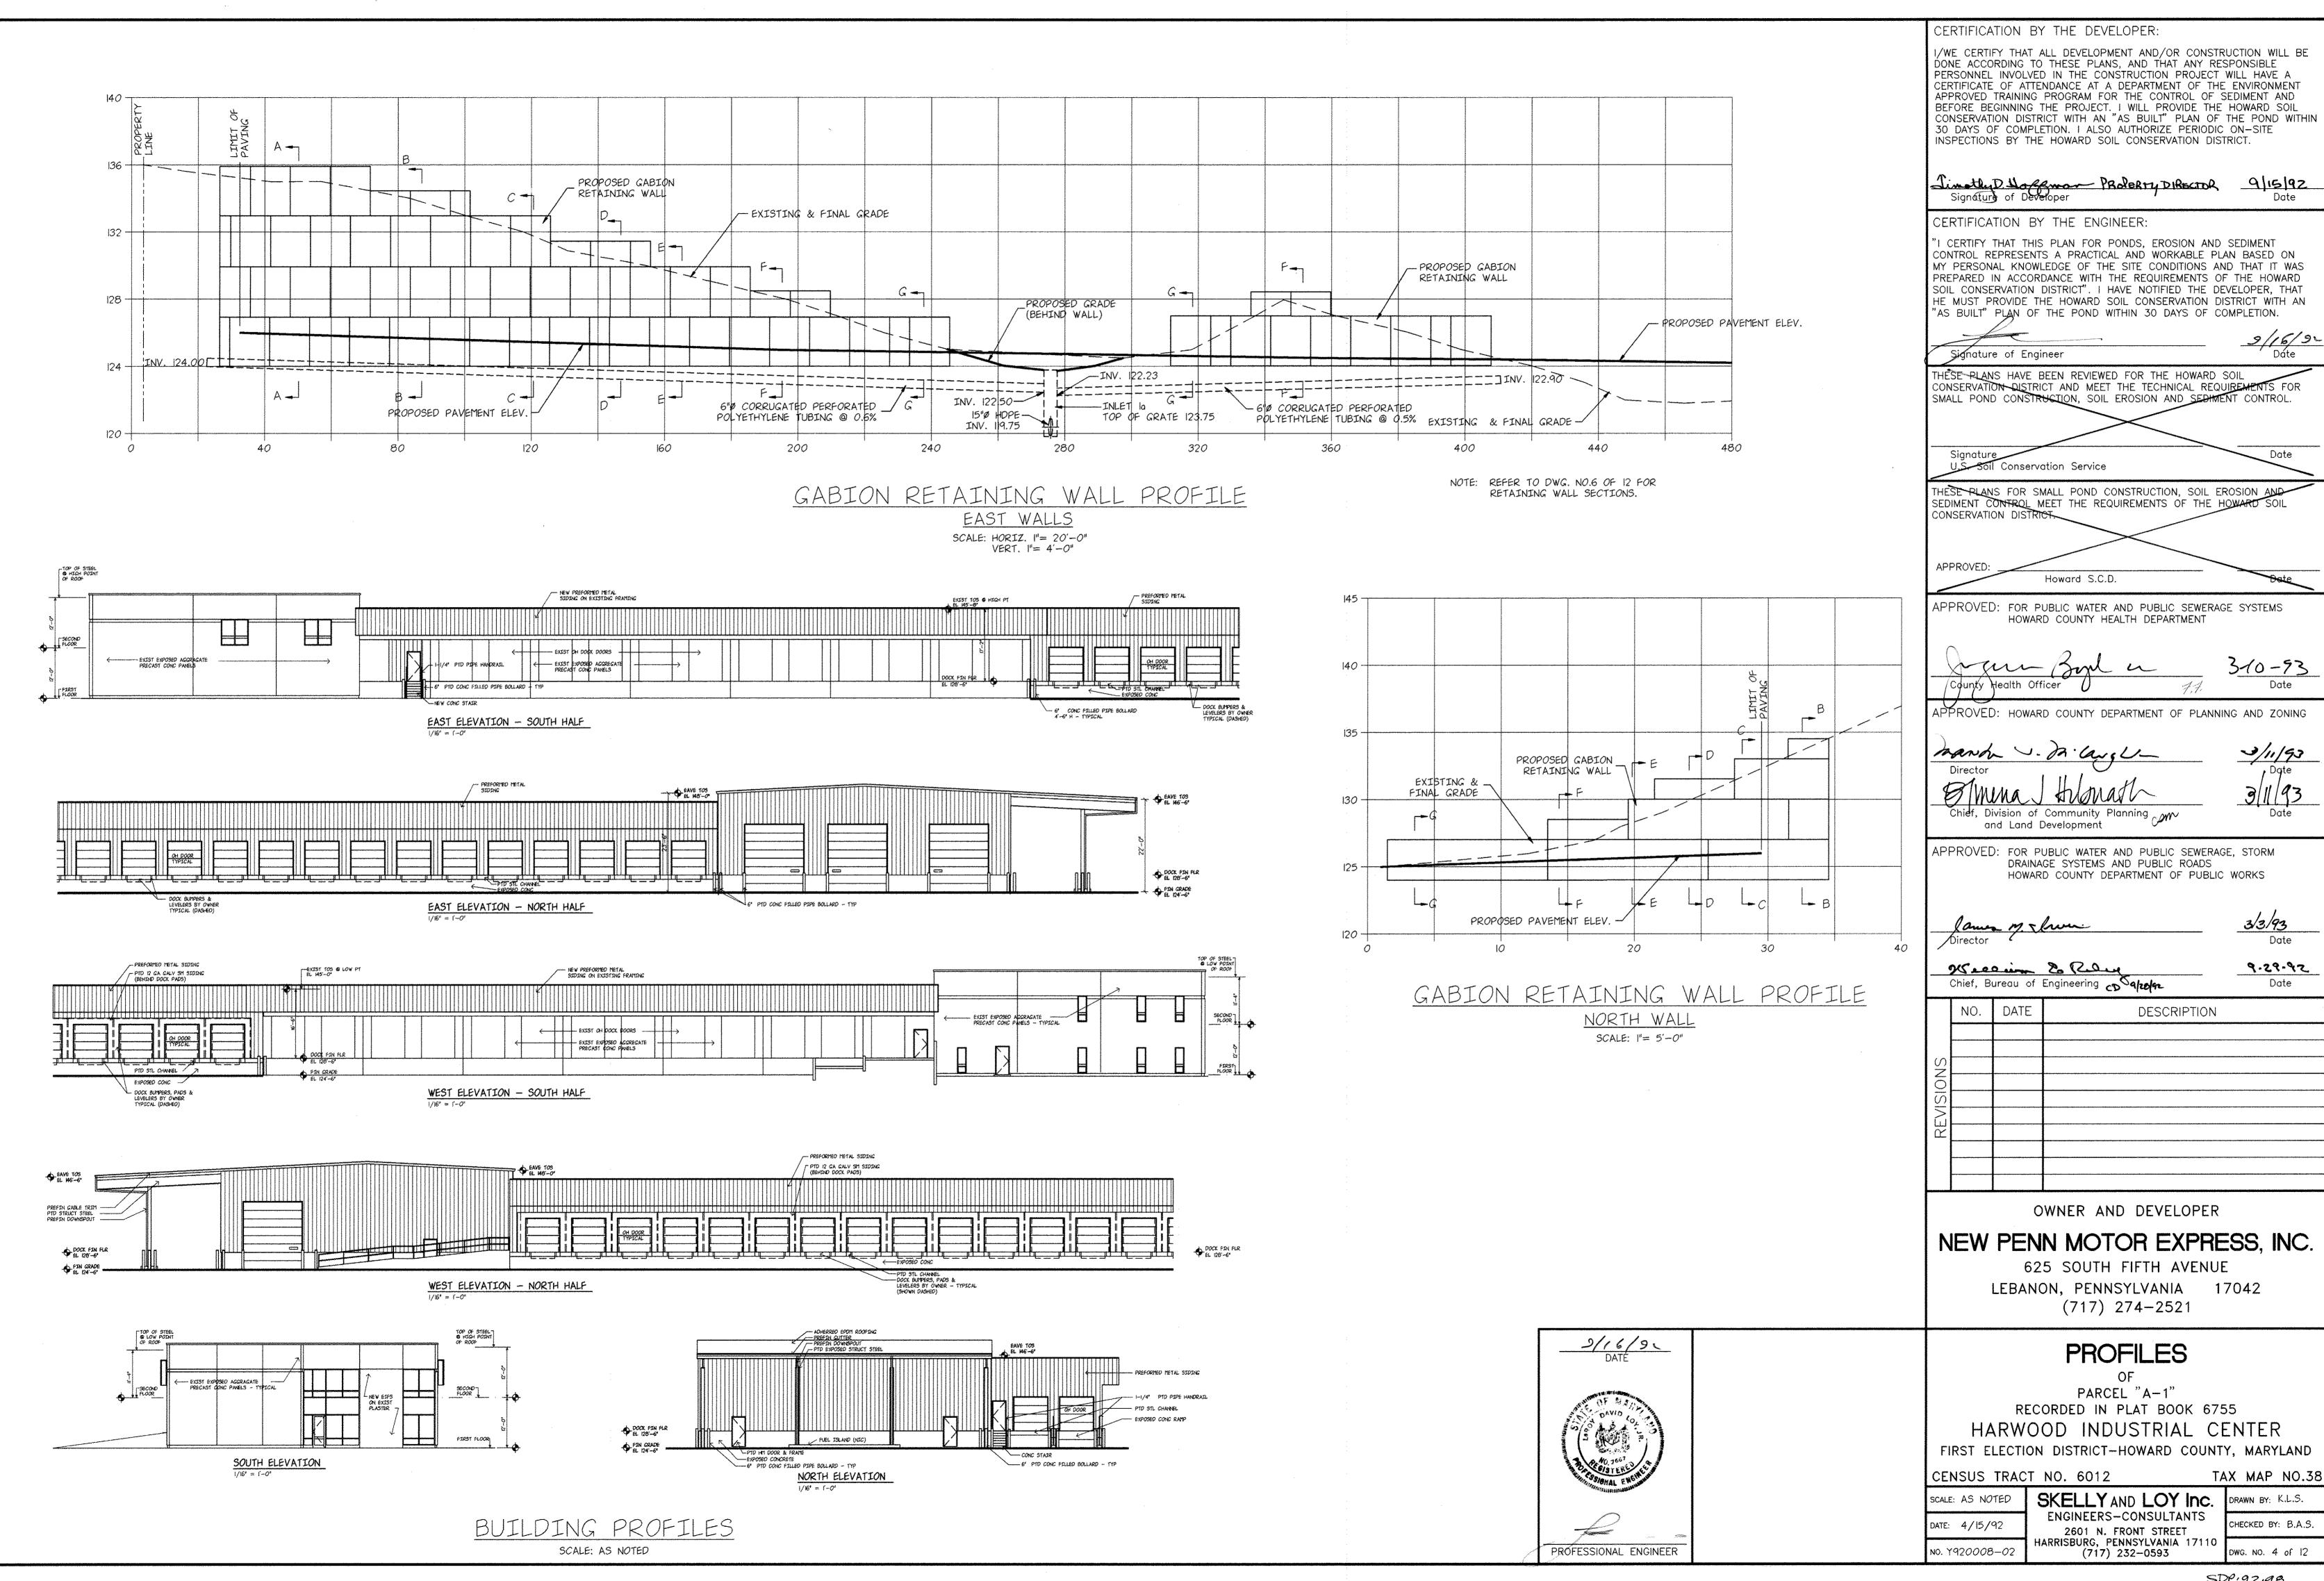


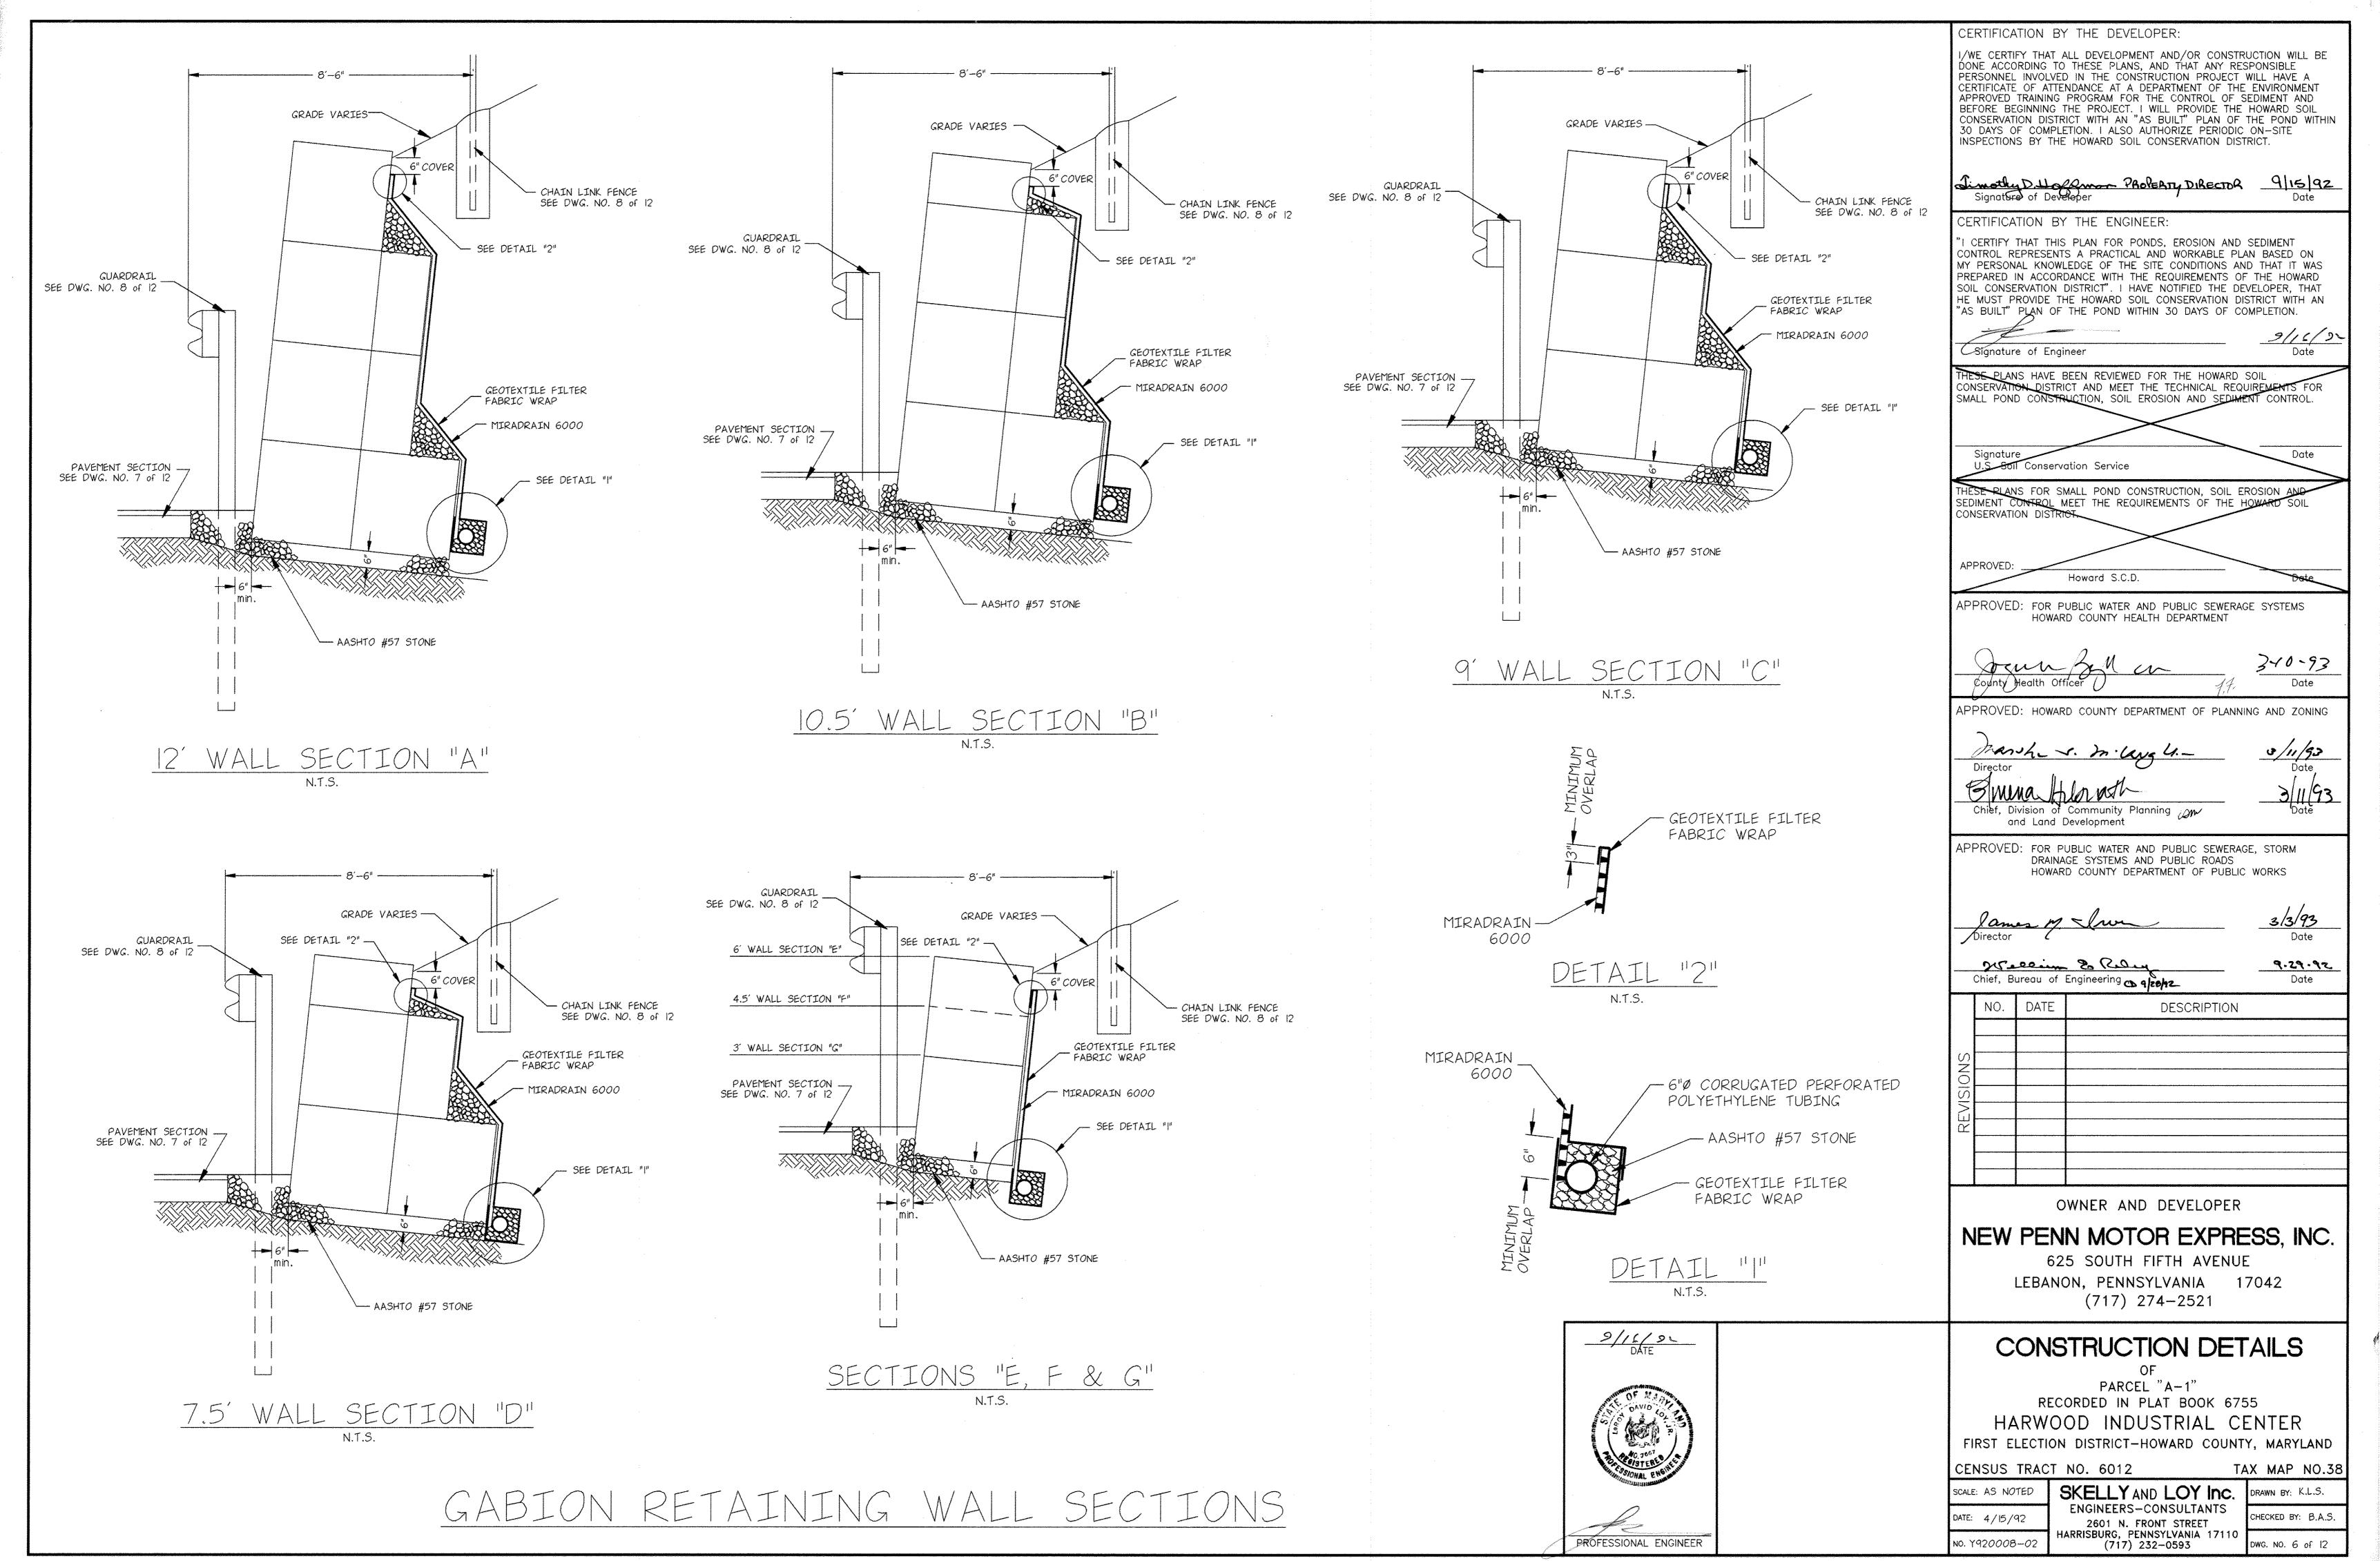

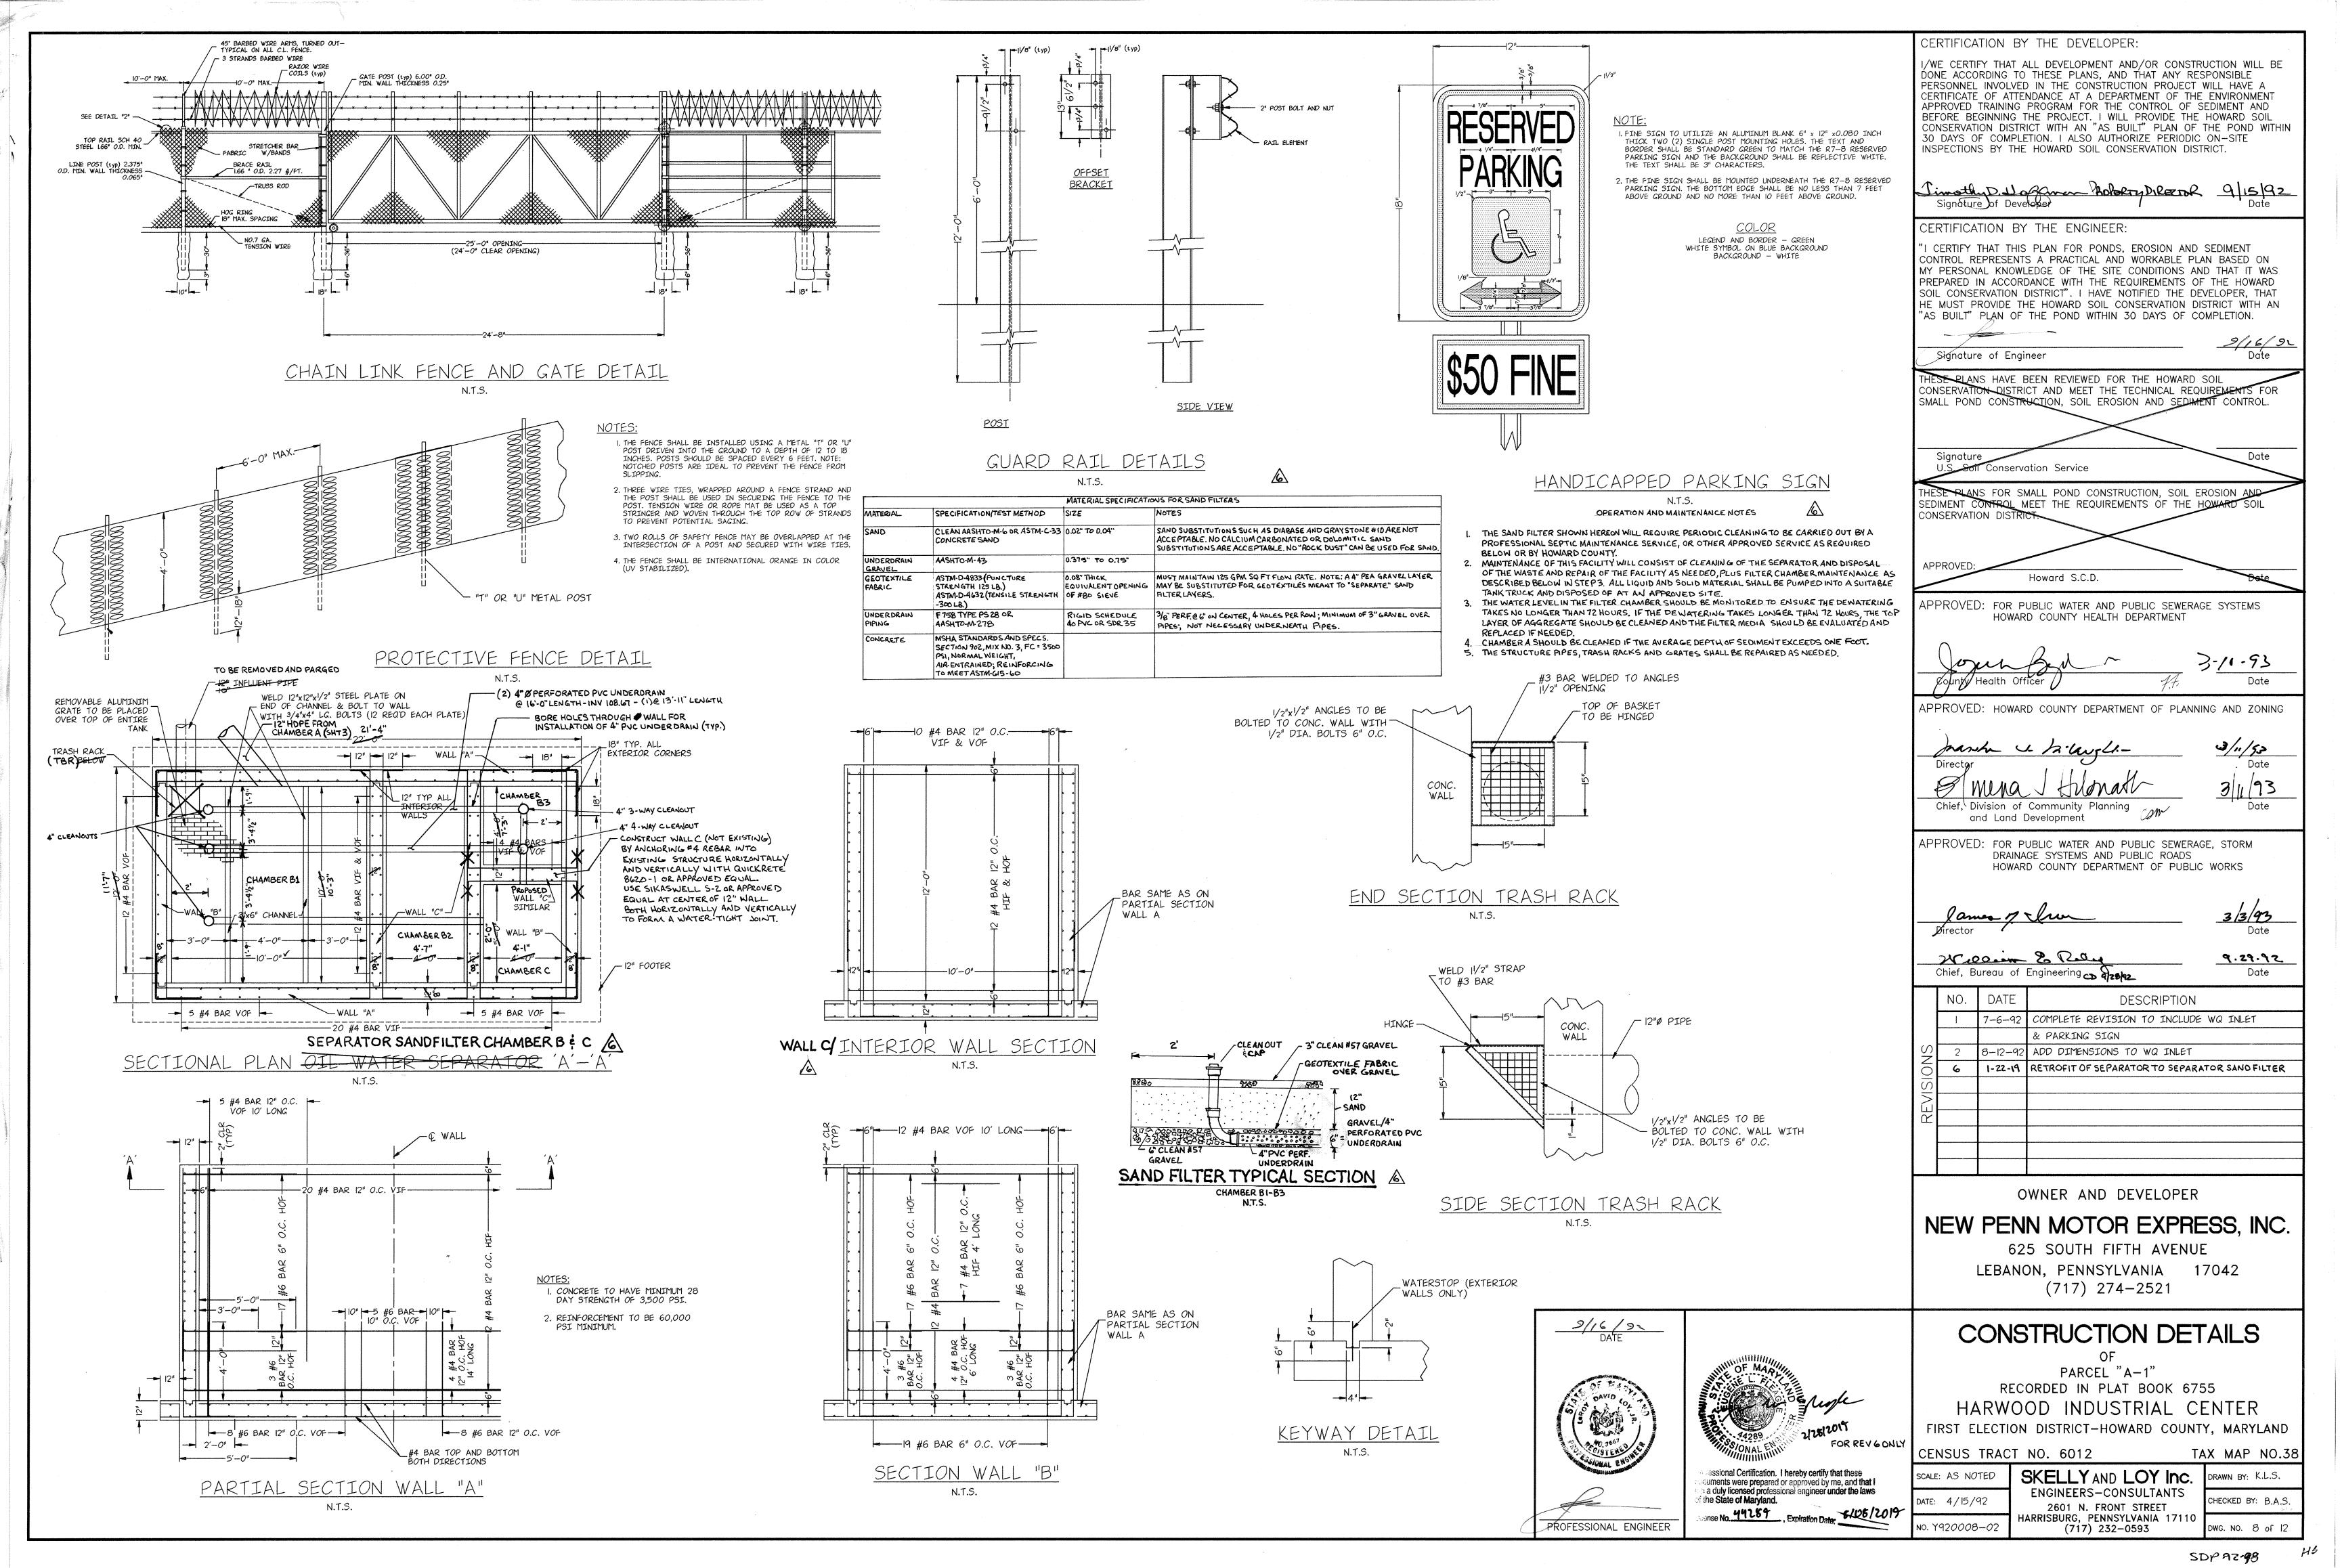

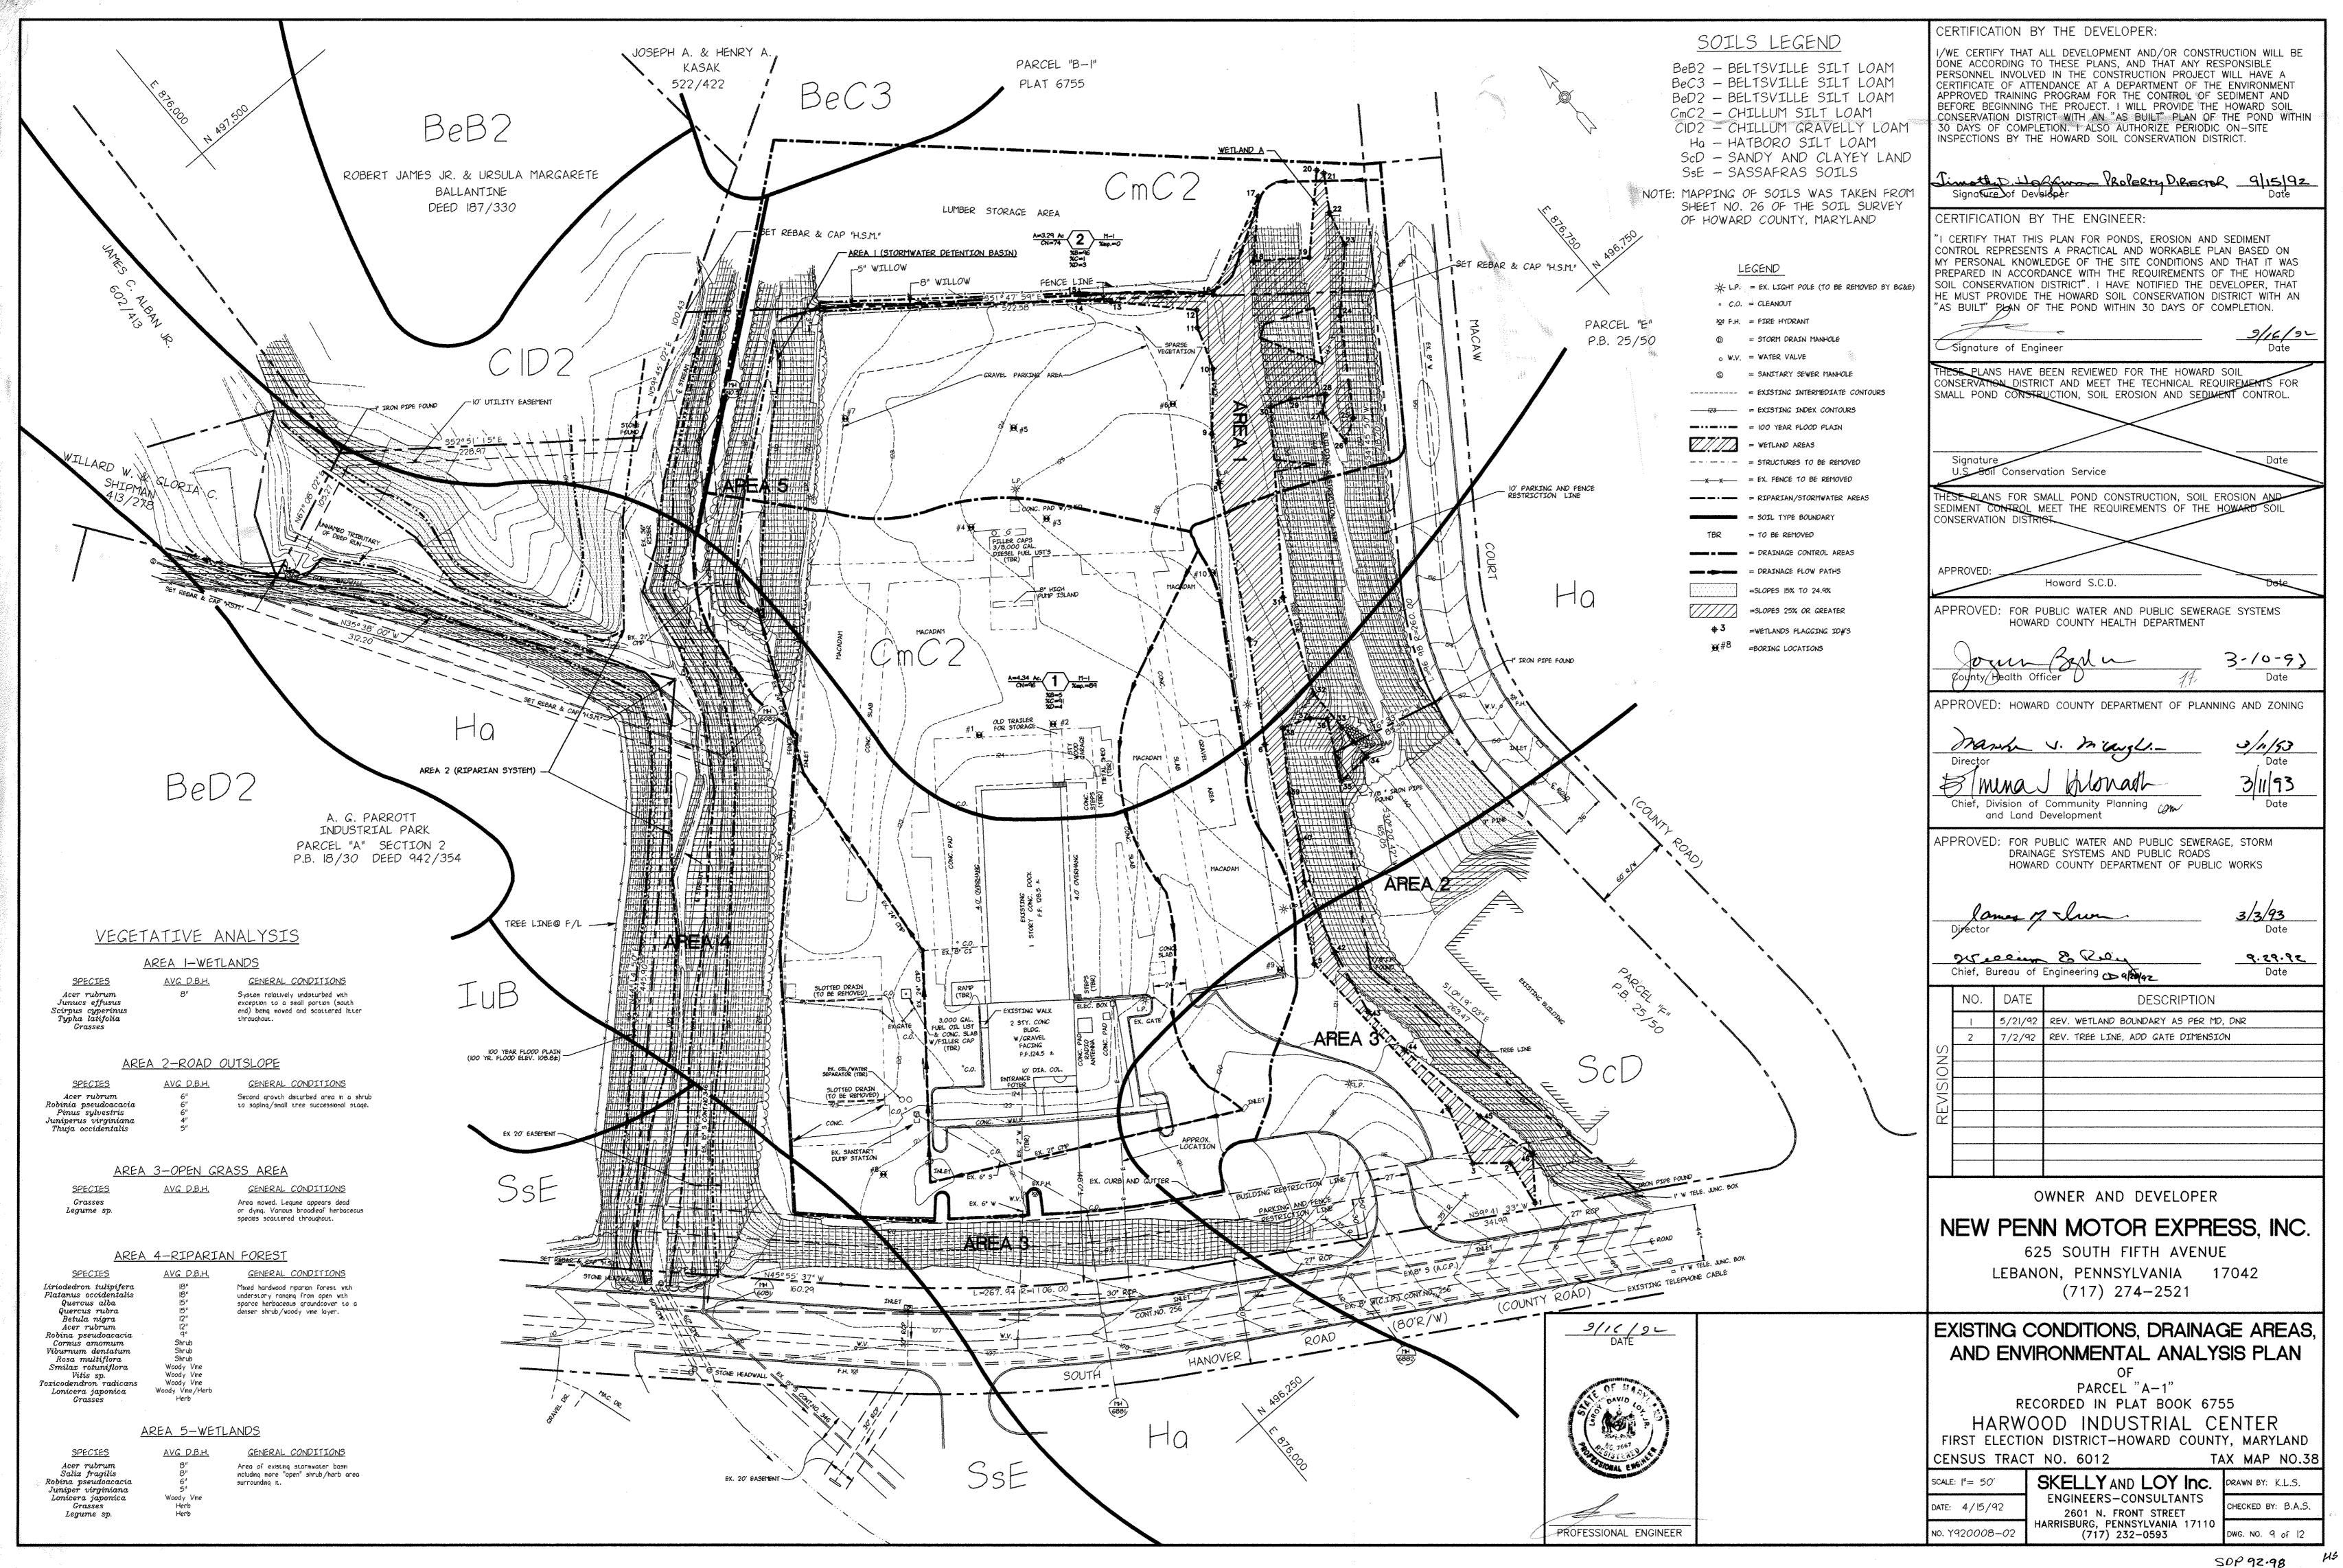

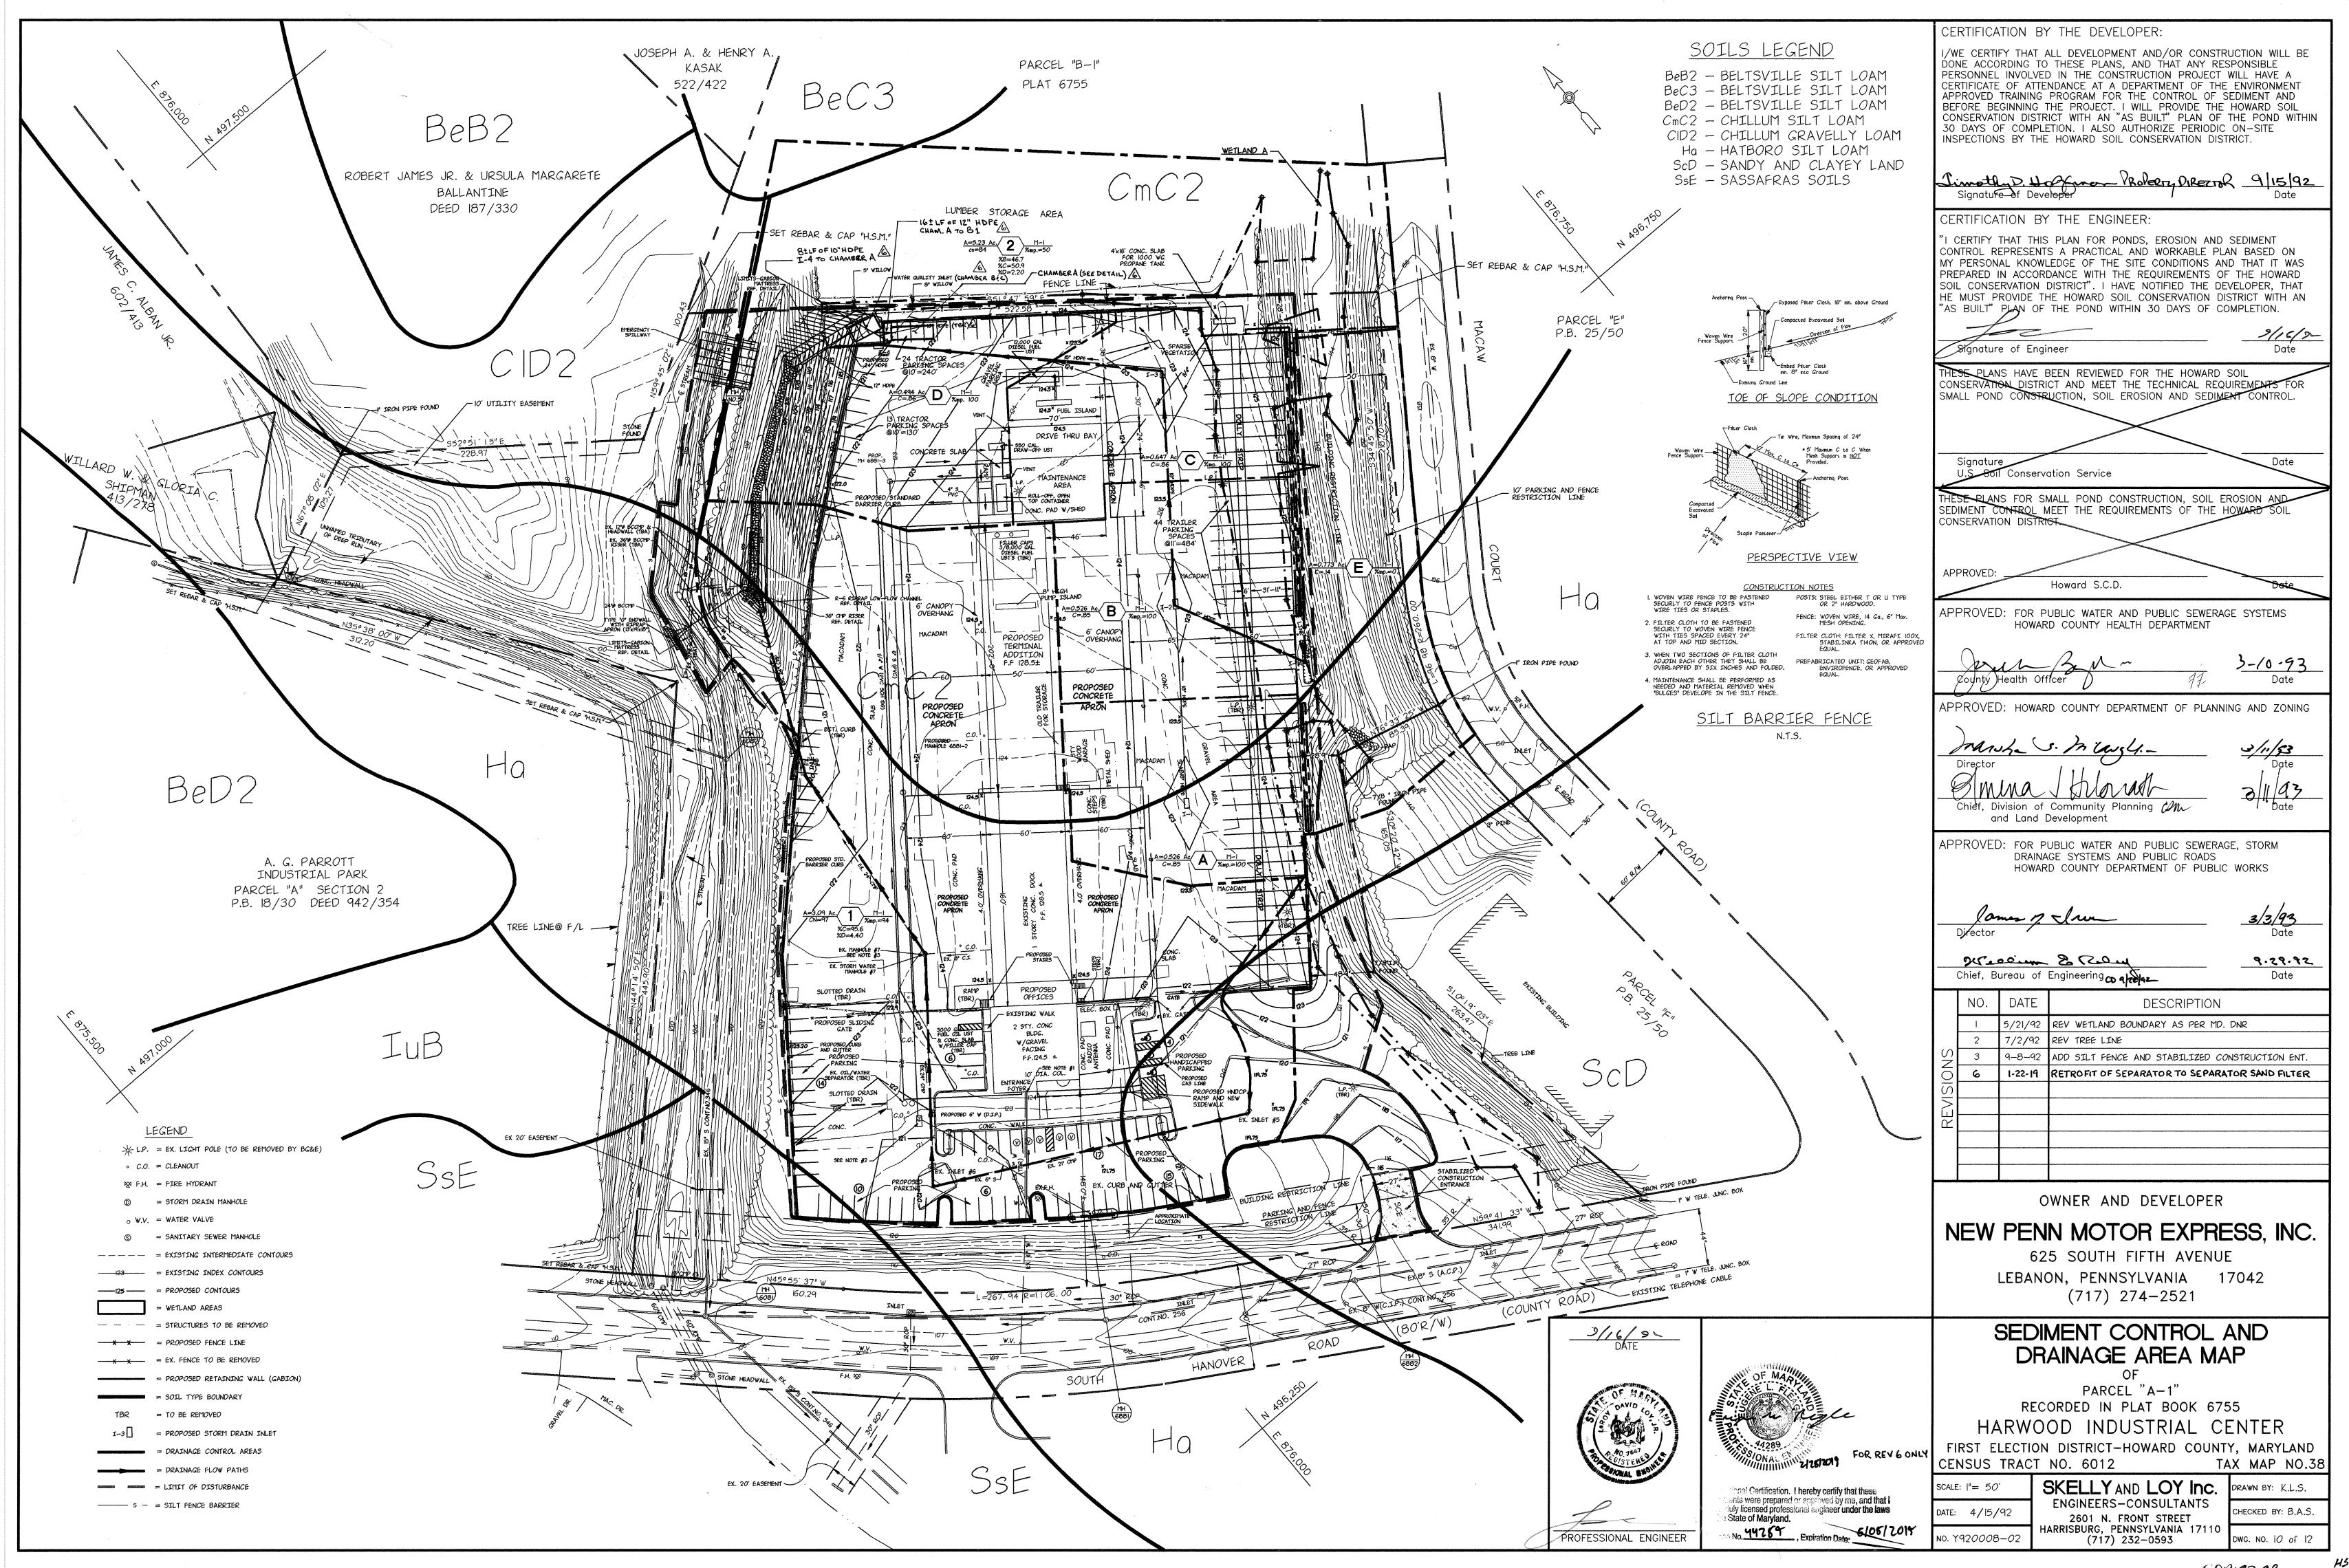

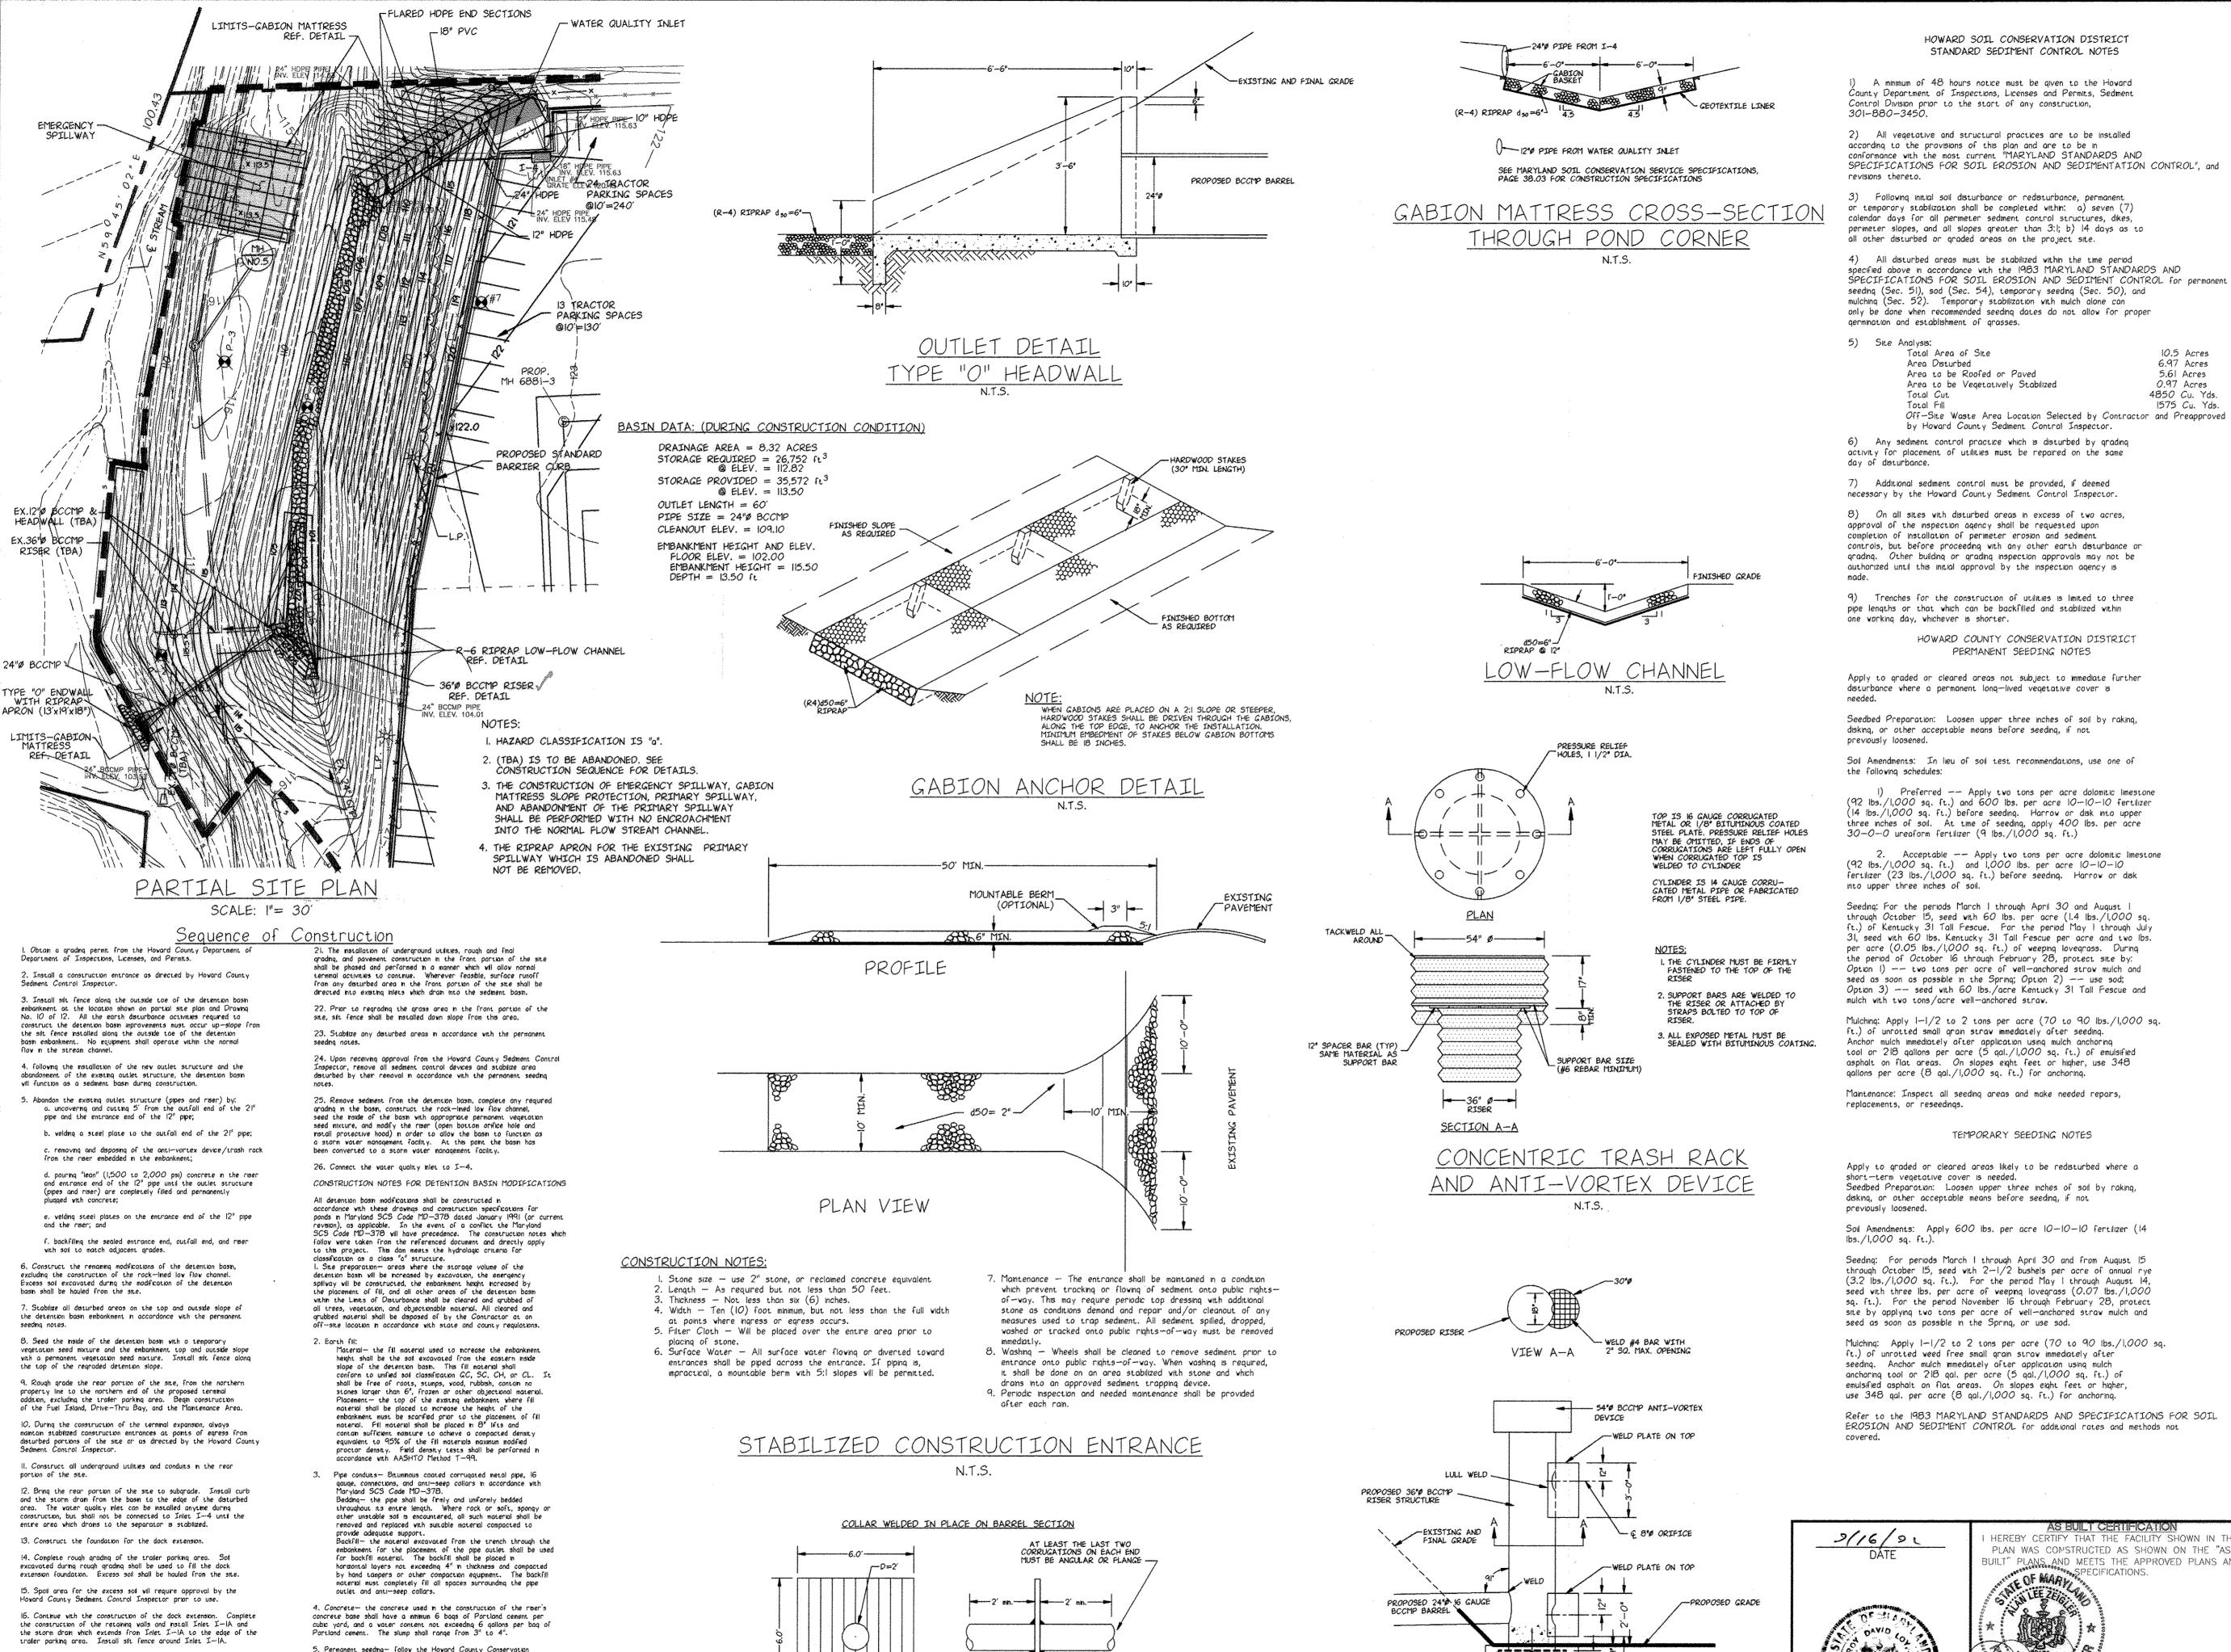

2-#8 (MIN.) BARS PLACED AT-RIGHT ANGLES AND PROJECTING INTO SIDES OF RISER TO HELP

ANCHOR RISER TO CONCRETE BASI

CONTINUOUS WELD

(FULL CIRCUMFERENCE, BOTH SIDES)

INSTALL WITH CORRUGATIONS

CORRUGATED ANTI-SEEP COLLARS

NOTE: LOWER ORIFICE NOT

PRESENT DURING CONSTRUCTION

17. Bring the trailer parking area to subgrade and complete the

18. Install sit fence at the top of the slope along the vestern

19. Complete rough grading of the areas on both sides of the dock extension. Excess sol shall be hauled from the site. Complete

the construction of the storm dram, and install curb along the

vestern side of the site and all underground utilities and conduits

20. Bring the areas on both sides of the dock extension to subgrade

and complete the construction of pavement surfaces on these areas.

construction of pavement surfaces on the trailer parking area.

District permanent seeding notes for seedbed preparation, soil

Seed mixtures — on outside embankment slopes and inside

the detention basin (elevation 108 to 102) disturbed by

detention bosin modifications use a seed mixture consisting of

detention facility slapes (to elevation 108) disturbed during the construction of the detention basin modifications use a

seed mixture consisting of crown vetch (99% pure, 70% germhation), 0.45 ibs./i,000 if and annual rye grass (98%

pure, 90% germnation), 0.55 lbs./1,000 sf. On the bottom of

Blackvell systchgrass (60 pure live seed), 0.07 lbs./1,000 sf; Birdsfoot trefoil (98% pure, 80% germination), 0.03 lbs./1,000

st; and Weeping lavegrass (98% pure, 80% germation), 0.03 lbs./1,000 sf.

HOWARD SOIL CONSERVATION DISTRICT STANDARD SEDIMENT CONTROL NOTES

A minimum of 48 hours notice must be given to the Hovard County Department of Inspections, Licenses and Permits, Sedment Control Division prior to the start of any construction,

2) All vegetative and structural practices are to be installed

according to the provisions of this plan and are to be in conformance with the most current "MARYLAND STANDARDS AND SPECIFICATIONS FOR SOIL EROSION AND SEDIMENTATION CONTROL", and

3) Following initial soil disturbance or redisturbance, permanent or temporary stabilization shall be completed within: a) seven (7) calendar days for all perimeter sediment control structures, dikes perimeter slopes, and all slopes greater than 3:1; b) 14 days as to all other disturbed or graded areas on the project site.

4) All disturbed areas must be stabilized within the time period specified above in accordance with the 1983 MARYLAND STANDARDS AND SPECIFICATIONS FOR SOIL EROSION AND SEDIMENT CONTROL for permanent seeding (Sec. 51), sod (Sec. 54), temporary seeding (Sec. 50), and mulching (Sec. 52). Temporary stabilization with mulch alone can only be done when recommended seeding dates do not allow for proper

10.5 Acres 6.97 Acres Area to be Roofed or Paved 5.61 Acres 0.97 Acres Area to be Vegetatively Stabilized 4850 Cu. Yds. 1575 Cu. Yds.

6) Any sediment control practice which is disturbed by grading activity for placement of utilities must be repaired on the same

7) Additional sediment control must be provided, if deemed necessary by the Howard County Sedment Control Inspector.

8) On all sites with disturbed areas in excess of two acres, approval of the inspection agency shall be requested upon completion of installation of perimeter erosion and sediment controls, but before proceeding with any other earth disturbance or aradina. Other building or grading inspection approvals may not be authorized until this initial approval by the inspection agency is

9) Trenches for the construction of utilities is limited to three pipe lengths or that which can be backfilled and stabilized within

> HOWARD COUNTY CONSERVATION DISTRICT PERMANENT SEEDING NOTES

Apply to graded or cleared areas not subject to immediate further disturbance where a permanent long-lived vegetative cover is

Seedbed Preparation: Loosen upper three inches of soil by raking, disking, or other acceptable means before seeding, if not

Soil Amendments: In lieu of soil test recommendations, use one of

(92 lbs./1,000 sq. ft.) and 600 lbs. per acre 10-10-10 fertilizer (14 lbs./1,000 sq. ft.) before seeding. Harrow or disk into upper three inches of soil. At time of seeding, apply 400 lbs. per acre 30-0-0 ureaform fertilizer (9 lbs./1,000 sq. ft.)

2. Acceptable -- Apply two tons per acre dolomitic limestone (92 lbs./1,000 sq. ft.) and 1,000 lbs. per acre 10-10-10 fertilizer (23 lbs./1,000 sq. ft.) before seeding. Harrow or disk

Seeding: For the periods March I through April 30 and August through October 15, seed with 60 lbs. per acre (1.4 lbs./1,000 sq. ft.) of Kentucky 31 Tall Fescue. For the period May I through July 31, seed with 60 lbs. Kentucky 31 Tall Fescue per acre and two lbs. per acre (0.05 lbs./l,000 sq. ft.) of weeping lovegrass. During the period of October 16 through February 28, protect site by: Option 1) -- two tons per acre of well-anchored straw mulch and seed as soon as possible in the Spring; Option 2) -- use sod; Option 3) -- seed with 60 lbs./acre Kentucky 31 Tall Fescue and mulch with two tons/acre well-anchored straw.

Mulching: Apply 1-1/2 to 2 tons per acre (70 to 90 lbs./1.000 sq. ft.) of unrotted small arain stray immediately after seeding. Anchor mulch immediately after application using mulch anchoring tool or 218 gallons per acre (5 gal./1,000 sq. ft.) of emulsified asphalt on flat areas. On slopes eight feet or higher, use 348 gallons per acre (8 gal./1,000 sq. ft.) for anchorina.

Maintenance: Inspect all seeding areas and make needed repairs,

TEMPORARY SEEDING NOTES

Apply to graded or cleared areas likely to be redisturbed where a Seedbed Preparation: Loosen upper three inches of soil by raking, disking, or other acceptable means before seeding, if not

through October 15, seed with 2-1/2 bushels per acre of annual rve (3.2 lbs./1,000 sq. ft.). For the period May 1 through August 14, seed with three lbs. per acre of weeping lovegrass (0.07 lbs./1,000 sq. ft.). For the period November 16 through February 28, protect site by applying two tons per acre of well-anchored straw mulch and seed as soon as possible in the Spring, or use sod.

Mulching: Apply 1-1/2 to 2 tons per acre (70 to 90 lbs./1,000 sq. ft.) of unrotted weed free small grain straw immediately after seeding. Anchor mulch mmediately after application using mulch anchoring tool or 218 gal, per acre (5 gal,/1,000 sq. ft.) of emulsified asphalt on flat areas. On slopes eight feet or higher use 348 gal. per acre (8 gal./1,000 sq. ft.) for anchoring.

PROFESSIONAL ENGINEER

EROSION AND SEDIMENT CONTROL for additional rates and methods not

AND MEETS THE APPROVED PLANS AN

PECIFICATIONS.

CERTIFY DOES NOT MEAN OR IMPLY A GUARANTE

BY THE ENGINEER NOR DOES AN ENGINEER'S

MEETING REQUIREMENTS IMPOSED BY CONTRACT,

MPLOYMENT, OR OTHER MEANS, INCLUDING MEETIN

COMMONLY ACCEPTED INDUSTRY PRACTICES

CERTIFICATION RELIEVE ANY OTHER PARTY FROM

CERTIFICATION BY THE DEVELOPER:

I/WE CERTIFY THAT ALL DEVELOPMENT AND/OR CONSTRUCTION WILL BE DONE ACCORDING TO THESE PLANS, AND THAT ANY RESPONSIBLE PERSONNEL INVOLVED IN THE CONSTRUCTION PROJECT WILL HAVE A CERTIFICATE OF ATTENDANCE AT A DEPARTMENT OF THE ENVIRONMENT APPROVED TRAINING PROGRAM FOR THE CONTROL OF SEDIMENT AND BEFORE BEGINNING THE PROJECT. I WILL PROVIDE THE HOWARD SOIL CONSERVATION DISTRICT WITH AN "AS BUILT" PLAN OF THE POND WITHIN 30 DAYS OF COMPLETION. I ALSO AUTHORIZE PERIODIC ON-SITE INSPECTIONS BY THE HOWARD SOIL CONSERVATION DISTRICT.

Signature of Developer Prolegry Director

CERTIFICATION BY THE ENGINEER:

CERTIFY THAT THIS PLAN FOR PONDS, EROSION AND SEDIMENT CONTROL REPRESENTS A PRACTICAL AND WORKABLE PLAN BASED ON MY PERSONAL KNOWLEDGE OF THE SITE CONDITIONS AND THAT IT WAS PREPARED IN ACCORDANCE WITH THE REQUIREMENTS OF THE HOWARD SOIL CONSERVATION DISTRICT". I HAVE NOTIFIED THE DEVELOPER, THAT HE MUST PROVIDE THE HOWARD SOIL CONSERVATION DISTRICT WITH AN "AS BUILT" PLAN OF THE POND WITHIN 30 DAYS OF COMPLETION.

The state of the s 2/16/3 Signature of Engineer

HESE PLANS HAVE BEEN REVIEWED FOR THE HOWARD SOIL CONSERVATION DISTRICT AND MEET THE TECHNICAL REQUIREMENTS FOR SMALL POND CONSTRUCTION, SOIL EROSION AND SEDIMENT CONTROL

U.S. Soil Conservation Service

THESE PLANS FOR SMALL POND CONSTRUCTION, SOIL EROSION AND SEDIMENT CONTROL MEET THE REQUIREMENTS OF THE HOWARD SOIL CONSERVATION DISTRICT.

APPROVED: FOR PUBLIC WATER AND PUBLIC SEWERAGE SYSTEMS HOWARD COUNTY HEALTH DEPARTMENT

3-10-93 County /Health Officer Date

9/21/92 Pate

Date

APPROVED: HOWARD COUNTY DEPARTMENT OF PLANNING AND ZONING

Chief. Division of Community Planning

APPROVED: FOR PUBLIC WATER AND PUBLIC SEWERAGE, STORM DRAINAGE SYSTEMS AND PUBLIC ROADS

and Land Development

HOWARD COUNTY DEPARTMENT OF PUBLIC WORKS

3/2/93

9.29.92 Chief, Bureau of Engineering

NO. **DESCRIPTION** DATE 7/2/92 GEN. REV. TO OVERALL SHEET AND NOTE ADDITIONS 3/12/92 GEN. REV. TO OVERALL SHEET AND NOTE ADDITIONS 1/25/92 ADD NOTES TO PARTIAL SITE PLAN 9/8/92 ADD BASIN DATA AND REVISE GABION ANCHOR DET As-Built Conditions on partial site plan shown in Red

OWNER AND DEVELOPER

NEW PENN MOTOR EXPRESS, INC

625 SOUTH FIFTH AVENUE

LEBANON, PENNSYLVANIA 17042 (717) 274-2521

STORMWATER AND SEDIMENT CONTROL NOTES AND DETAILS

PARCEL "A-1" RECORDED IN PLAT BOOK 6755 HARWOOD INDUSTRIAL CENTER

FIRST ELECTION DISTRICT-HOWARD COUNTY, MARYLAND CENSUS TRACT NO. 6012 TAX MAP NO.38


(717) 232-0593

SKELLY AND LOY Inc. SCALE: AS NOTED ENGINEERS-CONSULTANTS DATE: 4/15/92 2601 N. FRONT STREET HARRISBURG, PENNSYLVANIA 17110 NO. Y920008-02

HECKED BY: B.A.S. WG. NO. 11 of 12

DRAWN BY: K.L.S.

SDP.92.98

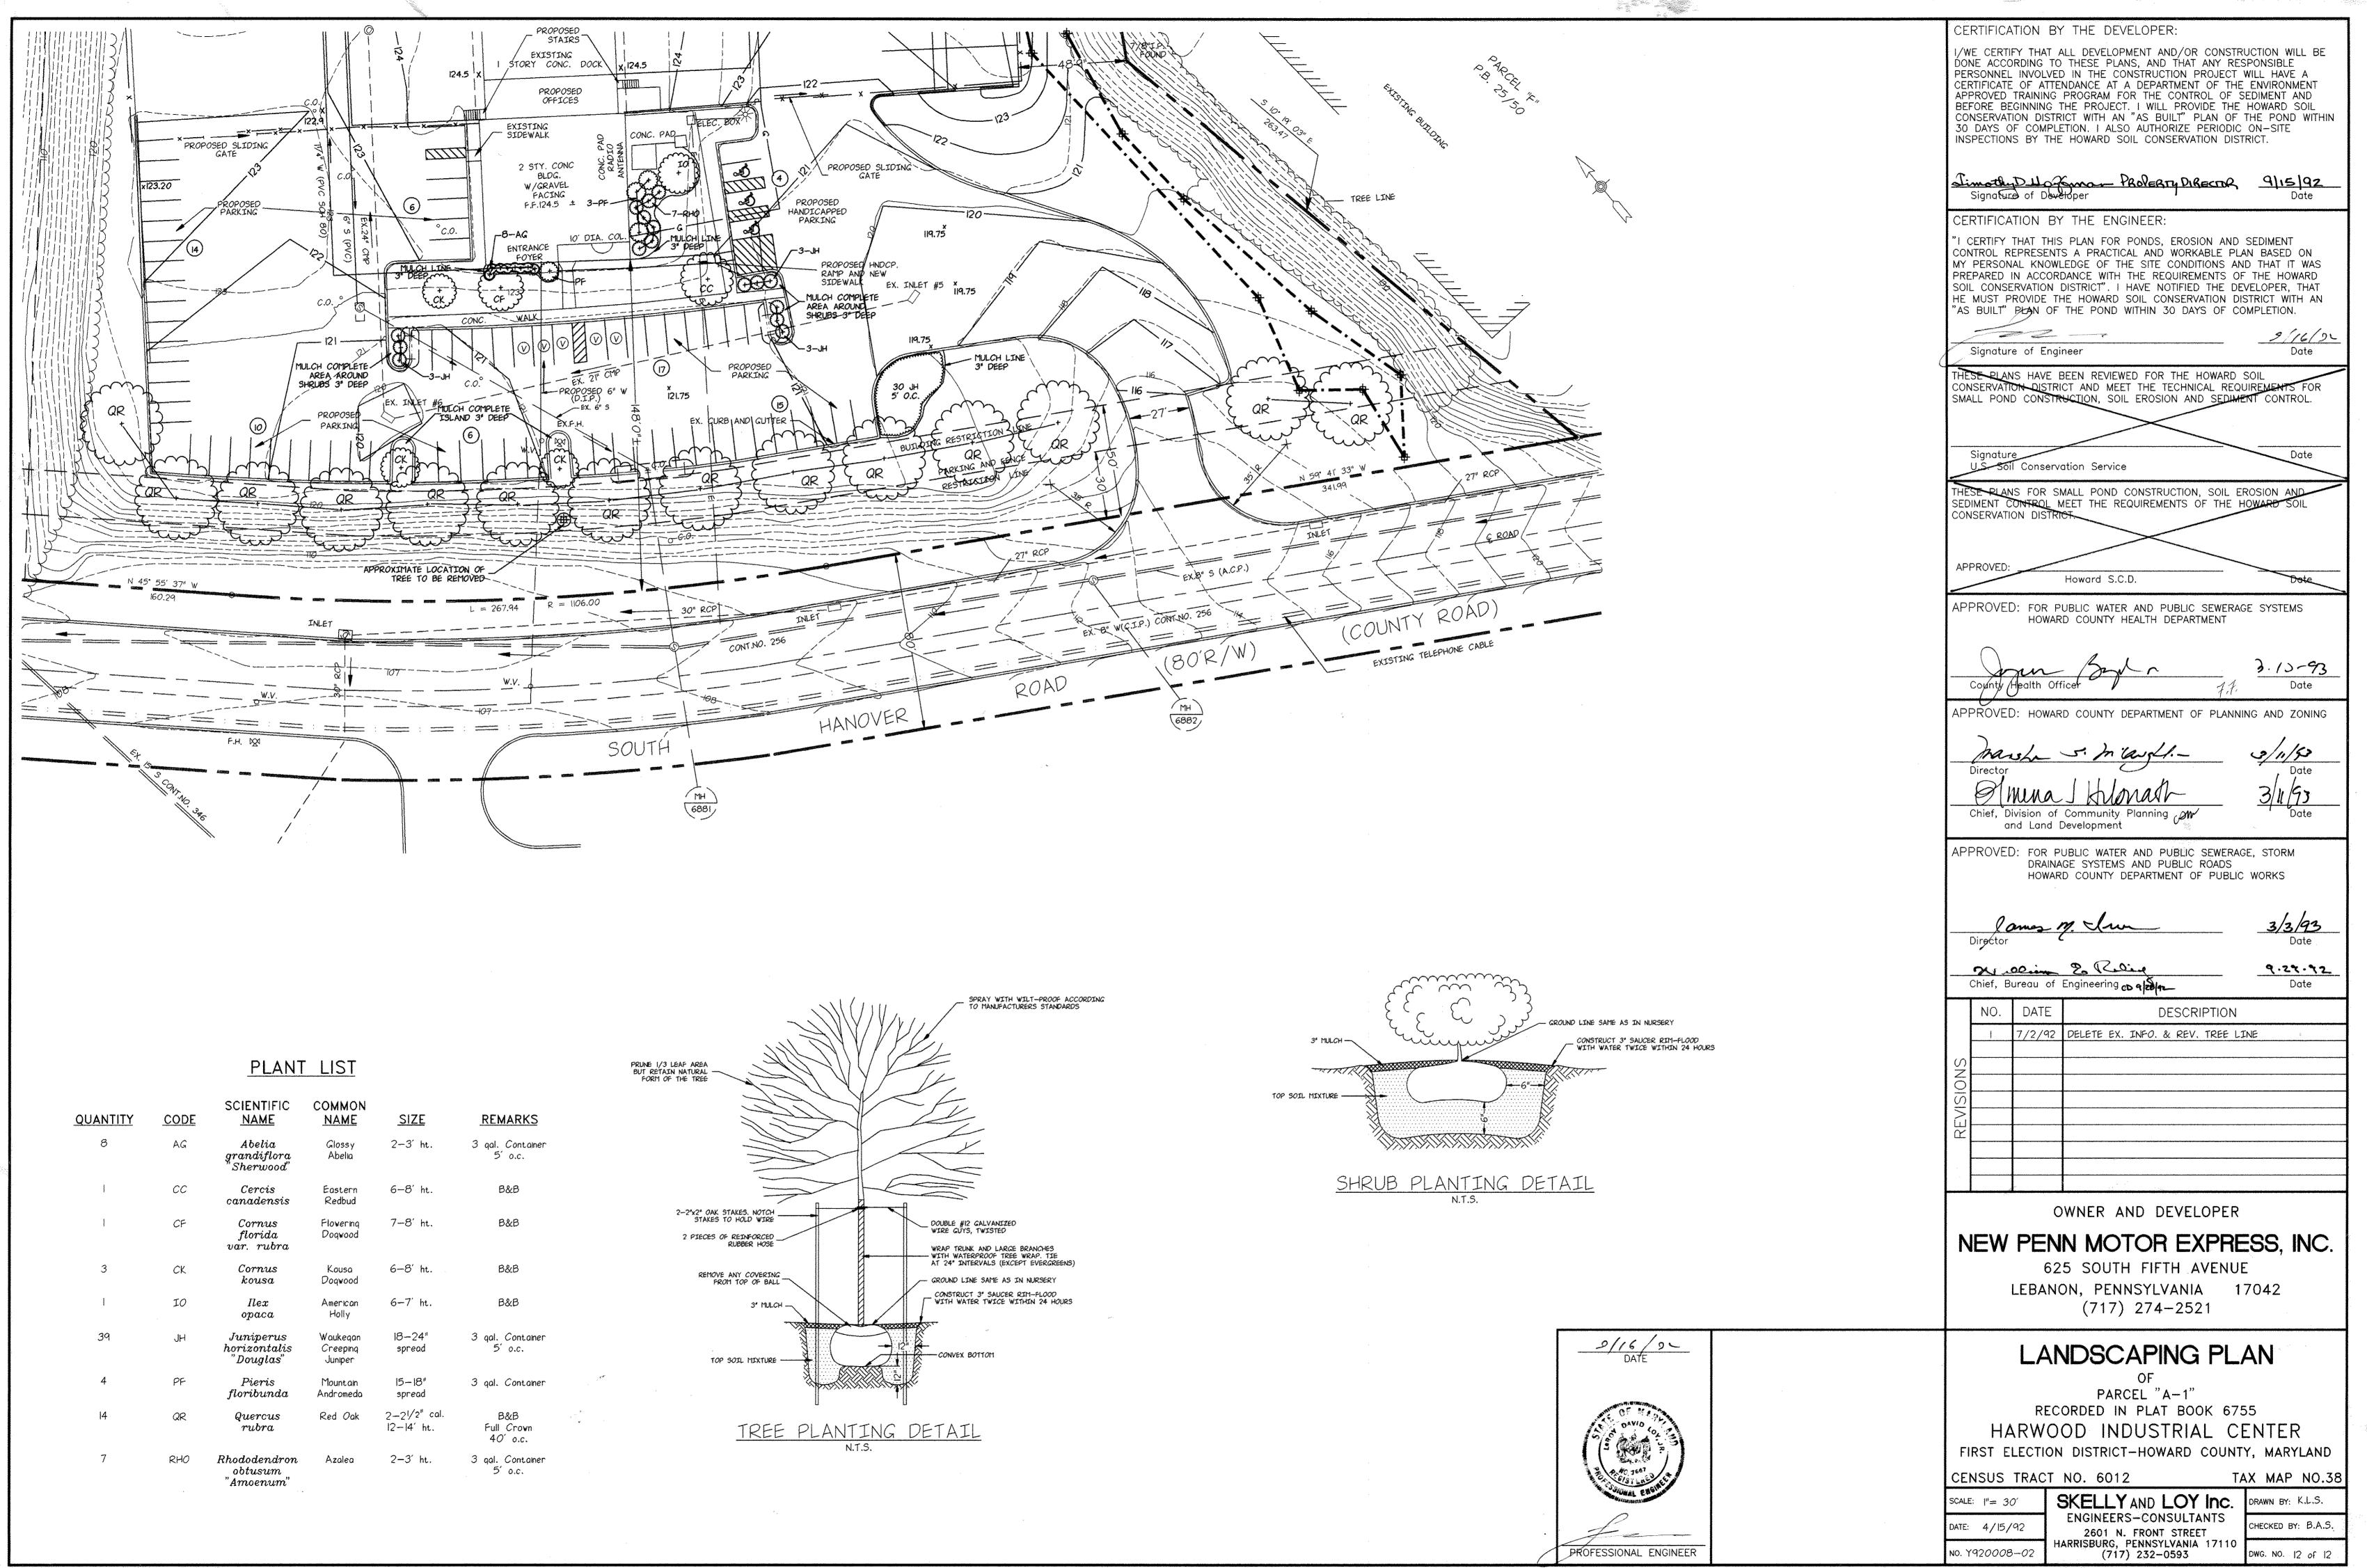

SDP.92.78