SITE ANALYSIS

OFFICES AND DATA CENTER

WATER CODE

E-06

i. PRESENT ZONING: MANUFACTURING, LIGHT (M-I)

SEWER CODE

4900000

2. TOTAL AREA OF SITE: 5.154 ACRES.

3. AREA OF SUBMISSION 5.154 ACRES BUILDING FLOOR SPACE: PROPOSED: 46,000 S.F.

4. NUMBER OF EMPLOYEES PROPOSED (MAX.): 217

5. NUMBER OF PARKING SPACES REQUIRED: 7SPACES/10 EMPLOYEES - 152 SPACES. PROPOSED: 200 INCLUDING 7 HANDICAP SPACES.


6. GREEN AREA 1.91 ACRES 37%.


7. BUILDING COVERAGE: 1.05 ACRES 20.3%.

8. PAVING APEA: H95 ACRES 37.8%.

9. LANDSCAPED ISLANDS: 0.24 ACRES 12.3% OF PARKING AREA.

	SHEET INDEX
NO.	DESCRIPTION
	COVER SHEET
2.	LAYOUT PLAN
3.	GRADING/UTILITY PLAN
4.	SITE DETAILS
5.	PROFILES
6.	SEDIMENT CONTROL PLAN
7.	SEDIMENT CONTROL DETAILS
8.	LANDSCAPING PLAN
9.	A SOLAR CARPORT PLAN

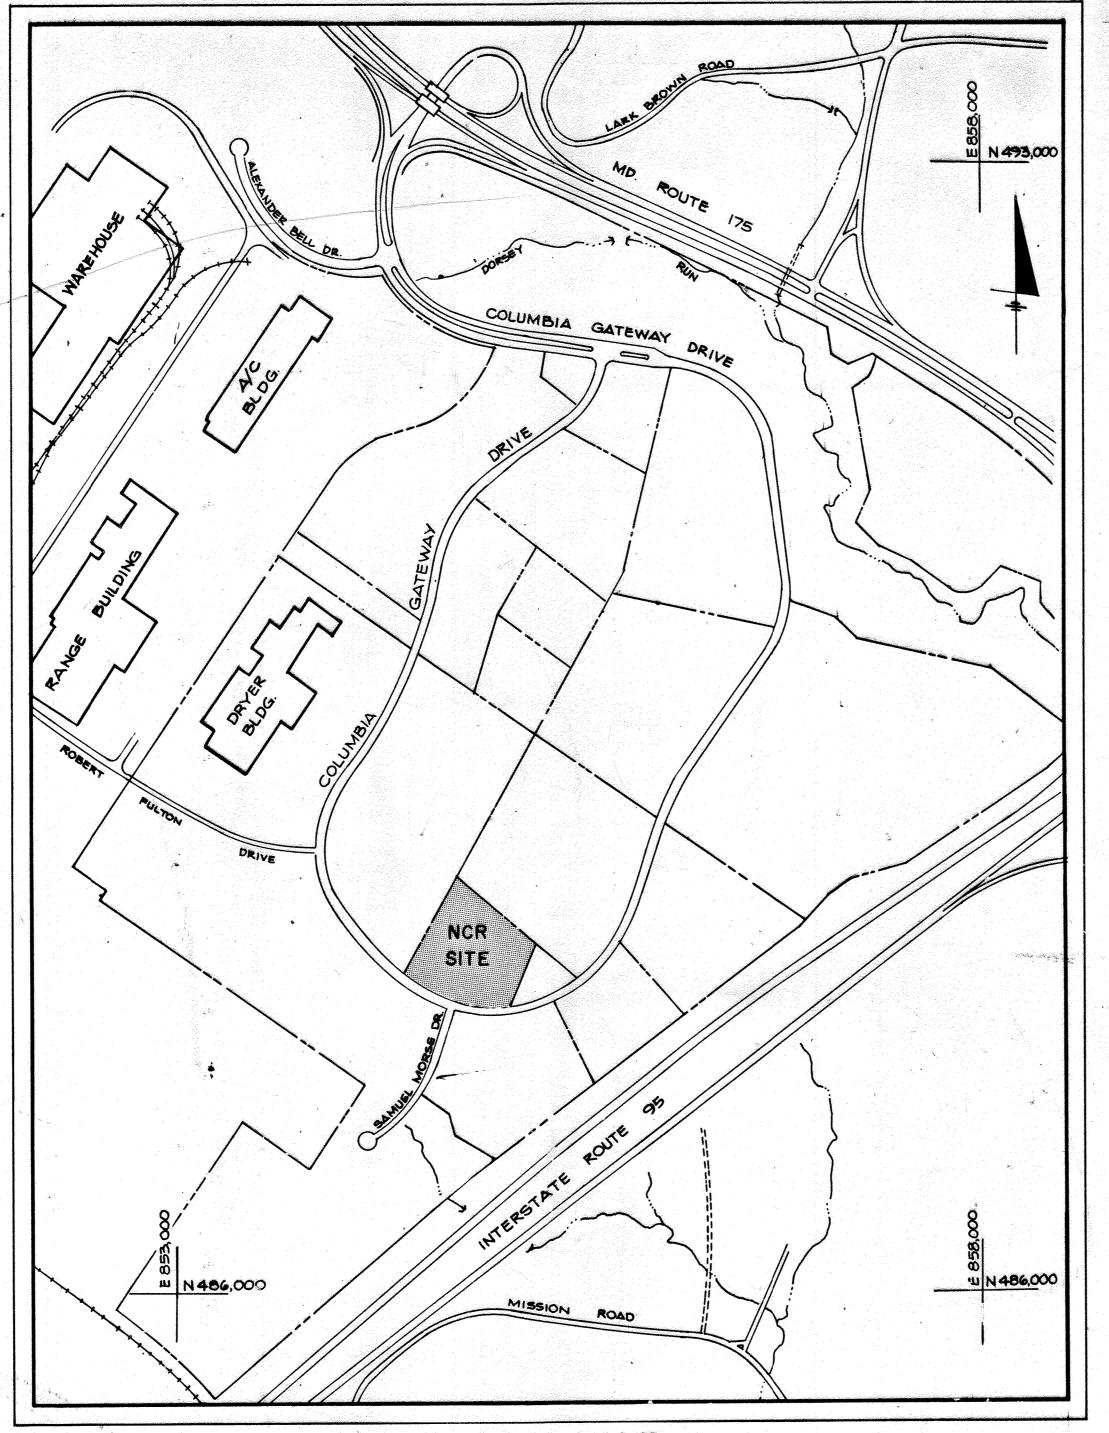


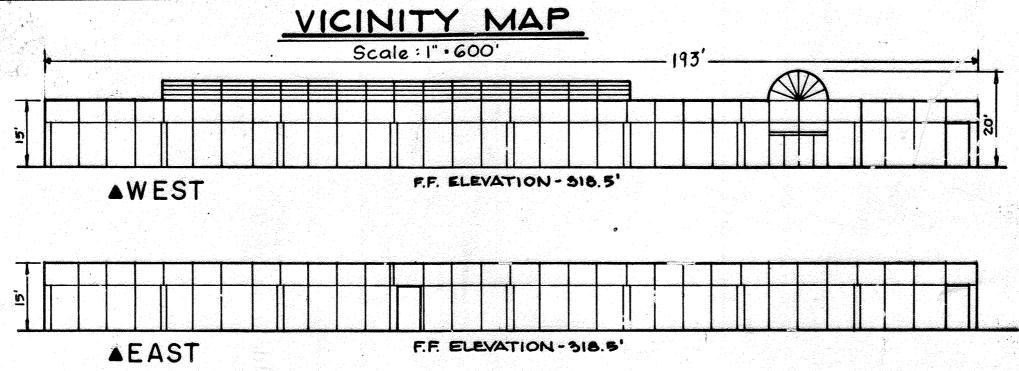

BUILDING ELEVATIONS

Ver Scale: 1" · 20'

WHITMAN, REQUARDT AND ASSOCIATES ENGINEERS 2315 ST. PAUL ST BALTIMORE , MARYLAND 21218

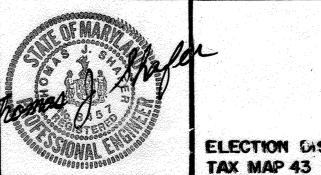

ELECTION DISTRICT NO.6

SITE DEVELOPMENT PLAN

EXISTING CONTOUR (2'INTERVAL)

PROPOSED CONTOUR (I' INTERVAL)

EXISTING CURB (TO BE REMOVED)

TOP CURB / BOTTOM CURB

CONCRETE WALK

FLOW ARROWS

BUILDING ENTRANCE

PROPOSED FINISHED FIRST FLOOR ELEVATION

RESERVED FOR HANDICAPPED PERSONS (INDICATED)

LEGEND

PROPOSED

F.F. 000.0

318x0

TC/BC

-x-x-x

UNIVERSITY OF MARYLAND MEDICAL SYSTEM

COLUMBIA, GATEWAY COLUMBIA, MARYLAND

DEVELOPER A

CIUMMS CG LLC 1340 SMITH AVENUE SUITE 200 BALTIMORE MARYL AND 21 209 WALTERSERAFYN

HOWARD COUNTY PARCEL 5-2

Richter Cornbrooks Gribble, Inc.

Architects/Planners 2120 North Charles, Street Baltimore. Maryland \212

GENERAL NOTES

ALL SITE WORK CONSTRUCTION TO BE DONE IN ACCORDANCE WITH HOWARD COUNTY DESIGN MANUAL-VOLUME IX STANDARD SPEC-IFICATIONS AND DETAILS FOR CONSTRUCTION.

- 2. PUBLIC WATER AND PUBLIC SEWER TO BE UTILIZED.
- 3. ANY DAMAGE TO PUBLIC RIGHT-OF-WAY OR PAVING MUST BE CORRECTED AT THE DEVELOPER'S EXPENSE.
- 4. GRADES HAVE BEEN ESTABLISHED TO INSURE POSITIVE DRAINAGE.
- 5. SIDEWALKS SHALL BE SCORED OR OTHERWISE TEXTURED TO INDICATE TO BLIND PERSONS THE LOCATION OF DOORS AT BUILDING.
- ONE HANDICAPPED PARKING SIGN SHALL BE PLACED AT EACH HANDICAPPED PARKING SPACE IN ACCORDANCE WITH REQUIRE-MENTS OF THE MARYLAND BUILDING CODE.
- AND WATER QUALITY MANAGEMENT 7. STORMWATER MANAGEMENT WILL BE PROVIDED BY THE EXISTING OFF SITE POND CONSTRUCTED UNDER F-87-125 (APPROVED REVISION JUNE 2,1989).
- 8. ALL PROPOSED EXTERIOR LIGHTING DEVICES SHALL BE REFLECTED! DIRECTED AWAY FROM ALL ADJOINING PUBLIC ROAD RIGHT-OF-WAYS.
- 9. THERE IS A MINIMUM OF 5 LEVEL FEET AT EACH BUILDING ENTRANCE.

APPROVED DIVISION of COMMUNITY PLANNING & LAND DEVELOPMEN HOWARD COUNTY, MARYLAND

DATE 8-27-87

OWNER (2)
UNIVERSITY OF MARYLAND

MEDICAL SYSTEM

ADDED SIDEWALK @ REAR 12-1905 AND DUCTBANK @ FRONT No. Description Date

Revisions

COVER SHEET


Scale as Shown

70GO COLUMBIA GATEWAY DRIVE COLUMBIA, MD. 2104G Project No. 40555

> Date 9/!1/89 Drawing No.

> > C-1 of 9

SDP 87-252

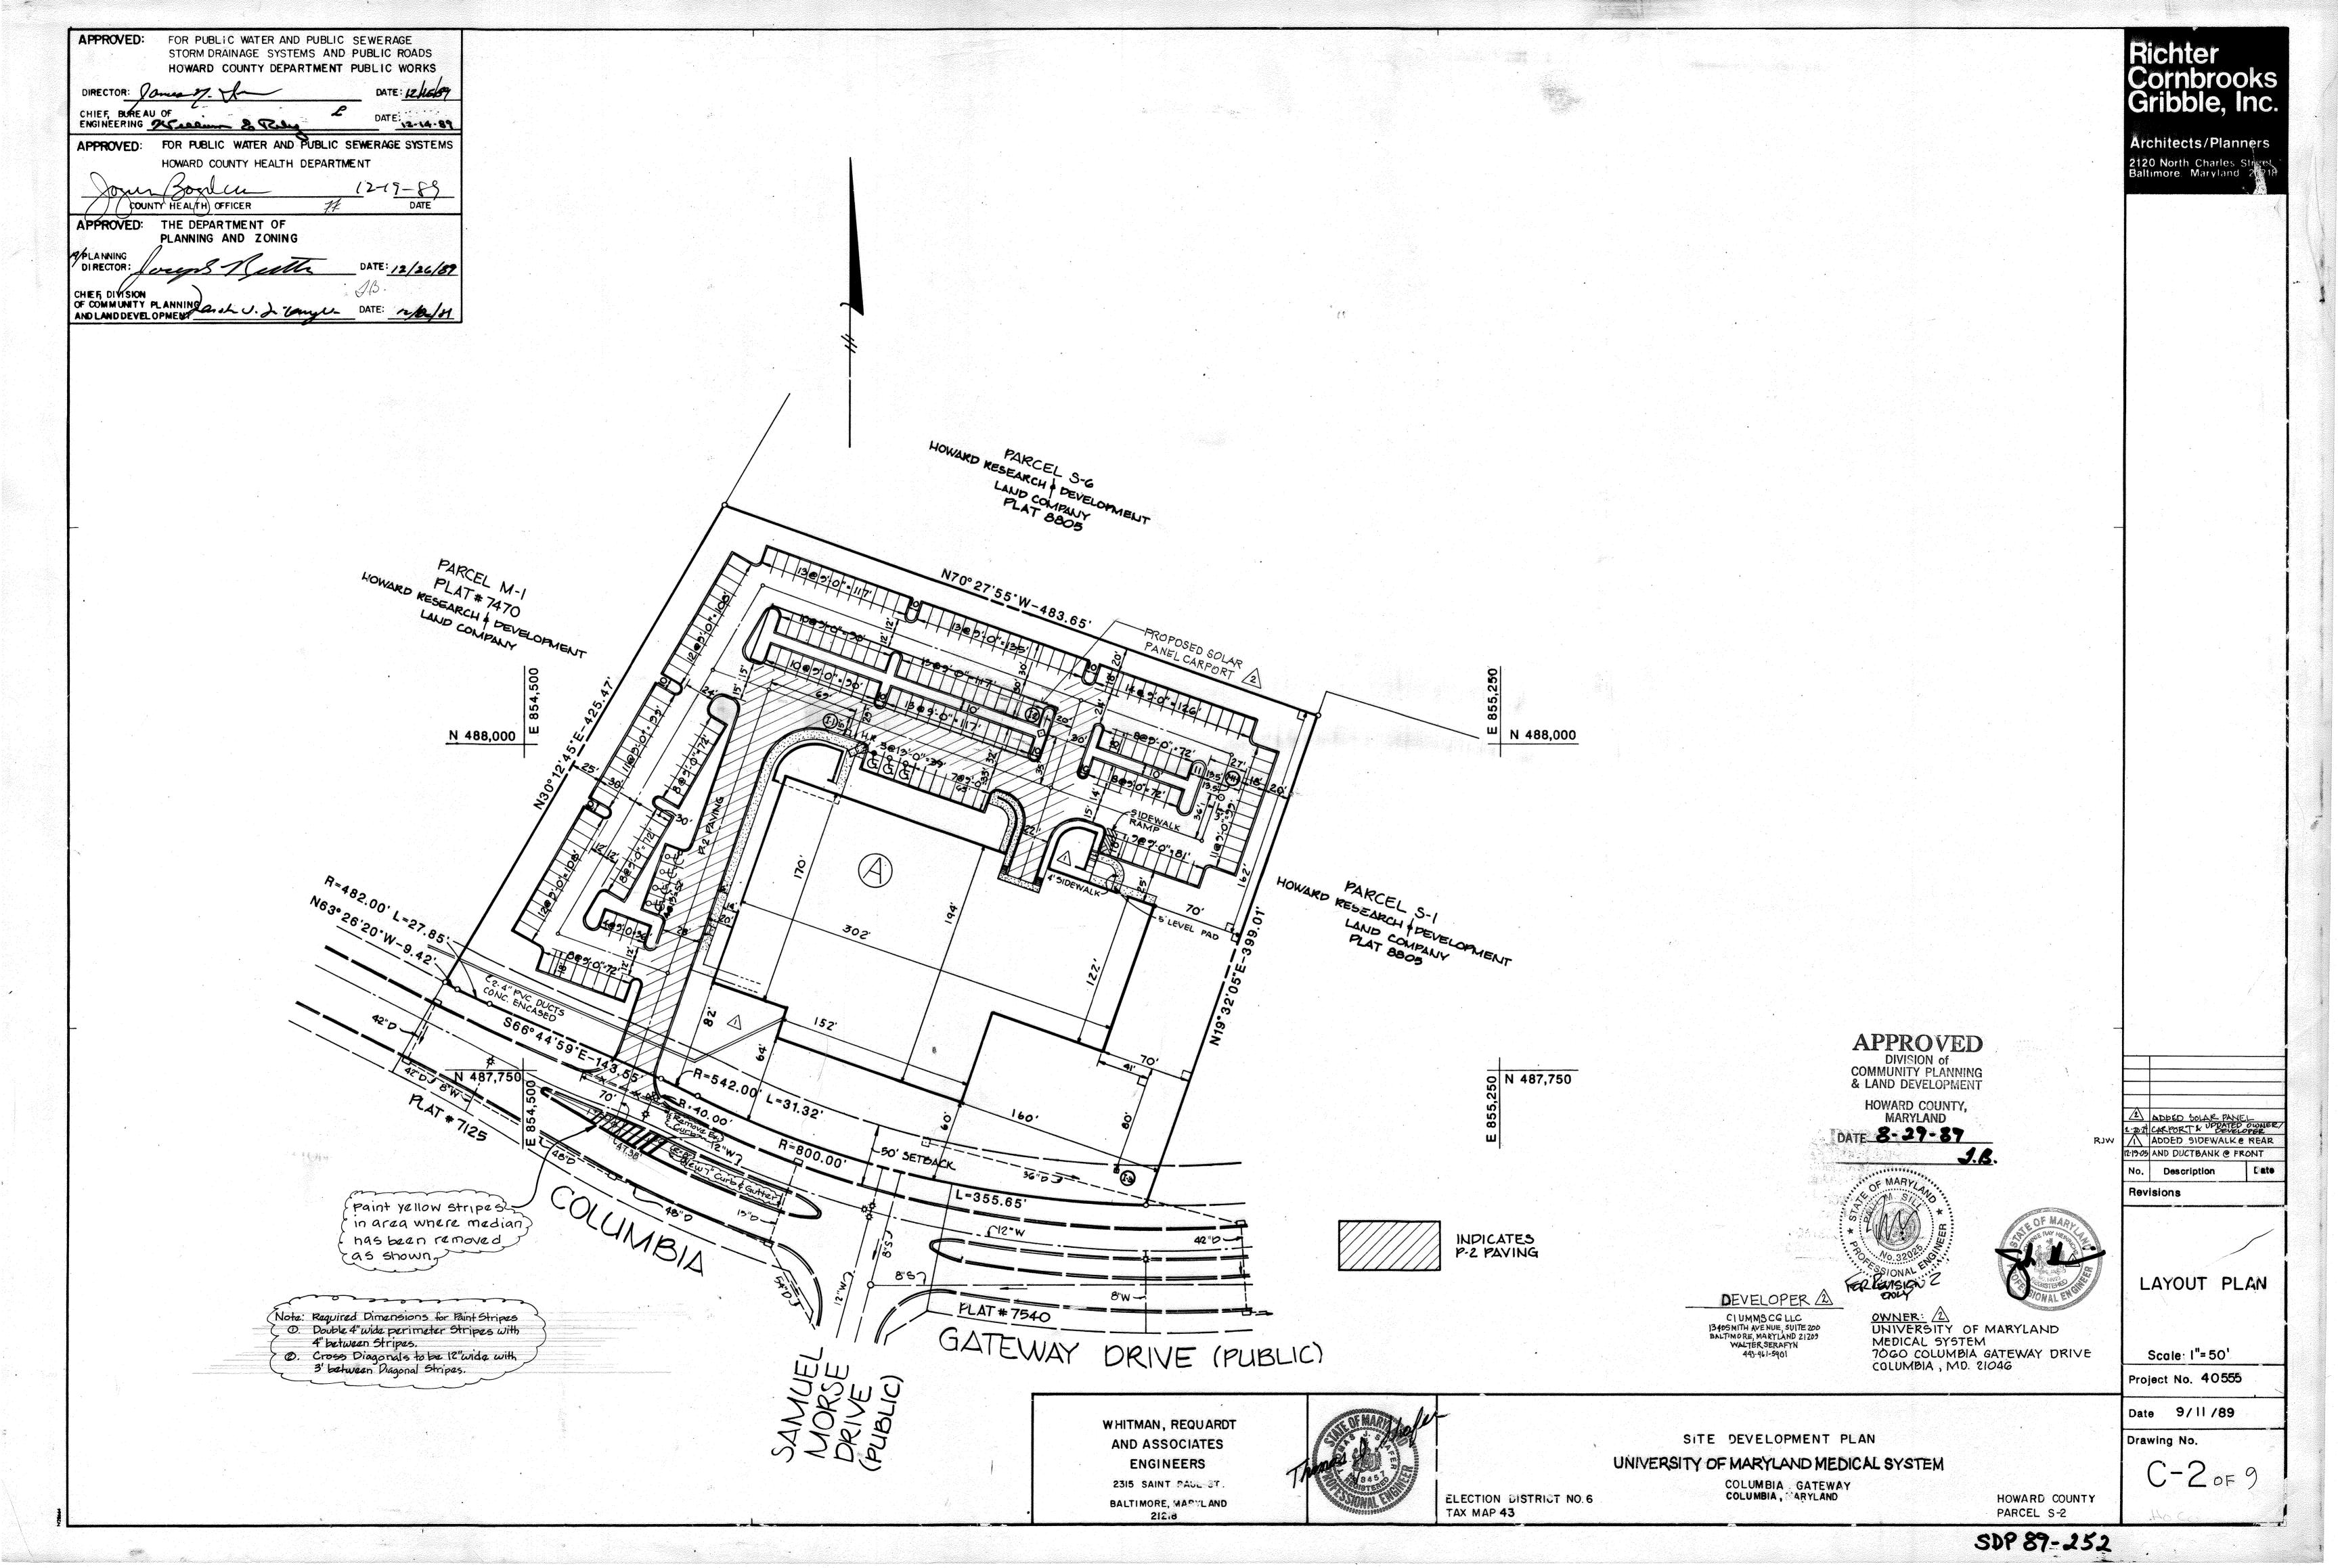

APPROVED: FOR PUBLIC WATER AND PUBLIC SEWERAGE STORM DRAINAGE SYSTEMS AND, RUBLIC ROADS HOWARD COUNTY DEPARTMENT PUBLIC WORKS DATE:/2/15/67 CHIEF, BUREAU OF DATE: 12-14-87 ENGINEERING Architects/Planners FOR PUBLIC WATER AND PUBLIC SEWERAGE SYSTEMS 2120 North Charles Street Baltimore, Maryland 21218 HOWARD COUNTY HEALTH DEPARTMENT 12-19-85 COUNTY HEALTH OFFICER APPROVED: HOWARD COUNTY THE DEPARTMENT OF PLANNING AND ZONING STORM DRAIN STRUCTURE SCHEDULE A PLANNING DI RECTOR: 29. TOPEL. INV. IN INV.OUT LOCATION TYPE MH-1 4'-0" Standard See Layout Plan 316.0 | 308.56 | 308.56 I-1 Double Type 'S' Comb. 5.04.33 316.0 ~ 312.30 See Layout Plan I-2 Type 'D' 9.0. 4.11 314.5 310.75 310.00 See Layout Plan I-3 Yard Inlet S.D. 4.14 313.5 ~ 309.75 See Layout Plan 5-1 Concrete End Section 3.0.5.5 300.06 298.06 297.00 See Layout Plan 5-2 Concrete End Section S.D.5.5 309.15. 307.90 307.90 See Layout Plan Two patio drains are to be Zurn Z-GIO'S 12" Top X-Heavy Duty Drain or approved equal. PARCEL M-1 PLAT 7470 HOWARD RESEARCH & DEVELOPMENT LAND CO. PARCEL 5-6 HOWARD RESEARCH & DEVELOPMENT LAND CO. PLAT 8805 N 488,000 N 488,000 RIP RAP OUTLET PROTECTION LENGTH : 10' WIDTH = 4' CLASS I RIP-RAP WITH FILTER FABRIC THICKNESS .I' STORMWATER MANAGEMENT AND RIP. RAP CHANNEL A WATER QUALITY WILL BE SIDE SLOPE 2:1 PROVIDED UNDER F-87-125. CHANNEL SLOPE 4:1 do = 6"TO 9" STONE PARCEL 5-1 n * 0.038 HOWARD RESEARCH & DEVELOPMENT LAND CO. MAX. YEL. B fee HICKNESS . 1.5 x9" = 1.2" PLAT. 8805 DEPTH : 1' Q10 = 1.27 efs V10 = 2.11 fps ON 487,750 2 ADOED SOLAR PANEL2: 20: 24 CARPORT & DEVELOPER

ADDED SIDEWALK & REAR APPROVED
DIVISION OF
COMMUNITY PLANNING
& LAND DEVELOPMENT 2-19-05 AND DUCTBANK @FRONT FOR BRUSION 2 Description Revisions HOWARD COUNTY, MARYLAND L=355.65' CI2.W DATE 8-27-89 GRADING / UTILITY PL.AN DEVELOPER A PROPOSED 20 WATER OWNER 12 UNIVERSITY OF MARYLAND MEDICAL SYSTEM 7060 COLUMBIA GATEWAY DRIVE COLUMBIA, MD. 21046 AND SEWER EASEMENT CI UMMS CG LLC 1340SMITH AVENUE, SUITE 200 BALTIMORE, MARYLAND 21200 WALTER SERAFYN 443-461-5901 GATEWAY DRIVE (PUBLIC) Scale: 1"= 50" Project No. 40555 Date 9/12/89 WHITMAN, REQUARDT

AND ASSOCIATES

ENGINEERS

2315 SAINT PAUL ST

BALTIMORE, MARYLAND

21218

SDP 87-252

HOWARD COUNTY

PARCEL S-2

Drawing No.


SITE DEVELOPMENT PLAN


UNIVERSITY OF MARYLAND MEDICAL SYSTEM


COLUMBIA, GATEWAY COLUMBIA, MARYLAND


ELECTION DISTRICT NO.6

TAX MAP 43

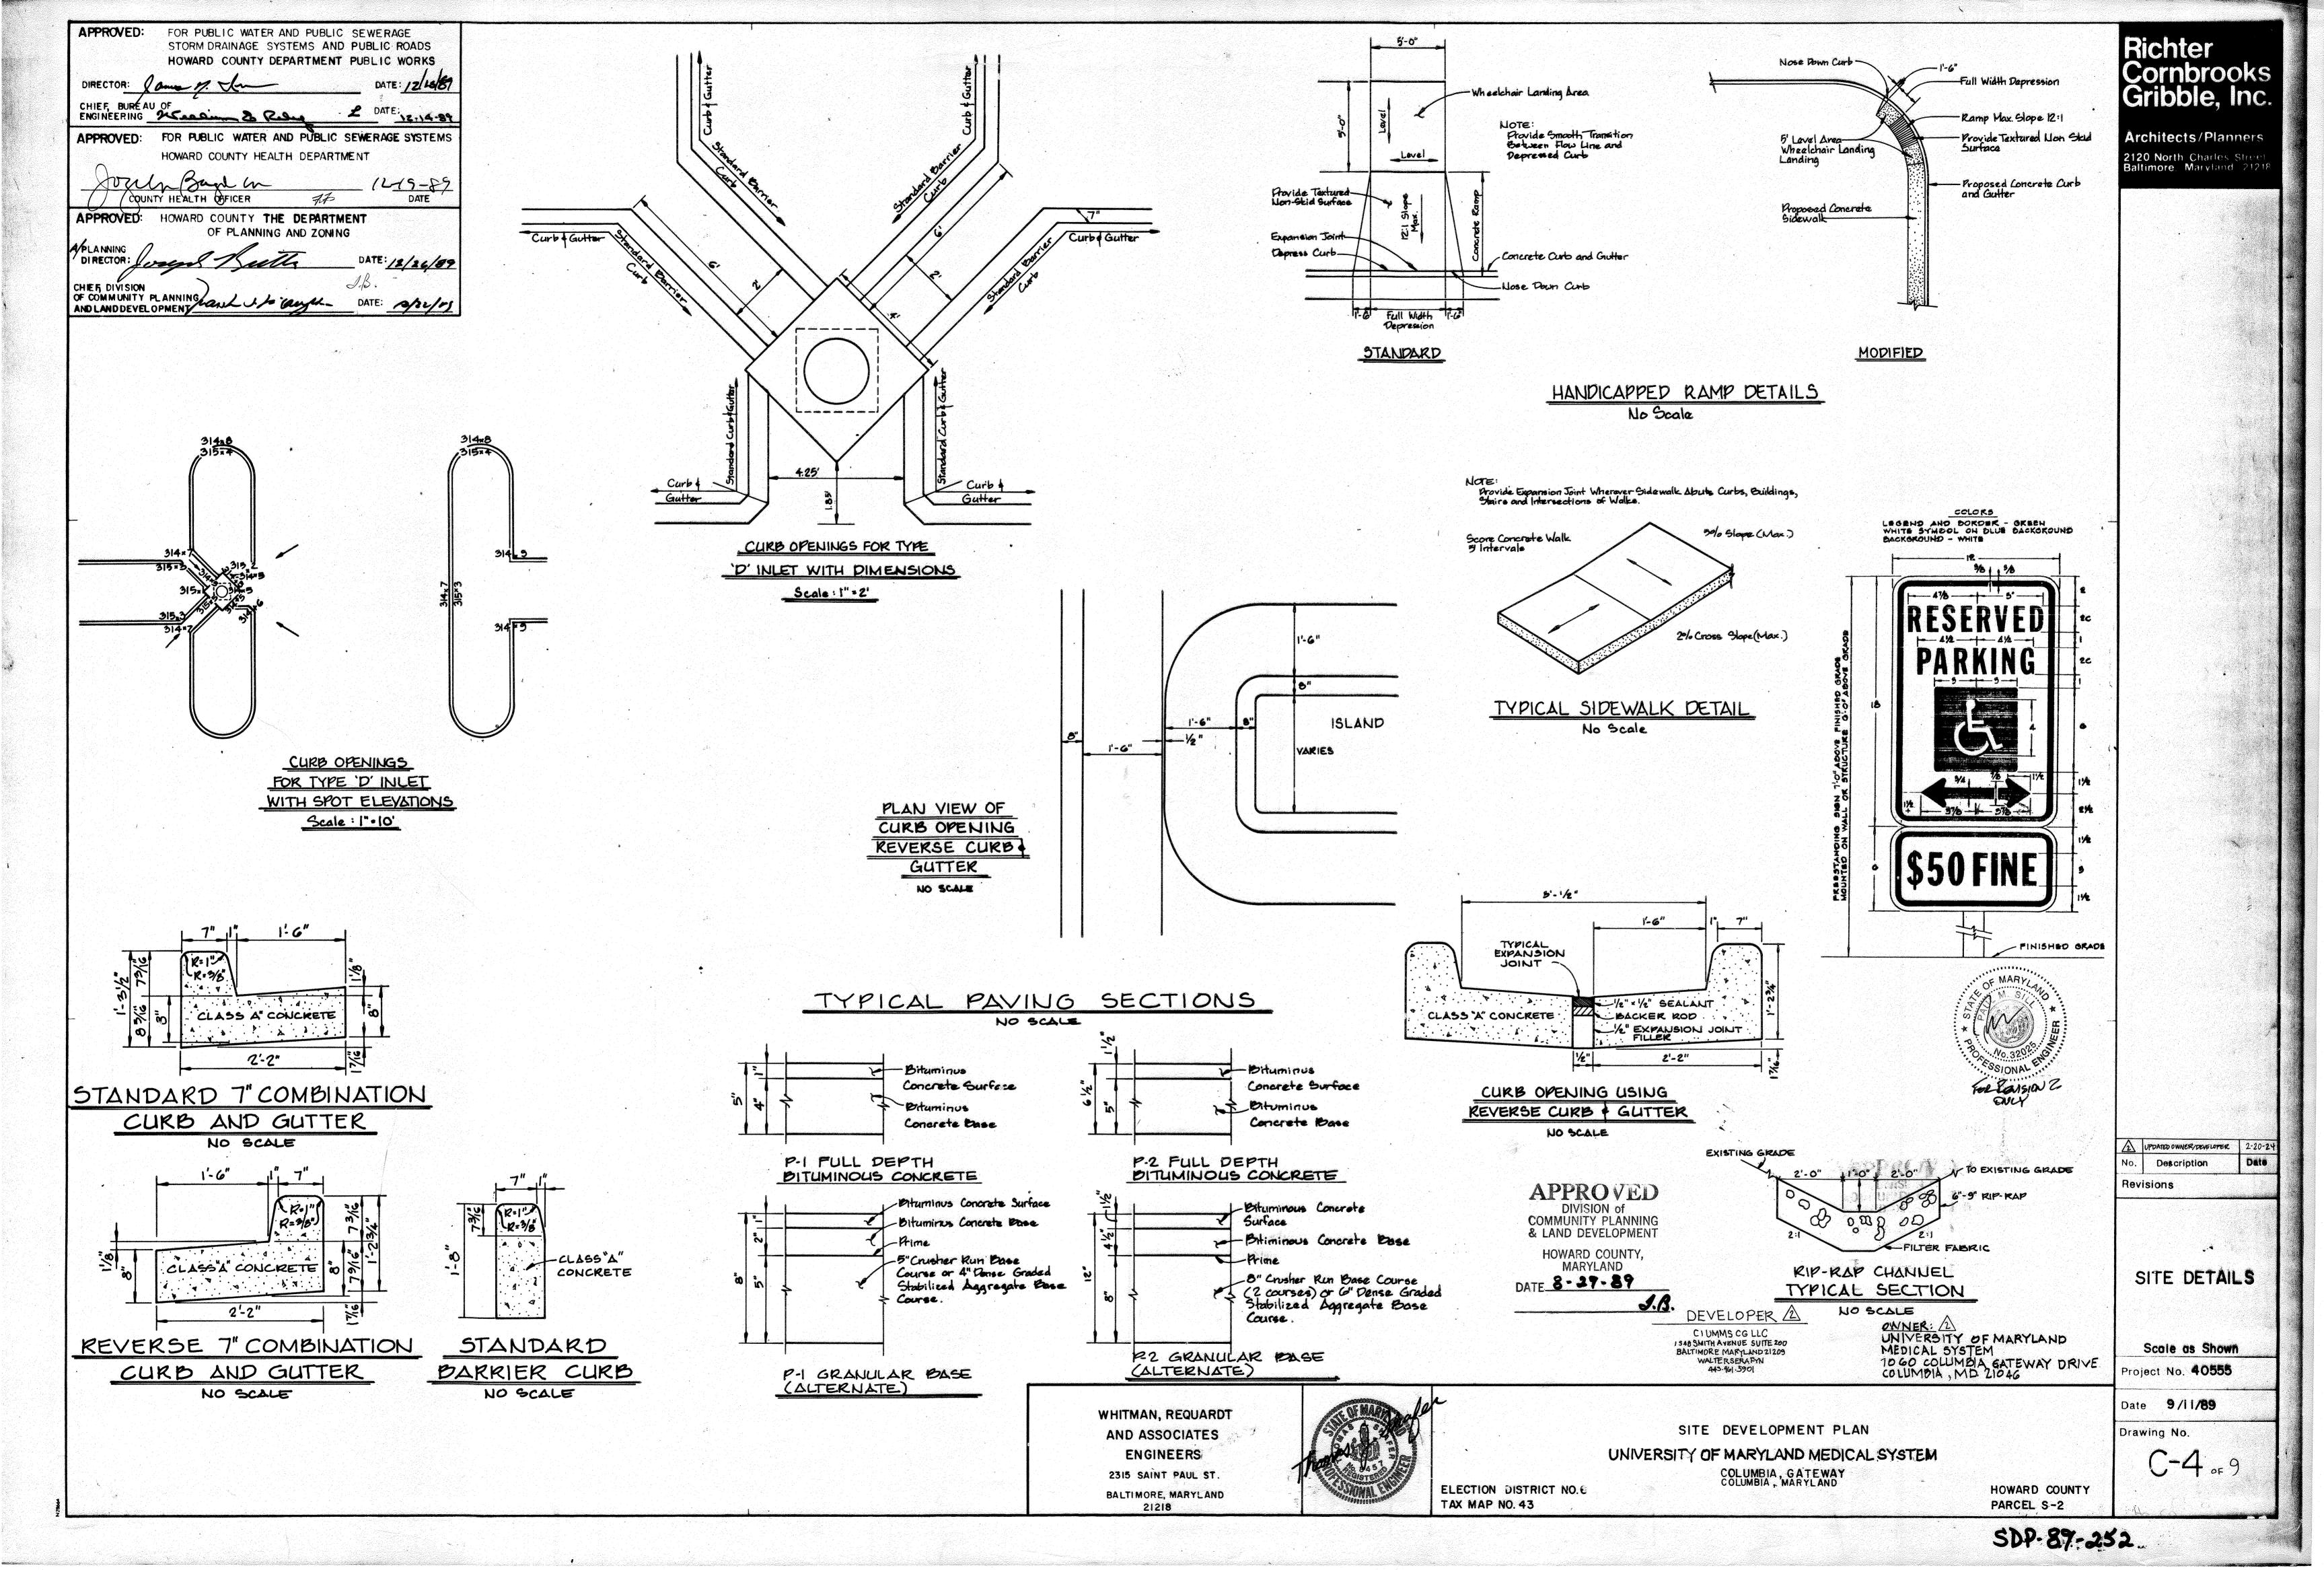

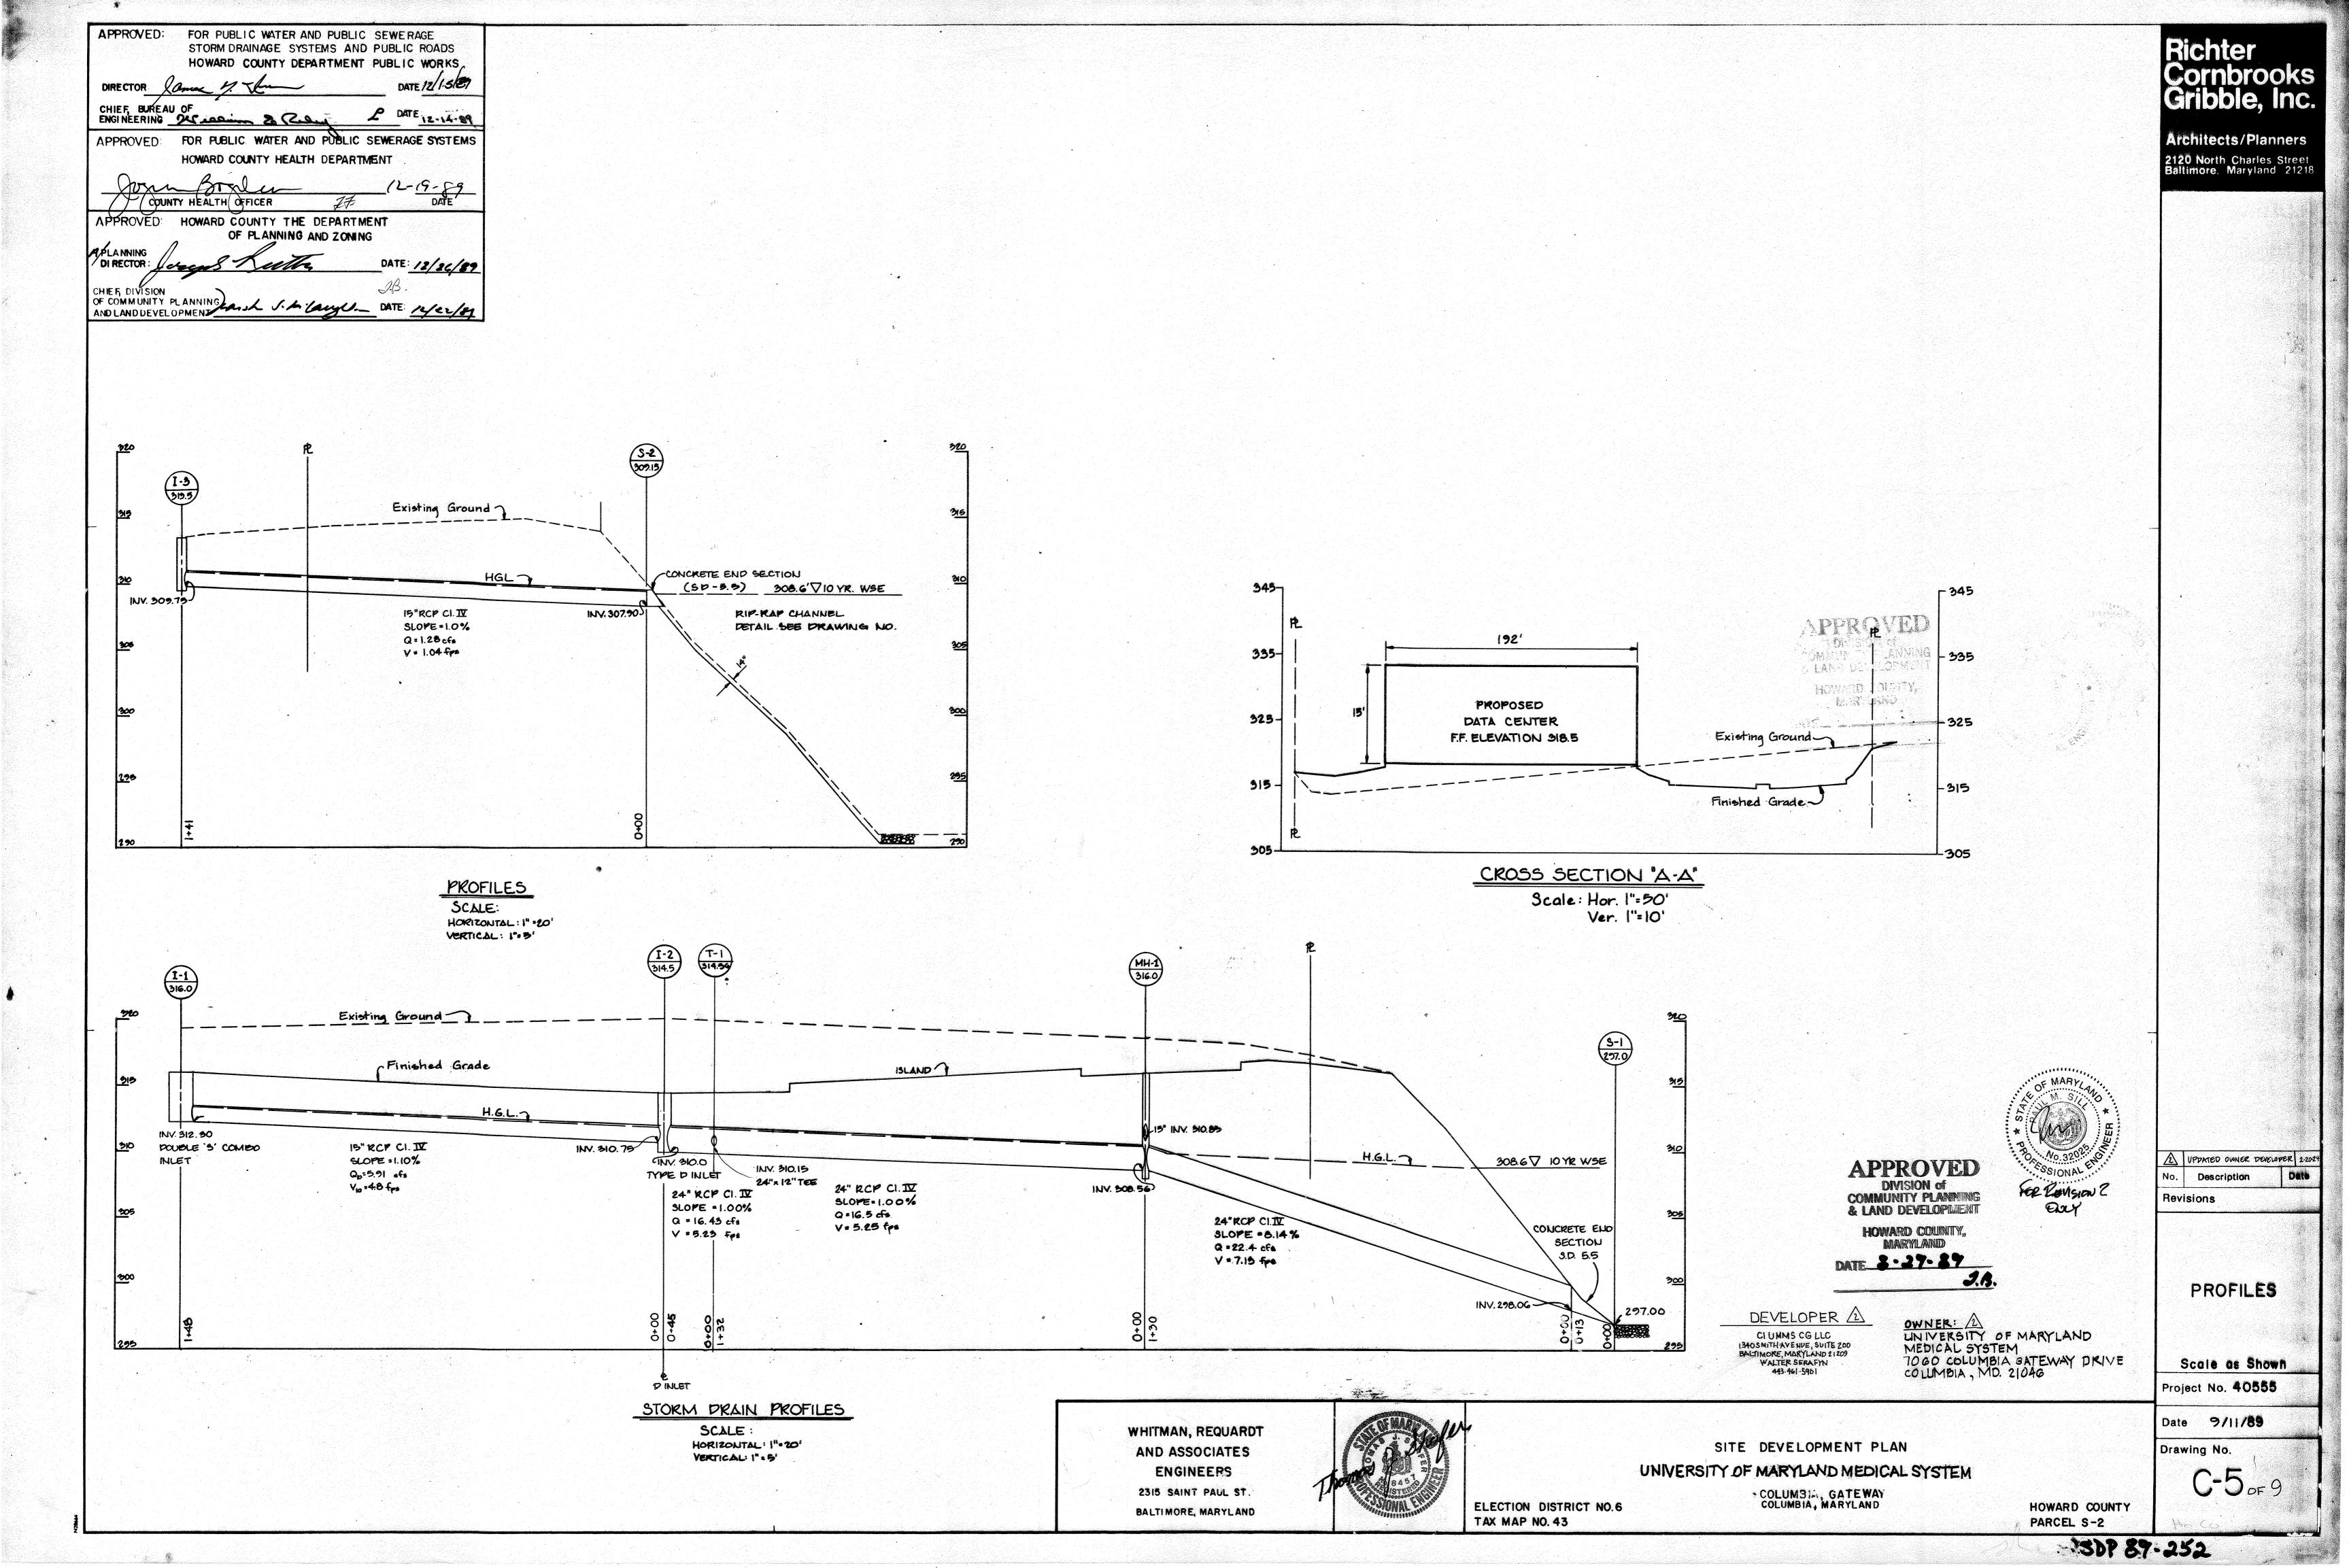

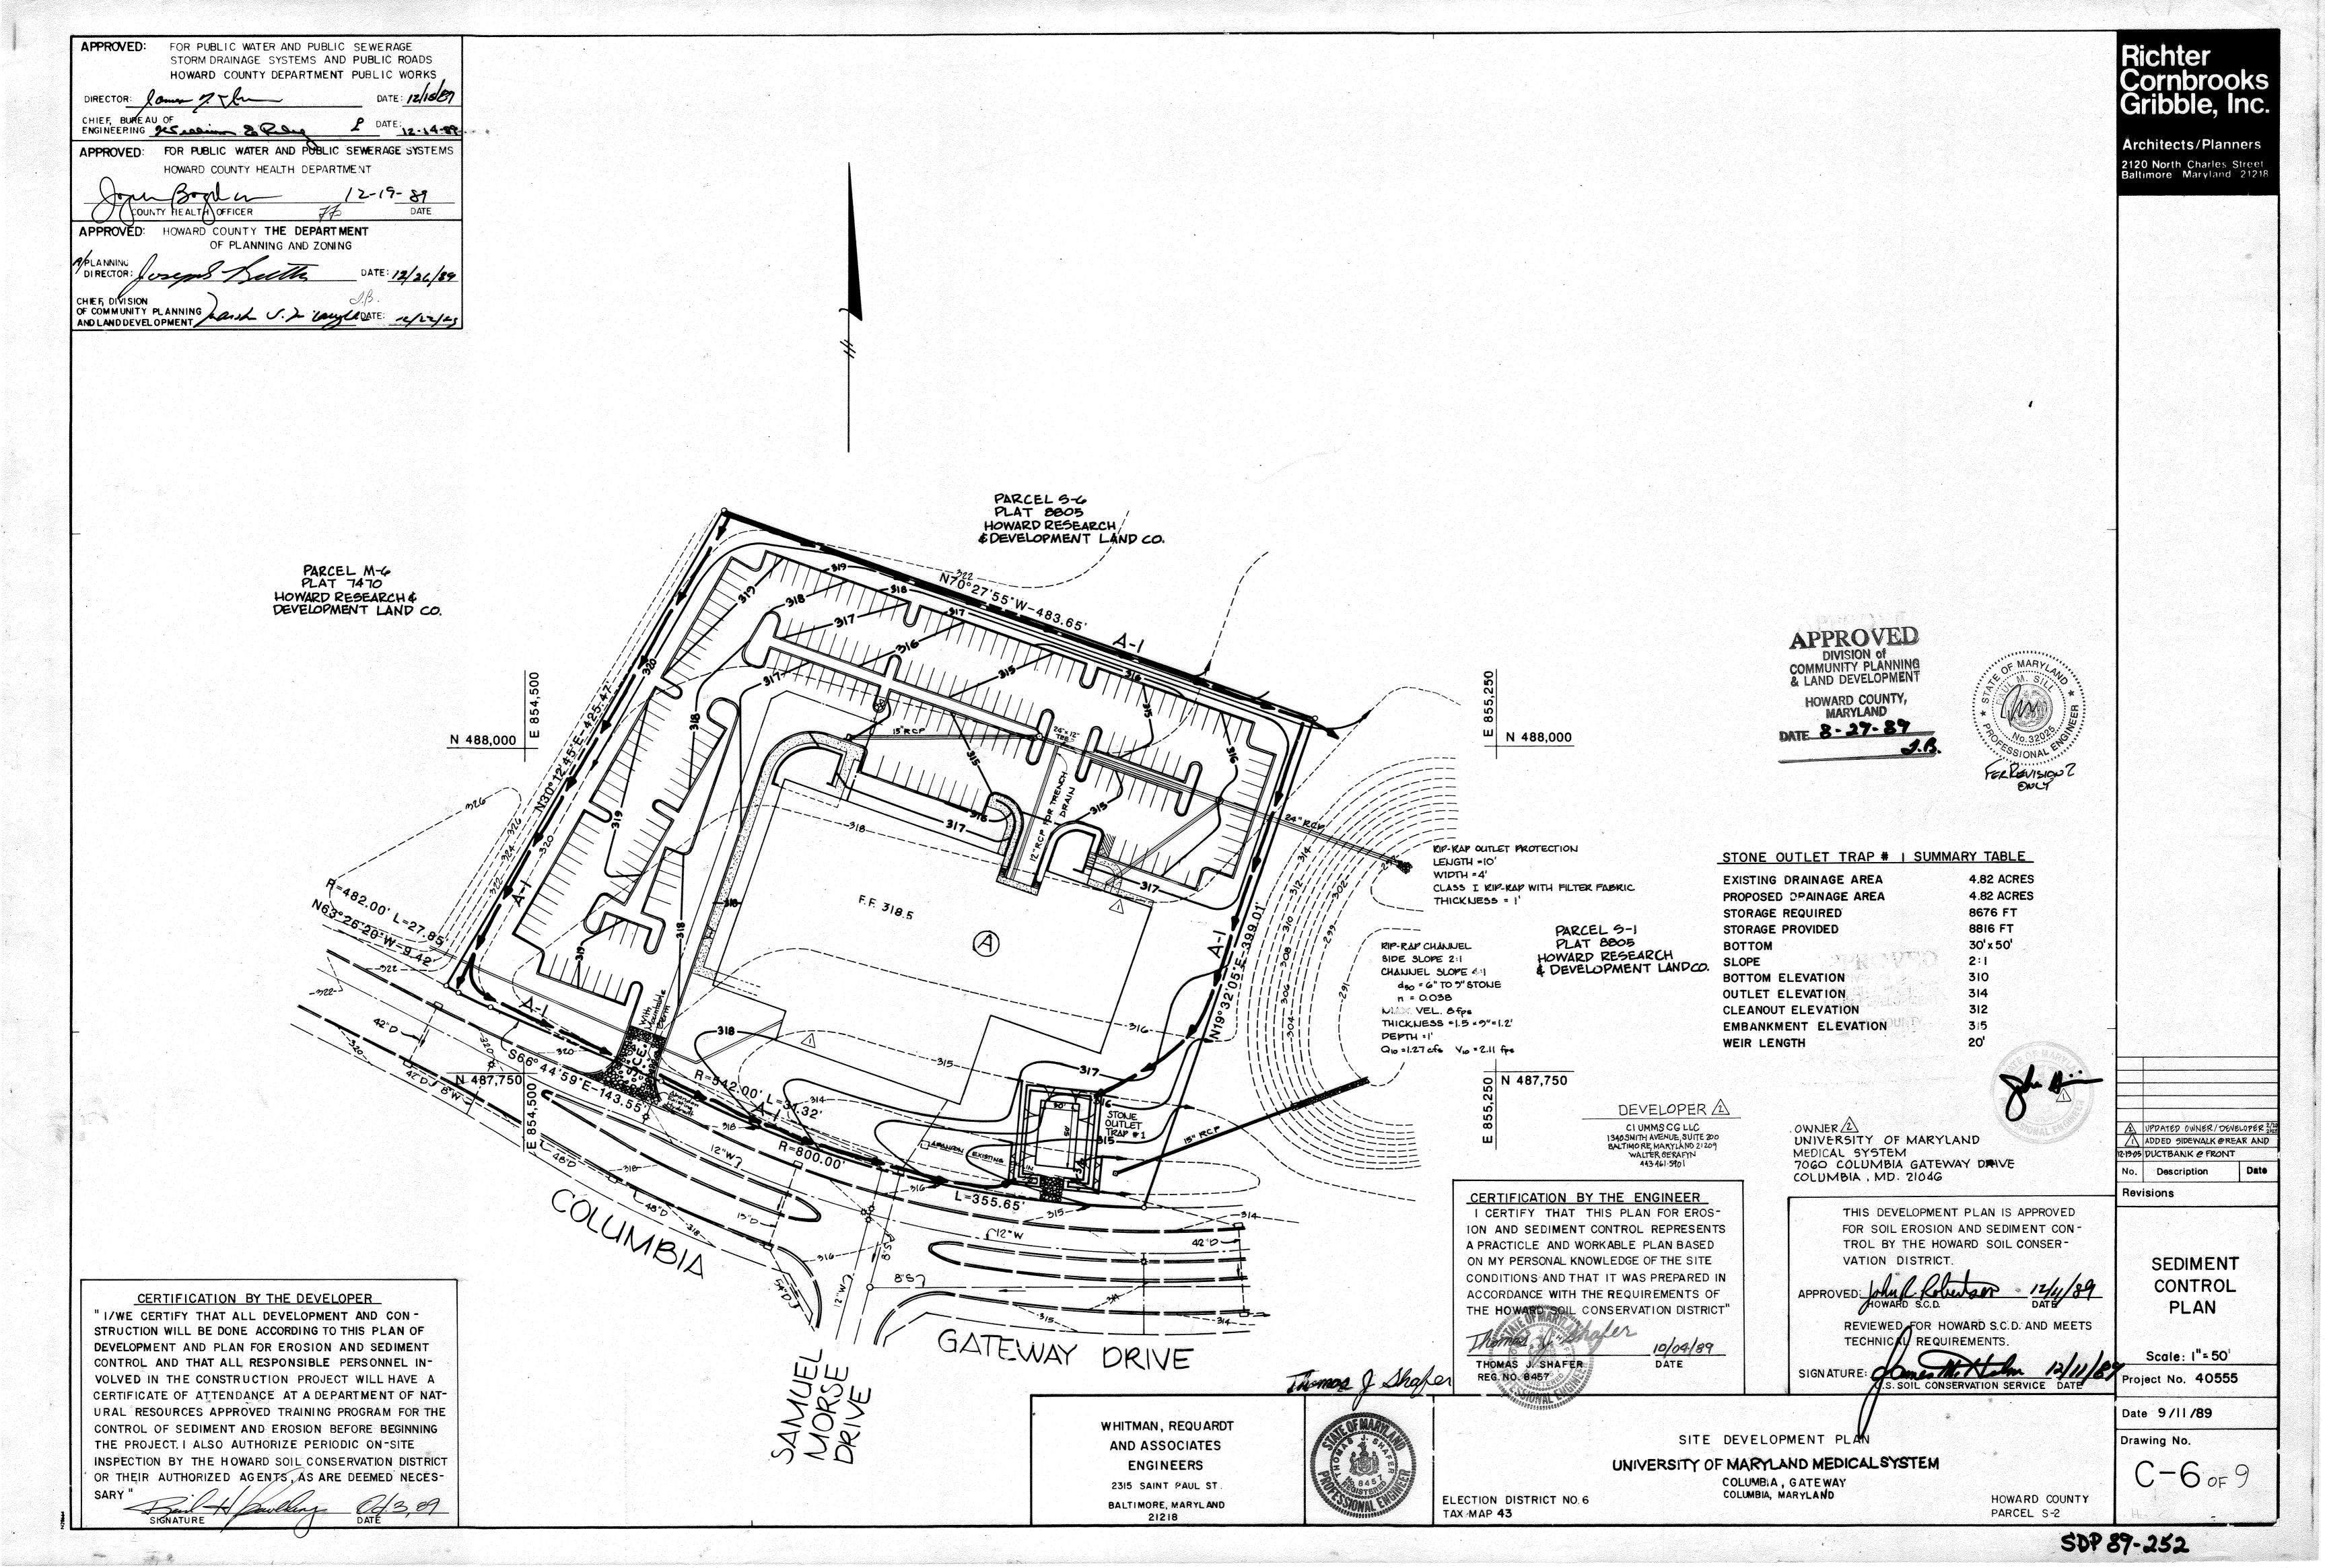

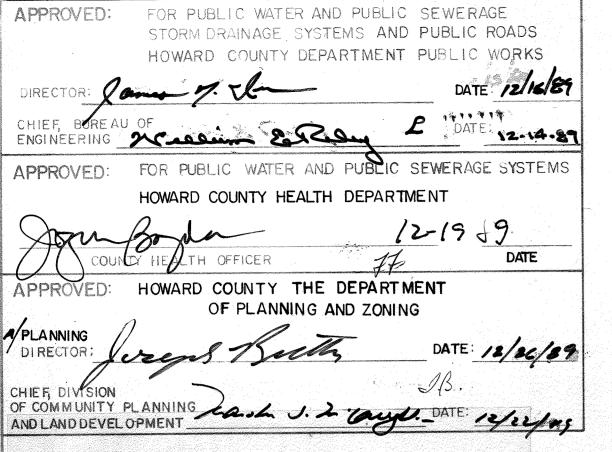

SEDIMENT CONTROL NOTES

- 1) A minimum of 24 hours notice must be given to the Howard County Office of Inspection and Permits prior to the start of any construction. (992-2437)
- 2) All vegetative and structural practices are to be installed according to the provisions of this plan and are to be in conformance with the 1983 MARYLAND STANDARDS AND SPECIFICATIONS FOR SOIL EROSION AND
- SEDIMENT CONTROL. 3) Following initial soil disturbance or redisturbance, permanent or temporary stabilization shall be completed within: a) 7 calendar days for all perimeter sediment control structures, dikes, perimeter slopes and all slopes greater than 3:1, b) 14 days as to all other disturbed or graded areas on the project site.
- 4) All sediment traps/basins shown must be fenced and warning signs posted around their perimeter in accordance with Vol. 1, Chaper 12, of the HOWARD COUNTY DESIGN MANUAL, Storm
- 5) All disturbed areas must be stabilized within the time period specified above in accordance with the 1983 MARYLAND STANDARDS AND SPECIFICATIONS FOR SOIL EROSION AND SEDIMENT CONTROL for permanent seedings (Sec. 51) sod (Sec. 54), temporary seeding (Sec. 50) and mulching (Sec. 52.) Temporary stabilization with mulch alone can only be done when recommended seeding dates do not allow for proper germination and estab-
- 6) All sediment control structures are to remain in place and are to be maintained in operative condition until permission for their removal has been obtained from the Howard County Sediment Control Inspector
- 7) Site Analysis: Total Area of Site 5.154 Acres Area to be vecesarily and a second se Area to be roofed or paved 3.0 Acres
 Area to be vegetatively stabilized 1.8 Acres Total Cut Total Fill Offsite waste/borrow area location
- 8) Any sediment control practice which is disturbed by grading activity for placement of utilities must be repaired on the same day of disturbance.
- 9) Additional sediment controls must be provided, if deemed necessary by the Howard County DPW sediment control inspector
- 10) On all sites with disturbed areas in excess of 2 acres, approval of the inspection agency shall be requested upon completion of installation of perimeter erosion and sediment controls, but before proceeding with any other earth disturbance or grading. Other building or grading inspection approvals may not be authorized until this initial approval by the inspection agency is made.

PERMANENT SEEDING NOTES

Apply to graded or cleared areas not subject to immediate further disturbance where a permanent long-lived vegetative cover is needed.

Seedbed Preparation: Loosen upper three inches of soil by raking, discing or other acceptable means before seeding, if not previously loosened.

- Soil Amendments: In lieu of soil test recommendations, use one of the following schedules: 1) Preferred -- Apply 2 tons per acre dolomitic limestone (92 lbs/1000 square ft) and 600 lbs per acre 10-10-10 fertilizer (14 lbs/1000 sq ft) before seeding. Harrow or disc into upper three inches of soil. At time of seeding, apply 400 lbs per acre 30-0-0 ureaform fertilizer (9 lbs/1000 sq ft).
- 2) Acceptable -- Apply 2 tons per acre dolomitic limestone (92 lbs/1000 sq ft) and 1000 lbs per acre 10-10-10 fertilizer (23 lbs/1000 sq ft) before seeding. Harrow or disc into upper three inches of soil.

Seeding - For the periods March 1 thru April 30, and August 1 thru October 15, seed with 60 lbs per acre (1.4 lbs/1000 sq ft) of Kentucky 31 Tall Fescue. For the period May 1 thru July 31, seed with 60 lbs Kentucky 31 Tall Fescue per acre and 2 lbs per acre (.05 1bs/1000 sq ft) of weeping lovegrass. During the period of October 16 thru February 28, protect site by: Option (1) 2 tons per acre of well anchored straw mulch and seed as soon as possible in the spring. Option (2) Use sod. Option (3) Seed with 60 lbs/acre Kentucky 31 Tall Fescue and mulch with 2 tons/acre well anchored straw.

Mulching -- Apply 1½ to 2 tons per acre (70 to 90 lbs/1000 sq ft) of unrotted small grain straw immediately after seeding. Anchor mulch immediately after application using mulch anchoring tool or 218 gallons per acre (5 gal/1000 sq ft) of emulsified asphalt on flat areas. On slopes 8 feet or higher, use 348 gallons per acre (8 gal/1000 sq ft) for anchoring. Maintenance -- Inspect all seeded areas and make needed repairs, replacements and

TEMPORARY SEEDING NOTES


Apply to graded or cleared areas likely to be redisturbed where a short-term vegetative


Seedbed Preparation: Loosen upper three inches of soil by raking, discing or other acceptable means before seeding, if not previously bosened.


Soil Amendments: Apply 60 lbs per acre 10-10-10 fertilizer (14 lbs/1000 sq ft). Seeding: For periods March 1 thru April 30 and from August 15 thru Novermber 15. seed with $2\frac{1}{2}$ bushel per acre of annual rye (3.2 lbs/1000 sq ft). For the period May 1 thru August 14, seed with 3 lbs per acre of weeping lovegrass (.07 lbs/1000 sq ft). For the period November 16 thru February 28, protect site by applying 2 tons per acre of well anchored straw mulch and seed as soon as possible in the spring, or use sod.

Mulching: Apply $1\frac{1}{2}$ to 2 tons per acre (70 to 90 lbs/1000 sq ft) of unrotted small grain straw immediately after seeding. Anchor mulch immediately after application using mulch anchoring tool or 218 gal per acre (5 gal/1000 sq ft) of emulsified asphalt on flat areas. On slopes 8 ft or higher, use 348 gal per acre (8 gal/1000 sq ft) for anchoring.

Refer to the 1983 MARYLAND STANDARDS AND SPECIFICATIONS FOR SOIL EROSION AND SEDIMENT CONTROL for rate and methods not covered.

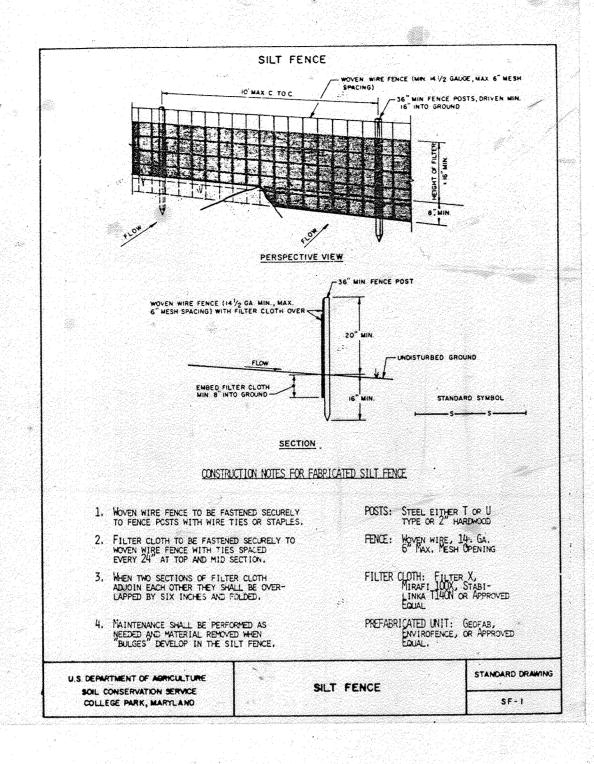

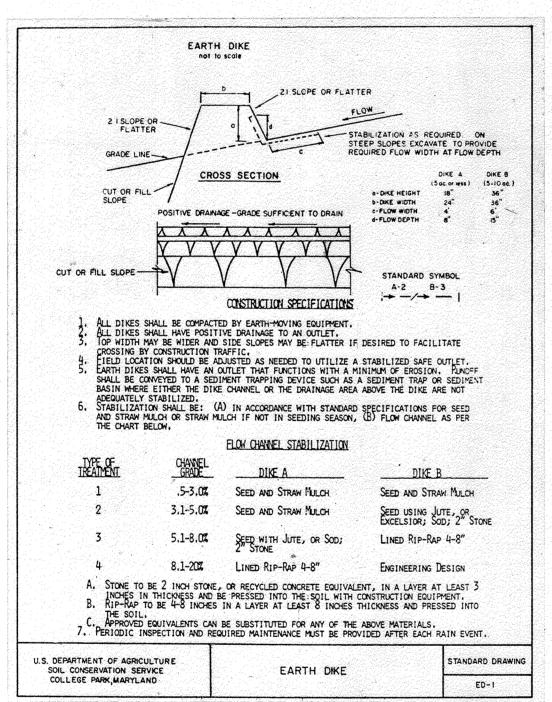

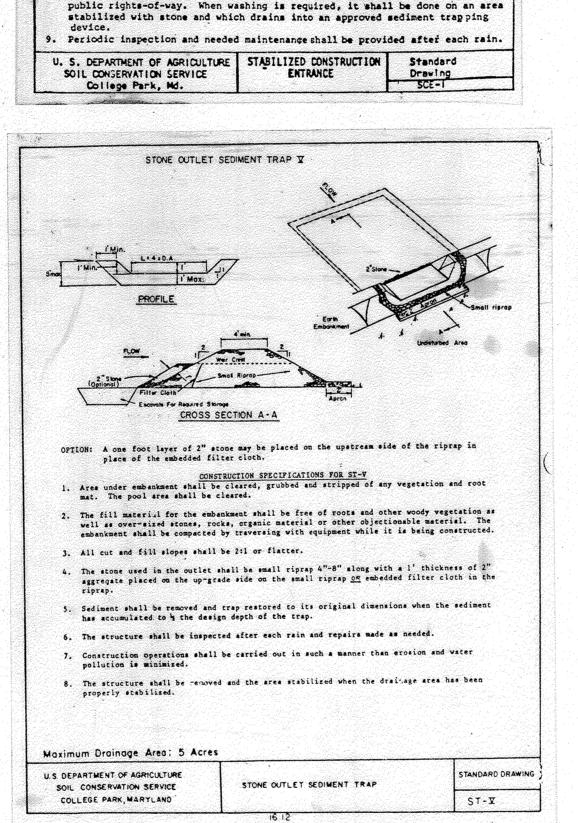

SARY".

STABILIZED CONSTRUCTION ENTRANCE

EXISTING PAVEMENT

not to scale

PROFILE

PLAN VIEW

CONSTRUCTION SPECIFICATIONS

dence lot where a 30 foot minimum length would apply).

a mountable berm with 5:1 slopes will be permitted.

Thickness - Not less than six (6) inches,

points where ingress or egress occurs.

1. Stone Size - Use 2" stone, or reclaimed or recycled concrete equivalent.

Width - Ten (10) foot minimum, but not less than the full width a

Pilter will not be required on a single family residence lot.

Length - As required, but not less than 50 feet (except on a single resi-

Filter Cloth - Will be placed over the entire area prior to placing of stone

Surface Water - All surface water flowing or diverted toward construction

entrances shall be piped across the entrance. If piping is impractical,

Maintenance - The entrance shall be maintained in a condition which will

require periodic top dressing with additional stone as conditions demand

and repair and/or cleanout of any measures used to trap sediment. All

prevent tracking or flowing of sediment onto public rights-of-way. This may

sediment spilled, dropped, washed or tracked onto public rights-of-way mus

Washing - Wheels shall be cleaned to remove sediment prior to entrance onto


STANDARD SYMBOL

SEQUENCE OF CONSTRUCTION

- I. OBTAIN REQUIRED PERMITS.
- 2. CLEAR AND GRUB FOR SEDIMENT CONTROLS.
- 3. INSTALL SEDIMENT CONTROLS
- 4 GRADE SITE AND STABILIZE AS PER SEDIMENT CONTROL NOTE NO. 3, THIS SHEET.
- 5. CONSTRUCT BUILDING. PARKING AND UTILITIES.
- 6. SEED AND MULCH EXPOSED AREAS WITH PERMANENT SEEDING.
- 7. ONCE SITE IS STABLE AND WITH THE APPROVAL OF THE SEDIMENT CONTROL INSPECTOR
 - a. REMOVE ACCUMULATED SEDIMENT FROM SEDIMENT CONTROLS AND DISPOSE OF AS DIRECTED BY THE SEDIMENT CONTROL INSPECTOR.
 - b. REMOVE SEDIMENT CONTROLS
 - c. FINAL GRADING WHERE NECESSARY.
 - d. SEED AND MULCH AREAS DISTURBED BY SEDIMENT CONTROLS WITH PERM-ANENT SEEDING.

APPROVED DIVISION of COMMUNITY PLANNING & LAND DEVELOPMEN HOWARD COUNTY,

MARYLAND

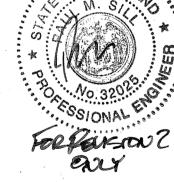

DATE 8-27-87 DEVELOPER 1 1340 SMITH AVENUE, SUITE 200

UNIVERSITY OF MARYLAND MEDICAL SYSTEM 7000 COLUMBIA GATEWAY DRIVE COLUMBIA, MD. 21046

1 UPDATED OWNER DEVELOPER Date Description

usions

Architects/Planners

2120 North Charles Street Baltimore: Maryland 21218

THIS DEVELOPMENT PLAN IS APPROVED FOR SOIL EROSION AND SEDIMENT CON-TROL BY THE HOWARD SOIL CONSER-VATION DISTRICT

TECHNICAL REQUIREMENTA

CONTROL DETAILS

SEDIMENT

)rawing No.

HOWARD COUNTY PARCEL S-2

CERTIFICATION BY THE DEVELOPER

"I/WE CERTIFY THAT ALL DEVELOPMENT AND CON-STRUCTION WILL BE DONE ACCORDING TO THIS PLAN OF DEVELOPMENT AND PLAN FOR EROSION AND SEDIMENT CONTROL AND THAT ALL RESPONSIBLE PERSONNEL IN-VOLVED IN THE CONSTRUCTION PROJECT WILL HAVE A CERTIFICATE OF ATTENDANCE AT A DEPARTMENT OF NAT-URAL RESOURCES APPROVED TRAINING PROGRAM FOR THE CONTROL OF SEDIMENT AND EROSION BEFORE BEGINNING THE PROJECT. I ALSO AUTHORIZE PERIODIC ON-SITE INSPECTION BY THE HOWARD SOIL CONSERVATION DISTRICT OR THEIR AUTHORIZED AGENTS, AS ARE DEEMED NECES-

WHITMAN, REQUARDT

AND ASSOCIATES

ENGINEERS

2315 SAINT PAUL ST.

BALTIMORE, MARYLAND

21218

DATE SIGNATURE

ELECTION DISTRICT NO.6

TAX MAP NO. 43

CERTIFICATION BY THE ENGINEER

"I CERTIFY THAT THIS PLAN FOR EROS-

A PRACTICLE AND WORKABLE PLAN BASED

ON MY PERSONAL KNOWLEDGE OF THE SITE

CONDITIONS AND THAT IT WAS PREPARED IN

ION AND SEDIMENT CONTROL REPRESENTS

CIUMMS CG LLC

BALTIMORE, MARYLAND 21209

WALTER SERAFYN

445.461.5901

THE HOWARD SOL CONSERVATION DISTRICT"

ACCORDANCE WITH THE REQUIREMENTS OF

SITE DEVELOPMENT PLKN

UNIVERSITY OF MARYLAND MEDICAL SYSTEM

COLUMBIA, GATEWAY

COLUMBIA, MARYLAND

S. SOIL CONSERVATION SERVICE DATE

Scale as Shown

9/11/89

