2125
 359.98
 371.66

 1700
 359.98
 371.66

 1700
 360.19
 369.66

 2125
 360.19
 369.66

 2125
 361.39
 361.66

 1700
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 1700
 361.69
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 2125
 361.69
 361.66

 2125
 361.69
 361.36
 8611 8607 8603 8601 N522200 VICINITY MAP NOT TO SCALE HAYES RYAN L. 125 F. 569 EXISTING ZONING R.E.D. TO BE DEDICATED TO HOWARD CO. GENERAL NOTES

1) THE LAND INCLINE


DEPT. OF PARKS & REC. OPEN SPACE LOT 138 8) STREET TREES WILL BE PROVIDED IN ACCORDANCE WITH SECTION 16.131 OF THE HOWARD COUNTY SUBDIVISION REGULATIONS BY THE DEVELOPER.

(9) PARKING SPACES REQUIRED = 16 (10) PARKING SPACES PROVIDED = 19 (11) TOTAL AREA FOR EASEMENTS - HONE WITH IN LOT AREA (12) ALL W.H.C.s TO BE 3/4" (13) ALL DUAL SEWER HOUSE CONNECTONS TO BE 6" (15) UTILITY ALLOCATION NOTE, DEV. AGRMT. NO. 14-1842-D, 14-1701-0, EFF. 8/19/87, 9/14/87 (16) BUILDING AREA COVERAGE: LOT AREA = 15,300 BUILDING AREA = 5,700 Q (17) PROPOSED STRUCTURES WILL BE SINGLE FAMILY TOWNHOUSES. THESE LOTS ARE
NOT PART OF THIS
SUBMISSION. (19) ALL REFUSE CONTAINERS WILL BE A MIN. OF SCY. (R.C.) AS SHOWN ON PLAN (20) RECORDED PLATS 7509-7516 (DATED 12.03-87) (21) STORM WATER MANAGEMENT IS PROVIDED TO THIS PROJECT UNDER FINAL NUMBER \$5-185. SANITARY SEWER - EASEMENT N 521900 AREA TABULATION CHART TOTAL NO. OF LOTS / PARCELS TO BE RECORDED = 8

TOTAL AREA OF LOTS / PARCELS TO BE RECORDED = 15 300 P

TOTAL AREA OF ROADWAY TO BE RECORDED = N.A.

TOTAL AREA OF SUBDIVISION TO BE RECORDED = N.A. DENSITY TABULATION = 131 / 74.74= 1.75 U/AC. OPEN SPACE PART OF LOT 136 SECT./AREA LOTS 56-63 TO BE DEDICATED TO HOWARD SUBDIVISION NAME TOLLHOUSE COUNTY DEPARTMENT OF PARKS PLAT # or L/F BLOCK # ZONE TAX/ZONE MAP ELEC. DIST. CENSUS TR. 7509-7516 12418 R-ED 24 2 6025 AND RECREATION WATER CODE F.04 E 853600 DEVELOPERS/BUILDER'S CERTIFICATE WE CERTIFY THAT ALL DEVELOPMENT AND CONSTRUCTION WILL BE DONE ACCORDING TO THIS PLAN OF DEVELOPMENT AND PLAN FOR EROSION AND SEDIMENT CONTROL AND THAT ALL RESPONSIBLE PERSONS INVOLVED IN THE CONSTRUCTION PROJECT WILL HAVE A CERTIFICATE OF ATTENDANCE AT A DEPT. OF NATURAL RESOURCES APPROVED TRAINING PROGRAM FOR THE CONTROL OF SEDIMENT AND EROSION CONTROL BEFORE BEGINNING THE PROJECT. I ALSO AUTHORIZE PERIODIC ON—SITE INSPECTION BY THE HOWARD SOIL CONSERVATION DISTRICT OF THEIR AUTHORIZED AGENTS AS DEEMED. NECESSARY LOTS: LAND DESIGN ASSOCIATES 56 THRU 63 APPROVED FOR PUBLIC WATER AND PUBLIC SEWERAGE
SYSTEMS HOWARD COUNTY HEALTH DEPARTMENT
COUNTY HEALTH OFFICER 718 HIGHWOOD DRIVE LEGEND BALTIMORE, MD. 21212 301-323-6344 TOLLHOUSE DEEMED NECESSARY. 6/22/89 DEVELOPER BUILDER PARCEL NO. 1183-254 SIGNATURE OF SECTION 2 AREA THIS DEVELOPMENT PLAN IS APPROVED FOR SOIL EROSION AND SEDIMENT CHEF DIVISION OF COMMUNITY PLANNING AND LAND DEVELOPMENT CONTROL BY THE HOWARD SOIL CONSERVATION DISTRICT. SITE DEVELOPEMENT & SEDIMENT CONTROL SECOND ELECTION DISTRICT HOWARD COUNTY, MARYLAND APPROVED FOR PUBLIC WATER AND PUBLIC SEWAGE STORM DRAINAGE SYSTEMS AND PUBLIC ROADS HOWARD COUNTY DEPARTMENT OF PUBLIC WORKS ENGINEERS CERTIFICATE CERTIFY THAT THIS PLAN FOR EROSION AND SEDIMENT CONTROL REPRESENTS A PRACTICAL AND WORKABLE PLAN BASED ON MY PERSONAL KNOWLEDGE OF SITE CONDITIONS AND THAT IT WAS PREPARED IN ACCORDANCE WITH THE REQUIREMENTS 7/27/89 SCALE: 1"=30" DESIGNED: OF THE HOWARD SOIL CONSERVATION DISTRICT. FOR: GRAYSON HOMES INC. SHEE" 1 3 DRAWN. #9025 CHEYROLET URIVE Wieden & Redy UAIE 7-7-89 7.27.89 CHECKED: PLIN ELLICUIT TIY MD. 21043 CHIEF BUREAU OF ENGINEERING DATE 43 3200 DATE ENGINEER SDP-89-217

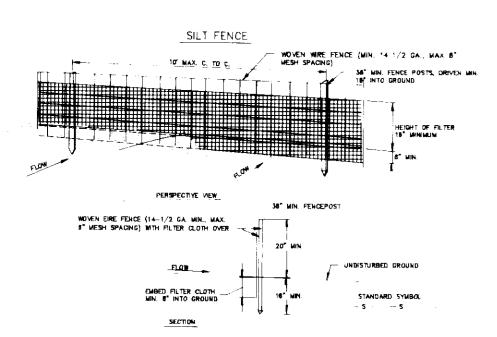

CONSTRUCTION NOTES FOR FARRICATED SULT FENCE

POSTS: STEEL EITHER T OR U TYPE OR 2" HARDWOOD FILTER CLOTH: FILTER X
NIRAFI 100X, STABLNKA T-140N OR APPROVED

SEDIMENT CONTROL NOTES

1) A minimum of 24 hours notice must be given to the Howard County Office of Inspections and Permits prior to the start of any construction (992-2437) 2) All vegetative and structural practices are to be installed according to the provisions of this plan-

and are to be in conformance with the 1983 MARYLAND STANDARDS AND SPECIFICATIONS FOR SOIL EROSION AND 3) Following initial soil dirturbance or redisturbance, permanent or temporary stabilization shall be completed within: a) 7 calendar days for all perimeter sediment control structures, dikes, perimeter slopes and all slopes greater than 3:1, b) 14 days as to all other disturbed or graded areas on the project site. 4) All sediment traps/basins shown must be fenced and warning signs posted around their perimeter in accordance with Vol. 1, Chapter 12, of the HOWARD COUNTY DESIGN MANUAL, Storm Drainage.

5) All disturbed areas must be stabilized within the time period specified above in accordance with the 1983 MARYLAND STANDARDS AND SPECIFICATIONS FOR SOIL EROSION AND SEDIMENT CONTROL for permanent seedings (Sec. 51), sod (Sec. 54), temporary seeding (Sec. 50) and mulching (sec. 52). Temporary stabilization with mulch alone can only be done when recommended seeding dates do not allow or proper permination and estabilishment of grasses. 6) All sediment control structures are to remain in place and are to be maintained in operation condition until permission for their removal has been obtained from the Howard County Sediment Control Inspector. 7) Site Analysis: Total Area of Site

Area Disturbed

Area to be roofed or paved

Area to be vegetatively stabilized

lotar rill Offsite waste/borrow area location Offsite waste/borrow area location NONE

8) Any sediment control practice which is disturbed by grading activity for placement of utilities, must be repaired on the same day of disturbance. 9) Additional sediment controls must be provided, if deemed necessary by the Howard County DPW sediment con-10)On all sites with disturbed areas in excess of 12 acres, approval of the inspection agency shall be requested upon completion of installation of perimeter erosion and sediment controls, but before proceeding with any other

earth disturbance or grading. Other building or grading inspection approvals may not be authorized until this initial approval by the inspection agency is made.

TEMPORARY SEEDING NOTES

acres


0.24 acres


A. SEEDBED PREPARATION — Loosen upper 3 inches of soil by discing, raking, or other acceptable means. IF NOT PREVIOUSLY LOOSENED B. SOIL AMENDMENTS - Apply 600 lbs.(15 lbs./1000 sq.ft.) of 10-20-10


thru November 15, seed with 2 1/2 bushels per acre (3.2 pounds/1000 sq.ft. of annual rye). For the period May 1 thru August 14 seed with 3 pounds per acre (0.07 lbs./1000 sq.ft.) with Weeping Lovegrass.


C. SEEDING — For periods March 1 thru April 30, and from August 15

D. MULCHING - Apply 1.5 to 2 tons per acre (70 to 90 pounds per 1000 sq.ft.) of unrotted small grain straw immediately after seeding. Anchor mulch immediately after application using 200 gallons per acre (5 gallons per 1000 sq.ft.) of emulsified asphalt on flat areas. On slopes 8 feet or higher use 348 gallons per acre (8 gallons per 1000

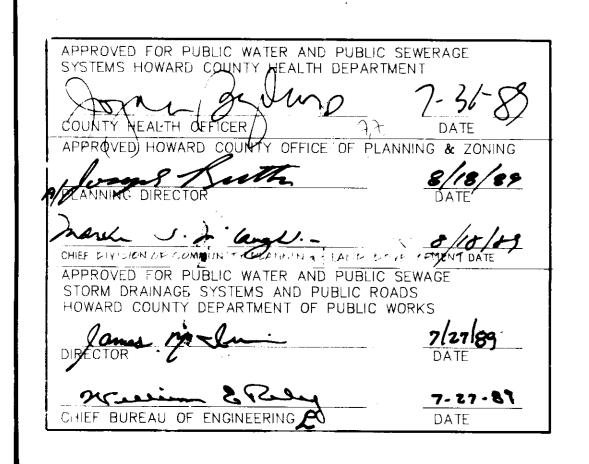

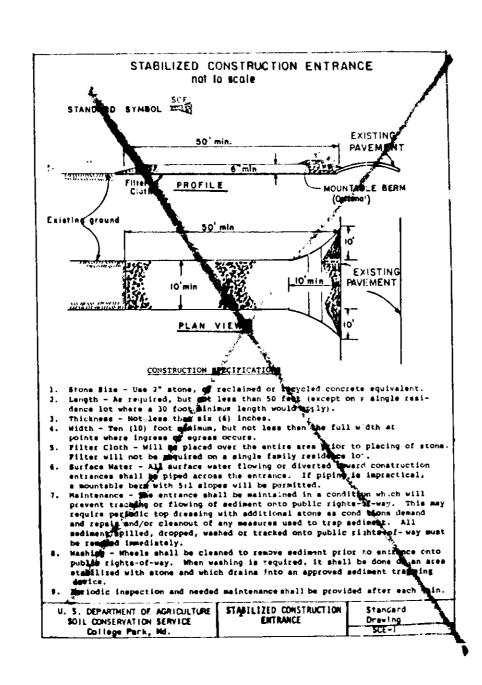

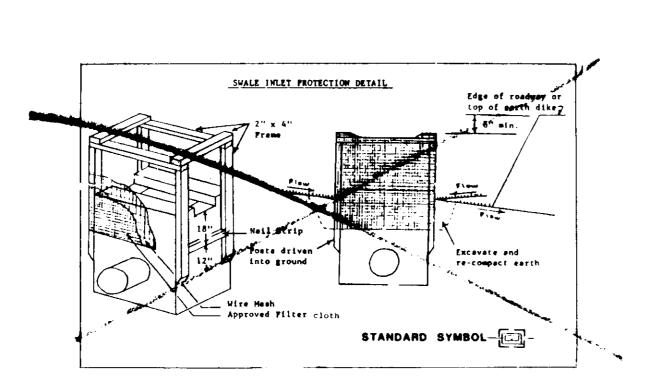

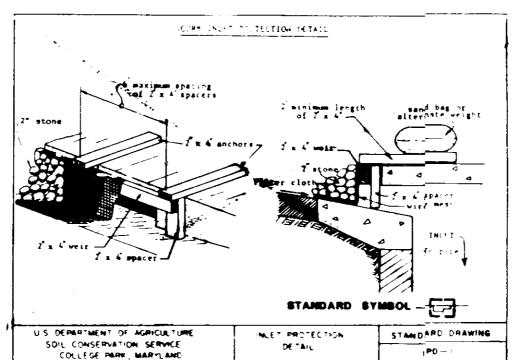

STORM INLET SEDIMENT TRAP ST-11

CROSS SECTIONS

manner that it will not grade.

6. All out slopes shall be 1 1 or tratter

Maximum Drainage Area: 3 Acres

CONSTRUCTION SPECIFICATION FOR ST-111

Sediment shall be removed and the trap restored to its disginal dimensions

when the segment has accumulated to give design reconstitute trap. Removed segment shall be deposited in a suitable area and in such a

The volume of sediment storage shall be 1811 outso feet on laure of

The structure shall be inspected after each rain and pepalis made as:

. Construction operations shall be carried out in survey as her that

The sectment trap shall be removed and the area start (1993 when the

STORM NUET

STORM NUET TRUBER STORMANS

erestin and water poliution shall be minimized.

constructed drainage area has been properly scattlinger

PERMANENT SEEDING NOTES

A. SEEDBED PREPARATION - Scarify or otherwise posen upper 5 inches of soil. Clods shall be broken up and the top three (3) inches of soil shall be worked into a satisfactory seedbed by raking, discing, or other acceptable means before seeding. F NOT PREVIOUSLY LOOSENED

B. SOIL AMENDMENTS — Apply 3 tons per acre dolomitic limestone (*38 lbs./1000 sq.ft.) and 600 lbs per acre 0-20-20 fertilizer (14 lbs./1000) sq. ft.). Harrow or disc lime and fertilizer into upper three inches of soil. At time of seeding, apply 400 lbs. per acre (99.2 lbs. 4000 sq.ft.) of 38-0-0 ureaform fertilizer and 500 lbs per acre (11.5) lbs./1000 sq.ft.) of 10-20-20 fertilizer.

C. SEEDING — Grass seed shall be certified seed only and should be delivered to the site with original state certification, or, in the case of a mixture, certified by the Maryland Department of Agriculture.

TURF GRASS MIXTURE 10 lbs/1,000 sq. ft. or 300 lbs/acre

% by Min % Minimum % Common Name Weight Purity Germination Tall Fescue (Rebel T5, Hound Dog, 90 Falcon No-78 or Shannon K5-27) Kentucky Blue Grass (Kenblue) D. MULCHING - Apply 1-1/2 to 2 tons per acre (70 to 90 lbs., 1000 sq.ft.) of unrotted small grain straw immediately after seeding. Apply mulch immediately after seeding. Anchor mulch immediately after

E. MAINTENANCE — Inspect all seeded areas and make needed repairs, replacements, and reseedings.

application using 348 gallons per acre (8 gallons/1000 sq.ft.) of

DEVELOPERS/BUILDER'S CERTIFICATE

emulsified asphalt.

I/WE CERTIFY THAT ALL DEVELOPMENT AND CONSTRUCTION WILL BE DONE ACCORDING TO THIS PLAN OF DEVELOPMENT AND PLAN FOR EROSION AND SEDIMENT CONTROL AND THAT ALL RESPONSIBLE PERSONS INVOLVED IN THE CONSTRUCTION PROJECT WILL HAVE A CERTIFICATE OF ATTENDANCE AT A DEPT. OF NATURAL RESOURCES APPROVED TRAINING PROGRAM FOR THE CONTROL OF SEDIMENT AND EROSION CONTROL BEFORE BEGINNING THE PROJECT. I ALSO AUTHORIZE PERIODIC ON—SITE INSPECTION BY THE HOWARD SOIL CONSERVATION DISTRICT OF THEIR AUTHORIZED AGENTS AS DEEMED VECESSARY.

ENGINEERS CERTIFICATE

CERTIFY THAT THIS PLAN FOR EROSION AND SEDIMENT CONTROL REPRESENTS A PRACTICAL AND WORKABLE PLAN BASED ON MY PERSONAL KNOWLEDGE OF SITE CONDITIONS AND THAT IT WAS PREPARED IN ACCORDANCE WITH THE REQUIREMENTS OF THE HOWARD SOIL CONSERVATION DISTRICT.

1/5/89 SCHATURE OF ENGINEER


i Sti⊋uctNorrige (14) +4 ° N

APPROVE

- HEEK A BYAN ARAC NA FERM T . The At we we set the "C S"AH" OF OPERATION. 3 2 THE SHOW IN THE PROPERTY OF THE SHOPES ON Y 1 3 JAA - 1 - 1 MAN IN THE MASSIME IN SESSIONATED AREAS.
- THE A NOTE OF MAN TO SEE MAN ASSESS 47 5 5-44 49 18 4 BALLE IN 15 5 TO 6 FICELAY OF WATCH IN A 15 GRADE ST.
- I THE SHAP MASTER AND THE AMERS MARSATERS E 12 B. 44 TH THE DESTABLE SHE AND SHOW THE APPROVAL OF THE INSPECTOR, PENSIF TENPOPER - SEL MENT SON THOS MEASURES AND CLEAR UP SITE. COTE: TRADING OF LOTS WAY NOT BEGIN INTIL ALLETORY DRAINS! GRAYEL STORAGE STRUCTURES ARE IN PLACE AND SLOPES BROUGHT TO FINISHED GRADE AND COMPLETELY STABLIZED.

THIS DEVELOPMENT PLAN S APPROVED FOR SOIL EMOSION AND SEDIMENT CONTROL BY THE HOWARD SOIL JCONSERVATION DISTRICT

TS TECHNICAL REQUIREMENTS.

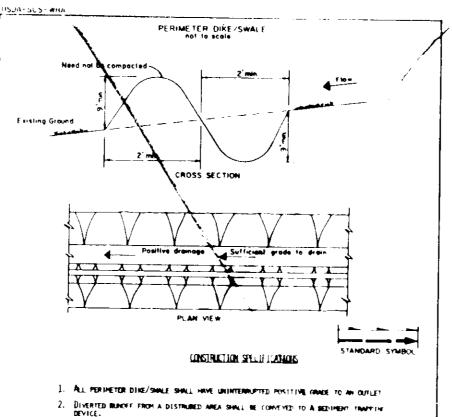


BLYERIED RUNCEF FROM AN UNDISTURBED AREA SMALL OUTLET INTO AN UNDISTURBED STABILIZED AREA AT MON-CANSION VELOCITY.

4. THE SHALE SHALL BE EXCAVATED OR SHAVED TO LINE, GRADE, MID CROSS SECUTION AS REQUIRED TO REET THE CRITERIA SPECIFIED IN THE STANDARD. STABILIZATION OF THE AREA DISTURBED BY THE DIRE AND SHALL BE DONE ON ACCOMBANCE WITH THE STANDARD AND SPECIFICATION FOR SEED AND STRAIN MALCH, BND SHALL BE DONE WITHIN 10 DAYS. 6. PERIODIC DISPECTION AND REQUIRED MAINTENANCE MUST BE PROVIDED AFTER EACH MAIR.

Mex. Drainege Area Limit: 2 Acres U.S. DEPARTMENT OF AGRICULTURE COLLEGE PARK, MARYLAND

NO PARKING FIRE LN-OW AWAY ZONE SIGN --

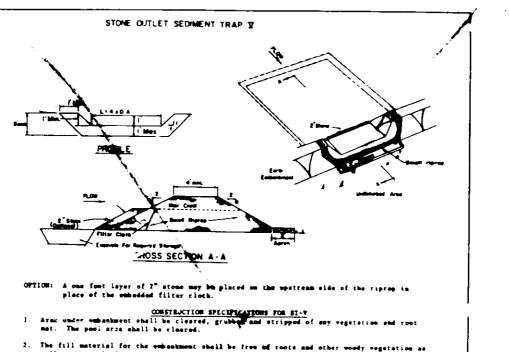


PDS-1

The fill material for the embankment shall be free of racts and other woody vegetation as well so over-sized stones, vocks, organic naterial or other objectionable naterial. The subantment shell be compacted by travarsing with equipment while it is being constructed.


- 3. All cut and fill slopes shall be 21% or flatter. . The stone used in the sutlet shall be small riprop 4"-8" along with a 1' thickness of 2"
- aggregate placed on the up-grade side on the small ripray on unbodded filter cloth in the ripray. Rediment shall be removed and trap restored to its original dimensions whom the sediment has accumulated to is the design depth of the trap.
- 6. The structure shall be imported after each rain and repairs made as moded.
- Construction operations shall be carried out in such a memoer than arceism and veter pollution is minimized. The structure-thali be removed and the area stabilized when the drainage area has been properly stabilized.

Maximum Drainage Area: 5 Acres U.S DEPARTMENT OF ABRICULTURE STONE OUTLET SEDMENT TRAP SOIL CONSERVATION SERVICE COLLEGE PARK, MARYLAND

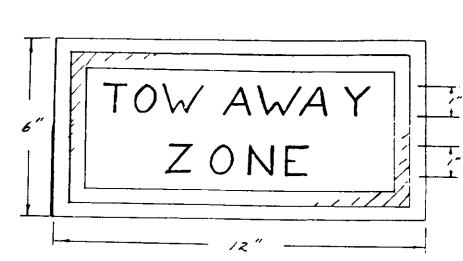

COLOR: RED LETTERS & BORDER ON WHITE RESISCTIVE BACK-RT-201- Designation in MANUAL ON UNIFORM

TRAFFIC CONTROL DEVICES

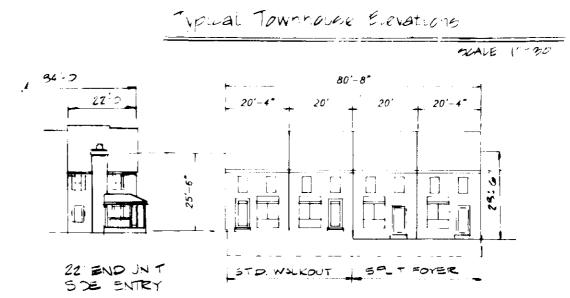

ST-W


FRONT ELEVATION

LAND DESIGN ASSOCIATES


BALTIMORE, MD 21212 301/323 4344

REVISIONS

718 HIGHWOOD DRIVE

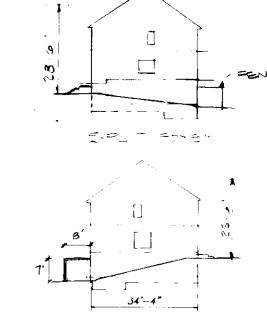

SIDE ELEVATION

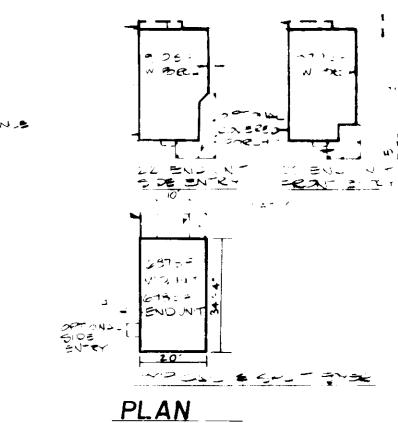


TOLL HOUSE PARCEL *1183-254 LOTS 56-63 SITE DEVELOPMENT & SEDIMENT CONTROL PLAN

SECOND ELECTION DISTRICT HOWARD COUNTY, MARYLAND

FOR: GRAYSON HOMES, INC. 9025 CHEVROLET DRIVE ELLICOTT CITY, MD 21043

DESIGNED K.L.W DRAWN P.S. CHECKED RUW.

SHEEL 2 F 3 DATE 7-7-89

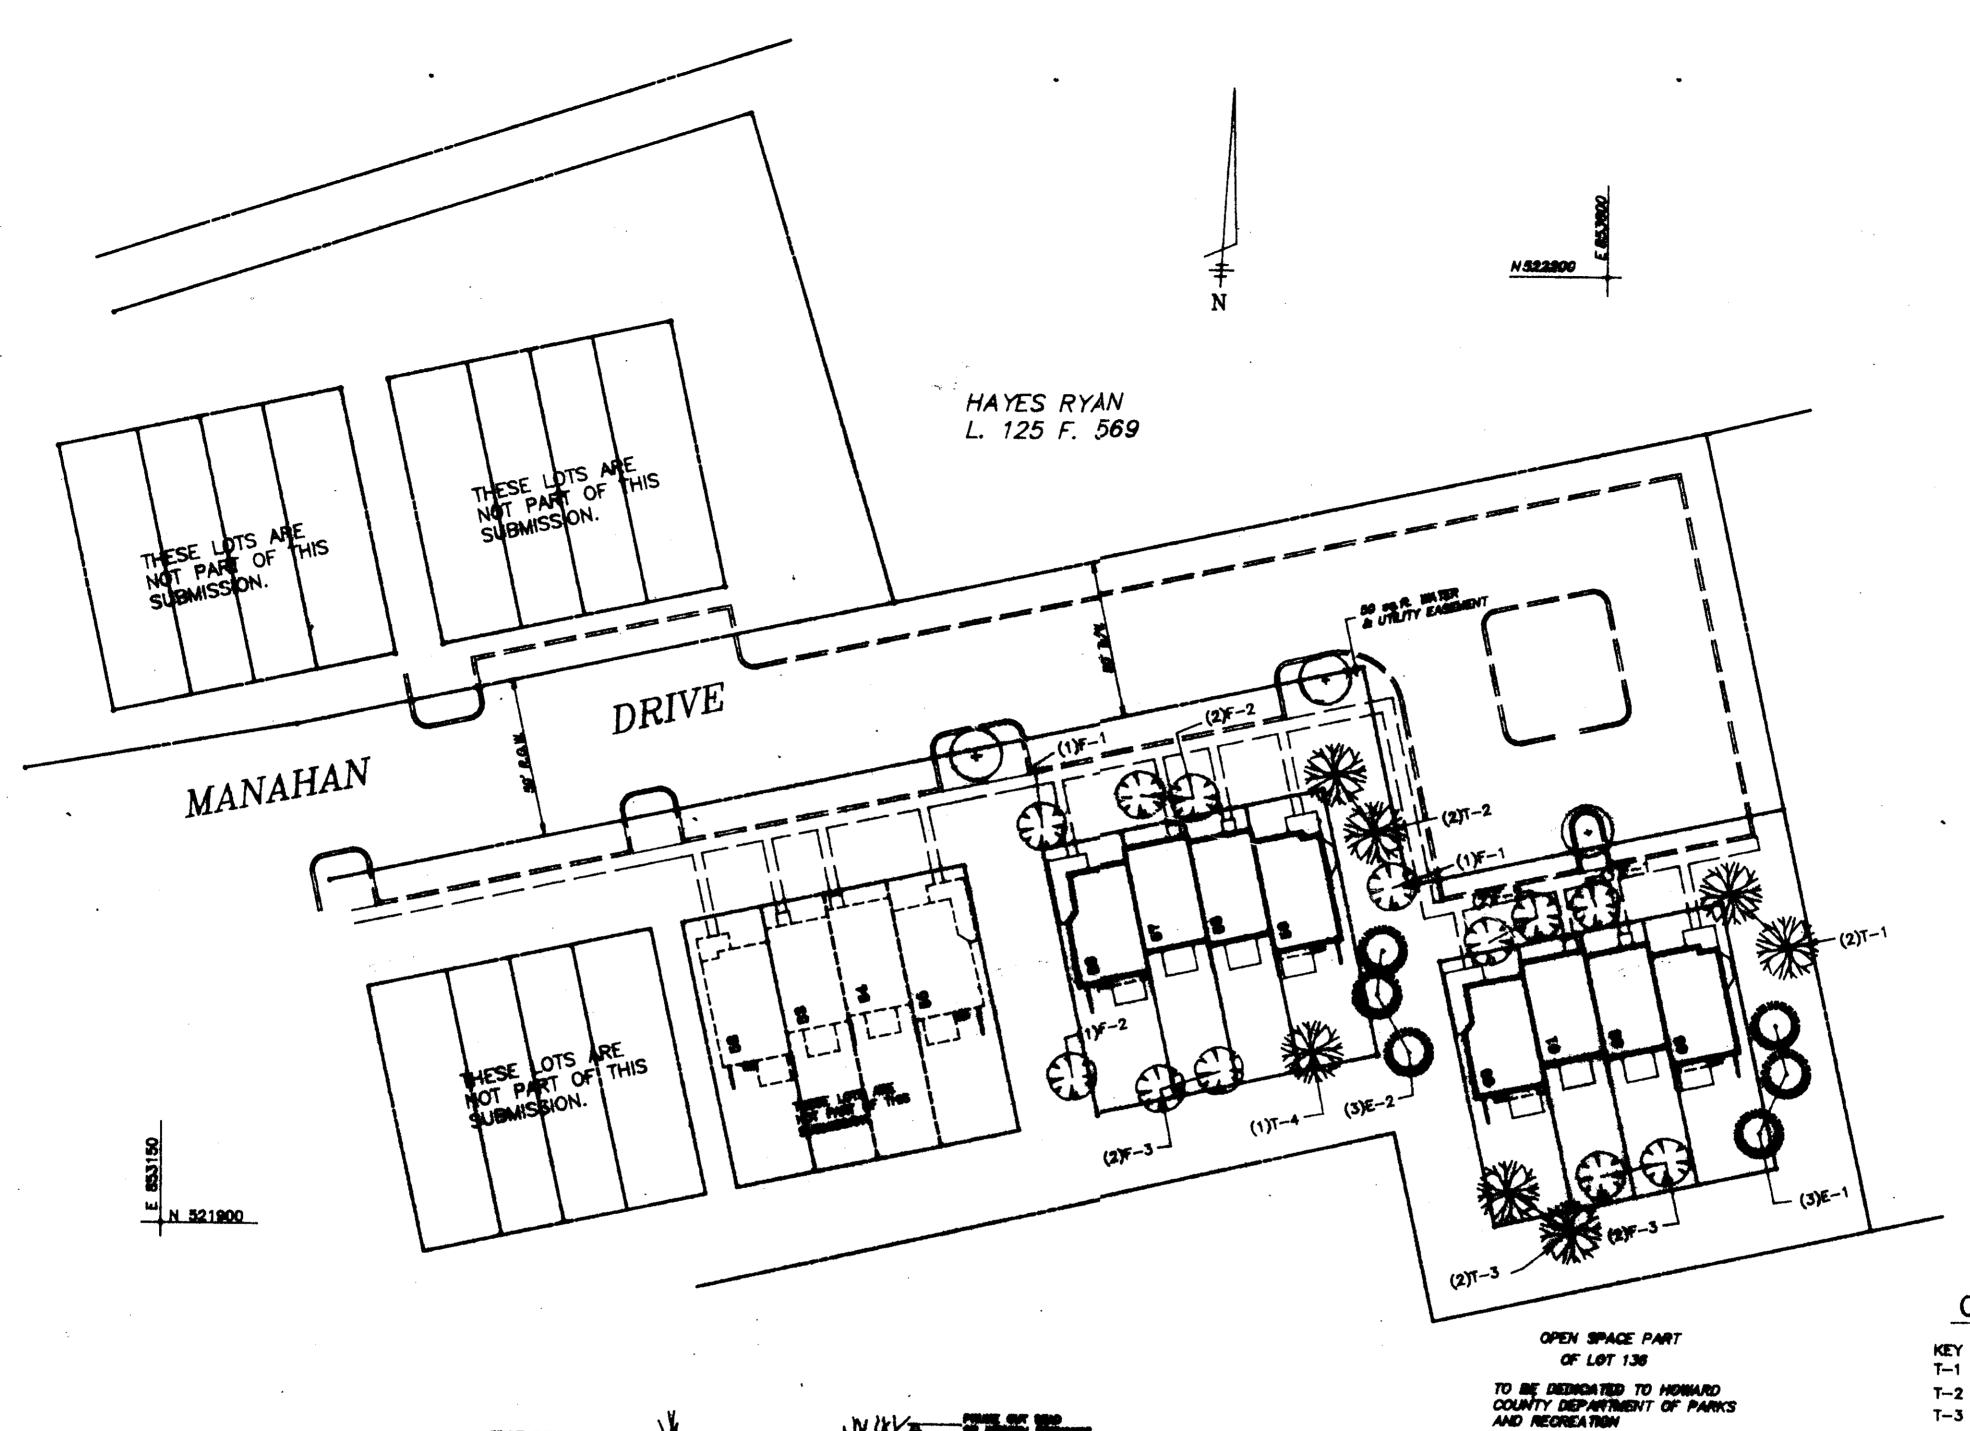

PLANT QUANTITIES

8 Units X 3 Trees Per Unit = 24 Trees Required
TREES PROVIDED

7 Major Decidious Tree 2 Flowering Trees 6 Evergreens

Total Trees Provided = 25

APPROVED FOR PUBLIC WATER AND PUBLIC SENERAGE
SYSTEMS LEDWARD COUNTY DEFICE OF PLANHING & ZONING

APPROVED HUMAND COUNTY DEFICE OF PLANHING & ZONING

APPROVED HUMAND COUNTY DEFICE OF PLANHING & ZONING

APPROVED FOR PUBLIC WATER AND PUBLIC SENERGE
STORM DRAWING SYSTEMS AND PUBLIC ROADS
HOWAND COUNTY DEPARTMENT OF PUBLIC WORKS

DATE

TO THE TOP OF THE PUBLIC WATER AND PUBLIC WORKS


APPROVED FOR PUBLIC WATER AND PUBLIC WORKS

DATE

TO THE TOP OF THE PUBLIC WATER AND PUBLIC WATER STORM DEPARTMENT OF PUBLIC WATER STORMS

TO THE TOP OF THE PUBLIC WATER STORMS

TO

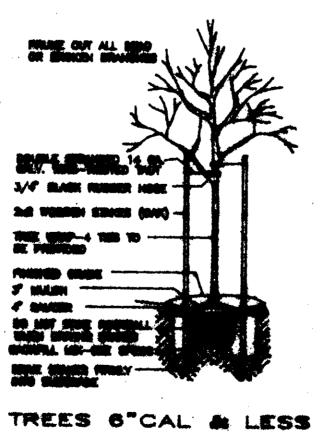

PLANTING DETAILS

SHRUBS

WILLIAM

WILLIAM

CONIFERS

CONIFERS

MAJOR DECIDIOUS TREE

FLOWERING TREE

EVERGREEN TREE

LEGEND

+ EMISTING STREET TREE

PLANTING DESIGN BY:

Peek/Smith, Inc.

Peek/Smith, Inc.

Cumulative Plant List

	QUAN.		COMMON NAME	SIZE	ROO
T-1	2	Acer rubrum "October Glory"	October Glory Red Maple	2.5-3°cal.	B&B
T-2	-	Pyrus calleryana "Bradfordii"	Bradford Pear	2.5-3"cci.	Вав
T-3	2	Querous phelios	Willow Oak	2.5-3"cal.	BAB
T-4	1	Tillia cordata "Greenspire"	Little Greenspire Linden	2.5-3°cai.	BAB
F-1	3	Cornus florida	Flowering Dogwood	1.5-2"cci.	BAB
F-2	5	Prunus sargenti	Sargent Cherry	1.5-2"cal.	BAB
F-3	4	Malus baccta	Siberian Crabapple	1.52"cai.	BAB
E-1	3	Picea pungens	Colorado Blue Spruce	6-7thght.	BAB
E-2	3	Pinus nigra	Austrian Pine	6-7'hght.	Bas

LAND DESIGN ASSOCIATES
718 HIGHWOOD DRIVE
BALTIMORE, MD. 21212 301-323-6344

LOTS: 56 THRU 63

TOLLHOUSE

SECTION 2 PARCEL NO. 1183-254
PLANTING PLAN

PLANTING PLAN
SECOND ELECTION DISTRICT
HOWARD COUNTY, MARYLAND

FOR: GRAYBON HOMES INC. 8005 CHEVROLET DRIVE ELLICOTT CITY MD. 21043 DESIGNED: GSR DRAWN: GSR CHECKED: ELP

SR SCALE: 1"=30' SR SHEET 3 OF 3 DATE: 6/7/80