



GENERAL NOTES

- A. PRIOR TO THE START OF ANY OPERATIONS, THE CONTRACTOR SHALL STAKE OUT THE BASELINES OF CONSTRUCTION, PROPOSED BUILDING AND VERIFY SETBACKS AND OFFSET DIMENSIONS.
- B. THE CONTRACTOR SHALL NOTIFY "MISS UTILITY" AT 1-800-257-7777 AT LEAST 72 HOURS PRIOR TO STARTING EXCAVATION TO VERIFY ALL LOCATIONS OF EXISTING UTILITIES.
- C. ADJUTING PROPERTIES TO BE PROTECTED FROM DAMAGE. REPAIRS ARE AN OBLIGATION OF THE CONTRACTOR. ACCESS TO AREAS OUTSIDE THE LIMIT OF CONTRACT WITHIN THE PROPERTY LINE IS PROHIBITED. THE CONTRACTOR SHALL BE LIABLE FOR ANY DAMAGE TO EXISTING VEGETATION AND ANY VIOLATIONS OF THE PROTECTED AREAS.
- D. ALL CONSTRUCTION SHALL BE ACCOMPLISHED IN ACCORDANCE WITH LATEST HOWARD COUNTY, DPW STANDARDS. SPECIFICATIONS AND REQUIREMENTS.
- E. THE INFORMATION SHOWN ON THESE PLANS IS FOR THE CONVENIENCE OF THOSE CONCERNED ONLY. THE CORRECTNESS OR COMPLETENESS OF THE INFORMATION SHOWN IS NOT WARRANTED OR GUARANTEED. THE CONTRACTOR SHALL VERIFY ALL INFORMATION TO HIS OWN SATISFACTION.
- F. THE LOCATIONS OF EXISTING UNDERGROUND UTILITIES ARE SHOWN IN AN APPROXIMATE WAY ONLY. THE CONTRACTOR SHALL DETERMINE THE EXACT LOCATION OF ALL EXISTING UTILITIES BEFORE COMMENCING WORK. HE AGREES TO BE FULLY RESPONSIBLE FOR ANY AND ALL DAMAGES WHICH MIGHT BE OCCASIONED BY HIS FAILURE TO EXACTLY LOCATE AND PRESERVE ANY AND ALL UNDERGROUND UTILITIES.
- G. ALL DISTURBED AREAS NOT STABILIZED WITH PAVING, BUILDING, SODDING OR MULCH IN PLANTING AREAS SHALL BE SEEDED AND MULCHED IN ACCORDANCE WITH THE SPECIFICATIONS AND SEDIMENT CONTROL PLAN, PRIOR TO CONTRACT COMPLETION.
- H. CONTRACTOR SHALL PROVIDE POSITIVE DRAINAGE AT ALL TIMES.
- I. TOPO SURVEY DONE BY FISHER COLLINS & CARTER DATED MAY 6, 1988.
- J. USE TOP ELEVATION OF EXISTING SANITARY MANHOLE AS BENCH MARK.

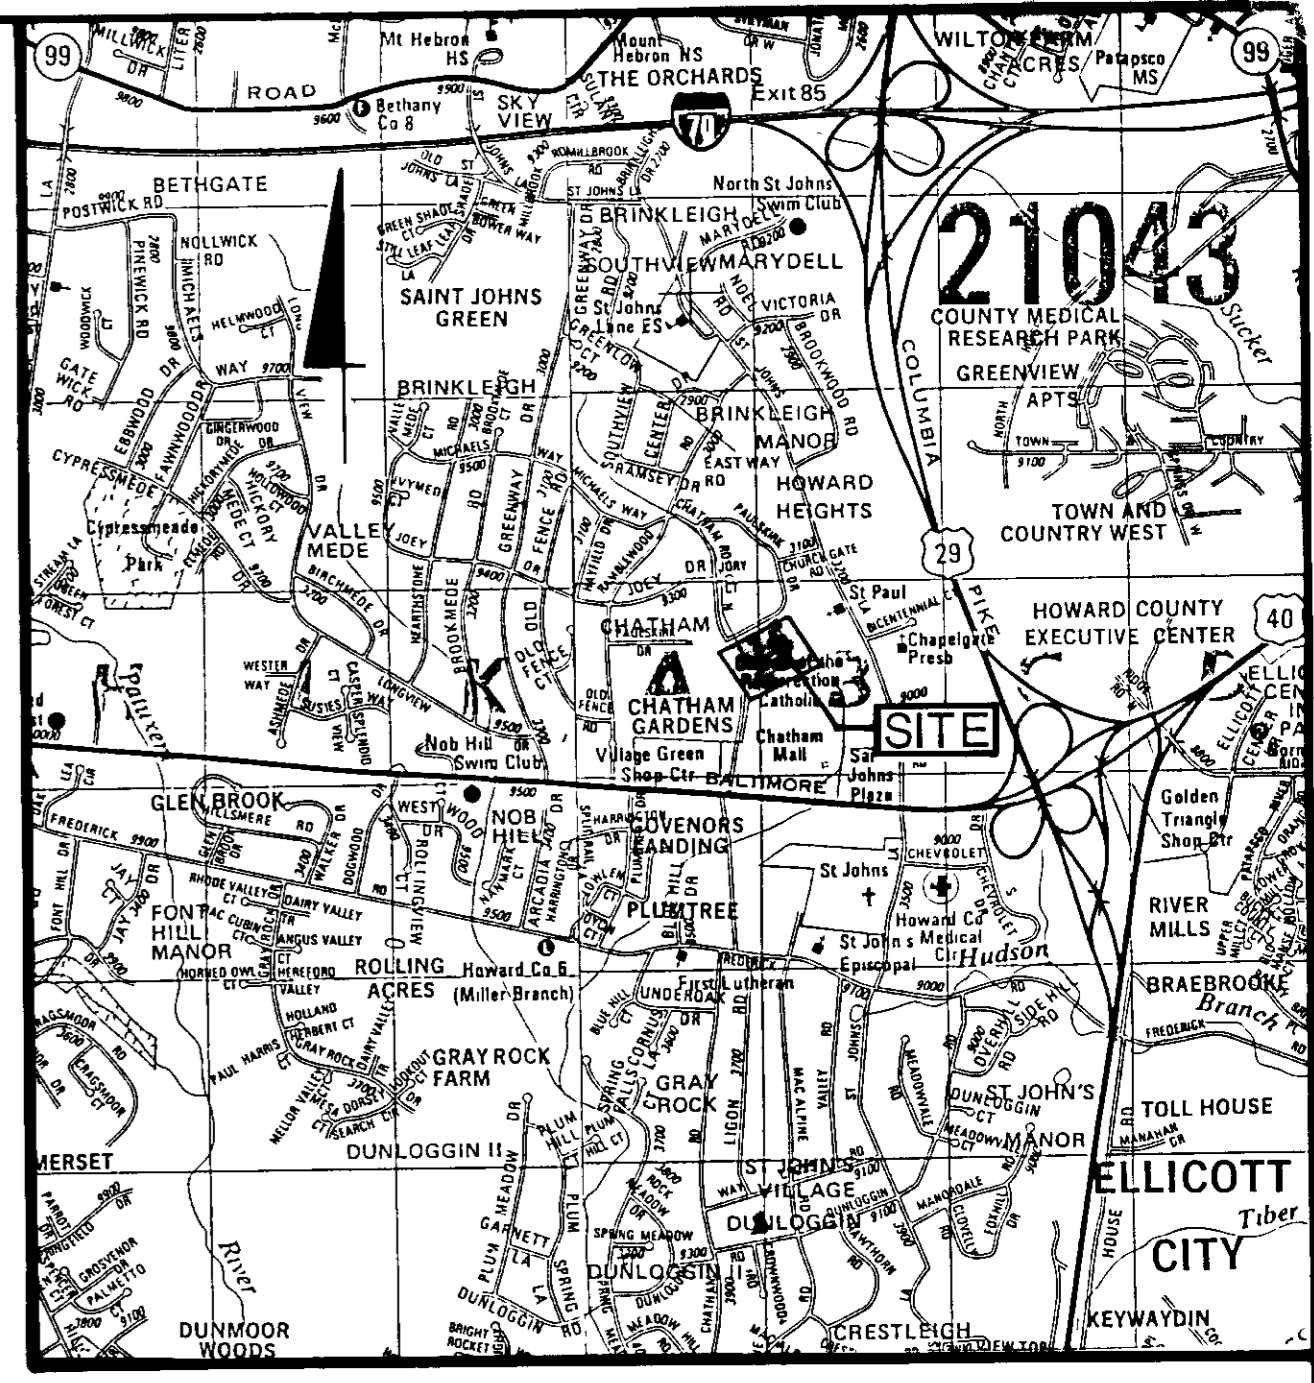

VICINITY MAP
SCALE: 1"=200'

- NOTES
- 1 SCHOOL ADDITION - TO INCREASE KINDERGARTEN PUPIL TO 40 PUPILS
 - 2 CHAPEL / OFFICE - TO ACCOMMODATE THE INCREASE IN RELIGIOUS ACTIVITIES

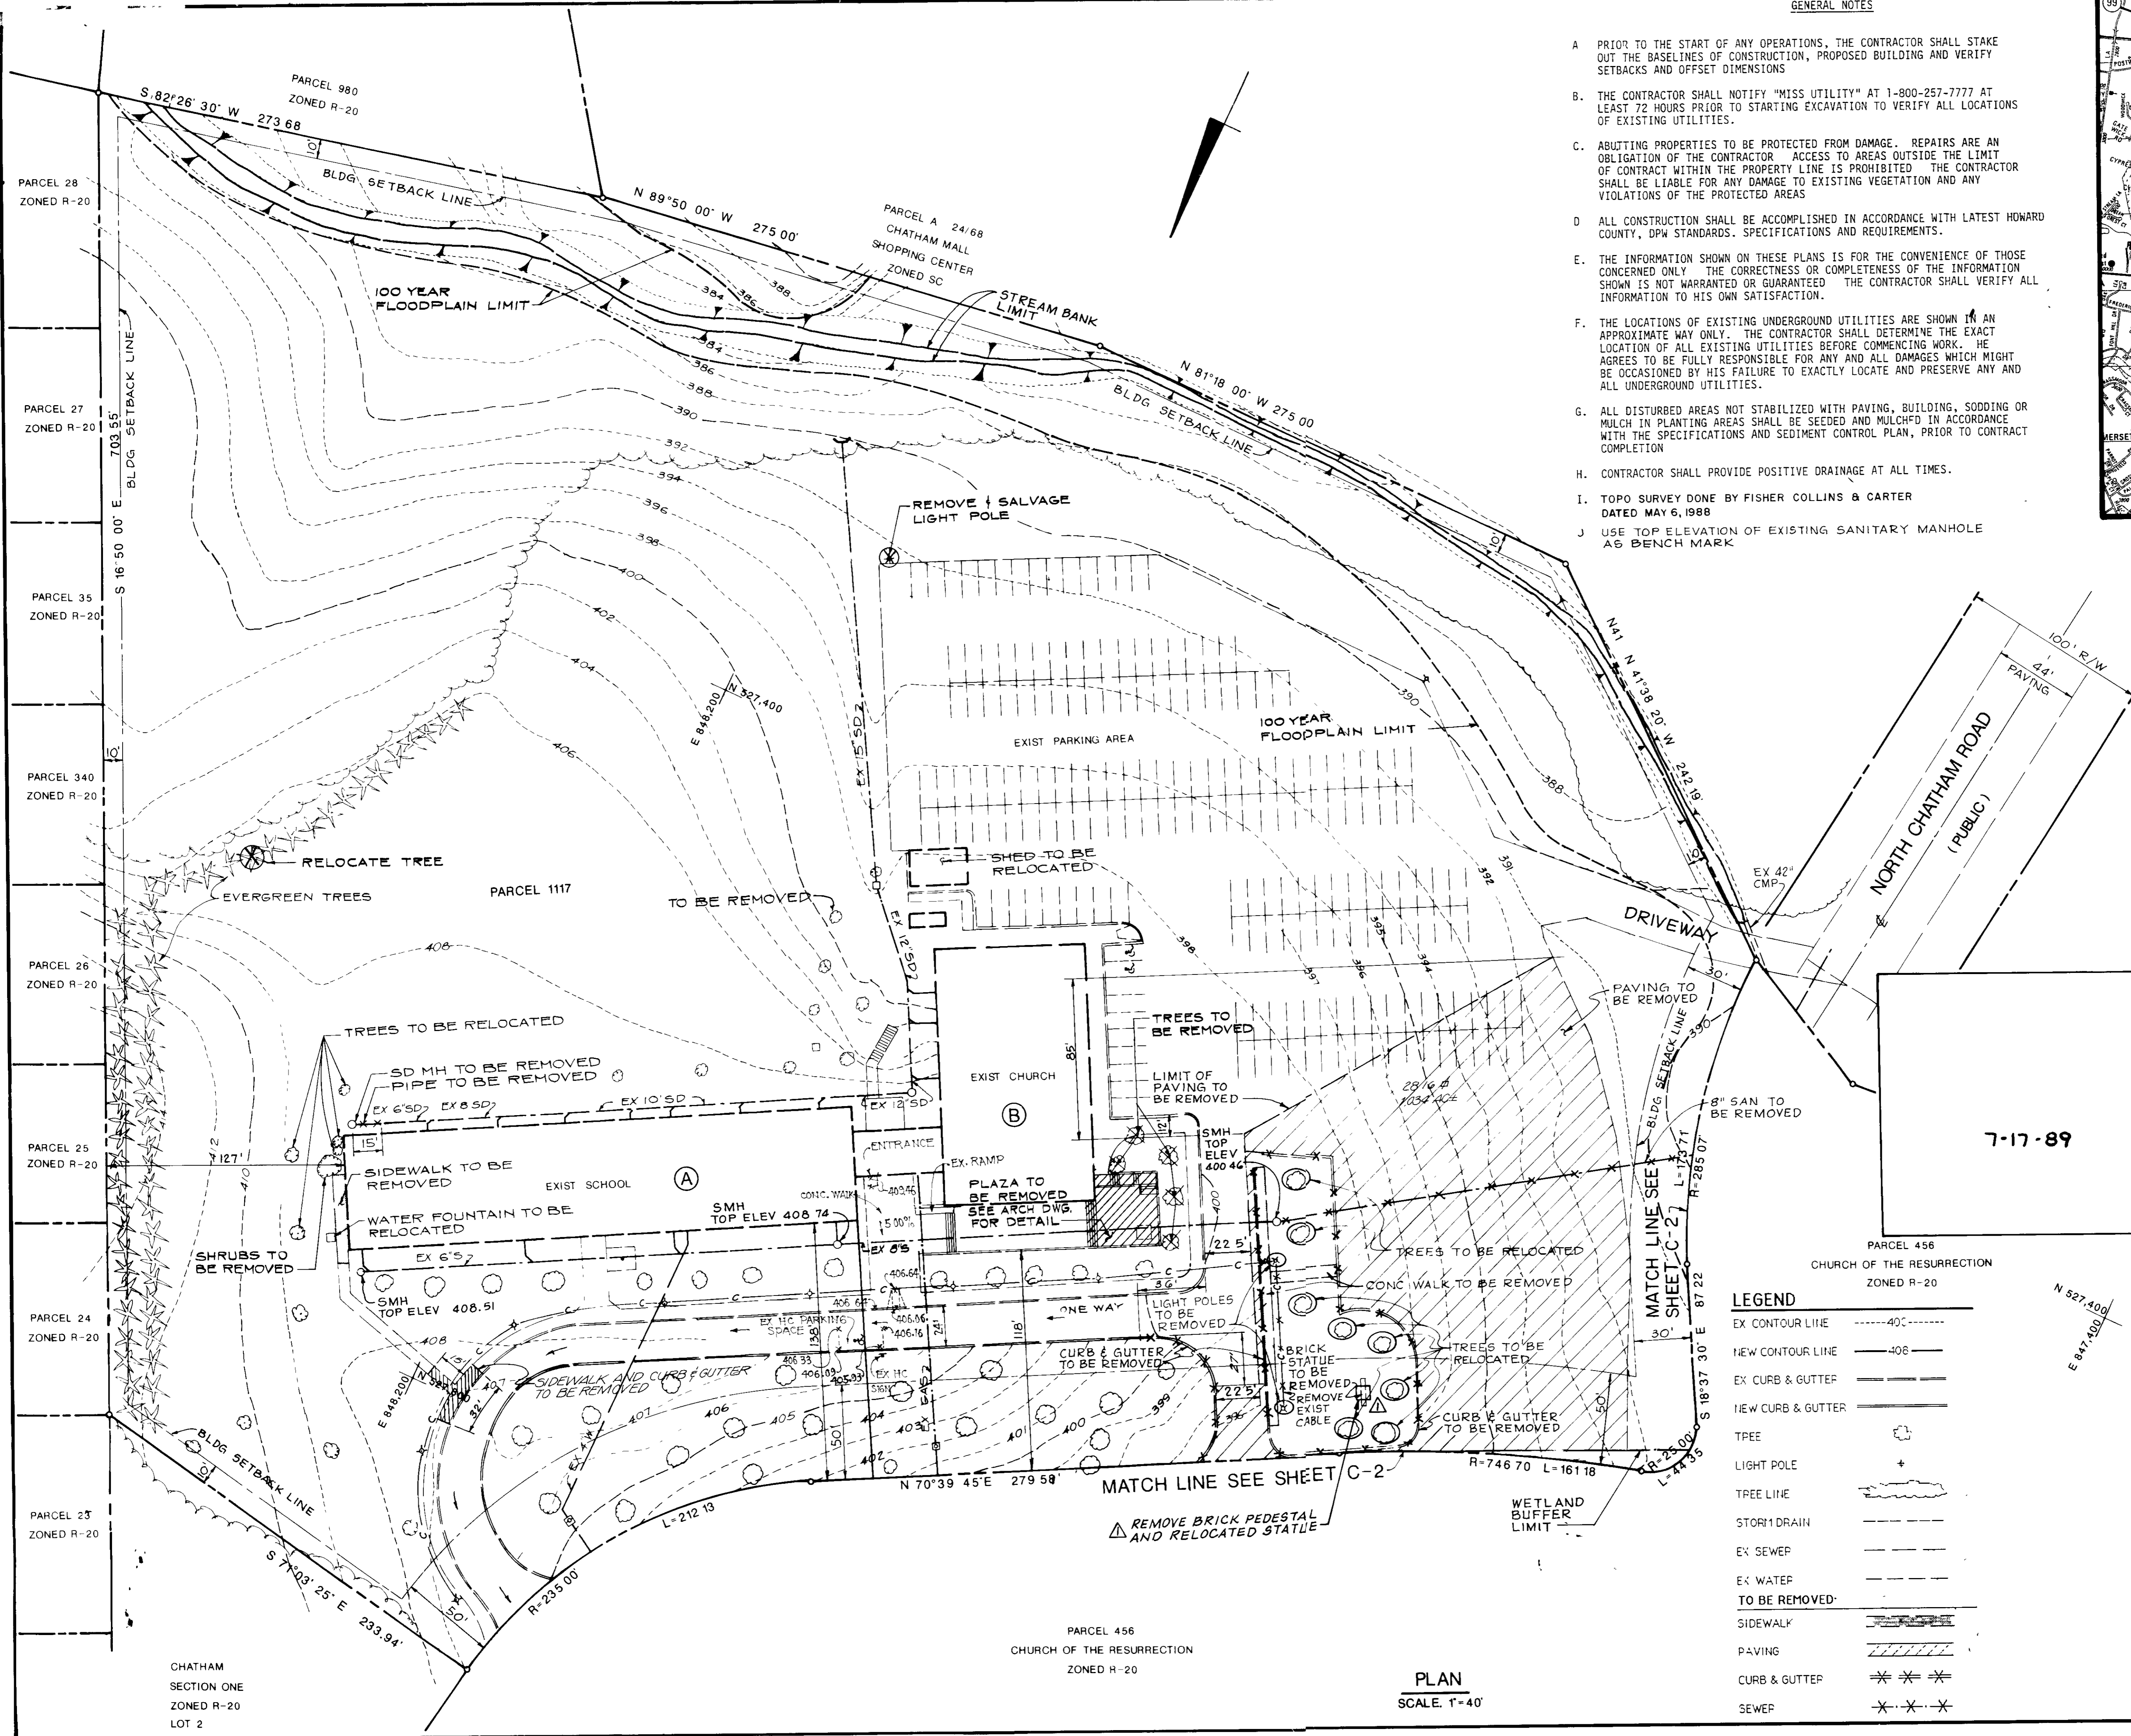

6/7/91		GENERAL REVISIONS (WBCM)	
DATE	NO	REVISION	
LOT NUMBER		ADDRESS CHART	
P 1117		3175 PAULSKIRK DR	
SUBDIVISION NAME		SECT/AREA	LOT
CHURCH OF THE RESURRECTION			P 1117
PLAT #	BLOCK#	ZONE	TAX/ZONE MAP
3476	5	R-20	24
WATER CODE		SEWER CODE	
FOG		1404800	

APPROVED FOR PUBLIC WATER AND SEWERAGE, STORM DRAINAGE SYSTEMS AND PUBLIC ROADS		
HOWARD COUNTY DEPARTMENT OF PUBLIC WORKS		
Director	<i>James H. ...</i>	11/22/89
DATE		
APPROVED FOR PUBLIC WATER AND PUBLIC SEWER SYSTEMS		
HOWARD COUNTY HEALTH DEPARTMENT		
Director	<i>James M. ...</i>	11/29/89
DATE		
APPROVED, HOWARD COUNTY DEPT. OF PLANNING AND ZONING		
Director		12/6/89
DATE		
APPROVED, DIVISION OF COMMUNITY PLANNING AND DEVELOPMENT		
Director		12/5/89
DATE		

OWNER CHURCH OF THE RESURRECTION
PAULSKIRK DRIVE & NORTH CHATHAM ROAD
ELLICOTT CITY, MARYLAND 21043
TEL. (301) 461-9111


PROJECT SCHOOL AND CHAPEL / OFFICE BUILDING ADDITIONS
CHURCH OF THE RESURRECTION
DEMOLITION PLAN

2ND ELECTION DISTRICT HOWARD COUNTY, MD.
TAX MAP NO 24 PARCEL 456, 1117 & 980
ENGINEERS. WHITNEY, BAILEY, COX & MAGNANI
CONSULTING ENGINEERS
1850 YORK ROAD
TIMONIUM, MD. 21093
(301) 252-6060

DESIGNED:	AR
DRAWN:	G,G
CHECKED:	P,D
DATE:	10/13/88
SCALE:	1" = 40'
DRAWING NO:	SHEET 1 OF 13
DATE:	10/21/88
	C-1

AS-BUILT SDP-89-76

PLAN
SCALE: 1"=40'

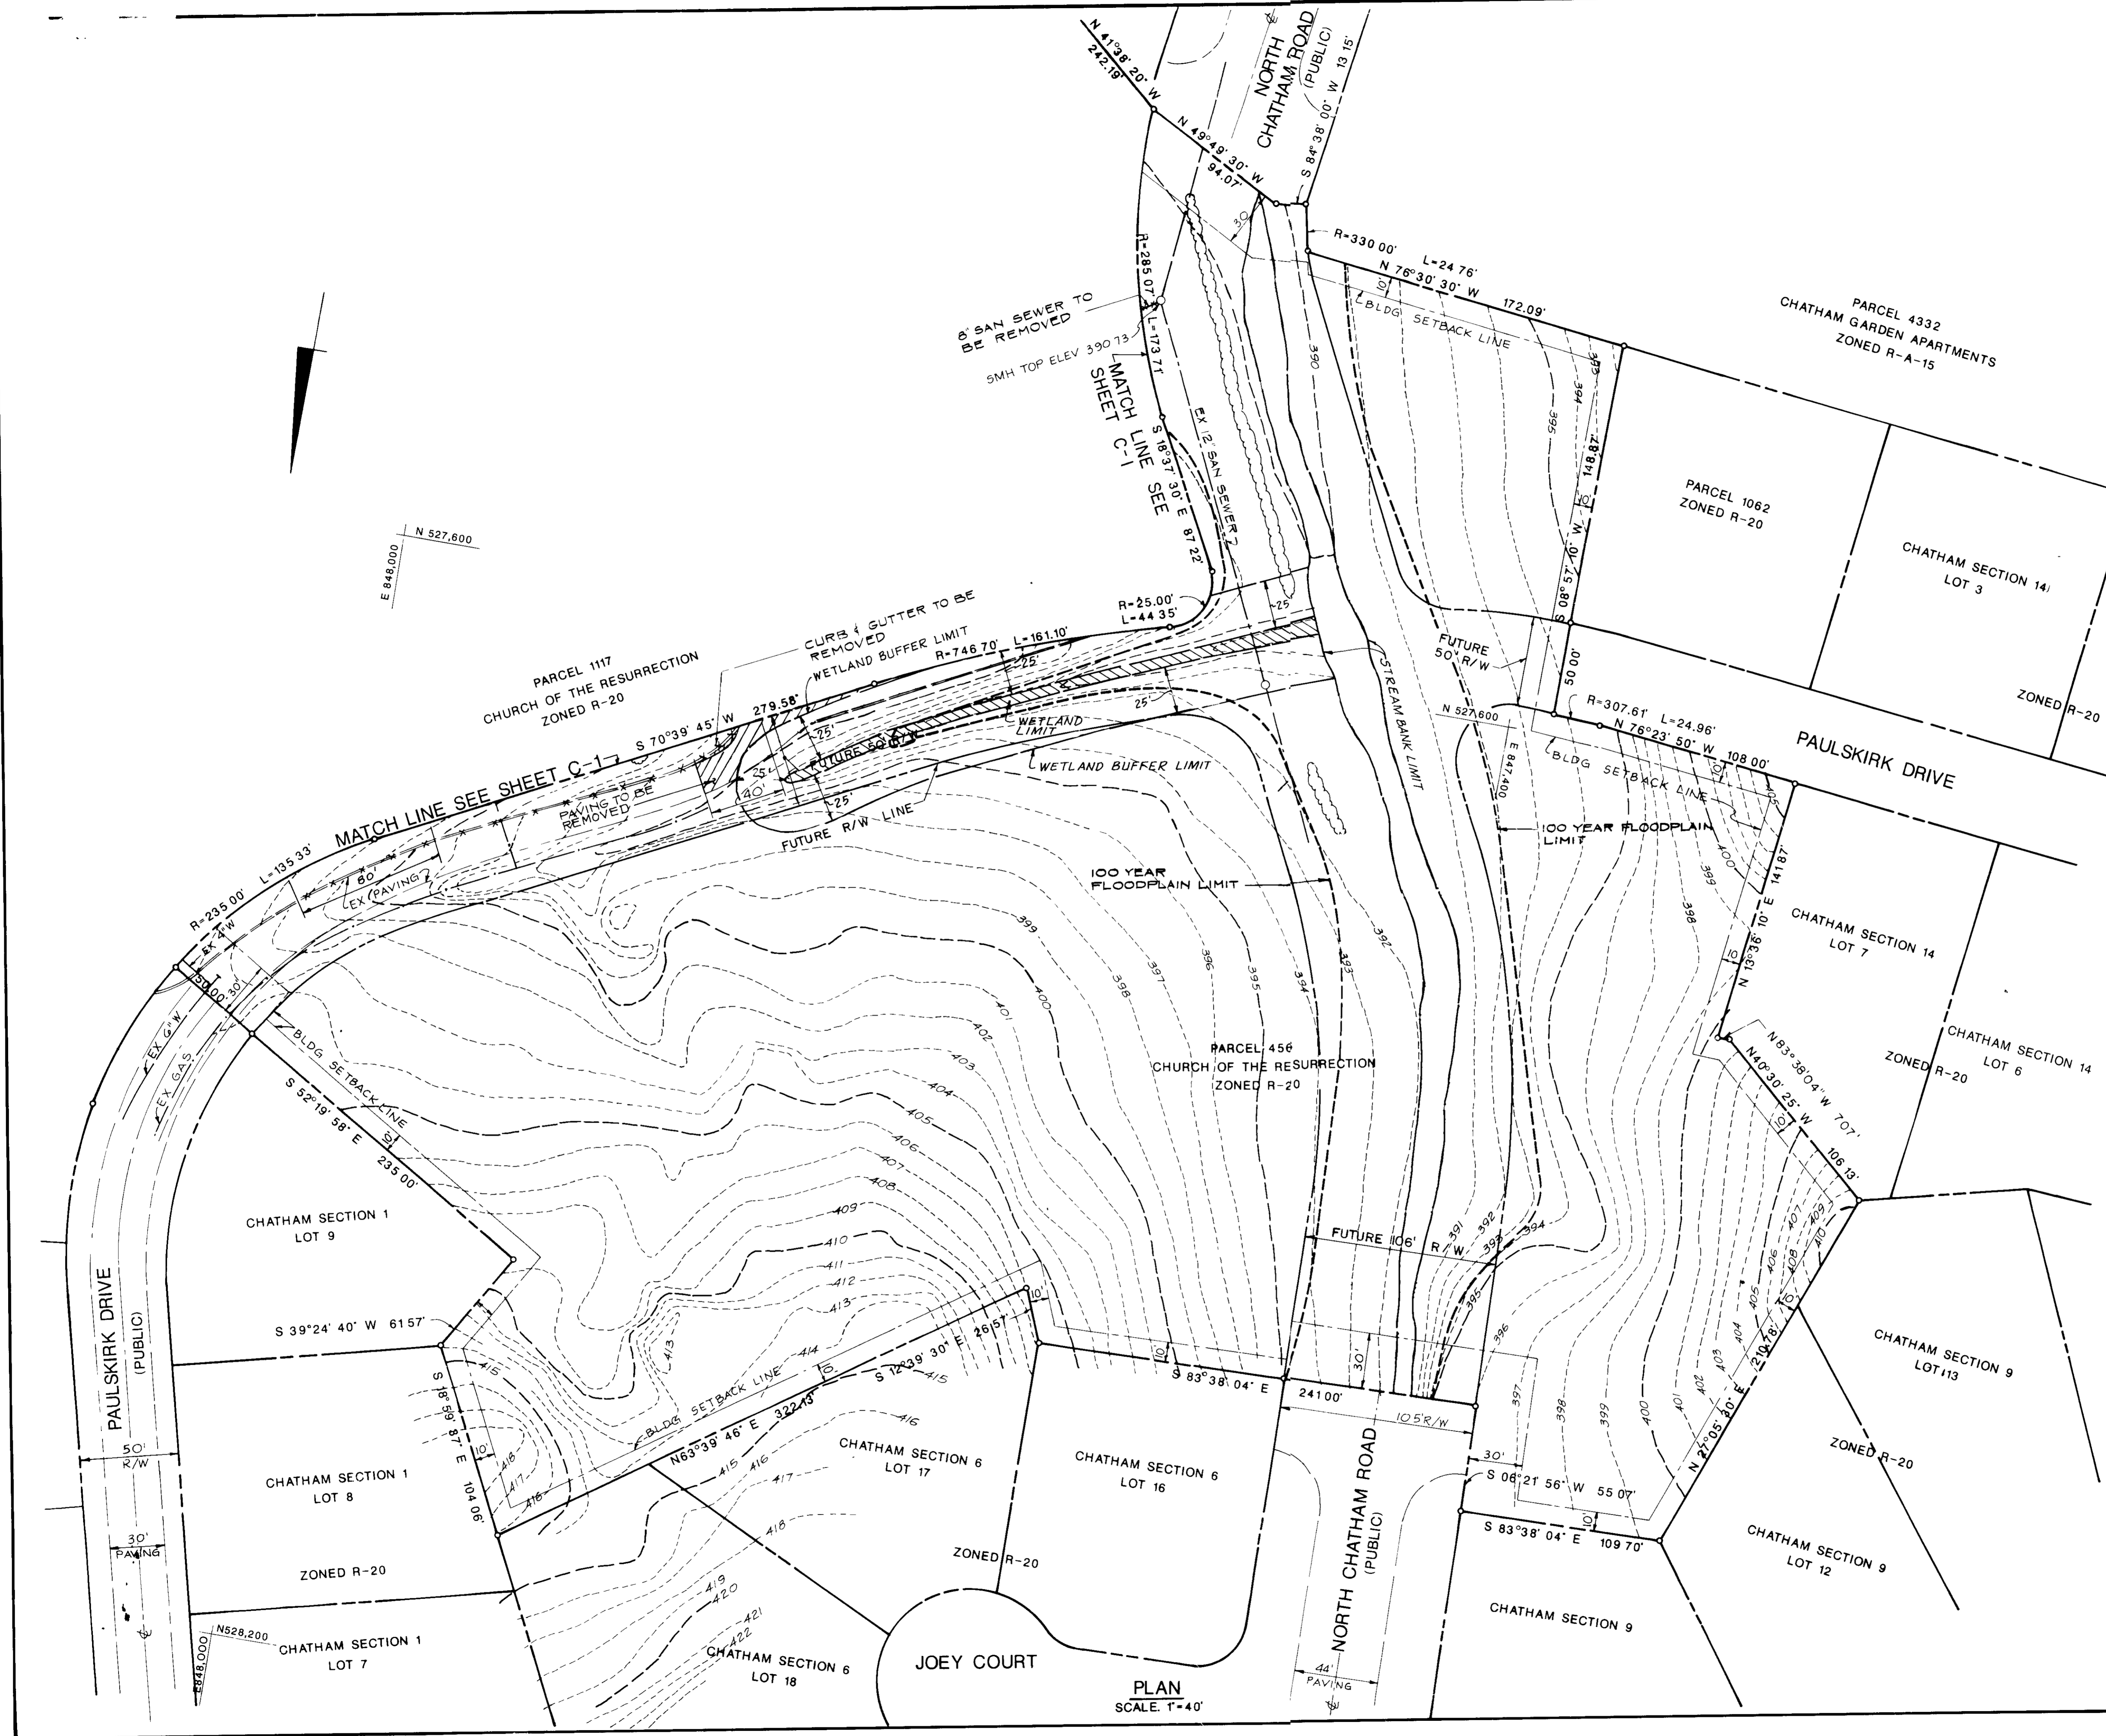

DATE	NO	REVISION
		APPROVED FOR PUBLIC WATER AND SEWERAGE, STORM DRAINAGE SYSTEMS AND PUBLIC ROADS HOWARD COUNTY DEPARTMENT OF PUBLIC WORKS
11/22/89		DIRECTOR
11/20/89		CHIEF, BUREAU OF ENGINEERING
11/29/89		APPROVED FOR PUBLIC WATER AND PUBLIC SEWER SYSTEMS HOWARD COUNTY HEALTH DEPARTMENT COUNTY HEALTH OFFICER
12/6/89		APPROVED HOWARD COUNTY DEPT. OF PLANNING AND ZONING DIRECTOR
12/6/89		CHIEF, DIVISION OF COMMUNITY PLANNING AND DEVELOPMENT
OWNER CHURCH OF THE RESURRECTION PAULSKIRK DRIVE & NORTH CHATHAM ROAD ELLCOTT CITY, MARYLAND 21043 TEL. (301) 461-9111		
PROJECT: SCHOOL AND CHAPEL / OFFICE BUILDING ADDITIONS CHURCH OF THE RESURRECTION DEMOLITION PLAN		
2ND ELECTION DISTRICT	HOWARD COUNTY, MD.	PARCEL 456, 1117 & 980
TAX MAP NO. 24	ENGINEERS WHITNEY, BAILEY, COX & MAGNANI CONSULTING ENGINEERS 1850 YORK ROAD TIMONIUM, MD. 21083 (301) 252-6060	
DESIGNED: A R	DRAWN: G G.	
CHECKED: P D.	DATE: 10/13/88	
SCALE: 1"=40'	JOB NO 085-097-71	
DRAWING NO: SHEET 2 OF 13	C-2	

7-17-89

SDP-89-76

UTILITY CONSTRUCTION NOTES

- U-1 FOR CONTINUATION SEE MECHANICAL DRAWING
- U-2 INSTALL NEW 8" PVC PIPE
- U-3 INSTALL NEW 6" CLEANOUT
- U-4 INSTALL RIPRAP (d50=40", dmax=6") OVER FILTER CLOTH
- U-5 INSTALL NEW 4" PVC (SANITARY SEWER). SEE MECHANICAL DRAWING FOR DETAIL
- U-6 INSTALL NEW 6" CLEANOUT AND CONNECT EXISTING PIPES. TOP OF CLEANOUT TO BE FLUSHED WITH EXISTING GROUND SURFACE
- U-7 INSTALL NEW SANITARY MANHOLE. RIM ELEV. 398.00
- U-8 INSTALL NEW 10" PVC PIPE
- U-9 INSTALL NEW 6" PVC PIPE
- U-10 INSTALL NEW 2" COPPER WATER TUBING
- U-11 CONNECT NEW 8" PVC PIPE TO EXISTING MANHOLE.
- U-12 INSTALL NEW 6" PLUG & BUTTRESS
- U-13 INSTALL NEW FIRE HYDRANT
- U-14 INSTALL NEW 6" VALVE
- U-15 INSTALL NEW 2" TAPPED TEE
- U-16 INSTALL NEW 2" BALL VALVE
- U-17 INSTALL NEW 6"x6" TEE
- U-18 INSTALL NEW 6" WATER
- U-19 INSTALL SALVAGED LIGHT POLE
- U-20 ADJUST MANHOLE TO ELEV. 398.50

1. Area of property - 25.26 AC.
2. Public water and public sewer will be utilized.
3. Zoning - R-20.
4. Tax Map No. 24.
5. Paved Area (existing) - 3.17 AC. 12.55%
6. Green Area (existing) 20.81 AC. 82.40%
7. BA Case 87-51E
8. Floor Areas - Chapel - 4650 SF office - 4,800 - Classroom - 5,000 SF
9. Existing building coverage - 2.45% - 0.62 AC.
Proposed building coverage - 1.31% - 0.33 AC.
Total building coverage - 3.76% - 0.95 AC.
10. Parking Analysis:
Parking requirement:
Office - 1/200 SF = 4800 SF/200 SF = 24 spaces
Church & Chapel - 900 seats - 1/3 seats = 300 spaces
Total = 324 spaces
Parking provided - 337 spaces
11. Parking requirement for school
For staff members:
existing number of pupils = 240/20 = 12 spaces
proposed additional kindergarten = 40/20 = 2 spaces
one all purpose room = 50 seats/5 seats = 10 spaces
Visitors parking = 5
No loading facility = 0
Total number of spaces = 29
12. See sheet C-11 for building profiles.
13. THE WIDENING OF THIS ENTRANCE IS CONSIDERED NECESSARY DISTURBANCE FOR PUBLIC SAFETY PER SECTION 16.11(C) OF THE SUBDIVISION AND LAND DEVELOPMENT REGULATIONS.
14. DUE TO THE MAJOR AREA DISTURBANCE, A FOREST CONSERVATION OBLIGATION WILL NOT BE APPLIED TO THIS PROJECT.

08/04/2021	REVISION ADDITION TO CHAPEL AND OFFICE BUILDING, ADD HANDICAP SPACE
02/09/2021	ADD ADDITION TO CHAPEL AND OFFICE BUILDING

LOD = 1,511 SF + 3,035 SF = 4,546 SF
 BECAUSE LOD IS LESS THAN 5,000 SF, STORMWATER MANAGEMENT IS NOT REQUIRED. IF CUMULATIVE LOD EXCEEDS 5,000 SF, STORM WATER MANAGEMENT WILL NEED TO BE ADDRESSED.

SITE LAYOUT CONSTRUCTION NOTES

- C-1 INSTALL 4"x4" CONCRETE SIDEWALK. SEE DETAIL
- C-2 INSTALL NEW BITUMINOUS PAVING.
- C-3 INSTALL NEW CURB & GUTTER.
- C-4 INSTALL NEW CONCRETE SIDEWALK.
- C-5 INSTALL HANDICAPPED SIGN. SEE DETAIL.
- C-6 INSTALL NEW HANDICAPPED STRIPING. SEE DETAIL.
- C-7 INSTALL NEW HANDICAPPED RAMP.
- C-8 INSTALL DEPRESSIONED CURB.
- C-9 TYPICAL PARKING SPACE STRIPING. SEE HANDICAPPED STRIPING DETAIL.
- C-10 INSTALL WHEEL STOPS

06/01/18	REVISED ENTRANCE AT WEST OF SITE
07/19/19	GENERAL REVISIONS (WBCM)
5/10/89	REVISED PER HOWARD CO. COMMENTS
DATE: NO.	REVISION

APPROVED: FOR PUBLIC WATER AND SEWERAGE, STORM DRAINAGE SYSTEMS AND PUBLIC ROADS HOWARD COUNTY DEPARTMENT OF PUBLIC WORKS	
<i>James J. Shi</i>	11/22/87
DIRECTOR	DATE
APPROVED: FOR PUBLIC WATER AND PUBLIC SEWER SYSTEMS HOWARD COUNTY DEPARTMENT	
<i>George M. Boyd</i>	11/29/89
COUNTY HEALTH OFFICER	DATE
APPROVED: HOWARD COUNTY DEPT. OF PLANNING AND ZONING	
<i>James R. Smith</i>	12/6/89
DIRECTOR	DATE
APPROVED: DIVISION OF COMMUNITY PLANNING AND DEVELOPMENT	
<i>James V. Smith</i>	12/6/89
CHIEF, DIVISION OF COMMUNITY PLANNING AND DEVELOPMENT	DATE


OWNER: CHURCH OF THE RESURRECTION
 PAULSKIRK DRIVE & NORTH CHATHAM ROAD
 ELLICOTT CITY, MARYLAND 21043
 TEL. (301) 461-9111

PROJECT: SCHOOL & CHAPEL/OFFICE BUILDING ADDITIONS
 CHURCH OF THE RESURRECTION
 SITE PLAN & UTILITY PLAN

2ND ELECTION DISTRICT HOWARD COUNTY, MD.
 TAX MAP NO. 24 PARCEL 456 1117 & 990
 ENGINEERS: WHITNEY, BAILEY, COX & MAGNANI
 CONSULTING ENGINEERS
 1850 YORK ROAD
 TOWSON, MD. 21093
 (301) 252-6060

DESIGNED: A.R.
DRAWN: GSB
CHECKED: P.D.
DATE: 10/13/88
SCALE: 1" = 40'
DRAWING NO: SHEET 3 OF 13
C-3

APPROVED
 DIVISION OF
 COMMUNITY PLANNING
 & LAND DEVELOPMENT
 HOWARD COUNTY,
 MARYLAND
 DATE: 7-17-89

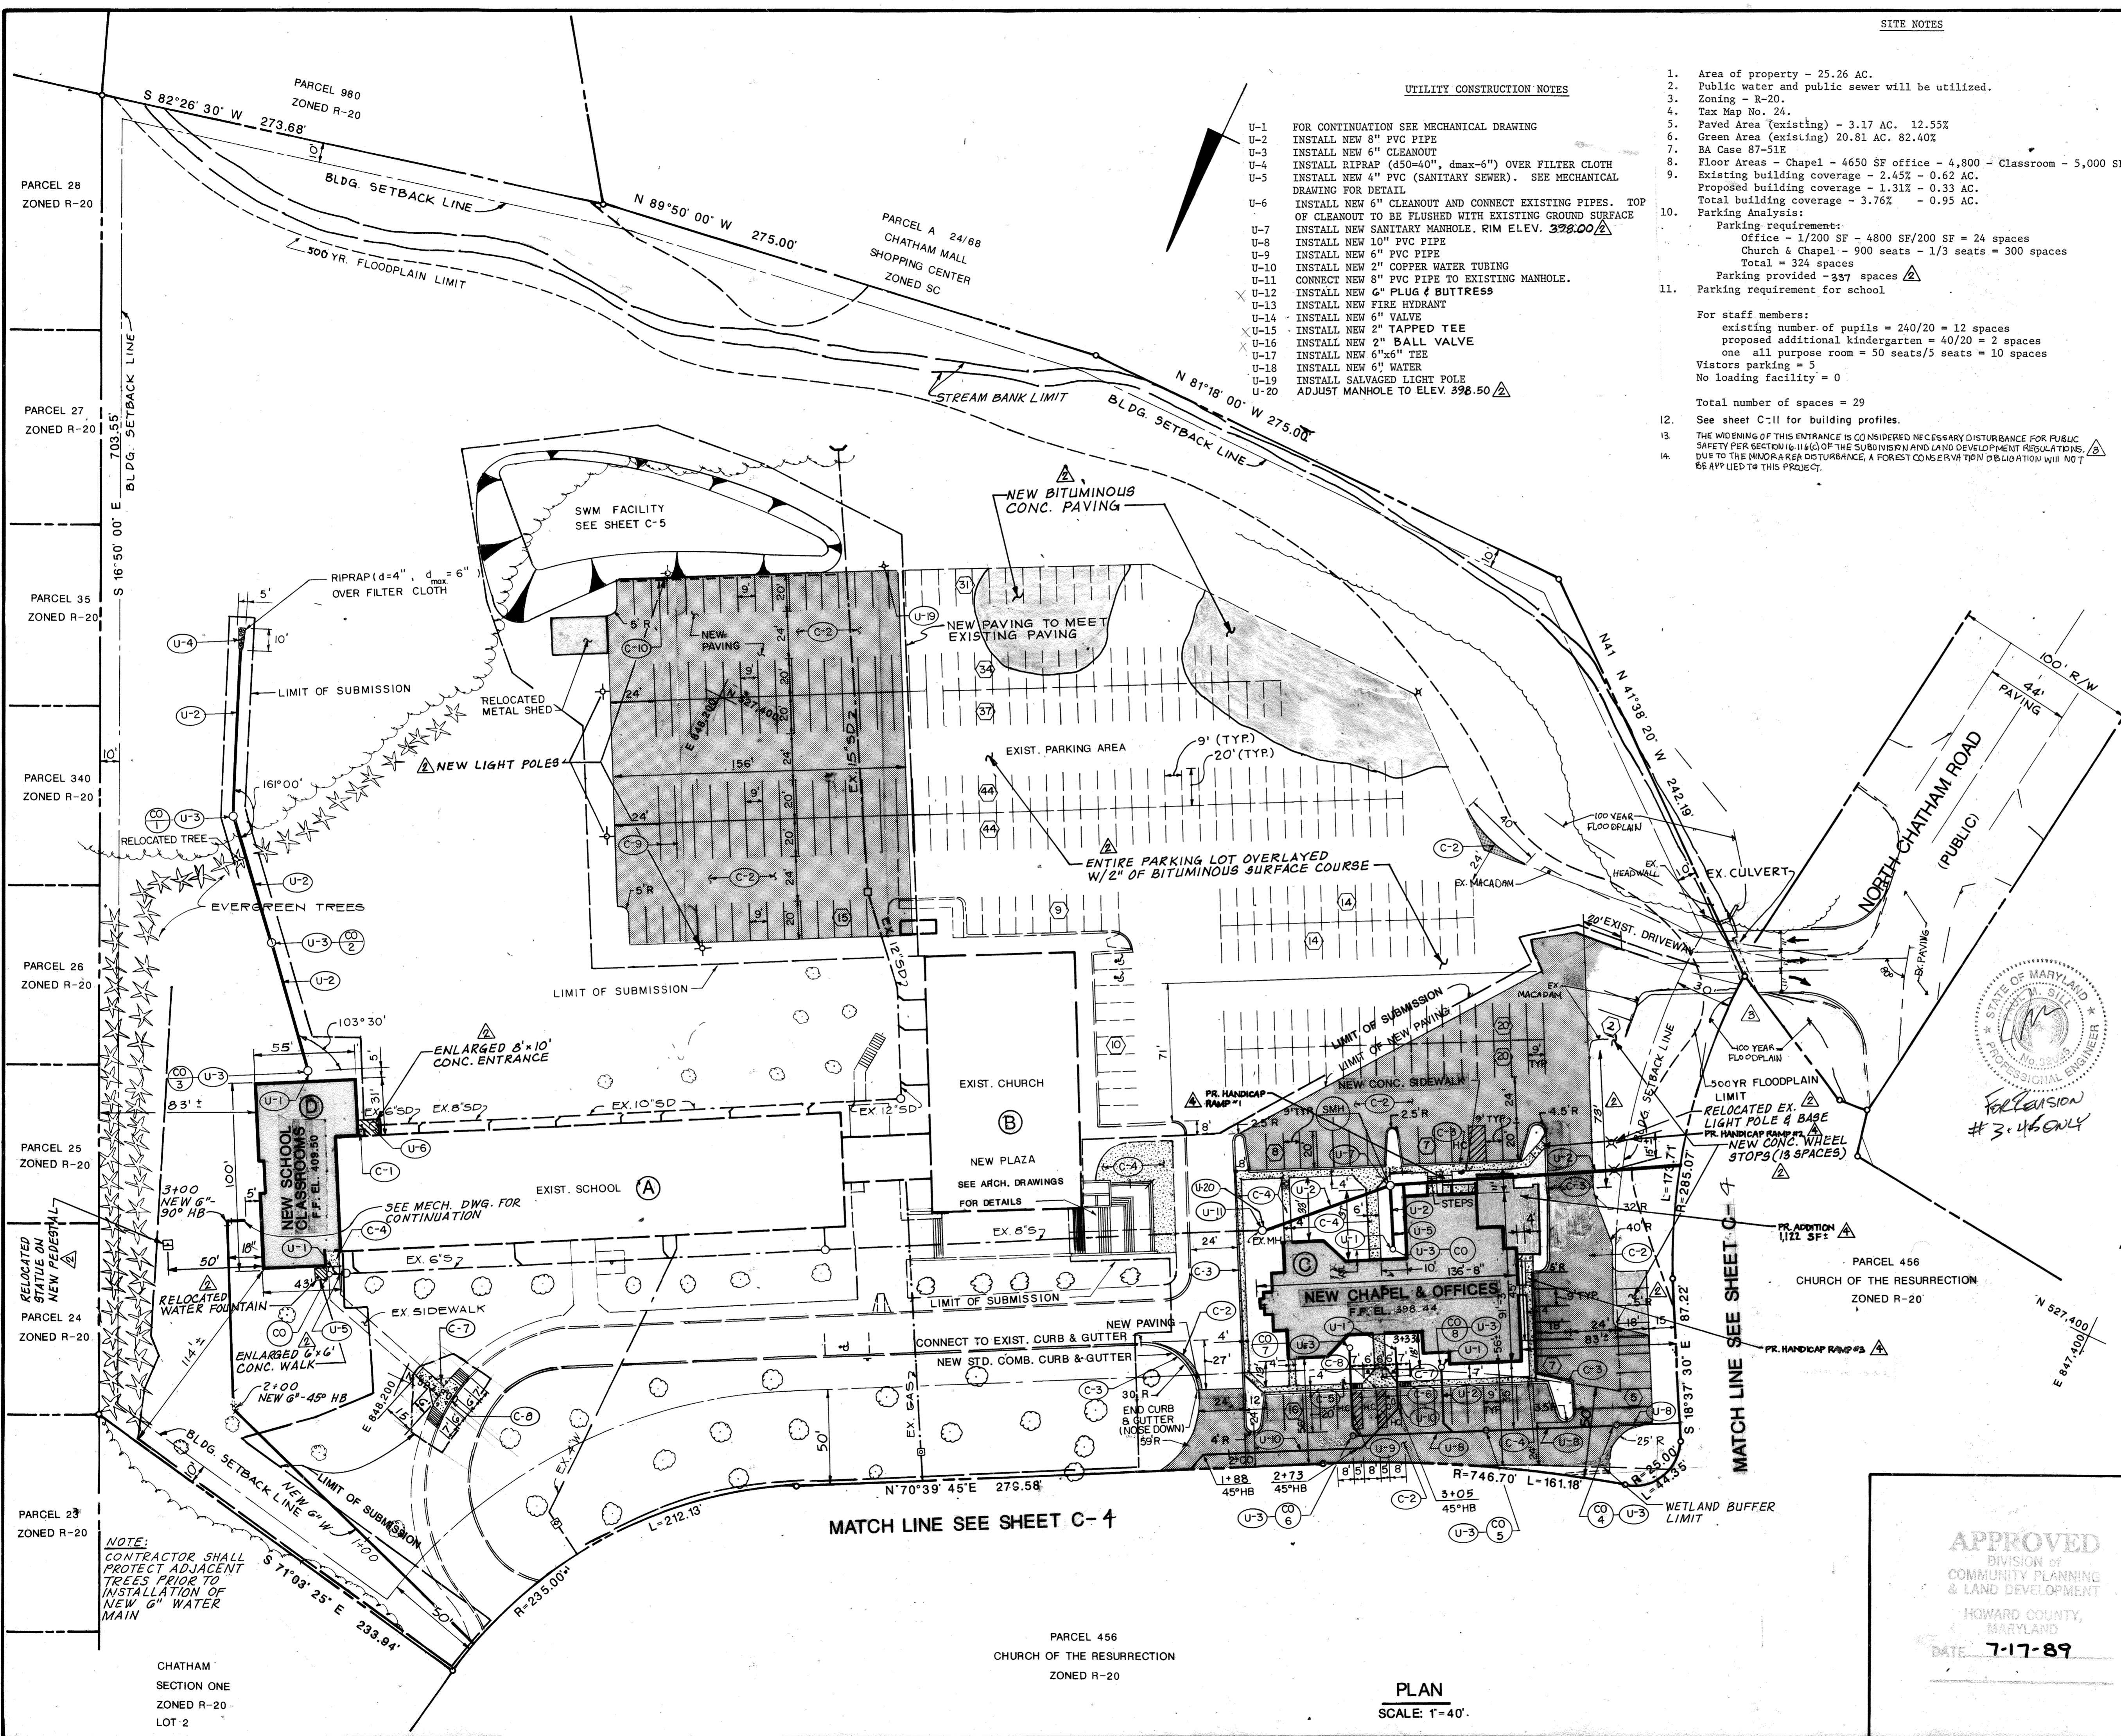

MATCH LINE SEE SHEET C-4

MATCH LINE SEE SHEET C-4




PARCEL 456
 CHURCH OF THE RESURRECTION
 ZONED R-20

PLAN
 SCALE: 1" = 40'

NOTE:
 CONTRACTOR SHALL
 PROTECT ADJACENT
 TREES PRIOR TO
 INSTALLATION OF
 NEW 6" WATER
 MAIN

CHATHAM
 SECTION ONE
 ZONED R-20
 LOT 2

1	REVISE ENTRANCE AT WEST OF SITE	09/01/89
NO.	DESCRIPTION	DATE
	REVISIONS	

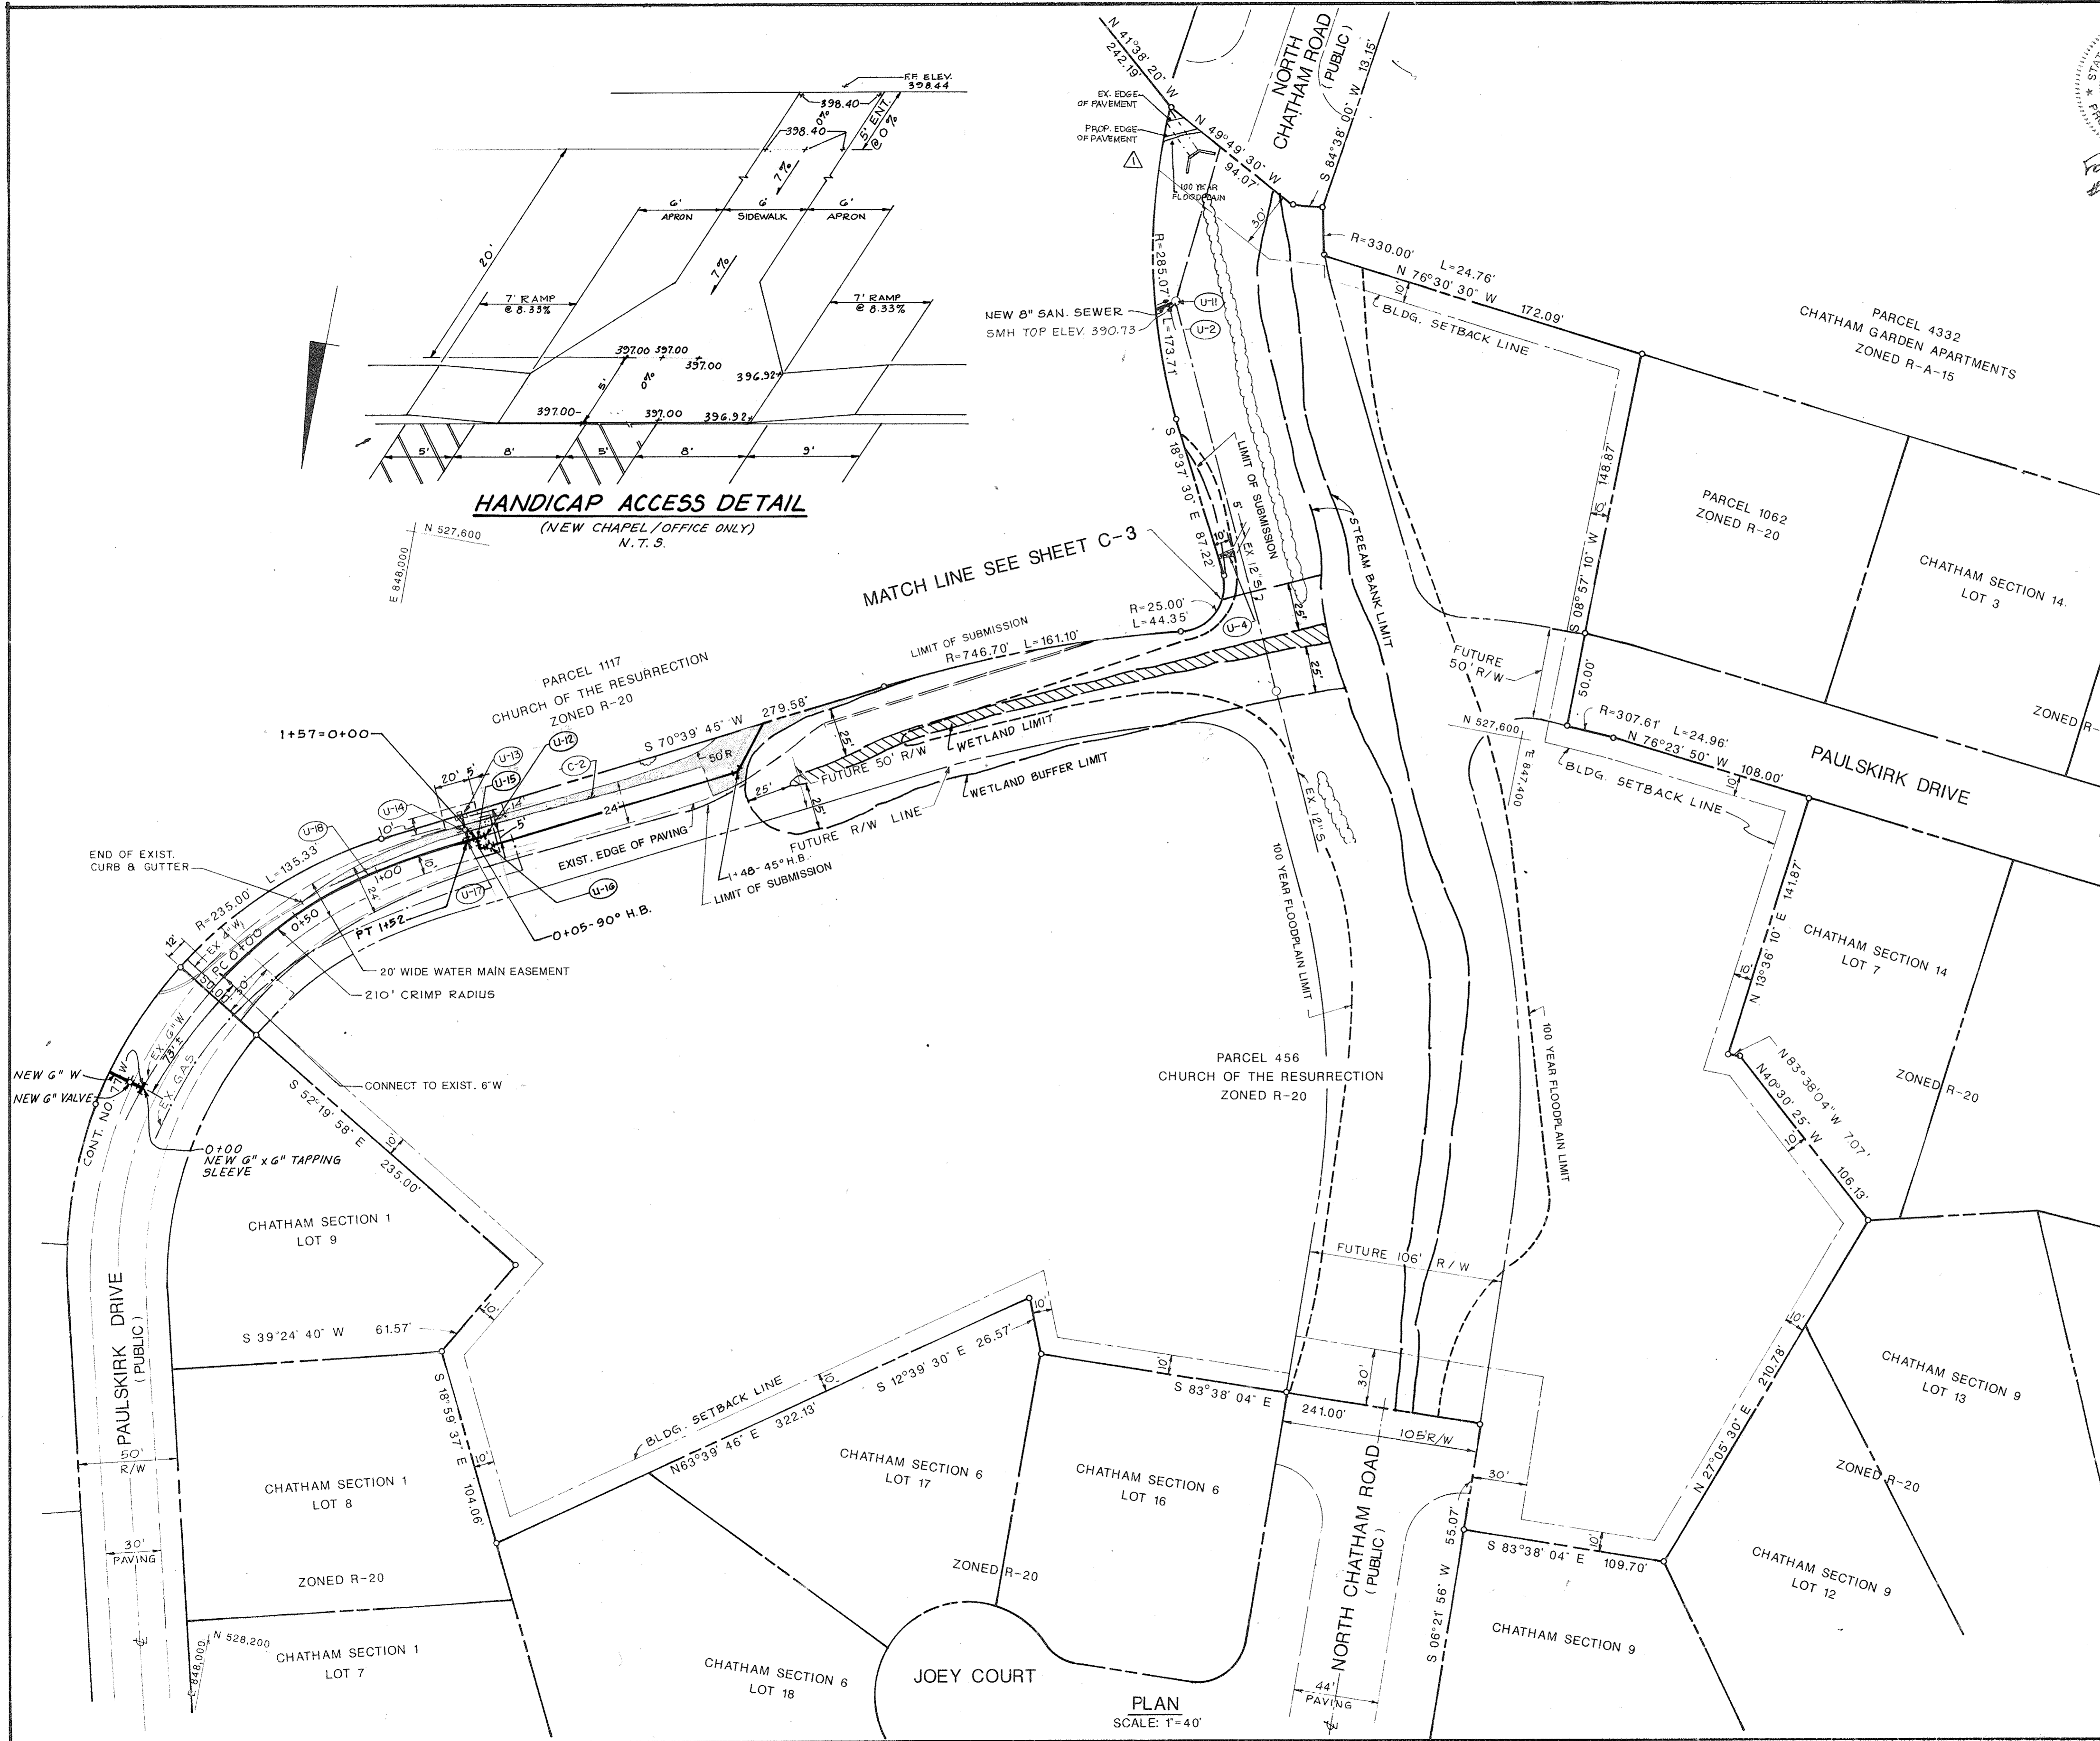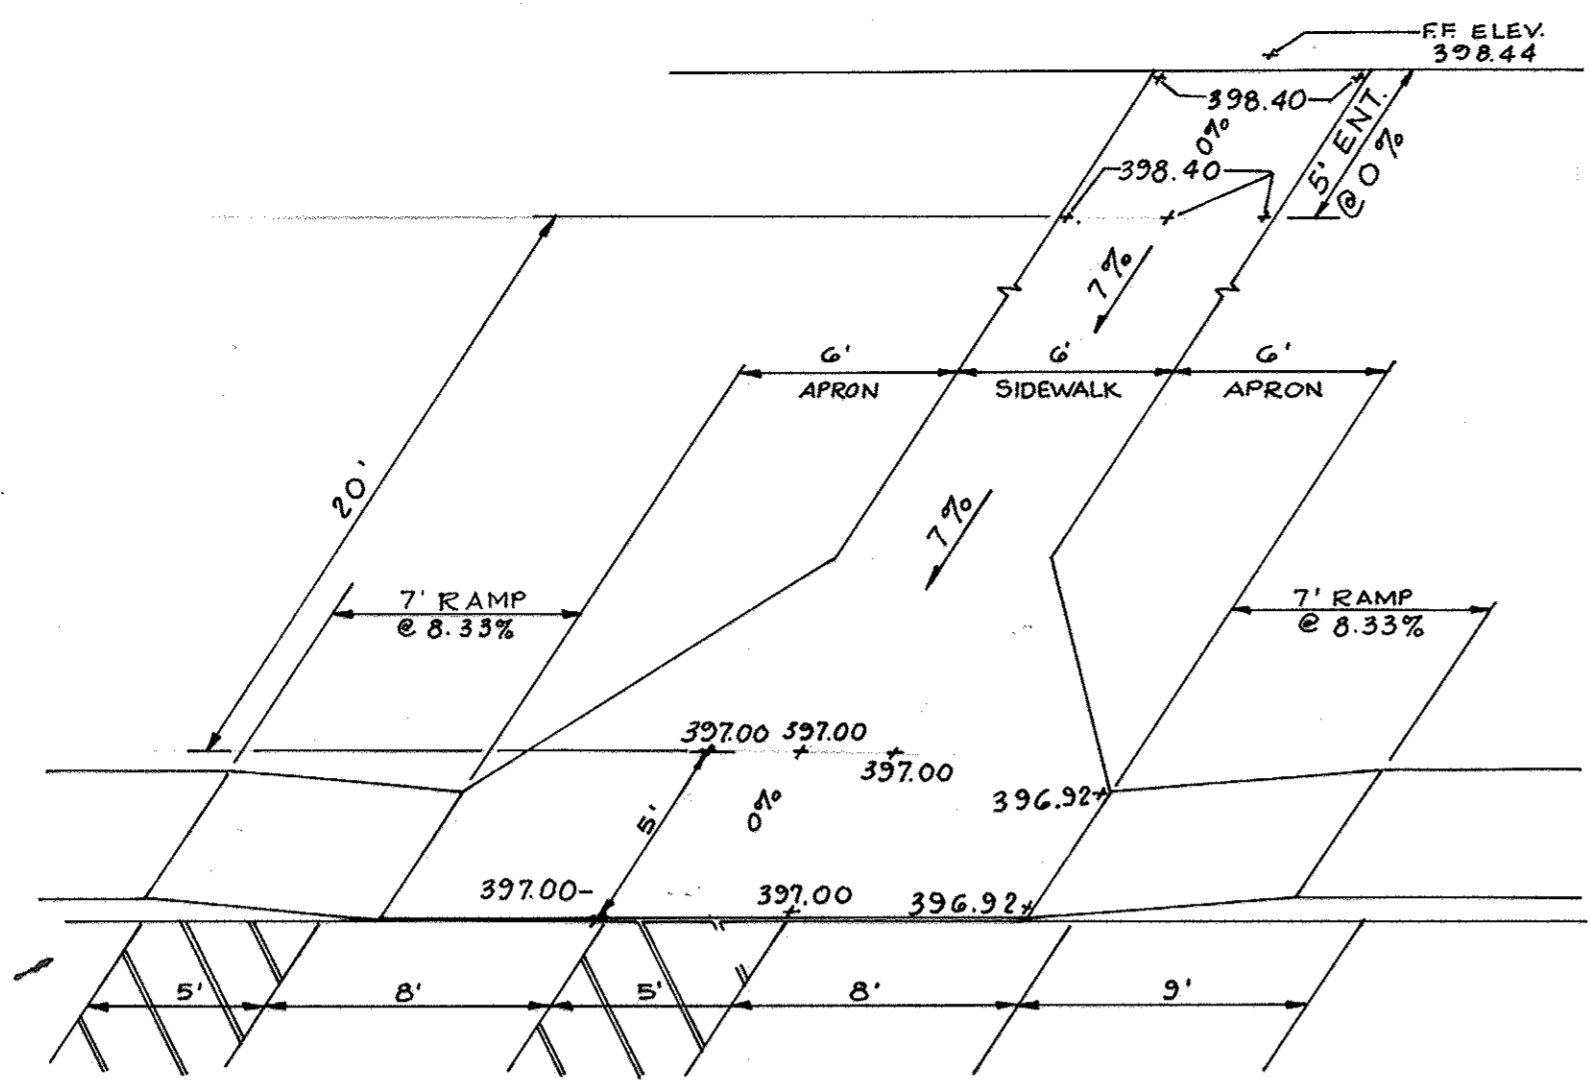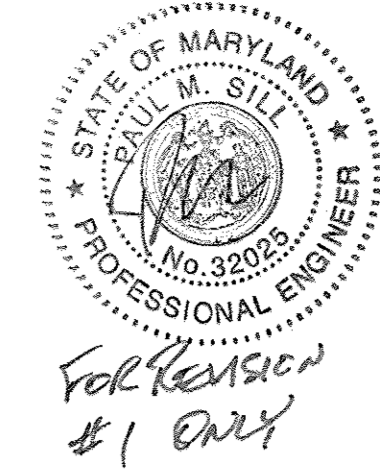

APPROVED
DIVISION of
COMMUNITY PLANNING
& LAND DEVELOPMENT
HOWARD COUNTY,
MARYLAND
DATE **7-17-89**

APPROVED: FOR PUBLIC WATER AND SEWERAGE, STORM DRAINAGE SYSTEMS AND PUBLIC ROADS HOWARD COUNTY DEPARTMENT OF PUBLIC WORKS DIRECTOR <i>James H. Lee</i> DATE 11/22/89
APPROVED: FOR PUBLIC WATER AND PUBLIC SEWER SYSTEMS HOWARD COUNTY HEALTH DEPARTMENT HEALTH OFFICER <i>Joyce M. Bond</i> DATE 11/29/89
APPROVED: HOWARD COUNTY DEPT. OF PLANNING AND ZONING DIRECTOR <i>James R. Smith</i> DATE 12/1/89
APPROVED: CHIEF, DIVISION OF COMMUNITY PLANNING AND DEVELOPMENT <i>David S. ...</i> DATE 12/1/89

OWNER: CHURCH OF THE RESURRECTION
PAULSKIRK DRIVE & NORTH CHATHAM ROAD
ELLCOTT CITY, MARYLAND 21043
TEL. (301) 461-9111


PROJECT: SCHOOL AND CHAPEL/OFFICE BUILDING ADDITIONS






CHURCH OF THE RESURRECTION
SITE PLAN & UTILITY PLAN

2ND ELECTION DISTRICT HOWARD COUNTY, MD.
TAX MAP NO. 24 PARCEL 456, 1117 & 980

ENGINEERS: WHITNEY, BAILEY, COX & MAGNANI
CONSULTING ENGINEERS
1850 YORK ROAD
TIMONIUM, MD. 21093
(301) 252-6050

DESIGNED: A.R.	DATE: 10/13/88
DRAWN: GSB	SCALE: 1"=40'
CHECKED: P.D.	DRAWING NO: SHEET 4 OF 13
DATE: 10/13/88	C-4
SCALE: 1"=40'	
DRAWING NO: SHEET 4 OF 13	
C-4	

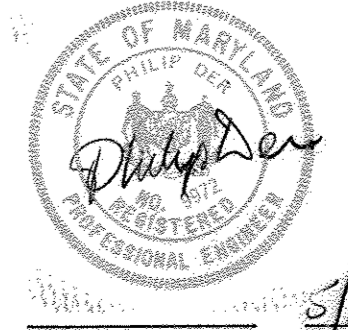

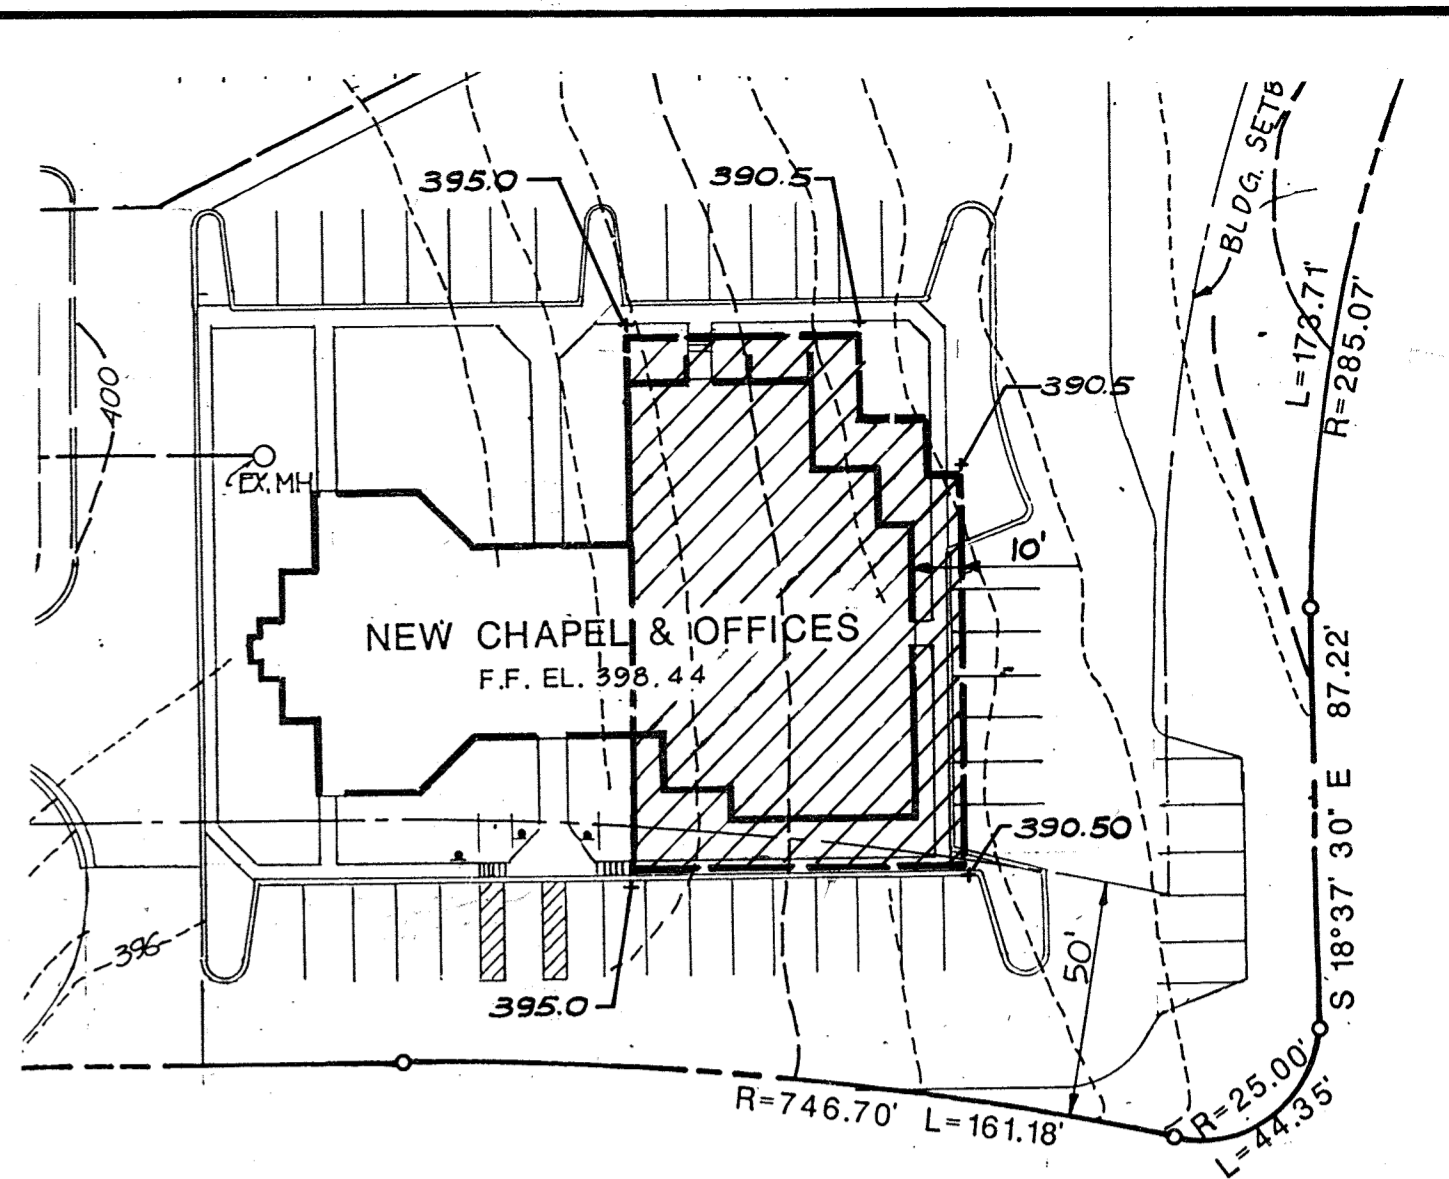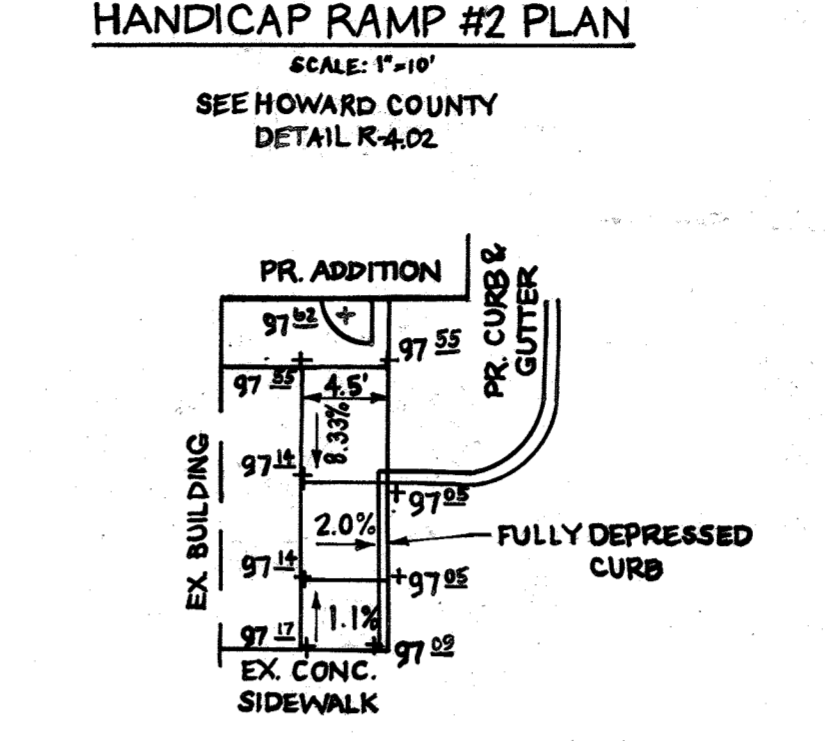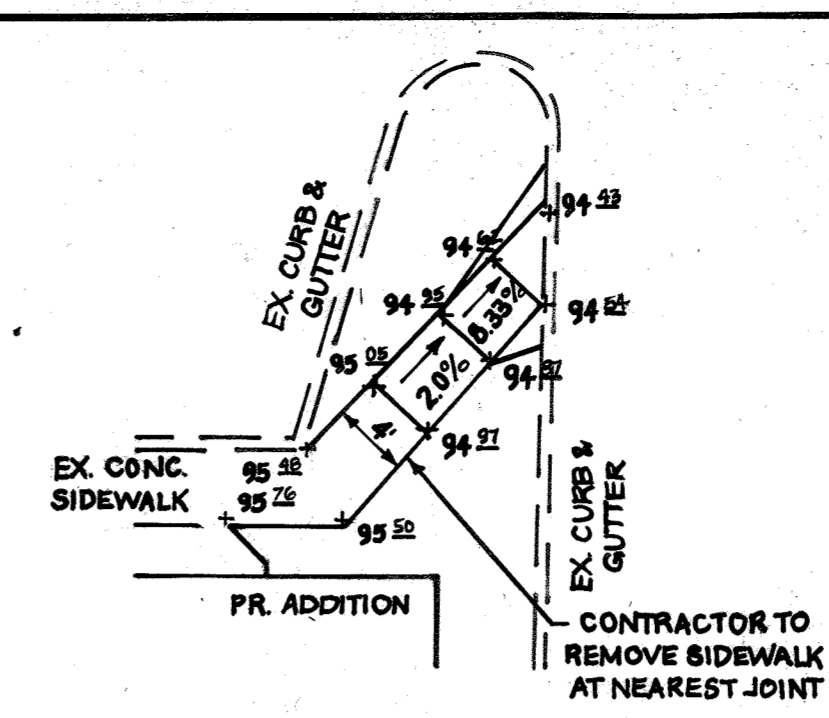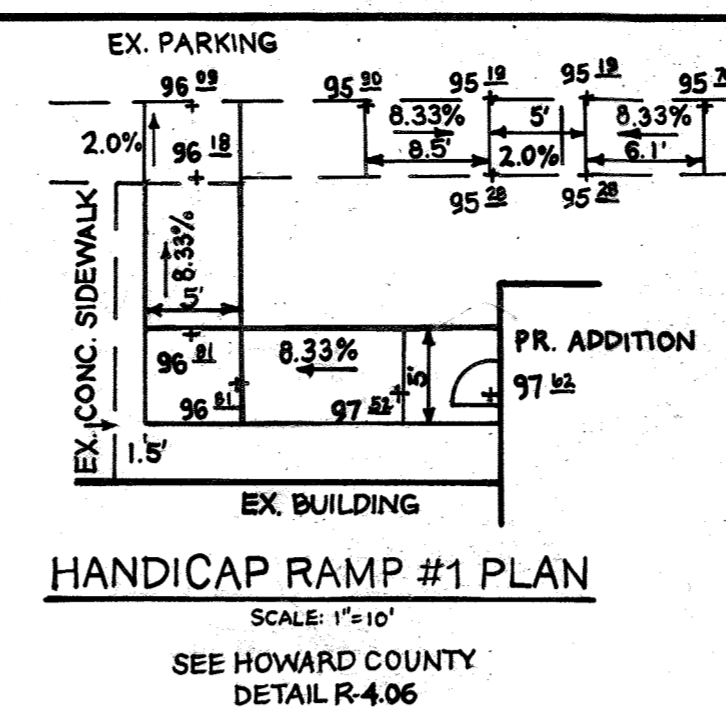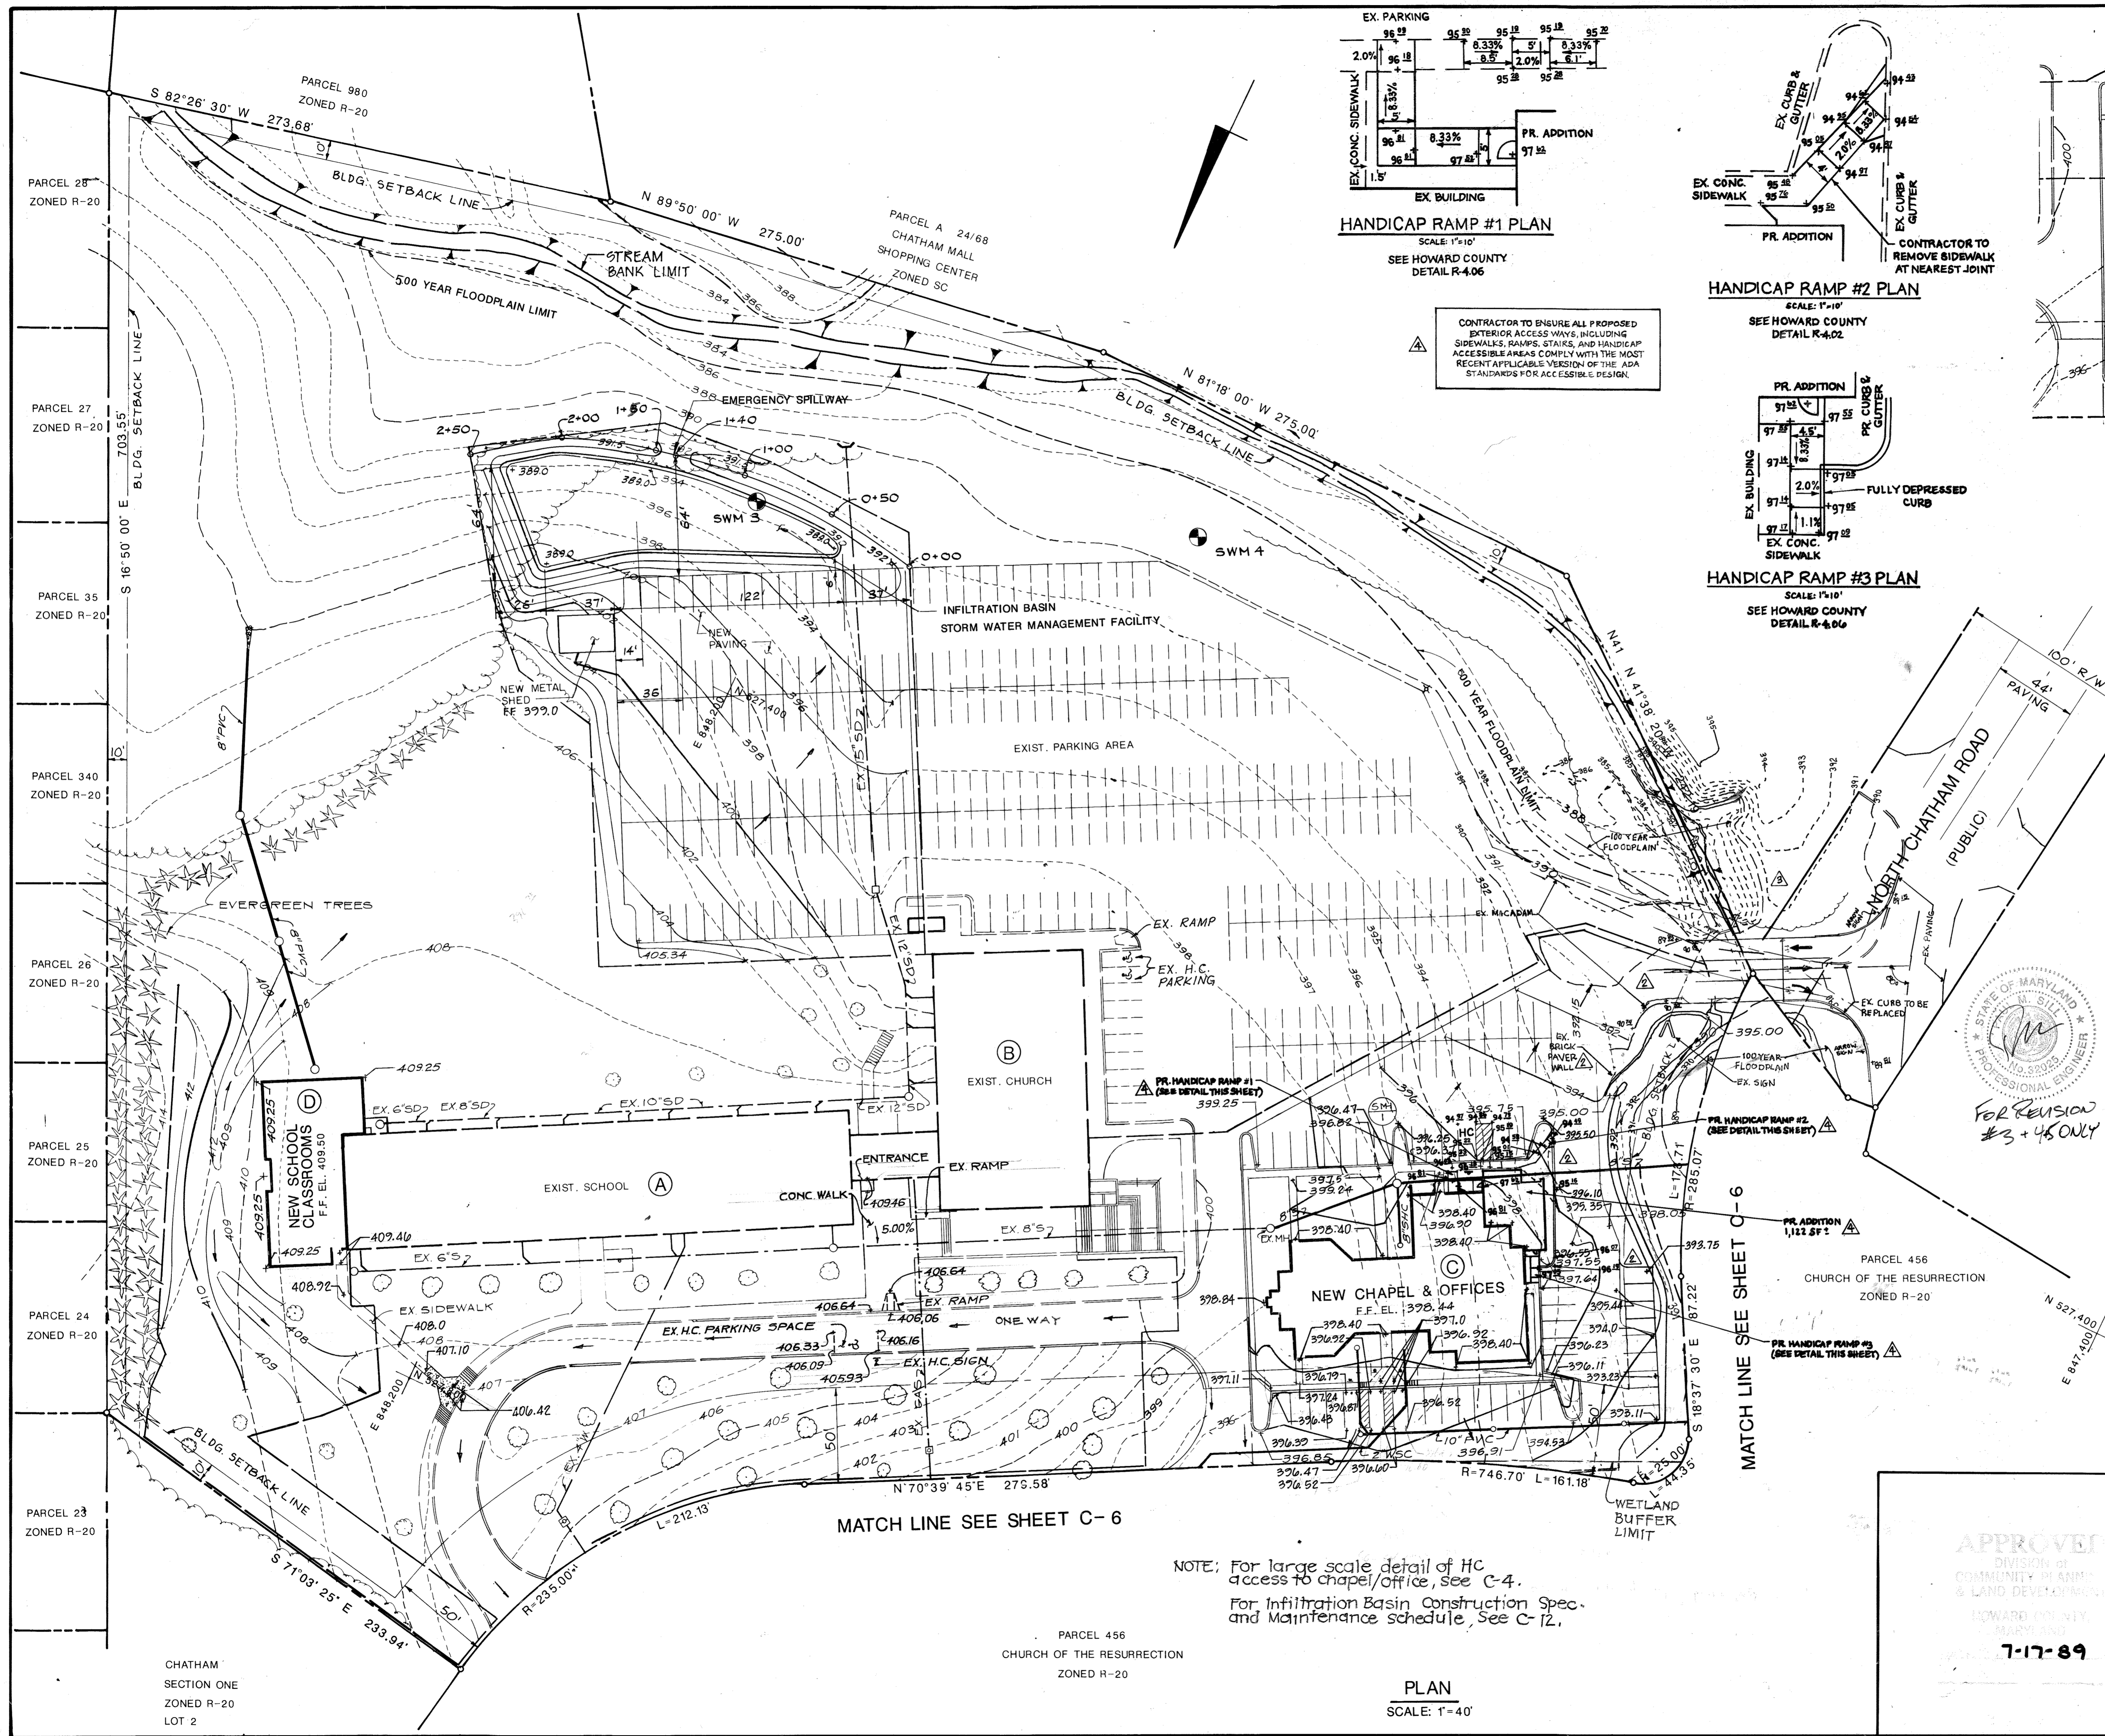

LOD = 1,511 SF + 3,035 SF = 4,546 SF Δ
 BECAUSE LOD IS LESS THAN 5,000 SF,
 STORMWATER MANAGEMENT IS NOT
 REQUIRED. IF CUMULATIVE LOD EXCEEDS 5,000
 SF, STORM WATER MANAGEMENT WILL NEED
 TO BE ADDRESSED.

- 08/01/2021 Δ REVISE ADDITION TO CHAPEL AND OFFICE BUILDING, ADD HANDICAP SPACE
- 02/09/2021 Δ ADD ADDITION TO CHAPEL AND OFFICE BUILDING

AS BUILT
 7/16/91

06/01/2018	Δ	REVISE ENTRANCE AT WEST OF SITE
6/17/91	Δ	GENERAL REVISIONS (WBCM)
5/10/89	Δ	REVISED PER H.O.C. COMMENTS
DATE:	NO.	REVISION

APPROVED: FOR PUBLIC WATER AND SEWERAGE,
 STORM DRAINAGE SYSTEMS AND PUBLIC ROADS
 HOWARD COUNTY DEPARTMENT OF PUBLIC WORKS
 DIRECTOR: James J. [Signature] DATE: 11/22/89

APPROVED: FOR PUBLIC WATER AND PUBLIC SEWER SYSTEMS
 HOWARD COUNTY HEALTH DEPARTMENT
 COUNTY HEALTH OFFICER: James M. [Signature] DATE: 11/29/89

APPROVED: HOWARD COUNTY DEPT. OF PLANNING AND ZONING
 DIRECTOR: [Signature] DATE: 12/6/89

CHIEF, DIVISION OF COMMUNITY PLANNING AND
 DEVELOPMENT: [Signature] DATE: 12/6/89

OWNER: CHURCH OF THE RESURRECTION
 PAULSKIRK DRIVE & NORTH CHATHAM ROAD
 ELLICOTT CITY, MARYLAND 21043
 TEL: (301) 461-9111

PROJECT: SCHOOL & CHAPEL/OFFICE BUILDING ADDITIONS
 CHURCH OF THE RESURRECTION
 GRADING & INFILTRATION BASIN PLAN
 2ND ELECTION DISTRICT HOWARD COUNTY, MD.
 TAX MAP NO. 24 PARCEL 456, 1117 & 980
 ENGINEERS: WHITNEY, BAILEY, COX & MAGNANI
 CONSULTING ENGINEERS
 1850 YORK ROAD
 TIMONIUM, MD. 21093
 (301) 252-6660

DESIGNED:	A.R.
DRAWN:	G.S.B.
CHECKED:	P.D.
DATE:	10/13/88
SCALE:	1" = 40'
DRAWING NO:	SHEET 5 OF 13 C-5
DATE:	6/12/89

APPROVED
 DIVISION OF
 COMMUNITY PLANNING
 & LAND DEVELOPMENT
 HOWARD COUNTY
 MARYLAND
 7-17-89

NOTE: For large scale detail of HC
 access to chapel/office, see C-4.
 For Infiltration Basin Construction Spec.
 and Maintenance schedule, See C-12.


PLAN
 SCALE: 1"=40'

CHATHAM
 SECTION ONE
 ZONED R-20
 LOT 2

PARCEL 456
 CHURCH OF THE RESURRECTION
 ZONED R-20

1	REVISE ENTRANCE AT WEST OF SITE	06/01/18
NO.	DESCRIPTION	DATE
REVISIONS		

STATE OF MARYLAND
 PROFESSIONAL ENGINEER
 No. 39205
 FOR REVISION
 #1 ONLY

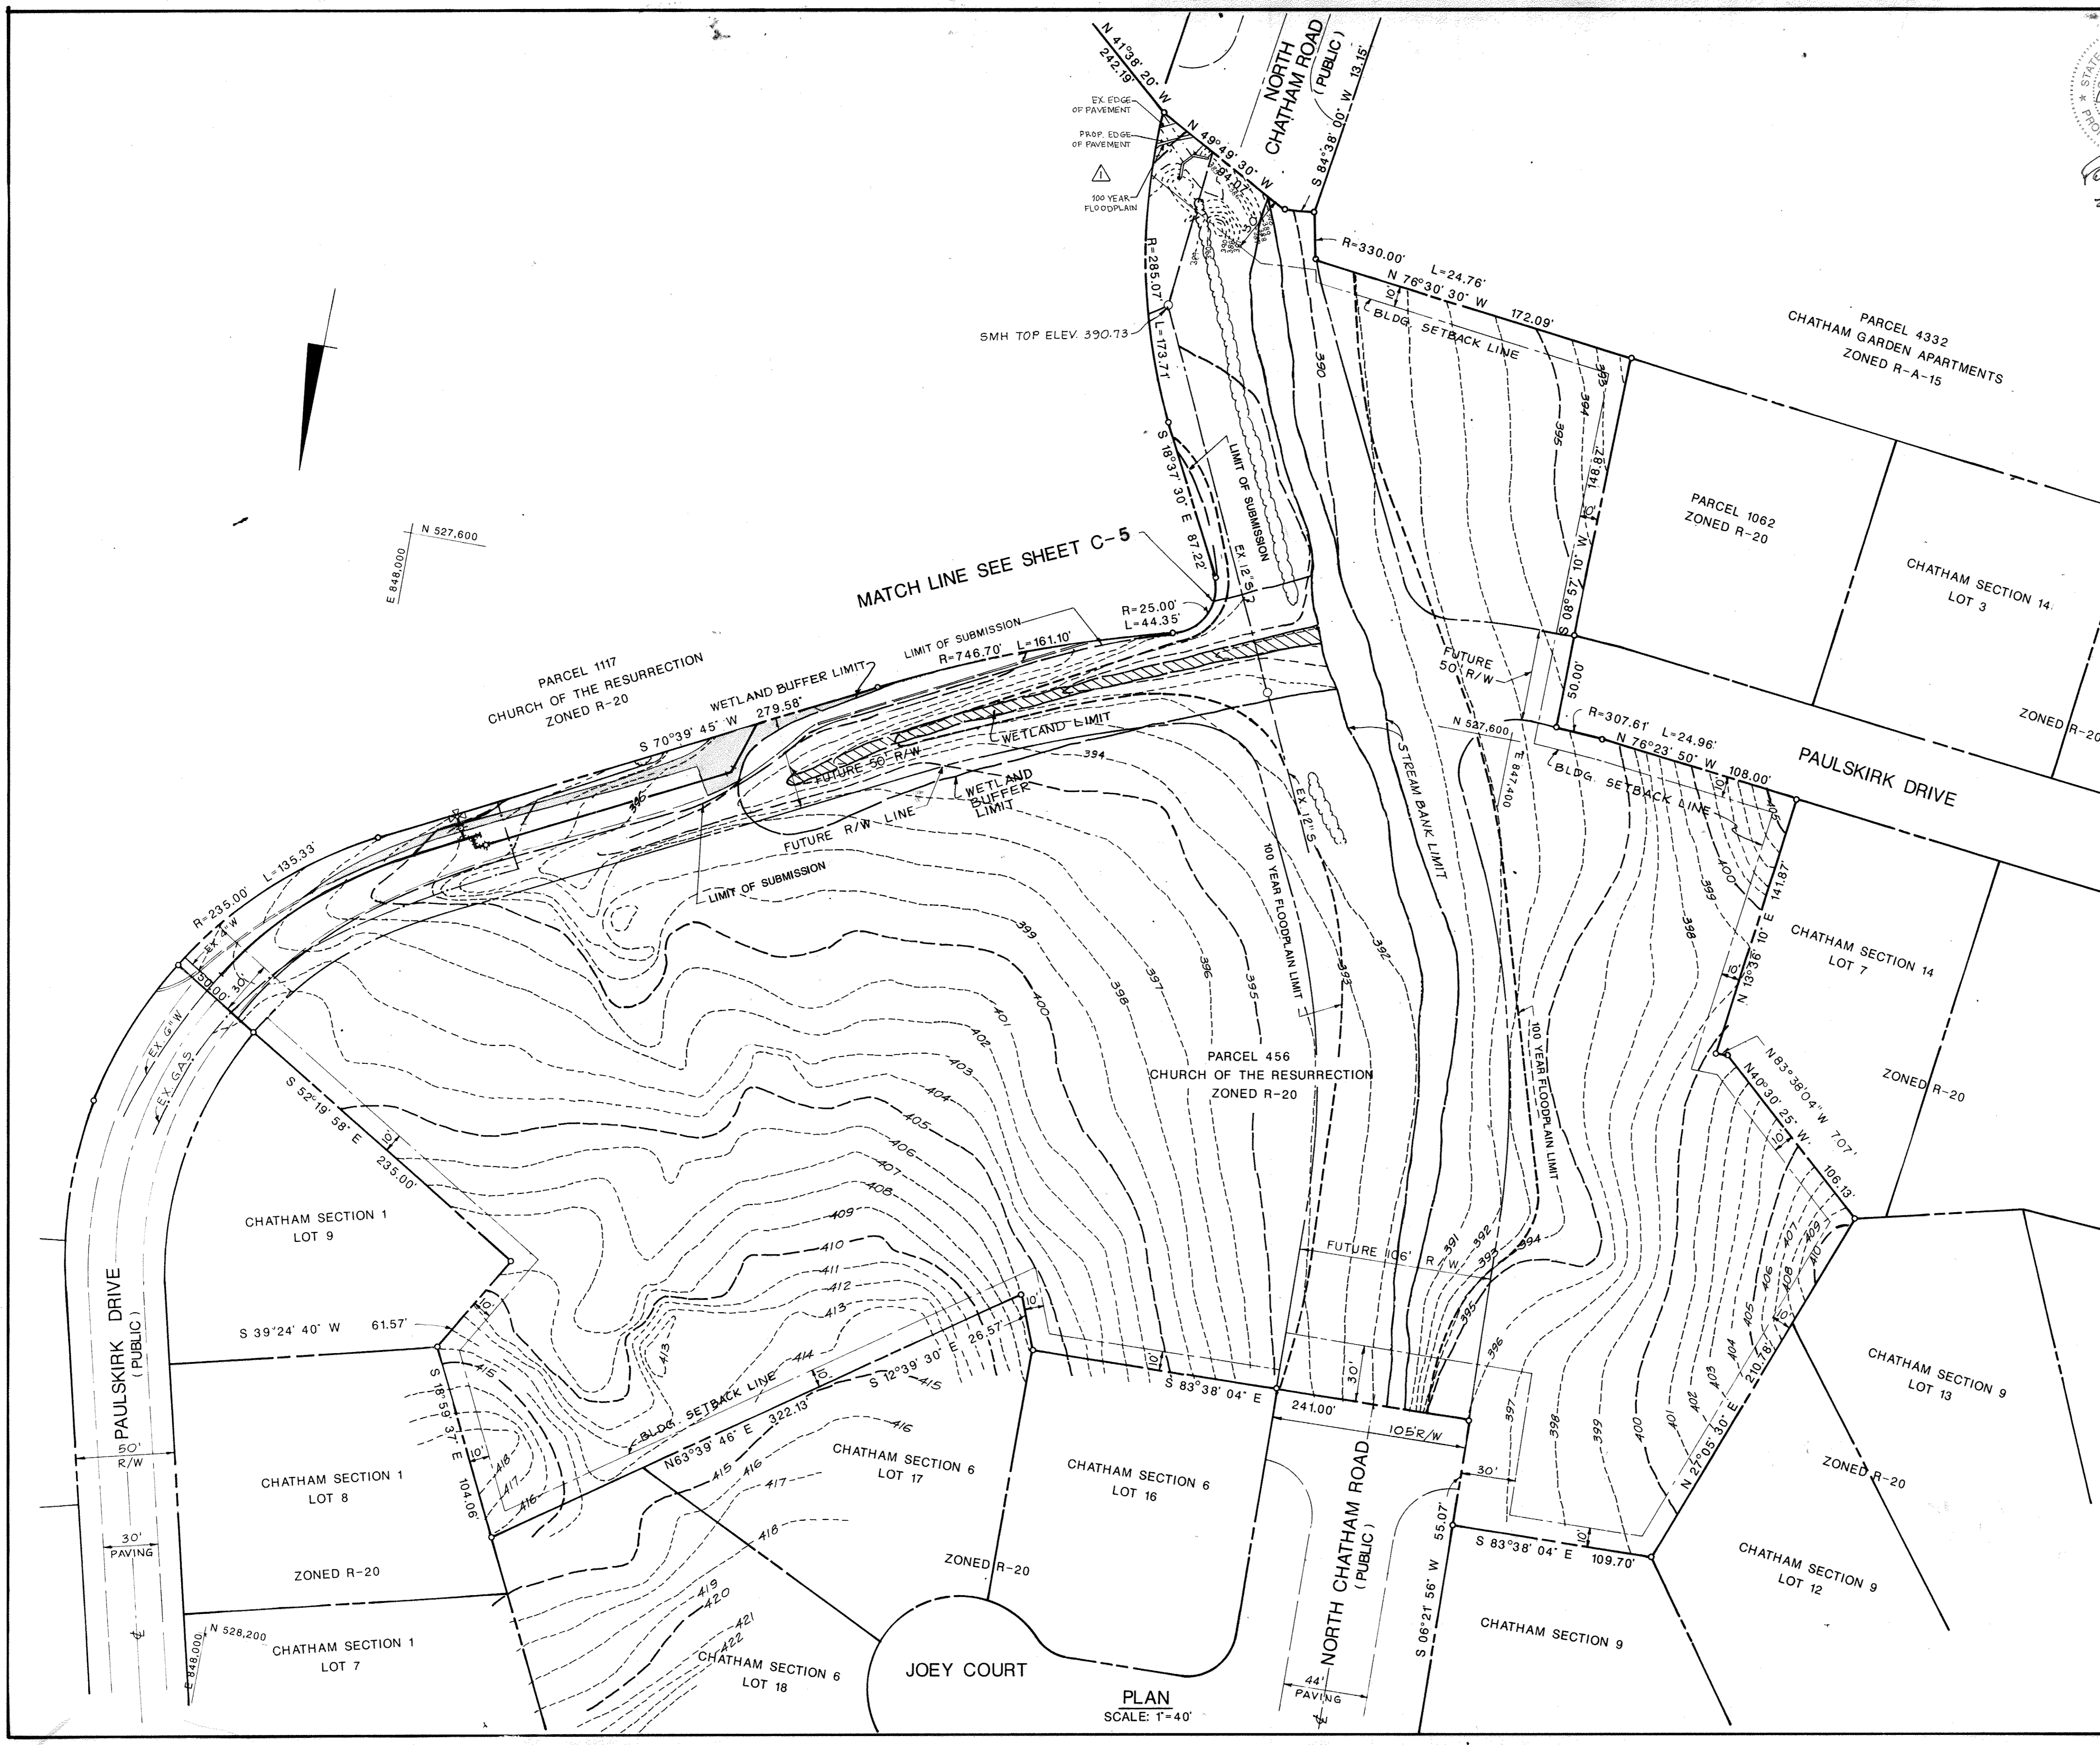


APPROVED
 DIVISION of
 COMMUNITY PLANNING
 & LAND DEVELOPMENT
 HOWARD COUNTY,
 MARYLAND
 DATE: **7-17-89**

APPROVED: FOR PUBLIC WATER AND SEWERAGE,
 STORM DRAINAGE SYSTEMS AND PUBLIC ROADS
 HOWARD COUNTY DEPARTMENT OF PUBLIC WORKS
James J. ... 11/22/89
 DIRECTOR DATE
... 11-20-89
 CHIEF, BUREAU OF ENGINEERING DATE
 APPROVED: FOR PUBLIC WATER AND PUBLIC SEWER SYSTEMS
 HOWARD COUNTY HEALTH DEPARTMENT
James M. ... 11/29/89
 COUNTY HEALTH OFFICER DATE
 APPROVED: HOWARD COUNTY DEPT. OF PLANNING AND ZONING
James ... 12/6/89
 DIRECTOR DATE
... 12/6/89
 CHIEF, DIVISION OF COMMUNITY PLANNING AND DEVELOPMENT DATE


OWNER: CHURCH OF THE RESURRECTION
 PAULSKIRK DRIVE & NORTH CHATHAM ROAD
 ELLICOTT CITY, MARYLAND 21043
 TEL. (301) 461-9111
 PROJECT: SCHOOL AND CHAPEL/OFFICE BUILDING ADDITIONS
CHURCH OF THE RESURRECTION
GRADING PLAN
 2ND ELECTION DISTRICT HOWARD COUNTY, MD.
 TAX MAP NO. 24 PARCEL 456, 1117 & 980
 ENGINEERS: WHITNEY, BAILEY, COX & MAGNANI
 CONSULTING ENGINEERS
 1850 YORK ROAD
 TIMONIUM, MD. 21093
 (301) 252-6060

DESIGNED:	A.R.
DRAWN:	GSB
CHECKED:	P.D.
DATE:	10/13/88
SCALE:	1"=40'
DRAWING NO.:	SHEET 6 OF 13
	C-6

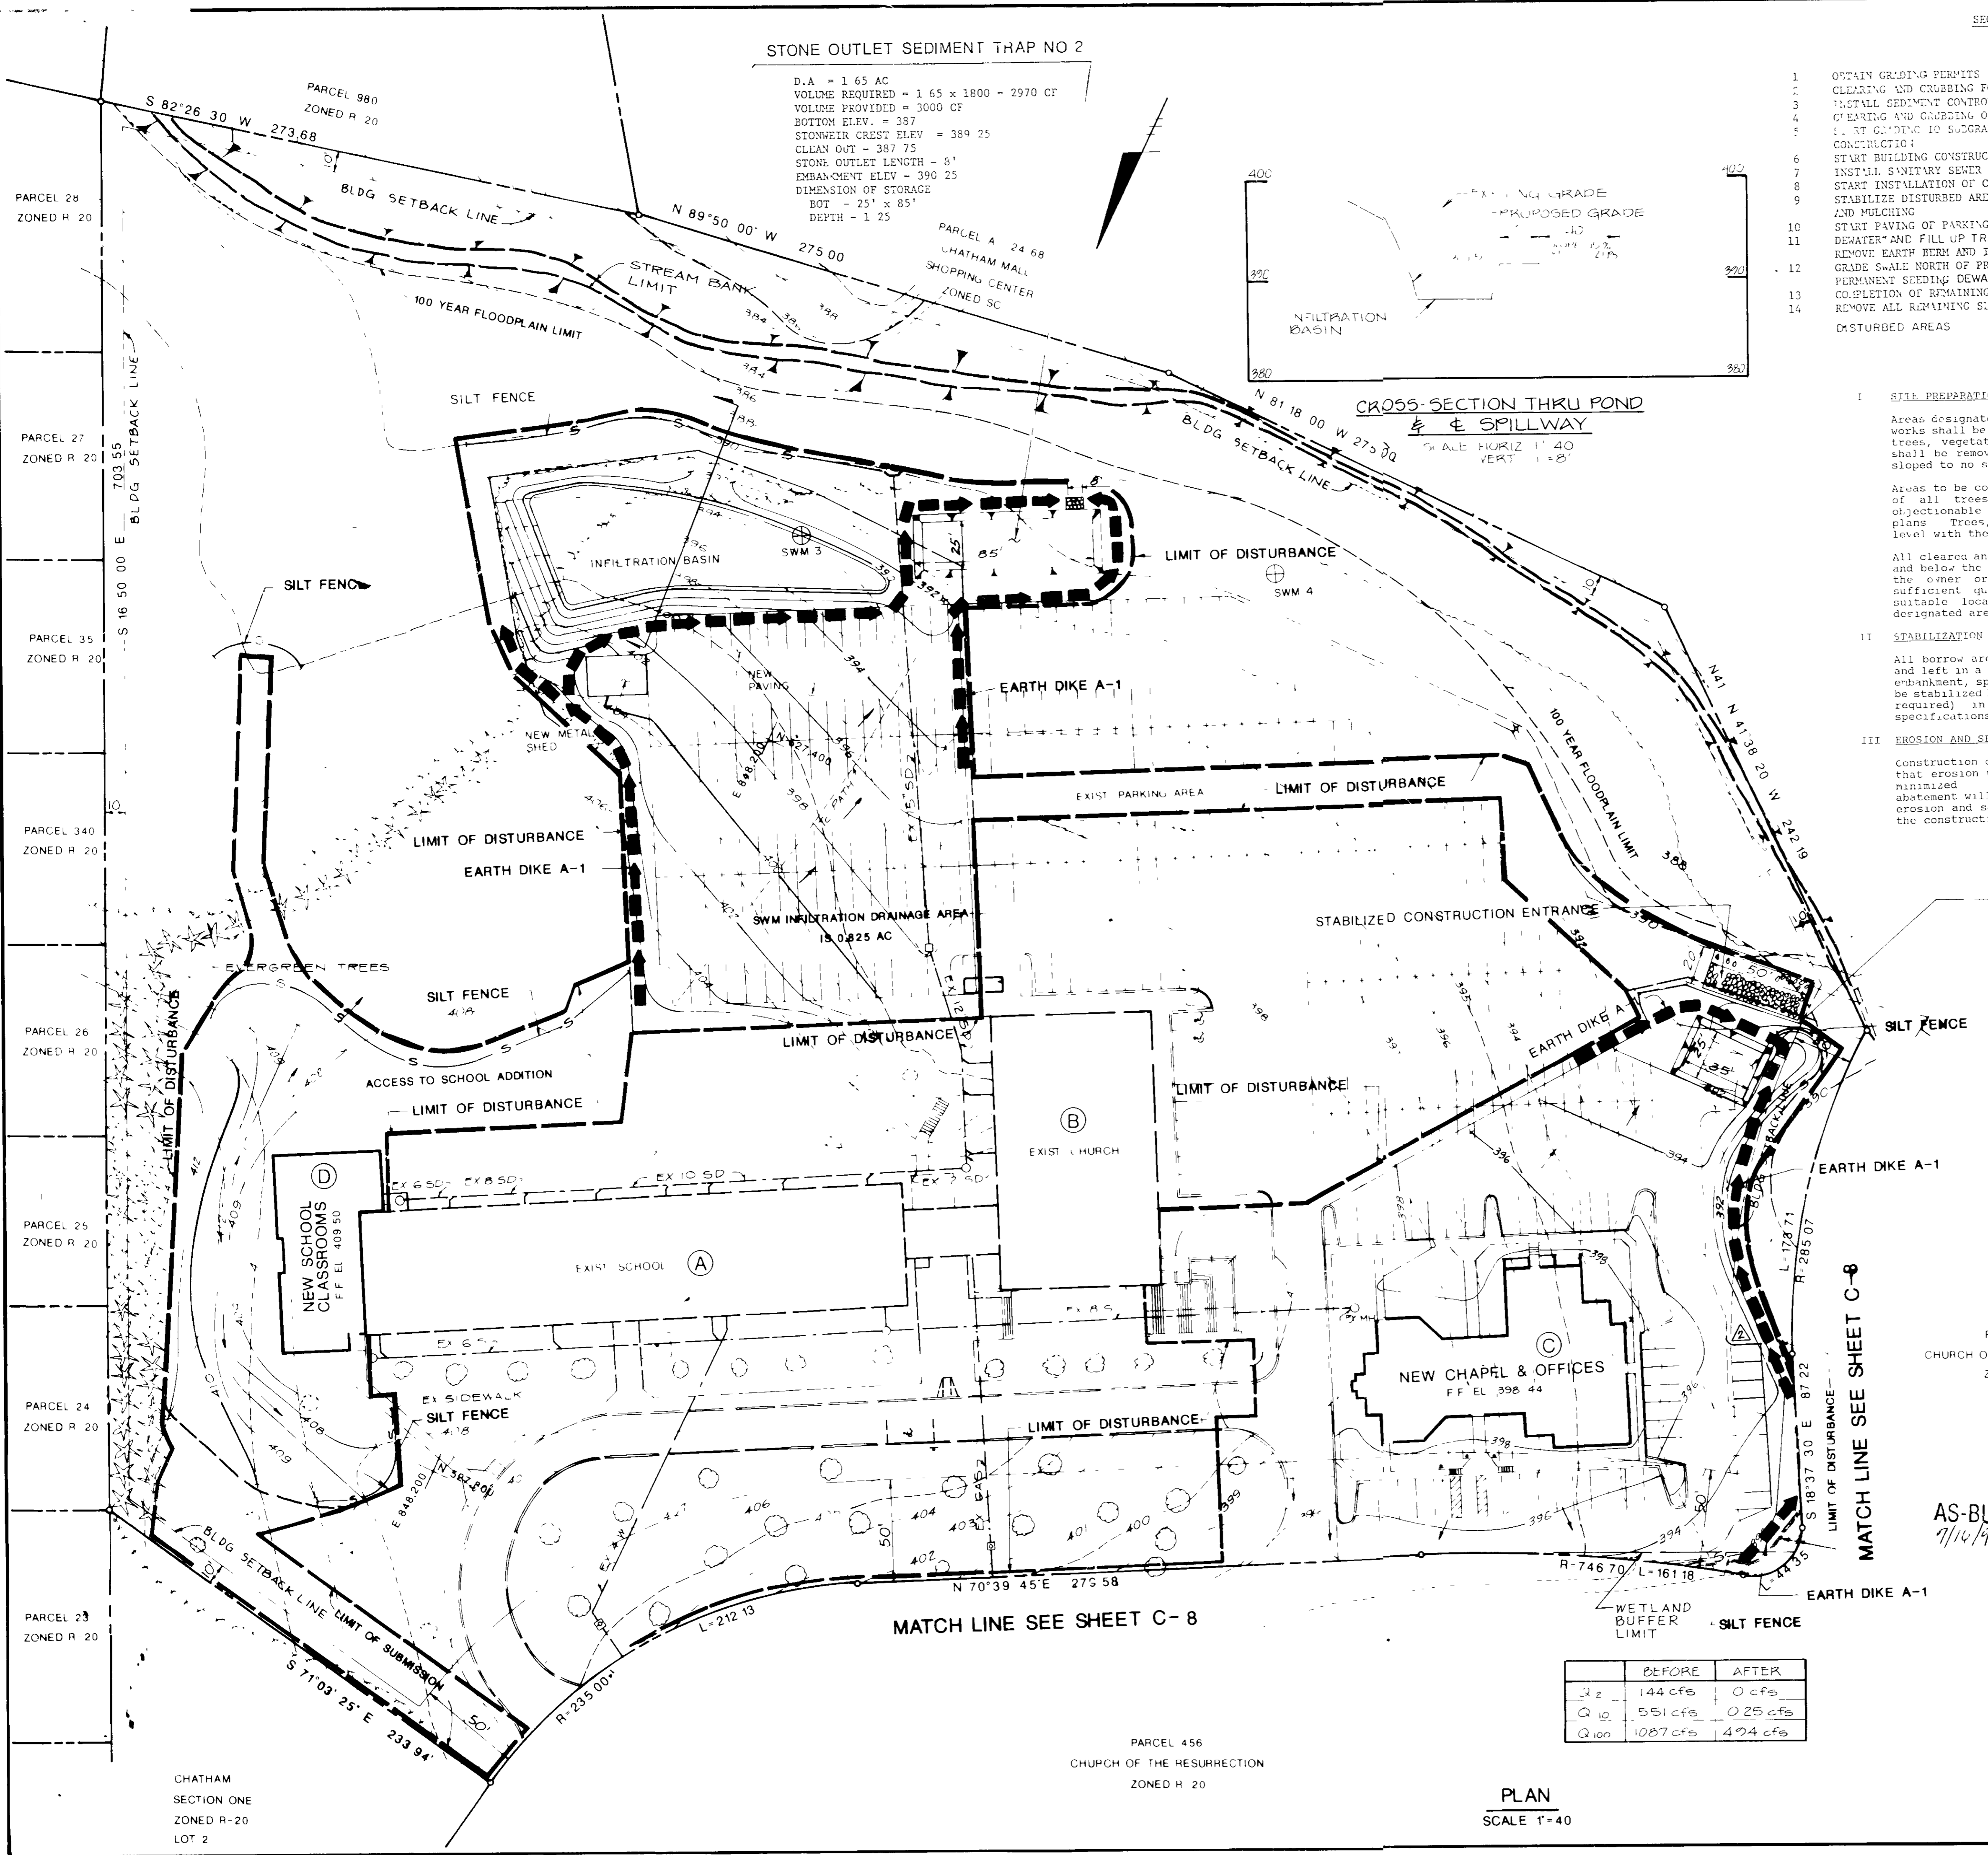

STONE OUTLET SEDIMENT TRAP NO 2

D.A = 1.65 AC
 VOLUME REQUIRED = 1.65 x 1800 = 2970 CF
 VOLUME PROVIDED = 3000 CF
 BOTTOM ELEV. = 387
 STONEWEIR CREST ELEV = 389.25
 CLEAN OUT = 387.75
 STONE OUTLET LENGTH = 6'
 EMBANKMENT ELEV = 390.25
 DIMENSION OF STORAGE
 BOT = 25' x 85'
 DEPTH = 1.25'

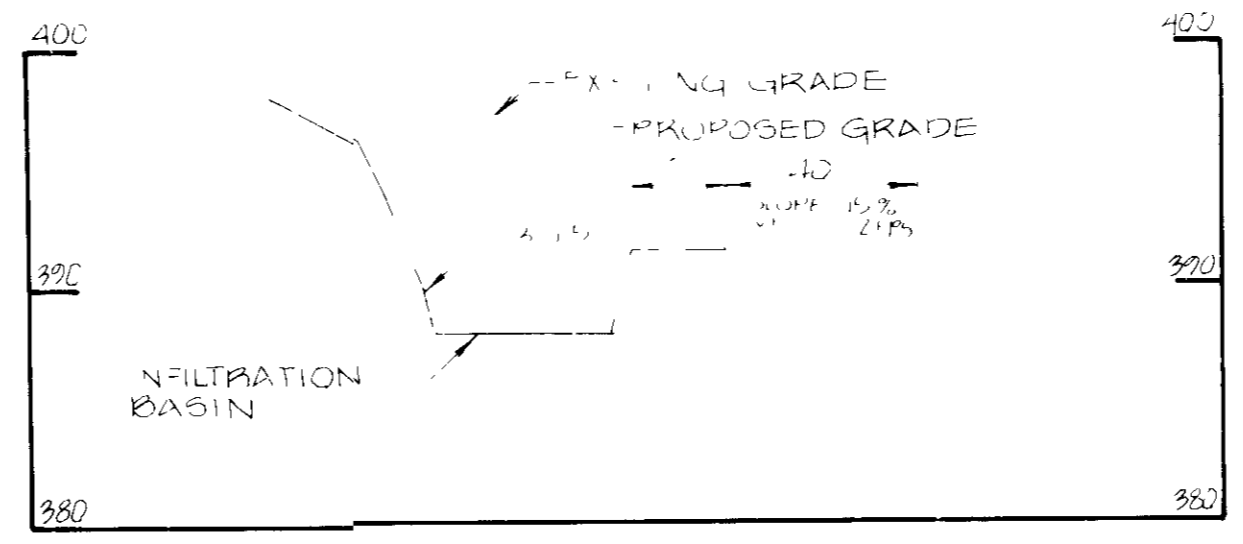

SEQUENCE OF CONSTRUCTION

- OBTAIN GRADING PERMITS
- CLEARING AND GRUBBING FOR THE INSTALLATION OF SILT FENCE
- INSTALL SEDIMENT CONTROL DEVICES
- GRADING AND GRUBBING OF SITES
- SET GRADING TO SUBGRADE AND EXCAVATION FOR BUILDING CONSTRUCTION
- START BUILDING CONSTRUCTION
- INSTALL SANITARY SEWER AND WATER MAIN
- START INSTALLATION OF CURB AND GUTTER
- STABILIZE DISTURBED AREAS NOT TO BE PAVED BY SEEDING AND MULCHING
- START PAVING OF PARKING AREAS AND TRAVELWAY
- DEWATER AND FILL UP TRAP #2 AND CONSTRUCT INFILTRATION BASIN AND STABILIZE
- REMOVE EARTH BERM AND INSTALL SILT FENCE WHERE NEEDED
- GRADE SWALE NORTH OF PROPOSED BUILDING AND STABILIZE BY PERMANENT SEEDING DEWATER & FILL UP TRAP #1 AND REMOVE EARTH DIKE
- COMPLETION OF REMAINING ACTIVITIES
- REMOVE ALL REMAINING SEDIMENT CONTROL DEVICES, AND STABILIZE DISTURBED AREAS

POUND CONSTRUCTION HOLD:

I. SILT PREPARATION

Areas designated for borrow areas, embankment, and structural works shall be cleared, grubbed and stripped of topsoil. All trees, vegetation, roots and other objectionable materials shall be removed. Channel banks and sharp breaks shall be sloped to no steeper than 1:1.

Areas to be covered by the pond or reservoir will be cleared of all trees, brush, logs, fences, rubbish and other objectionable materials unless otherwise designated on the plans. Trees, brush and stumps shall be cut approximately level with the ground surface.

All cleared and grubbed material shall be disposed of outside and below the limits of the dam and reservoir as directed by the owner or his representative. When specified, a sufficient quantity of topsoil will be stockpiled in a suitable location for use on the embankment and other designated areas.

II. STABILIZATION

All borrow areas shall be graded to provide proper drainage and left in a slightly condition. All exposed surfaces of the embankment, spillway, spoil and borrow areas, and berms shall be stabilized by seeding, liming, fertilizing and mulching (if required) in accordance with the vegetative treatment specifications or as shown on the accompanying drawings.

III. EROSION AND SEDIMENT CONTROL

Construction operations will be carried out in such a manner that erosion will be controlled and water and air pollution minimized. State and local laws concerning pollution abatement will be followed. Construction plans shall detail erosion and sediment control measures to be employed during the construction process.

STONE OUTLET SEDIMENT TRAP NO.1

DRAINAGE AREA=100 AC
 VOLUME REQUIRED=1800x100=180000 CF
 VOLUME PROVIDED=190000 CF
 BOTTOM ELEV=388.50
 STONE WEIR CREST ELEV=391.00
 CLEANOUT ELEV=389.50
 STONE OUTLET LENGTH=6
 EMBANKMENT ELEV=392.00
 DIMENSIONS OF STORAGE
 BOTTOM=25 x 35
 DEPTH=2

I certify that all development and/or construction will be done according to these plans, and that an responsible personnel involved in the construction project will have a Certificate of Attendance at a Department of the Environment Approved Training Program for the Control of Sediment and Erosion before starting the project. I will provide the Howard Soil Conservation District with an "as-built" plan of the pond within 30 days of completion. I also authorize periodic on-site inspections by the Howard Soil Conservation District.

Brian M Rafferty 8-22-89
 Signature of Developer Date
 Print name below signature
BRIAN M RAFFERTY
 by the Engineer

I certify that this plan for pond construction, erosion and sediment control represents a practical and workable plan based on my personal knowledge of the site conditions. This plan was prepared in accordance with the requirements of the Howard Soil Conservation District. I have notified the developer that he must provide the Howard Soil Conservation District with an "as-built" plan of the pond within 30 days of completion.

Philip Der 8/18/89
 Signature of Engineer Date
 Print name below signature
PHILIP DER

These plans have been reviewed for the Howard Soil Conservation District and meet the technical requirements for small pond construction, soil erosion and sediment control.

J. Helm 9/27/89
 Signature of Engineer Date
 Print name below signature
J. HELM
 U.S. Soil Conservation Service

These plans for small pond construction, soil erosion and sediment control meet the requirements of the Howard Soil Conservation District.

Robert J. Helm 9/29/89
 Signature of Engineer Date
 Print name below signature
ROBERT J. HELM
 Howard Soil Conservation District

The construction of the infiltration basin shall comply with the criteria set forth in the Department of the Environment's "Sediment Control Manual" dated July, 1987, and shall be as follows:

1. The infiltration basin shall be located away from the pond and shall be protected from storm water runoff by a berm or dike. The infiltration basin shall be protected from storm water runoff by a berm or dike. The infiltration basin shall be protected from storm water runoff by a berm or dike. The infiltration basin shall be protected from storm water runoff by a berm or dike.

	BEFORE	AFTER
Q ₂	144 cfs	0 cfs
Q ₁₀	551 cfs	0.25 cfs
Q ₁₀₀	1087 cfs	4.24 cfs

GENERAL REVISIONS (WBCM)

DATE	NO	REVISION
6/1/91	1	GENERAL REVISIONS (WBCM)
5/10/89	1	REVISED PER HO CO COMMENTS

APPROVED FOR PUBLIC WATER AND SEWERAGE:
 STORM DRAINAGE SYSTEMS AND PUBLIC ROADS
 HOWARD COUNTY DEPARTMENT OF PUBLIC WORKS

James J. Helm 11/22/89
 DIRECTOR DATE

APPROVED FOR PUBLIC WATER AND PUBLIC SEWER SYSTEMS:
 HOWARD COUNTY HEALTH DEPARTMENT

James M. Taylor 11/29/89
 HEALTH OFFICER DATE

APPROVED HOWARD COUNTY DEPARTMENT OF PLANNING & ZONING

James B. Smith 12/6/89
 DIRECTOR DATE

James S. Taylor 12/6/89
 DEPUTY DIVISION OF COMMUNITY PLANNING AND DEVELOPMENT DATE

OWNER: CHURCH OF THE RESURRECTION
 PAULSKIRK DRIVE & NORTH CHATHAM ROAD
 ELLICOTT CITY, MARYLAND 21043
 TEL: (301) 461-9111

PROJECT: SCHOOL & CHAPEL/OFFICE BUILDING ADDITIONS
CHURCH OF THE RESURRECTION
SEDIMENT CONTROL PLAN

2ND ELECTION DISTRICT HOWARD COUNTY, MD
 TAX MAP NO. 24 PARCEL 456, 1172, 4-200

ENGINEERS: WHITNEY, BAILEY, COX & MAGNANI
 CONSULTING ENGINEERS
 1850 YORK ROAD
 TAYLOR, MD 21083
 (301) 252-6060

DESIGNED: A R
DRAWN: GSB
CHECKED: P D
DATE: 10/13/88
SCALE: 1" = 40'
DRAWING NO: SHEET 7 OF 13
C-7

James S. Taylor 8/18/89
 DATE



AS-BUILT
 7/10/91

7-17-89

CHATHAM SECTION ONE
 ZONED R-20
 LOT 2

PARCEL 456
 CHURCH OF THE RESURRECTION
 ZONED R-20

PLAN
 SCALE 1"=40'

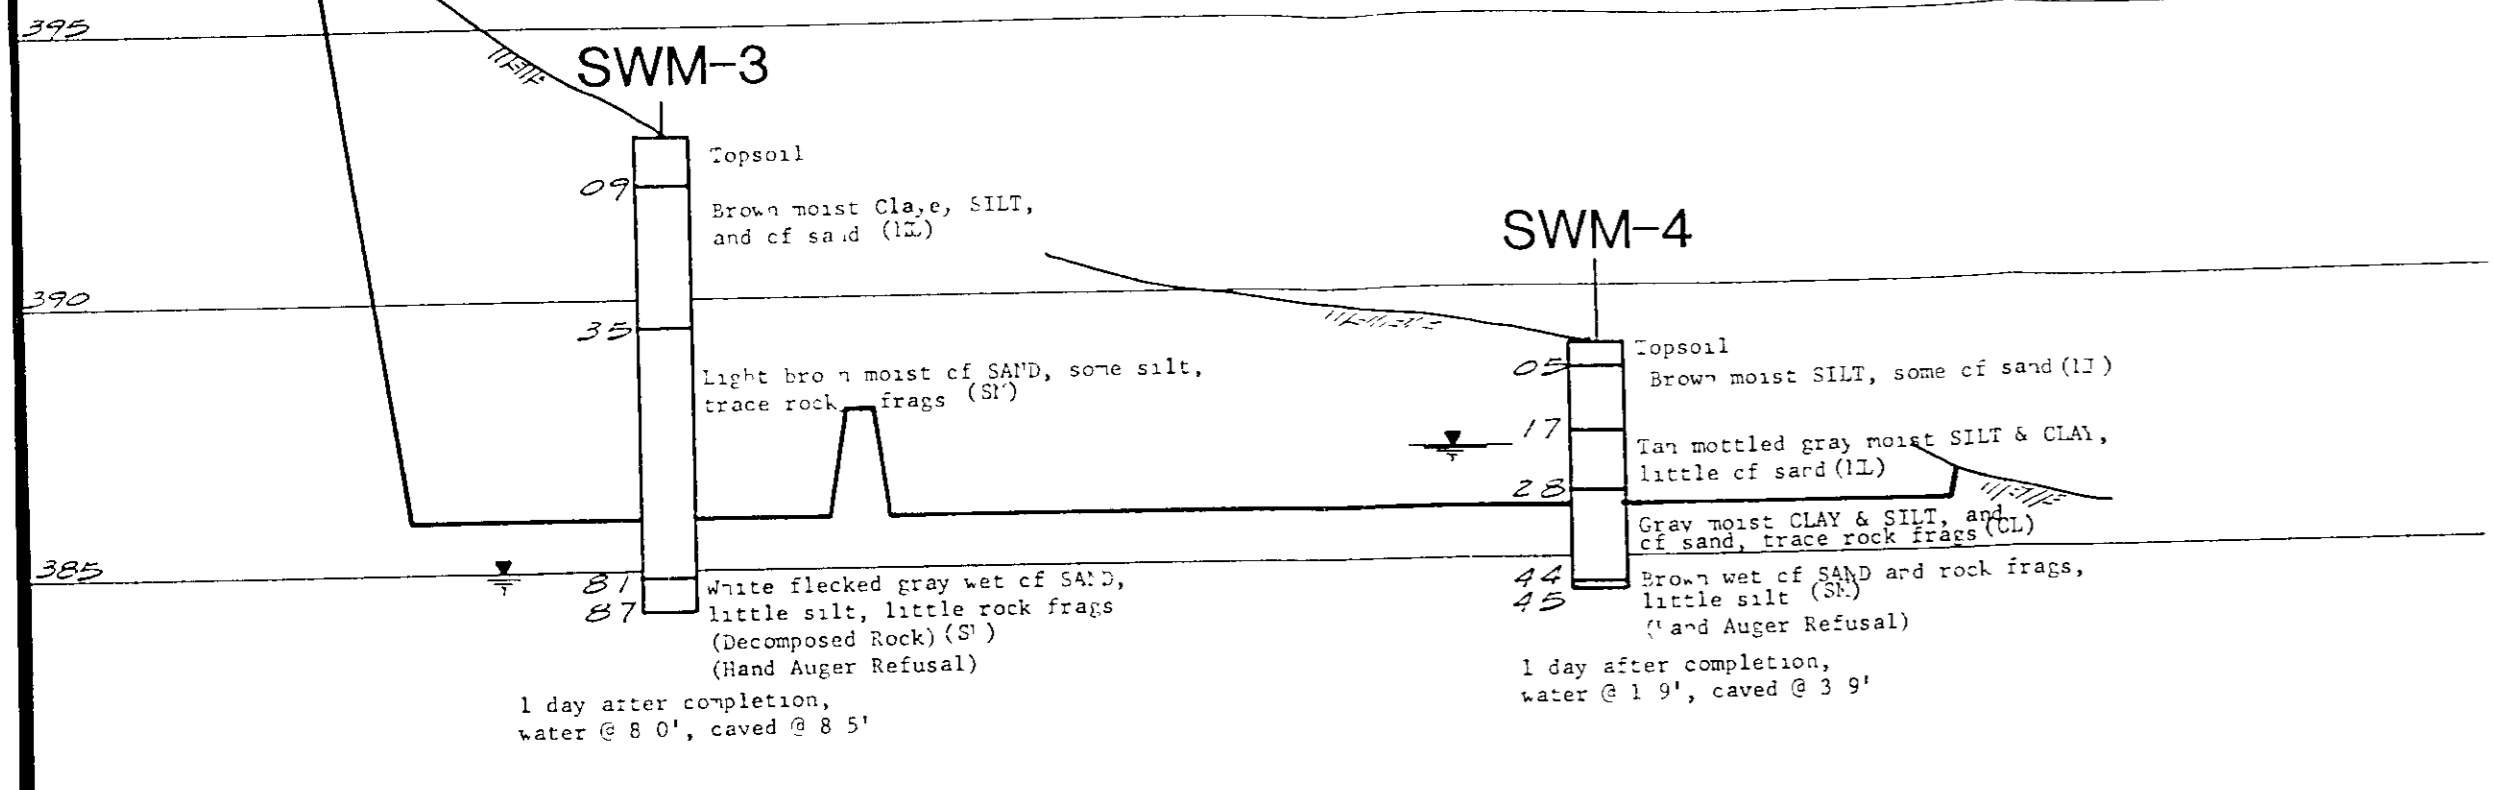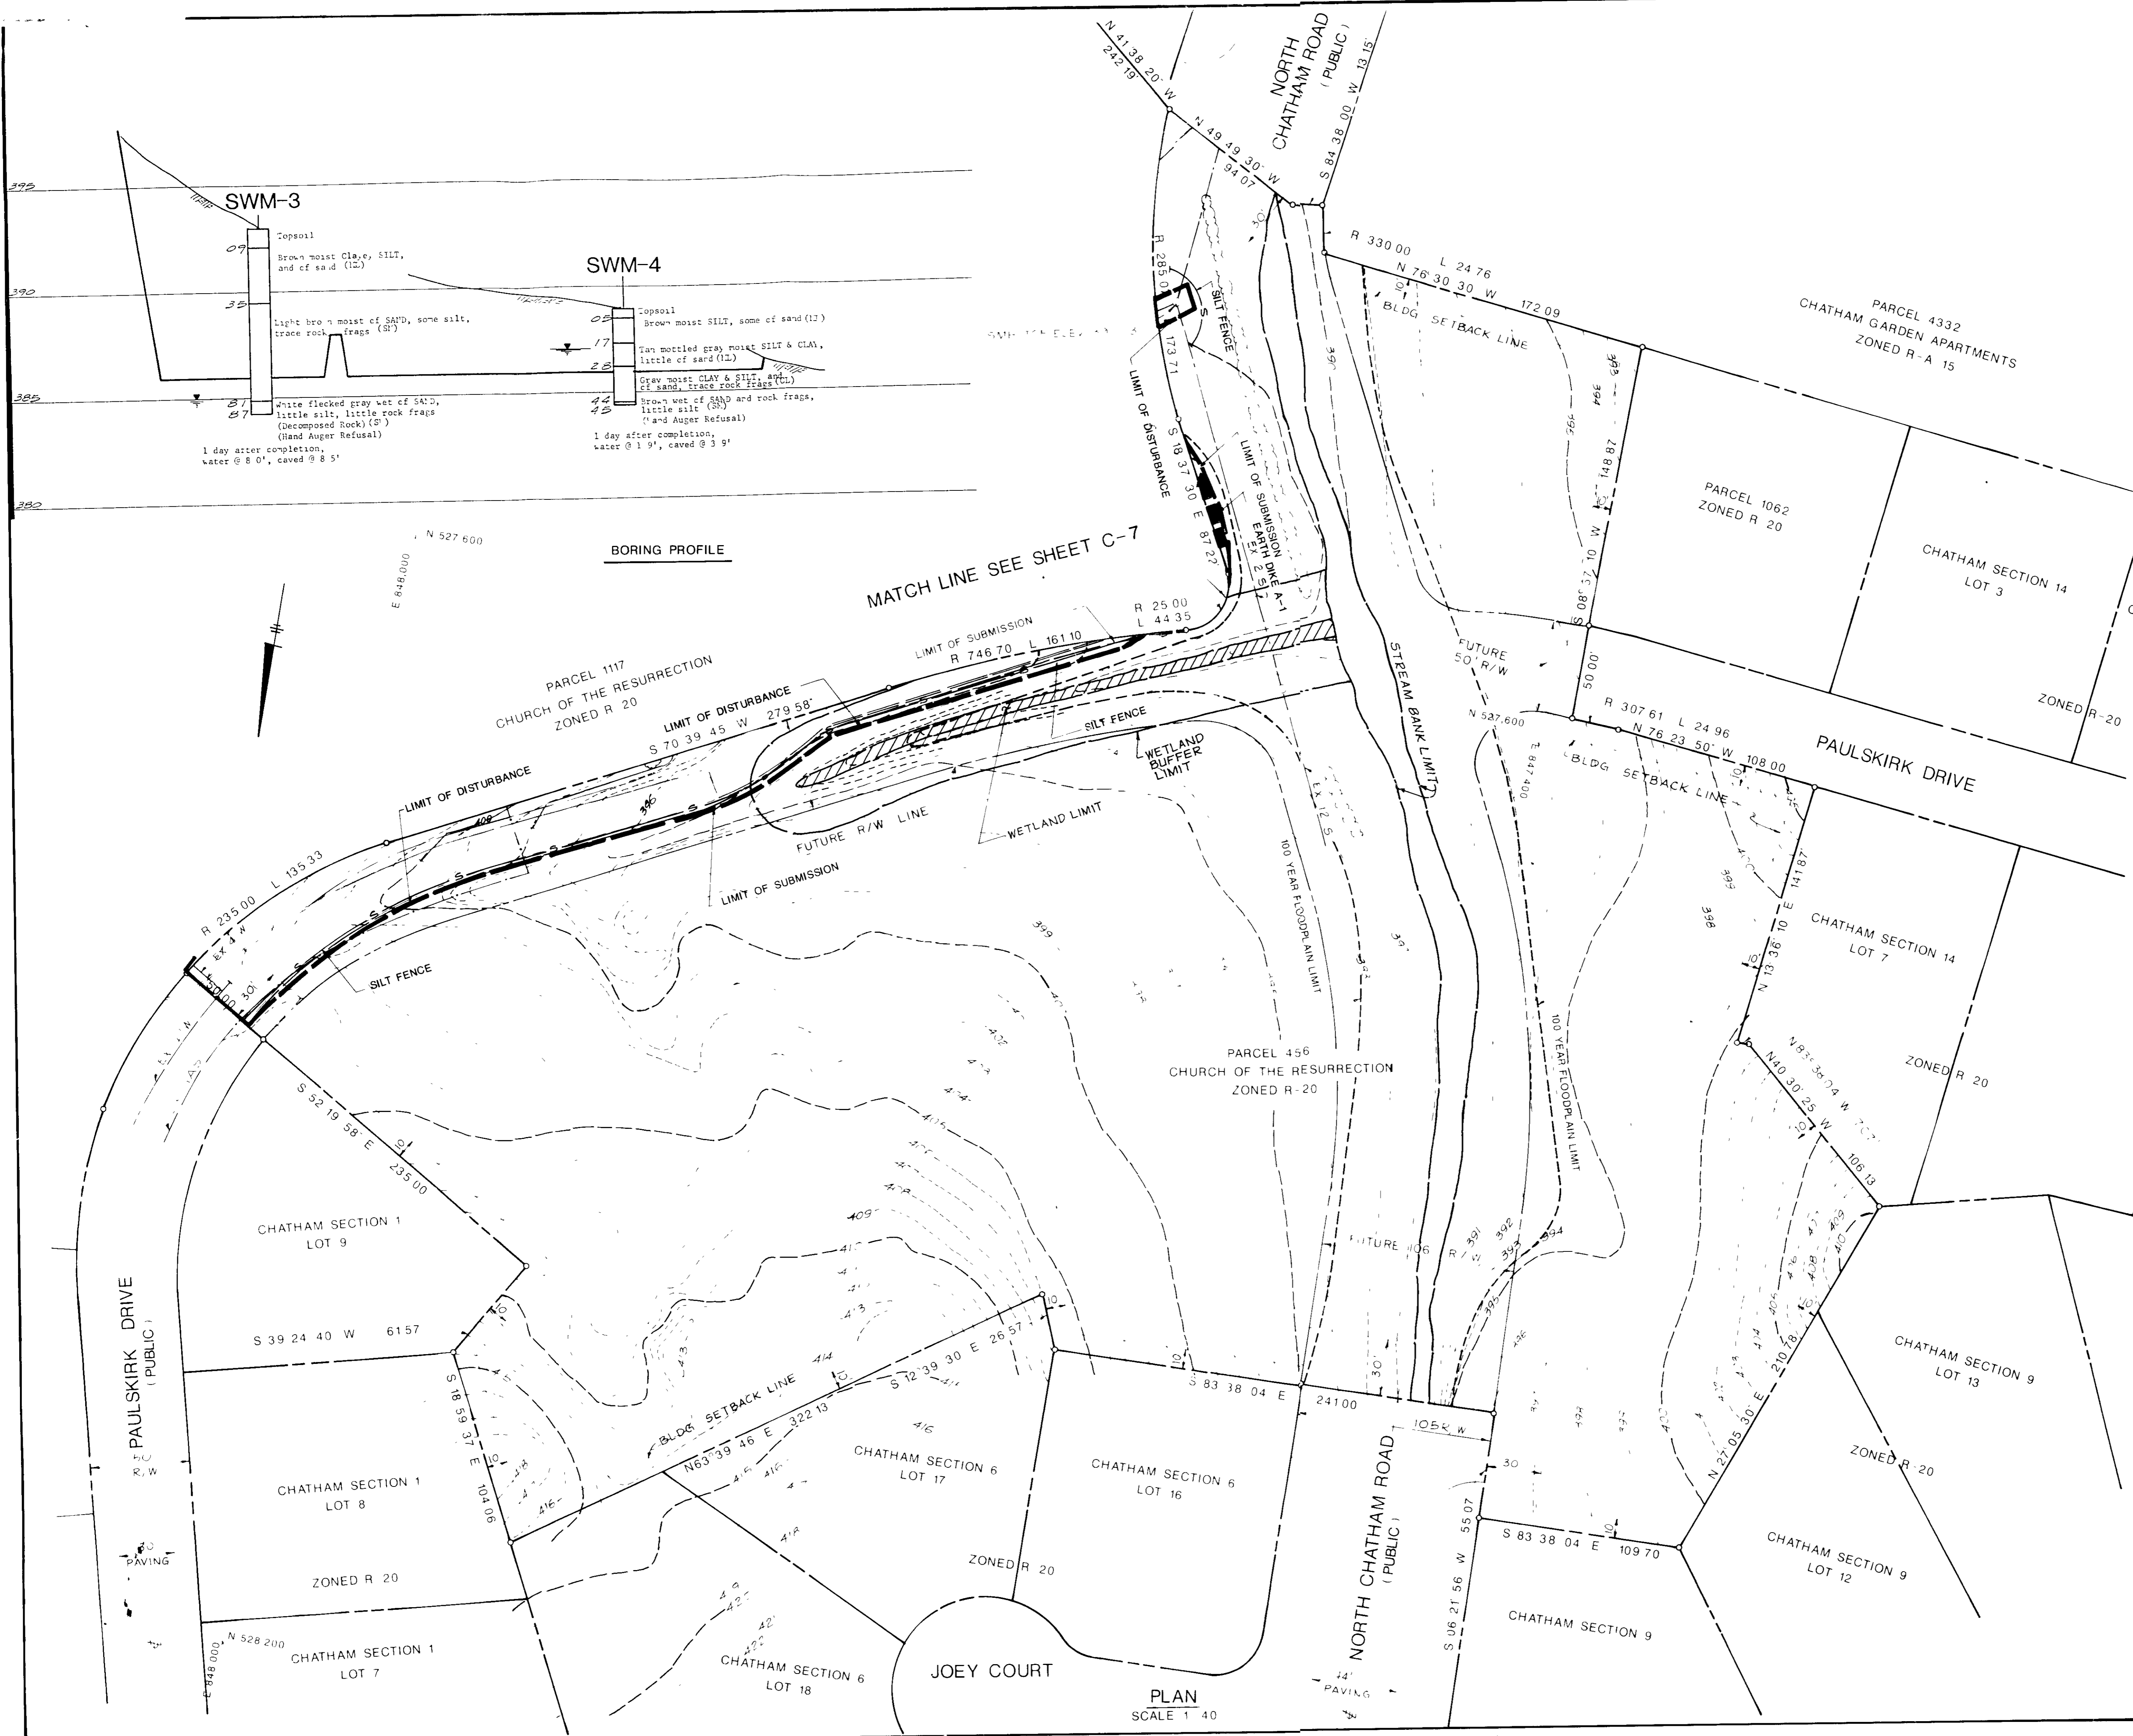

7-17-89

James J. Clark 11/22/89
 2
George M. Boyd and per John 11/29/89
Whitney, Bailey, Cox & Magnani 12/6/89
David J. ... 1/6/89

OWNER CHURCH OF THE RESURRECTION
 PAULSKIRK DRIVE & NORTH CHATHAM ROAD
 ELLICOTT CITY, MARYLAND 21043
 TEL (301) 461-9111


PROJECT SCHOOL AND CHAPEL/OFFICE BUILDING ADDITIONS
CHURCH OF THE RESURRECTION
 SEDIMENT CONTROL PLAN

2ND ELECTION DISTRICT HOWARD COUNTY MD
 TAX MAP NO 24 PARCEL 456, 1117 & 980

ENGINEERS WHITNEY, BAILEY, COX & MAGNANI
 CONSULTING ENGINEERS
 1850 YORK ROAD
 TIMONIUM, MD 21093
 (301) 252-6060

Philip ...
 1/2/89
 DATE

DESIGNED	A R
DRAWN	GSB
CHECKED	P D
DATE	10/13/88
SCALE	1 40
DRAWING NO	SHEET 8 OF 13
	C-8

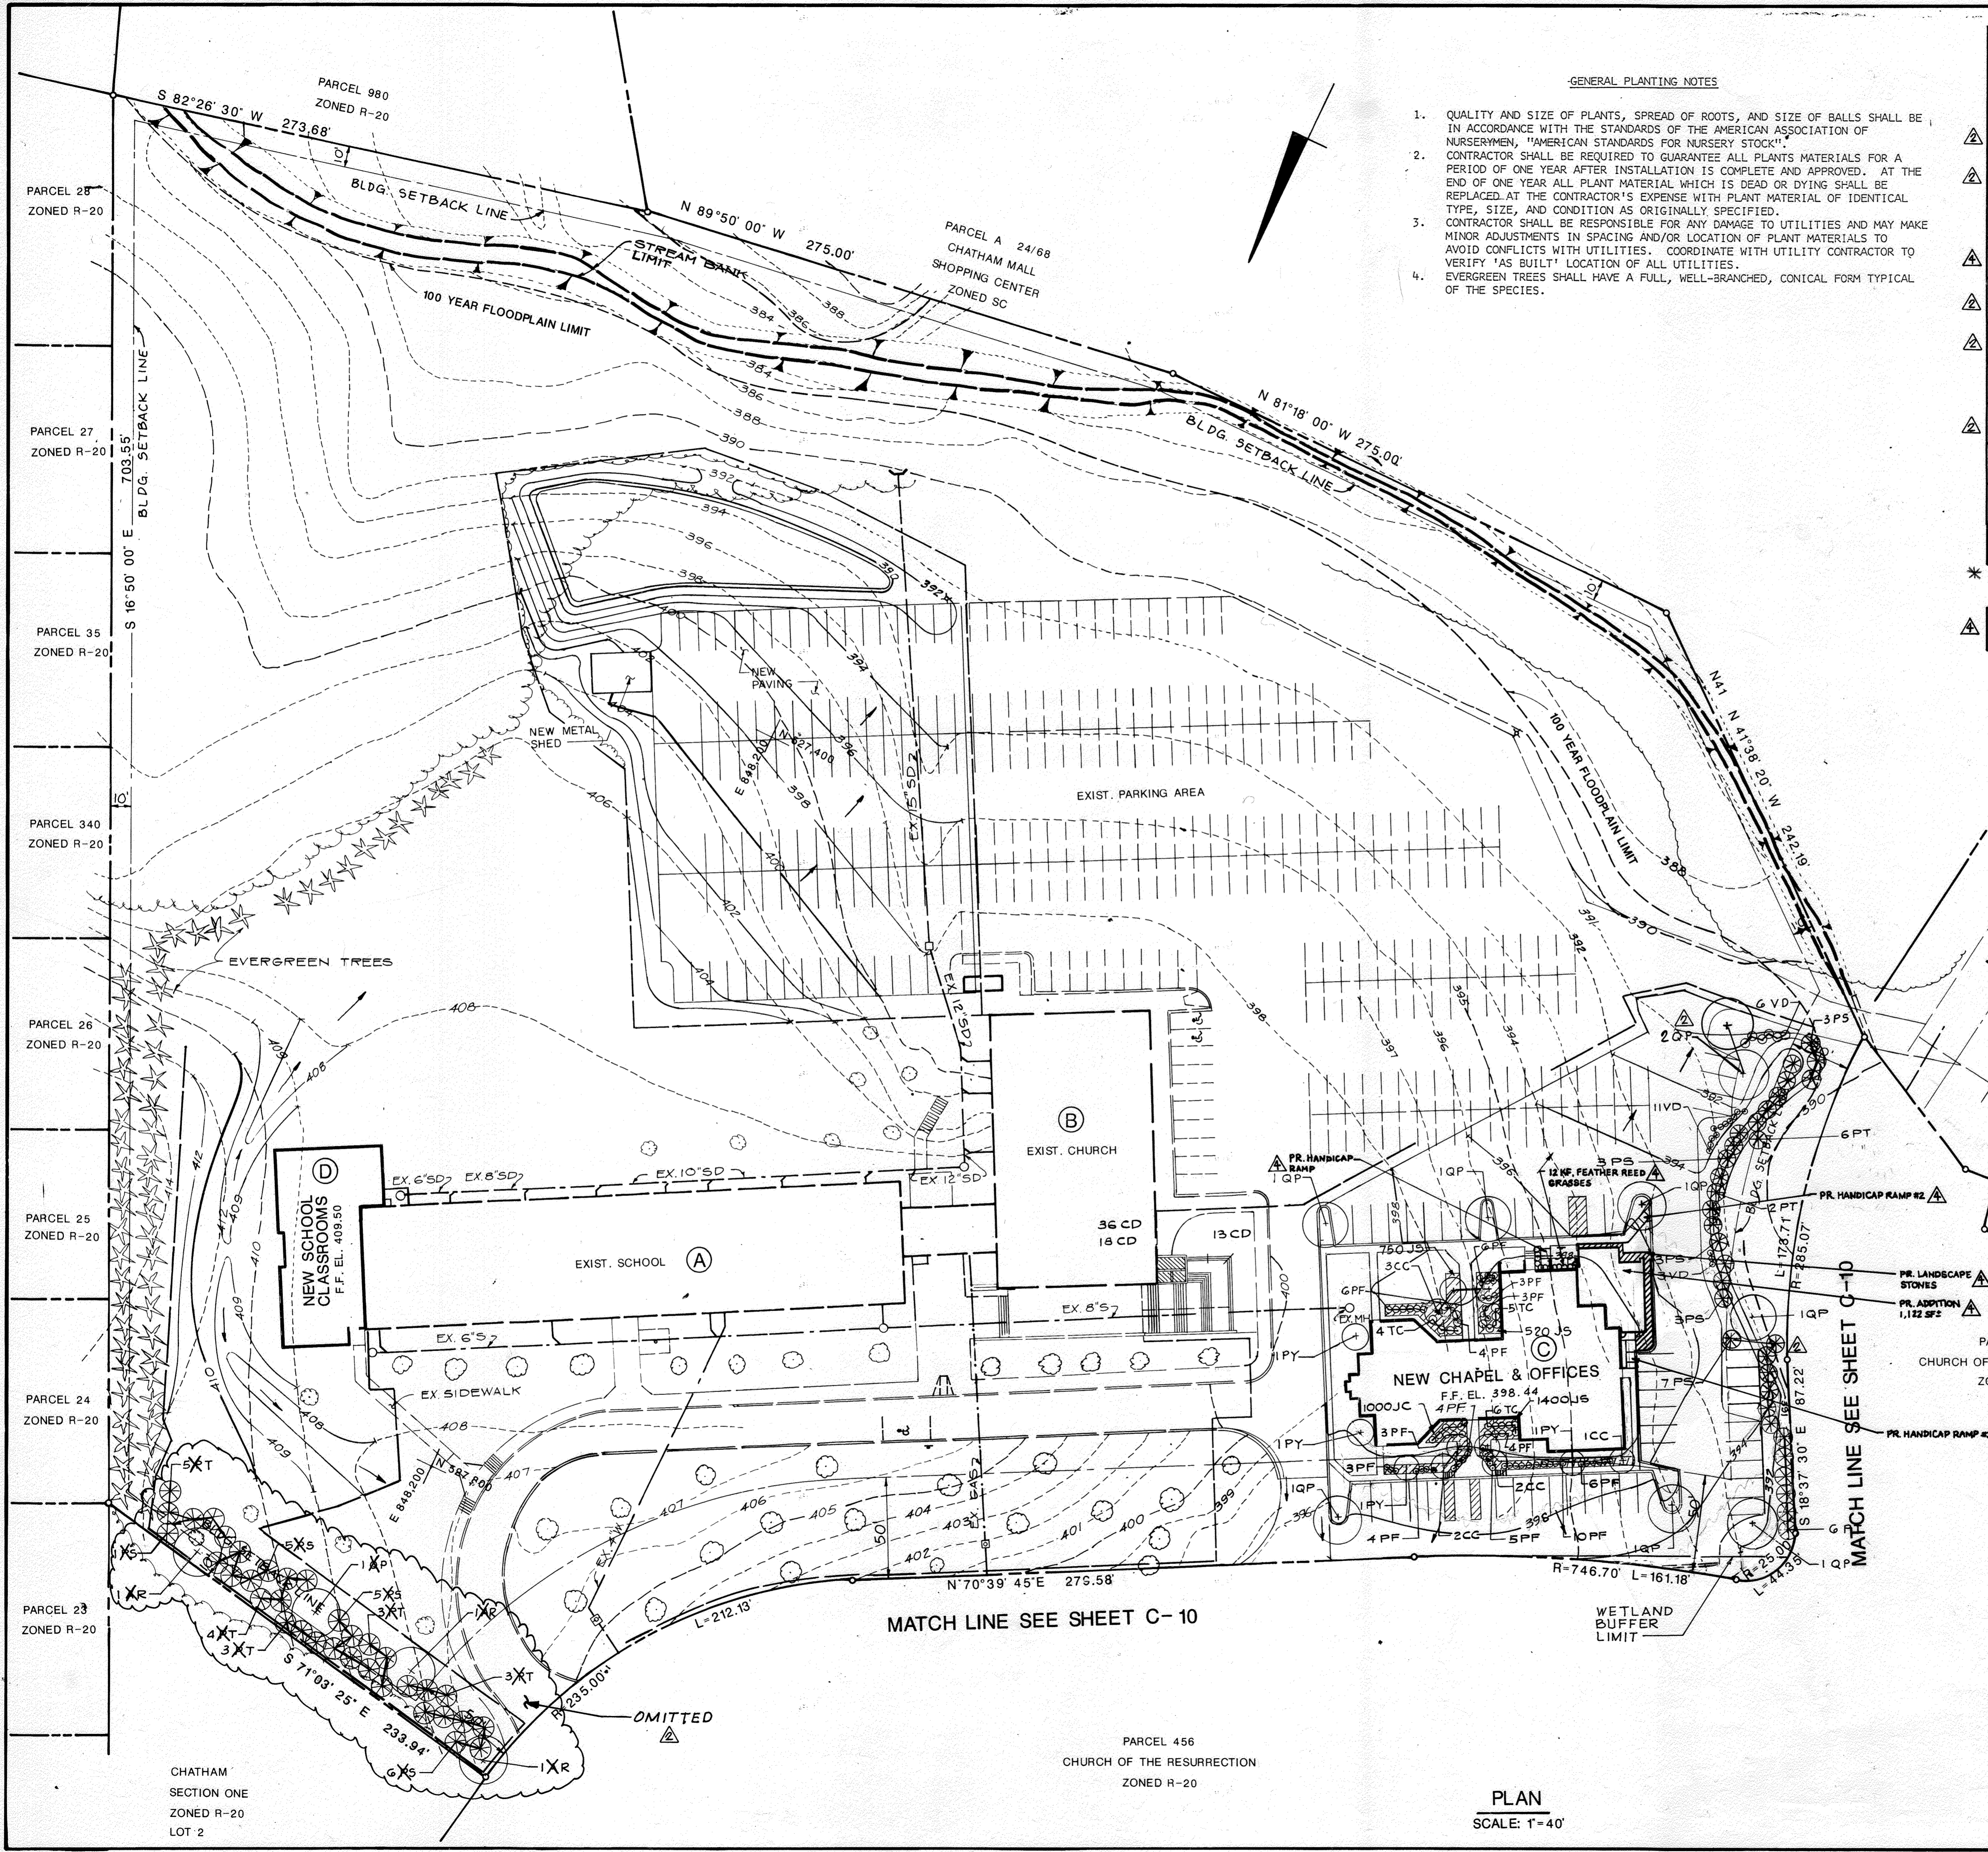

GENERAL PLANTING NOTES

1. QUALITY AND SIZE OF PLANTS, SPREAD OF ROOTS, AND SIZE OF BALLS SHALL BE IN ACCORDANCE WITH THE STANDARDS OF THE AMERICAN ASSOCIATION OF NURSERYMEN, "AMERICAN STANDARDS FOR NURSERY STOCK".
2. CONTRACTOR SHALL BE REQUIRED TO GUARANTEE ALL PLANTS MATERIALS FOR A PERIOD OF ONE YEAR AFTER INSTALLATION IS COMPLETE AND APPROVED. AT THE END OF ONE YEAR ALL PLANT MATERIAL WHICH IS DEAD OR DYING SHALL BE REPLACED AT THE CONTRACTOR'S EXPENSE WITH PLANT MATERIAL OF IDENTICAL TYPE, SIZE, AND CONDITION AS ORIGINALLY SPECIFIED.
3. CONTRACTOR SHALL BE RESPONSIBLE FOR ANY DAMAGE TO UTILITIES AND MAY MAKE MINOR ADJUSTMENTS IN SPACING AND/OR LOCATION OF PLANT MATERIALS TO AVOID CONFLICTS WITH UTILITIES. COORDINATE WITH UTILITY CONTRACTOR TO VERIFY 'AS BUILT' LOCATION OF ALL UTILITIES.
4. EVERGREEN TREES SHALL HAVE A FULL, WELL-BRANCHED, CONICAL FORM TYPICAL OF THE SPECIES.

PLANT SCHEDULE

KEY	QUAN.	BOTANICAL NAME COMMON NAME	SIZE	COND.	REMARKS
TREES:					
QP	9	QUERCUS PHELLOWS WILLOW OAK	2 1/2-3" CAL	B+B	*
AR	0	ACER RUBRUM 'OCTOBER GLORY' OCTOBER GLORY RED MAPLE	2 1/2-3" CAL	B+B	
CC	8	CERCIS CANADENSIS EASTERN REDBUD	8-10'	B+B	HEAVY
PV	24	PRUNUS VEDDENSIS YOSHINO CHEERY	1 3/4-2" CAL	B&B	HEAVY
PT	13	PINUS THUNBERGIANA JAPANESE BLACK PINE	8-10'	B+B	*
PS	19	PINUS STROBUS WHITE PINE	6-8'	B&B	*
VD	20	VIBURNUM DILATATUM LINDEN VIBURNUM	3-4'	B&B	
TC	50	TAXUS CUSPIDATA 'NANA' DWARF JAPANESE VEW	2-2 1/2'	B&B	
PF	61	POTENTILLA FRUITICOSA 'KATHERINE DYKES' BUSH CINQUEFOIL	12-18"	CONT	
JS	3670	PACHYSANDRA TERMINALIS JAPANESE SPURGE	4-6"	CONT	PLANT 8" O.C. STAGGERED
CD	67	COTONEASTER DAMMERI CHRISTMAS CARPET COTONEASTER	15"-18"	CONT.	PLANT 18" O.C. STAGGERED
* NOTE: ALL PROPOSED TREES (PS, PT, & QP) ALONG NORTH CHATHAM ROAD (FUTURE) SHALL BE 2 1/2" MIN. CALIPER SIZE.					
KF	12	CALAMAGROSTIS KARL FOERSTER FEATHER REED GRASS	24"	CONT.	

08/04/2021	REVISION ADDITION TO CHAPEL AND OFFICE BUILDING, ADD HANDICAP STAIRS
02/09/2021	ADD ADDITION TO CHAPEL AND OFFICE BUILDING AND LANDSCAPING
6/7/19	GENERAL REVISIONS (WBCM)
5/10/09	REVISED PER HO. CO COMMENTS
DATE: NO.	REVISION
APPROVED: FOR PUBLIC WATER AND SEWERAGE, STORM DRAINAGE SYSTEMS AND PUBLIC ROADS HOWARD COUNTY DEPARTMENT OF PUBLIC WORKS	
<i>James M. ...</i>	11/22/89 DATE
APPROVED: FOR PUBLIC WATER AND PUBLIC SEWER SYSTEMS HOWARD COUNTY HEALTH DEPARTMENT	
<i>James M. ...</i>	11/29/89 DATE
APPROVED: HOWARD COUNTY DEPT. OF PLANNING AND ZONING	
<i>James M. ...</i>	12/6/89 DATE
APPROVED: DIVISION OF COMMUNITY PLANNING AND DEVELOPMENT	
<i>James M. ...</i>	12/14/89 DATE

OWNER: CHURCH OF THE RESURRECTION
PAULSKIRK DRIVE & NORTH CHATHAM ROAD
ELLCOTT CITY, MARYLAND 21043
TEL. (301) 461-9111

PROJECT: SCHOOL & CHAPEL/OFFICE BUILDING ADDITIONS
CHURCH OF THE RESURRECTION
LANDSCAPING PLAN

2ND ELECTION DISTRICT HOWARD COUNTY, MD.
TAX MAP NO. 24 PARCEL 456, 1117 & 980


ENGINEERS: WHITNEY, BAILEY, COX & MAGNANI
CONSULTING ENGINEERS
1850 YORK ROAD
TIMONIUM, MD. 21093
(301) 252-6060

APPROVED
DIVISION OF
COMMUNITY PLANNING
& LAND DEVELOPMENT
HOWARD COUNTY,
MARYLAND
DATE 7-17-89

DESIGNED:	A.R.
DRAWN:	GSB
CHECKED:	P.D.
DATE:	10/13/88
SCALE:	1" = 40'
DRAWING NO:	SHEET 9 OF 13 C-9

PLAN
SCALE: 1" = 40'

CHATHAM
SECTION ONE
ZONED R-20
LOT 2

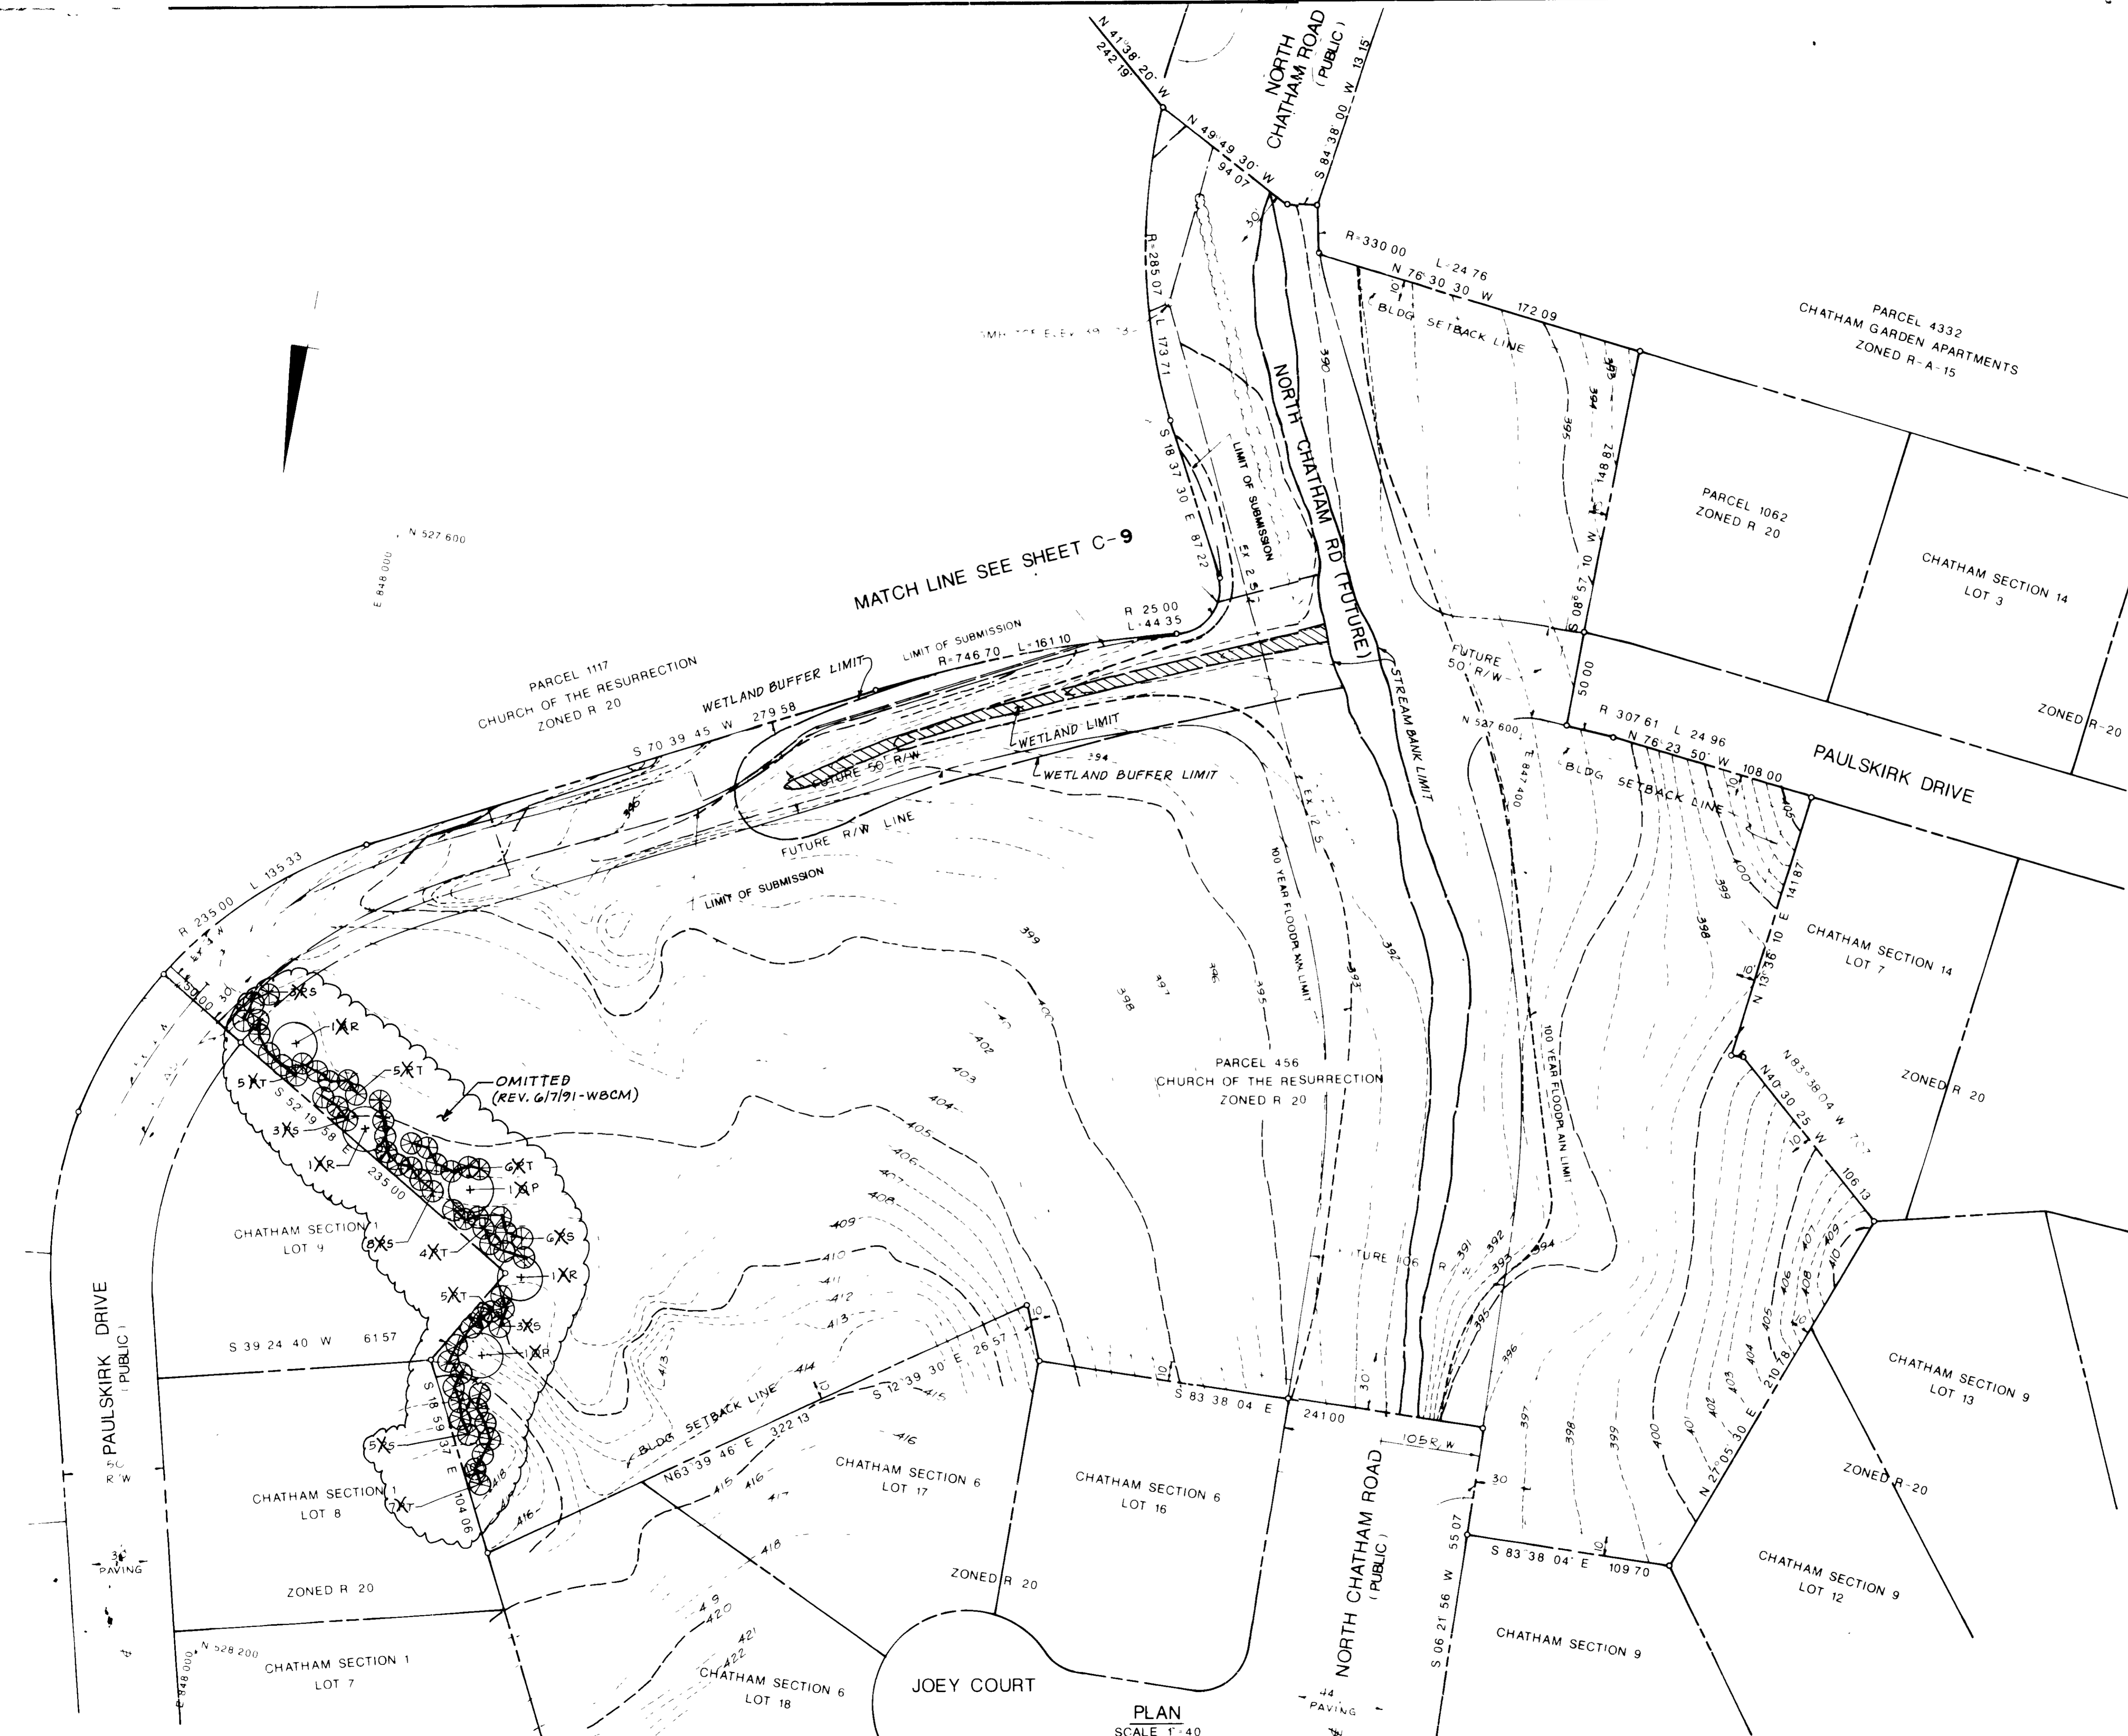


MATCH LINE SEE SHEET C-9

PLAN
SCALE 1" = 40'

7-17-89

<i>James J. [Signature]</i>	11/22/89
<i>[Signature]</i>	11-20-89
<i>James M. [Signature]</i>	11/29/89
<i>[Signature]</i>	12/6/89
<i>[Signature]</i>	7/1/89
OWNER CHURCH OF THE RESURRECTION PAULSKIRK DRIVE & NORTH CHATHAM ROAD ELLCOTT CITY, MARYLAND 21043 TEL. (301) 461-9111	
PROJECT SCHOOL AND CHAPEL/OFFICE BUILDING ADDITIONS CHURCH OF THE RESURRECTION LANDSCAPING PLAN	
2ND ELECTION DISTRICT TAX MAP NO 24	HOWARD COUNTY MD PARCEL 456, 1117 & 980
ENGINEERS WHITNEY, BAILEY, COX & MAGNANI CONSULTING ENGINEERS 1850 YORK ROAD TIMONIUM, MD 21093 (301) 252-6060	
<i>[Signature]</i>	DESIGNED A R
	DRAWN GSB
	CHECKED P D
	DATE 10/13/88
	SCALE 1" = 40'
	DRAWING NO. SHEET 10 OF 13 C-10

SDP-89-76

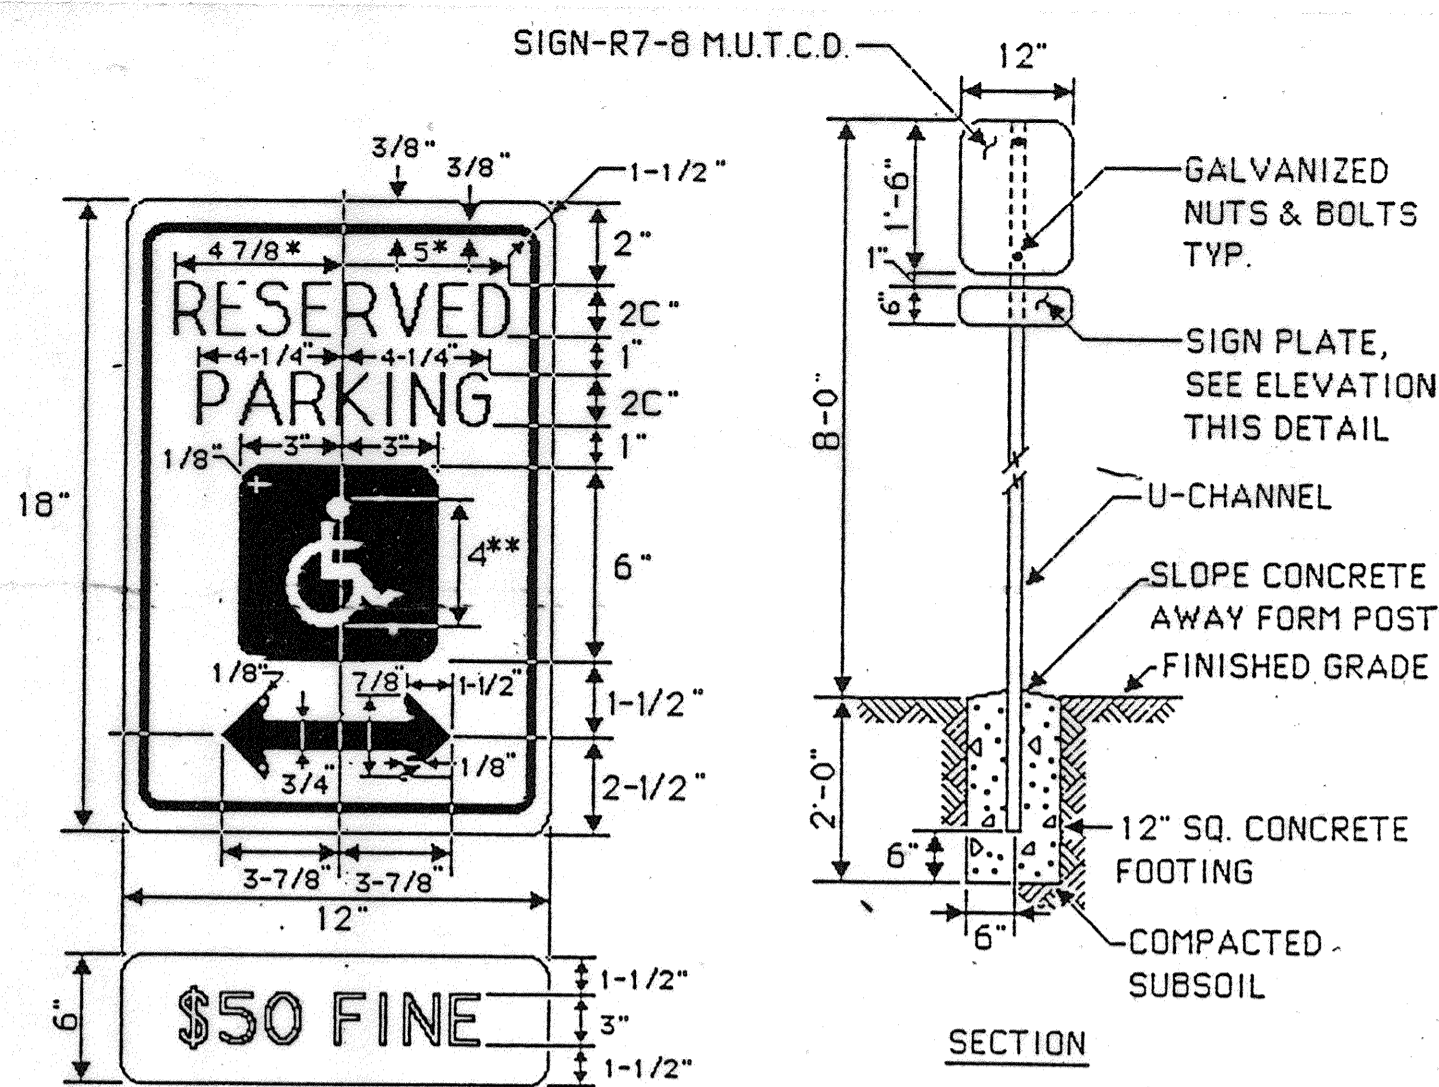


NOTE: PROVIDE ONE SIGN AND POST PER HANDICAP PARKING SPACE, SEE PLAN.

COLORS:
LEGEND & BORDER - GREEN
WHITE SYMBOL ON BLUE BACKGROUND
BACKGROUND - WHITE

* REDUCE SPACING 50%
** SEE SYMBOL 186d FOR SYMBOL DESIGN


1 HANDICAPPED SIGN

NOTE: PAINT IS TO BE WHITE TRAFFIC PAINT APPLIED IN ACCORDANCE WITH THE MANUFACTURER'S RECOMMENDATIONS. (TWO (2) COATS REQUIRED)

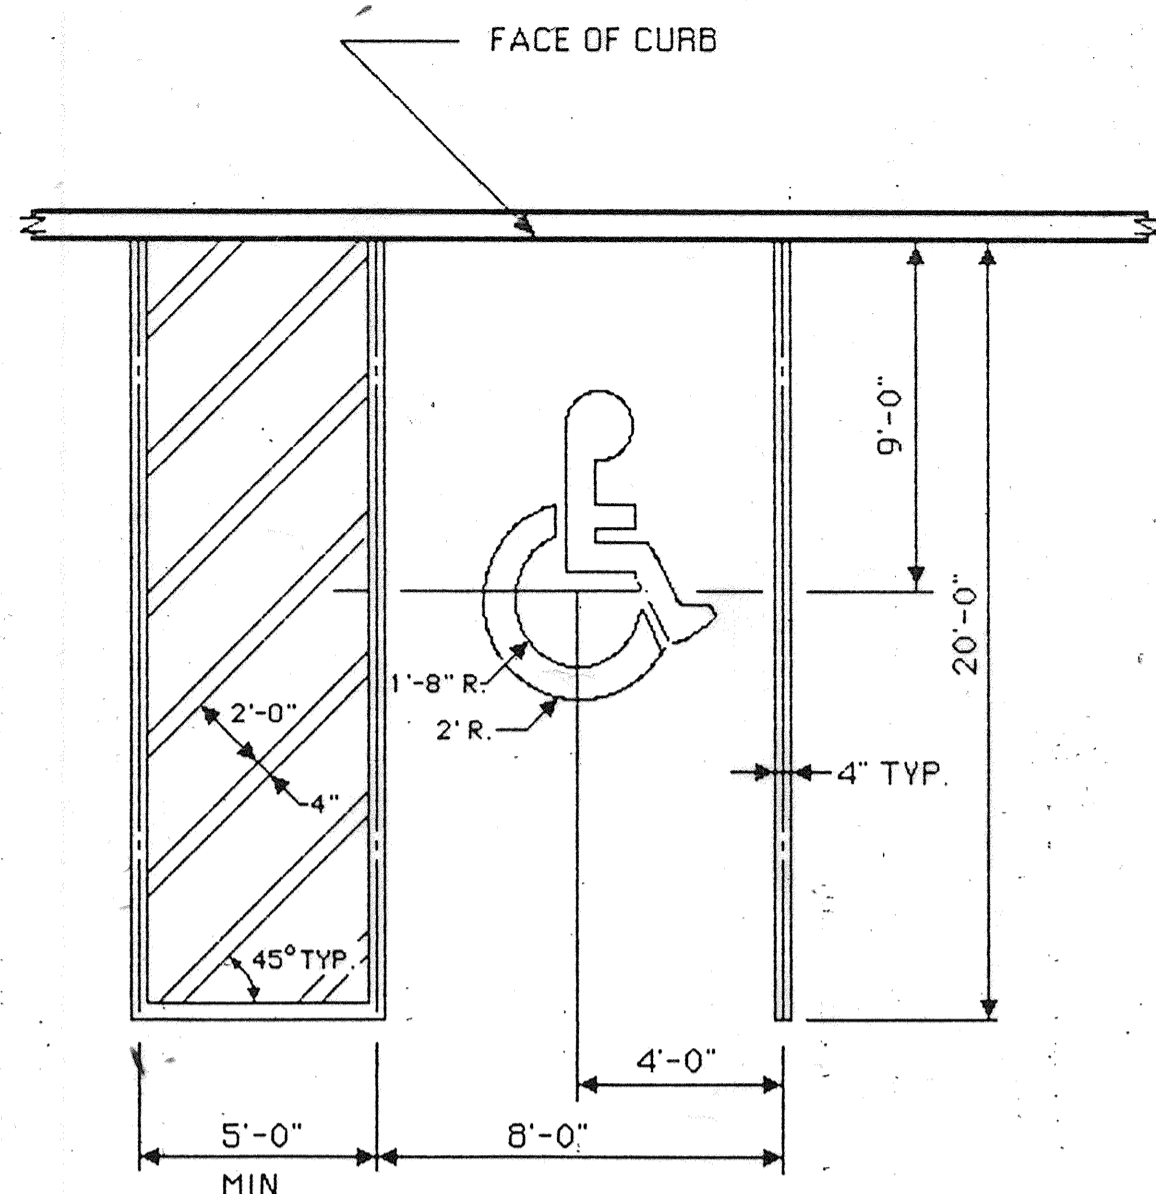


2 HANDICAPPED STRIPING

3 BITUMINOUS CONCRETE PAVING SECTIONS

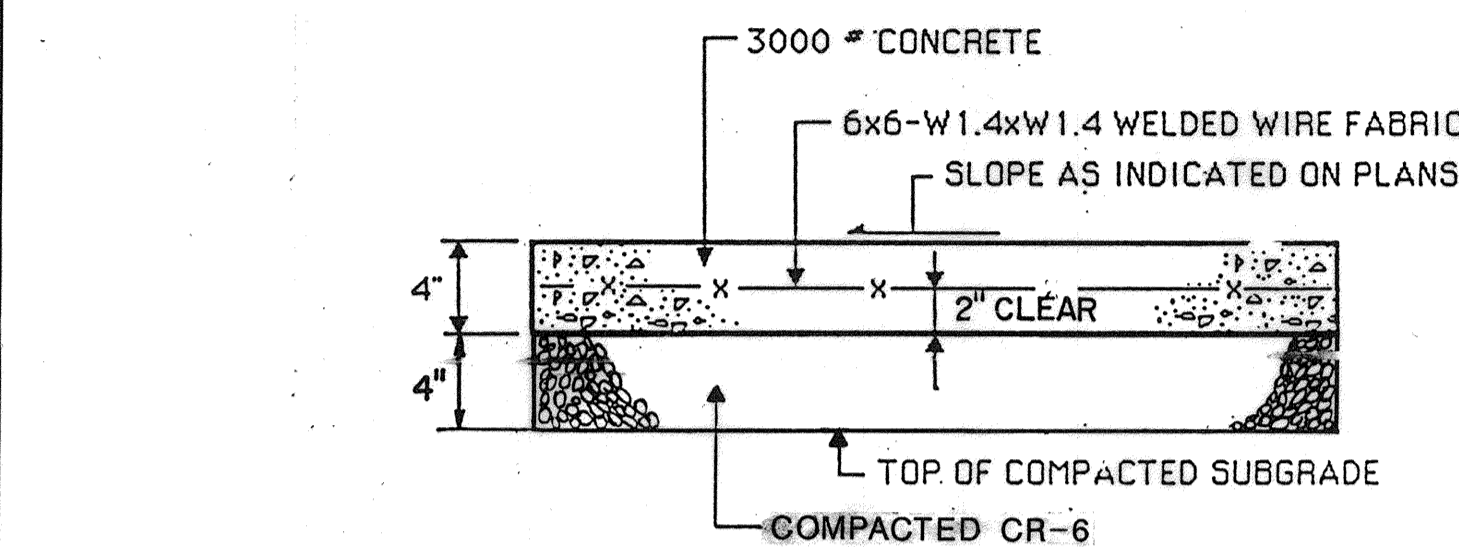


NOTE:
1. 1/2" PREMOLDED EXPANSION JOINT MATERIAL TO BE PLACED WHERE WALKS ABUT CURBS, STEPS, BUILDINGS, OTHER WALKS, ETC. AND AT A MAXIMUM OF 20' INTERVALS ALONG THE WALK.
2. SCORING SHALL BE AS PROVIDED AT 4' ON CENTER FOR 4' & 8' WALKS, 5' ON CENTER FOR 5' & 10' WALKS, AND 6' ON CENTER FOR 6' AND LARGER, NOT PREVIOUSLY MENTIONED.


6 CONCRETE SIDEWALK (REINFORCED)

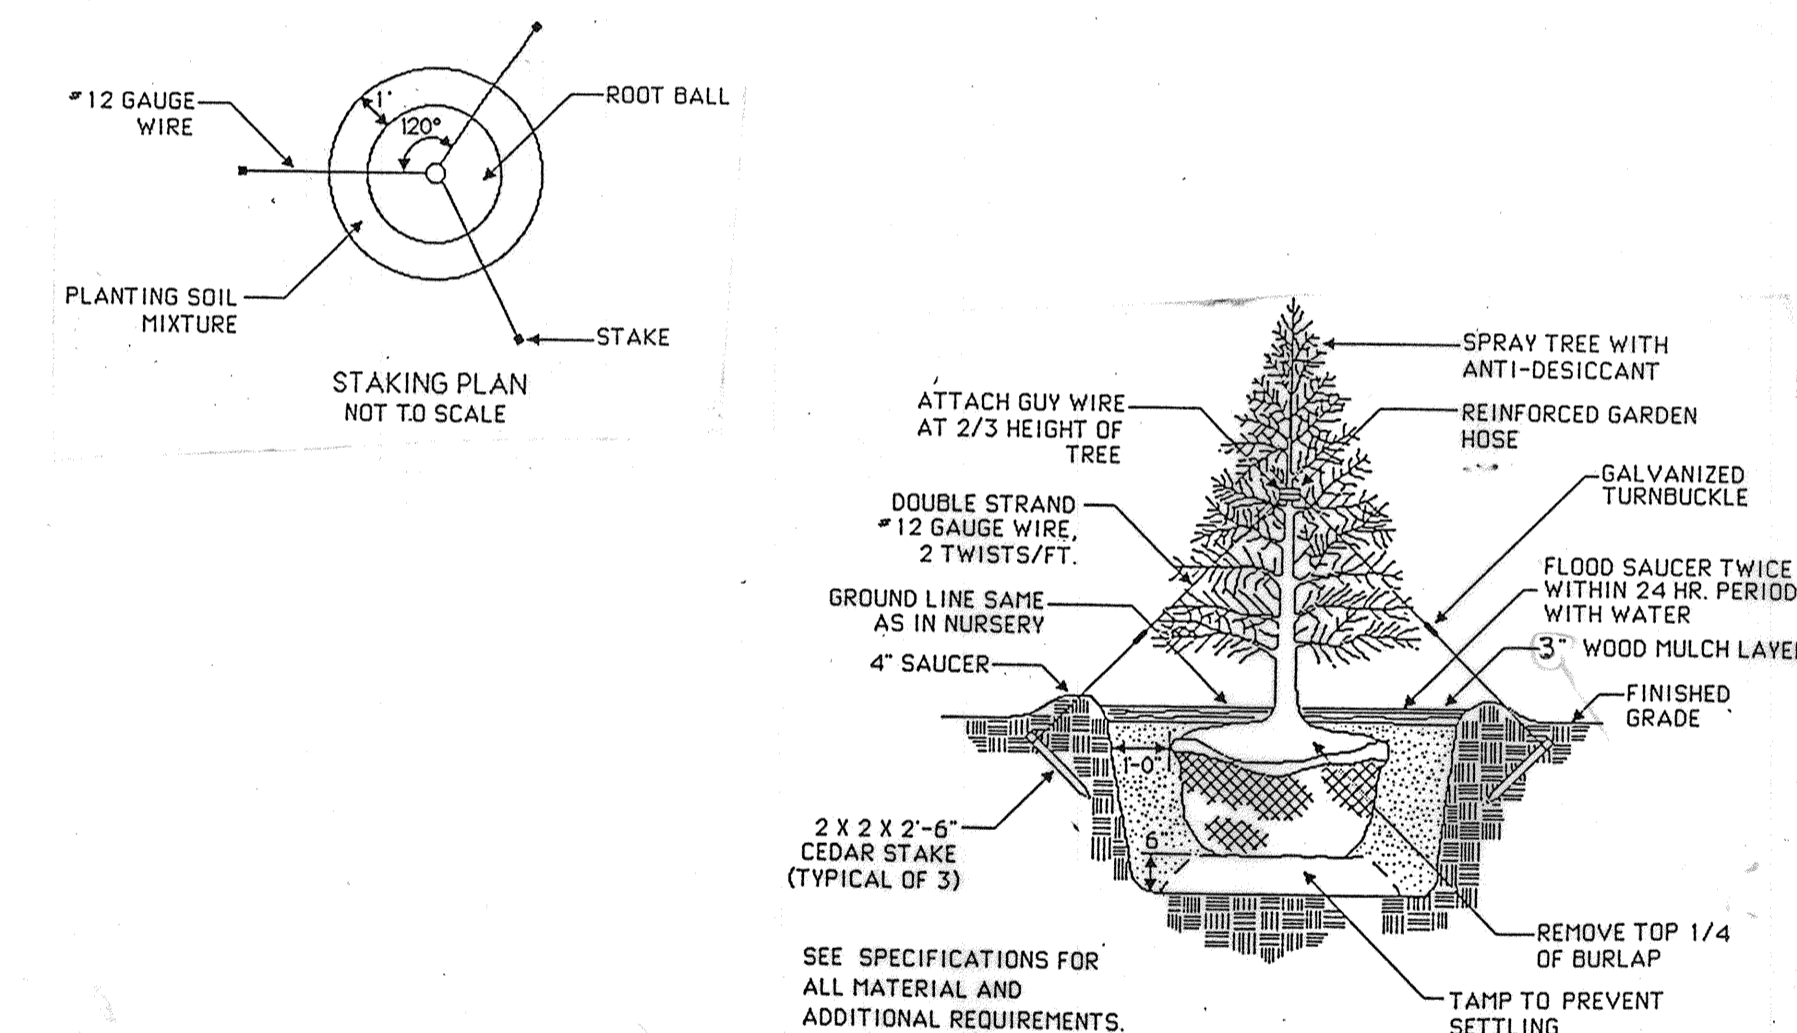


9 EVERGREEN TREE DETAIL

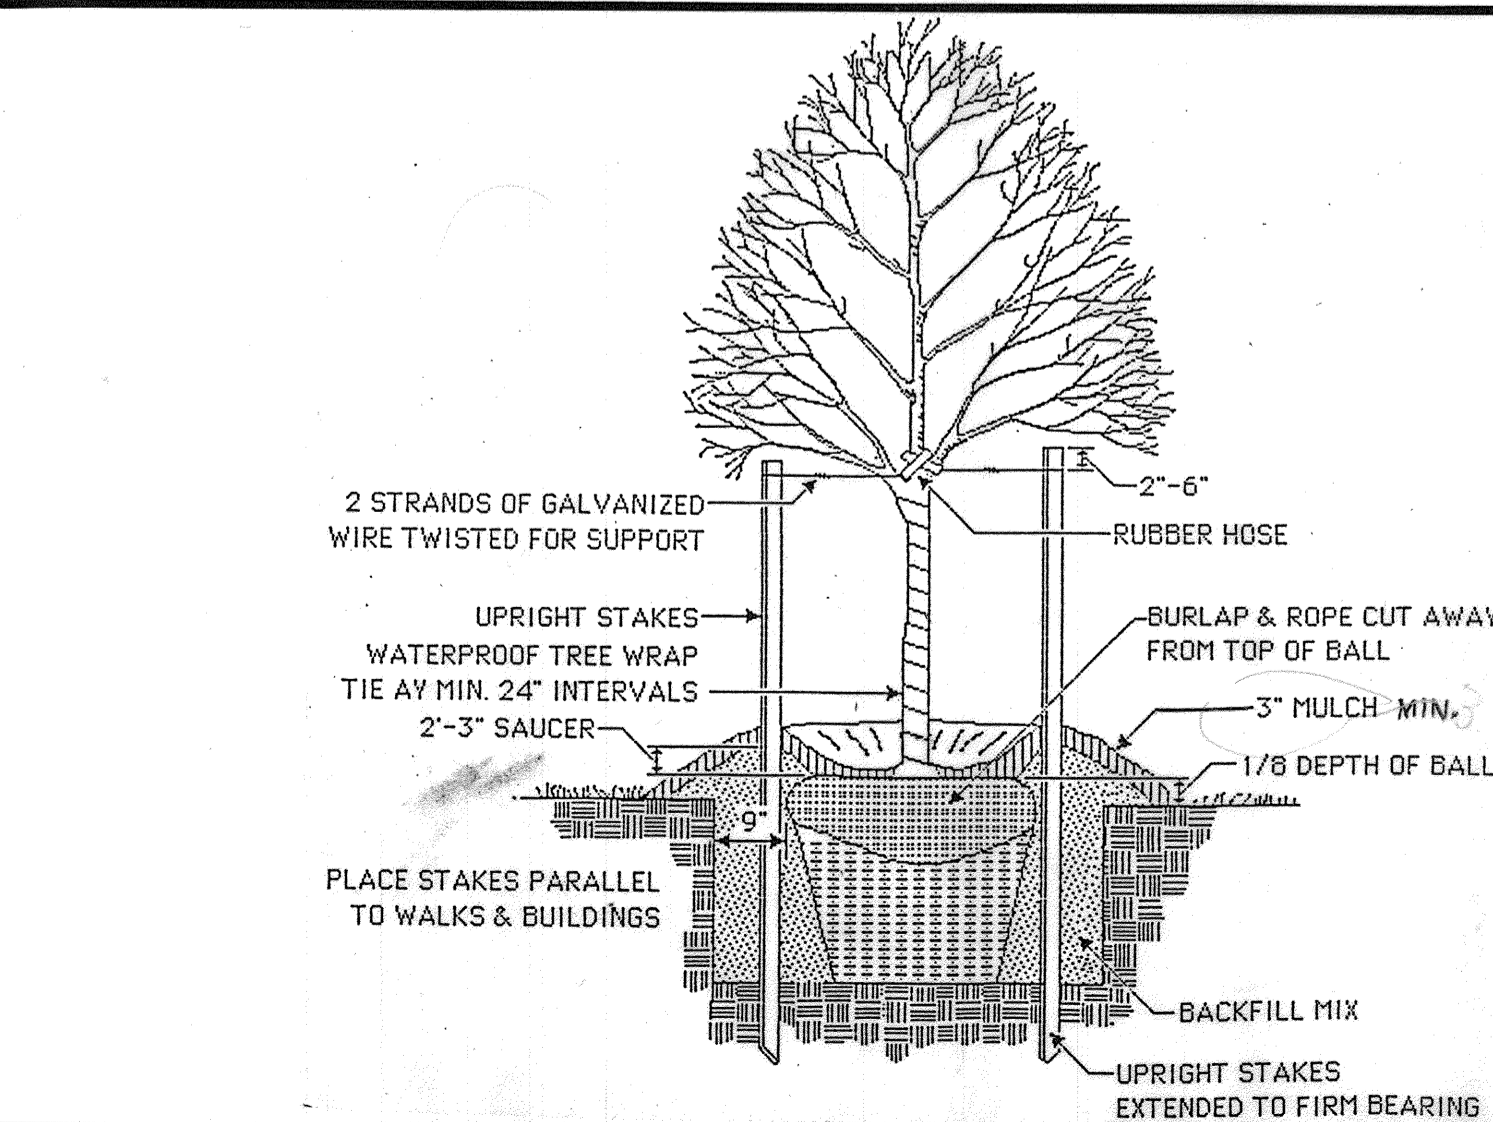


10 TYPICAL UPRIGHT STAKING DETAIL WITH WRAPPING

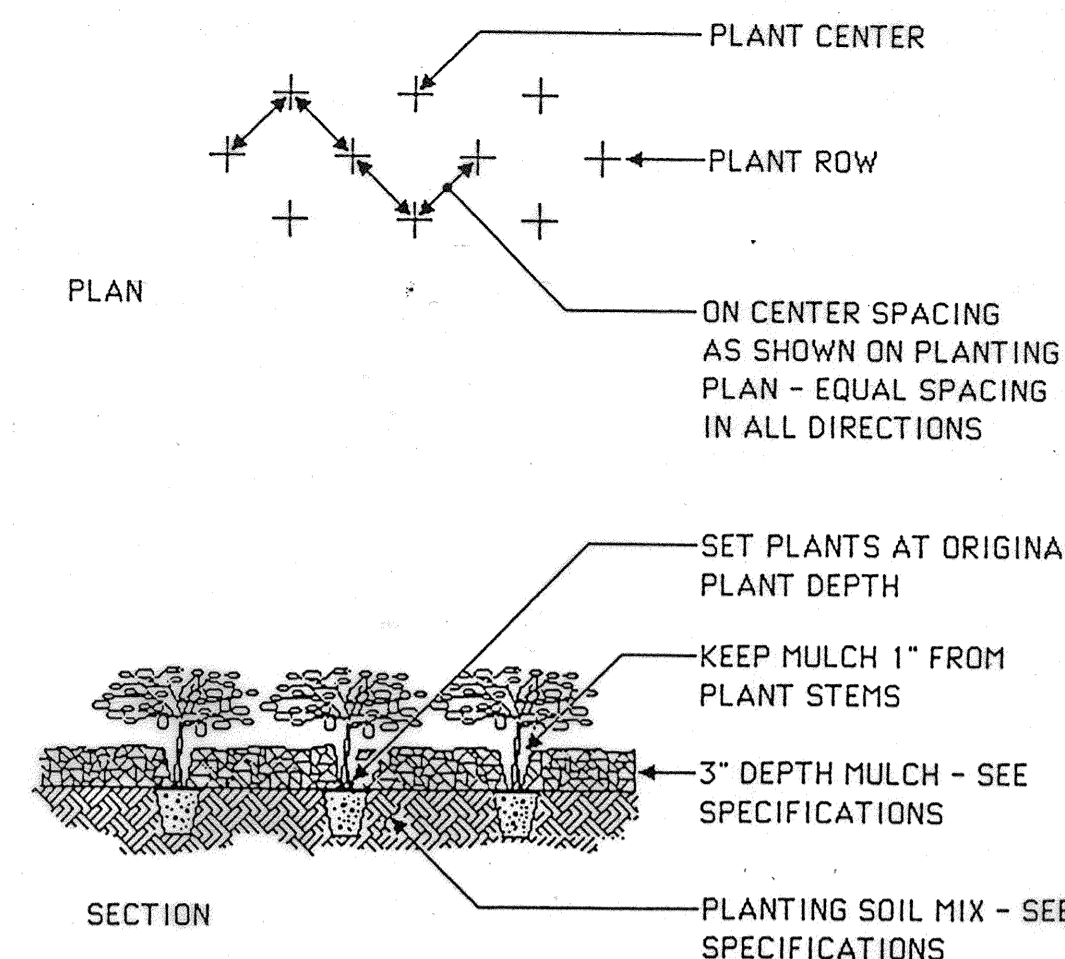


7 GROUND COVER PLANTING DETAIL

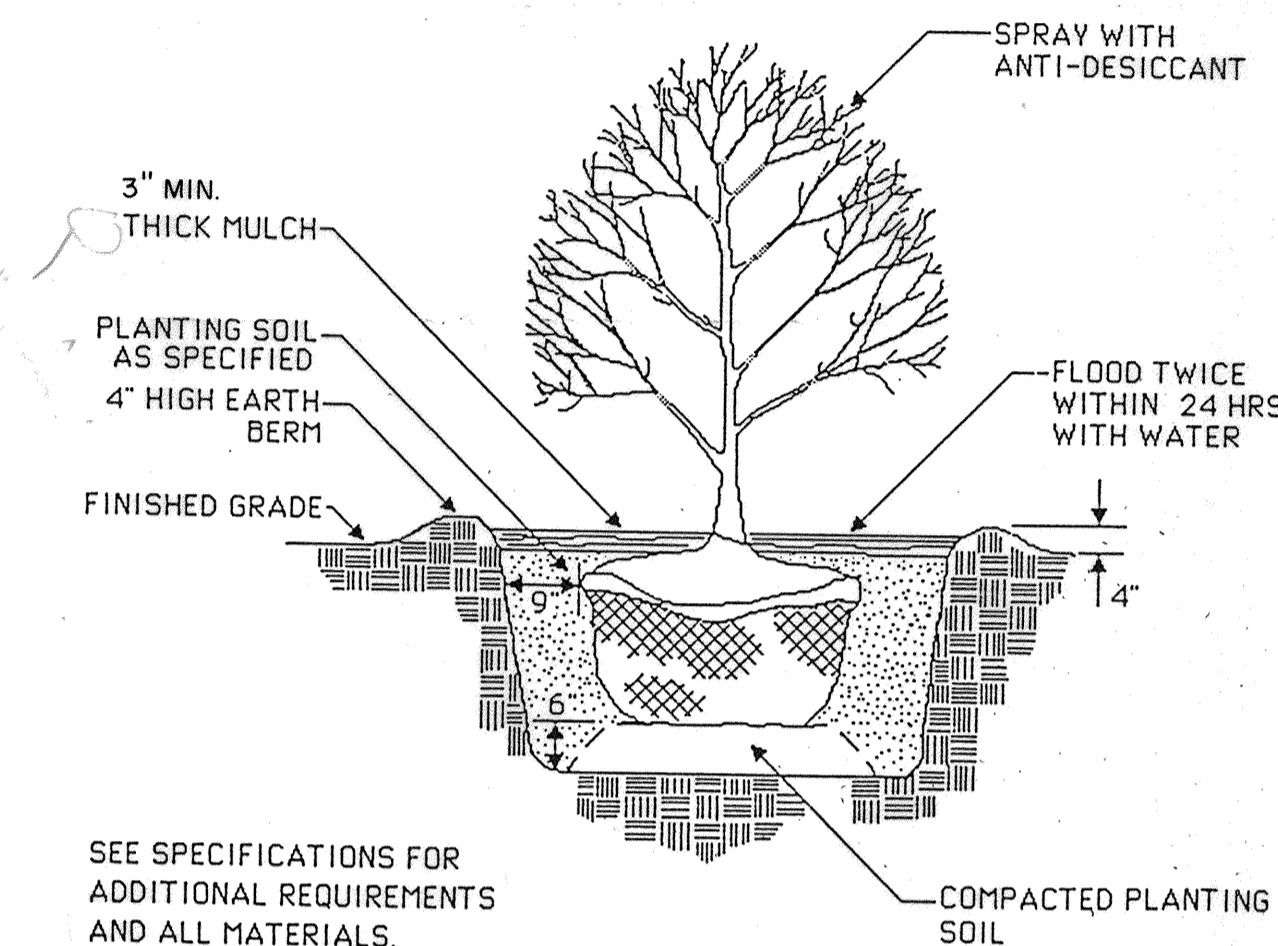


8 SHRUB PLANTING DETAIL

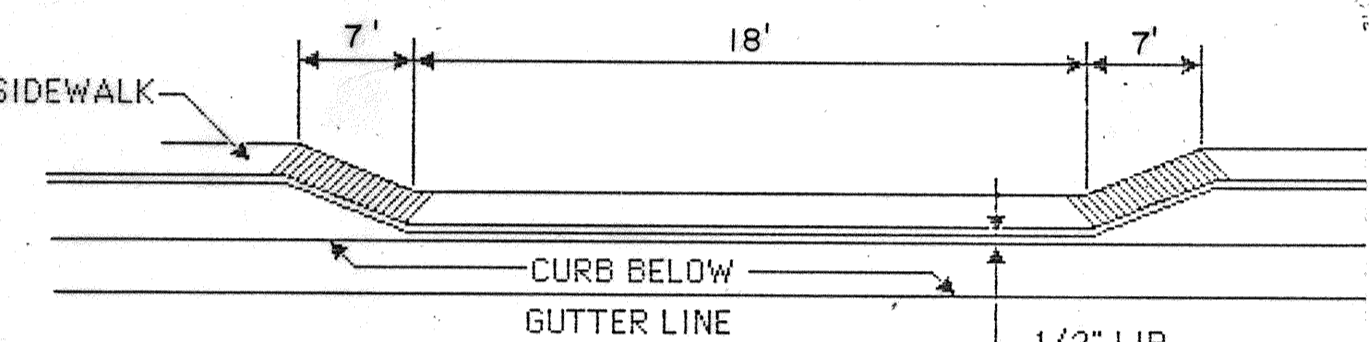

4 DEPRESSED CURB

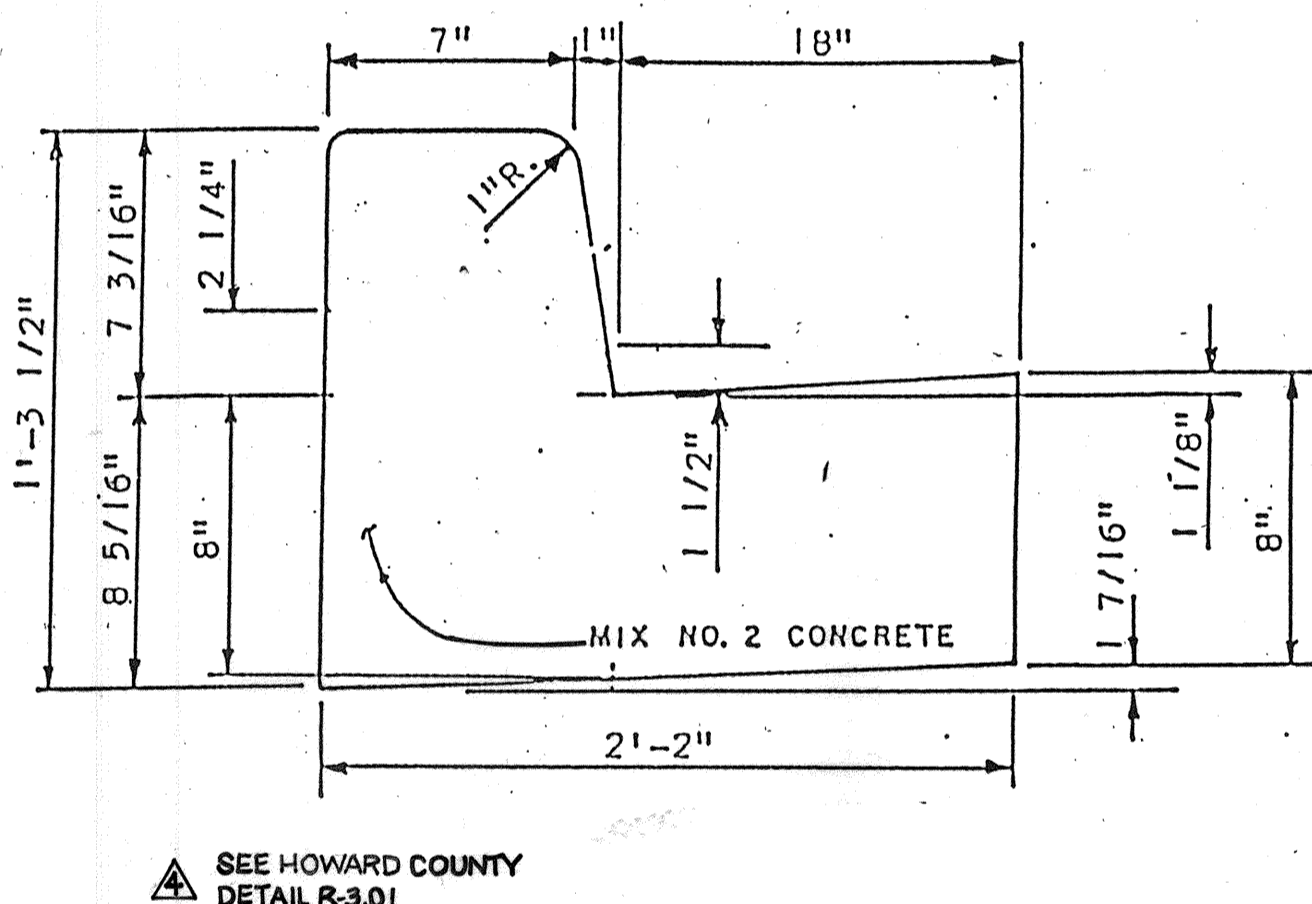

5 7" COMBINATION CURB AND GUTTER

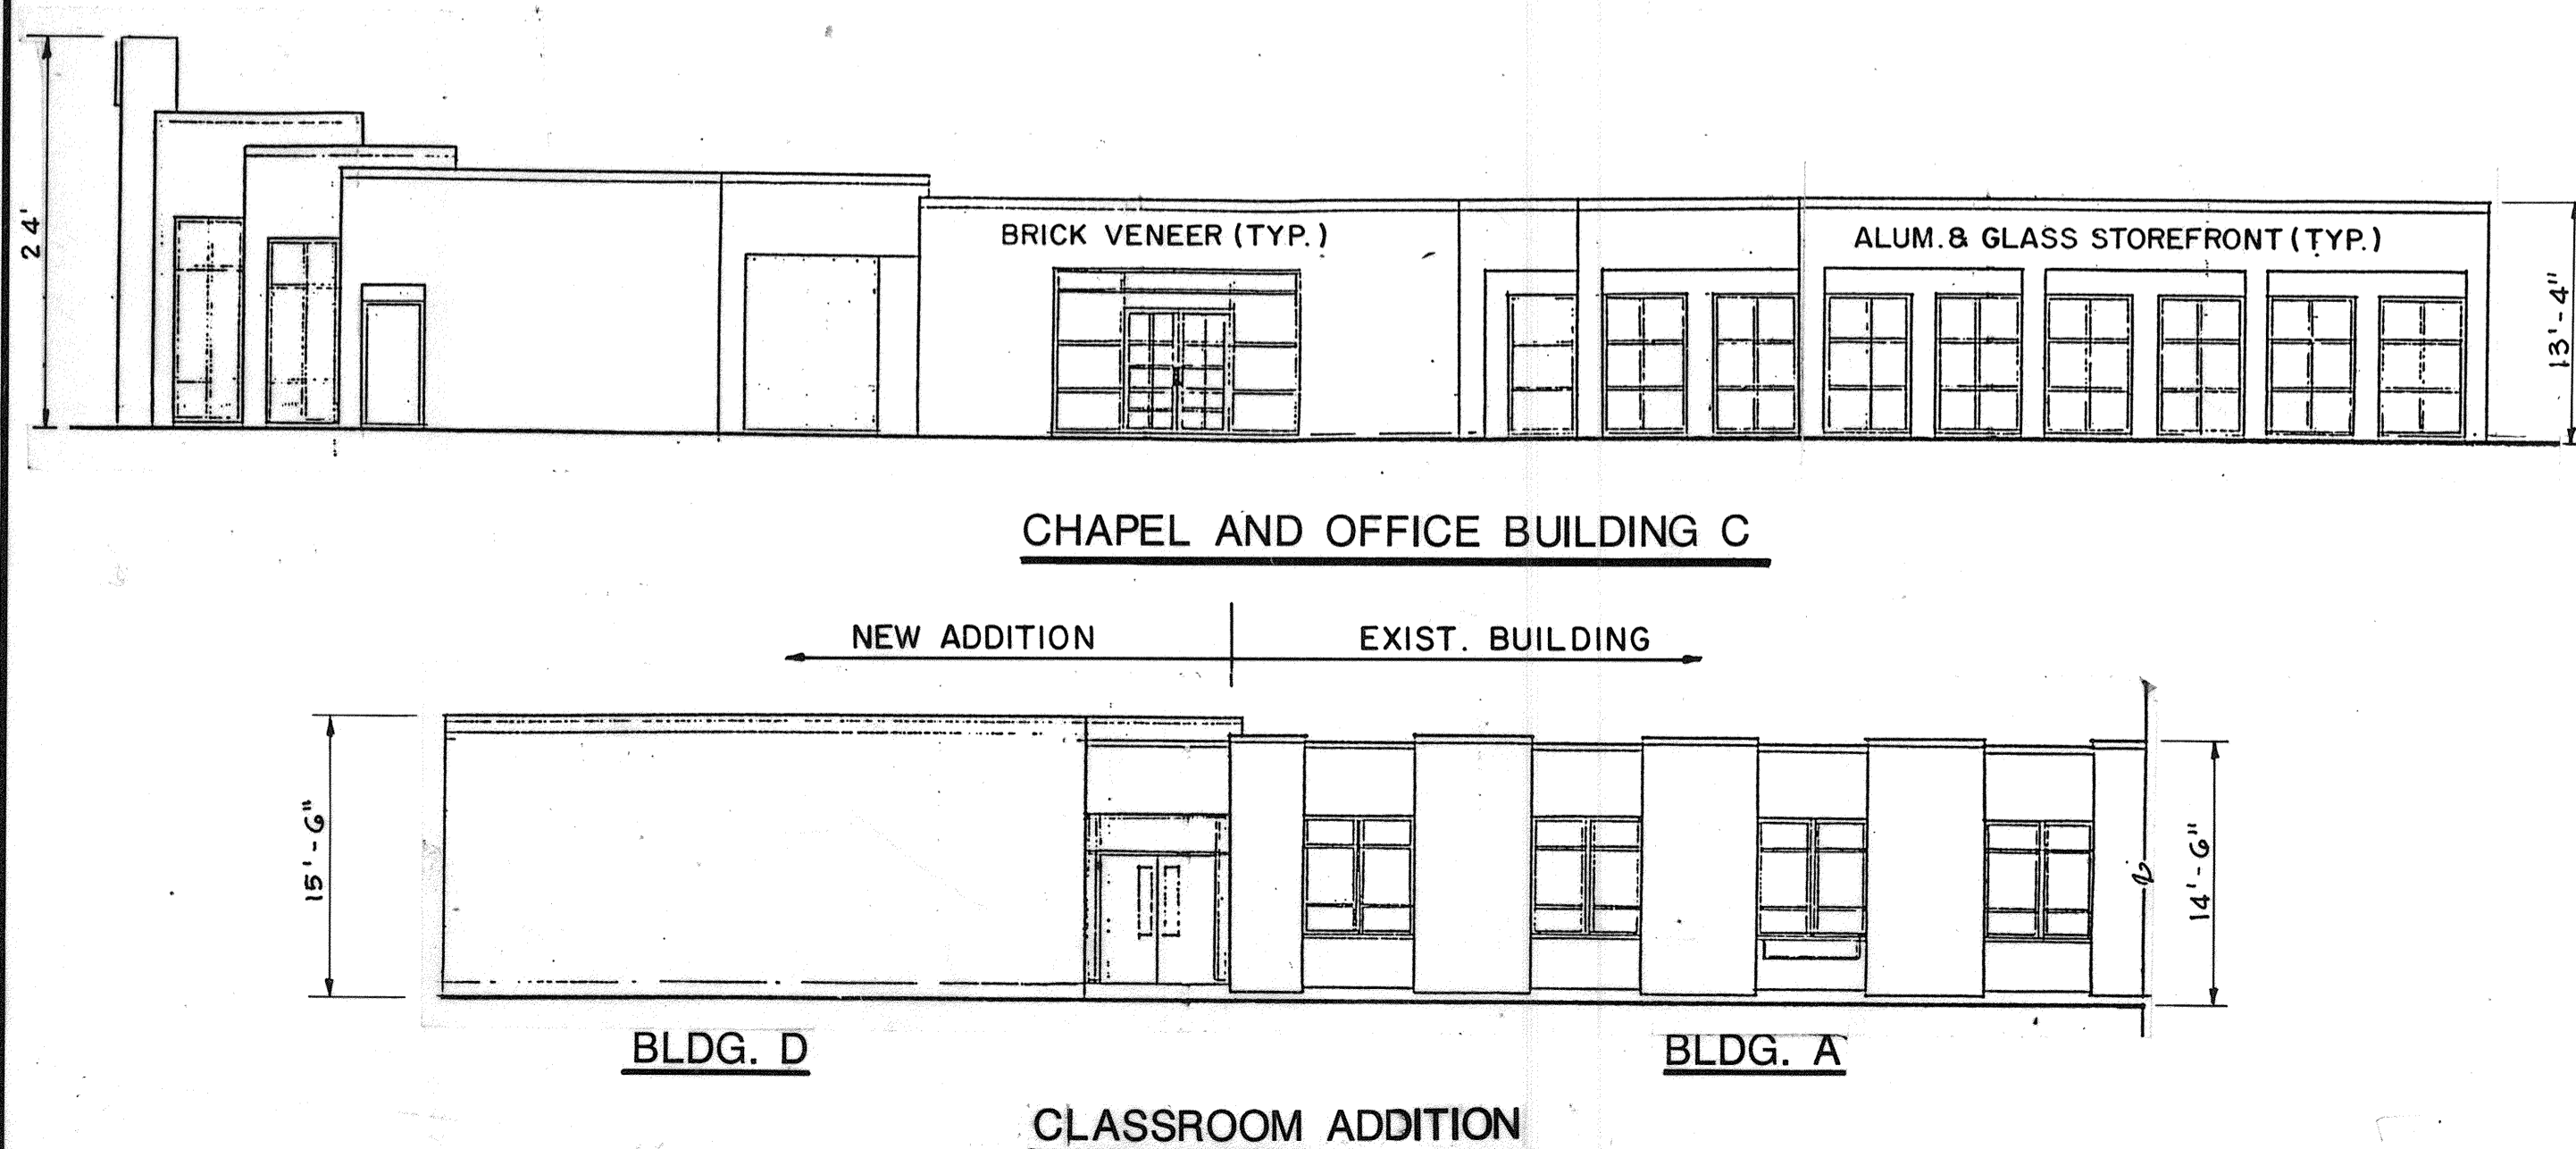

CHAPEL AND OFFICE BUILDING C

BLDG. D

CLASSROOM ADDITION

BLDG. A

DATE	REVISION
6/7/91	UPDATE CURB DETAIL
5/10/89	GENERAL REVISIONS (WBCM)
	REVISED PER HO. CO. COMMENTS
APPROVED: FOR PUBLIC WATER AND SEWERAGE, STORM DRAINAGE SYSTEMS AND PUBLIC ROADS HOWARD COUNTY DEPARTMENT OF PUBLIC WORKS	1/22/89
DIRECTOR	DATE
APPROVED: FOR PUBLIC WATER AND PUBLIC SEWER SYSTEMS HOWARD COUNTY HEALTH DEPARTMENT	11/29/89
COUNTY HEALTH OFFICER	DATE
APPROVED: HOWARD COUNTY DEPT. OF PLANNING AND ZONING	12/6/89
DIRECTOR	DATE
CHIEF, DIVISION OF COMMUNITY PLANNING AND DEVELOPMENT	12/6/89
DIRECTOR	DATE

OWNER: CHURCH OF THE RESURRECTION
PAULSKIRK DRIVE & NORTH CHATHAM ROAD
ELLICOTT CITY, MARYLAND 21043
TEL. (301) 461-9111

PROJECT: SCHOOL AND CHAPEL / OFFICE BUILDING ADDITIONS

CHURCH OF THE RESURRECTION
SITE DETAILS

2ND ELECTION DISTRICT HOWARD COUNTY, MD.
TAX MAP NO. 24 PARCEL 456,117 & 980

ENGINEERS: WHITNEY, BAILEY, COX & MAGNANI
CONSULTING ENGINEERS
1850 YORK ROAD
TIMONIUM, MD. 21098
(301) 252-6060

APPROVED
DIVISION OF
COMMUNITY PLANNING
& LAND DEVELOPMENT
HOWARD COUNTY,
MARYLAND
DATE 7-17-89

DESIGNED: A.R.
DRAWN: G.G.
CHECKED: P.D.
DATE: 10/13/88
SCALE: NOT TO SCALE
DRAWING NO: SHEET II OF 13
C-11

Construction Specifications

The construction of all infiltration basins should comply with the criteria set forth in the Maryland SCS Standards and Specifications 378-Ponds dated July, 1981 or subsequent revisions and the additional criteria provided below.

Schedule

The sequence of various phases of basin construction shall be coordinated with the overall project construction schedule. A program should schedule


Excavation

Initial basin excavation should be carried to within 1 foot of the final elevation of the basin floor. Final excavation to the finished grade should be deferred until all disturbed areas on the watershed have been stabilized or protected. The final phase excavation should remove all accumulated sediment. Relatively light tracked equipment is recommended for this operation to avoid compaction of the basin floor. After the final grading is completed, the basin floor should be deeply tilled by means of rotary tillers or disc harrows to provide a well-aerated, highly porous surface texture.

Lining Material


Establishing dense vegetation on the basin side slopes and floor is recommended. A dense vegetative stand will not only prevent erosion and sloughing, but will also provide a natural means of maintaining relatively high infiltration rates. Erosion protection of inflow points to the basin shall also be provided. Removal of accumulated sediment is a problem only at the basin floor. Little maintenance is normally required to maintain the infiltration capacity of slope areas.

Selection of suitable vegetative materials for the side slope and all other areas to be stabilized with vegetation and application of required fertilizer and mulches shall be done in accordance with the Maryland Standards and Specifications for Soil Erosion and Sediment Control. Local Extension Agencies should also be consulted.

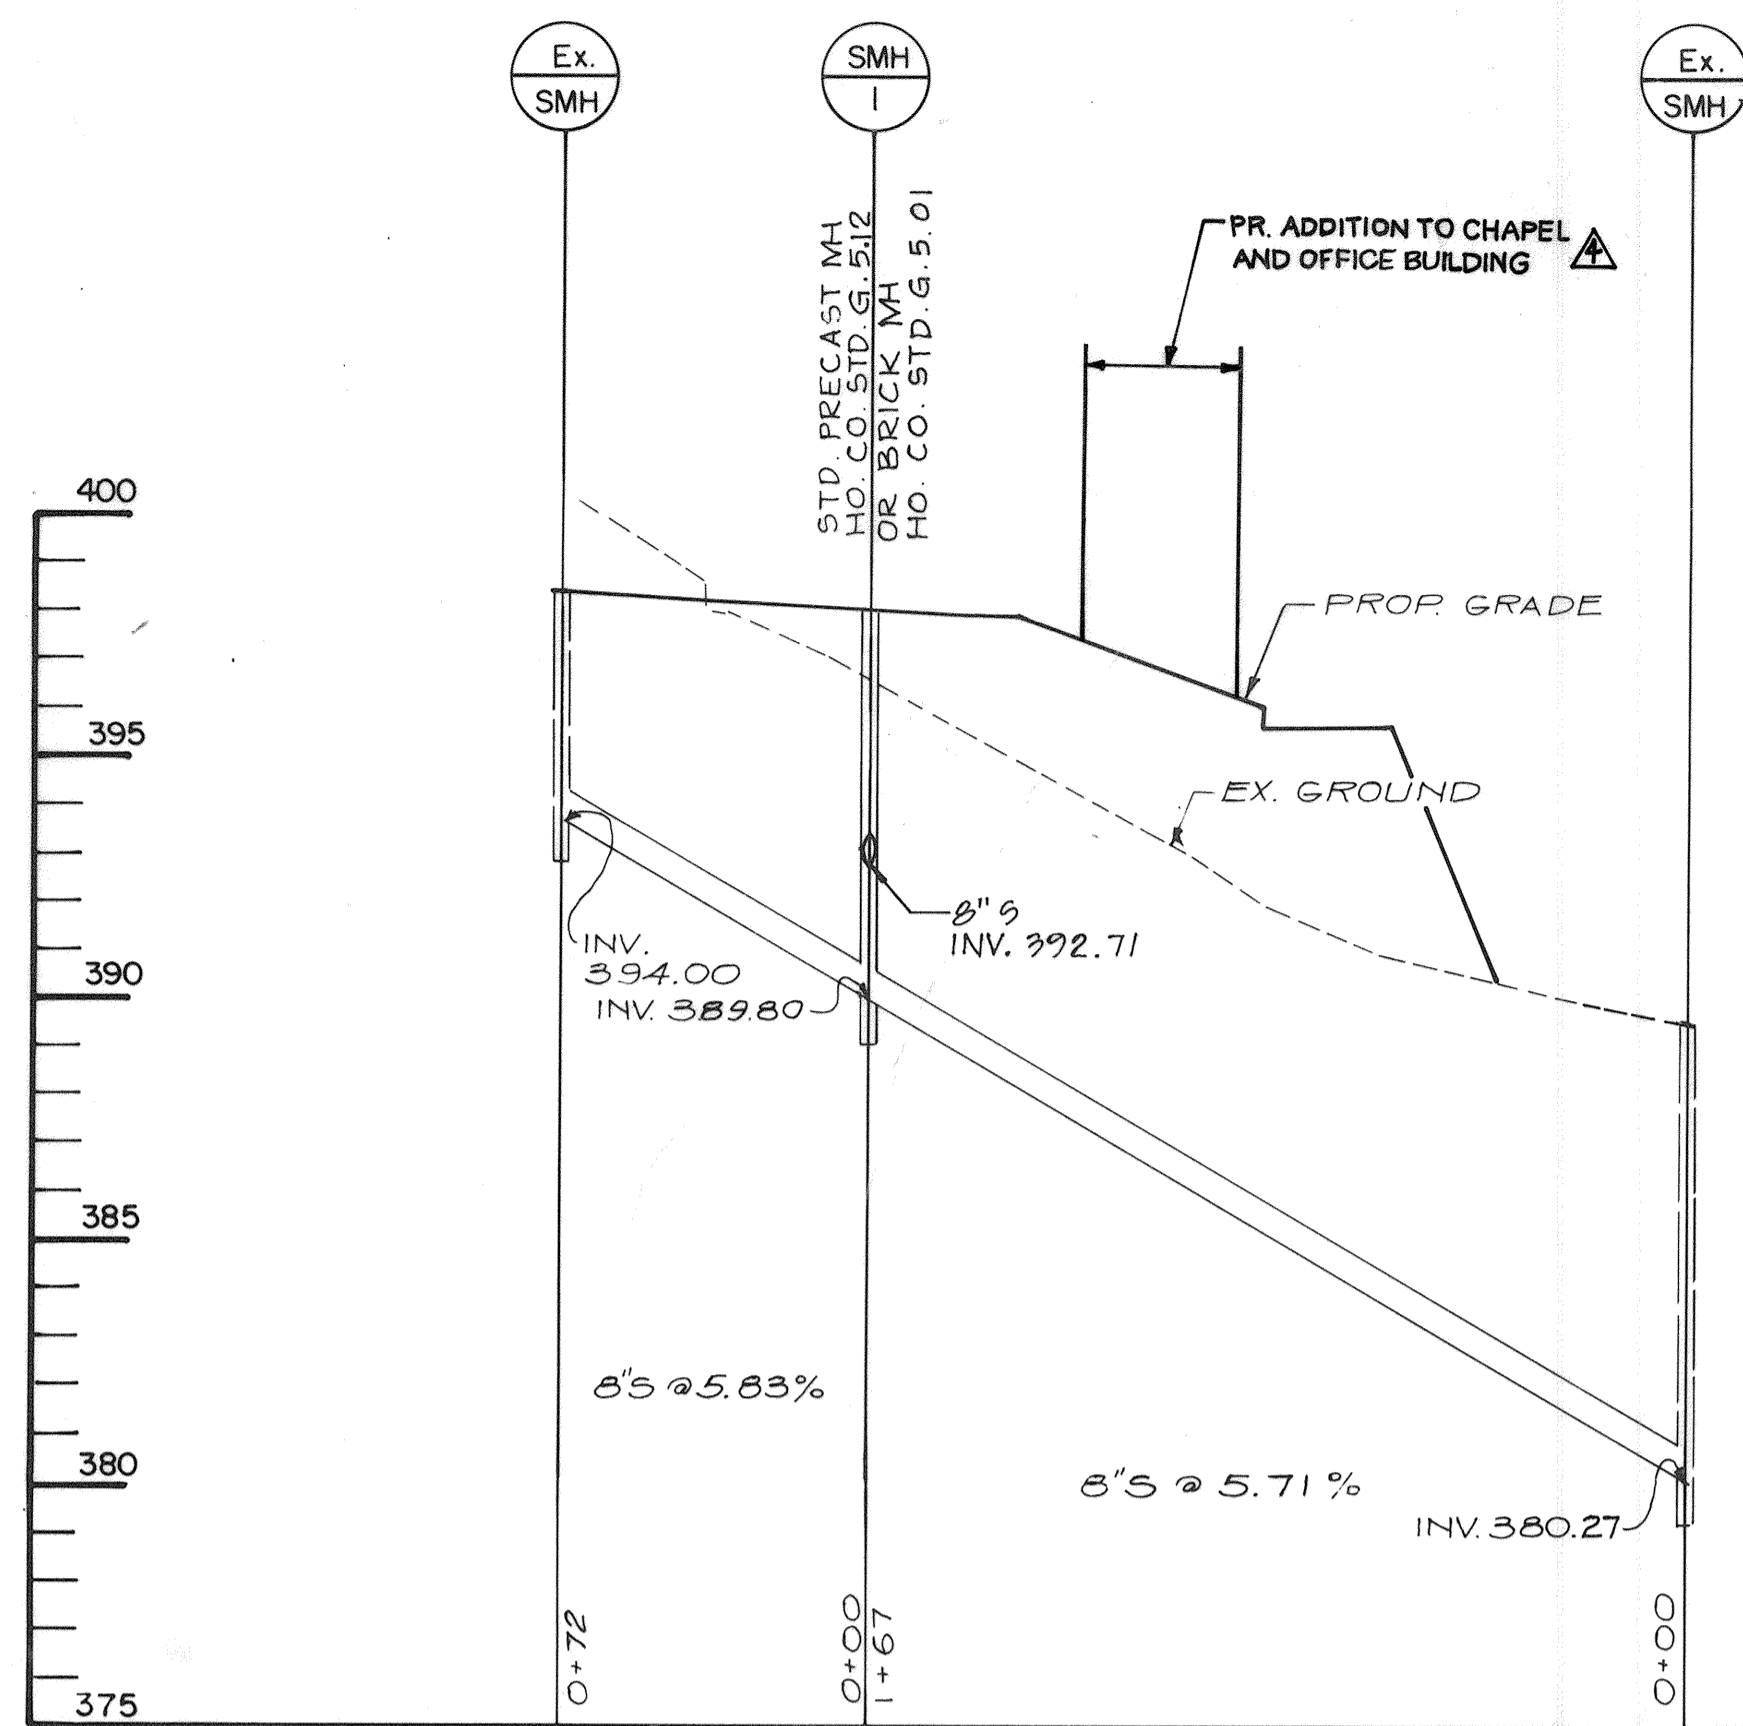


SANITARY SEWER PROFILE

SCALE: HORIZ. 1"=4'
VERT. 1"=4'

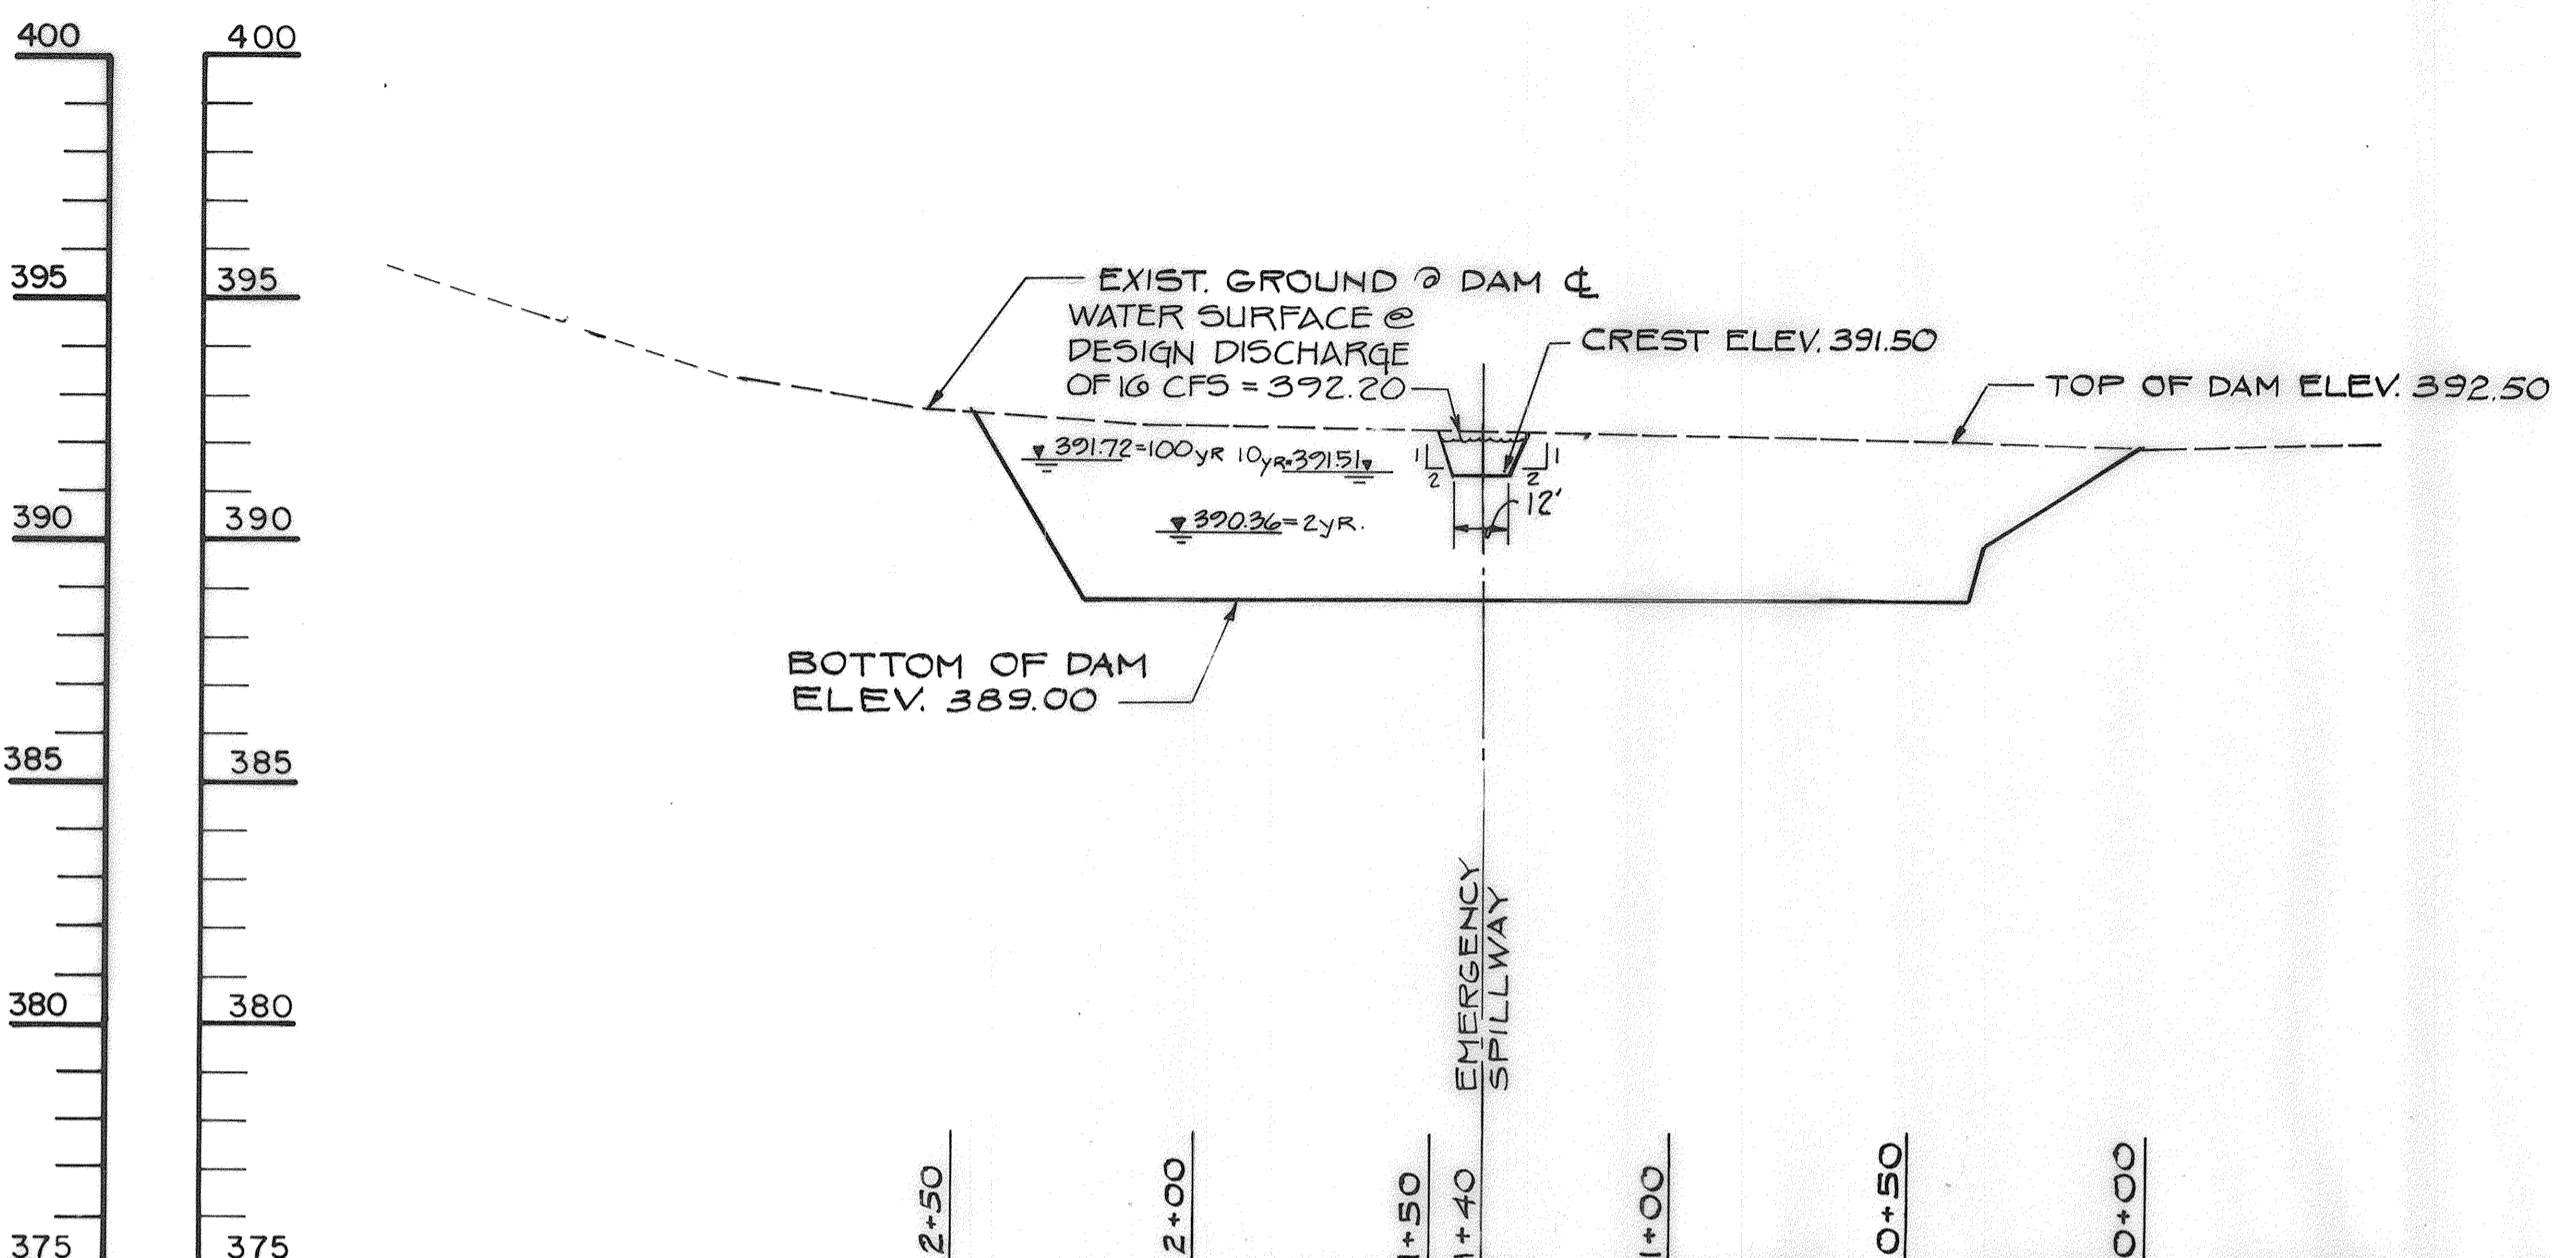


DAM PROFILE INFILTRATION BASIN

SCALE: HORIZ. 1"=40'
VERT. 1"=4'

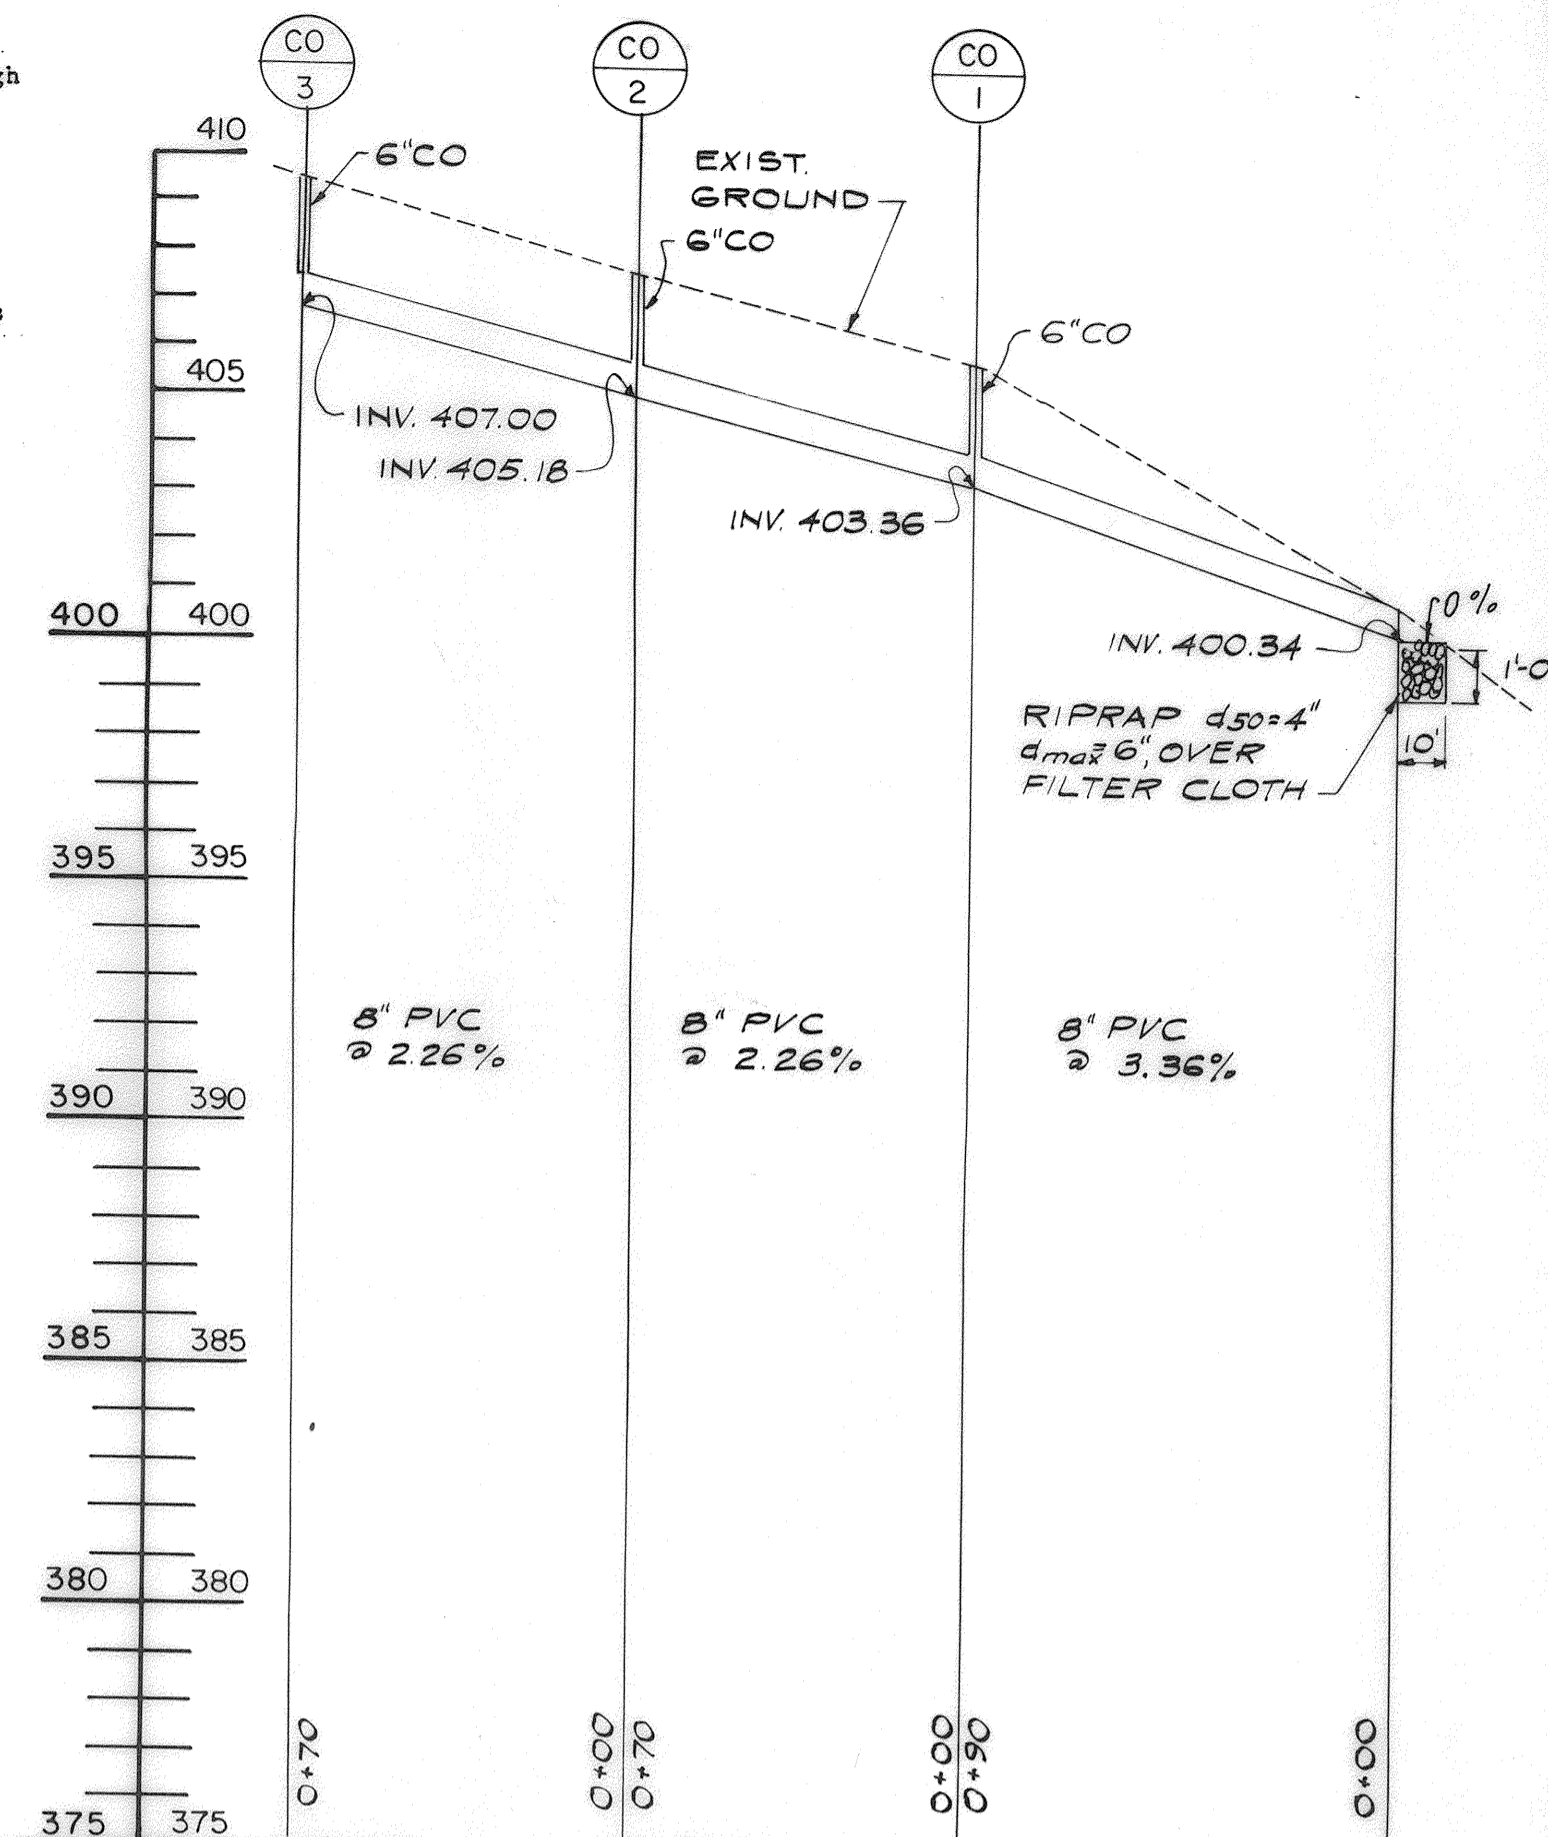


NEW SCHOOL ROOF LEADER PROFILE

SCALE: HORIZ. 1"=40'
VERT. 1"=4'

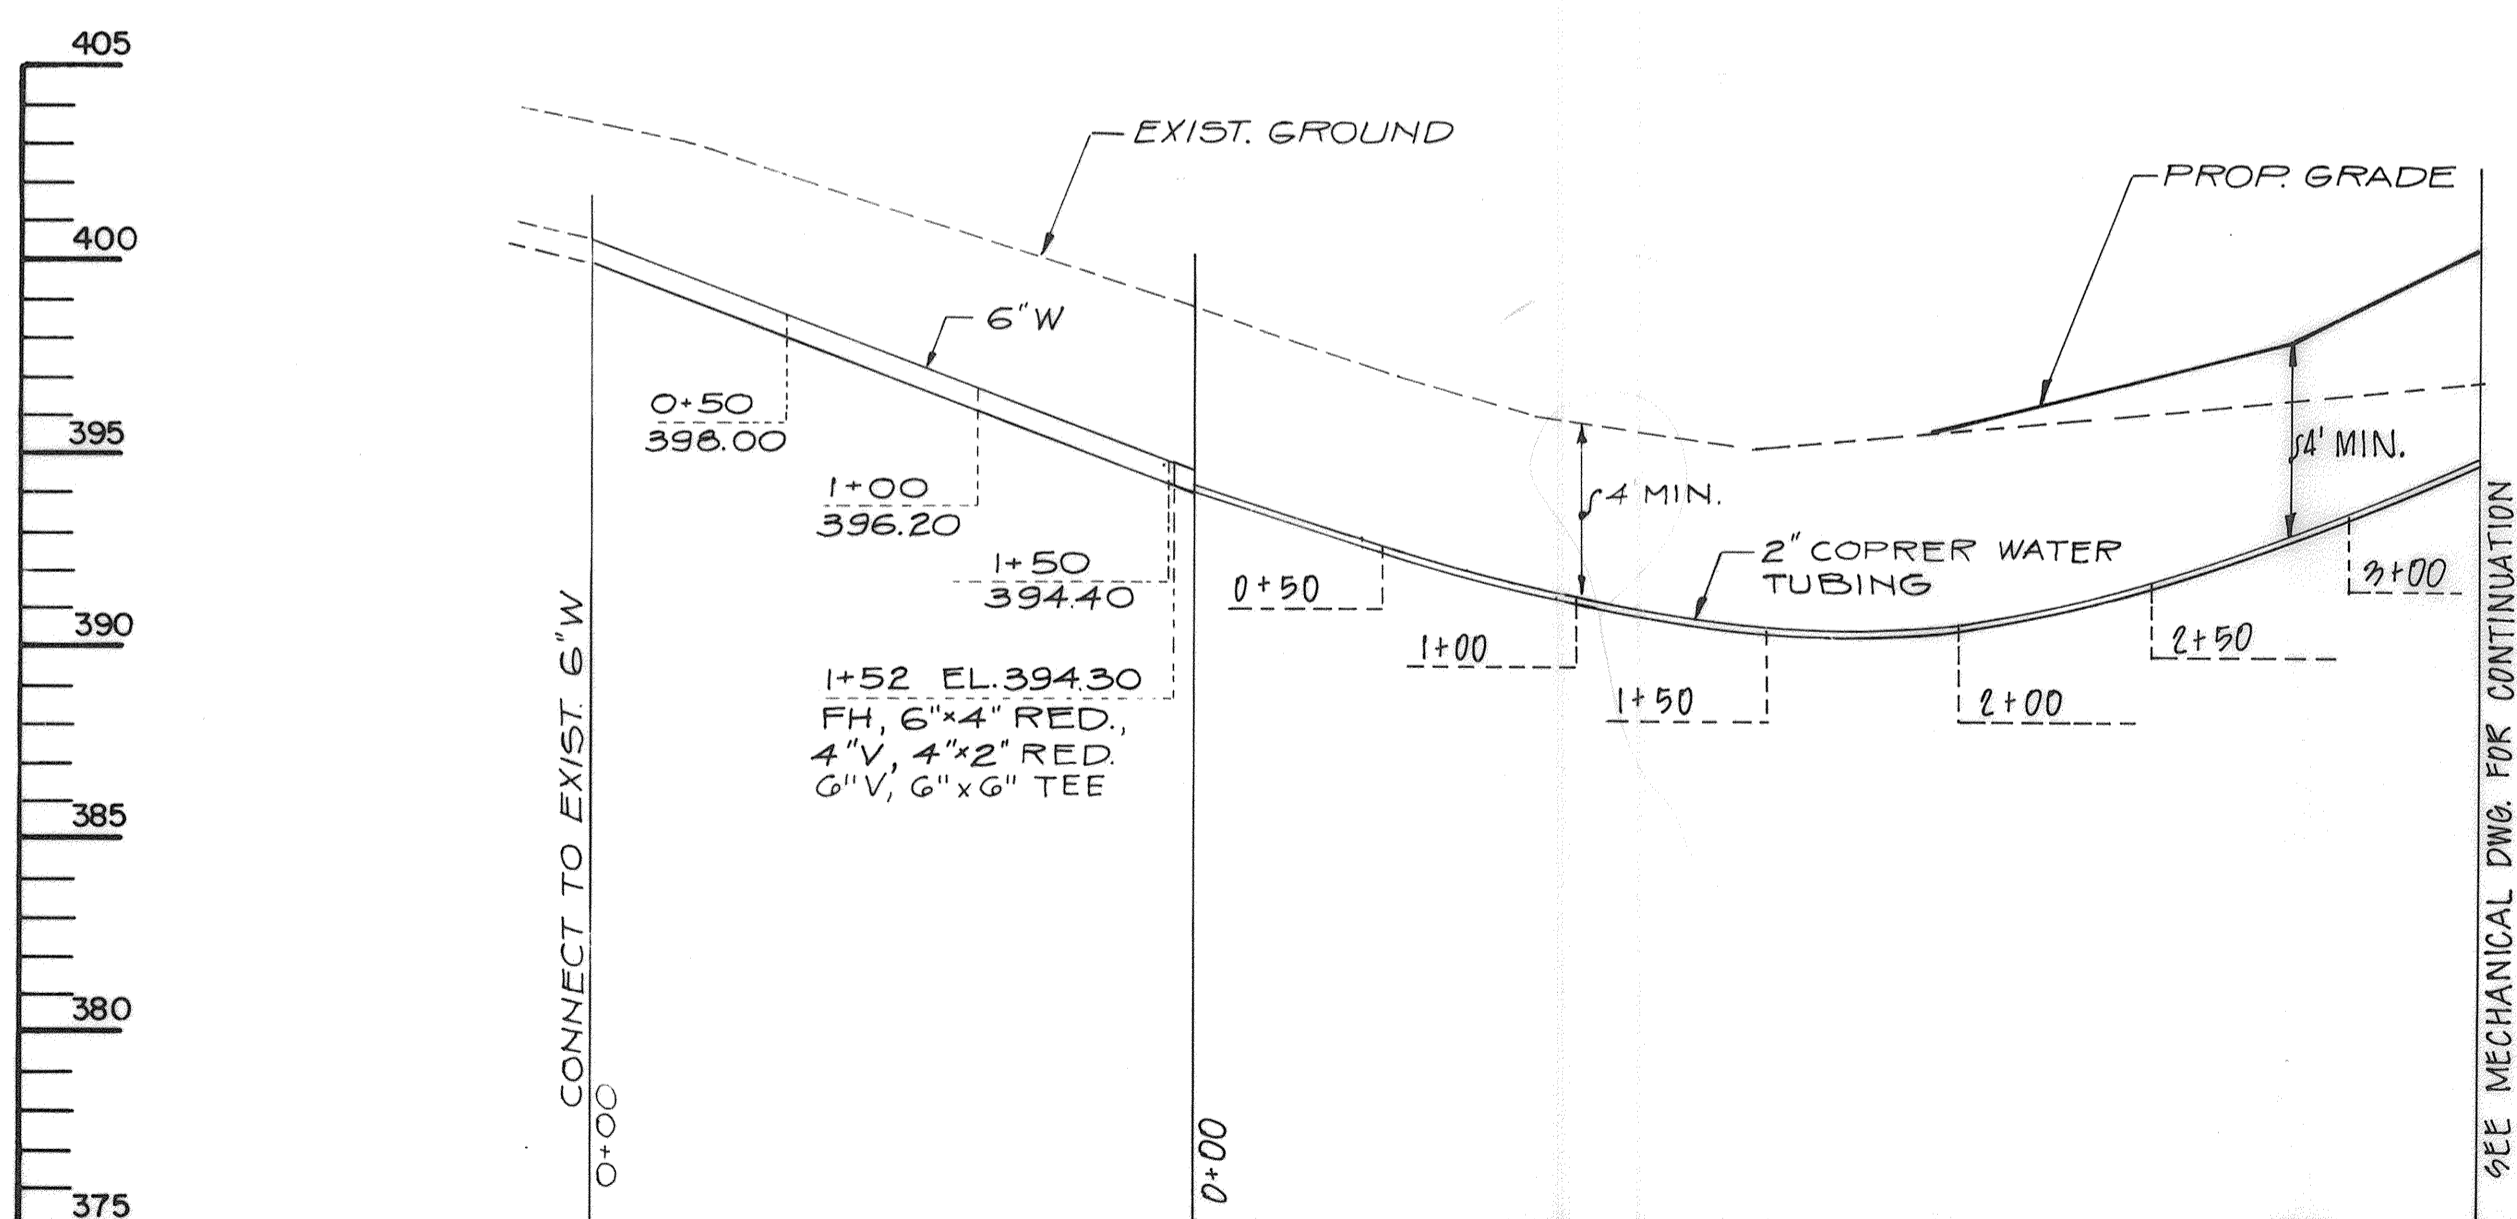

WATER MAIN PROFILE

SCALE: HORIZ. 1"=50'
VERT. 1"=5'

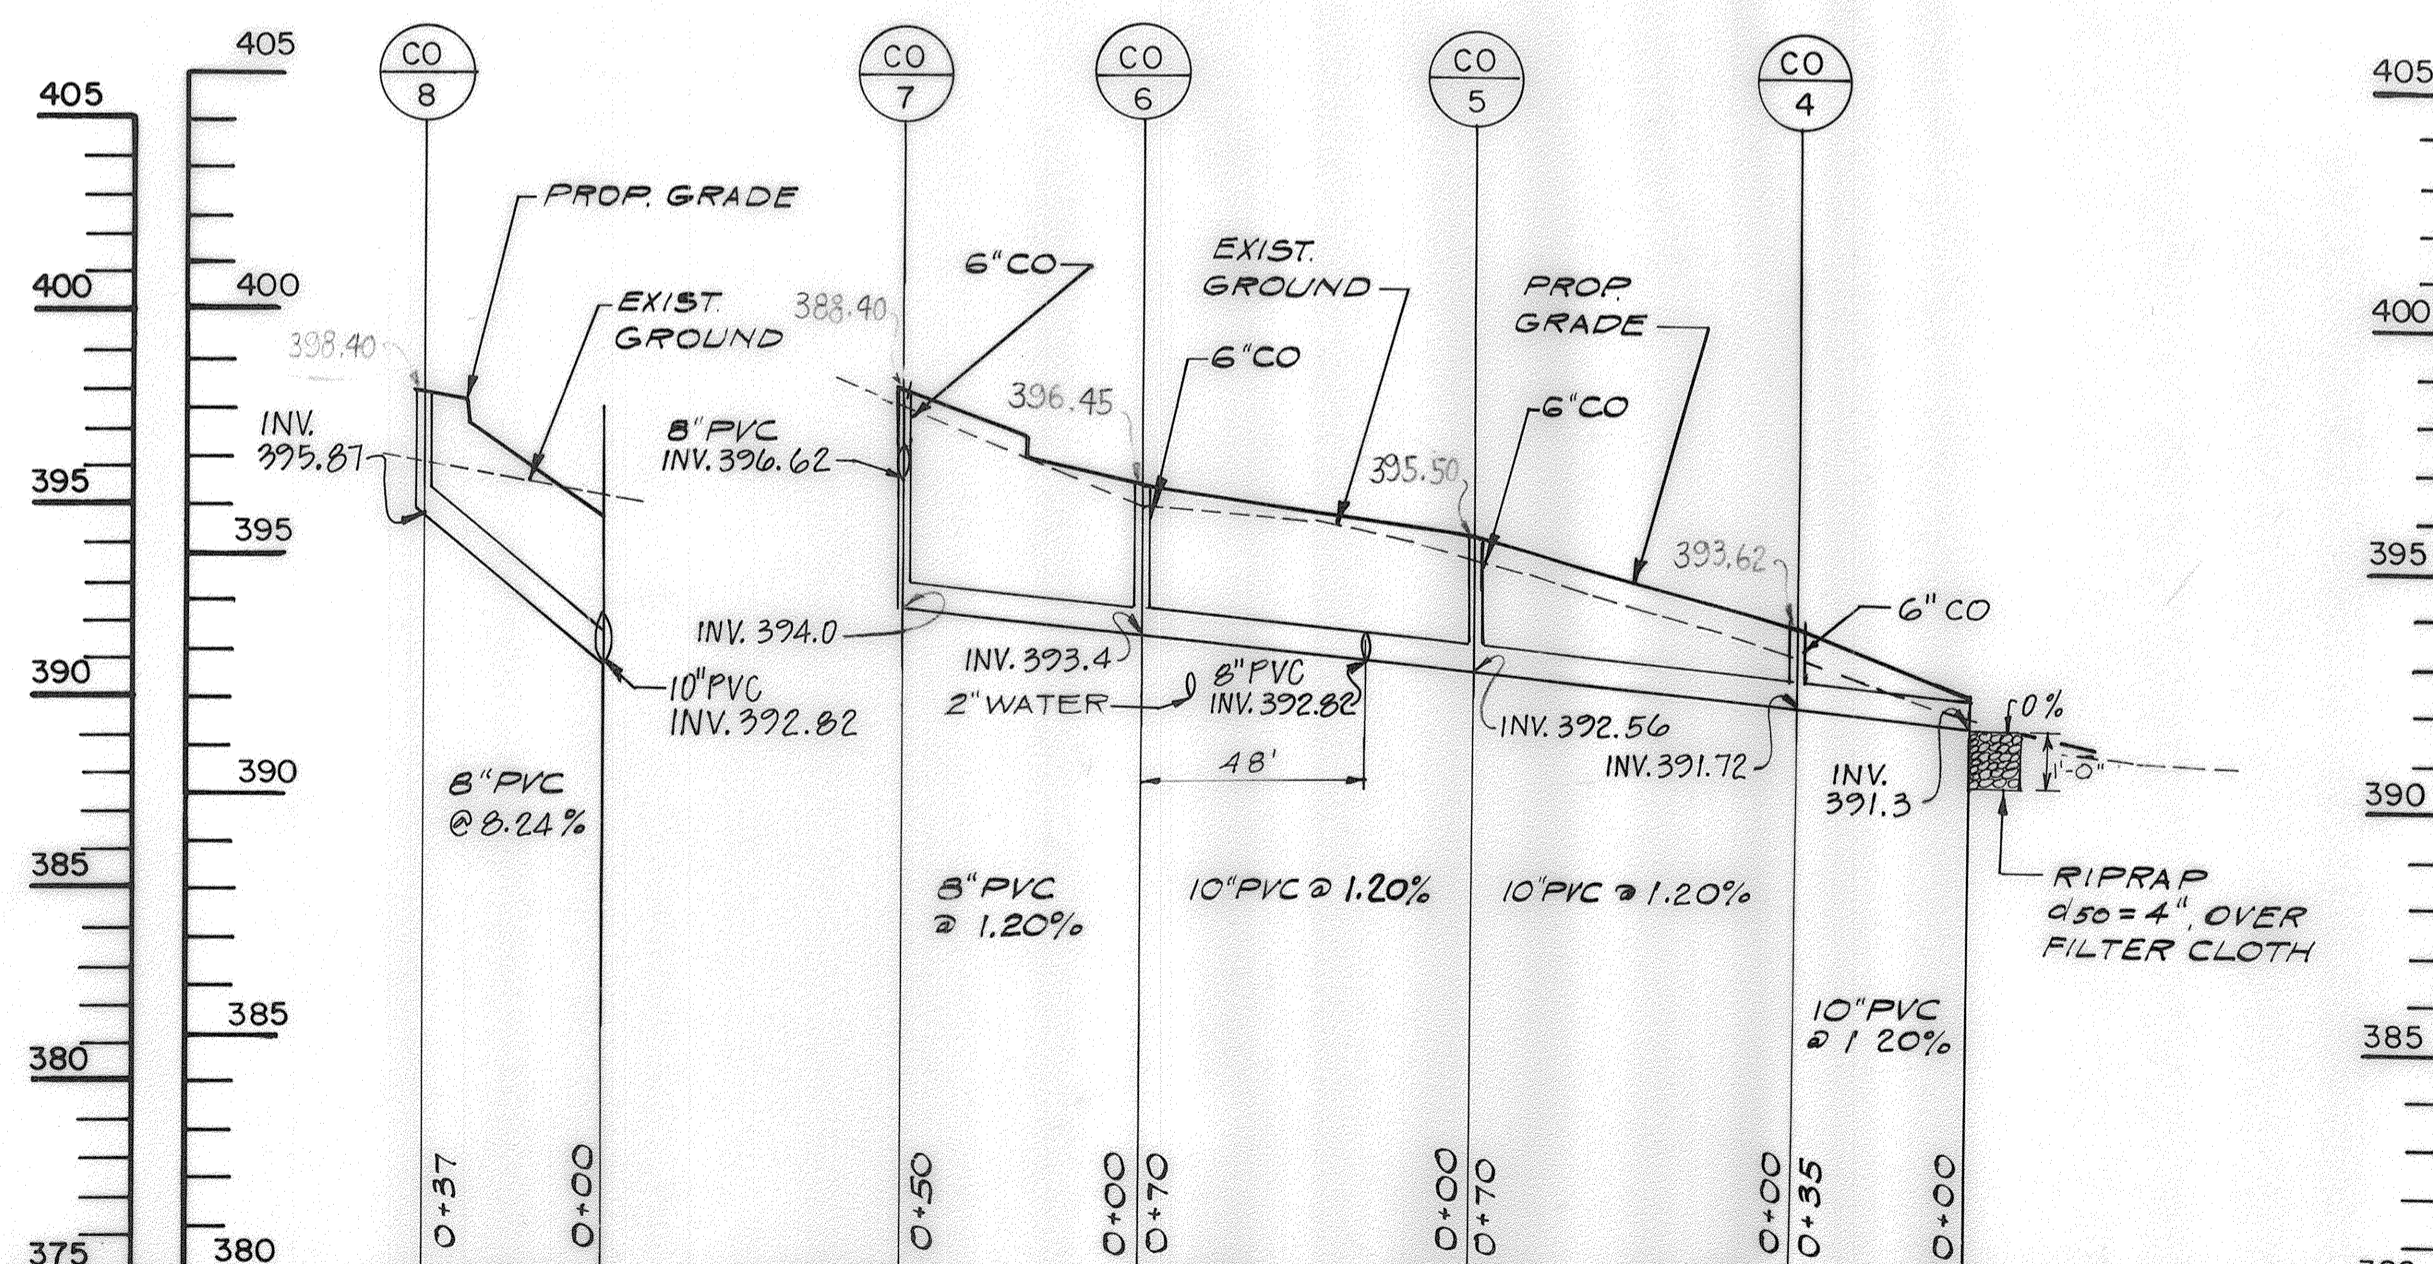

NEW CHAPEL/OFFICE ROOF LEADER PROFILE

SCALE: HORIZ. 1"=40'
VERT. 1"=4'

AS-BUILT SWM

7/16/96

Maintenance

Inspection Schedule

Drainage systems must be inspected on a routine basis to ensure that they are functioning properly. Inspections can be on a semiannual basis but should always be conducted following major storms.

Sediment Control Effect on Vegetated Basins

Cleanout frequency of infiltration basins will depend on whether they are vegetated or nonvegetated and will be a function of their storage capacity, recharge characteristics, volume of inflow, and sediment load. Infiltration basins should be inspected at least once a year. Sedimentation basins and traps may require more frequent inspection and cleanout.

Grass bottoms on infiltration basins seldom need replacement since grass serves as a good filter material. This is particularly true of Kentucky 31 Tall Fescue, which is extremely hardy and can withstand several days of submergence. If silty water is allowed to trickle through the turf, most of the suspended material is strained out within a few yards of surface travel. Well established turf on a basin floor will grow up through sediment deposits, forming a porous turf and preventing the formation of an impermeable layer. Grass filtration would work well with long, narrow, shoulder-type (swales, ditches, etc.) depressions where highway runoff flows down a grassy slope between the roadway and the basin. Kentucky 31 Tall Fescue demands very little attention and looks attractive when trimmed. Grass planted on basin side slopes will also prevent erosion.

Side Slope Maintenance

- (a) **Purpose.** To promote a dense turf with extensive root growth, thereby enhancing infiltration through the slope surface and prevent weeds from gradually taking over the slope areas.
- (b) **Frequency.** Grasses of the fescue family are recommended for seeding primarily due to their adaptability to dry sandy soils, drought resistance, hardiness, and ability to withstand brief inundations. The use of fescues will also permit long intervals between mowings. This is important due to the relatively steep slopes which make mowing difficult. Mowing twice a year, once in June and again in September, is generally satisfactory. Refertilization with 10-6-4 ratio fertilizer at a rate of 500 lb per acre (11 lb per 1000 sq ft) may be required the second year after seeding.



APPROVED
DIVISION OF
COMMUNITY PLANNING
& LAND DEVELOPMENT

HOWARD COUNTY,
MARYLAND
DATE 7-17-89

02/28/89	ADD. ADDITION TO CHAPEL AND OFFICE BUILDING
5/10/89	REVISIONS PER HO. CO. COMMENTS
DATE: NO.	REVISION
APPROVED: FOR PUBLIC WATER AND SEWERAGE, STORM DRAINAGE SYSTEMS AND PUBLIC ROADS HOWARD COUNTY DEPARTMENT OF PUBLIC WORKS	
<i>James G. Smith</i>	11/22/89
DIRECTOR	DATE
APPROVED: FOR PUBLIC WATER AND PUBLIC SEWER SYSTEMS HOWARD COUNTY HEALTH DEPARTMENT	
<i>Joyce M. Boyd</i>	11/29/89
COUNTY HEALTH OFFICER	DATE
APPROVED: HOWARD COUNTY DEPT. OF PLANNING AND ZONING	
<i>Joyce M. Boyd</i>	12/2/89
DIRECTOR	DATE
<i>Mark J. ...</i>	12/4/89
CHEF, DIVISION OF COMMUNITY PLANNING AND DEVELOPMENT	DATE

OWNER: CHURCH OF THE RESURRECTION
PAULSKIRK DRIVE & NORTH CHATHAM ROAD
ELLCOTT CITY, MARYLAND 21043
TEL. (301) 461-9111


PROJECT: SCHOOL AND CHAPEL/OFFICE BUILDING ADDITION

CHURCH OF THE RESURRECTION
PROFILES

2ND ELECTION DISTRICT HOWARD COUNTY, MD.
TAX MAP NO. 24 PARCEL 456,1117 8,980


ENGINEERS: WHITNEY, BAILEY, COX & MAGNANI
CONSULTING ENGINEERS
1850 YORK ROAD
TIMONIUM, MD. 21093
(301) 252-6060

DESIGNED: A.R.
DRAWN: G.G.
CHECKED: P.D.
DATE: 10/13/88
SCALE: AS SHOWN
DRAWING NO: SHEET 12 OF 13
C-12

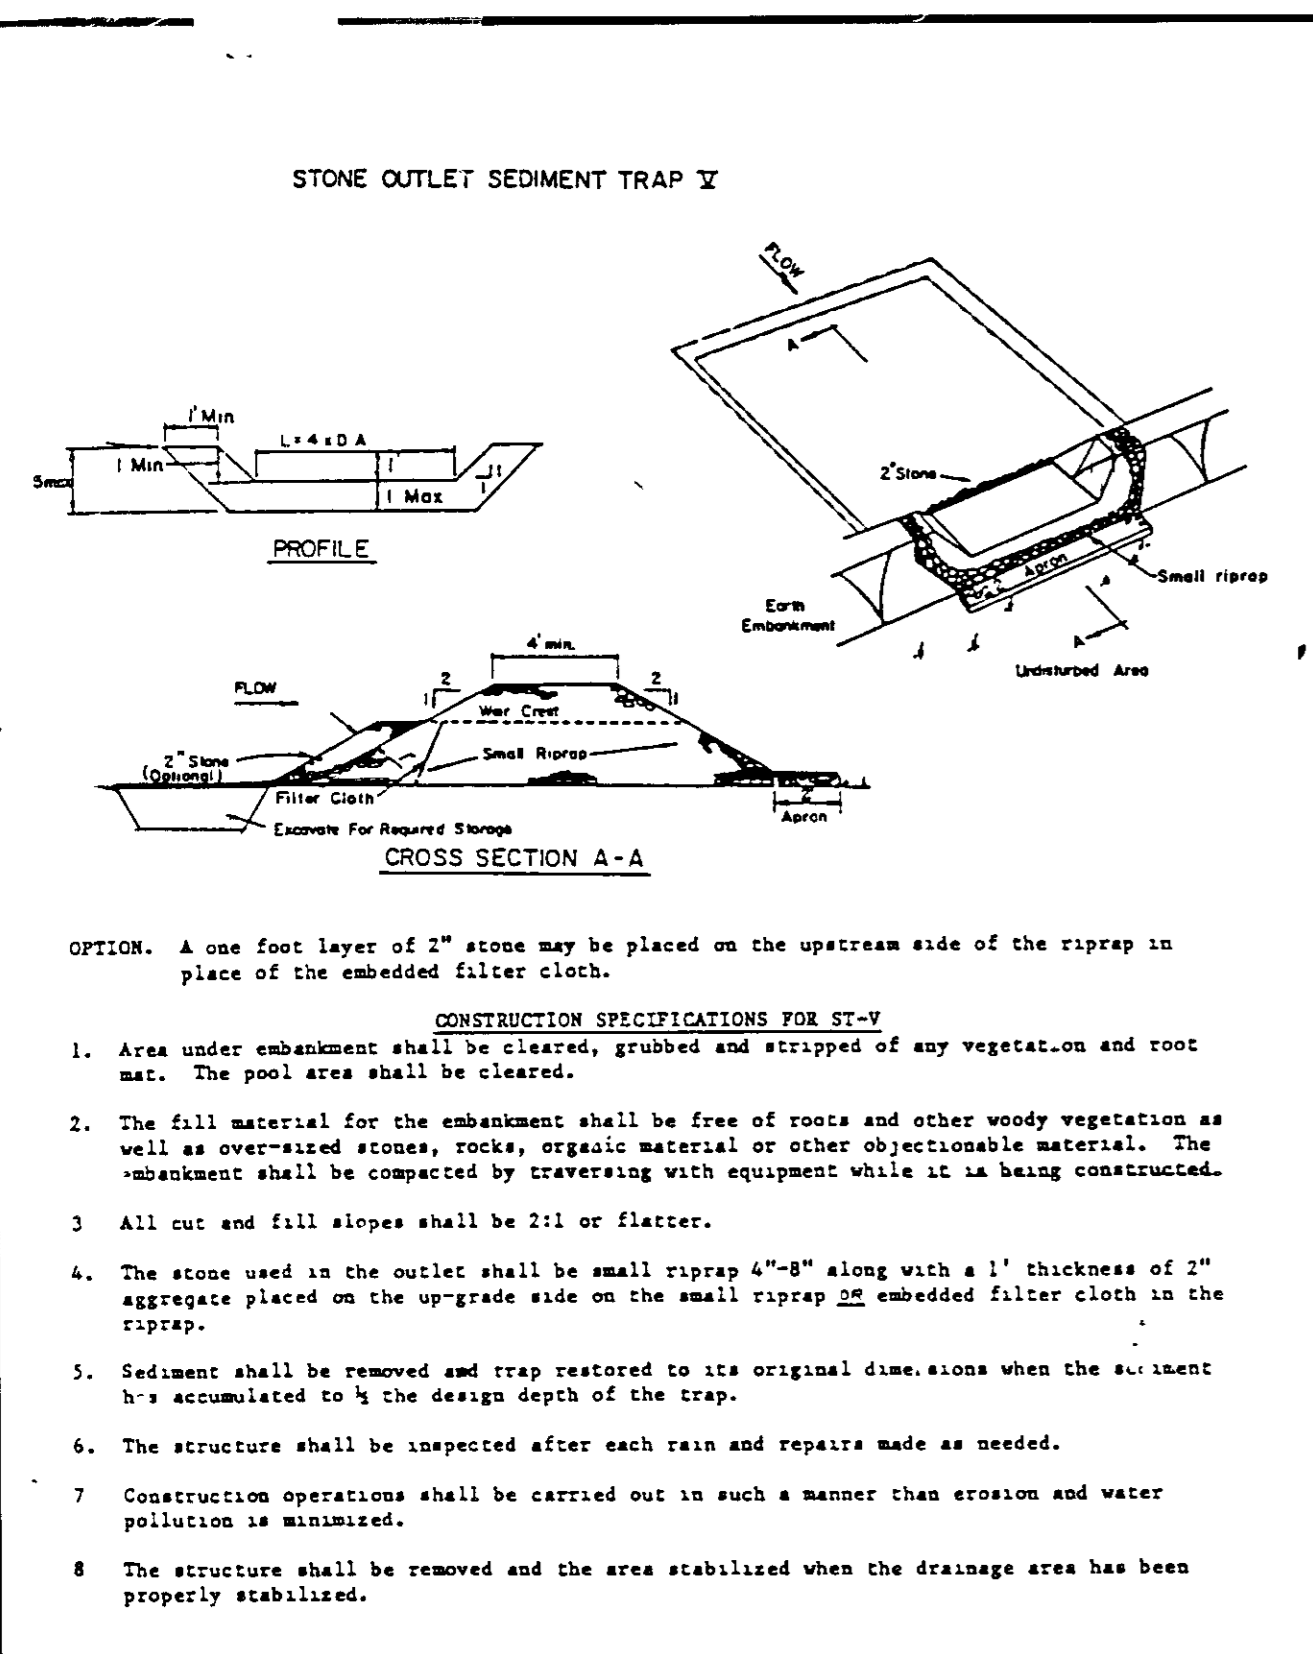

OPTION: A one foot layer of 2" stone may be placed on the upstream side of the riprap in place of the embedded filter cloth.


- Area under embankment shall be cleared, grubbed and stripped of any vegetation and root mat. The pool area shall be cleared.
- The fill material for the embankment shall be free of roots and other woody vegetation as well as oversized stones, rocks, organic material or other objectionable material. The embankment shall be compacted by traversing with equipment while it is being constructed.
- All cut and fill slopes shall be 2:1 or flatter.
- The stone used in the outlet shall be small riprap 4"-8" along with a 1" thickness of 2" aggregate placed on the up-grade side on the small riprap and embedded filter cloth in the trap.
- Sediment shall be removed and trap restored to its original dimensions when the sediment has accumulated to 1/2 the design depth of the trap.
- The structure shall be inspected after each rain and repairs made as needed.
- Construction operations shall be carried out in such a manner that erosion and water pollution is minimized.
- The structure shall be removed and the area stabilized when the drainage area has been properly stabilized.

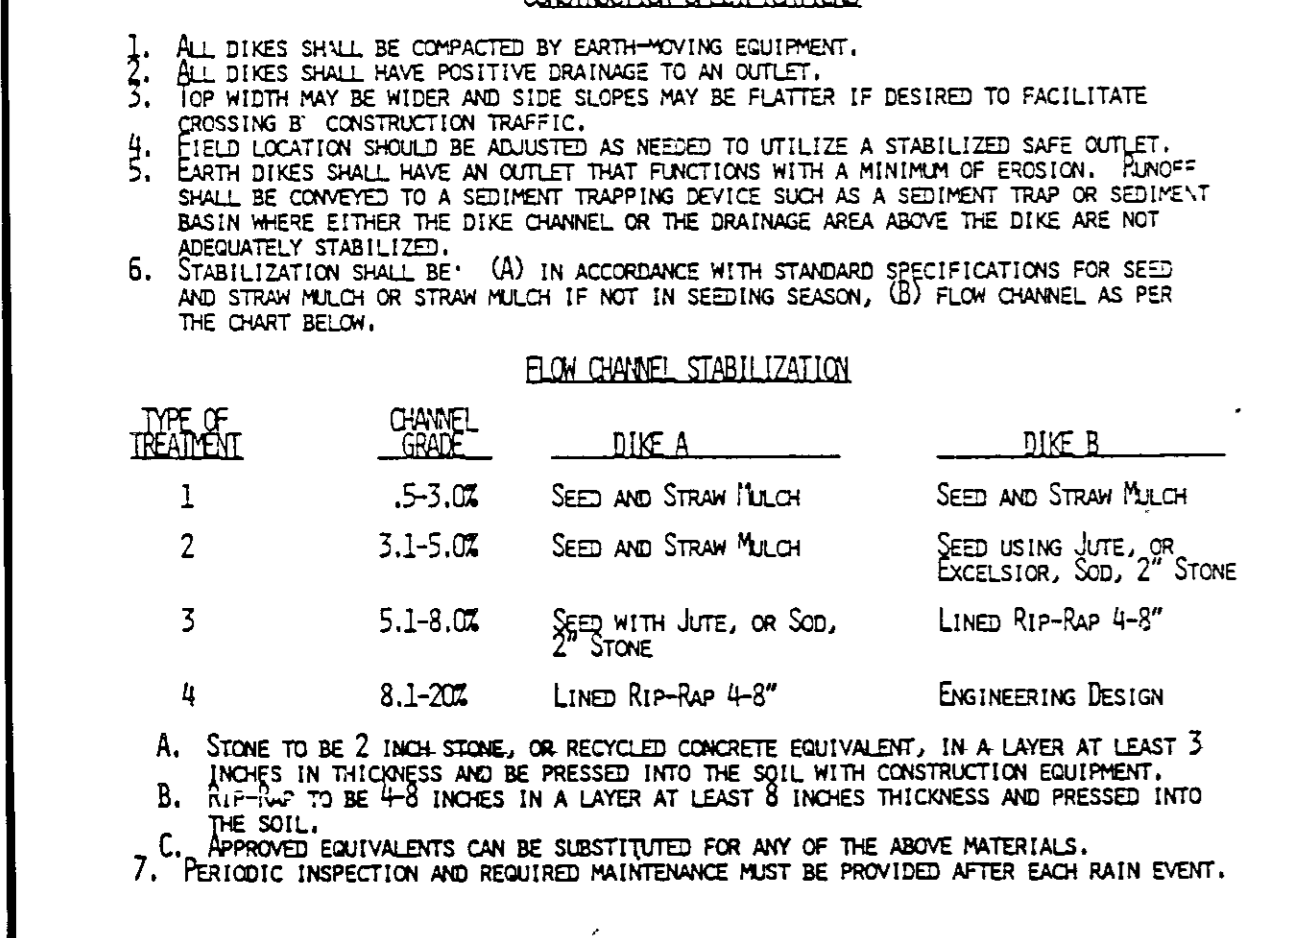


TYPE OF TREATMENT	CHANNEL GRADE	DIKE A	DIKE B
1	5-5.0%	SEED AND STRAW MULCH	SEED AND STRAW MULCH
2	3.1-5.0%	SEED AND STRAW MULCH	SEED USING JUTE, OR EXCELSTOR, SOG, 2" STONE
3	5.1-8.0%	SEED WITH JUTE, OR SOG, 2" STONE	LINED RIP-RAP 4-8"
4	8.1-20%	LINED RIP-RAP 4-8"	ENGINEERING DESIGN

- STONE TO BE 2 INCH STONE, OR RECYCLED CONCRETE EQUIVALENT, IN A LAYER AT LEAST 3 INCHES IN THICKNESS AND BE PRESSED INTO THE SOIL WITH CONSTRUCTION EQUIPMENT.
 - RIP-RAP TO BE 4-8 INCHES IN A LAYER AT LEAST 8 INCHES THICKNESS AND PRESSED INTO THE SOIL.
 - APPROVED EQUIVALENTS CAN BE SUBSTITUTED FOR ANY OF THE ABOVE MATERIALS.
- PERIODIC INSPECTION AND REQUIRED MAINTENANCE MUST BE PROVIDED AFTER EACH RAIN EVENT.

3 EARTH DIKE

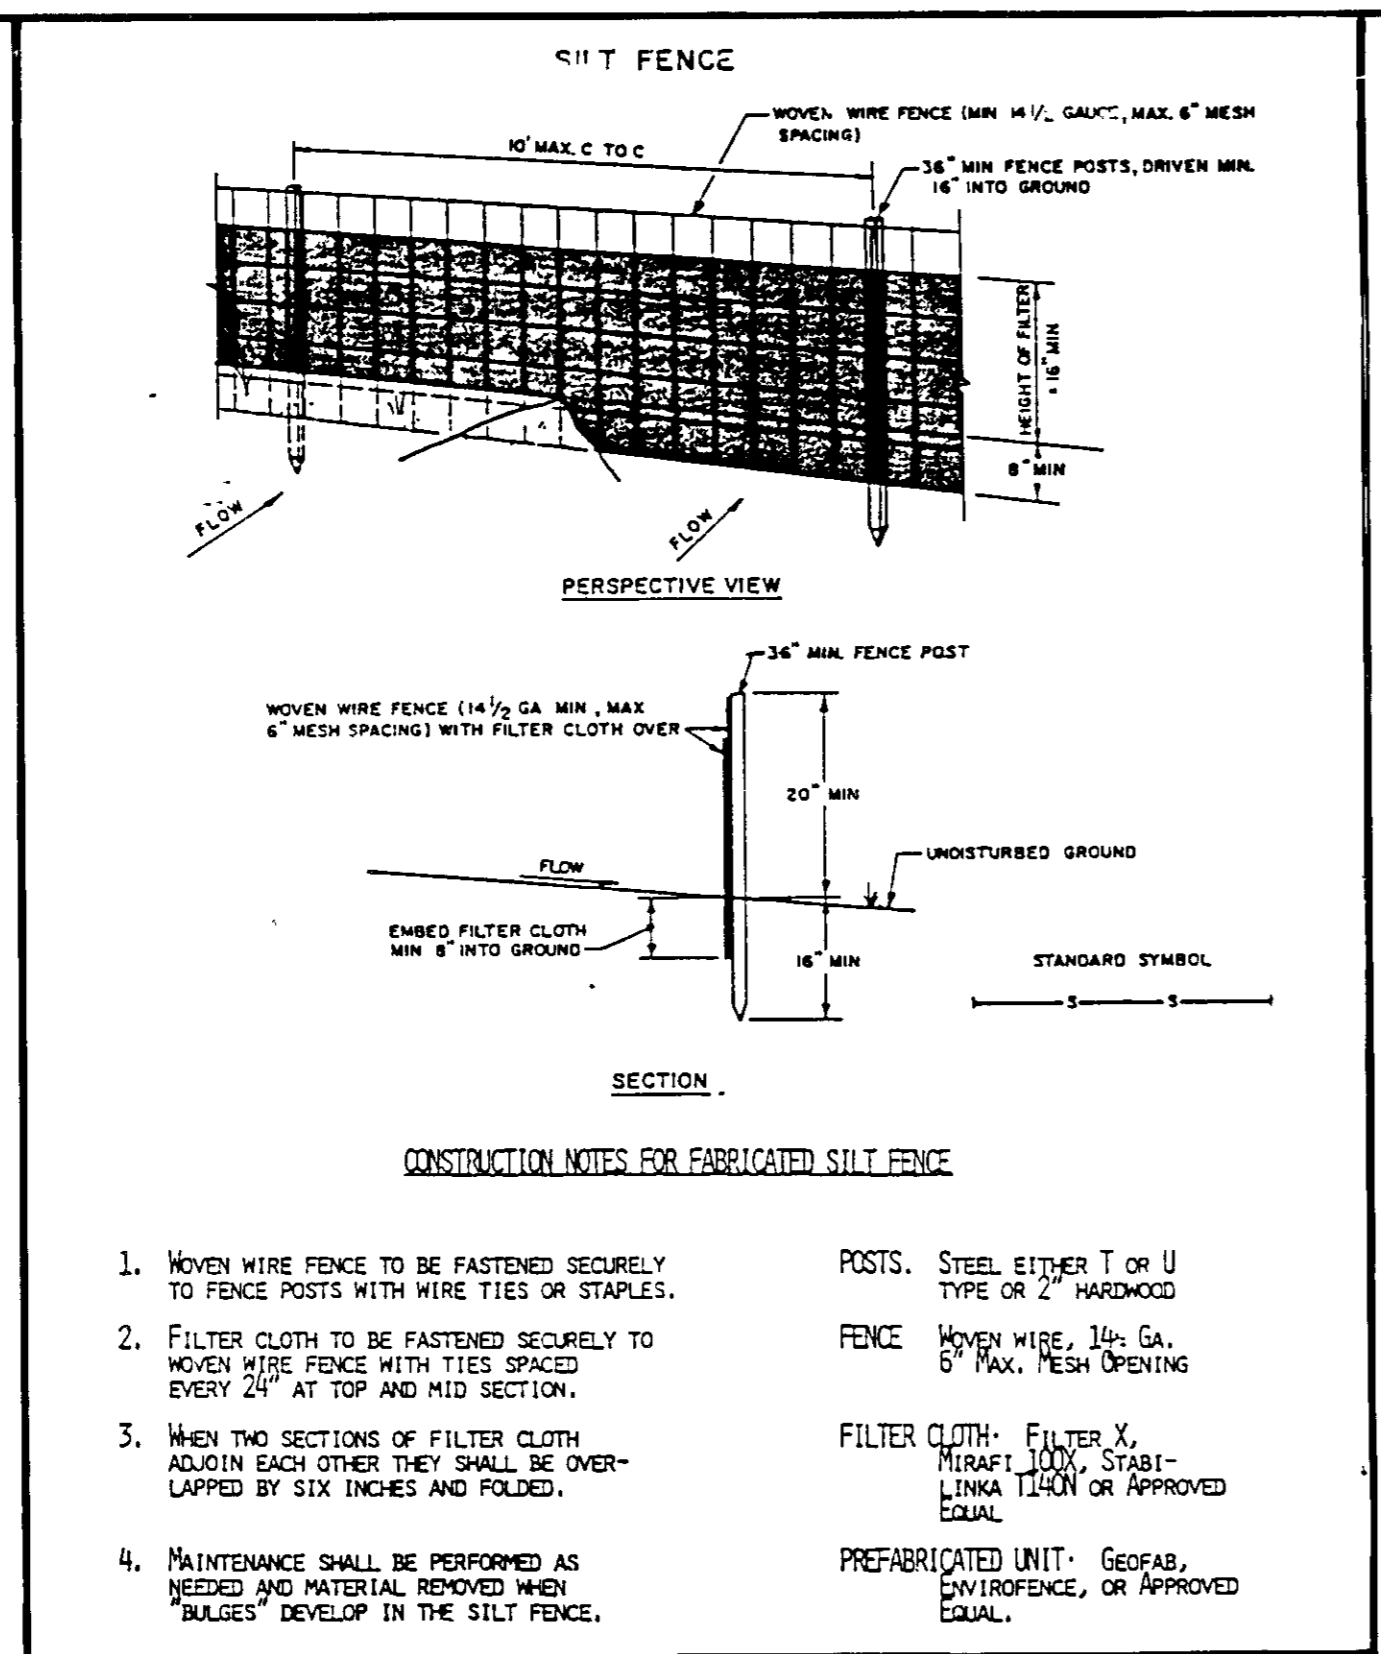

- WOVEN WIRE FENCE TO BE FASTENED SECURELY TO FENCE POSTS WITH WIRE TIES OR STAPLES.
- FILTER CLOTH TO BE FASTENED SECURELY TO WOVEN WIRE FENCE WITH TIES SPACED EVERY 24" AT TOP AND MID SECTION.
- WHEN TWO SECTIONS OF FILTER CLOTH ADJOIN EACH OTHER THEY SHALL BE OVERLAPPED BY SIX INCHES AND FOLDED.
- MAINTENANCE SHALL BE PERFORMED AS NEEDED AND MATERIAL REMOVED WHEN 'BULGES' DEVELOP IN THE SILT FENCE.

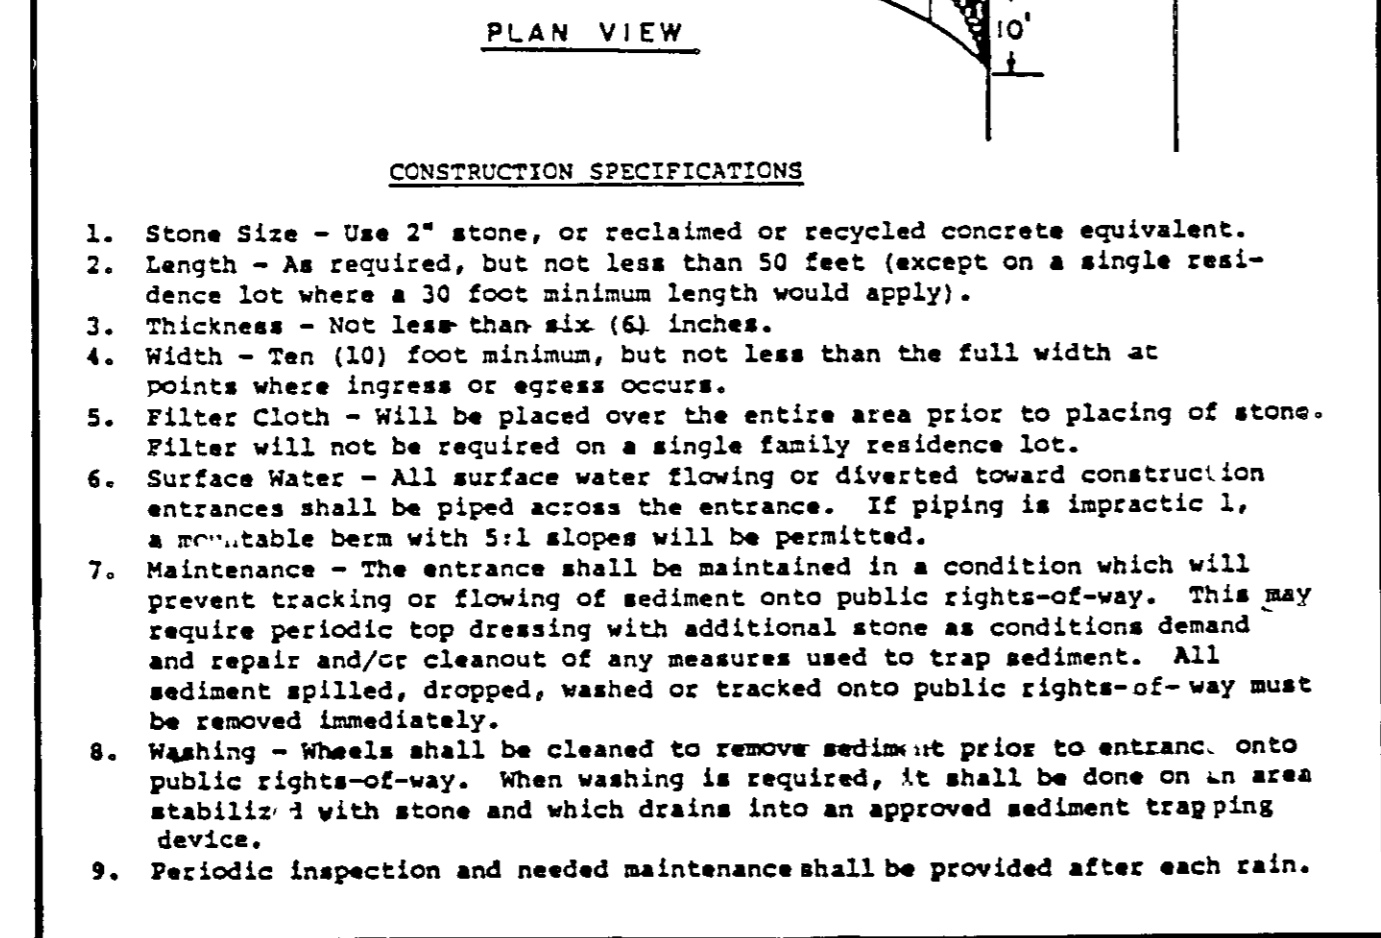

- Stone Size - Use 2" stone, or reclaimed or recycled concrete equivalent.
- Length - As required, but not less than 50 feet (except on a single residence lot where a 30 foot minimum length would apply).
- Thickness - Not less than six (6) inches.
- Width - Ten (10) foot minimum, but not less than the full width at points where ingress or egress occurs.
- Filter Cloth - Will be placed over the entire area prior to placing of stone. Filter will not be required on a single family residence lot.
- Surface Water - All surface water flowing or diverted toward construction entrances shall be piped across the entrance. If piping is impracticable, a mountable berm with 5:1 slopes will be permitted.
- Maintenance - The entrance shall be maintained in a condition which will prevent tracking or flowing of sediment onto public rights-of-way. This may require periodic top dressing with additional stone as conditions demand and repair and/or cleanout of any measures used to trap sediment. All sediment spilled, dropped, washed or tracked onto public rights-of-way must be removed immediately.
- Washing - Wheels shall be cleaned to remove sediment prior to entrance onto public rights-of-way. When washing is required, it shall be done on an area stabilized with stone and which drains into an approved sediment trapping device.
- Periodic inspection and needed maintenance shall be provided after each rain.

4 STABILIZED CONSTRUCTION ENTRANCE

PERMANENT SEEDING NOTES

Apply to graded or cleared areas not subject to immediate further disturbance where a permanent long-lived vegetative cover is needed.

Seedbed Preparation: Loosen upper three inches of soil by raking, discing or other acceptable means before seeding, if not previously loosened

Soil Amendments: In lieu of soil test recommendations, use one of the following schedule:

- Preferred - Apply 2 tons per acre dolomitic limestone (92 lbs/1000 square ft) and 600 lbs per acre 10-10-10 fertilizer (14 lbs/1000 sq ft) before seeding. Harrow or disc into upper three inches of soil. At time of seeding, apply 400 lbs per acre 30-0-0 ureaform fertilizer (9 lbs/1000 sq ft).
- Acceptable - Apply 2 tons per acre dolomitic limestone (92 lbs/1000 sq ft) and 1000 lbs per acre 10-10-10 fertilizer (23 lbs/1000 sq ft) before seeding. Harrow or disc into upper three inches of soil.

Seeding - For the periods March 1 thru April 30, and August 1 thru October 15, seed with 60 lbs per acre (1.4 lbs/1000 sq ft) of Kentucky 31 Tall Fescue. For the period May 1 thru July 31, seed with 60 lbs Kentucky 31 Tall Fescue per acre and 2 lbs per acre (.05 lbs/1000 sq ft) of weeping lovegrass. During the period of October 16 thru February 28, protect site by Option (1) 2 tons per acre of well anchored straw mulch and seed as soon as possible in the spring. Option (2) Use sod. Option (3) Seed with 60 lbs/acre Kentucky 31 Tall Fescue and mulch with 2 tons/acre well anchored straw.

Mulching - Apply 1 1/2 to 2 tons per acre (70 to 90 lbs/1000 sq ft) of rotted small grain straw immediately after seeding. Anchor mulch immediately after application using mulch anchoring tool or 218 gallons per acre (5 gal/1000 sq ft) of emulsified asphalt on flat areas. On slopes 8 feet or higher, use 348 gallons per acre (8 gal/1000 sq ft) for anchoring.

Maintenance - Inspect all seeded areas and make needed repairs, replacements and reseeding.

TEMPORARY SEEDING NOTES

Apply to graded or cleared areas likely to be redistributed where a short-term vegetative cover is needed.

Seedbed Preparation: Loosen upper three inches of soil by raking, discing or other acceptable means before seeding, if not previously loosened

Soil Amendments: Apply 600 lbs per acre 10-10-10 fertilizer (14 lbs/1000 sq ft)

Seeding - For periods March 1 thru April 30 and from August 15 thru November 15, seed with 2 1/2 bushel per acre of annual rye (3.2 lbs/1000 sq ft). For the period May 1 thru August 14, seed with 3 lbs per acre of weeping lovegrass (.07 lbs/1000 sq ft). For the period November 16 thru February 28, protect site by applying 2 tons per acre of well anchored straw mulch and seed as soon as possible in the spring, or use sod.

Mulching - Apply 1 1/2 to 2 tons per acre (70 to 90 lbs/1000 sq ft) of rotted small grain straw immediately after seeding. Anchor mulch immediately after application using mulch anchoring tool or 218 gal per acre (5 gal/1000 sq ft) of emulsified asphalt on flat areas. On slopes, 8 ft or higher, use 348 gal per acre (8 gal/1000 sq ft) for anchoring.

Refer to the 1983 MARYLAND STANDARDS AND SPECIFICATIONS FOR SOIL EROSION AND SEDIMENT CONTROL for rate and methods not covered.

SEDIMENT CONTROL NOTES

- A minimum of 24 hours notice must be given to the Howard County Office of Inspection and Permits prior to the start of any construction (992-2437)
- All vegetative and structural practices are to be installed according to the provisions of this plan and are to be in conformance with the 1983 MARYLAND STANDARDS AND SPECIFICATIONS FOR SOIL EROSION AND SEDIMENT CONTROL.
- Following initial soil disturbance or redistribution, permanent or temporary stabilization shall be completed within:
 - 7 calendar days for all perimeter sediment control structures, dikes, perimeter slopes and all slopes greater than 3:1.
 - 14 days as to all other disturbed or graded areas on the project site.
- All sediment traps/basins shown must be fenced and warning signs posted around their perimeter in accordance with Vol. 1, Chapter 12, of the HOWARD COUNTY DESIGN MANUAL, Storm Drainage.
- All disturbed areas must be stabilized within the time period specified above in accordance with the 1983 MARYLAND STANDARDS AND SPECIFICATIONS FOR SOIL EROSION AND SEDIMENT CONTROL for permanent seedings (Sec. 51) sod (Sec. 54), temporary seeding (Sec. 50) and mulching (Sec. 52). Temporary stabilization with mulch alone can only be done when recommended seeding dates do not allow for proper germination and establishment of grasses.
- All sediment control structures are to remain in place and are to be maintained in operative condition until permission for their removal has been obtained from the Howard County Sediment Control Inspector.
- Site Analysis.

Total Area of Site	25.26 Acres
Area Disturbed	11.66 Acres
Area to be roofed or paved	1.10 Acres
Area to be vegetatively stabilized	10.56 Acres
Total Cut	500 Cu. Yds.
Total Fill	4700 Cu. Yds.
Office waste/borrow area location	NOT KNOWN
- Any sediment control practice which is disturbed by grading activity for placement of utilities must be repaired on the same day of disturbance.
- Additional sediment controls must be provided, if deemed necessary by the Howard County DPW sediment control inspector.
- On all sites with disturbed areas in excess of 2 acres, approval of the inspection agency shall be requested upon completion of installation of perimeter erosion and sediment controls, but before proceeding with any other earth disturbance or grading. Other building or grading inspection approvals may not be authorized until this initial approval by the inspection agency is made.
- On all sites with disturbed areas in excess of 2 acres, approval of the inspection agency shall be requested upon completion of installation of perimeter erosion and sediment controls, but before proceeding with any other earth disturbance or grading. Other building or grading inspection approvals may not be authorized until this initial approval by the inspection agency is made.

* The information shown for Howard County only and not to be used for bidding purposes by the contractor

BY THE DEVELOPER:

"I/WE CERTIFY THAT ALL DEVELOPMENT AND CONSTRUCTION WILL BE DONE ACCORDING TO THIS PLAN, AND THAT ANY RESPONSIBLE PERSONNEL INVOLVED IN THE CONSTRUCTION PROJECT WILL HAVE A CERTIFICATE OF ATTENDANCE AT A DEPARTMENT OF NATURAL RESOURCES APPROVED TRAINING PROGRAM FOR THE CONTROL OF SEDIMENT AND EROSION BEFORE BEGINNING THE PROJECT. I ALSO AUTHORIZE PERIODIC ONSITE INSPECTION BY THE HOWARD SOIL CONSERVATION DISTRICT"

Rev Brian M Rafferty
SIGNATURE OF DEVELOPER
8-22-89
DATE

BY THE ENGINEER:

"I CERTIFY THAT THIS PLAN FOR EROSION AND SEDIMENT CONTROL REPRESENTS A PRACTICAL AND WORKABLE PLAN BASED ON MY PERSONAL KNOWLEDGE OF THE SITE CONDITIONS AND THAT IT WAS PREPARED IN ACCORDANCE WITH THE REQUIREMENTS OF THE HOWARD COUNTY SOIL CONSERVATION DISTRICT"


Philip Der
SIGNATURE OF ENGINEER
5/12/89
DATE

PHILIP DER
S.C.D. AND MEETS TECHNICAL REQUIREMENTS.

J. Schantz
U.S. SOIL CONSERVATION SERVICE
9/27/89
DATE

THIS DEVELOPMENT PLAN IS APPROVED FOR SOIL EROSION AND SEDIMENT CONTROL BY THE HOWARD SOIL CONSERVATION DISTRICT.

Robert J. Zich
HOWARD S.C.D.
9/27/89
DATE

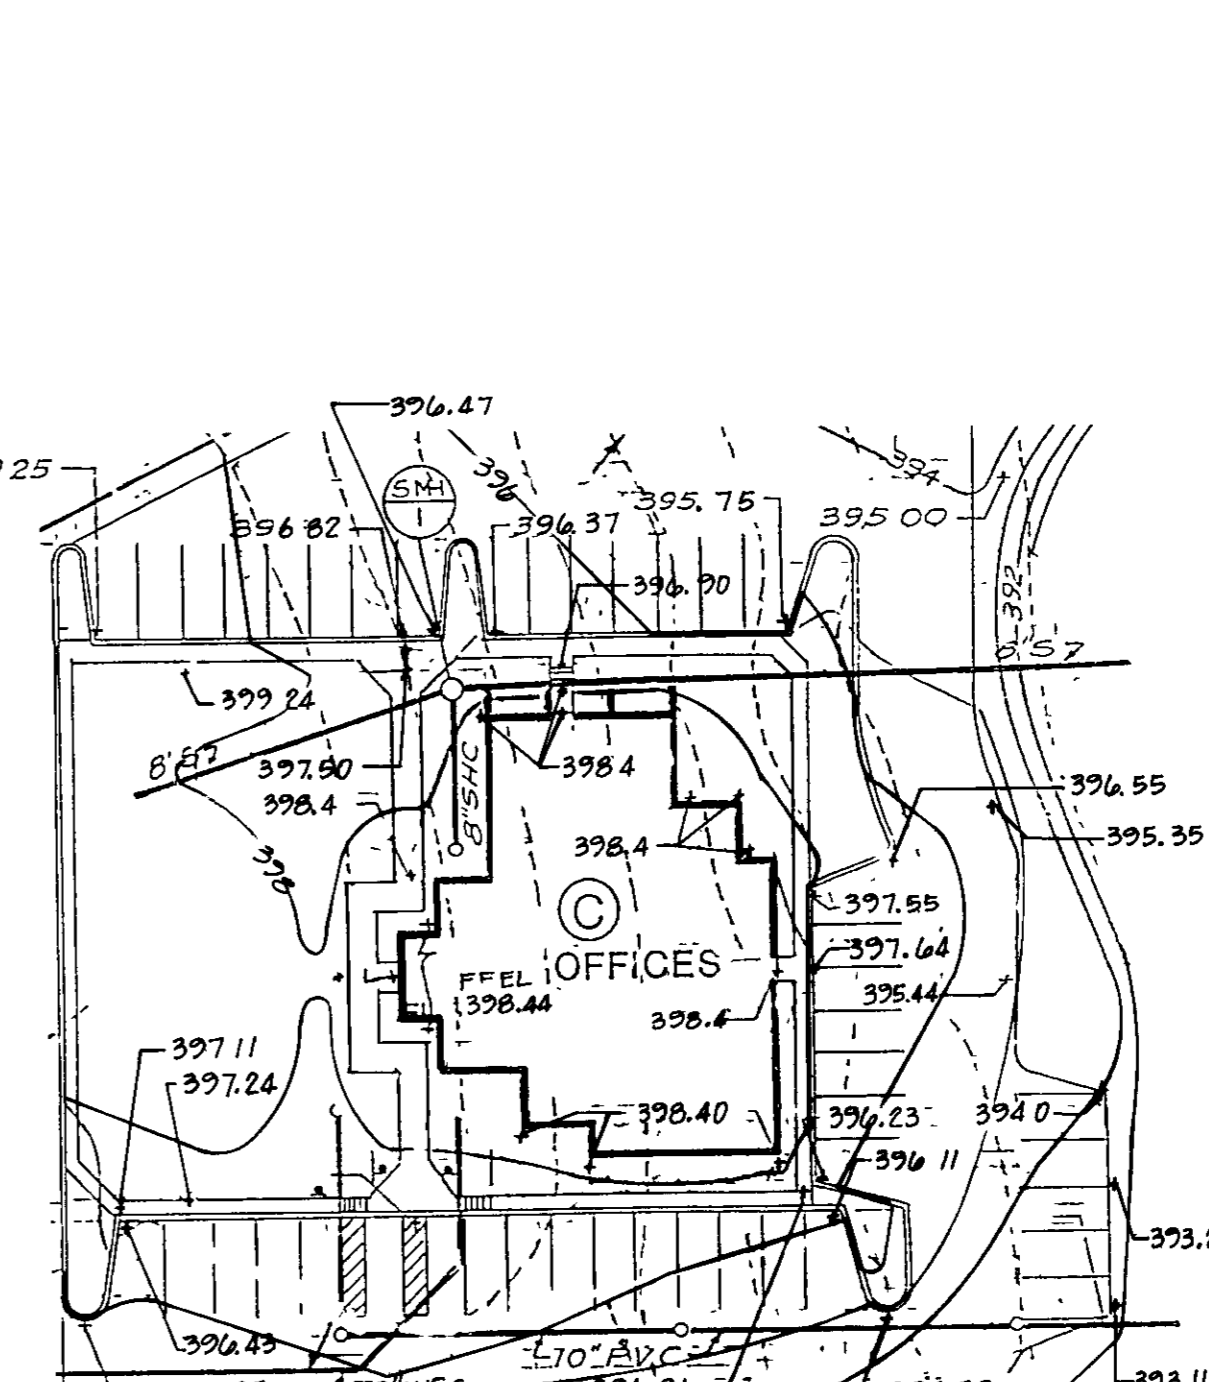

7-17-89

DATE	NO	REVISED PER HO CO COMMENTS	REVISION
5/10/89			
		APPROVED FOR PUBLIC WATER AND SEWERAGE, STORM DRAINAGE SYSTEMS AND PUBLIC ROADS HOWARD COUNTY DEPARTMENT OF PUBLIC WORKS	
		<i>James P. Schantz</i> DIRECTOR	11/23/89 DATE
		<i>William S. Ray</i> CHIEF, BUREAU OF ENGINEERING	11-29-89 DATE
		APPROVED FOR PUBLIC WATER AND PUBLIC SEWER SYSTEMS HOWARD COUNTY HEALTH DEPARTMENT	
		<i>James M. Boydland per JPM</i> COUNTY HEALTH OFFICER	11/29/89 DATE
		APPROVED HOWARD COUNTY DEPT OF PLANNING AND ZONING	
		<i>Joseph K. Smith</i> DIRECTOR	12/6/89 DATE
		<i>Frank S. Ziegler</i> CHIEF, DIVISION OF COMMUNITY PLANNING AND DEVELOPMENT	1/4/89 DATE
OWNER CHURCH OF THE RESURRECTION PAULSKIRK DRIVE & NORTH CHATHAM ROAD ELLCOTT CITY, MARYLAND 21043 TEL. (301) 461-9111			
PROJECT: SCHOOL AND CHAPEL / OFFICE BUILDING			
CHURCH OF THE RESURRECTION SEDIMENT CONTROL DETAILS			
2ND ELECTION DISTRICT TAX MAP NO 24		HOWARD COUNTY, MD PARCEL 456,117 & 990	
ENGINEERS: WHITNEY, BAILEY, COX & MAGNANI CONSULTING ENGINEERS 1850 YORK ROAD TIMONUM, MD. 21093 (301) 252-6060			
DESIGNED:	A R		
DRAWN:	GSB		
CHECKED:	P D		
DATE:	10/13/88		
SCALE:	NOT TO SCALE		
DRAWING NO:	SHEET 13 OF 13		
	C-13		