

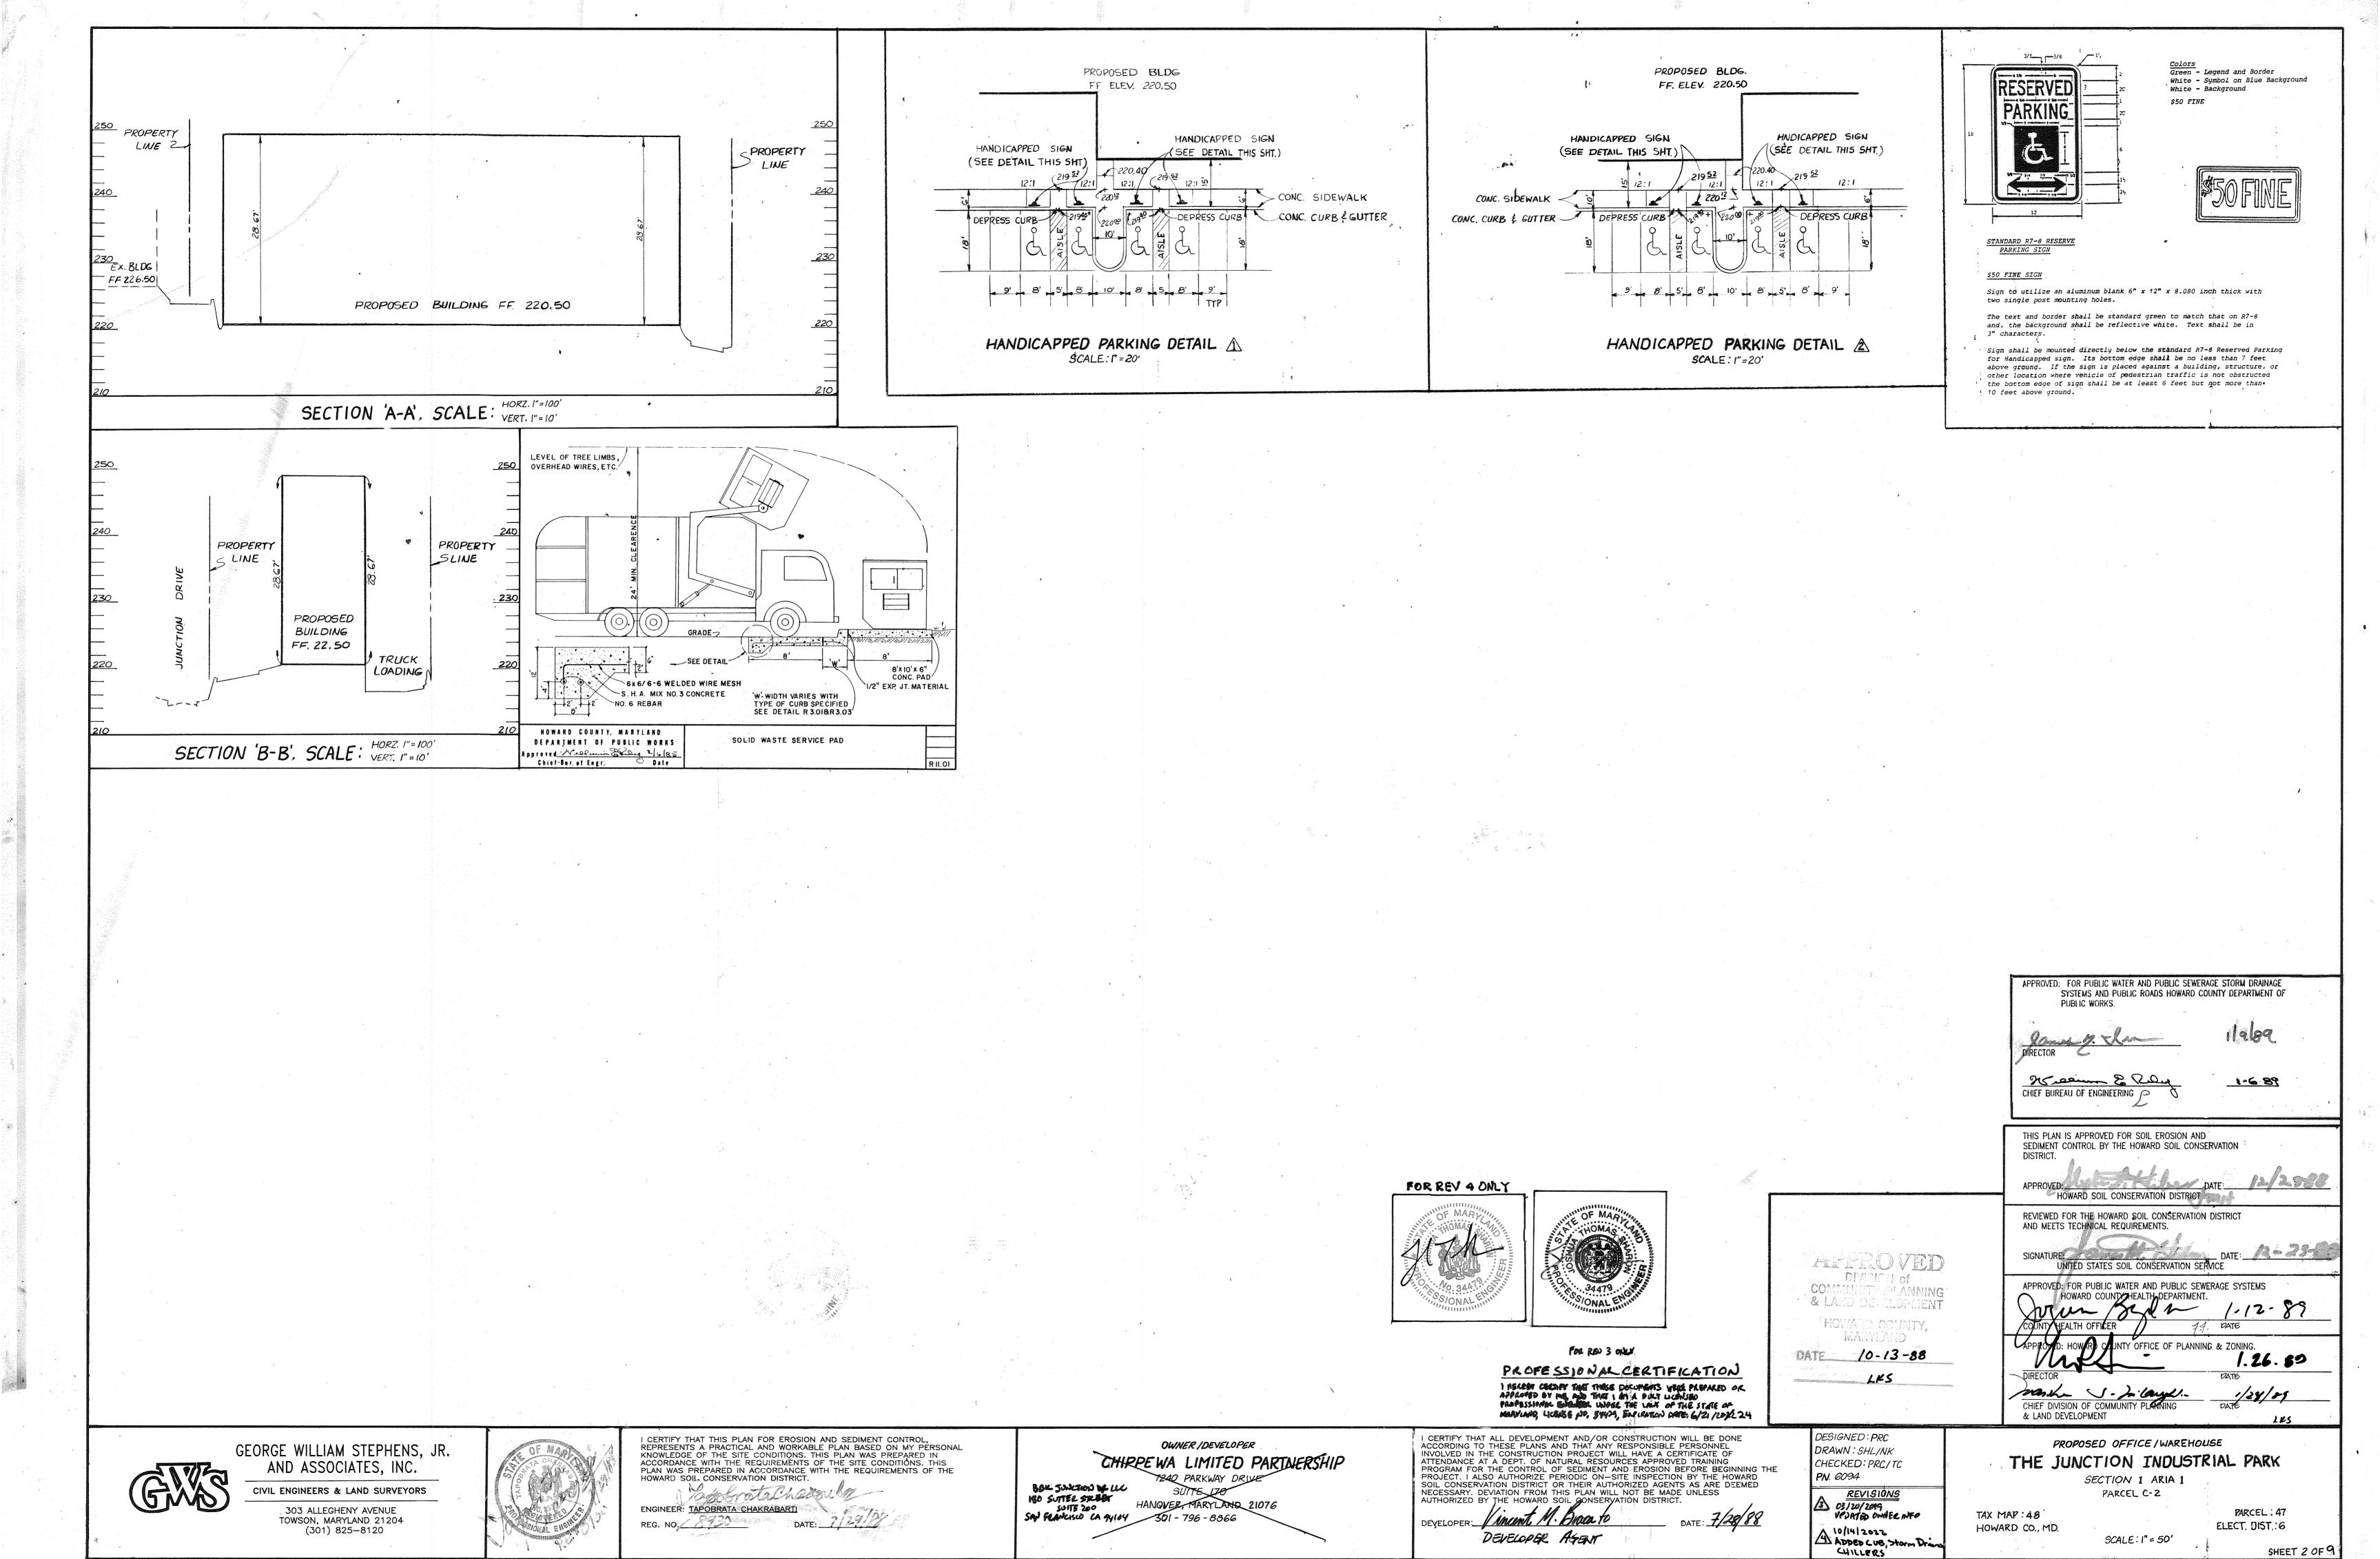


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SDP-89-29

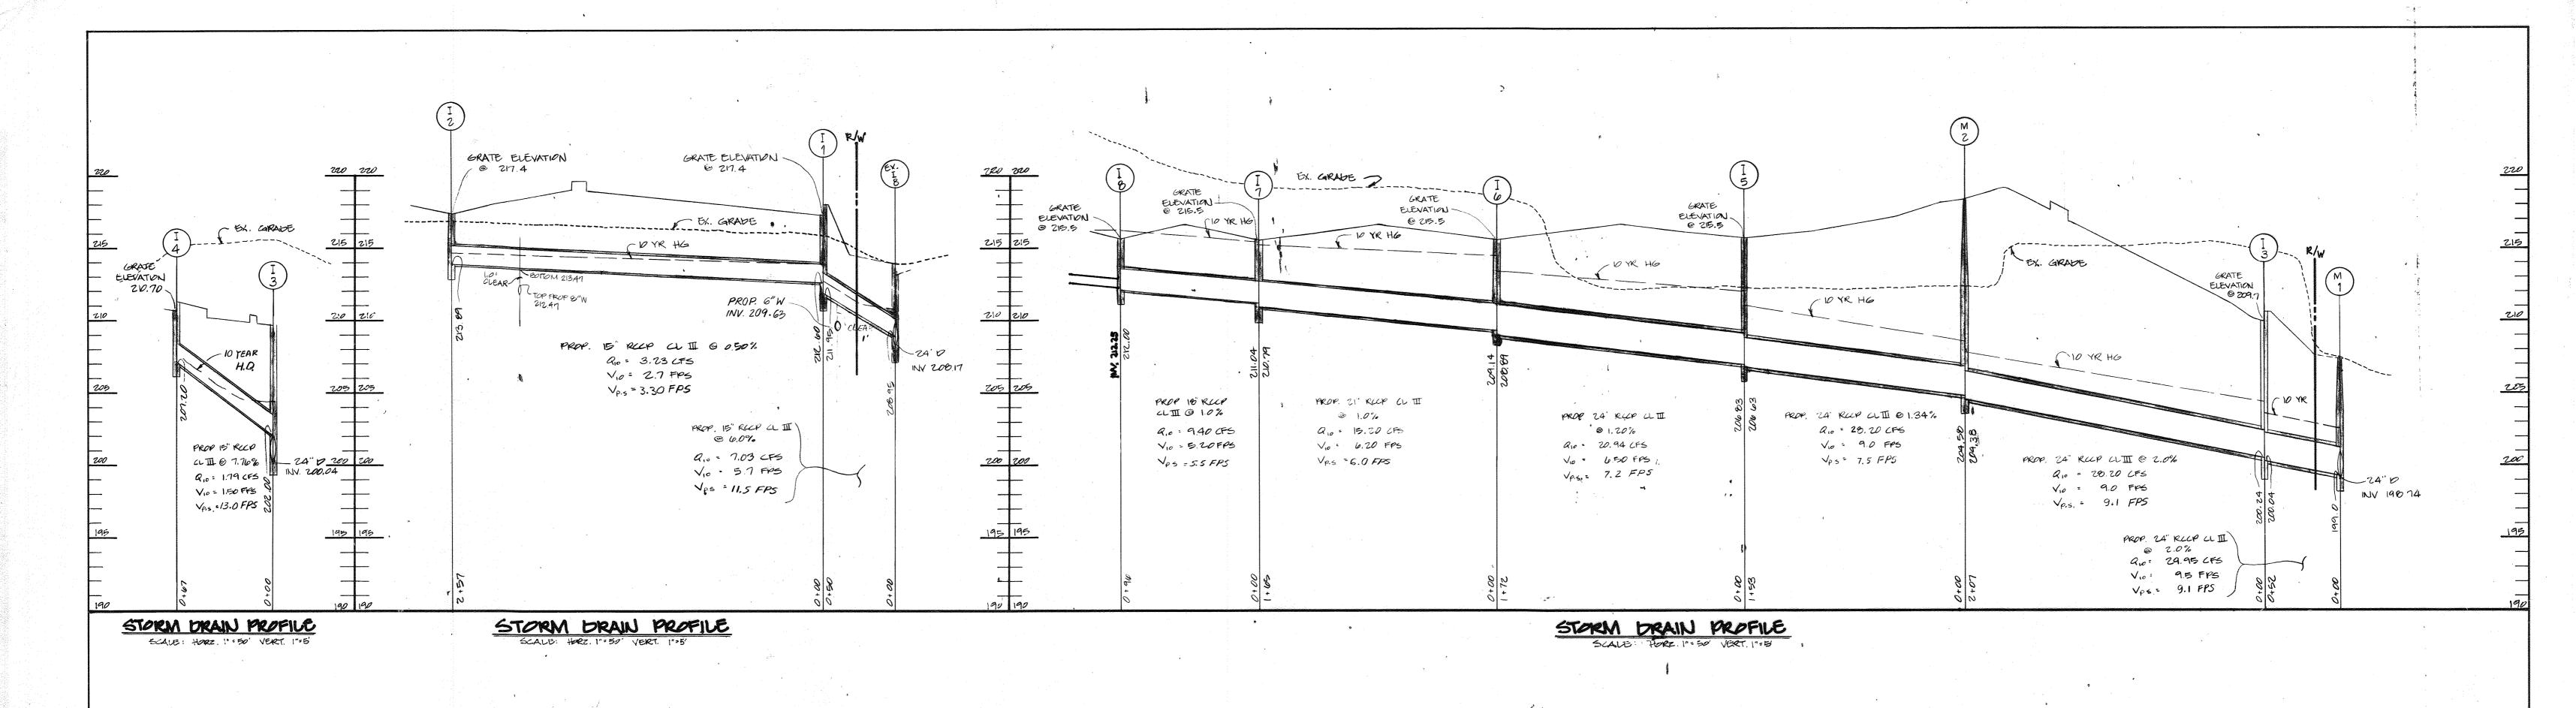


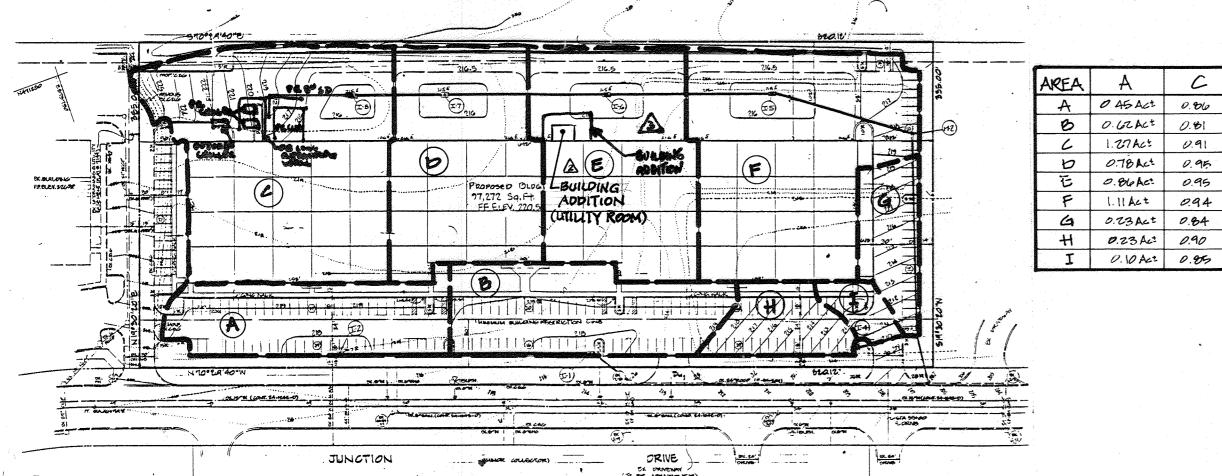


AREA	<i>1</i> 11	
A	0 45 Act	0.86
B	0.62AC+	0.81
6	1.27 Act	0.91
b	0.78 Act	0.95
毛	0.86AC	0.95
F	1.11 Act	0.94
6	0.73 Act	0.84
H	0.23 Act	0.90
I	0.10 Ac=	0.85


STORM DRAIN DRAINAGE AREA MAP

·····	MANHOL	E & IN	LET S	CHEDUL	走
ND.	TYPE	INV. IN	INV. OUT	TOP ELEV.	remarks
I-1	DOUBLE'S' COMB.	212.60	211.95	217.40	SEE HO. CO. STD. S.D. 4.34
I-2	bouble 's comb.		213.89	217.40	. 15 56 56 55
1.3	POUBLE'S' COMB	202.00	200.04	209.70	
I-4	bouble 's' comb.		201.20	210.70	11 15 14 15 14
I.5	600 6 15 'S'	206.83	206.63	215.50	SEE HO. W. STO. S.D. 4.23
I-6	bauble 's'	209.14	208.89	215.50	fo 30 40 60 00 11
I-7	bouble 's'	211.04	210.79	215.50	10 H 11 10 15 15
1-8	balble '5'		212.00	215.50	, is to 40 40 40
M-I	PRECAST MH	199.00	198.74	207.30	SEE HO. CO. STD. G-5.12
M-Z	PRECAST MH	204.58	204.38	218.55	14 16 15 16 15

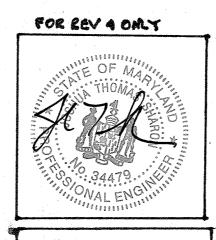


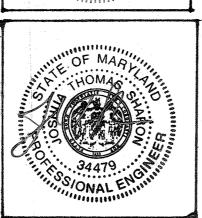

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SCALE: HORZ. 1" . 50 YERT. 1" . 5

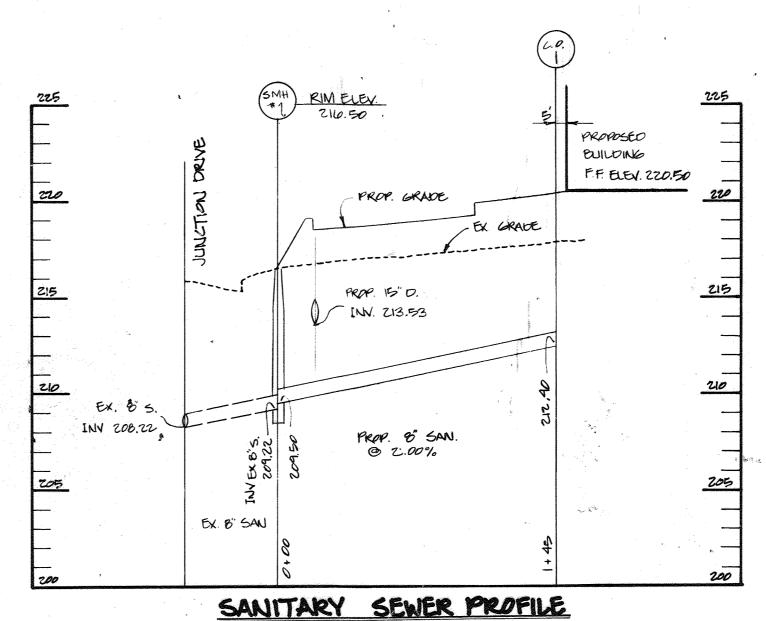

APPROVED: FOR PUBLIC WATER AND PUBLIC SEWERAGE STORM DRAINAGE SYSTEMS AND PUBLIC ROADS HOWARD COUNTY DEPARTMENT OF PUBLIC WORKS.

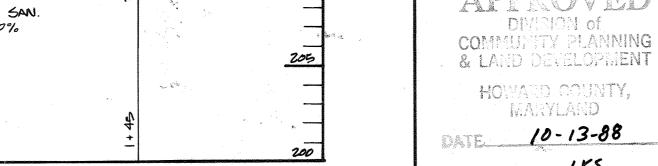Wien & Ride SEAL APPLICABLE TO REVISION ONLY CHIEF BUREAU OF ENGINEERING P

> THIS PLAN IS APPROVED FOR SOIL EROSION AND SEDIMENT CONTROL BY THE HOWARD SOIL CONSERVATION.

APPROVE HOWARD SOIL CONSERVATION DISTRICT REVIEWED FOR THE HOWARD SOIL CONSERVATION DISTRICT AND MEETS TECHNICAL REQUIREMENTS.

UNITED STATES SOIL CONSERVATION SERVICE APPROVED: FOR PUBLIC WATER AND PUBLIC SEWERAGE SYSTEMS

Y OFFICE OF PLANNING & ZONING.

CHIEF DIVISION OF COMMUNITY PLANTING & LAND DEVELOPMENT

GEORGE WILLIAM STEPHENS, JR. AND ASSOCIATES, INC.

> CIVIL ENGINEERS & LAND SURVEYORS 303 ALLEGHENY AVENUE TOWSON, MARYLAND 21204 (301) 825-8120



ENGINEER'S CERTIFICATE:
I CERTIFY THAT THIS PLAN FOR EROSION AND SEDIMENT CONTROL REPRESENT A PRACTICAL AND WORKABLE PLAN BASED ON MY PERSONAL KNOWLEDGE OF THE SITE CONDITIONS. THIS PLAN WAS PREPARED IN ACCORDANCE WITH THE RE-QUIREMENTS OF THE SITE CONDITIONS. THIS PLAN WAS PREPARED IN ACCORD—ANCE WITH THE REQUIREMENTS OF THE HOWARD SOIL CONSERVATION DISTRICT.

TAPOERATA CHARRABARTI

OWNER / DEVELOPER CHIPPEWA LIMITED PARTNERSHIP BOK JUNTION DRIVE, LL 7240 PARKWAY DRIVE SAN FRANCISCO, CA 14101 HANOVER, MARYLAND 21076 301-796-3860

DEVELOPER'S CERTIFICATE
I CERTIFY THAT ALL DEVELOPMENT AND/OR CONSTRUCTION WILL BE DONE
ACCORDING TO THESE PLANS AND THAT ANY RESPONSIBLE PERSONNEL INVOLVED IN THE CONSTRUCTION PROJECT WILL HAVE A CERTIFICATE OF ATTENDANCE AT A DEPT. OF NATURAL RESOURCES APPROVED PROGRAM FOR THE CONTROL OF SEDIMENT AND EROSION BEFORE BEGINNING THE PROJECT. I ALSO AUTHORIZE PERIODIC ON-SITE INSPECTION BY THE HOWARD SOIL CONSERVATION DISTRICT OR THEIR AUTHORIZED AGENTS AS ARE DEEMED NECESSARY. DEVIATION FROM THIS PLAN WILL NOT BE MADE UNLESS AUTHORIZED BY THE HOWARD, SOLD CONSERVATION DISTRICT.

DEVELOPER: DEVIATION DISTRICT.

DEVELOPER: DEVELOPER ALENT

DESIGNED: PRC DRAWN: SHL/NK CHECKED: PRC/TC PN. 6094 REVISIONS ADDED BUILDING

PROPOSED OFFICE/WAREHOUSE THE JUNCTION INDUSTRIAL PARK SECTION | AREA ! PARKEL 2 TAX MAP: 48 PARCEL: 47 HOWARD GONTY MD


SDP-89-29

ADDED CUB, STORM DRAINS, CHILLERS

ADD BUTUING ADDITION.

3 03/20/2019

SHEET JAF9

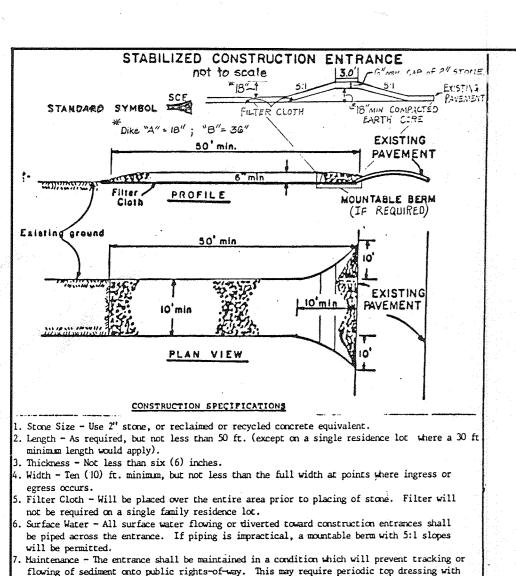

SEDIMENT CONTROL NOTES

Orainage.

7) Site Analysis:

Total Cur

Total Fill

lishment of grasses.

Total Ares of Site

Beainers Control Plan

acceptable weans before seeding.

Ares to be roofed or paved

Area Disturbed

1) A minimum of 24 hours notice must be given to the Howard County Office of Inspection and Permits

prior to the start of any construction. (992-2437)

and are to be in conformance with the 1983 MARYLAND STANDARDS AND SPECIFICATIONS FOR SOIL EROSION AND

3) Following initial soil disturbance or redisturbance, permanent or temporary stabilization shall be completed within: a) 7 calendar days for all perimeter sediment

control structures, dikes, perimeter slopes and all slopes greater than 3:1, b) 14 days as to all other

4) All seciment traps/basins shown must be fenced and warning signs

posted around their perimeter in accordance with Vol. 1.

Thaper 12, of the HOWARD COUNTY DESIGN MANUAL, Storm

disturbed or graded areas on the project site.

5) All disturbed areas must be stabilized within the

time period specified above in accordance with the

1983 MARYLAND STANDARDS AND SPECIFICATIONS FOR SOIL EROSION AND SEDIMENT CONTROL for permanent seedings

mulching (Sec. 52.) Temporary stabilization with

lates do not allow for proper germination and estab-

6) All sediment control structures are to remain in place

the Howard County Sediment Control Inspector

Ar a to be vegetatively stabilized 127

8) my sediment control practice which is disturbed by

9% Additional sediment controls must be provided, if

grading activity for placement of utilities must be

Of site waste/borrow area location

repaired on the same day of disturbance.

Soil Amendments: Use one of the following schedules:

form fertilizer (9 lbs./1000 sq. ft.)

19.ft.) of emulsified saphalt on flat areas

possible in the spring, or use sod.

MOUNTABLE

per acre (8 gal./1000 sq.ft.) for anchoring.

and are to be maintained in operative condition unril permission for their removal has been obtained from

5.04 Acres

deemed necessary by the Howard County DPW sediment control inspector

installation of perimeter erosion and sediment controls, but before

10 On all sites with disturbed areas in excess of 2 acres, approval of the inspection agency shall be requested upon completion of

proceeding with any other earth disturbance or grading. Other building or grading inspection approvals may not be authorized until

PERMANENT SEEDING NOTES

Seedbed Preparation: Loosen upper 3 inches of soil by raking, discing or other

1) Preferred - Apply 2 tons per acre dolcmitic limestone (92 lbs./1000 square ft.) and 600 lbs. per acre 10-10-10 fertilizer (14 lbs/1000 eq.fr.) before seeding. Harrow or disc into upper three inches of. soil. At time of seeding, apply 400 lbs. per acre 30-0-0 urea

2) Acceptable - Apply 2 tons per acre do:omitic limestone (92 lbs./1000 sq.ft.) and 1000 lbs. per acre 10-10- 0 fertilizer (23lbs./1000 sq.fr.) before seeding. Harrow or disc into upper three inches of

Seeding - For the periods March I thru April 10, and August I thru October 15, seed with 60 lbs. per acre (1.4 lbs./1000 sq.ft.) of Kentucky 31 tall fascue.

For the period May 1 thru July 31, seed with 60 lbs. Kentucky 31 tall fescue

Mulching - Apply 15 to 2 tons per acre (70 to 90 lbs./1000 sq.ft.) of unrocced

small grain straw immediately after seeding. Anchor mulch invediately after

application using mulch anchoring tool or 218 gallons per acre (5 ga./1000

Maintenance - Inspect all seeded areas and make needed repairs, replacements

TEMPORARY SEEDING NOTES

Seedbed Preparation: Loosen upper I inches of soil by raking, discing or

Soil Amendments: Apply 600 lbs. per scre 10-10-10 fercilizer (14 lbs/1000 sq.ft.)

Seeding: For periods Harch 1 thru April 30 and from August 15 thru Nov. 15, seed with 25 bu. per acre of annual rye (3.2 ibs./1000 sq.ft.) For the period

1000 sq. ft.) for the period November 16 thru February 28, protect site by

Mulching Apply 19 to 2 tons per acre (70-90 lbs./1000 sq. st.) of unretted small grain straw immediately after seeding. Anchor mulch immediately after

application using mulch anchoring tool or 218 gal. per acre (5gal./1000 sq.ft.) of emulsified asphalt on flat areas. On slopes, 8 ft, or higher, use 348 gal.

FILTER CLOTH

"MIN COMPACTED EARTH

applying 2 cons per acre of well anchored straw mulch and seed as soon as

Hav I thru August 14, seed with 3 lbs. per icre of weeping lovegrass (.37 lbs./

per acre and 2 lbs. per acre (.05 lbs./1000 sq.ft.) of weeping lovegrass. During the period of October 16 thru February 28, protect site by: Option. (1) 2 mons per acre of well anchored acraw mulch and seed as soon as possible in the spring. Option (2) Use sod. Option (3) Seed with 60 lbs./acre

Kentucky 31 tall feacue and mulch with 2 tons/acre well anchored straw.

use 348 gallons per acre (8 gal./1000 sq.ft.) for anchoring.

this initial approval by the inspection agency is made. 11) Material Will Be Obtained From A Gite With An Approved

mulch alone can only be done when recommended seeding


(Sec. 51) sod (Sec. 54), temporary seeding (Sec. 50) and

2) All vegetative and structural practices are to be installed according to the provisions of this plan

flowing of sediment onto public rights-of-way. This may require periodic top dressing with additional stone as conditions demand and repair and/or cleanout of any measures used to trap sediment. All sediment spilled, dropped, washed or tracked onto public rights-of-way must be removed immediately. . Washing - Wheels shall be cleaned to remove sediment prior to entrance onto public rights-ofway. When washing is required, it shall be done on an area stabilized with stone and which drains into an approved sediment trapping device.

U. S. DEPARTMENT OF AGRICULTURE STABILIZED CONSTRUCTION Standard SOIL CONSERVATION SERVICE College Park, Md.

. Periodic inspection and needed maintenance shall be provided after each rain.

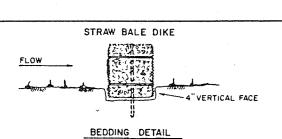


STANDARD SYMBOL SBD -


U.S. DEPARTMENT OF AGRICULTURE

DEPARTMENT OF AGRICULTURE

SOIL CONSERVATION SERVICE COLLEGE PARK, MARYLAND

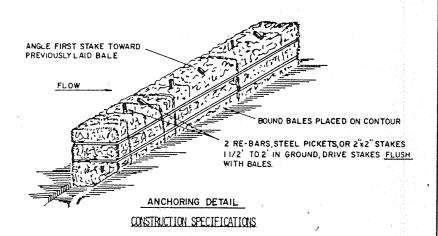

- 1. BALES SHALL BE PLACED AT THE TOE OF A SLOPE OR ON THE CONTOUR AND IN A ROW WITH ENDS TIGHTLY ABUTTING THE ADJACENT BALES.
- EACH BALE SHALL BE EMBEDDED IN THE SOIL A MINIMUM OF (4) INCHES, AND PLACED SO THE BINDINGS ARE HORIZONTAL.
- 3. BALES SHALL BE SECURELY ANCHORED IN PLACE BY EITHER TWO STAKES OR RE-BARS DRIVEN THROUGH THE BALE. THE FIRST STAKE IN EACH BALE SHALL BE DRIVEN TOWARD THE PREVIOUSLY LAID BALE AT AN ANGLE TO FORCE THE BALES TOGETHER. STAKES SHALL PE DRIVEN FLUSH WITH THE BALE.
- Inspection shall be frequent and repair replacement shall be made promptly as NEELED.
- Bales shall be removed when they have served their usefulness so as not to block or impede storm flow or drainage.

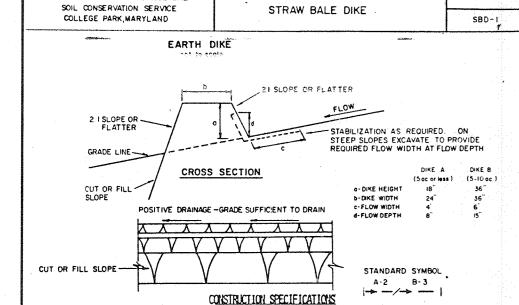

ALL DIKES SHALL BE COMPACTED BY EARTH-MOVING EQUIPMENT. ALL DIKES SHALL HAVE POSITIVE DRAINAGE TO AN OUTLET. TOP WIDTH MAY BE WIDER AND SIDE SLOPES MAY BE FLATTER IF DESIRED TO FACILITATE CROSSING BY CONSTRUCTION TRAFFIC.
FIELD LOCATION SHOULD BE ADJUSTED AS NEEDED TO UTILIZE A STABILIZED SAFE OUTLET.
EARTH DIKES SHALL HAVE AN OUTLET THAT FUNCTIONS WITH A MINIMUM OF EROSION, PUNCEF
SHALL BE CONVEYED TO A SEDIMENT TRAPPING DEVICE SUCH AS A SEDIMENT TRAP OR SEDIMENT
BASIN WHERE EITHER THE DIKE CHANNEL OR THE DRAINAGE AREA ABOVE THE DIKE ARE NOT

ADEQUATELY STABILIZED.

STABILIZATION SHALL BE: (A) IN ACCORDANCE WITH STANDARD SPECIFICATIONS FOR SEED AND STRAW MULCH OR STRAW MULCH IF NOT IN SEEDING SEASON, (B) FLOW CHANNEL AS PER THE CHART BELOW. FLOW CHANNEL STABILIZATION DIKE B .5-3.0% SEED AND STRAW MULCH SEED AND STRAW MULCH 3.1-5.0% SEED AND STRAW MULCH LINED RIP-RAP 4-8" SEED WITH JUTE, OR SOD; 2" STONE LINED RIP-RAP 4-8" ENGINEERING DESIGN A. STONE TO BE 2 INCH STONE, OR RECYCLED CONCRETE EQUIVALENT, IN A LAYER AT LEAST 3 INCHES IN THICKNESS AND BE PRESSED INTO THE SOIL WITH CONSTRUCTION EQUIPMENT.

B. RIP-RAP TO BE 4-8 INCHES IN A LAYER AT LEAST 8 INCHES THICKNESS AND PRESSED INTO THE SOIL.

C. APPROVED EQUIVALENTS CAN BE SUBSTITUTED FOR ANY OF THE ABOVE MATERIALS.

7. PERIODIC INSPECTION AND REQUIRED MAINTENANCE MUST BE PROVIDED AFTER EACH RAIN EVENT.


> EARTH DIKE GEORGE WILLIAM STEPHENS, JR.

AND ASSOCIATES, INC.

(301) 825-8120

CIVIL ENGINEERS & LAND SURVEYORS 303 ALLEGHENY AVENUE TOWSON, MARYLAND 21204



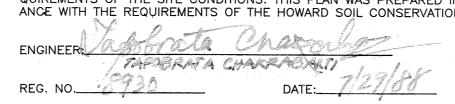

I CERTIFY THAT THIS PLAN FOR EROSION AND SEDIMENT CONTROL REPRESENT A PRACTICAL AND WORKABLE PLAN BASED ON MY PERSONAL KNOWLEDGE OF THE SITE CONDITIONS. THIS PLAN WAS PREPARED IN ACCORDANCE WITH THE RE-QUIREMENTS OF THE SITE CONDITIONS. THIS PLAN WAS PREPARED IN ACCORD-ANCE WITH THE REQUIREMENTS OF THE HOWARD SOIL CONSERVATION DISTRICT.



NIRE HESH

PLUGGING

CONSTRUCTION SPECIFICATIONS I PLACE NIKE MESH OVER INLET GRATE AND THROAT OPENING, OVERLAP & FEET AT ALL ENDS.

E PLACE A PIECE OF APPROVED FILTER CLOTH (40-85 SIEVE) (OF THE SAME DIMENSIONS OF THE WIKE MESH) OVER THE WIRE MESH. 3 PLACE SANDBAGS OVER FILTER CLOTH AND WHEE MECH SANDBAGS SHOULD OVERLAP AND COVER COMPLETE SURPACE OF THE

4 INSPECT FREQUENTLY TO INSURE SANDBAGE ARE SECURE A ID FILTER CLOTH IS FREE OF SEDILIENT, REPLACE PILIER CLOTH IT CLASSED.

STONE OUTLET SEDIMENT TRAP T CROSS SECTION A-A

SILT FENCE

PERSPECTIVE VIEW

CONSTRUCTION NOTES FOR FABRICATED SILT FENCE

SILT FENCE

WOVEN WIRE FENCE (14 1/2 GA, MIN., MAX. 6" MESH SPACING) WITH FILTER CLOTH OVER

Woven wire fence to be fastened securely to fence posts with wire ties or staples.

2. FILTER CLOTH TO BE FASTENED SECURELY TO WOVEN WIRE FENCE WITH TIES SPACED EVERY 24" AT TOP AND MID SECTION.

When two sections of filter cloth Adjoin each other they shall be over-LAPPED BY SIX INCHES AND FOLDED.

4. MAINTENANCE SHALL BE PERFORMED AS

U.S. DEPARTMENT OF AGRICULTURE

SOIL CONSERVATION SERVICE

COLLEGE PARK, MARYLAND

NEEDED AND MATERIAL REMOVED WHEN "BULGES" DEVELOP IN THE SILT FENCE.

WOVEN WIRE FENCE (MM. 14 1/2 GAUGE, MAX. 6" MESH SPACING)

POSTS: STEEL EITHER T OR U TYPE OR 2" HARDWOOD

FILTER CLOTH: FILTER X, MIRAFI 100X, STABI-LINKA 1140N OR APPROVED

PREFABRICATED UNIT: GEOFAB, ENVIROFENCE, OR APPROVED

CONSTRUCTION SPECIFICATIONS FOR ST-V 1. Area under embankment shall be cleared, grubbed and stripped of any vegetation and root mat. The pool area shall be cleared.

The fill material for the embankment shall be free of roots and other woody vegetation as well as over-sized stones, rocks, organic material or other objectionable material. The embankment shall be compacted by traversing with equipment while it is being constructed.

3. All cut and fill slopes shall be 2:1 or flatter.

4. The stone used in the outlet shall be small riprap 4"-8" along with a 1' thickness of 2" aggregate placed on the up-grade side on the small riprap OR embedded filter cloth in the

5. Sediment shall be removed and trap restored to its original dimensions when the sediment has accumulated to 1/2 the design depth of the trap.

6. The structure shall be inspected after each rain and repairs made as needed. 7. Construction operations shall be carried out in such a manner than erosion and water

8. The structure shall be removed and the area stabilized when the drainage area has been properly stabilized.

Maximum Drainage Area: 5 Acres U.S. DEPARTMENT OF AGRICULTURE SOIL CONSERVATION SERVICE

COLLEGE PARK, MARYLAND

STONE OUTLET SEDIMENT TRAP

STANDARD DRAWING ST-V

FOR REV 4 ONLY

FOR REV 3 ONLY.

I CERTIFY THAT ALL DEVELOPMENT AND/OR CONSTRUCTION WILL BE DONE

ATTENDANCE AT A DEPT. OF NATURAL RESOURCES APPROVED PROGRAM FOR

THE CONTROL OF SEDIMENT AND EROSION BEFORE BEGINNING THE PROJECT.

ACCORDING TO THESE PLANS AND THAT ANY RESPONSIBLE PERSONNEL

INVOLVED IN THE CONSTRUCTION PROJECT WILL HAVE A CERTIFICATE OF

I ALSO AUTHORIZE PERIODIC ON-SITE INSPECTION BY THE HOWARD SOIL

CONSERVATION DISTRICT OR THEIR AUTHORIZED AGENTS AS ARE DEEMED


NECESSARY. DEVIATION FROM/THIS PLAN WILL NOT BE MADE UNLESS

AUTHORIZED BY THE HOWARD SOIL CONSERVATION DISTRICT.

DEVELOPER: JANUARY MEDICAL TO SOLUTION DISTRICT.

PROFESSIONAL CERTIFICATION

I HERBOY CERTOY THE THESE DOCUMENTS WELL AR SPINED BY MOPROVED BY ME. OND THIS I MAY A DULY UCENSED PROFESSIONAL ENSURE WASHING HAYS OF THE STATE OF THE PARTY OF

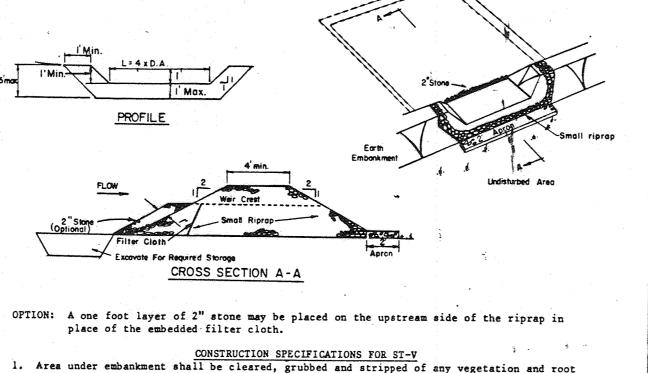

APPROVED: FOR PUBLIC WATER AND PUBLIC SEWERAGE STORM DRAINAGE SYSTEMS AND PUBLIC ROADS HOWARD COUNTY DEPARTMENT OF CHIEF BUREAU OF ENGINEERING

THIS PLAN IS APPROVED FOR SOIL EROSION AND

SEDIMENT CONTROL BY THE HOWARD SOIL CONSERVATION

REVIEWED FOR THE HOWARD SOIL CONSERVATION DISTRICT

AND MEETS TECHNICAL REQUIREMENTS.

UNITED STATES SOIL CONSERVATION SERVICE APPROVED: FOR PUBLIC WATER AND PUBLIC SEWERAGE SYSTEMS HOWARD COUNTY HEALTH DEPARTMENT.

COMMUNITY PLANNING & LAND DEVELOPMENT HOWATD COUNTY.

10-13-38

DIVISION of -

MARYLAND

DATE PPROVED HOWARD COUNTY OFFICE OF PLANNING & ZONING. & LAND DEVELOPMENT SEDIMENT & EROSION CONTROL DETAILS

PN. 6094 REVISIONS (3) 03/20/20A UPDATED OWNER WYD ADDED CUB, SHORM DRAFNS

DESIGNED: PRC

DRAWN: SHL/NK

CHECKED: PRC/TC


CHILLERS

I PROPOSED OFFICE/WAREHOUSE THE JUNCTION INDUSTRIAL PARK SECTION | AREA ! PARCEL 6-2 TAX MAP: 48 HOWARD CO. MID STALE: 1"=50

SLIEET 4 F9

PARCEL: 47

ELECT. DIST: (

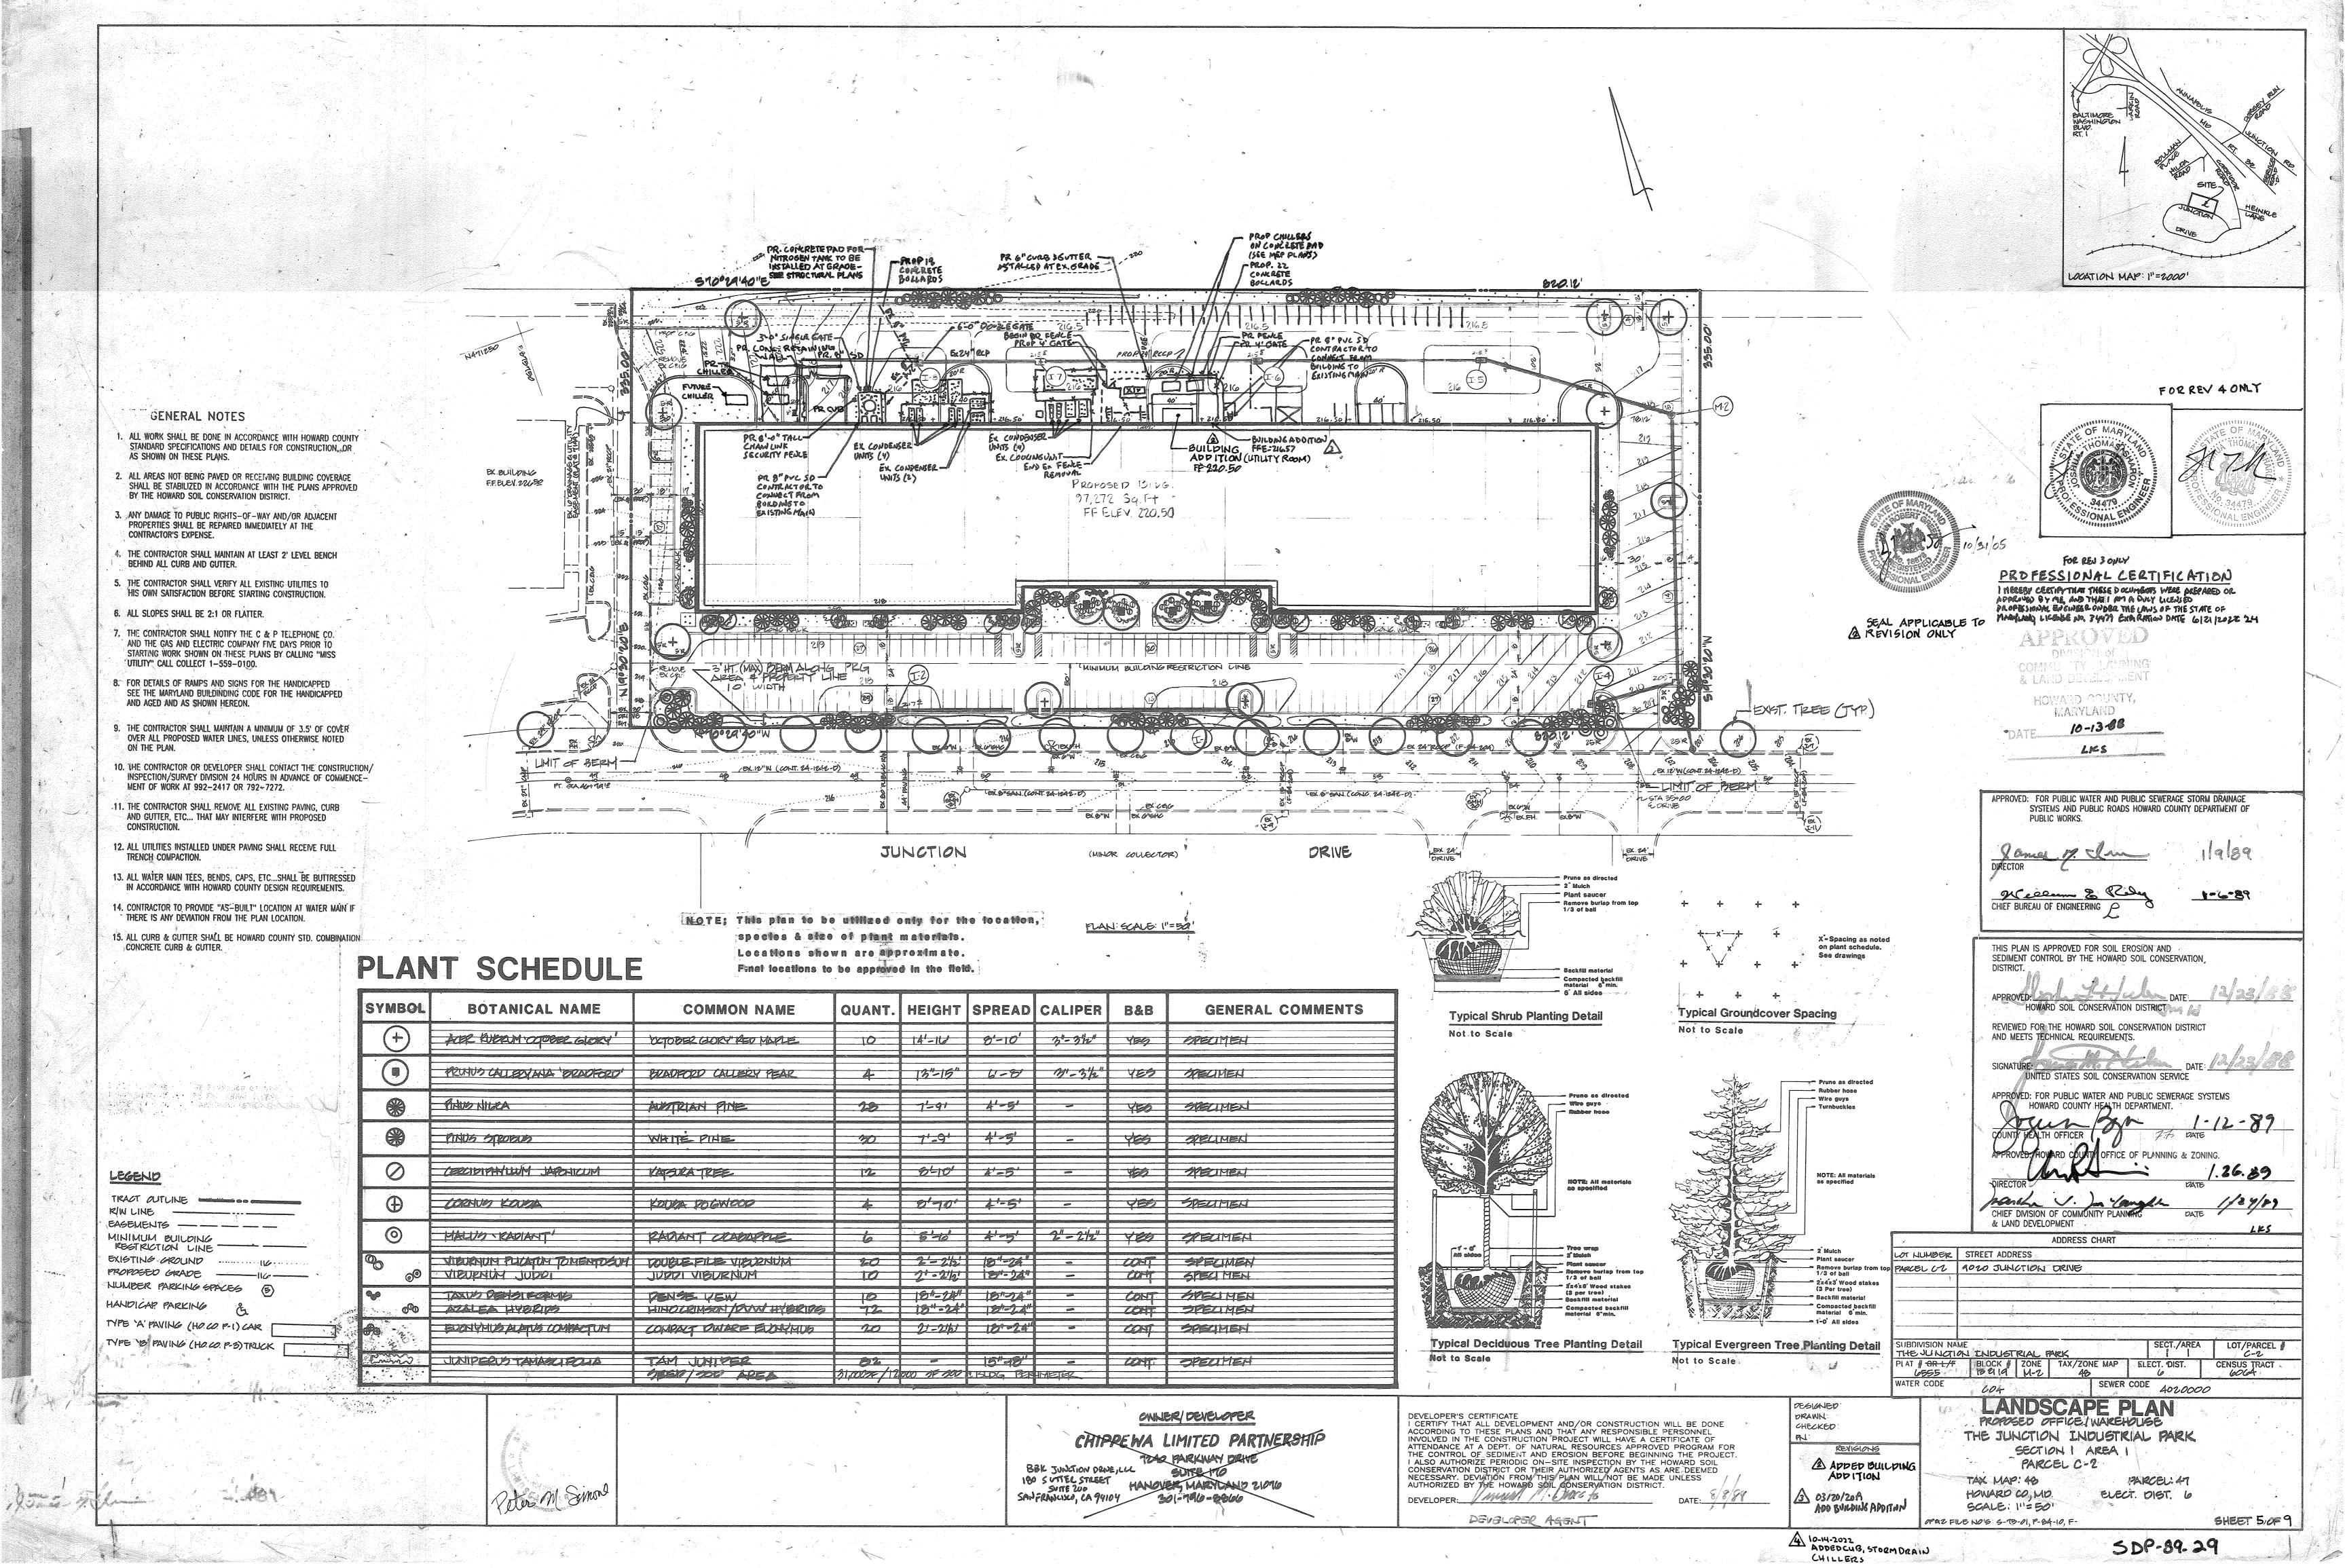

LEGEND

	EX. PROPERTY LINE
	EX. ADJACENT PROPERTY LINE
	EX. RIGHT OF WAY LINE
ess non com este com este sens tons tons tons and este force and com com com and este sens com tons este tons	EX. 1' CONTOUR
	EX. 2' CONTOUR
10	EX. 10' CONTOUR
	EX. BUILDING
D D	EX. CONCRETE
	EX. PAVEMENT STRIPING
=========	EX. CURB
	EX. STORM DRAIN
	EX. WATER
	EX. SANITARY LINE
UGE UGE	EX. UNDERGROUND ELECTRIC
UGT UGT	EX. UNDERGROUND TELE CABLE
G G	EX. GAS LINE
	EX. BOLLARDS
	PR. LIMIT OF DISTURBANCE
= x = x = x = x = x = x = x = x = x = x	EX. CURB (TBR)
	EX. PAVEMENT (TBR)
	EX. MILL AND OVERLAY

SOILS CLASSIFICAT	TION CH	ART/SIT	E AREA
MAP SYMBOL AND SOIL NAME	HYDROLOGIC GROUP	SLOPES	ACREAGE ON-SITE
UtD URBAN LAND-UDORTHENTS COMPLEX	D	<u>-</u>	0.09 AC.

UTILITY NOTE

PRIOR TO CONSTRUCTION, THE CONTRACTOR SHALL HAVE THIS PRIVATE UTILITY LOCATOR REMARK THE EXISTING UTILITIES WITHIN THE WORK AREA:

J.W. DELL COMPANY, INC. 591 HANOVER PIKE HAMPSTEAD, MD 21097


NOTES

(410) 833-5510

- . THE PROPERTY IS ZONED M-2.
 2. THE LOCATIONS OF FEATURES SHOWN ON THIS PLAN HAVE BEEN FIELD VERIFIED.
- WATER SERVICE: PUBLIC 4. SEWER SERVICE: PUBLIC
- 5. THERE ARE NO NATURAL STEEP SLOPES (25%+) ON SITE WHICH MEET THE COUNTY DEFINITION OF STEEP SLOPES.
- 6. THERE ARE NO WETLANDS AND STREAMS LOCATED ON SITE.
 7. THERE ARE NO 100 YEAR FLOODPLAINS ON SITE. THE SITE LIES WITHIN ZONE X OF THE FEMA FLOOD INSURANCE MAP 24027C017OD. DATED NOVEMBER 6, 2013 FOR HOWARD
- 8. THE SITE IS NOT LOCATED IN THE CRITICAL AREA OR BOG.
 9. THERE ARE NO ARCHAEOLOGICAL RESOURCES, CEMETARIES, ETC. ON SITE.

NOTE

THE CORRECTNESS OR COMPLETENESS OF EXISTING INFORMATION SHOWN ON THE DRAWINGS IS NOT WARRANTED OR GUARANTEED. THE CONTRACTOR SHALL VERIFY THE LOCATION OF UTILITIES AND UNDERGROUND FACILITIES, BY TEST PITS OR OTHER METHODS APPROVED BY THE OWNER'S REPRESENTATIVE, AS REQUIRED TO VERIFY EXACT LOCATIONS AND DEPTHS WITHIN THE LIMIT OF DISTURBANCE. ALL DISCREPANCIES BETWEEN INFORMATION SHOWN ON THE DRAWINGS AND THAT WERE VERIFIED IN THE FIELD SHALL BE REPORTED TO THE OWNER'S REPRESENTATIVE PRIOR TO BEGINNING WORK.

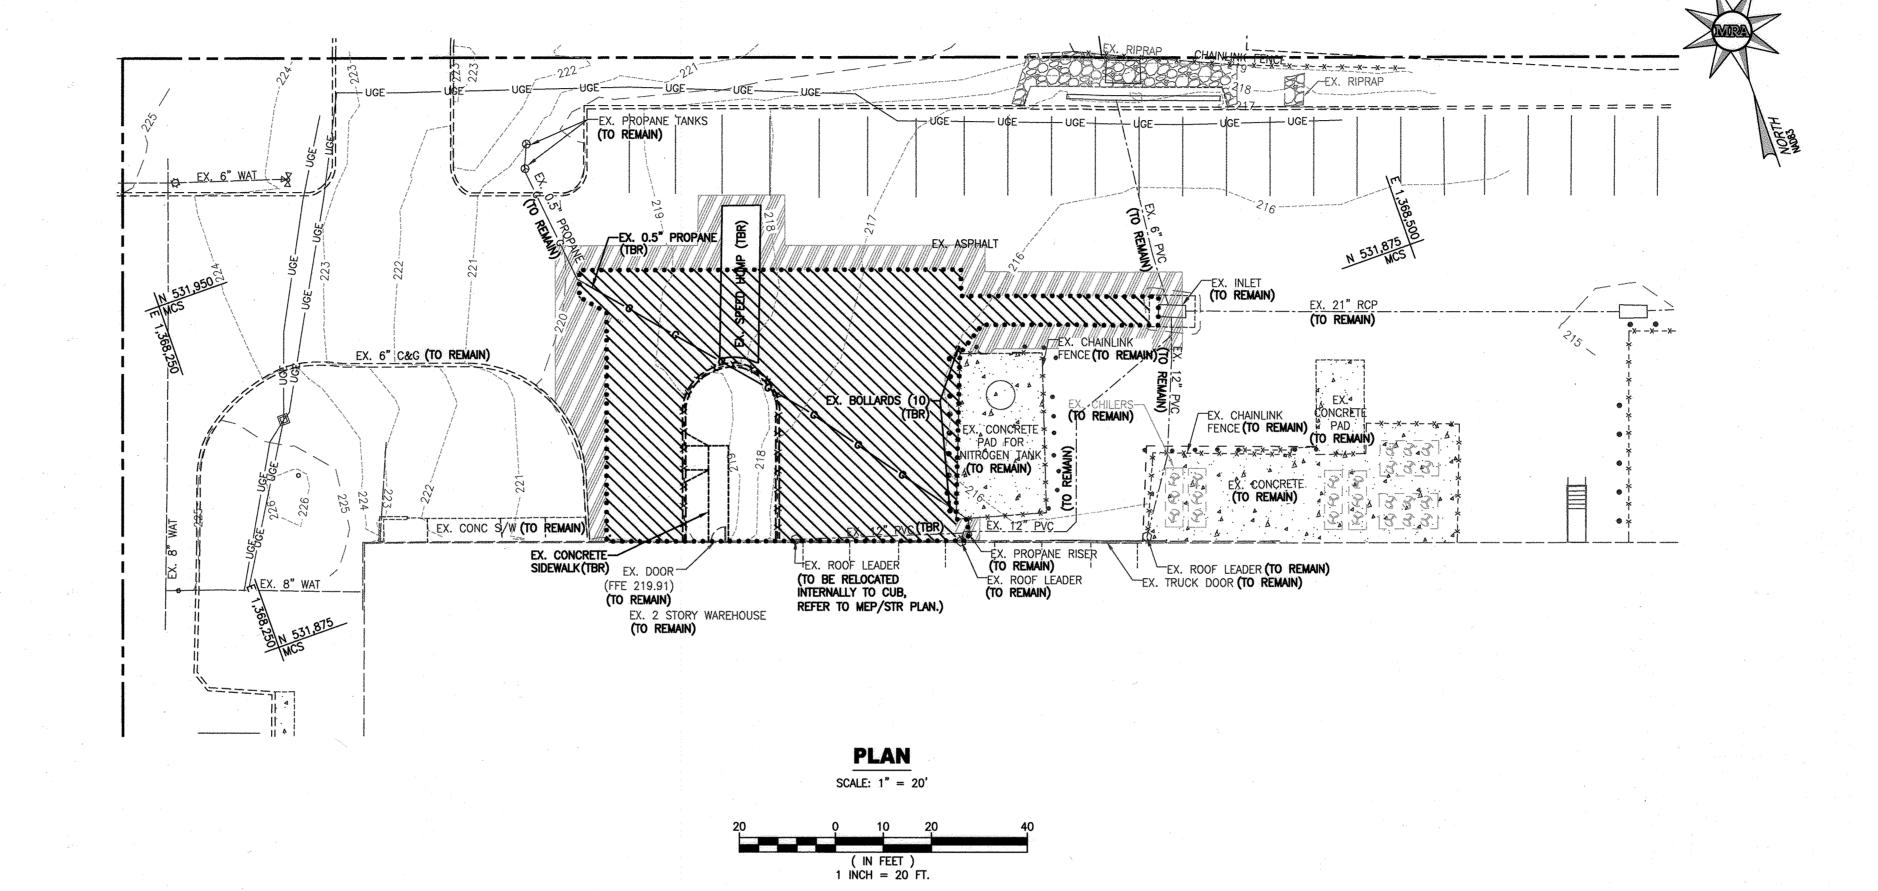

APPROVED: FOR PUBLIC WATER AND PUBLIC SEWERAGE STORM DRAINAGE SYSTEMS AND PUBLIC ROADS HOWARD COUNTY DEPARTMENT OF PUBLIC WORKS CHIEF BUREAU OF ENGINEERING THIS DEVELOPMENT PLAN IS APPROVED FOR SOIL EROSION AND SEDIMENT CONTROL BY THE HOWARD SOIL CONSERVATION DISTRICT APPROVED: FOR PUBLIC WATER AND PUBLIC SEWERAGE SYSTEMS / COUNTY HEALTH OFFICER
HOWARD COUNTY HEALTH DEPARTMENT % DATE / APPROVED: DEPARTMENT OF PLANNING & ZONING CHIEF, DEVELOPMENT ENGINEERING DIVISION 3.13.23 DATE CHIEF, DIVISION OF LAND DEVELOPMENT

		ADDRE	SS CHART		
LOT/PARCEL#			STREET	ADDRESS	
PARCEL C-2	9020 JING	TION DRIVE		¥	
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SUBDIVISION NA	and the best block to the second	<u>liinide eesti tilki ja se tarasid</u> Sasaan	INFORMATION (CHART SECT./AI	REA LOT/PARCEL
	and the best block to the second	ARK	TINFORMATION (TAX MAP NO. 48	manuscript of the street of th	



Civil & Structural 1220-B East Joppa Road 410-821-1690



ENGINEER'S CERTIFICATE I CERTIFY THAT THIS PLAN FOR SEDIMENT AND EROSION CONTROL REPRESENTS A PRACTICAL AND WORKABLE PLAN BASED ON MY PERSONAL KNOWLEDGE OF THE SITE CONDITIONS AND THAT IT WAS PREPARED IN ACCORDANCE WITH THE REQUIREMENTS OF THE HOWARD SOIL CONSERVATION DISTRICT

12-9-2022

SIGNATURE OF ENGINEER (PRINT NAME BELOW SIGNATURE)

BBK JUNCTION DRIVE, LLC 180 SUTTER STREET SUITE 200 SAN FRANCISCO, CA 94104

OWNER/DEVELOPER

DEVELOPER'S CERTIFICATE "I/WE CERTIFY THAT ALL DEVELOPMENT AND CONSTRUCTION WILL BE DONE ACCORDING TO THIS PLAN FOR SEDIMENT AND EROSION CONTROL, AND THAT ALL RESPONSIBLE PERSONNEL INVOLVED IN THE CONSTRUCTION PROJECT WILL HAVE A CERTIFICATE OF ATTENDANCE AT A DEPARTMENT OF THE ENVIRONMENT APPROVED TRAINING PROGRAM FOR THE CONTROL OF SEDIMENT AND EROSION BEFORE BEGINNING THE PROJECT. I ALSO AUTHORIZE PERIODIC ON-SITE INSPECTION BY THE HOWARD SOIL CONSERVATION DISTRICT."

SIGNATURE OF DEVELOPER (PRINT NAME BELOW SIGNATURE)

DESIGN BY: THS REVIEW BY: THS REVISIONS /4\10/14/2022 ADDED CUB, STORM DRAIN, CHILLERS

DRAWN BY: APJ/DLG

EXISTING CONDITIONS AND DEMOLITION PLAN PROPOSED OFFICE/WAREHOUSE THE JUNCTION INDUSTRIAL PARK **SECTION1 AREA 1** PARCEL C-2 TAX MAP: 48

HOWARD COUNTY, MD SCALE: AS SHOWN

PARCEL: 47

ELECT. DIST. 6

SHEET 6 OF 9

