GENERAL NOTES

- 1. EXISTING CONDITIONS ARE BASED ON SURVEY DATED JUNE 1986, AND PREPARED BY ASSOCIATED ENGINEERS, INC. BENCHMARK USED: 1ST FLOOR AT MAIN ENTRANCE TO SCHOOL. ELEV. 482.00.
- 2. ALL DISTURBED UNPAVED AREA SHALL BE TOPSOILED, FERTILIZED, LIMBO AND SEEDED. TOPSOIL DEPTH SHALL BE MINIMUM 4 INCHES COMPACTED.
- 3. ALL SEDIMENT AND EROSION CONTROL FEATURES SHALL BE INSTALLED IN ACCORDANCE WITH THE "STANDARDS AND SPECIFICATIONS FOR SOIL EROSION AND SEDIMENT CONTROL IN DEVELOPED AREAS," 1983 EDITION.
- 4. ALL CONSTRUCTION AND MATERIALS SHALL BE IN ACCORDANCE WITH THE HOWARD COUNTY ROAD CONSTRUCTION CODE AND SPECIFICATIONS AND THE APPLICABLE PROVISIONS OF THE MARYLAND STATE HIGHWAYS ADMINISTRATION STANDARDS AND SPECIFICATIONS FOR MATERIALS, HIGHWAYS, BRIDGES AND INCIDENTAL STRUCTURES.
- 5. A PREFIX OF 4 MAY HAVE TO BE ADDED TO ALL GRADES.
- 6. ALL UNSUITABLE AND EXCESS FILL MATERIAL SHALL BE DISPOSED OF OFF SITE. LOCATION OF DISPOSAL AREA SHALL BE THE CONTRACTOR'S RESPONSIBILITY.
- 7. CONTRACTOR SHALL PROVIDE ALL SUITABLE FILL MATERIAL. LOCATION OF BORROW SHALL BE THE CONTRACTOR'S RESPONSIBILITY.
- 8. CONTACT "MISS UTILITY" AT LEAST 48 HOURS PRIOR TO COMMENCING EXCAVATIONS (TELEPHONE 1-800-257-7777).
- 9. EXISTING UTILITIES ARE BASED ON AVAIALBLE RECORDS AND WERE FIELD-CHECKED WHERE POSSIBLE. CONTRACTOR MUST DIG TEST PITS BY HAND AT UTILITY CROSSINGS AND CONNECTION POINTS TO VERIFY EXACT LOCATION AND INVERTS WELL IN ADVANCE OF CONSTRUCTION. IF CONNECTIONS ARE NOT AS SHOWN OR IF CONFLICT IS ANTICIPATED, ENGINEER SHALL BE NOTIFIED BEFORE PROCEEDING WITH TRENCHING.
- 10. CONTRACTOR SHALL CLEAN UP THE WORK AREA AT THE COMPLETION OF THE PROJECT. ALL AREAS DISTURBED DURING THE CONSTRUCTION ACTIVITY SHALL BE REPAIRED TO THE SATISFACTION OF THE OWNER'S REPRESENTATIVE.
- 11. THE CONTRACTOR SHALL CONTACT THE CONSTRUCTION INSPECTION DIVISION 24 HOURS IN ADVANCE OF START OF WORK AT TELEPHONE 792-2630.
- 12. CONCRETE CURB SHALL BE STANDARD 7" COMBINATION CURB AND GUTTER, HOWARD COUNTY DPW STD. R-3.01. PITCH GUTTER AWAY FROM CURB TO CONFORM TO ADJACENT DRAINAGE PATTERN.
- 13. PAVING FOR PARKING AND DRIVE AREAS SHALL CONSIST OF 1 1/2" BITUMINOUS CONCRETE SURFACE COURSE (BAND SN) 2" BITUMINOUS CONCRETE BASE COURSE (BAND SN, BF OR BI)
 - 6" CRUSHED STONE BASE (M.S.H.A. DGA SPEC) FIRM SUBGRADE COMPACTED TO A MINIMUM 95% OF THE AASHTO T-180 MAXIMUM DRY DENSITY.
 - CONSTRUCTION SEQUENCE
 - 1. INSTALL STABILIZED CONSTRUCTION ENTRANCE.
 - 2. INSTALL INLET PROTECTION AT 1-1
 - 3. STRIP TOPSOIL AND CONSTRUCT PERIMETER/DIKE SWALE
 - 4. INSTALL STONE OUTLET SEDIMENT TRAP
 - 5. CARRY OUT INITIAL TRENCH EXCAVATION FOR INFILTRATION TRENCH. (REFER O DIMENSIONS AND CONSTRUCTION SEQUENCE FOR TEMPORARY INFILTRATION
 - 6. INSTALL TEMPORARY 15" CMP TO DIVERT OUTFALL FROM EX. 1-1 TO TEMPORARY

 - 7. RELOCATE EXISTING LIGHTS AND ADJUST LOCATION OF EXISTING UTILITIES. 8. REMOVE OR RELOCATE EXISTING TREES
 - 9. ROUGH GRADE.
 - 10. CONSTRUCT STORM DRAIN STRUCTURES AND CONNECTING PIPES FROM 8-1 TO I-4 AND I-3. INSTALL OUTLET PROTECTION AT 8-1.
 - 11. INSTALL INLET PROTECTION AT CURB INLET 1-4 AND 1-3
 - 12. COMPLETE EXCAVATION FOR PERMANENT INFILTRATION TRENCE AND BUILT INLET 1-6 AND 1-7 AND COMMECTING CHARGING PIPE. (FOR DIMENSIONS REFER TO PERMANENT INFILTRATION TRENCE TABLE.) CONSTRUCT CONNECTING PIPE FROM 1-6 TO 1-1 AND DISCONNECT TEMPORARY C
 - 33. COMPLETE CONSTRUCTION OF INFILTRATION TRENCH GRADE AREA ABOVE TRENCH AS SHOWN ON PLAN (BERM, HIGHPOINT BETWEEN INLETS AND OVERFLOW SPILL-
 - 14. INSTALL SILT FENCE AT TOE OF SLOPE ABOVE INFILTRATION TRENCE AND YARD INLET PROTECTION AT 1-6 AND 1-7.

20. STABILIZE REMAINING DISTURBED AREAS AND REMOVE REMAINING SEDIMENT

- 15. FINE GRADE FOR INSTALLATION OF BASE COURSE AND CURB AND GUTTES
- 16. CONSTRUCT CURB AND GUTTER AND BASE COURSE. 17. FINE GRADE ALL DISTURBED UNPAVED AREAS TO BE STABILIZED

At. DATE

4.3.87

APPROVED: FOR PUBLIC WATER AND PUBLIC SEWERAGE BYSTEMS.

HOWARD COUNTY HEALTH DEPARTMENT

APPROVED: HOWARD COUNTY OFFICE OF PLANNING & ZONING

STORM DRAINAGE SYSTEMS AND PUBLIC ROADS

HOWARD COUNTY DEPARTMENT OF PUBLIC WORKS

DIMA CITEDIMA

APPROVED: FOR PUBLIC WATER AND PUBLIC SEWERAGE

COUNTY HEALTH OFFICER

CHIEF DIVISION OF LAND DEVELOPMENT

Made & Caly

CHIEF BUREAU OF ENGINEERING

MOITARTZINIADA DALNOT ONA

- 19. REMOVE SEDIMENT TRAP
- 21. CLEAN UP SITE AND BEGIN MAINTENANCE

DIVISION OF LAND DEVELOPMENT

DATE 4-2-87

SEDIMENT CONTROL NOTES:

- 1. A MINIMUM OF 24 HOURS NOTICE MUST BE GIVEN TO THE HOWARD COUNTY OFFICE OF INSPECTION AND PERMITS PRIOR TO THE START OF ANY CONSTRUCTION (922-2437).
- 2. ALL VEGEGATATIVE AND STRUCTURAL PRACTICES ARE TO BE INSTALLED ACCORDING TO THE PROVISIONS OF THIS PLAN AND ARE TO BE IN CONFORMANCE WITH THE 1983 "MARYLAND STANDARDS AND SPECIFICATIONS FOR SOIL EROSION AND SEDIMENT CONTROL."
- 3. FOLLOWING INITIAL SOIL DISTURBANCE OR REDISTURBANCE, PERMANENT OR TEMPORARY STABILIZATION SHALL BE COMPLETED WITHIN: A) 7 CALENDAR DAYS FOR ALL PERIMETER SEDIMENT CONTROL STRUCTURES, DIKES, PERIMETER SLOPES AND ALL SLOPES GREATER THAN 3:1; B) 14 DAYS AS TO ALL OTHER DISTURBED OR GRADED AREAS ON THE PROJECT SITE.
- 4. ALL SEDIMENT TRAPS/BASINS SHOWN MUST BE FENCED AND WARNING SIGNS POSTED AROUND THEIR PERIMETER IN ACCORDANCE WITH VQL. 1, CHAPTER 12 OF THE HOWARD COUNTY DESIGN MANUAL, "STORM DRAINAGE."
- 5. ALL DISTURBED AREAS MUST BE STABILIZED WITHIN THE TIME PERIOD SPECIFIED ABOVE IN ACCORDANCE WITH THE 1983 "MARYLAND STANDARDS AND SPECIFICATIONS FOR SOIL EROSION AND SEDIMENT CONTROL" FOR PERMANENT SEEDINGS (SEC. 51) SOD (SEC. 54), TEMPORARY SEEDING (SEC. 50) AND MULCHING (SEC. 52), AND AS SPECIFIED HEREIN.
 - A. TOPSOIL SHALL MEET ALL APPLICABLE REQUIREMENTS OF THE SPECIFICATIONS FOR MATERIALS, HIGHWAYS, BRIDGES AND INCIDENTAL STRUCTURES OF THE MARYLAND STATE HIGHWAY ADMINISTRATION. TOPSOIL SHALL BE 4 INCHES THICK (COMPACTED).
 - B. LIME SHALL BE SPREAD AT A RATE OF ONE (1) TON PER ACRE.
 - C. FERTILIZER 5-10-10 OR EQUIVALENT SHALL BE APPLIED AT A RATE OF 1700 LBS. PER ACRE. BOTH LIME AND FERTILIZER SHALL BE UNIFORMLY APPLIED TO THE LOOSENED TOPSOIL AND SHALL BE RAKED SMOOTH PRIOR TO SEEDING.
 - D. SEED SHALL BE "KENTUCKY 31" TALL FESCUE APPLIED AT A RATE OF 2 LBS. PER 1,000 SQ. FT. STRAW MULCH SHALL BE UNIFORMLY APPLIED AT THE RATE OF 70 TO 90 LBS. PER 1,000 FT.
 - E. SOD SHALL BE A CLASS OF TURF GRASS SOD AND SHALL BE MARYLAND STATE CERTIFIED.

TEMPORARY STABILIZATION WITH MULCH ALONE CAN ONLY BE DONE WHEN RECOMMENDED SEEDING DATES DO NOT ALLOW FOR PROPER GERMINATION AND ESTABLISHMENT OF GRASSES.

ALL SEDIMENT CONTROL STRUCTURES ARE TO REMAIN IN PLACE AND ARE TO BE MAINTAINED IN OPERATIVE CONDITION UNTIL PERMISSION FOR THEIR REMOVAL HAS BEEN OBTAINED FROM THE HOWARD COUNTY SEDIMENT CONTROL INSPECTOR.

SITE ANALYSIS:

TOTAL AREA OF SITE: 40.055 AC. AREA DISTURBED: 1.380 AC. AREA TO BE PAVED AND ADDED: THIS CONTRACT = 0.42 AC. AREA TO BE PAVED AND ADDED: FUTURE = 0.32 AC TOTAL IMPERVIOUS AREA: 0.74 AC. AREA TO BE VEGETATIVELY STABILIZED: 0.64 AC TOTAL CUT: 610 CU. YD. (EXCLUDING EXCAVATION FOR INFILTRATION TRENCH) TOTAL FILL: 2,151 CU. YD. OFF-SITE WASTE AREA LOCATION: TO BE SUBMITTED OFF-SITE BORROW AREA LOCATION: TO BE SUBMITTED CONTRACTOR WILL BE REQUIRED TO PROVIDE THE ABOVE INFORMATION PRIOR TO ISSUANCE OF THE PERMIT AND SUBMIT A SEDIMENT CONTROL PLAN

8. ANY SEDIMENT CONTROL PRACTICE WHICH IS DISTURBED BY GRADING ACTIVITY FOR PLACEMENT OF UTILITIES MUST BE REPAIRED ON THE SAME DAY OF

ACCEPTABLE TO THE SOIL CONSERVATION DISTRICT.

9. ADDITIONAL SEDIMENT CONTROLS MUST BE PROVIDED. IF DEEMED NECESSARY BY THE HOWARD COUNTY DPW SEDIMENT CONTROL INSPECTOR.

10. THE INFILTRATION TRENCH SHALL BE CONSTRUCTED IN ACCORDANCE WITH THE 1984 "STANDARDS AND SPECIFICATIONS FOR INFILTRATION PRACTICES" OF THE MARYLAND DEPARTMENT OF NATURAL RESOURCES. WATER RESOURCES ADMINISTRATION, STORMWATER MANAGEMENT DIVISION.

LIST OF DRAWINGS


- SP-1 NOTES AND DRAINAGE DIVIDES
- SP-2 SITE PLAN
- SP-3 SEDIMENT CONTROL PLAN
- SP-4 PROFILES AND DETAILS
- SP-5 DETAILS

DIMENSIONS AND CONSTRUCTION SEQUENCE

- CARRY OUT INITIAL TRENCH EXCAVATION FRIOR TO ROUGH GRADING PHASE TO ALLOW TRENCH TO ACT AS A TEMPORARY STORMWATER
- 2. THE DIMENSIONS AND ELEVATIONS OF TRENCH IN INITIAL FORM SHALL BE AS FOLLOWS:


BOTTOM OF TRENCE & ELEVATION

- EXCAVATE TEMPORARY TRENCH ON CENTER LINE OF PROPOSED LOCATION OF PERMANENT INFILTRATION TRENCH.
- 3. AFTER COMPLETION OF CONSTRUCTION SEQUENCE NO. 11 (SEE GENERAL STRUCTION SEQUENCE THIS SHEET), REMOVE ACCUMULATED SEDIMENT 13
- 4. EXCAVATE TRENCH TO FINAL DIMENSIONS AND ELEVATIONS (PEFER TO PERWANENT TRENCH TABLE), LINE TRENCE WITE FILLER FABRIC AND FILL
- 5. INSTALL INLETS I-6 AND I-7 IN TRENCH A AND CHARGING PIPE. 6. COMPLETE INFILTRATION TRENCH CONSTRUCTION AND PROVIDE SOIL COVER
- SPREAD TOPSOIL AND STABILIZE.

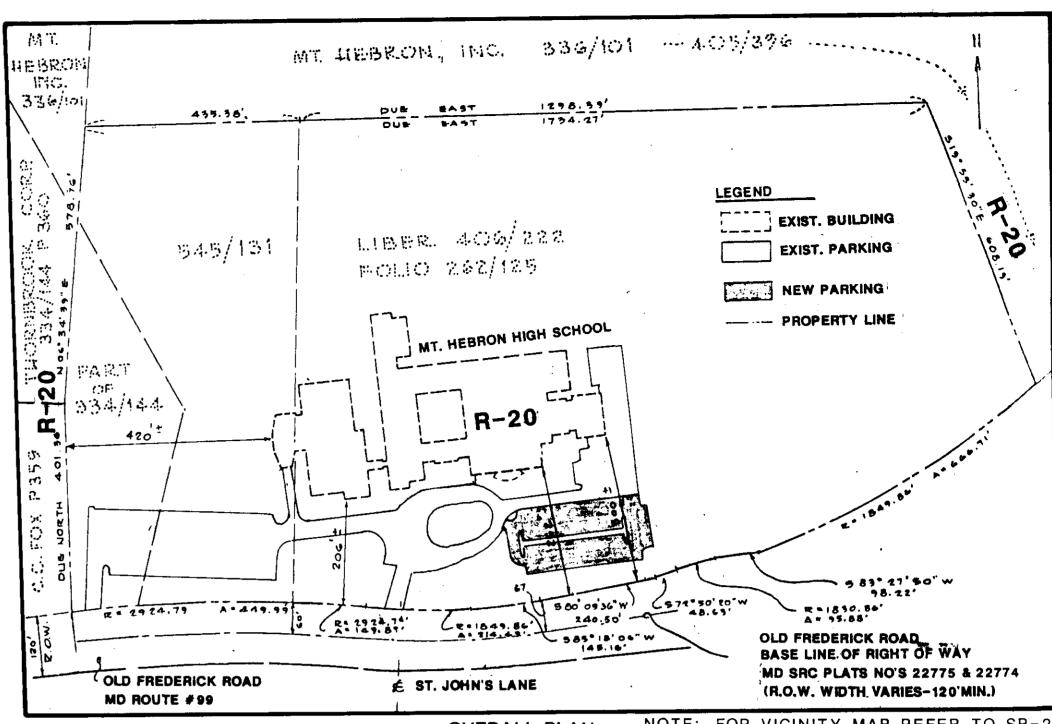

NOTE: FOR VICINITY MAP REFER TO SP-2 OVERALL PLAN SCALE : 1"=200"

TOTAL AREA OF SITE = 40.06 AC

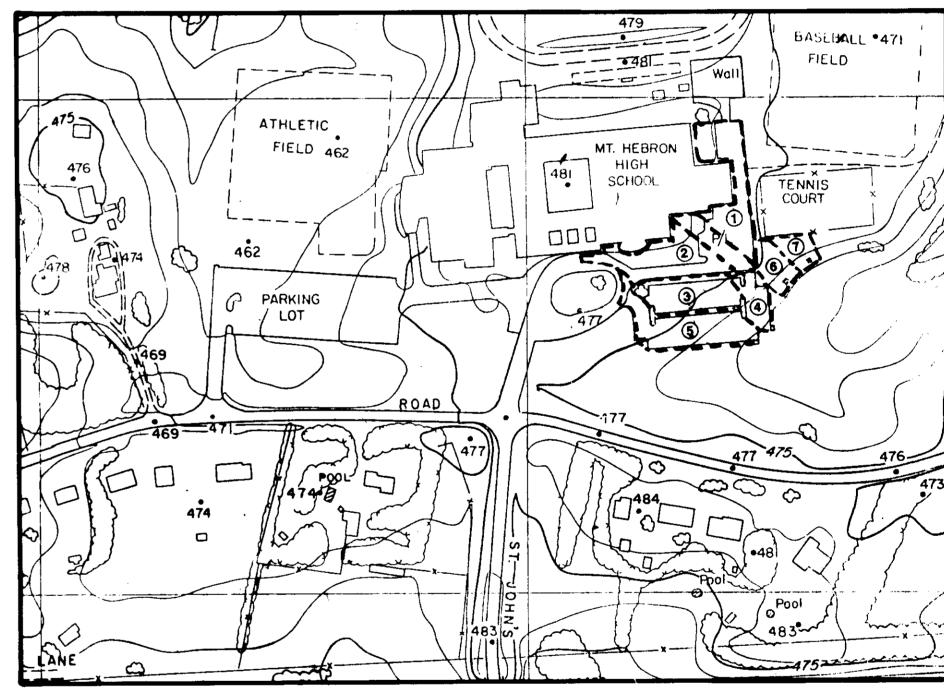

DRAINAGE DIVIDES SCALE : 1" = 200"

DRAINAGE AREAS COMP. RUNOFF PAV'T. TRIBUTARY TRIBUTARY COEFFICIENT (AC) (AC) AREA (AC) TO STRUCTURE 0.95 0.490.49 I-10.650.200.40 0.20I-20.88 0.05 0.290.34 1-3 0.90 0.03 0.210.24 I-40.39 0.87 0.45I-50.35 0.09 ___ I-6 0.35 0.07 0.07___ I-7

SPD87-167 ADDRESS CHART STREET ADDRESS OT NUMBER 4.71 9440 Route 99 ELLICOTT CITY, MARYLAND

471 MT HEBRON HIGH SCHOOL PLAT OR L/F BLOCK | ZONE TAX/ZONE MAP ELEC. DIST CENSUS TR.
SEE LIST 15.16 R-20 17 2 6021 SEWER CODE 1406900

SHEET NO

1 OF 5

SP-1


PARKING ADDITION TO SDP-78-27 PROJECT NAME ADDITIONAL PARKING FOR 103 CARS MOUNT HEBRON HIGH SCHOOL **ELECTION DISTRICT NO. 2** MARYLAND HOWARD COUNTY.


NOTES AND DRAINAGE DIVIDES


ASSOCIATED ENGINEERS, INC. 8555 SIXTEENTH STREET SILVER SPRING, MARYLAND 20910 TEL. 301-589-7311 SCALE AS SHOWN DATE 2/27/1987


SDP-87-167


REVISED 3/30/1987

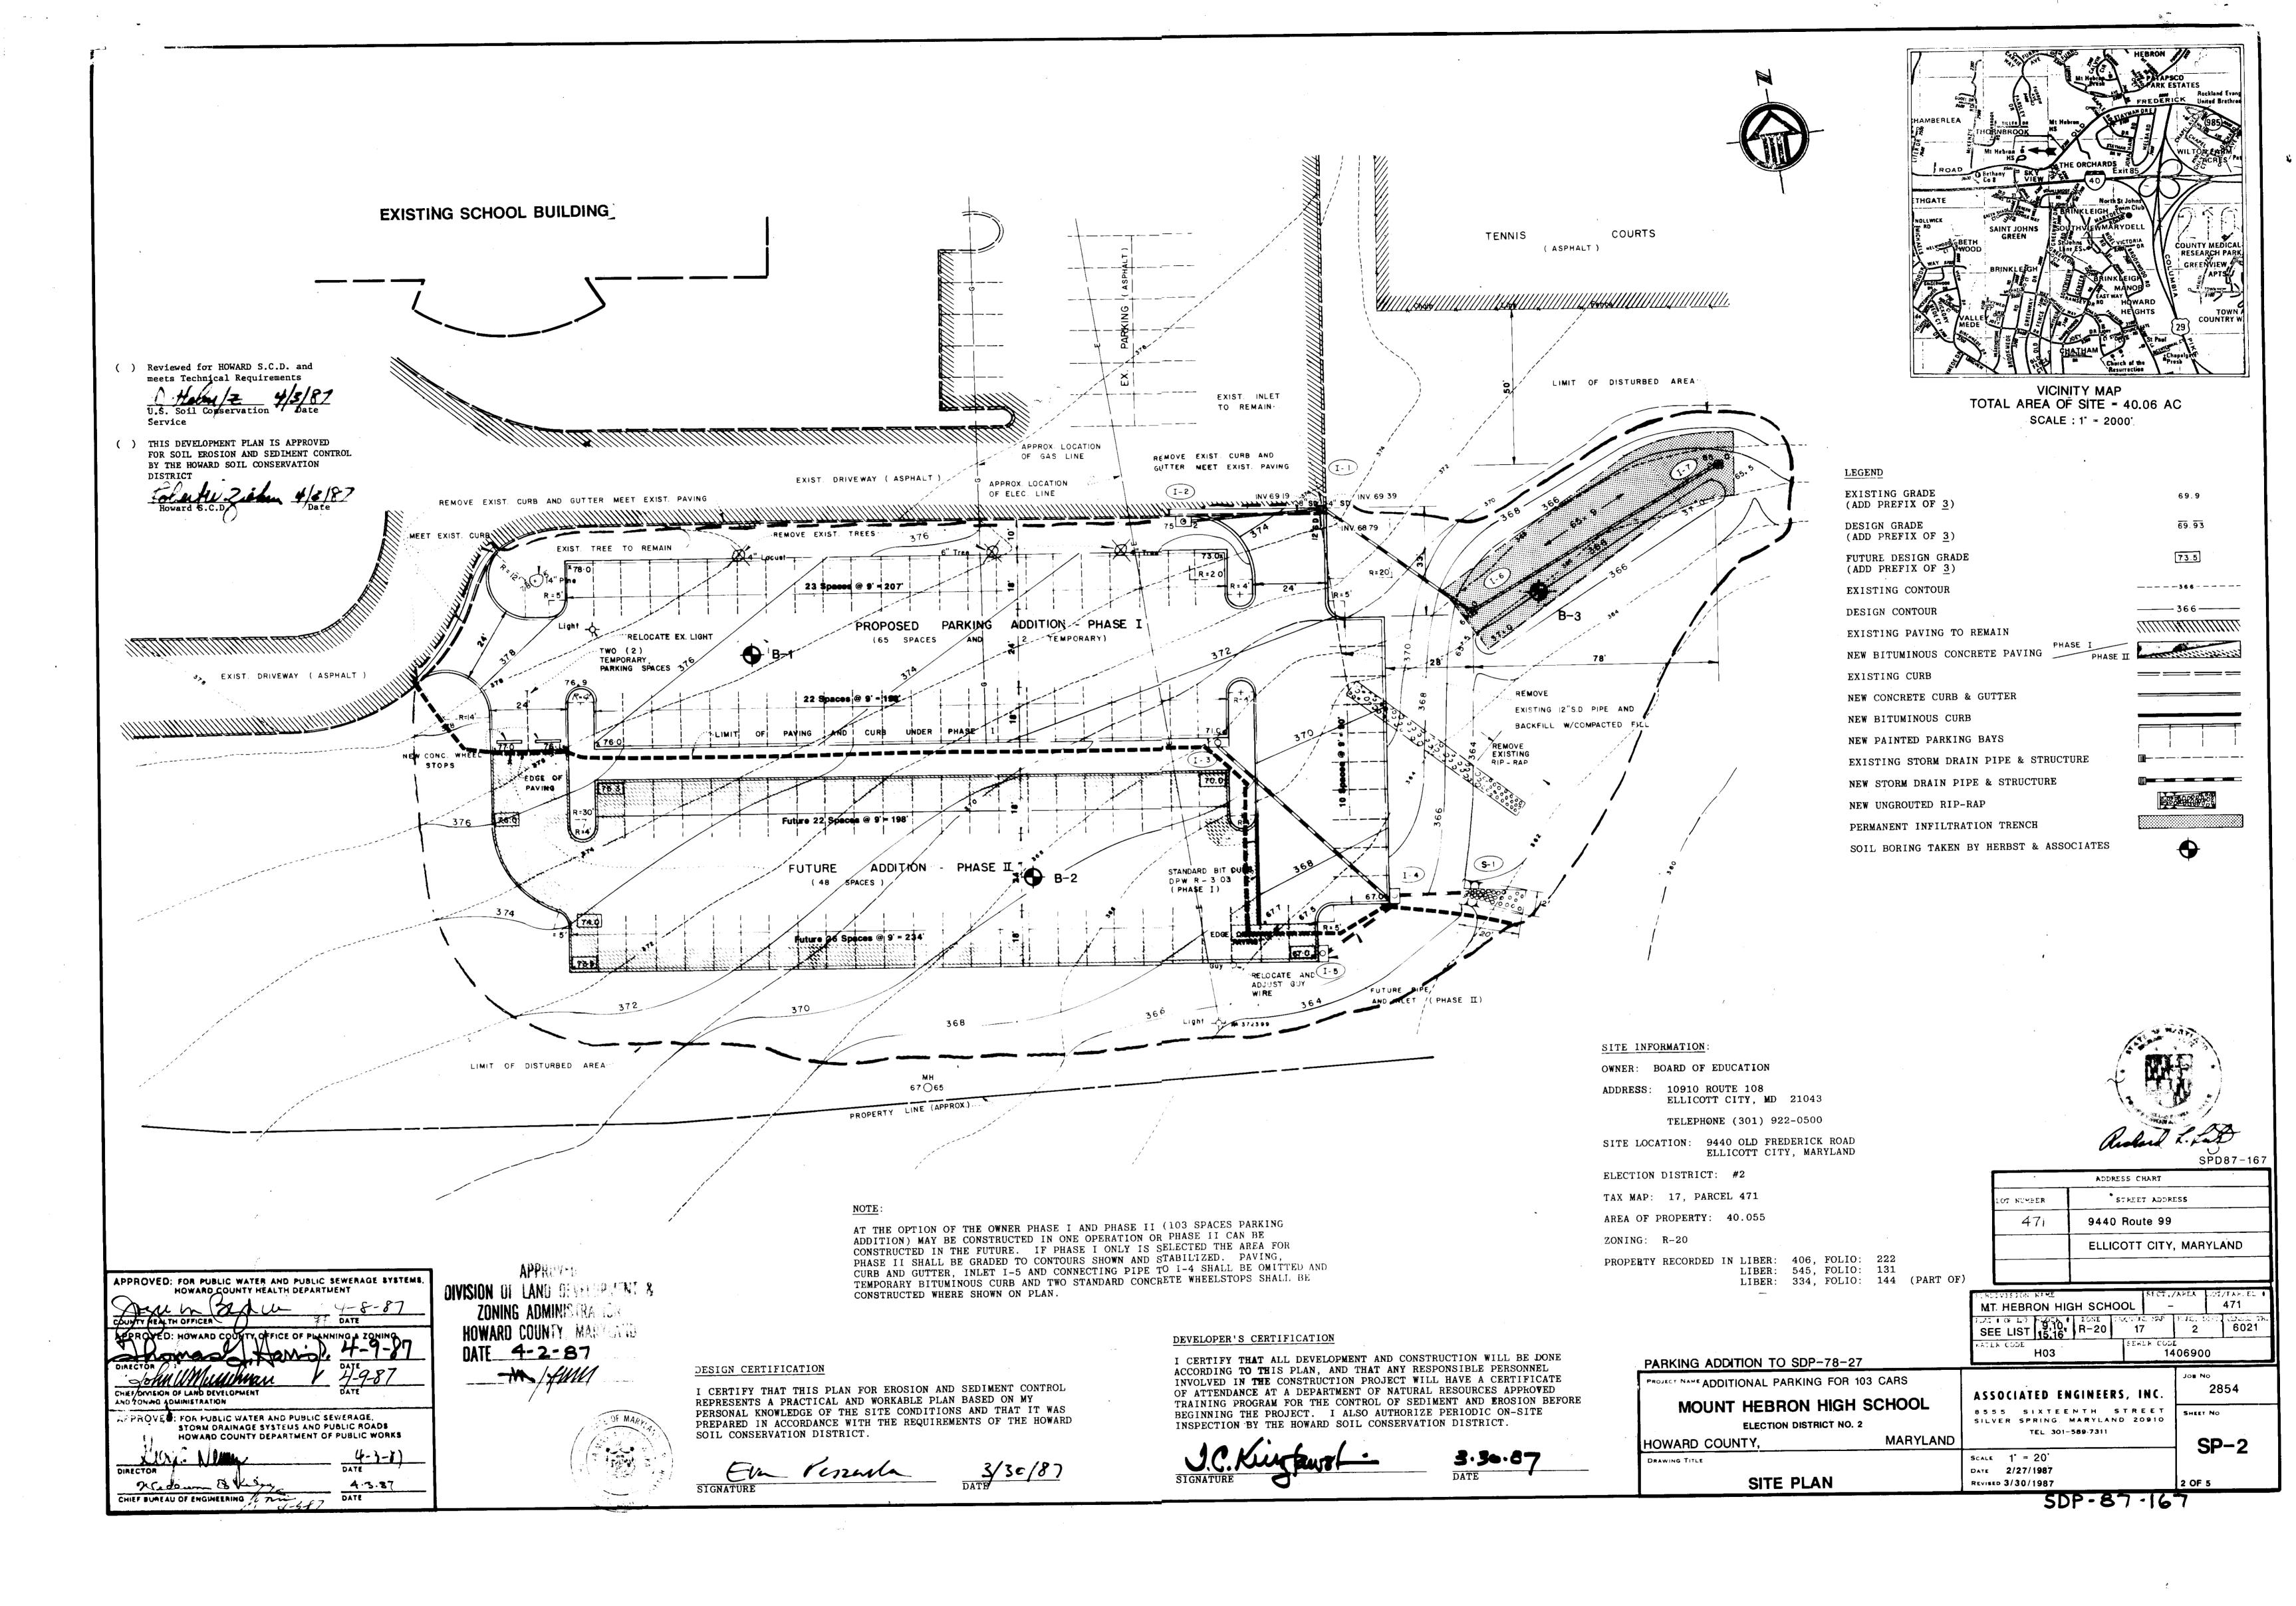


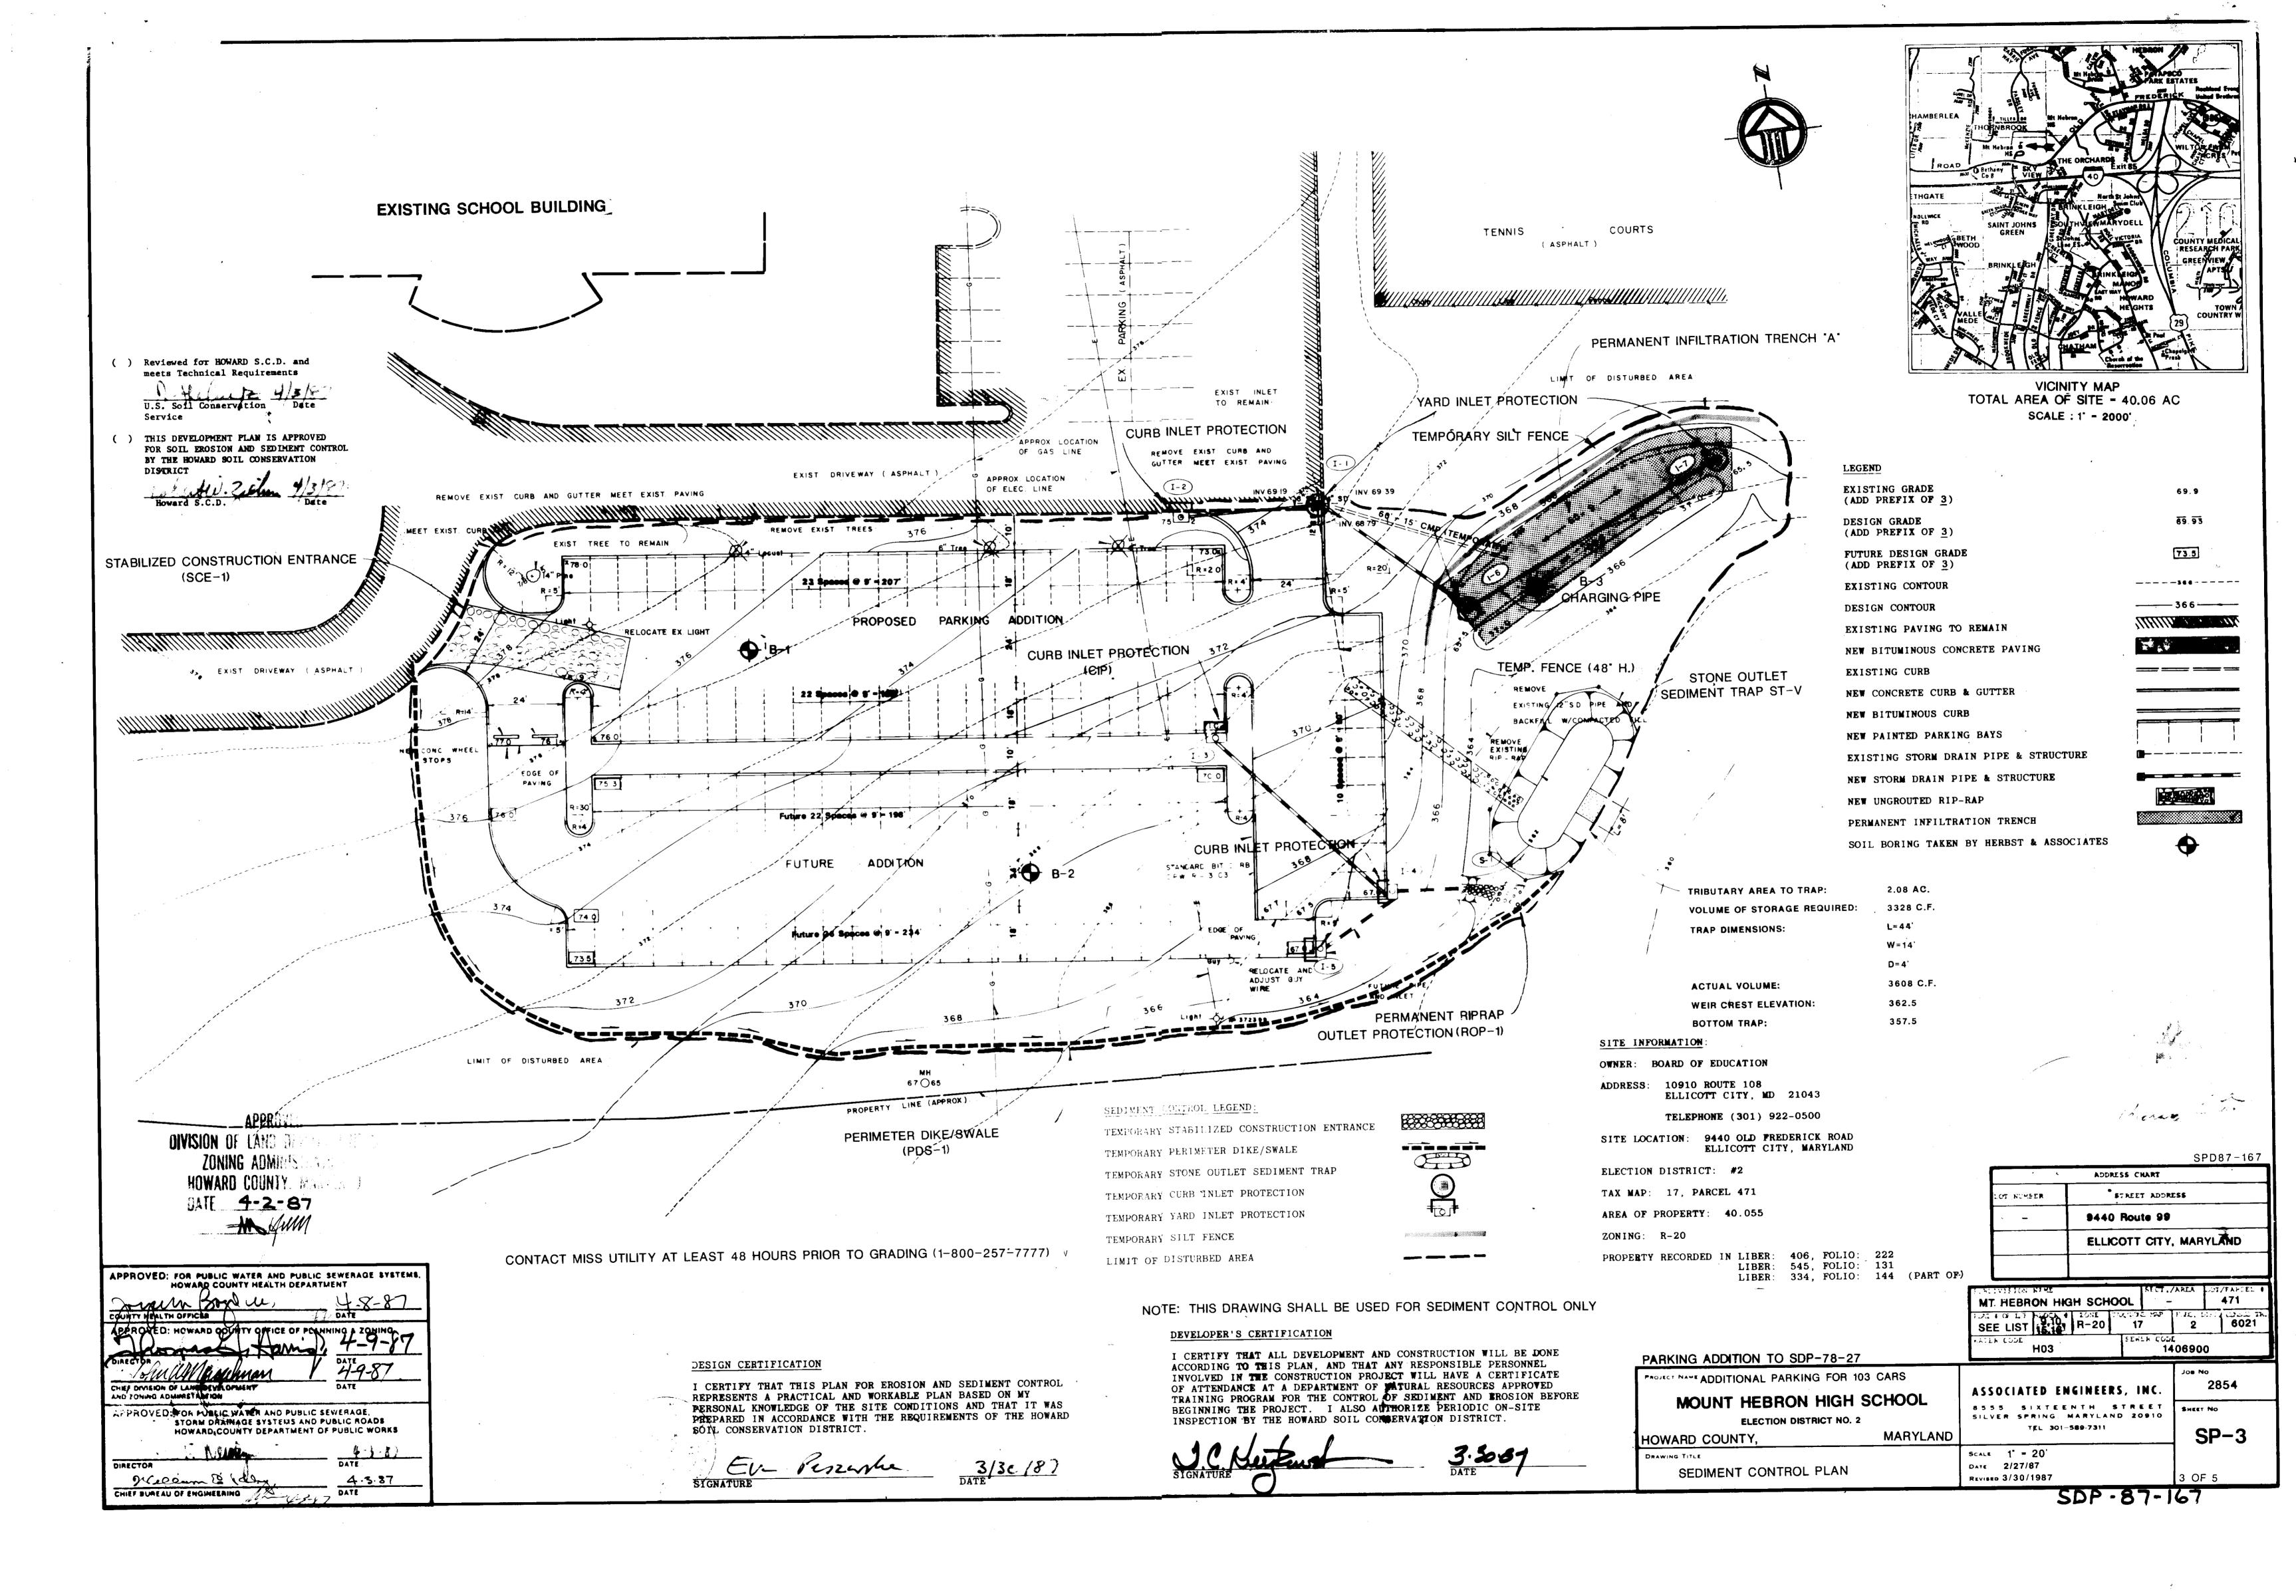

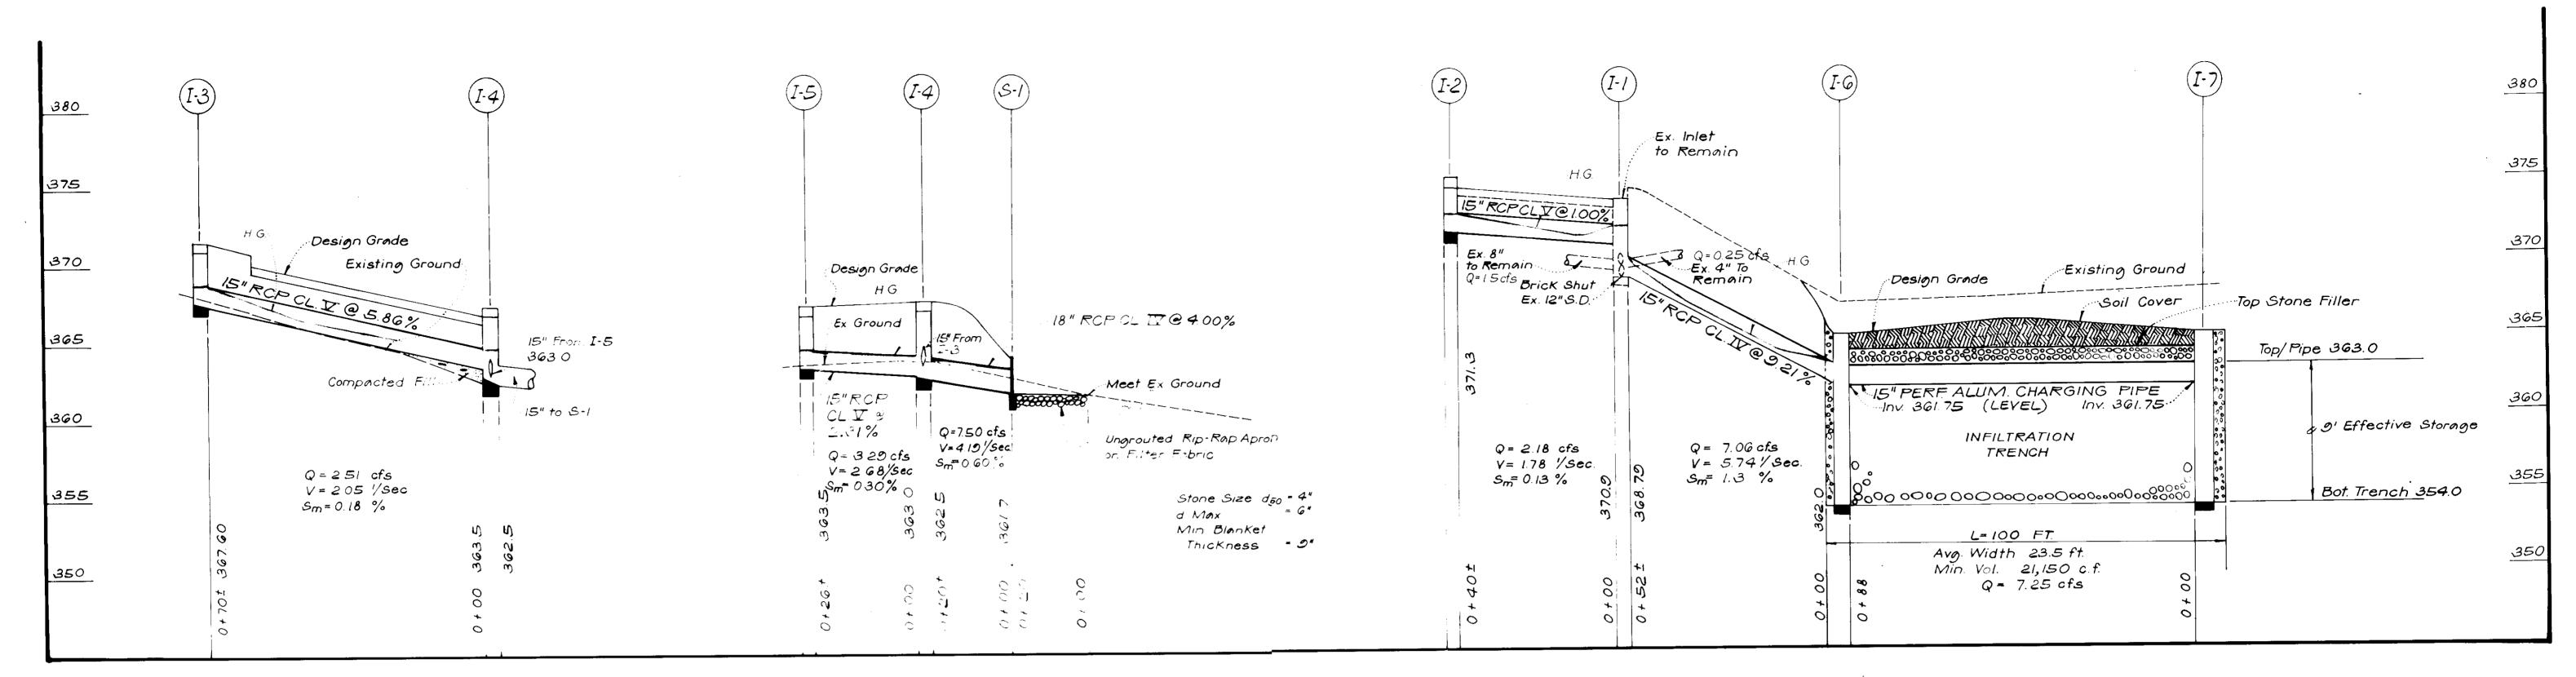


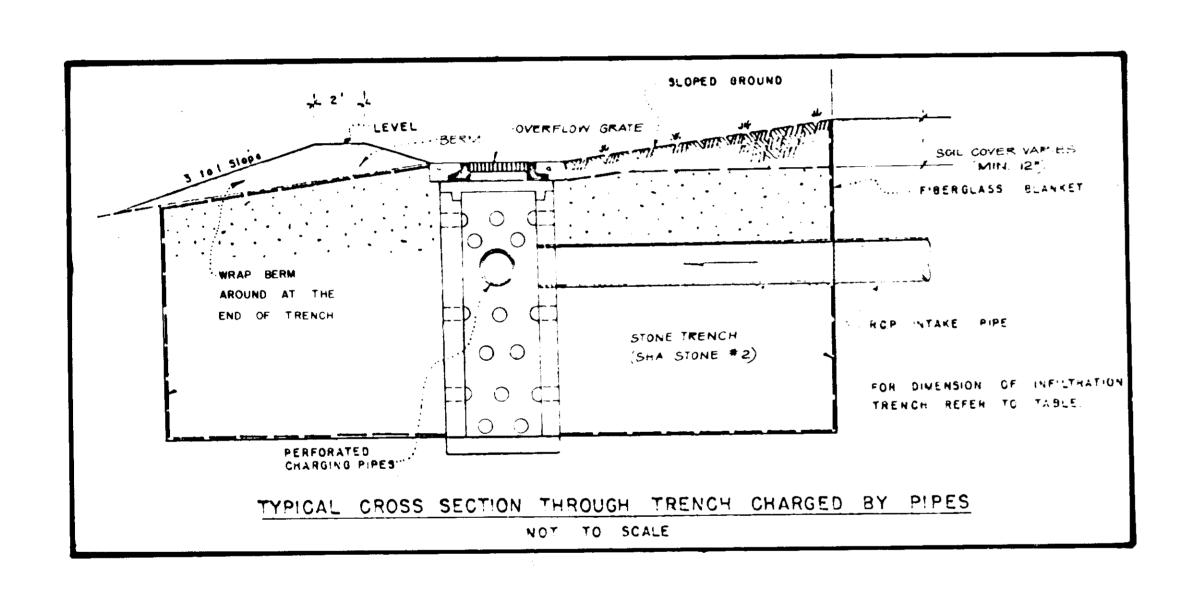

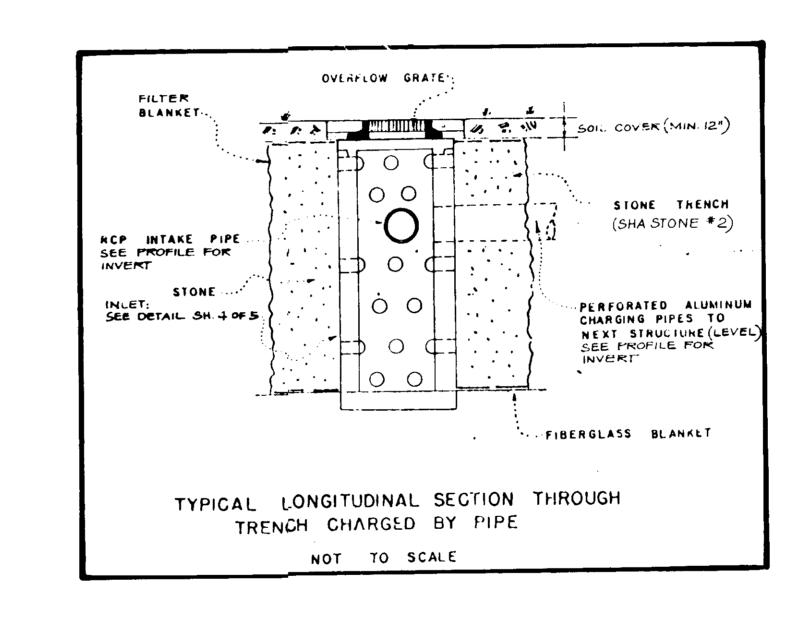


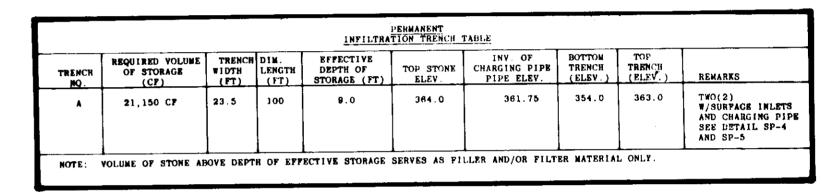


		<u>S</u>	TRUCTURE TABLE			
NO.	ТҮРЕ	TOP ELEV.	INV. IN	INV. OUT	REMARKS	
I-1	EXIST. INLET	-	370.9 (15")	368.79	BRICK-SHUT EX. 12" OUTFALL PIPE; RECHANNEL STRUCTURE, CONNECT NEW PIPE AND REPAIR STRUCTURE AS NECESSARY.	
I-2	TYPE "A-5" INLET	375.2	_	371.30	DPW STD DETAIL SD-4.01	
I -3	TYPE "A-5" INLET	371.6	-	367.60	DPW STD DETAIL SD-4.01	
1-4	TYPE "A-5" INLET	367.4	363.00	362.50	DPW STD DETAIL SD-4.01	
I-5	TYPE "A-5" INLET	367.3	_	363.5	DPW STD DETAIL SD-4.01	
I-6	INLET TO INFILTRATION TRENCH	367 .0	362.0	361.75	AS DETAILED	
I-7	INLET TO INFILTRATION TRENCH	367.0	361.75	-	AS DETAILED	
S-1	TYPE "C" ENDWALL	-	-	361.7	DPW STD DETAIL SD-5.21 (D=18") RIPRAP OUTLET PROTECTION (ROP-1	

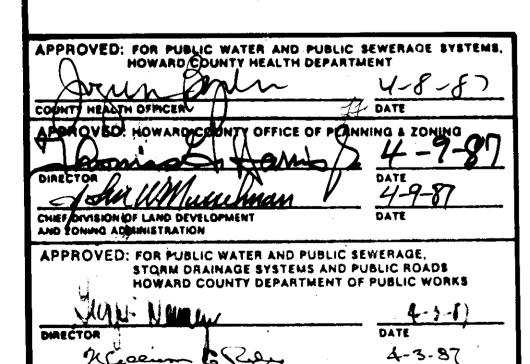


CHIEF BUREAU OF ENGINEERING

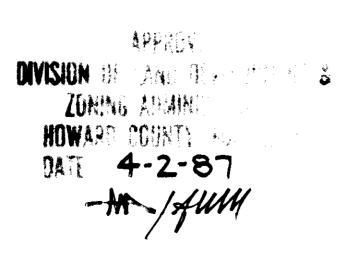

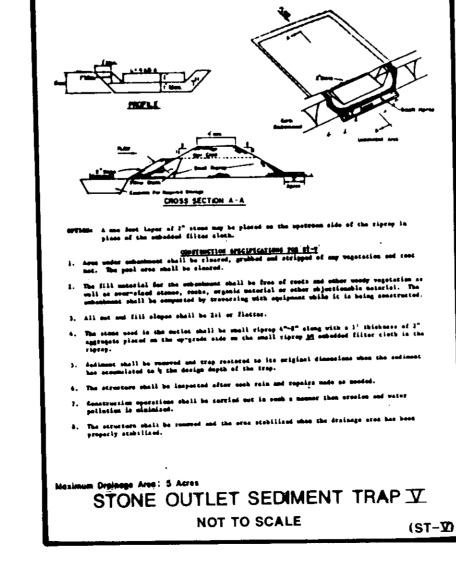


STONE OUTLET SECULENT TRAP T

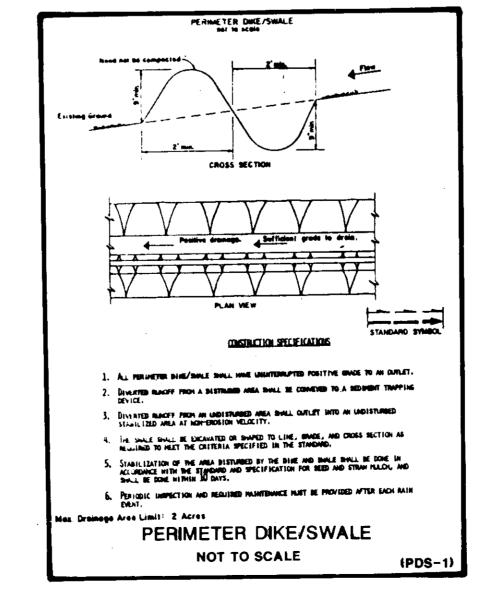

			Chron		
DARKING ADDITION TO CDD-79-9	7	MT HEBRON HIGH SCHO PLAT OR L/F BLOCK ZONE TO SEE LIST 9 15 16 R-20 WATER CODE HO3	EBRON HIGH SCHOOL LIF BLOCK ZONE TAX/ZONE HAP ELEC. DIST. IST 15.76 R-20 17 2 DDE SEWER CODE	471 ELEC. DIST CENSUS TR. 2 6021	
PARKING ADDITION TO SDP-78-27 PROJECT NAME ADDITIONAL PARKING FOR 1	R 103 CARS	ASSOCIATED ENGINEER	S, INC.	Jo∎ No 2854	
MOUNT HEBRON HIGH ELECTION DISTRICT HOWARD COUNTY,		8555 SIXTEENTH STREET SILVER SPRING, MARYLAND 20910 TEL. 301-589-7311		SHEET NO.	
PROFILES AND DETA	AILS	SCALE AS SHOWN DATE 2/27/1987 REVISED 3/30/1987		4 OF 5	
	1	5DP-87	-167		

2DL-01-101

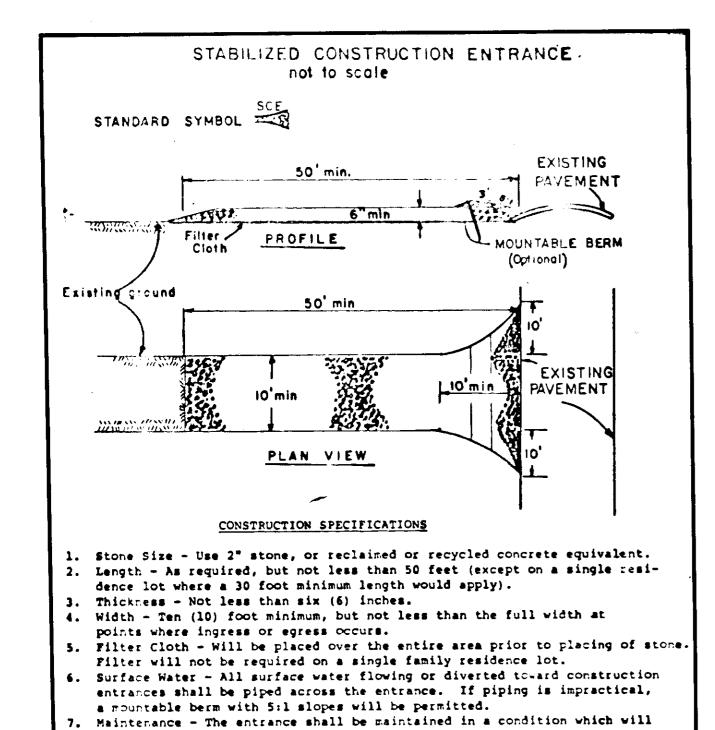

prevent tracking or flowing of sediment onto public rights-of-way. This may

require periodic top dressing with additional stone as conditions demand

. Washing - Wheels shall be cleaned to remove sediment prior to entrance onto public rights-of-way. When washing is required, it shall be done on an area

stabilized with stone and which drains into an approved sediment trapping

9. Periodic inspection and needed maintenance shall be provided after each rain.


STABILIZED CONSTRUCTION ENTRANCE


(SCE-1)


NOT TO SCALE


and repair and/or cleanout of any measures used to trap sediment. All sediment spilled, dropped, washed or tracked onto public rights-of-way must


be removed immediately.

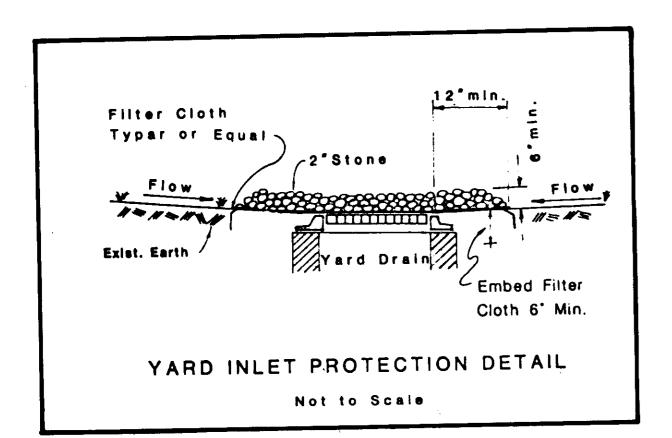


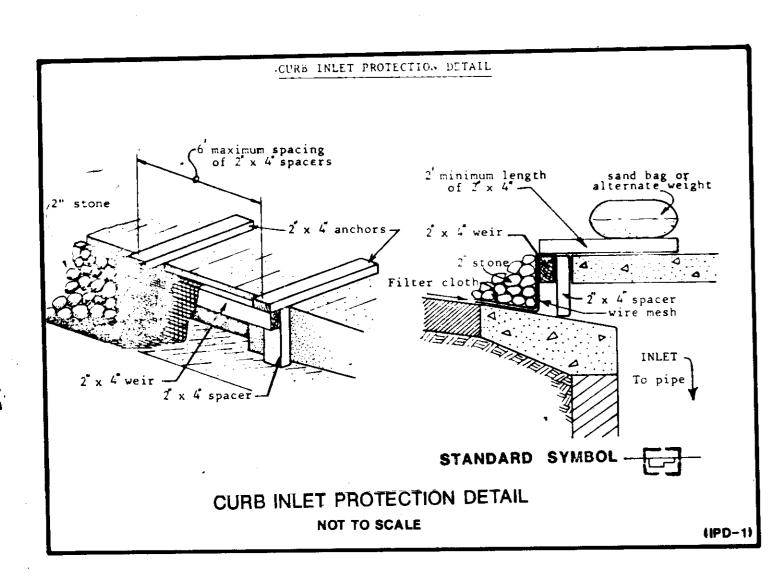


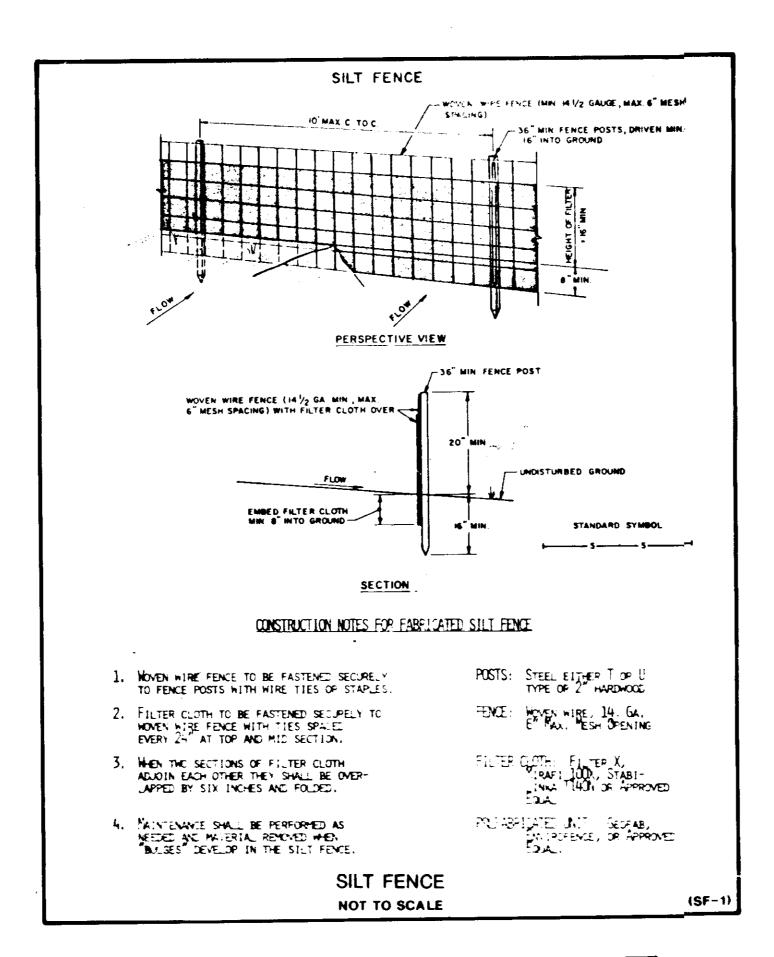


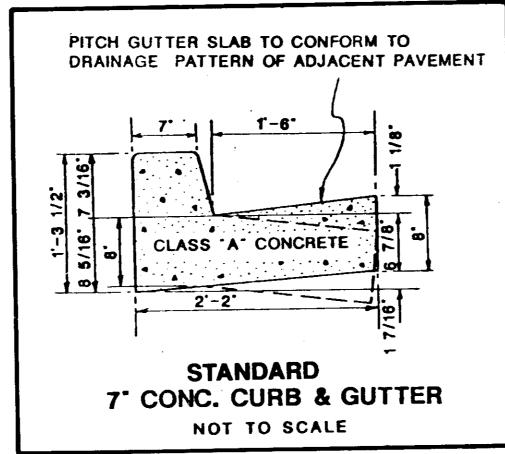


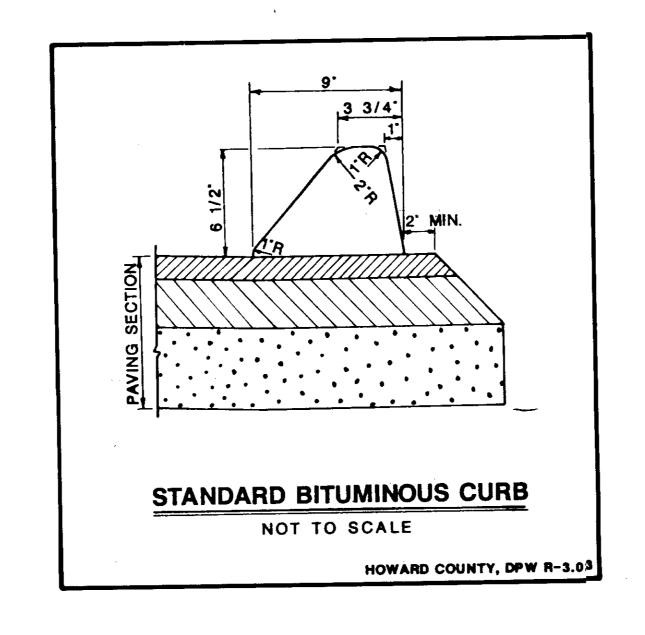


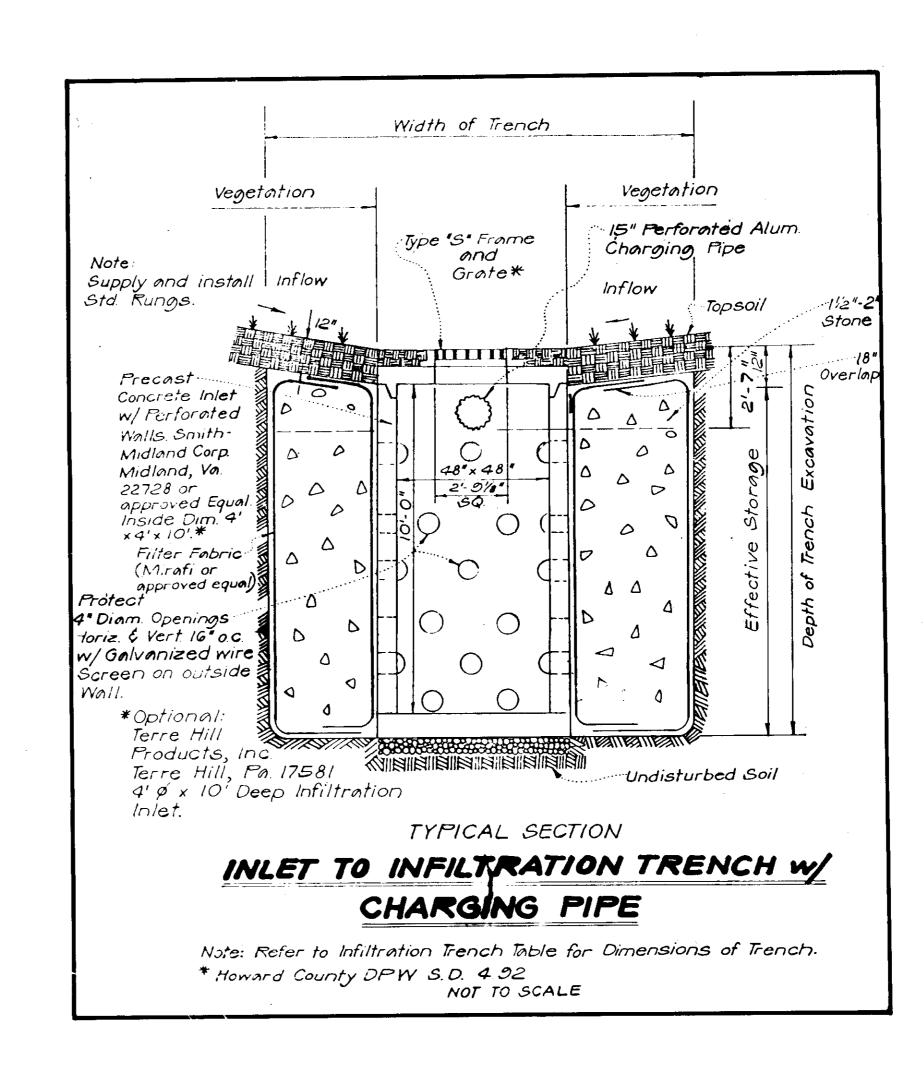

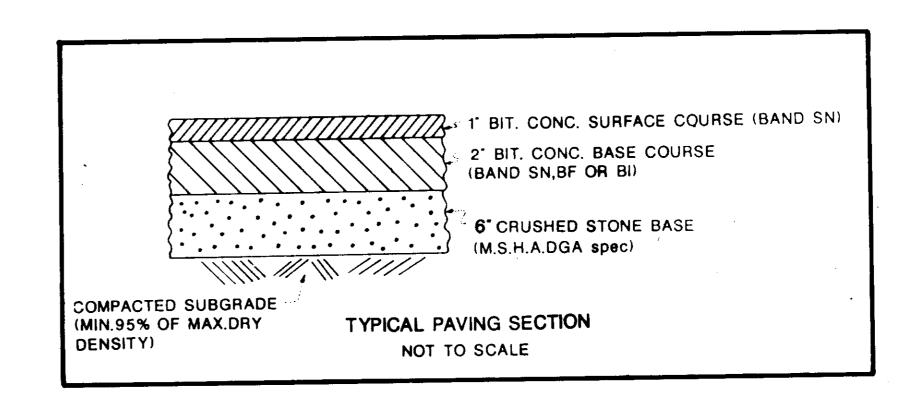

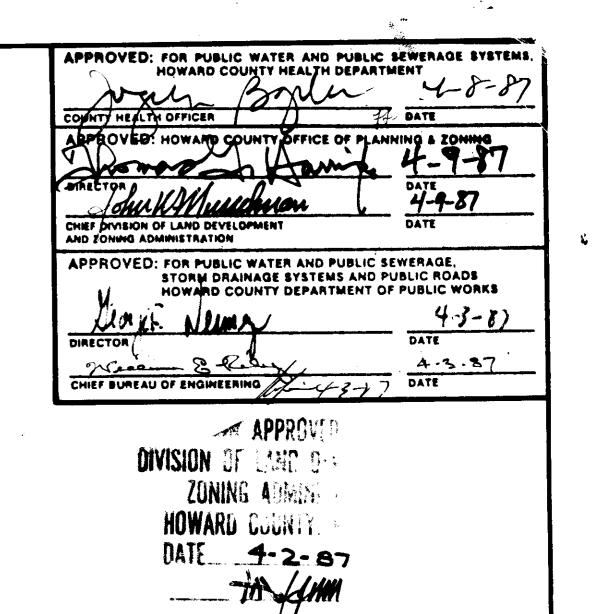

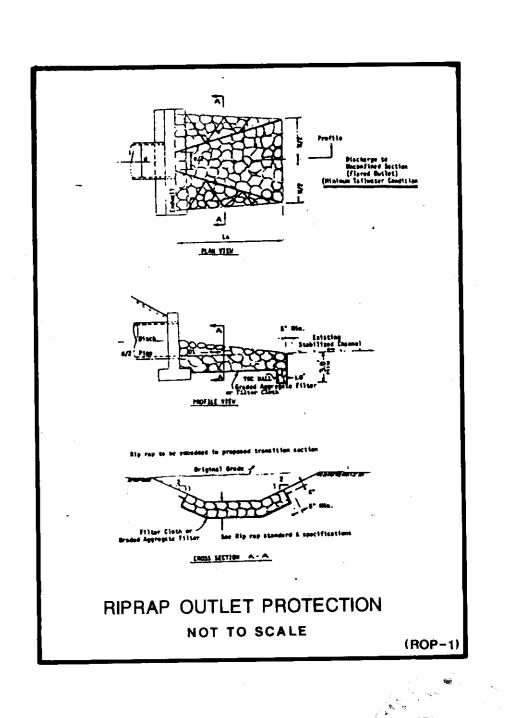

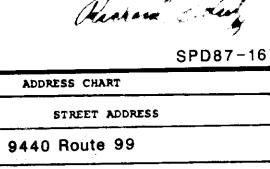

5 OF 5

ADDRESS CHART					
STREET ADDRESS					
9440 Route 99					
ELLICOTT CITY, MARYLAND					
LESCT (ADEA HOT/PA					

MT HEBRON HIGH SCHOOL 1406900 PARKING ADDITION TO SDP-78-27 PROJECT NAME ADDITIONAL PARKING FOR 103 CARS 2854 ASSOCIÁTED ENGINEERS, INC. MOUNT HEBRON HIGH SCHOOL 8555 SIXTEENTH STREET SILVER SPRING, MARYLAND 20910 SHEET NO. ELECTION DISTRICT NO. 2 TEL. 301-589-7311 **SP-5** MARYLAND HOWARD COUNTY, SCALE NOT TO SCALE DRAWING TITLE DATE 2/27/1967 **DETAILS**

REVISED 3/30/1987 5DP-87-167