



As Shown on Plan


VARIES

SLOPE TO DRAIN


CLASS & CONCRETE

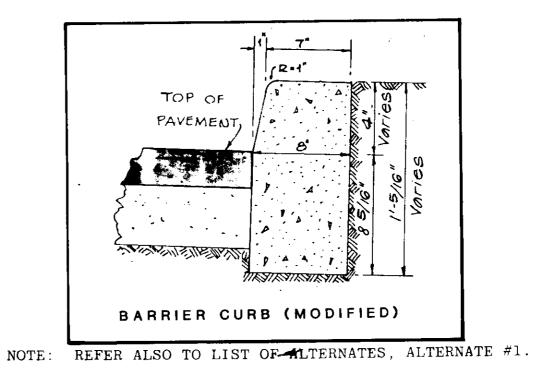


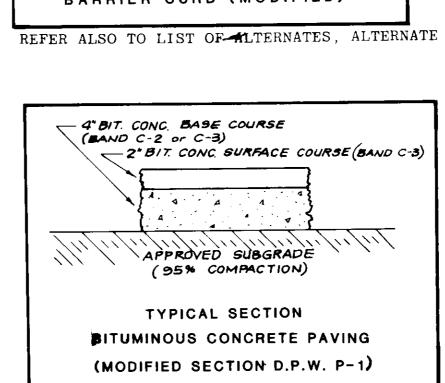

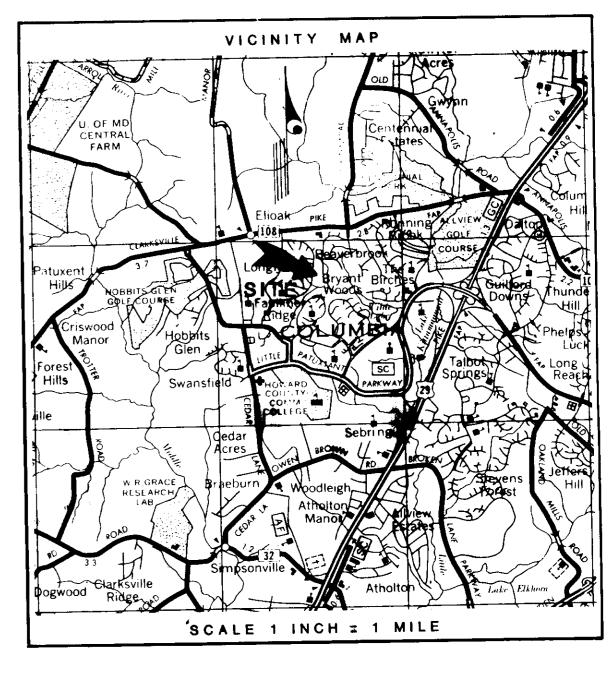

TOTAL AREA OF SITE-9.25 ACRES

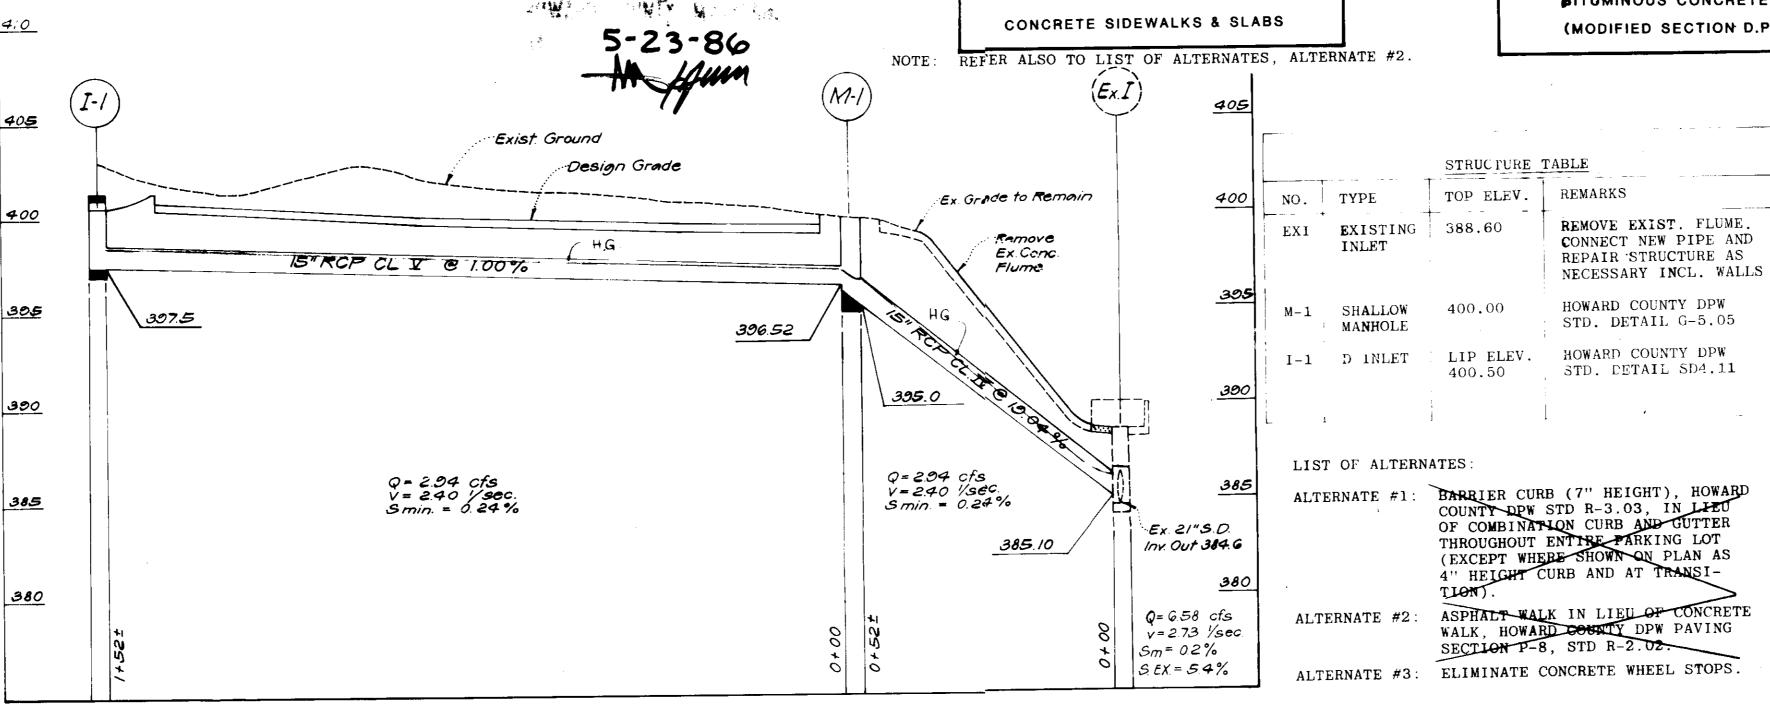

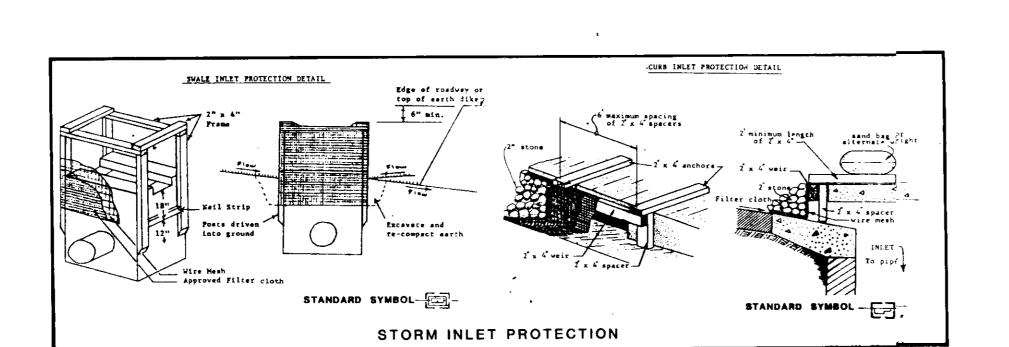


STORM DRAIN PROFILE

Horiz. /" = 20'

SCALE: Vert. I"=5'

ALTERNATE #1 - NOT ACCEPTED ALTERNATE #2 - NOT ACCEPTED ALTERNATE #3 - ACCEPTED

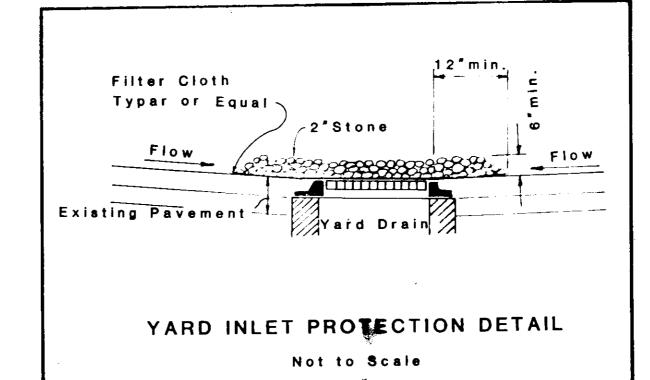

GENERAL NOTES:

- EXISTING CONDITIONS ARE BASED ON SURVEY DATED MAY 30, 1985 AND PREPARED BY ASSOCIATED ENGINEERS, INC. BENCHMARK USED: ENTRANCE OF GROUND FLOOR OF BRYANT WOODS ELEMENTARY SCHOOL BUILDING, ELEVATION 405.0.
- ALL DISTURBED UNPAVED AREA SHALL BE TOPSOILED, FERTILIZED, LIMED AND SEEDED, EXCEPT AREAS TO BE PLANTED AND AREAS TO BE SODDED. TOPSOIL DEPTH SHALL BE MINIMUM 4 INCHES COMPACTED.
- ALL SEDIMENT AND EROSION CONTROL FEATURES SHALL BE INSTALLED IN ACCORD-ANCE WITH THE "STANDARDS AND SPECIFICATIONS FOR SOIL EROSION AND SEDIMENT CONTROL IN DEVELOPED AREAS," 1983 EDITION.
- ALL CONSTRUCTION AND MATERIALS SHALL BE IN ACCORDANCE WITH THE HOWARD COUNTY ROAD CONSTRUCTION CODE AND SPECIFICATIONS AND THE APPLICABLE PROVISIONS OF THE MARYLAND STATE HIGHWAYS ADMINISTRATION STANDARDS AND SPECIFICATIONS FOR MATERIALS, HIGHWAYS, BRIDGES AND INCIDENTAL STRUCTURES.
- 5. A PREFIX OF  $\frac{4}{2}$  MAY HAVE TO BE ADDED TO ALL GRADES.
- ALL UNSUITABLE AND EXCESS FILL MATERIAL SHALL BE DISPOSED OF OFF SITE. LOCATION OF DISPOSAL AREA SHALL BE THE CONTRACTOR'S RESPONSIBILITY.
- 7. CONTACT "MISS UTILITY" AT LEAST 48 HOURS PRIOR TO COMMENCING EXCAVATIONS.
- EXISTING UTILITIES ARE BASED ON AVAILABLE RECORDS AND WERE FIELD-CHECKED WHERE POSSIBLE. CONTRACTOR MUST DIG TEST PITS BY HAND AT UTILITY CROSSINGS AND CONNECTION POINTS TO VERIFY EXACT LOCATION AND INVERTS WELL IN ADVANCE OF CONSTRUCTION. IF CONNECTIONS ARE NOT AS SHOWN OR IF CONFLICT IS ANTICIPATED, ENGINEER SHALL BE NOTIFIED BEFORE PROCEEDING WITH TRENCHING.
- CONTRACTOR SHALL CLEAN UP THE WORK AREA AT THE COMPLETION OF THE PROJECT. ALL AREAS DISTURBED DURING THE CONSTRUCTION ACTIVITY SHALL BE REPAIRED TO THE SATISFACTION OF THE OWNER'S REPRESENTATIVE.
- 10. CONTRACTOR SHALL ERECT A TEMPORARY CONSTRUCTION FENCE AND BARRICADE IN LOCATION SHOWN ON PLAN TO MINIMIZE INTERFERENCE WITH SCHOOL ACTIVITIES AND TO PROTECT BIKE PATH.
- 11. PITCH GUTTER OF CURBS TO CONFORM TO ADJACENT DRAINAGE PATTERN.
- 12. CONTRACTOR SHALL PROVIDE ALL SUITABLE FILL MATERIAL. LOCATION OF BORROW SHALL BE THE CONTRACTOR'S RESPONSIBILITY.
- CHAIN LINK FENCE SHALL BE 5 FEET HIGH AND HOWARD COUNTY DEPARTMENT OF PUBLIC WORKS STANDARD G8-01 THROUGH G8-02.
- FOR CONSTRUCTION SPECIFICATIONS OF INFIL-TRATION TRENCH REFER TO "STANDARDS AND SPECIFICATIONS FOR INFILTRATION PRACTICES, MARYLAND DEPARTMENT OF NATURAL RESOURCES, WATER RESOURCES ADMINISTRATION, STORM-WATER MANAGEMENT DIVISION, FEBRUARY 1984

SUBDIVISION VWL-BRY		DODS EL	.SCH.		/AREA		PARCEL 1
PLAT 1 OR L/F 12/46	BLOCK 1	20ME N.T. OS.CREDIT	TAX/20N		EEC.	DIST.	CONSUS TR. 6052.04
WATER CODE I- O/			SEWI	SER CODE 5601000			

SITE INFORMATION: OWNER: BOARD OF EDUCATION ADDRESS: 10910 ROUTE 108 ELLICOTT CITY, MD. 21043 TELEPHONE: (801) 922 9599

LOCATION: 5450 BLUE HERON LANE COLUMBIA, MD. ELECTION DISTRICT: #2

TAX MAP: #30 AREA OF PROPERTY: 9.25 ACRES

ZONING: NT Open Space FDP-2-A-V PROPERTY RECORDED IN LIBER: 478 FOLIO: 566

27478

SP-1

1 OF 3

APPROVED:	For Public Water, Public Sewerage Drawinage Systems and Roads	and	Storm	
HOWARD COU	NTY DEPARTMENT OF PUBLIC WORKS			
_ yun_	DIRECTOR	<u>.</u>	DATE	
CHIEF. BUR	EAU OF ENGINEENING	<u> </u>	DATE	-

SCALE: 1/2 IN. T.FT.

WHEEL STOP DETAILS

PRECAST UNITS

NOTE: REFER ALSO TO LIST OF ALTERNATES, ALTERNATE #3

APPROVED: For Public Water and Public Sewerage Systems HOWARD COUNTY HEALTH DEPARTMENT

6-26.86 AND ZONING ADMINISTRATION

Howard County Office of Planning and Zoning

. less the

ADDRESS CHART OT NUMBER STREET ADDRESS 5450 BLUE HERON 215

NOTE: ALL DETAILS SHOWN ARE NOT TO SCALE

PROJECT NAME BRYANT WOODS ELEMENTARY SCHOOL

EDITION.


SDP-86-235C


Parking lot addition to SDP-84-97c

VILLAGE OF WILDE LAKE, SECT. 1, O.S. LOT 215 HOWARD COUNTY MARYLAND-2nd Elect. Dist. DRAWING TITLE PARKING ADDITION NOTES & DETAILS

ASSOCIATED ENGINEERS, INC 8555 SIXTEENTH STREET SHEET NO. SILVER SPRING. MARYLAND 20910 TEL. 301-589-7311 SCALE AS SHOWN DATE 4/15/86 REVISED June 4, 1986

## NOTE: THIS DRAWING IS TO BE USED FOR SEDIMENT CONTROL ONLY

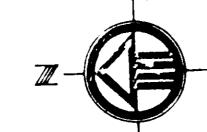

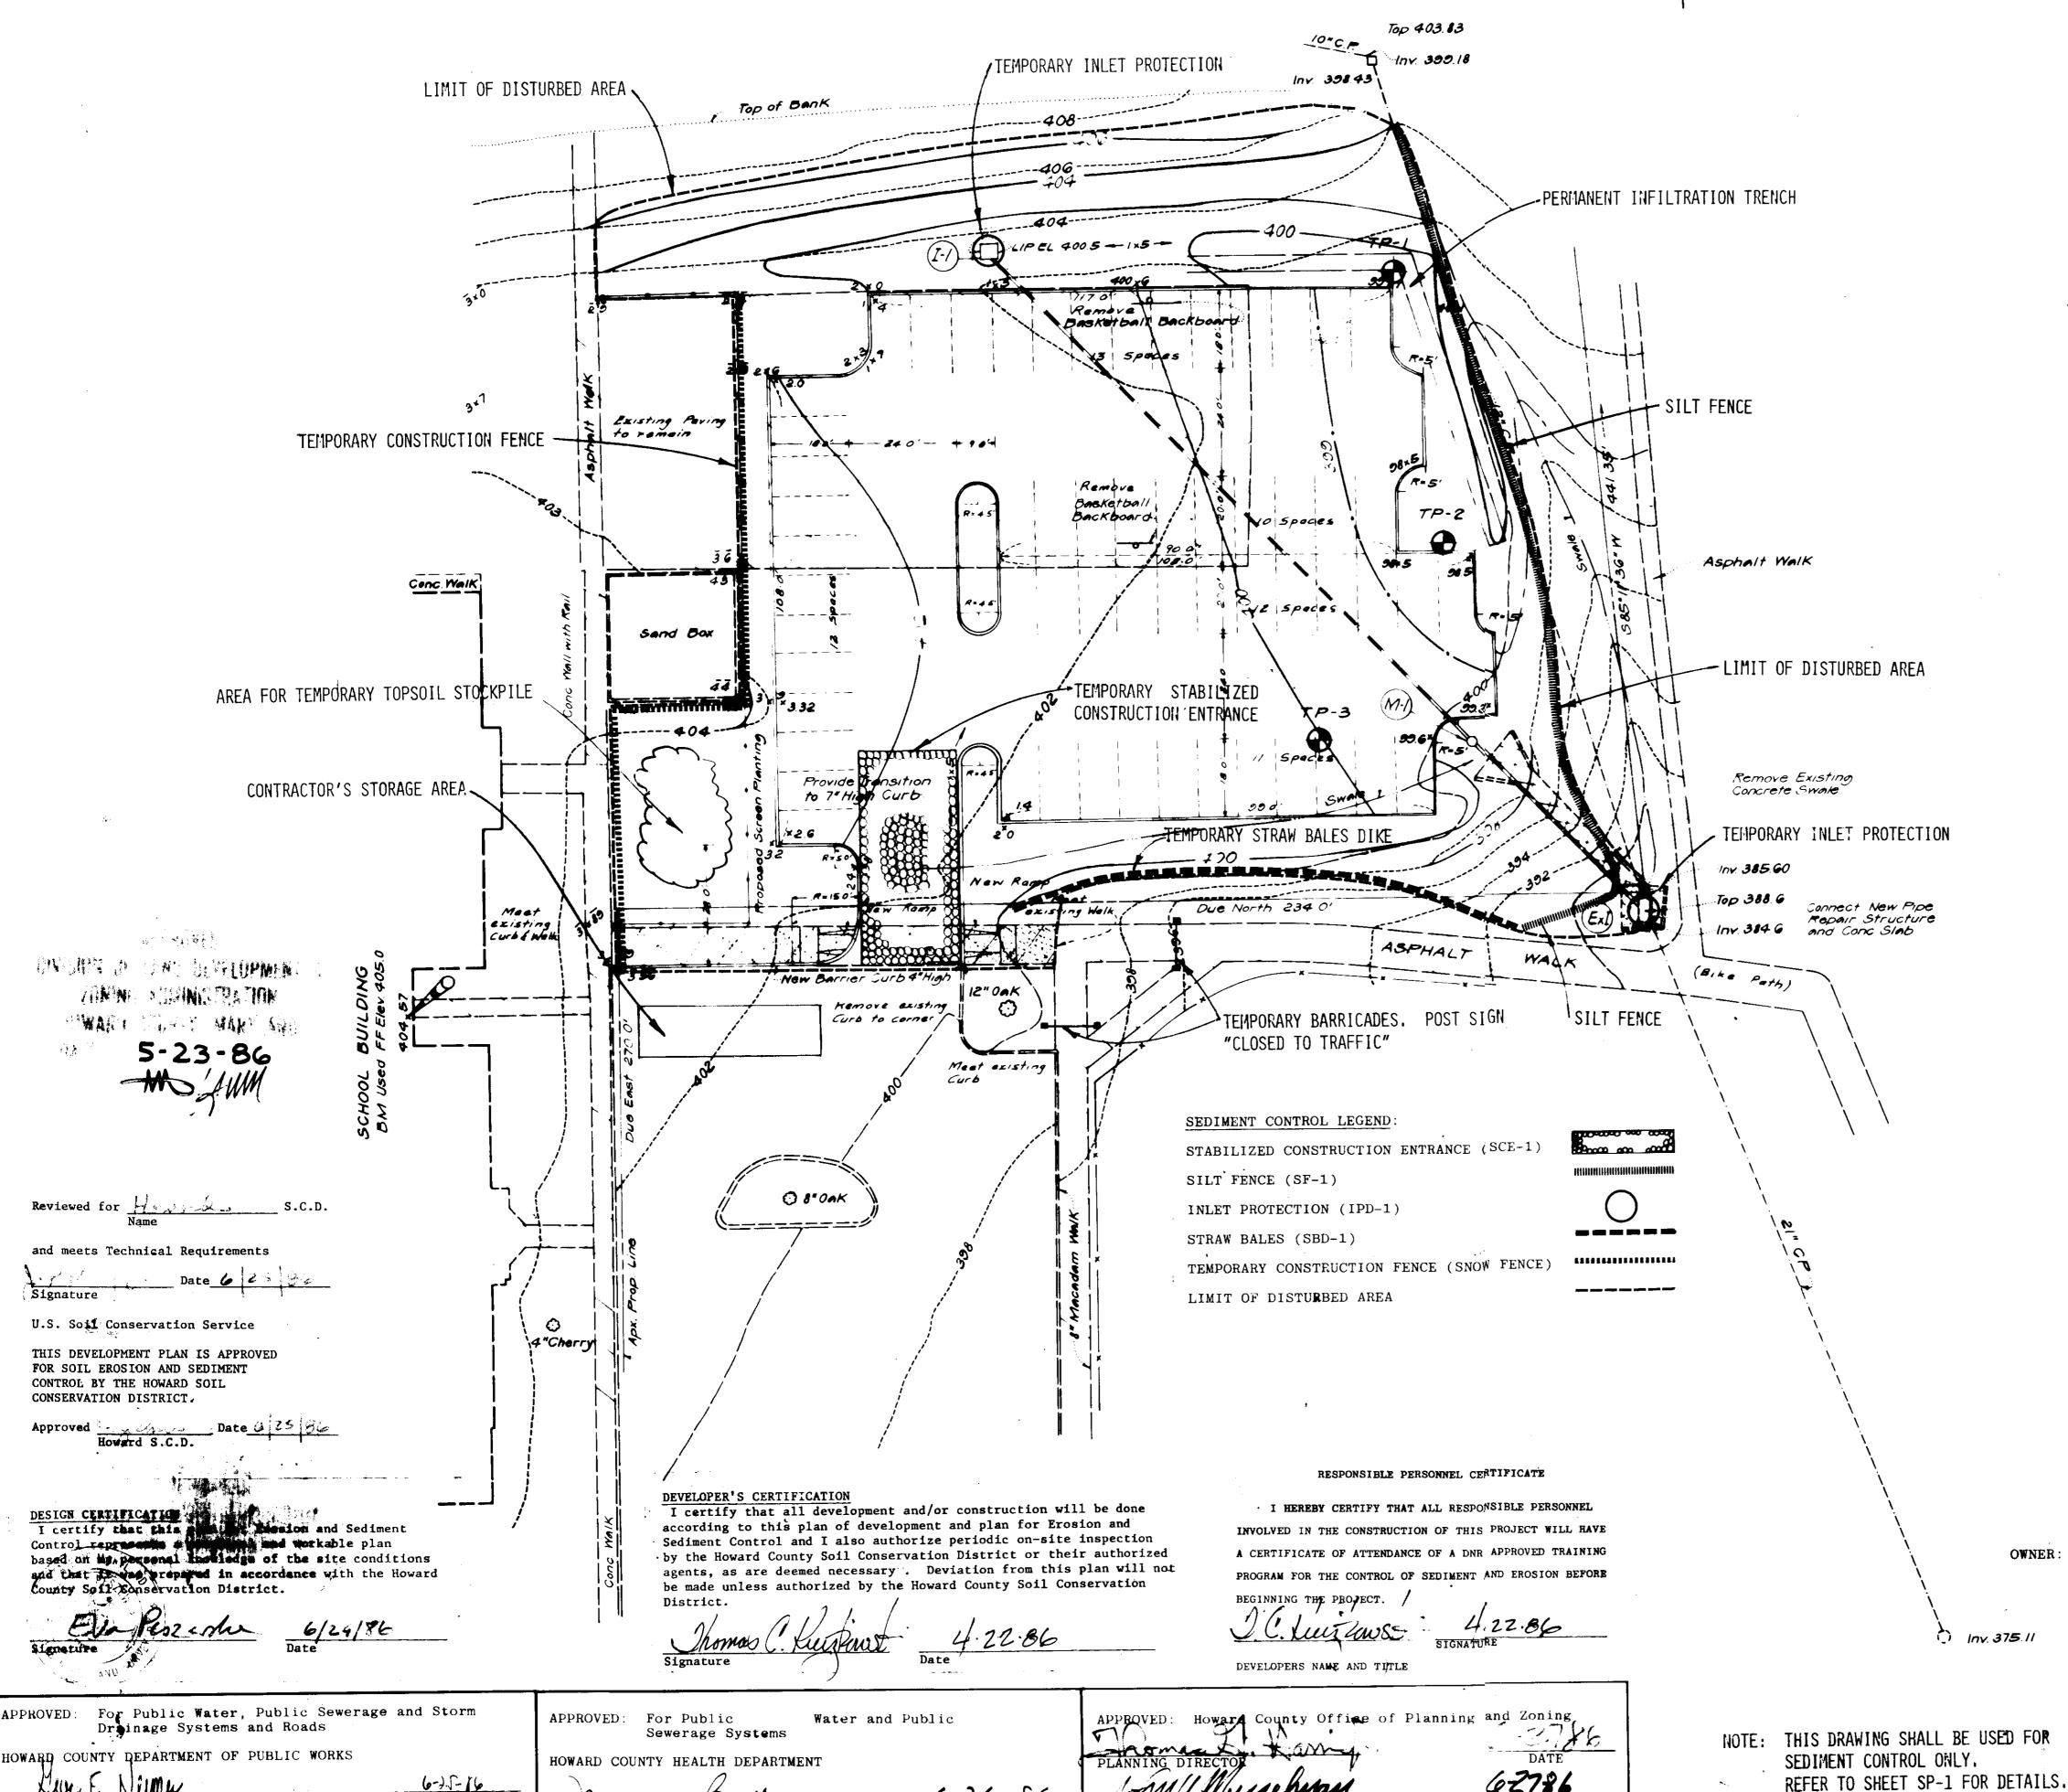

6-26-86

1.1

AND ZONING ADMINISTRATION

SEDIMENT CONTROL NOTES:

- 1. A MINIMUM OF 24 HOURS NOTICE MUST BE GIVEN TO THE HOWARD COUNTY OFFICE OF INSPECTION AND PERMITS PRIOR TO THE START OF ANY CONSTRUCTION (922-2437).
- 2. ALL VEGETATIVE AND STRUCTURAL PRACTICES ARE TO BE INSTALLED ACCORDING TO THE PROVISIONS OF THIS PLAN AND ARE TO BE IN CONFORMANCE WITH THE 1983 "MARYLAND STANDARDS AND SPECIFICATIONS FOR SOIL EROSION AND SEDIMENT CONTROL"
- 3. FOLLOWING INITIAL SOIL DISTURBANCE OR RELISTURBANCE, PERMANENT OR TEMPORARY STABILIZATION SHALL BE COMPLETED WITHIN: A) 7 CALENDAR DAYS FOR ALL PERIMETER SEDIMENT CONTROL STRUCTURES, DIKES, PERIMETER SLOPES AND ALL SLOPES GREATER THAN 3:1, B) 14 DAYS AS TO ALL OTHER DISTURBED OR GRADED AREAS ON THE PROJECT SITE.
- 4. ALL SEDIMENT TRAPS/BASINS SHOWN MUST BE FENCED AND WARNING SIGNS POSTED AROUND THEIR PERIMETER IN ACCORDANCE WITH VOL. 1. CHAPTER 12 OF THE HOWARD COUNTY DESIGN MANUAL. "STORM DRAINAGE." (N/A FOR THIS PROJECT.)
- 5. ALL DISTURBED AREAS MUST BE STABILIZED WITHIN THE TIME PERIOD SPECIFIED ABOVE IN ACCORDANCE WITH THE 1983 "MARYLAND STANDARDS AND SPECIFICATIONS FOR SOIL EROSION AND SEDIMENT CONTROL" FOR PERMANENT SEEDINGS (SEC. 51) SOD (SEC. 54), TEMPORARY SEEDING (SEC. 50) AND MULCHING (SEC. 52), AND AS SPECIFIED HEREIN:
  - A. TOPSOIL SHALL MEET ALL APPLICABLE REQUIREMENTS OF THE SPECIFICATIONS FOR MATERIALS, HIGHWAYS, BRIDGES AND INCIDENTAL STRUCTURES OF THE MARYLAND STATE HIGHWAY ADMINISTRATION. TOPSOIL SHALL BE 4 INCHES THICK (COMPACTED).
  - B. LIME SHALL BE SPREAD AT A RATE OF ONE (1) TON PER ACRE.
- C. FERTILIZER 5-10-10 OR EQUIVALENT SHALL BE APPLIED AT A RATE OF 1700 LBS. PER ACRE. BOTH LIME AND FERTILIZER SHALL BE UNIFORMLY APPLIED TO THE LOOSENED TOPSOIL AND SHALL BE RAKED SMOOTH PRIOR TO SEEDING.
  - D. SEED SHALL BE "KENTUCKY 31" TALL FESCUE APPLIED AT A RATE OF 2 LBS PER 1.000 SQ. FT. STRAW MULCH SHALL BE UNIFORMLY APPLIED AT THE RATE OF 70 TO 90 LBS. PER 1.000 FT.
  - E. SOD SHALL BE A CLASS OF TURF GRASS SOD AND SHALL BE MARYLAND STATE CERTIFIED OR MARYLAND STATE APPROVED SOD.

TEMPORARY STABILIZATION WITH MULCH ALONE CAN ONLY BE DONE WHEN RECOMMENDED SEEDING DATES DO NOT ALLOW FOR PROPER GERMINATION AND ESTABLISHMENT OF GRASSES.

- 6. ALL SEDIMENT CONTROL STRUCTURES ARE TO REMAIN IN PLACE AND ARE TO BE MAINTAINED IN OPERATIVE CONDITION UNTIL PERMISSION FOR THEIR REMOVAL HAS BEEN OBTAINED FROM THE HOWARD COUNTY SEDIMENT CONTROL INSPECTOR.
- 7. SITE ANALYSIS:

TOTAL AREA OF SITE: 9.25 ACRES Total area of existing and proposed parking lots AREA DISTURBED: 0.74 ACRES to remain 0.92 Acres (actual 0.88 Acres) AREA TO BE PAVED: 0.42 ACRES
PAVING AREA TO BE REMOVED: 0.13 ACRES
NET AREA TO BE PAVED: 0.29 ACRES
AREA TO BE VEGETATIVELY STABILIZED: 0.32 ACRES
TOTAL CUT: 1330 C.Y. (EXCLUDING EXCAVATION FOR INFILTRATION TRENCHES)
TOTAL FILL: 120 C.Y.
OFFSITE WASTE AREA LOCATION: TO BE SUBMITTED
OFFSITE BORROW AREA LOCATION: TO BE SUBMITTED
CONTRACTOR WILL BE REQUIRED TO PROVIDE
THE ABOVE INFORMATION PRIOR TO ISSUANCE OF
THE PERMIT AND SUBMIT A SEDIMENT CONTROL
PLAN ACCEPTABLE TO THE SOIL CONSERVATION
DISTRICT.

- 8. ANY SEDIMENT CONTROL PRACTICE WHICH IS DISTURBED BY GRADING ACTIVITY FOR PLACEMENT OF UTILITIES MUST BE REPAIRED ON THE SAME DAY OF DISTURBANCE.
- 9. ADDITIONAL SEDIMENT CONTROLS MUST BE PROVIDED, IF DEEMED NECESSARY BY THE HOWARD COUNTY DPW SEDIMENT CONTROL INSPECTOR.

  SEDIMENT CONTROL CONSTRUCTION SEQUENCE:
  - 1. INSTALL BARRICADE; POST SIGN "CLOSED TO TRAFFIC."
  - 2. INSTALL ALL SEDIMENT CONTROL FEATURES, INCLUDING INLET PROTECTION AT EXISTING INLET.
  - 3. INSTALL CONSTRUCTION FENCE
  - 4. CARRY OUT INITIAL TRENCH EXCAVATION FOR TEMPORARY STORMWATER MANAGEMENT. (REFER TO STORMWATER MANAGEMENT CONSTRUCTION SEQUENCE FOR TRENCH DIMENSIONS.)
  - 5. DEMOLISH EXISTING PAVING.
  - 6. STRIP TOPSOIL AND STOCKPILE.
  - 7. ROUGH GRADE AREA
  - 8. CONSTRUCT STORM DRAIN; TEMPORARILY PLUG STRUCTURES AND PIPES.
  - 9. FINE GRADE AND CONSTRUCT CURB AND BASE COURSE.
  - 10. INSTALL INLET PROTECTION AT I-1.
  - 11. SPREAD TOPSOIL AND STABILIZE ALL DISTURBED, UNPAVED AREAS.
  - 12. UNPLUG STORM DRAIN PIPES AND MAKE SYSTEM OPERABLE.
  - 13. COMPLETE EXCAVATION FOR PERMANENT INFILTRATION TRENCH AND FILL WITH STONE.
  - 14. PLACE SURFACE COURSE AND CONSTRUCT WALKS.
  - 15. REMOVE ALL SEDIMENT CONTROL FEATURES.
  - 16. STABILIZE ALL REMAINING, DISTURBED AREAS.

SDP-86-235C 17. CLEAN UP SITE AND BEGIN MAINTENANCE.

Parking lot addition to SDP-84-97c

BOARD OF EDUCATION

ELLICOTT CLTY, MD 21943

TELE. (301)-022-0500-

10910 ROUTE 108

2747B ASSOCIATED ENGINEERS, INC. BRYANT WOODS ELEMENTARY SCHOOL 8555 SIXTEENTH STREET SHEET NO SILVER SPRING MARYLAND 20910 VILLAGE OF WILDE LAKE, SECT. 1, O.S.LOT 215 SP-2 TEL 301 589-7311 HOWARD COUNTY, MARYLAND-2nd Elect. Dist. 20F3 SCALE /" = 20' DRAWING TITLE SEDIMENT & EROSION CONTROL PLAN July 3, 1985 DATE REVISED June 4 1986

SDP-86-235.

