


LEGEND

- PROPOSED CURB AND GUTTER
- PROPOSED STORM DRAIN
- PROPOSED STORM DRAIN STRUCTURE
- GENERAL AREA OF TURF ADJACENT TO PROPOSED WORK (NOT SHOWN TO LIMITS) SEE NOTE 9.
- EXISTING TREE TO REMAIN AND BE PROTECTED
- SEE NOTE 6 WORK TO BE ACCOMPLISHED AS INDICATED IN REFERENCED NOTE AND GENERAL LOCATION ON PLAN
- CONCRETE SIDEWALK, HOWARD CO. STD. R 3.05
- HANDICAPPED RAMP, 3/4" WIDE OPENING, 4' LONG RAMP
- HEAVY DUTY BITUMINOUS PAVEMENT SEE DETAIL 1
- LIGHT DUTY BITUMINOUS PAVEMENT SEE DETAIL 2
- 1/2" SURFACE BITUMINOUS OVERLAY SEE DETAIL 3
- PROPOSED CLEAN CUT
- LIMIT OF COMPACT LINE

General Notes

1. Existing pavement and stone base not under proposed pavements shall be removed, area shall be topsoiled and made smooth with adjacent existing lawn. Meet top of existing or proposed curb. Provide positive drainage, seed and mulched in accordance with the specifications.
2. Existing pavements and stone base under proposed pavements shall be removed where designated on the plans. Subgrade shall be prepared for new pavement as indicated on the plans and in the specifications.
3. Curb and gutter endings not at existing curbs to remain, i.e. entrances off Burnt Woods Road, east end of building, shall be terminated with a three foot long taper which reduces curb height from 6 inches to 1 inch.
4. Joints between existing bituminous pavement to remain and proposed bituminous pavement shall be a clean, smooth, unbroken saw cut. Saw cut joint shall be tacked prior to placement of new pavement and final joint sealed.
5. All site construction shall be accomplished in accordance with the project plans, specifications, Howard County Standards and Specifications and the Maryland State Highway Standards and Specifications.
6. The locations of existing utilities on these drawings are taken from available records, however, it is the Contractor's responsibility to locate all utilities within the area of construction prior to commencing work. The contractor shall contact Miss Utility, utility company representative, perform test pits, review current test pit data, and whatever other operations available, to insure the exact horizontal and vertical location of all utilities in the area of construction. The contractor shall notify VIKI, Inc. of any potential conflicts or discrepancies between actual locations and those on the plans prior to commencing construction.
7. All proposed utility crossings shall be test pitted prior to construction.
8. Existing concrete sidewalk and curb and gutter which is to be removed shall be removed to the nearest expansion joint at or beyond the point indicated on the plans. New concrete construction shall join existing concrete surfaces (incl. building) with sealed 1/2" expansion joint.
9. All disturbed areas (due to contractors activities) not under pavements or building shall be stabilized by placement or existence of minimum of 5" depth native topsoil and seeding per the specifications.
10. Planimetric and topographic information obtained from survey prepared by Hudkins Associates titled "Glenelg High School, Locations and Topography" and dated October 12, 1983
11. Existing bituminous pavement to remain shall be cleaned, primed and overlain with 1 1/2" course MSHA Band SN bituminous surface. SEE SYMBOL IN LEGEND AND 1
12. Contractor shall remove and dispose of excess earth, demolished concrete and bituminous material offsite. Borrow for the site shall be obtained in a manner which conforms with the Howard County sediment control regulations.
13. Adjust existing structure frames and grates to match proposed grade as referenced on the plan (note 13).
14. Close inlet openings, provide manhole opening with frame and grate to match proposed grade as referenced on the plan (note 14). @ STRUCTURES 3 & 7
15. Existing bell shall be relocated as shown. This item shall be secured in an equal manner. SEE ALSO DETAILS ON ARCHITECTURAL PLANS.

APPROVED
DIVISION OF LAND DEVELOPMENT &
ZONING ADMINISTRATION
HOWARD COUNTY, MARYLAND
DATE 2-19-85

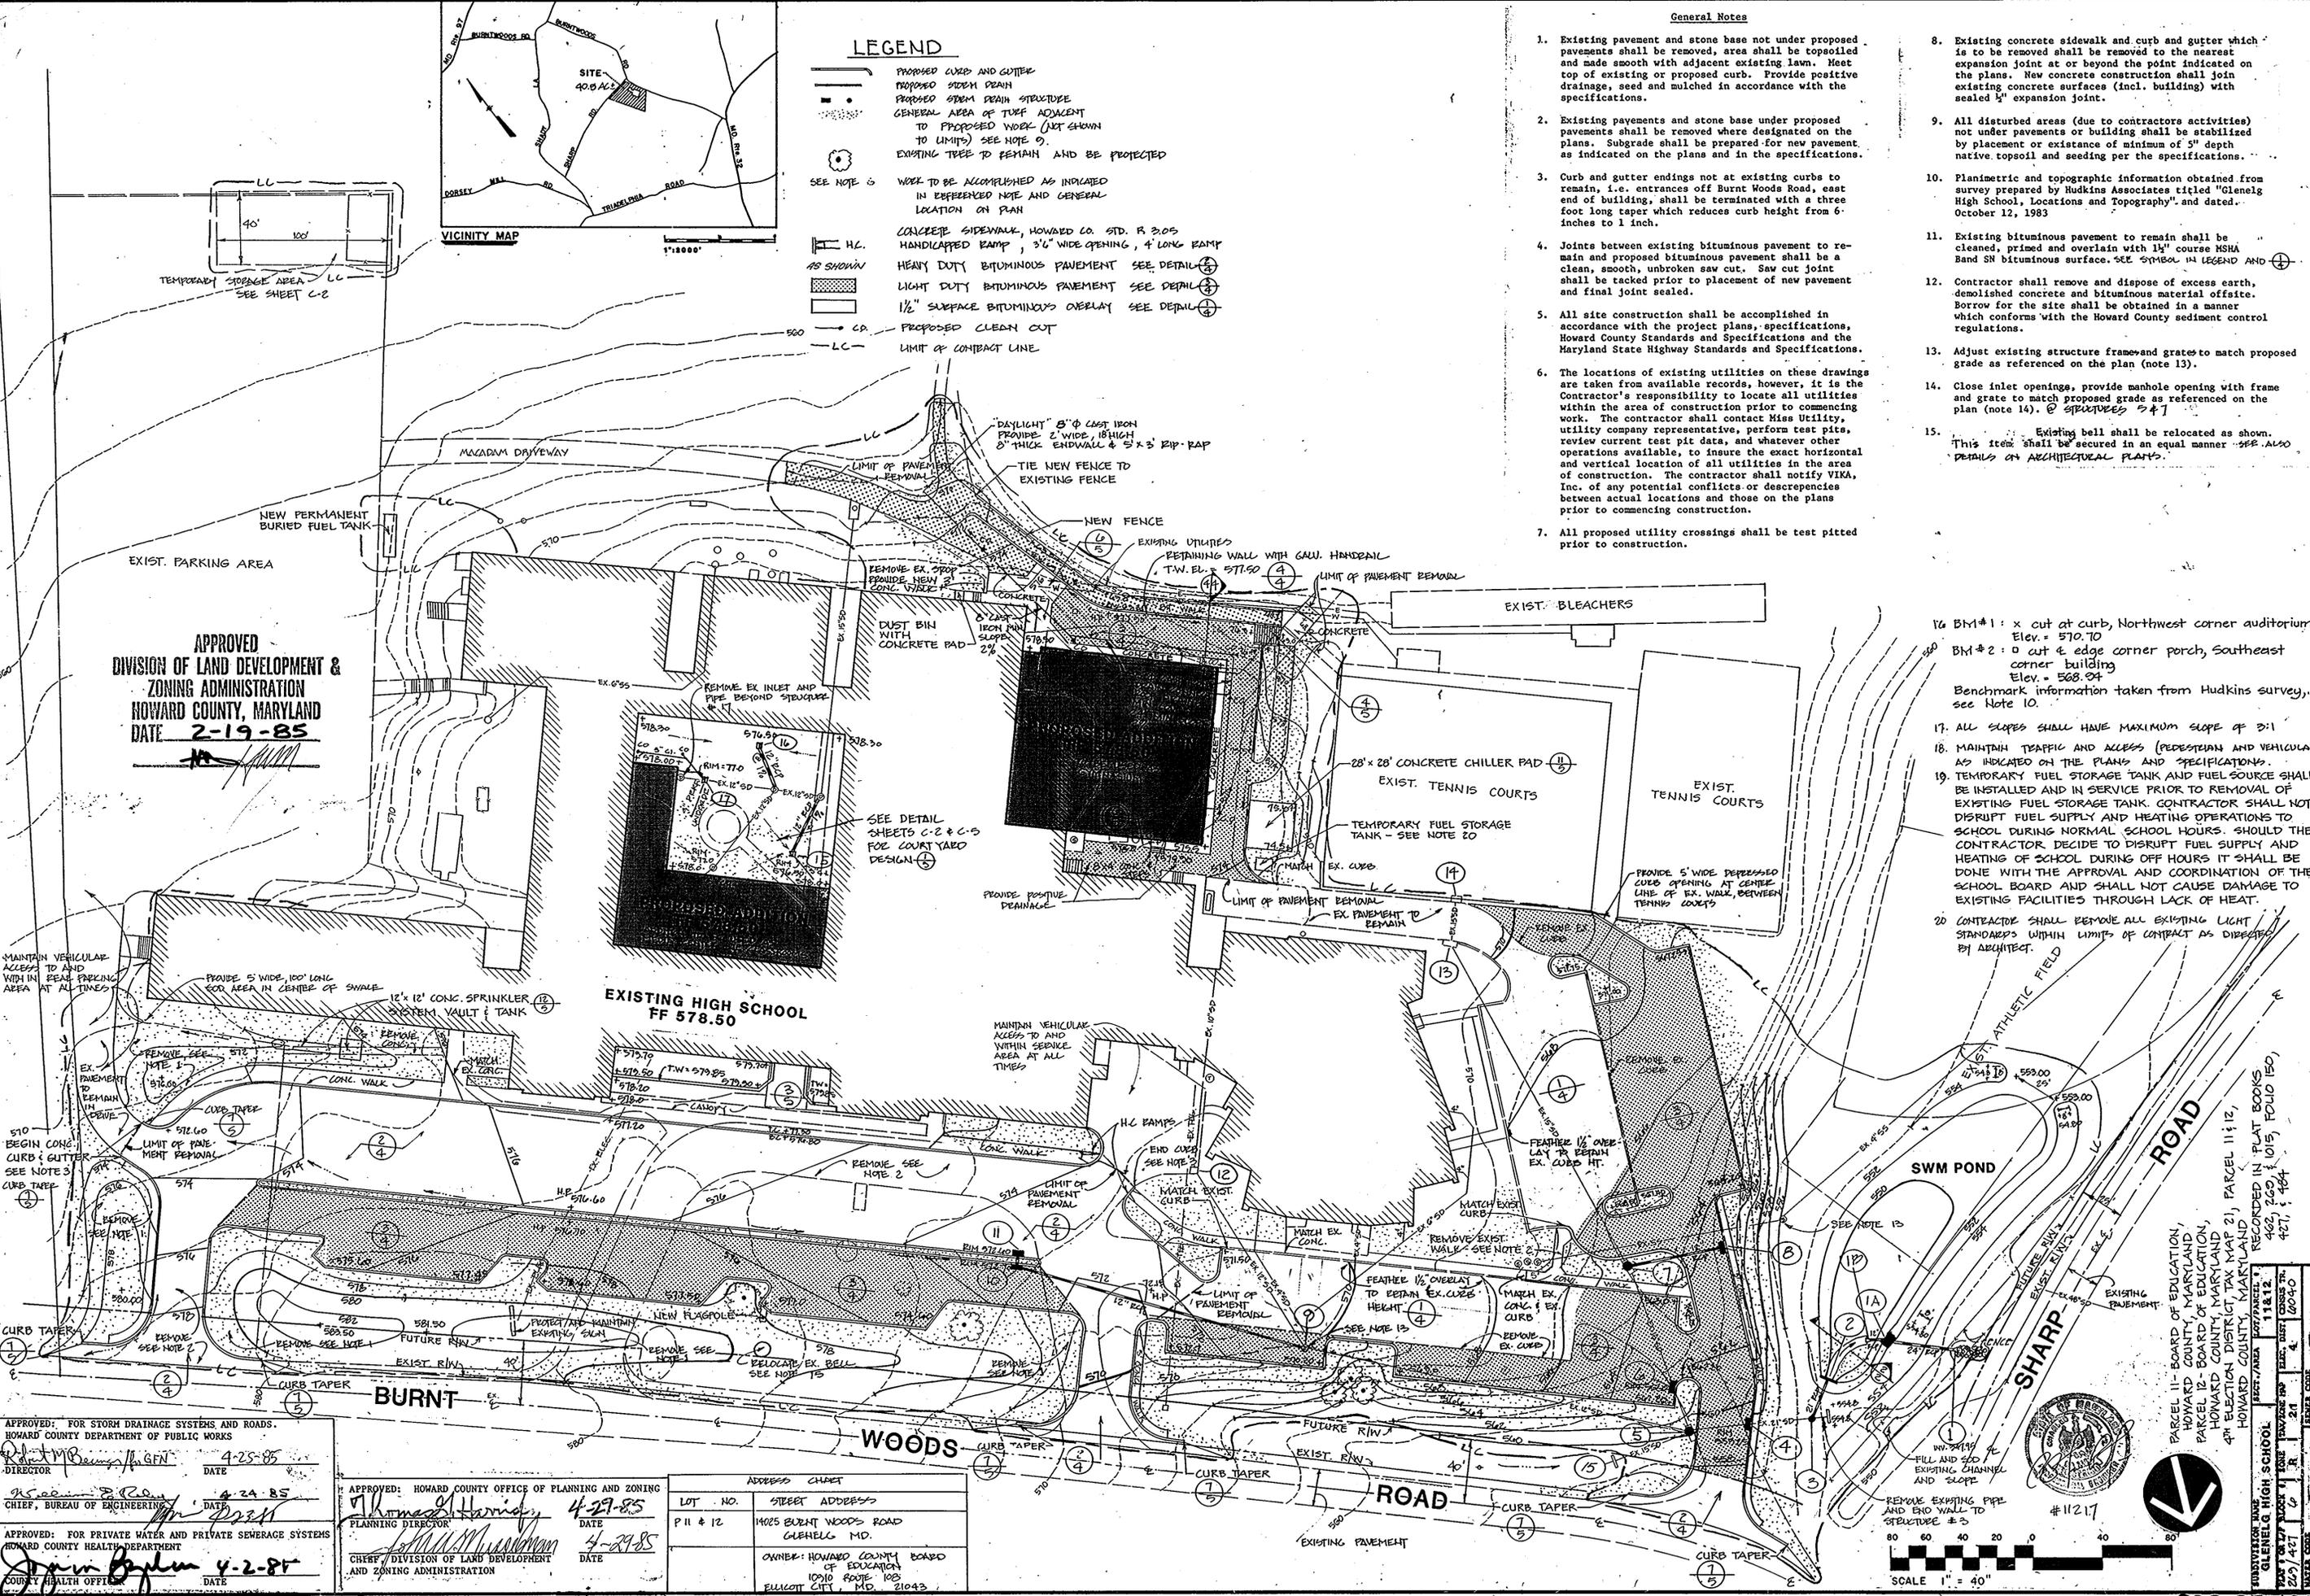

16. BM #1 : x cut at curb, Northwest corner auditorium Elev. = 570.70
- BM #2 : o cut & edge corner porch, Southeast corner building Elev. = 568.94
- Benchmark information taken from Hudkins survey, see Note 10.
17. ALL SLOPES SHALL HAVE MAXIMUM SLOPE OF 3:1
18. MAINTAIN TRAFFIC AND ACCESS (PEDESTRIAN AND VEHICULAR) AS INDICATED ON THE PLANS AND SPECIFICATIONS.
19. TEMPORARY FUEL STORAGE TANK AND FUEL SOURCE SHALL BE INSTALLED AND IN SERVICE PRIOR TO REMOVAL OF EXISTING FUEL STORAGE TANK. CONTRACTOR SHALL NOT DISRUPT FUEL SUPPLY AND HEATING OPERATIONS TO SCHOOL DURING NORMAL SCHOOL HOURS. SHOULD THE CONTRACTOR DECIDE TO DISRUPT FUEL SUPPLY AND HEATING OF SCHOOL DURING OFF HOURS IT SHALL BE DONE WITH THE APPROVAL AND COORDINATION OF THE SCHOOL BOARD AND SHALL NOT CAUSE DAMAGE TO EXISTING FACILITIES THROUGH LACK OF HEAT.
20. CONTRACTOR SHALL REMOVE ALL EXISTING LIGHT STANDARDS WITHIN LIMITS OF CONTRACT AS DIRECTED BY ARCHITECT.

APPROVED: FOR STORM DRAINAGE SYSTEMS AND ROADS.
HOWARD COUNTY DEPARTMENT OF PUBLIC WORKS
DIRECTOR [Signature] DATE 4-25-85

APPROVED: FOR PRIVATE WATER AND PRIVATE SEWERAGE SYSTEMS
HOWARD COUNTY HEALTH DEPARTMENT
COUNTY HEALTH OFFICE [Signature] DATE 4-2-85

APPROVED: HOWARD COUNTY OFFICE OF PLANNING AND ZONING
PLANNING DIRECTOR [Signature] DATE 4-27-85

APPROVED: DIVISION OF LAND DEVELOPMENT AND ZONING ADMINISTRATION
CHIEF [Signature] DATE 4-27-85

LOT NO.	STREET ADDRESS
P11 & 12	1005 BURNT WOODS ROAD GLENELG MD.
	OWNER: HOWARD COUNTY BOARD OF EDUCATION 10510 ROUTE 103 ELLICOTT CITY MD. 21043



SITE PLAN




GLENELG HIGH SCHOOL

Subdivision Name: GLENELG HIGH SCHOOL
Part of 277 Block 1, Zone 1, Burnt Woods Road, Bethesda, MD 20814
Sheet No. 1 of 4
Date: NOV. 1984
Project No. 84020
Scale: 1" = 40'

APPROVED: FOR STORM DRAINAGE SYSTEMS AND ROADS.
 HOWARD COUNTY DEPARTMENT OF PUBLIC WORKS
 DIRECTOR: *R. J. M. ...* DATE: 4-25-85

APPROVED: FOR PRIVATE WATER AND PRIVATE SEWERAGE SYSTEMS
 HOWARD COUNTY HEALTH DEPARTMENT
 COUNTY HEALTH OFFICER: *John ...* DATE: 4-24-85

APPROVED: HOWARD COUNTY OFFICE OF PLANNING AND ZONING
 PLANNING DIRECTOR: *John ...* DATE: 4-29-85
 CHIEF, DIVISION OF LAND DEVELOPMENT AND ZONING ADMINISTRATION

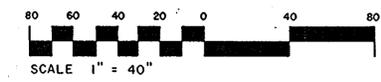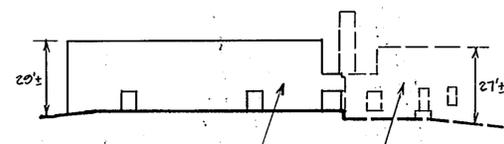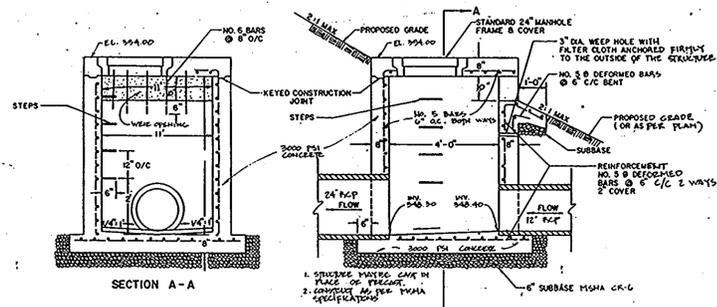

STORM WATER MANAGEMENT STRUCTURE
 STRUCTURE NO. 1-A

NOTES:


- FOR LIMITS OF CURB AND GUTTER SEE SITE PLAN, SHEET 1 OF 4
- FOR LIMITS OF VARIOUS TYPES OF PAVEMENTS, STORM DRAINAGE, AND GRADING SEE SITE PLAN, SHEET 1 OF 4
- TRAFFIC PAINT LINES SHALL BE 4" WIDE, WHITE FOR BUSES & CARS, SHOWN ON THIS PLAN AND TYPICALLY DIMENSIONED.
- CONTRACTOR SHALL REMOVE ALL EXISTING LIGHT STANDARDS (POLES) WITHIN LIMITS OF CONTRACT AS DIRECTED BY THE ARCHITECT.

SITE ANALYSIS


- A. AREA OF PARCEL 40.9 AC.±
- B. ZONING R
- C. FLOOR SPACE PROPOSED ADDITION 17,950 sq ft
- D. FLOOR SPACE EXISTING BUILDING 193,000 sq ft
- E. ADJACENT PROPERTY ZONING R

PARKING TABULATION

- A. PARKING SPACES FOR CARS
- EXISTING PARKING SPACES TO REMAIN 230
 - PROPOSED PARKING SPACES 112
 - PROPOSED HANDICAP SPACES 3
 - TOTAL SPACES 354
- B. PARKING SPACES FOR BUSES
- PROPOSED PARKING SPACES 23

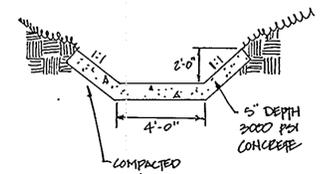

CONCRETE CHANNEL

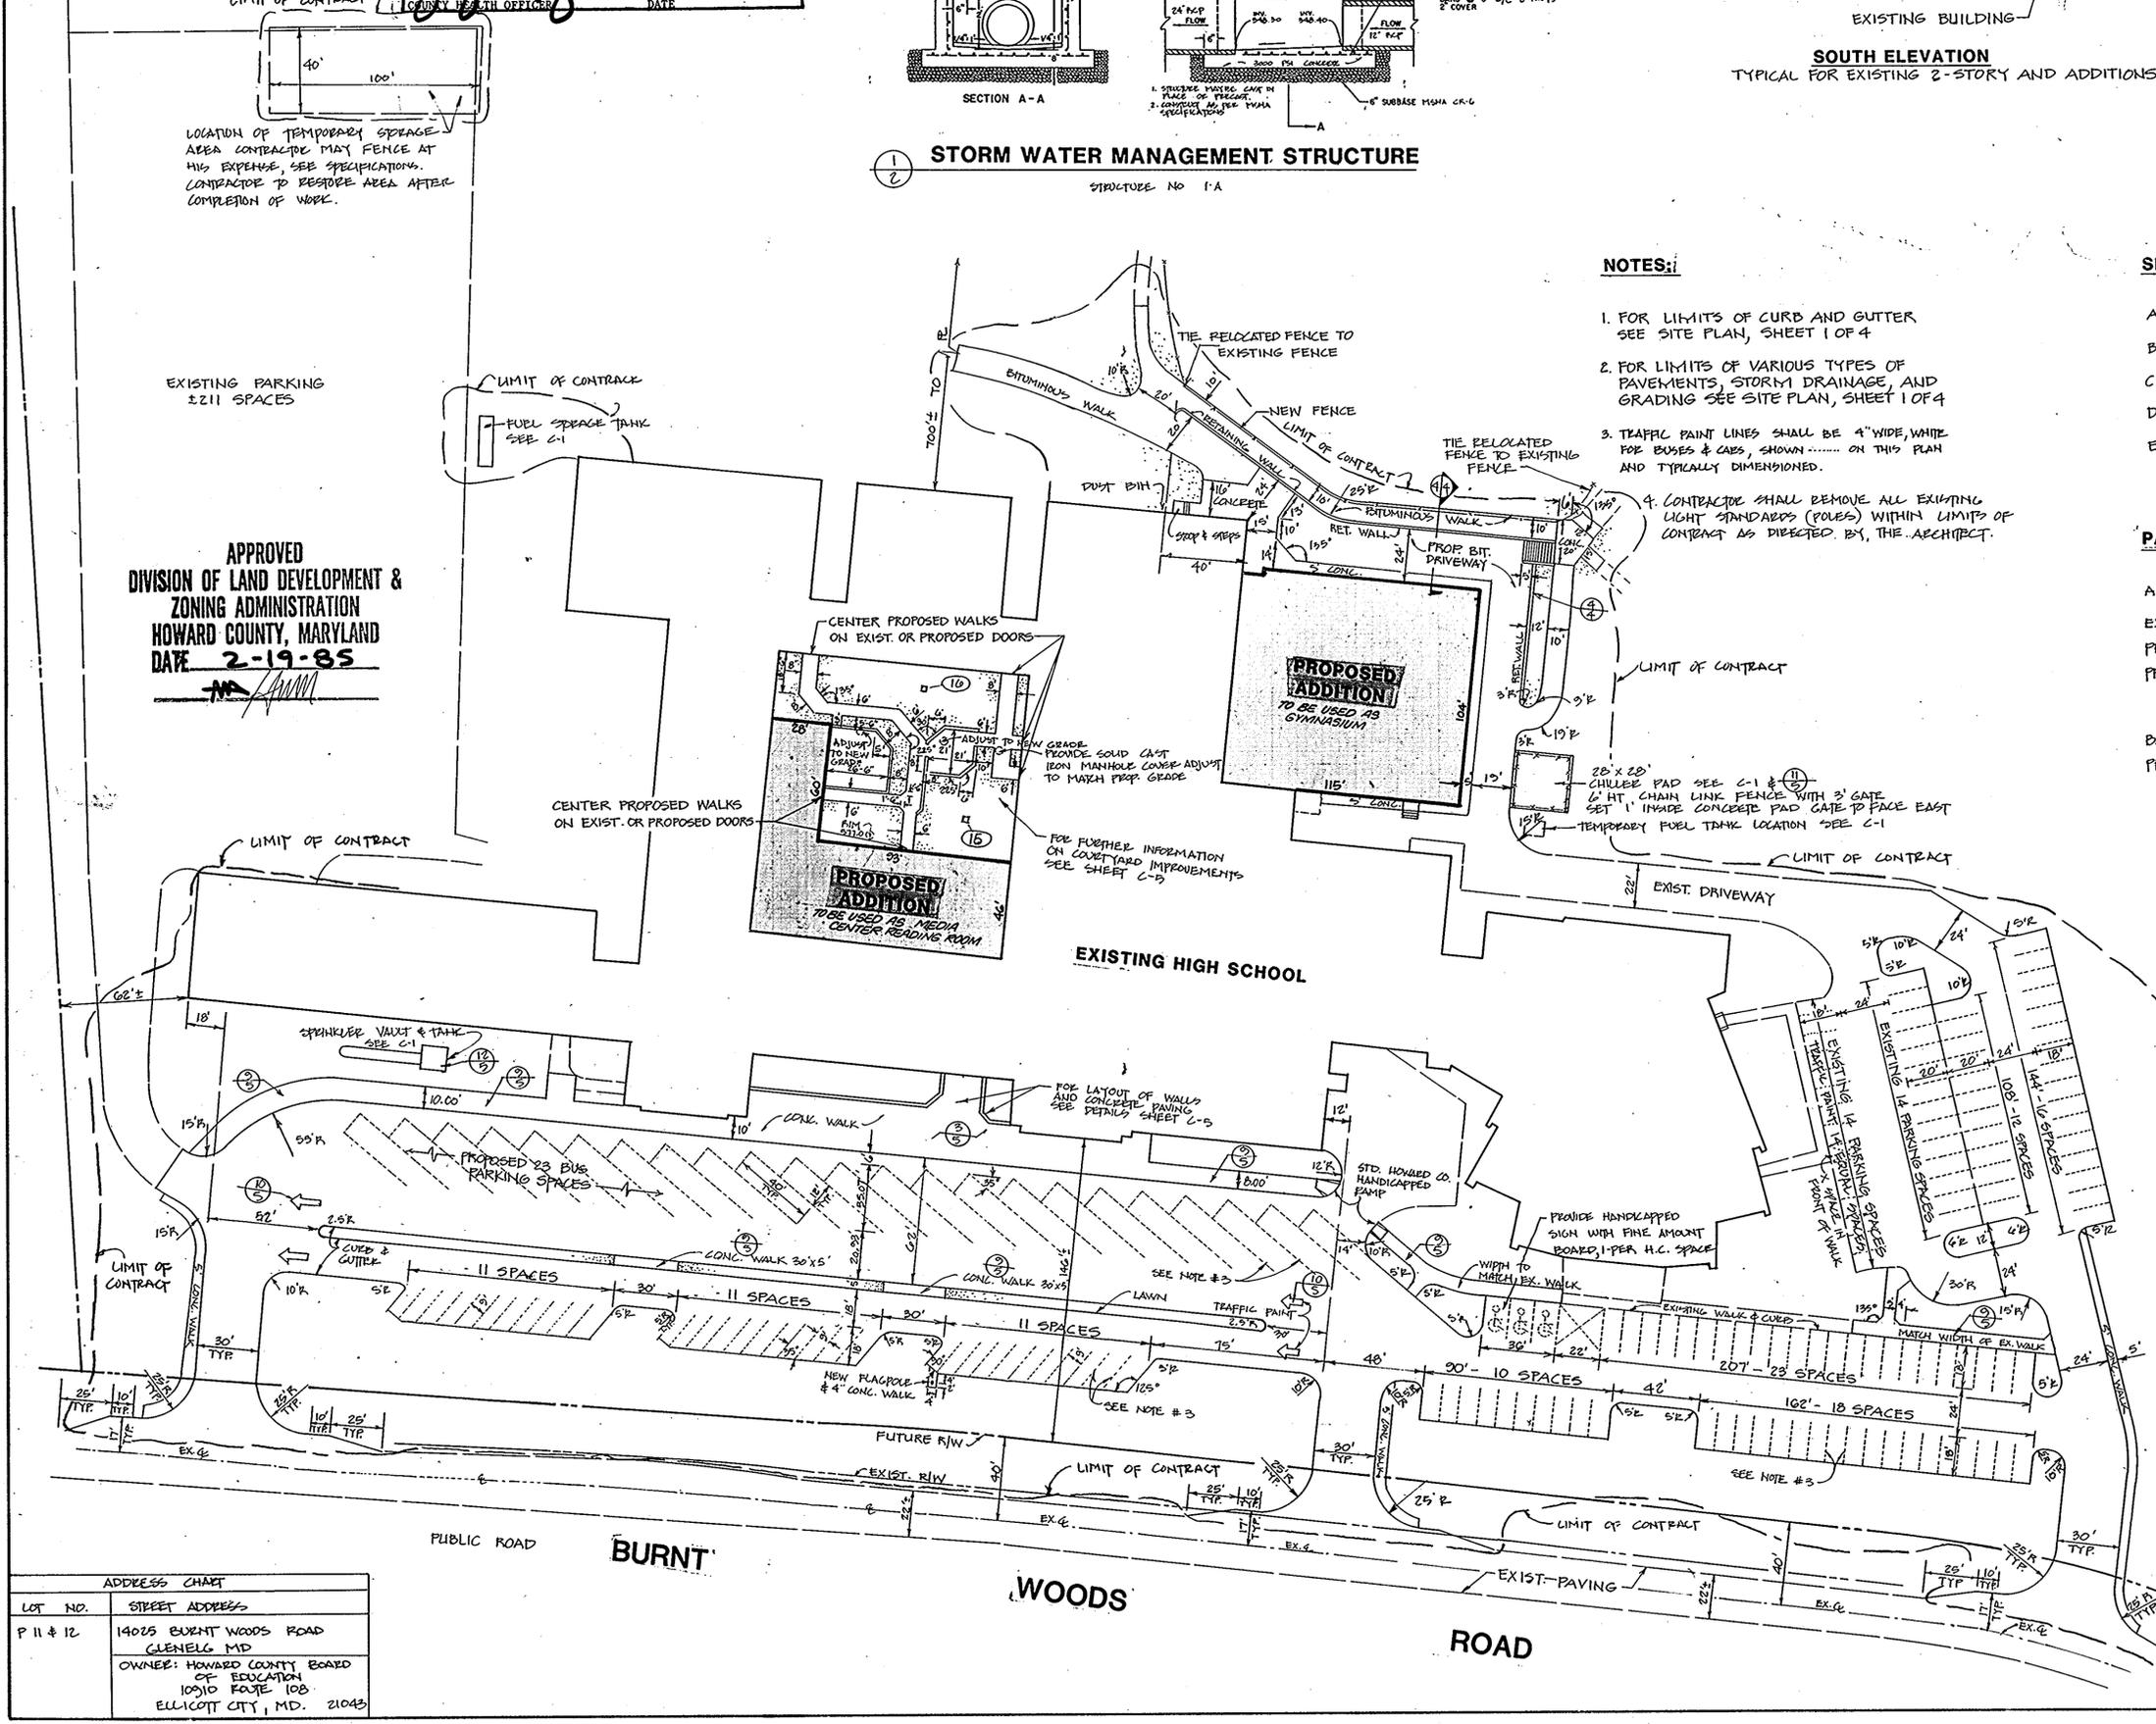

APPROVED
 DIVISION OF LAND DEVELOPMENT &
 ZONING ADMINISTRATION
 HOWARD COUNTY, MARYLAND
 DATE: 2-19-85

ADDRESS CHART

LOT NO.	STREET ADDRESS
P 11 & 12	14025 BURNT WOODS ROAD GLENELG MD
OWNER: HOWARD COUNTY BOARD OF EDUCATION 10910 FOSTE, 108 ELLCOTT CITY, MD. 21043	

SUBDIVISION NAME GLENELG HIGH SCHOOL	SECT./AREA 21	LOT/PARCEL # P11 & 12
PLAN # 21 L7 BLOCK 1	TRAVELER HWY 21	ELEC. DIST. CENSUS TR. 4 6040
PARCEL 12- 260/427	60	SEWER CODE PRIVATE
WATER CODE PRIVATE		SEWER CODE PRIVATE

PARCEL 11- BOARD OF EDUCATION, HOWARD COUNTY, MARYLAND
 PARCEL 12-
 4TH ELECTION DISTRICT, TAX MAP 21, PARCEL 11 & 12, HOWARD COUNTY,
 MARYLAND
 RECORDED IN PLAT BOOKS 465, 260, 1015, FOLIO 150, 427 & 484

LAYOUT PLAN

GLENELG HIGH SCHOOL

Project No. 84020
 Date NOV. 1984
 Scale 1"=40'

APPROVED: HOWARD COUNTY OFFICE OF PLANNING AND ZONING
 PLANNING DIRECTOR: *Howard County* DATE: 4-29-85
 CHIEF, DIVISION OF LAND DEVELOPMENT AND ZONING ADMINISTRATION DATE: 4-29-85

APPROVED: FOR PRIVATE WATER AND PRIVATE SEWERAGE SYSTEMS
 HOWARD COUNTY HEALTH DEPARTMENT
 COUNTY HEALTH OFFICER: *Howard County* DATE: 4-2-85


BY THE DEVELOPER:
 "I/We certify that all development and construction will be done according to this plan, and that any responsible personnel involved in the construction project will have a Certificate of Attendance at a Department of Natural Resources Approved Training Program for the Control of Sediment and Erosion before beginning the project."
 Signature of Developer: *Howard County* Date: 3/19/85

APPROVED: FOR STORM DRAINAGE SYSTEMS AND ROADS
 HOWARD COUNTY DEPARTMENT OF PUBLIC WORKS
 DIRECTOR: *Howard County* DATE: 4-25-85
 CHIEF, BUREAU OF ENGINEERING DATE: 4-24-85
 Reviewed for: HOWARD S.C.D. DATE: 3-21-85

BY THE ENGINEER:
 "I certify that this plan for erosion and sediment control represents a practical and workable plan based on my personal knowledge of the site conditions and that it was prepared in accordance with the requirements of the Howard Soil Conservation District."
 Signature of Engineer: *Howard County* Date: 3-19-85
 This development plan is approved for soil erosion and sediment control by the Howard Soil Conservation District.
 Signature: *Howard County* Date: 3/19/85

TEMPORARY SEEDING NOTES
 Apply to graded or cleared areas likely to be reseeded where a short-term vegetative cover is needed.
 Seeding Preparation: Loosen upper three inches of soil by raking, disking or other acceptable means before seeding.
 Soil Amendments: Apply 600 lbs per acre 10-10-10 fertilizer (14 lbs/1000 sq ft).
 Seeding: For periods March 1 thru April 30 and from August 15 thru November 15, seed with 20 lbs per acre of annual ryegrass (2.2 lbs/1000 sq ft). For the period May 1 thru August 14, seed with 3 lbs per acre of weeping lovegrass (0.7 lbs/1000 sq ft). For the period November 16 thru February 28, protect sites by applying 2 tons per acre of well aerated straw mulch and seed as soon as possible in the spring, or use sod.
 Mulching: Apply 1 1/2 to 2 tons per acre (10 to 20 lbs/1000 sq ft) of unrotted small grain straw immediately after seeding. Anchor mulch immediately after application using match anchoring tool or 2 1/2 gal per acre (5 gal/1000 sq ft) of mulchified asphalt on flat areas. On slopes, 6 ft or higher, use 3 1/2 gal per acre (8 gal/1000 sq ft) for anchoring.
 Refer to the 1993 MARYLAND STANDARDS AND SPECIFICATIONS FOR SOIL EROSION AND SEDIMENT CONTROL for rate and methods not covered.

SEDIMENT CONTROL NOTES
 1) A minimum of 24 hours notice must be given to the Howard County Office of Inspection and Permit prior to the start of any construction (932-2437).
 2) All vegetative and structural practices are to be installed according to the provisions of this plan and are to be in conformance with the 1993 MARYLAND STANDARDS AND SPECIFICATIONS FOR SOIL EROSION AND SEDIMENT CONTROL.
 3) Following initial soil disturbance or re disturbance, permanent or temporary stabilization shall be completed within 7 calendar days for all perimeter sediment control structures, dikes, perimeter slopes and all slopes greater than 3:1, 14 days as to all other disturbed or graded areas on the project site.
 4) All sediment traps/basins shall be fenced and warning signs posted around their perimeter in accordance with Vol. 1, Chapter 12, of the HOWARD COUNTY DESIGN MANUAL, Storm Drainage.
 5) All disturbed areas must be stabilized within the time period specified above in accordance with the 1993 MARYLAND STANDARDS AND SPECIFICATIONS FOR SOIL EROSION AND SEDIMENT CONTROL for permanent seedings (Sec. 51) and (Sec. 54). Temporary seeding (Sec. 50) and mulching (Sec. 52). Temporary stabilization with mulch alone can only be done when recommended seeding rates do not allow for proper germination and establishment of grasses.
 6) All sediment control structures are to remain in place and site to be maintained in operative condition until permission for their removal has been obtained from the Howard County Sediment Control Inspector.
 7) Site Analysis:
 Total Area of Site: 42.9 acres
 Area to be roofed or paved: 20 acres
 Area to be vegetatively stabilized: 22.9 acres
 Total Cut: 0.0 cu. yds.
 Office waste/borrow area location:
 8) Any sediment control practice which is disturbed by grading activity for placement of utilities must be repaired on the same day of disturbance.
 9) Additional sediment controls must be provided, if deemed necessary by the Howard County DPW sediment control inspector.



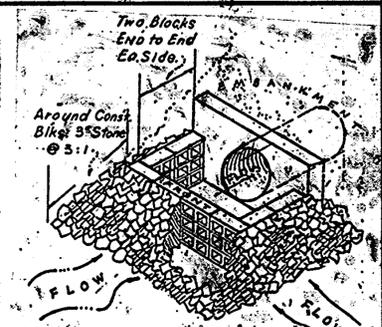


ADDRESS CHART

LOT NO.	STREET ADDRESS
P 11 & 12	14025 BURNT WOODS ROAD GLENELG, MD. OWNER: HOWARD COUNTY BOARD OF EDUCATION C/O 108 ELLICOTT CITY, MD. 21043

PROVIDE INLET PROTECTION FOR ALL S.D. INLETS


- CONSTRUCTION SEQUENCE**
1. INSTALL SEDIMENT TRAPS AND CONTROL MEASURES.
 2. INSTALL STORM DRAINAGE SYSTEM.
 3. INSTALL INLET PROTECTION.
 4. REMOVE EXISTING PAVEMENTS TO BE DEMOLISHED.
 5. CONSTRUCT BUILDING AND PAVEMENTS.
 6. STABILIZE LAWN AREAS AS SOON AS THEY ARE READY.
 7. REMOVE AND STABILIZE AREA SEDIMENT CONTROL MEASURES.

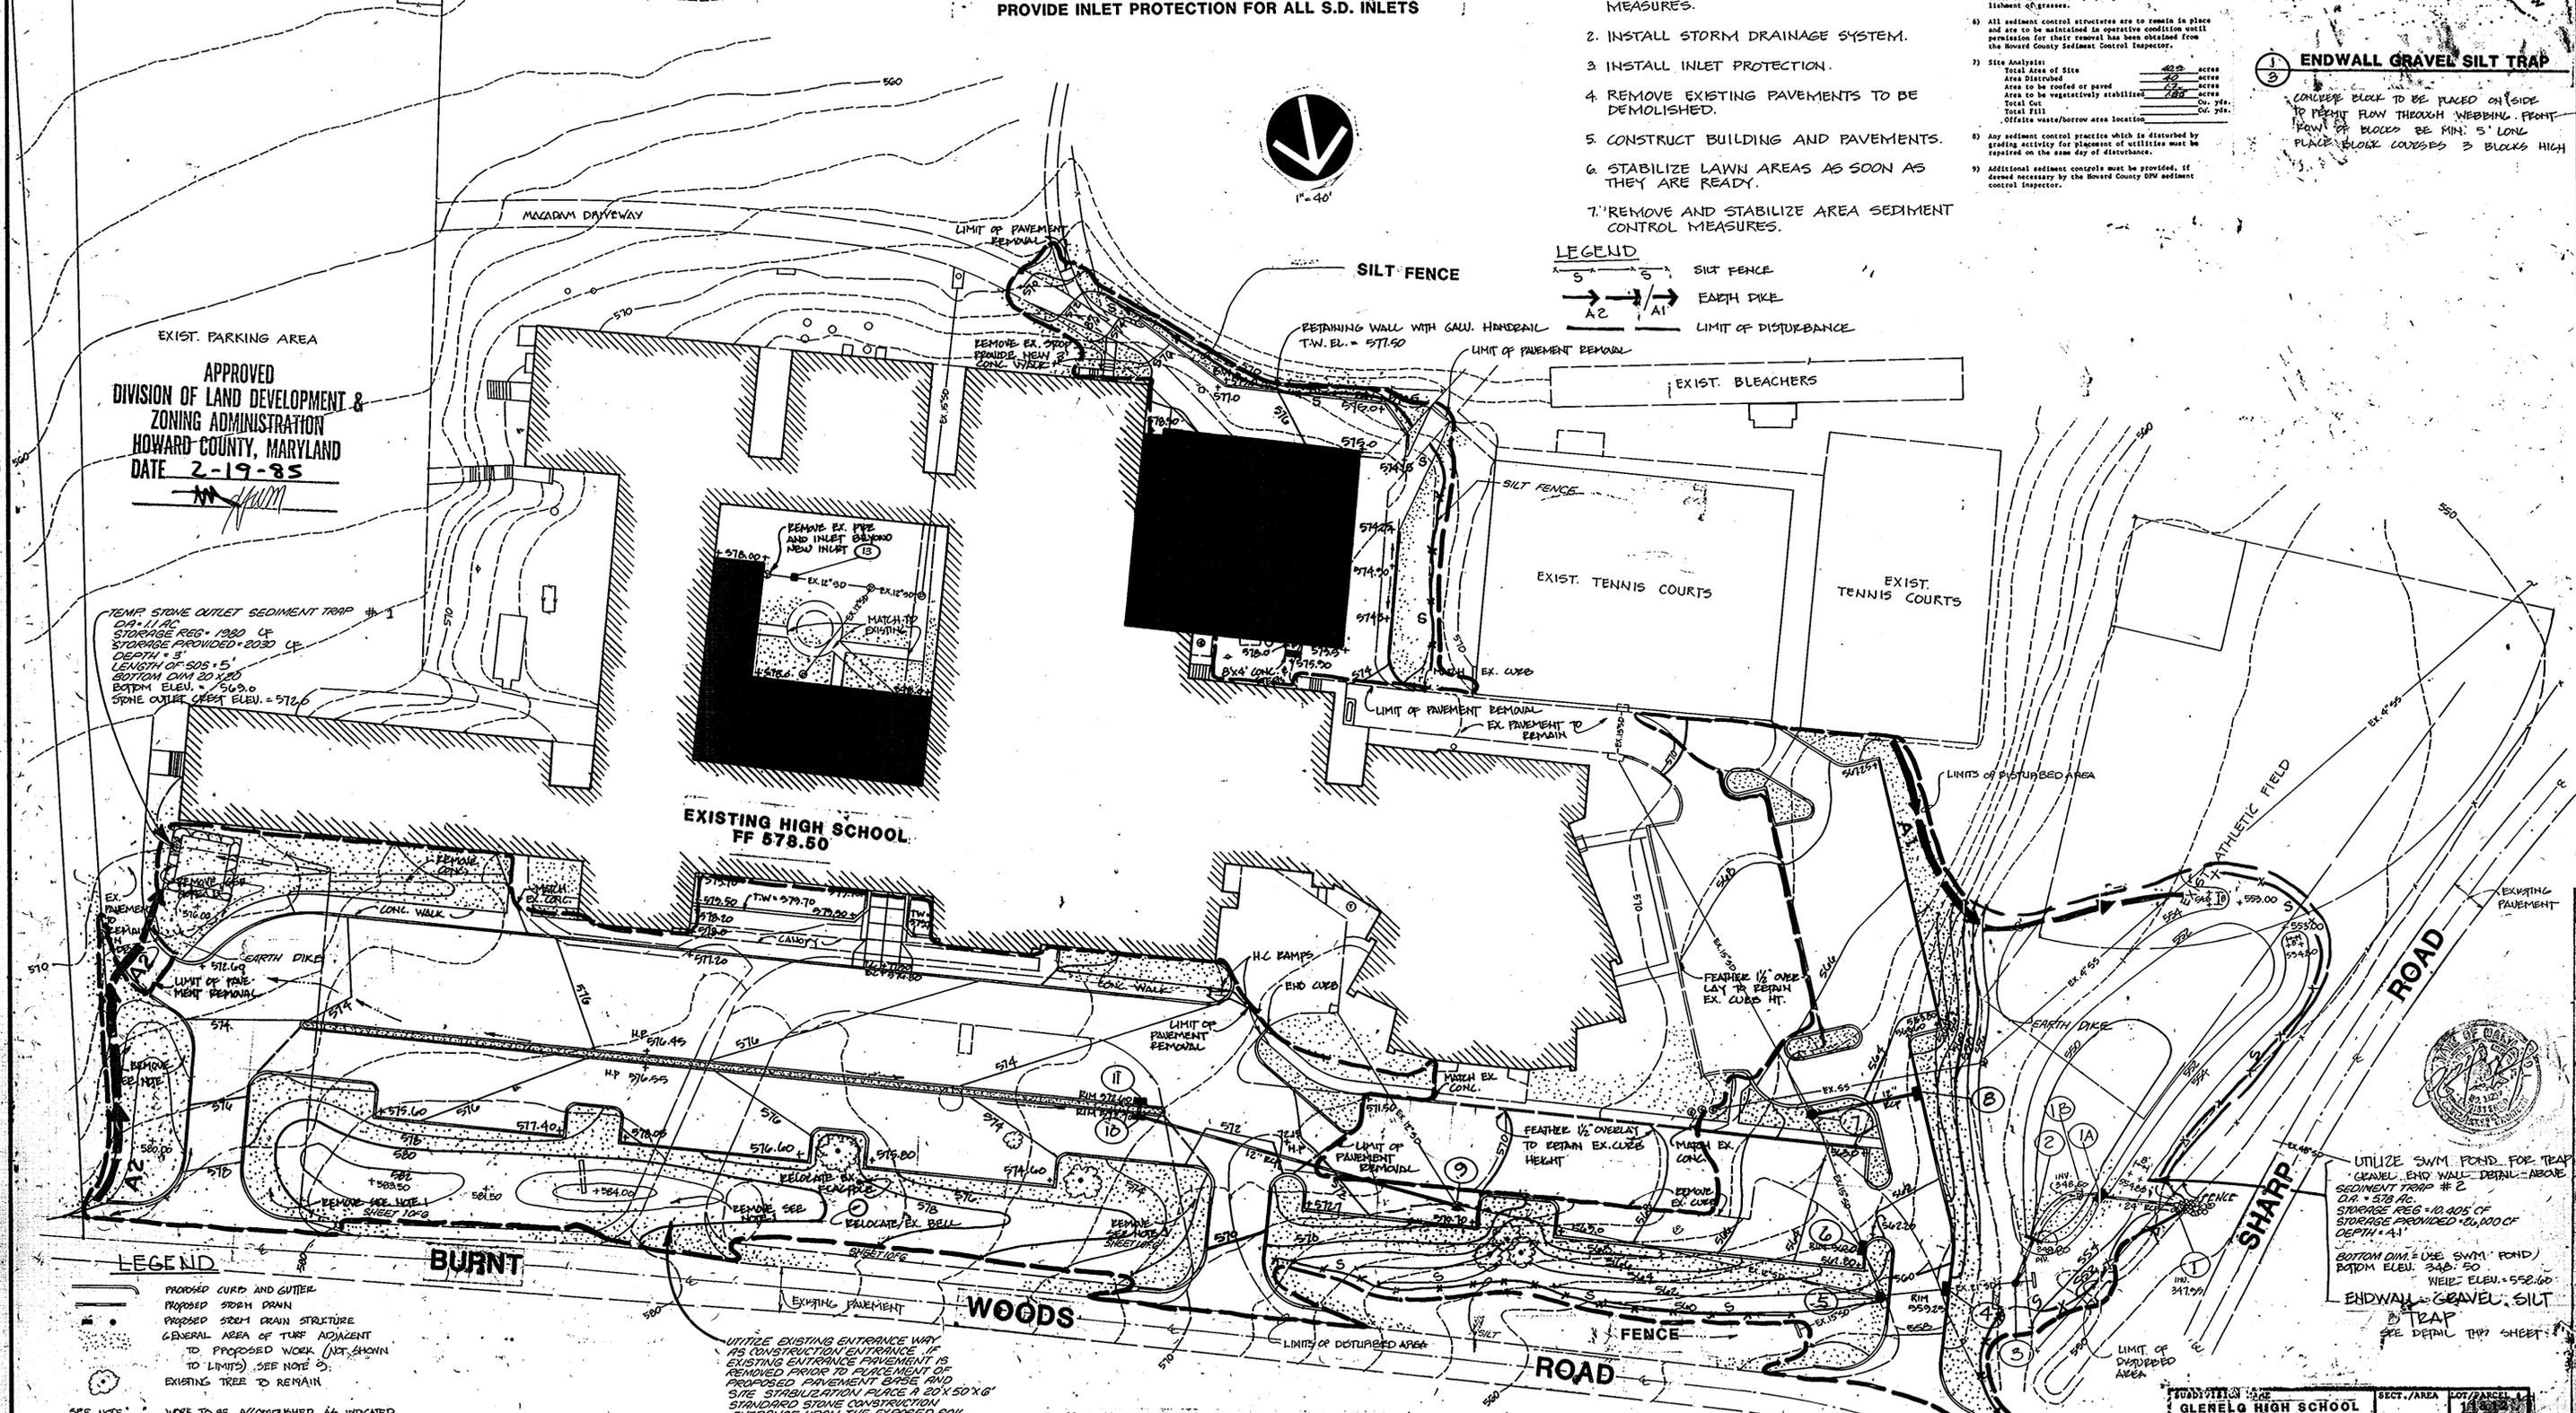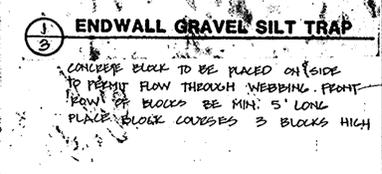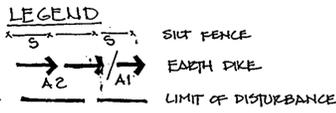

LEGEND


- PROPOSED CURB AND GUTTER
- PROPOSED STORM DRAIN
- PROPOSED SEWER DRAIN STRUCTURE
- GENERAL AREA OF TUFF ADJACENT TO PROPOSED WORK (NOT SHOWN TO LIMITS). (SEE NOTE 5).
- EXISTING TREES TO REMAIN
- SEE NOTE 1
- WORK TO BE ACCOMPLISHED AS INDICATED IN REFERENCED NOTE AND GENERAL LOCATION ON PLAN

THIS PLAN FOR SEDIMENT CONTROL ONLY.
 SEE SHEET 1 of 4 and 2 of 4

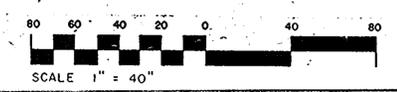


SUBDIVISION NAME		SECT./AREA		LOT/PARCEL	
GLENELG HIGH SCHOOL		21		14040	
PLAN TYPED BY	DATE	SCALE	NO.	ELEV. DIFF. CONS. TO	
269/427	6	R	21	4.7	14040
WATER CODE	PRIVATE	SEWER CODE	PRIVATE		

SEDIMENT CONTROL PLAN
 GLENELG HIGH SCHOOL
 PROJECT NO. 84000
 SHEET NO. 3 OF 5
 SDP-85-105

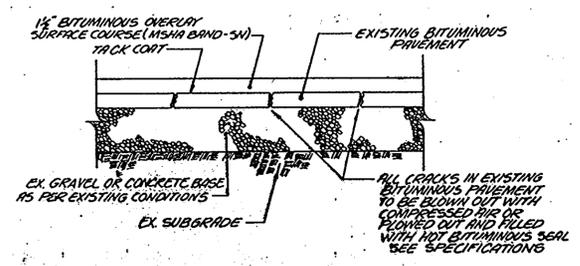


1 1/2" OVERLAY SURFACE DETAIL

NO SCALE
DESIGNATED AS [Symbol] ON THE SITE PLAN

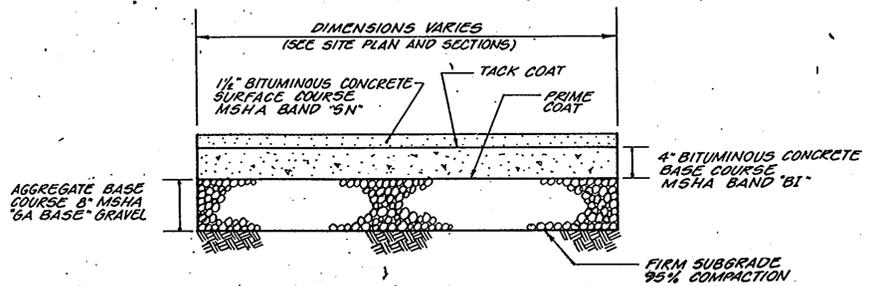

HEAVY DUTY PAVEMENT

NO SCALE

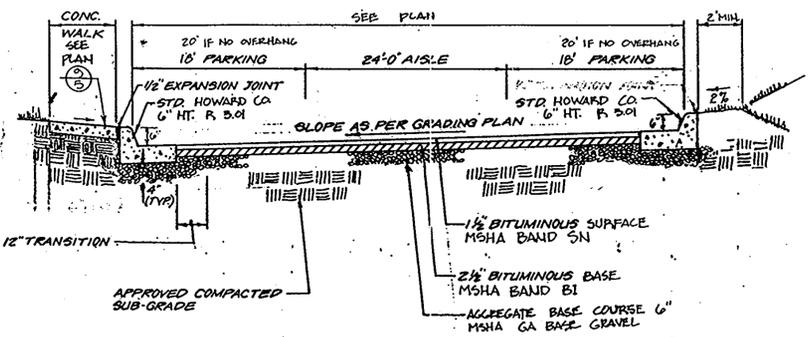


LIGHT DUTY PAVEMENT


NO SCALE
DESIGNATED AS [Symbol] ON THE SITE PLAN

STRUCTURE SCHEDULE


NO.	TYPE DETAIL	ELEVATION	REMARKS
1	HOWARD CO. SD 5.51 - 24'D	INV. 347.95	
2	HOWARD CO. G 5.51 - 21'D	INV. 348.80	
3	HOWARD CO. G 5.01	INV. EX. 349.0	
4	HOWARD CO. SD 4.32	INV. EX. PIPE	
5	MODIFY EXISTING, SEE NOTE 14	EX.	
6	HOWARD CO. SD 4.32	INV. EX. PIPE	
7	MODIFY EXISTING, SEE NOTE 14	EX.	
8	HOWARD CO. SD 4.32	INV. 561.5	
9	MODIFY EXISTING, SEE NOTE 13	EX.	
10	HOWARD CO. SD 4.32	INV. 568.15	
11	HOWARD CO. SD 4.32	INV. 567.50	
12	EXISTING	EX. PIPE	
13	EXISTING	EX.	
14	EXISTING	EX.	
15	HOWARD CO. SD. 4.22	MIN. 12" COVER	MIN. PIPE SLOPE 1%
16	HOWARD CO. SD. 4.22	MIN. 12" COVER	MIN. PIPE SLOPE 1%
17	HOWARD CO. SD. 4.22	MIN. 12" COVER	MIN. PIPE SLOPE 1%
18	SEE DETAIL SHEET 2 OF 3	INV. IN 348.40	SWM CONTROL STR.
19	HOWARD CO. SD. 5.51 - 12"	INV. 348.50	

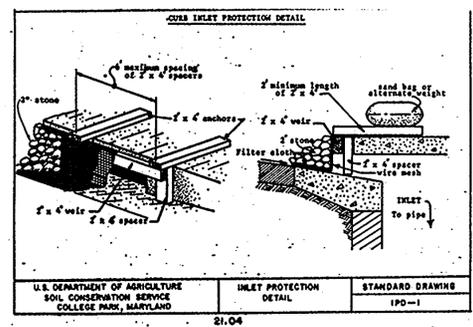

CULVERT INLET PROTECTION DETAIL

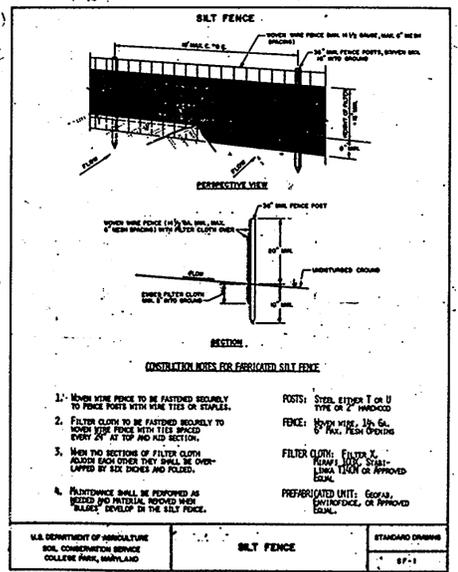


SILT FENCE

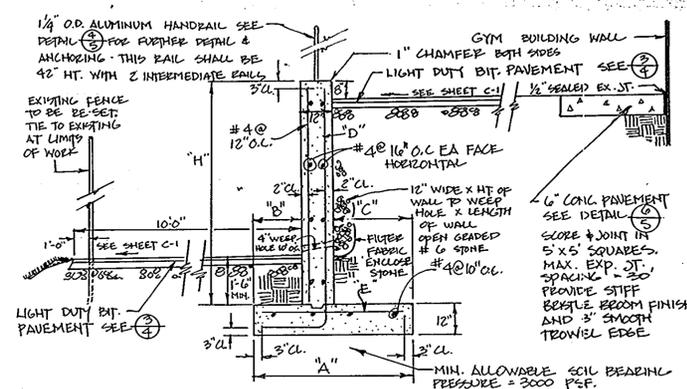


"H"	"A"	"B"	"C"	"D"	"E"
4'-0"	3'-3"	0'-9"	1'-6"	#4@12"O.C.	#4@12"O.C.
6'-0"	4'-6"	1'-3"	2'-3"	#4@12"O.C.	#4@12"O.C.
8'-0"	6'-0"	1'-9"	3'-3"	#4@9"O.C.	#4@12"O.C.
10'-0"	7'-6"	2'-3"	4'-3"	#5@6"O.C.	#5@12"O.C.


RETAINING WALL

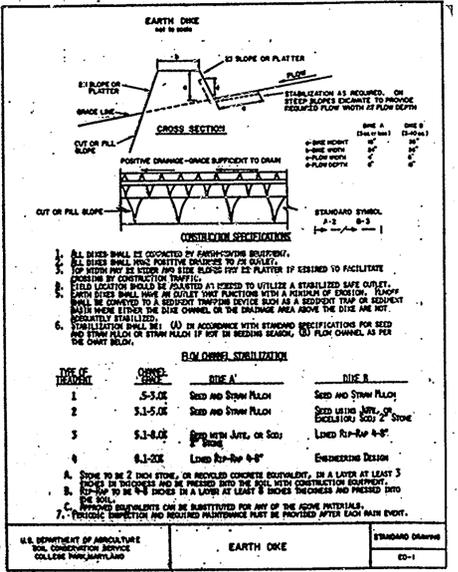

EARTH DIKE

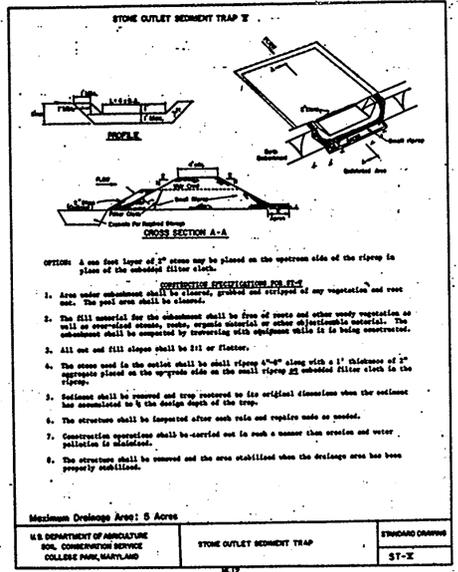

STONE OUTLET TRAP

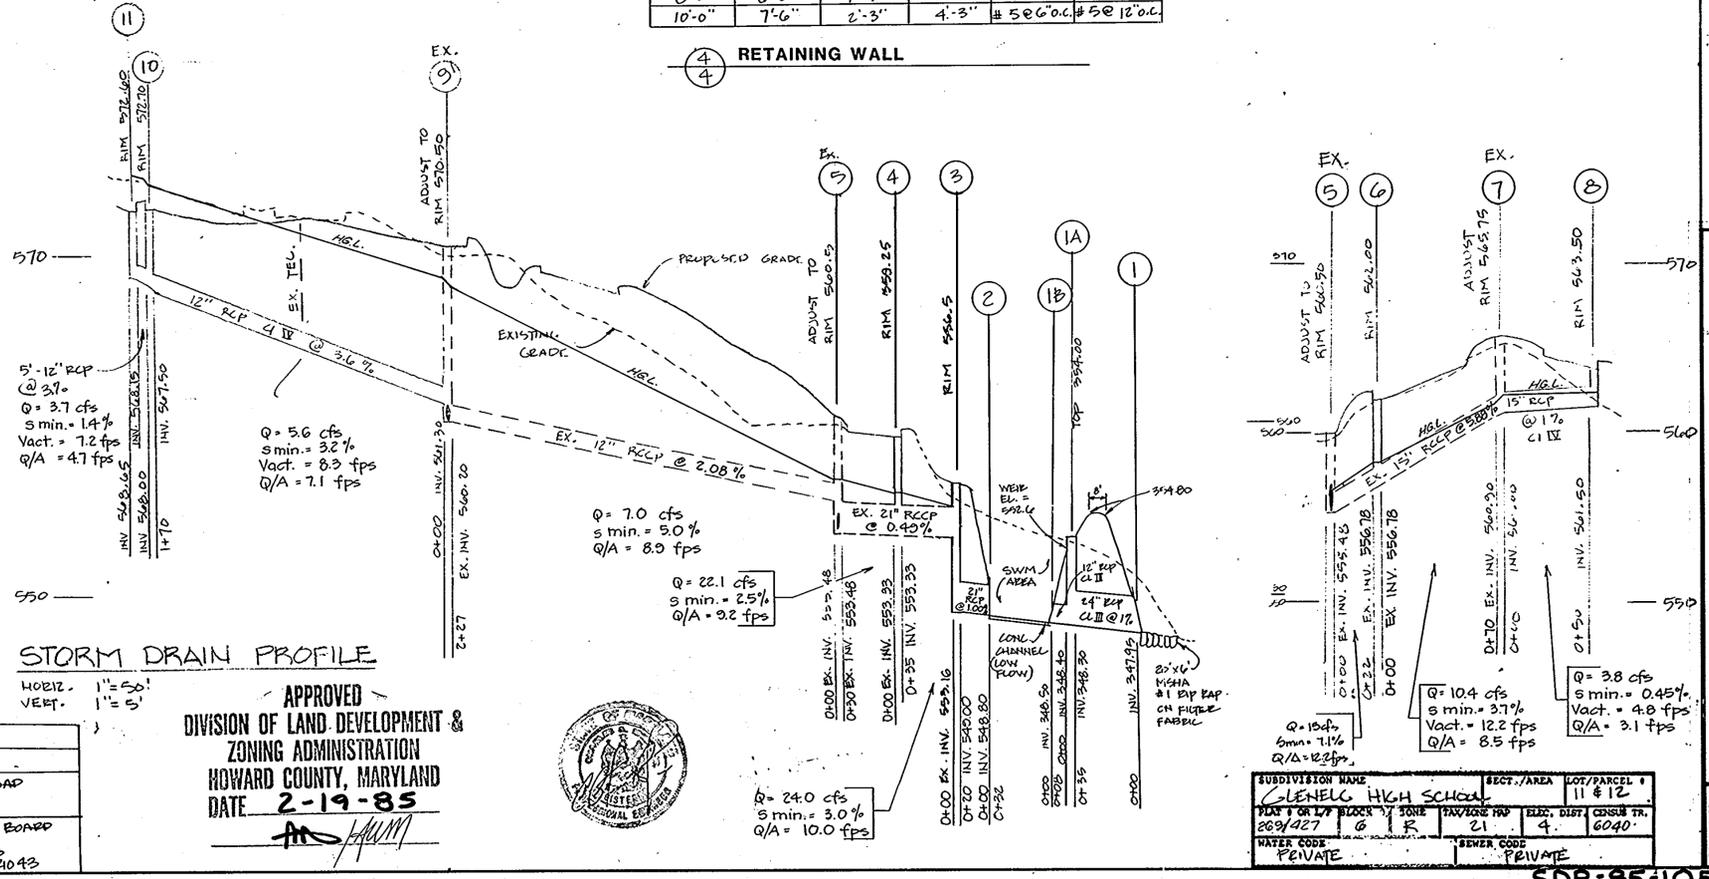

STORM DRAIN PROFILE

APPROVED ZONING ADMINISTRATION
HOWARD COUNTY, MARYLAND
DATE 2-19-85

APPROVED FOR STORM DRAINAGE SYSTEMS AND ROADS.
HOWARD COUNTY DEPARTMENT OF PUBLIC WORKS
Director: [Signature] DATE 4-25-85

APPROVED: HOWARD COUNTY OFFICE OF PLANNING AND ZONING
Planning Director: [Signature] DATE 4-29-85

APPROVED: FOR PRIVATE WATER AND PRIVATE SEWERAGE SYSTEMS
HOWARD COUNTY HEALTH DEPARTMENT
County Health Officer: [Signature] DATE 4-2-85

LOT NO.	STREET ADDRESS
P11 & 12	14025 EVENT WOODS ROAD GLENELG MD.
	OWNER: HOWARD COUNTY BOARD OF EDUCATION 10310 ROUTE 102 ELLICOTT CITY MD. 21043




SUBDIVISION NAME	SECT./AREA	LOT/PARCEL #
GLENELG HIGH SCHOOL		11 & 12
PLAN 1 OR LOT BLOCK / STONE	UNDIVIDED INV.	ELEC. DIST. CHSUS TR.
289/427	G R	21 4 6040
WATER CODE	SEWER CODE	
PRIVATE	PRIVATE	

APPROVED: FOR STORM DRAINAGE SYSTEMS AND ROADS.
 HOWARD COUNTY DEPARTMENT OF PUBLIC WORKS
 DATE: 4-25-85
 DIRECTOR: [Signature]

APPROVED: HOWARD COUNTY OFFICE OF PLANNING AND ZONING
 PLANNING DIRECTOR: [Signature]
 DATE: 4-29-85


APPROVED: FOR PRIVATE WATER AND PRIVATE SEWERAGE SYSTEMS
 HOWARD COUNTY HEALTH DEPARTMENT
 DATE: 4-28-85
 HEALTH OFFICER: [Signature]

APPROVED
 DIVISION OF LAND DEVELOPMENT &
 ZONING ADMINISTRATION
 HOWARD COUNTY, MARYLAND
 DATE: 2-19-85

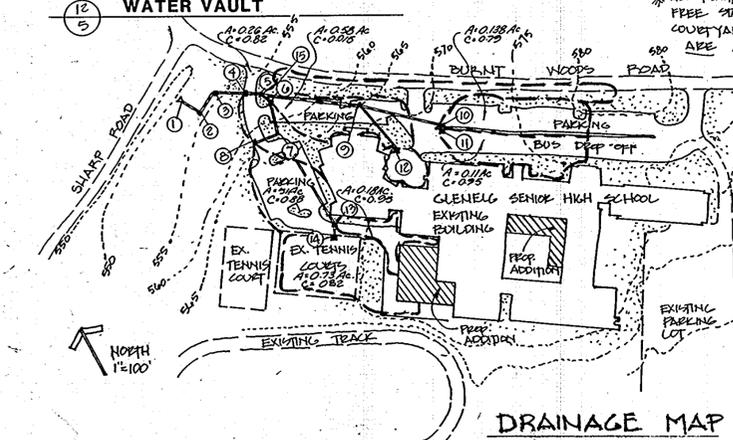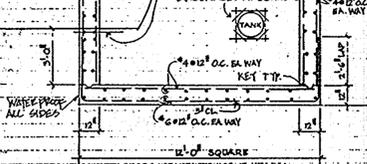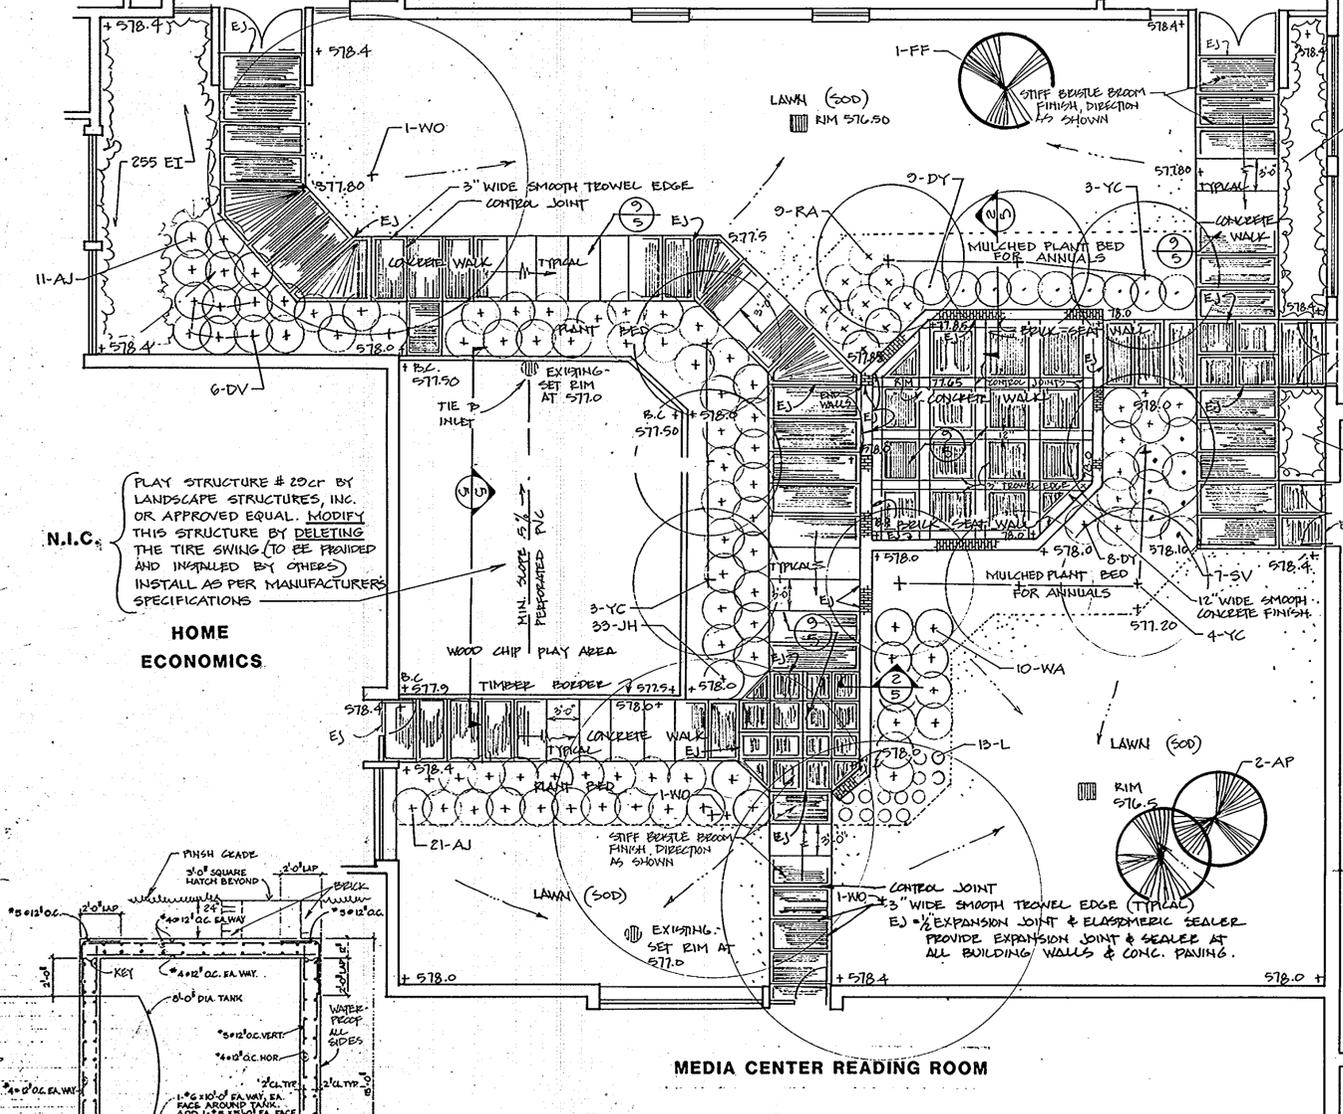

ADDRESS CHART


LOT NO.	STREET ADDRESS
P11 & 12	4005 EXHIBIT WOODS ROAD GLENELG, MD.
	OWNER: HOWARD COUNTY BOARD OF EDUCATION 10010 ROUTE 100 ELLICOTT CITY, MD. 21043

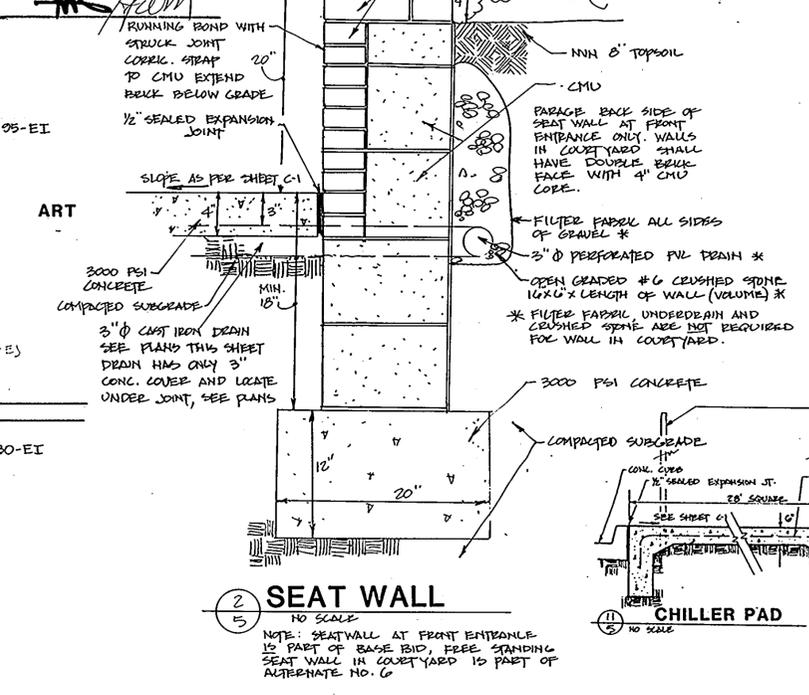




GYMNASIUM PLANT LIST SEE SPECIFICATIONS FOR PLANTING DETAILS

KEY	QUAN.	BOTANICAL NAME	COMMON NAME	SIZE	REMARKS
WB	2	Betula Alba	European White Birch	10'-12'	B&B, 3 stems
WO	3	Quercus Phellos	Willow Oak	2 1/2"-3" cal.	B&B
FF	1	Abies Fraseri	Fraser Fir	8'-10'	B&B
AP	2	Pinus Nigra	Austrian Pine	8'-10'	B&B
YC	10	Prunus Yedoensis	Yoshino Cherry	8'-9'	B&B
AR	9	Azalea Red	Hershey Azalea	30"-36"	cont
AW	45	Azalea White	Helen Curtis Azalea-Dwarf	12"-15"	cont
JH	33	Ilex Crenata Convexa	Convexleaf Japanese Holly	30"-36"	B&B
AJ	32	Juniperus Horizontalis	Andorra Juniper	30"-36"	B&B
SEY	29	Taxus Baccata Repandens	Spreading English Yew	18"-24"	B&B
DY	17	Taxus Cuspidata "Densiflora"	Dense Japanese Yew	24"-30"	B&B
SV	7	Viburnum Carlesii	Spice Viburnum	30"-36"	B&B
DV	6	Viburnum Plicatum "Tomentosum Martesii"	Maries Doublefile Viburnum	3'-4'	B&B
EI	380	Hedera Helix	English Ivy	2 1/2" Pots	2" O.C.
L	13	Liriope Muscari "Variegata"	Variegated Liriope	2 1/2" Pots	contain.
P	1260	Pachysandra Terminalis	Japanese Spurge	2 1/2" Pots	2" O.C.

ALL PLANT MATERIAL ON PLANT LIST ARE PART OF ALTERNATE NO. 6

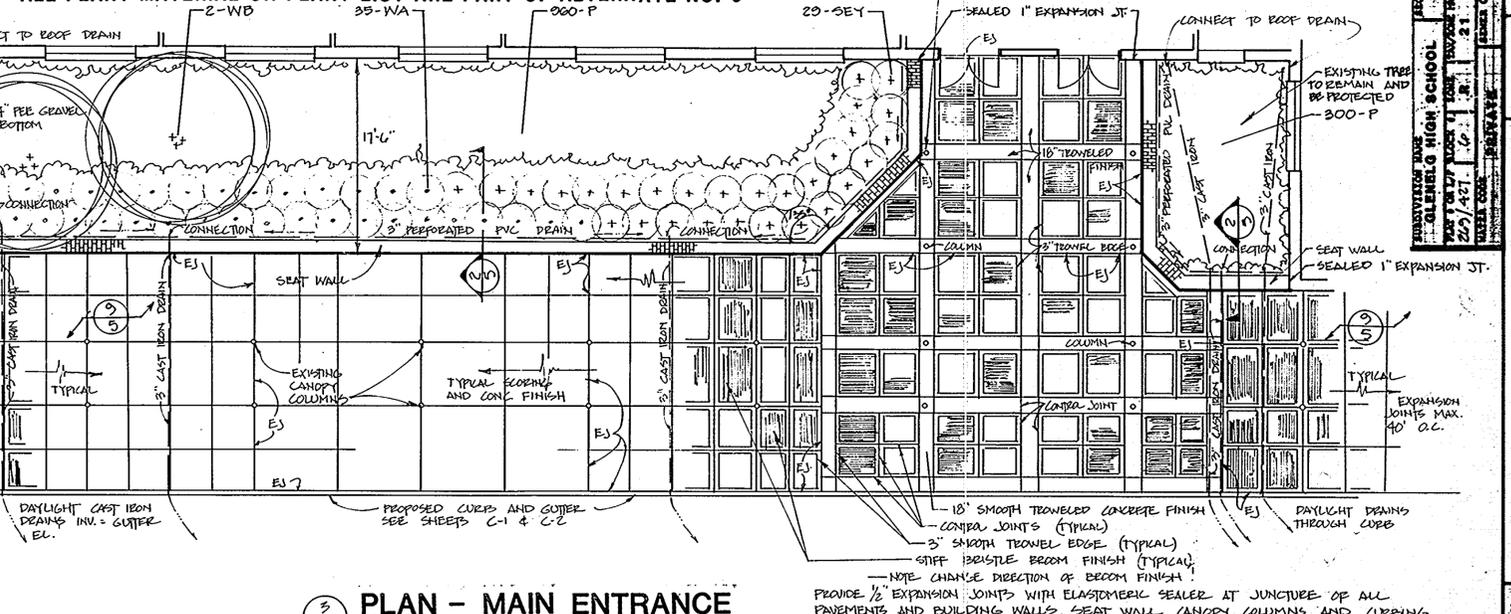

NOTE: PROVIDE 1/2" EXPANSION JOINTS WITH ELASTOMERIC SEALER AT JUNCTURE OF ALL PAVEMENTS AND BUILDING WALLS, SEAT WALL, CANOPY COLUMNS AND CURBING AND AS INDICATED BY SYMBOL "EJ" IN PLANS ALL OTHER JOINTS 1/2" DEEP x 1/4" WIDE.

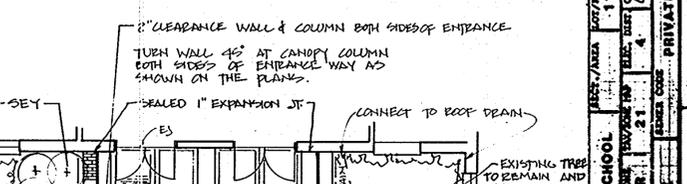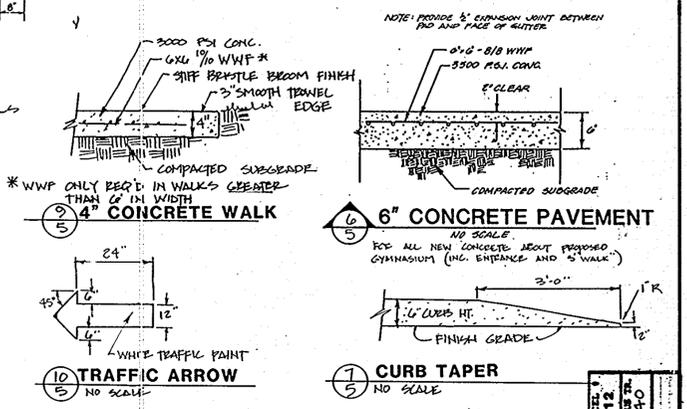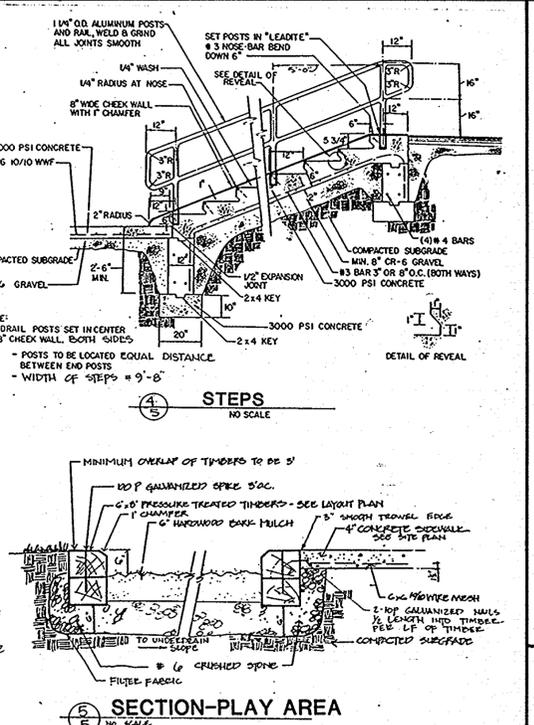

DETAILS
 GLENELG HIGH SCHOOL
 Project No. 84100
 Date 12-30-84
 Scale 1/8" = 1'-0"
 SHEET NO. 5 OF 5
 SDP-85-105