



PROPOSED BUILDING ELEVATION (WEST)

SCALE - 1/16"-1"

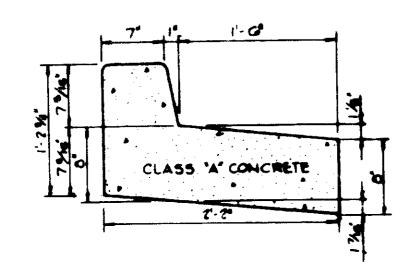


REVERSE 7" COMBINATION CURB AND GUTTER

NO SCALE

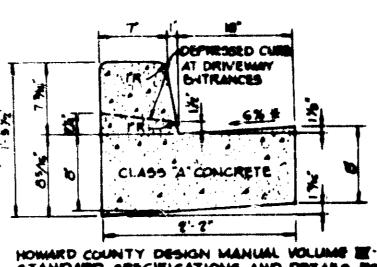



HOWARD COUNTY DESIGN MANUAL VOLUME TO STANDARD SPECIFICATIONS AND DETAILS FOR CONSTRUCTION (DRAWING R-EOI) ARTERIALS OR THE HIGH SIDE OF SUPERELEVATED SECTIONS SHALL BE SLOPED AT THE SAME RATE AS THE PAVEMENT.

STANDARD 7" COMBINATION CURB AND GUTTER

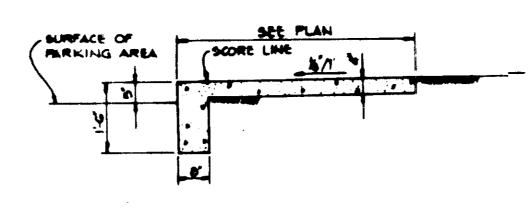

SIDEWALK W/INTEGRAL CURB NO SCALE

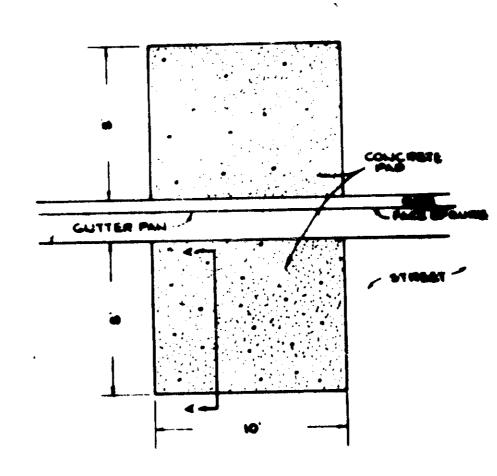

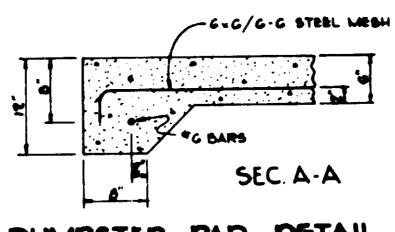


DUMPSTER PAD DETAIL




COLORS

LEGEND AND BORDER-GREEN
WHITE SYMBOLS ON BLUE BACKGROUND
BACKGROUND - WHITE

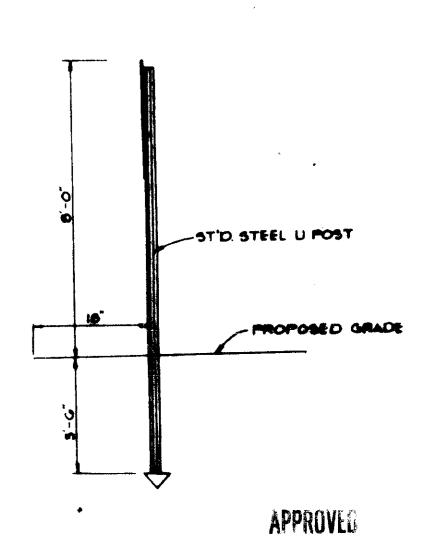

DIVISION OF LAND DEVELOPMENT ZONING ADMINISTRA HOWARD COUNTY, MARY DATE 3-15-83

THE SUM

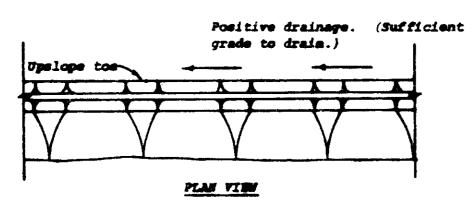

CHOSE SECTION

Construction Specifications

- 1. All dikes shall be machine compacted. 2. All perimeter dikes shall have positive drainage to as outlet. 3. A. Miverted runoff from a protected or stabilised upland area shall
- outlet directly onto an undisturbed stabilised area or into a level spreader or grade stabilisation structure. B. Biverted runoff from a disturbed or exposed upland area shall be conveyed to a sediment trapping device such as sediment trap or a sediment besin or to an area protected by any of those
- practices. 4. Stabilization, when required, shall be done in accordance with Standard and Specifications for Grassed Waterway. The minimum area to be stabilized shall be the channel flow area.

5. Periodic inspection and required maintenance shall be provided.


Standard Symbol

⇒ Drainage area less than 5 acres

PERIMETER DIKE

NO SCALE

NO SCALE

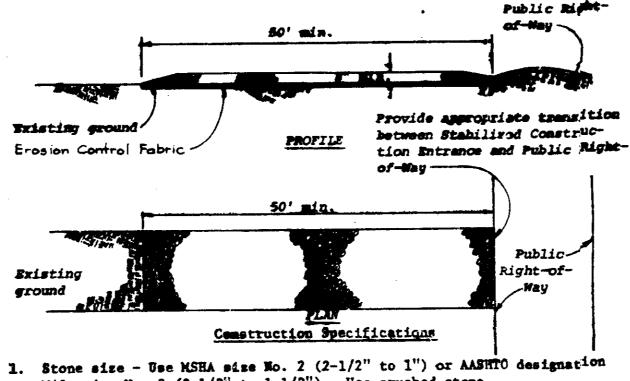

M43, size No. 2 $(2-1/2^n)$ to $1-1/2^n$). Use crushed stone.

2. Length - As effective, but not less than 50 feet. 3. Thickness - Not less than eight (8) inches.

4. Width - Not less than full width of all points of ingress or egress. 5. Washing - When necessary, wheels shall be cleaned to remove sediment prior to entrance onto public right-of-way. When washing is required, it shall be done on an area stabilized with crushed stone which drains into an approved sediment trap or sediment basin. All sediment shall be prevented from entering any storm drain, ditch, or watercourse through use of sand bags, gravel, boards or other approved methods.

6. Maintenance - The entrance shall be maintained in a condition which will prevent tracking or flowing of sediment onto public rights-of-way: This may require periodic top dressing with additional stone as comditions demand and repair and/or cleanout of any measures used to trep sediment. All sediment spilled, dropped, washed or tracked onto public rights-of-way must be removed immediately.

Standard Symbol

STABILIZED CONSTRUCTION ENTRANCE NO SCALE

HANDICAP SIGN DETAIL BITUMINOUS CONCRETE SURFACE BITUMINOUS CONCRETE BASE # 6' CRUSHER RUN BASE COURSE (2 COURSES) G" DENSE GRADED STABILIZED AGGREGATE BASE COURSE (ALTERNATE) BITUMINOUS CONCRETE SURFACE

DITUMINOUS CONCRETE SASE

TION WILL BE DONE ACCORDING TO THIS PLAN, AND THE

ATTENDANCE AT A DEPARTMENT OF NATURAL RESOURCES

I CERTIFY THAT THIS PLAN FOR EROSION AND SEPTIME

CONTROL REPRESENTS A PRACTICAL AND WORKARLE PLAN

BASED ON MY PERSONAL KNOWLEDGE OF THE SITE COME

TIONS AND THAT IT WAS PREPARED IN ACCOMMAND WITH THE REQUIREMENTS OF THE HOMAND SOIL COMMENTED IN

MIE

ANY RESPONSIBLE PERSONNEL INVOLVED IN THE COM-

STRUCTION PROJECT WILL HAVE A CERTIFICATE OF

HOWARD COUNTY DESIGN MANUAL YOUME 以-STANDARD SPECIFICATIONS AND DETAILS FOR CONSTRUCTION (DRAWING R. 2.01)

(G"PAVING, P-2)

ON THE DOVOLOPER:

BY THE ENGINEER

Thelma J. Lyman

DEVELOPER: THELMA J. LYMAN

Sichun E. Mugg

ENGINEER: ARTHUR E. MUEGGE

FOR PUBLIC WATER AND PUBLIC SEWERAGE SYSTEMS, HOWARD COUNTY HEALTH DEMART-COUNTY HEALTH OF ICER DATE CHIEF, DIVISION OF LAND DEVELOPMENT AND ZONING ADMINISTRATION APPROVED: FOR PUBLIC WATER, PUBLIC SEWERAGE,

STORM DRAINAGE SYSTEMS AND PUBLIC

HOWARD COUNTY DEPARTMENT OF PUBLIC WORKS

DATE DIRECTOR

I/WE CERTIFY THAT ALL DEVELOPMENT AND COMSTRUCT DATE NO OWNER ROUTE 40 MANAGEMENT APPROVED TRAINING PROGRAM FOR THE CONTROL OF MENT AND EROSION BEFORE BEGINNING THE PROJECT. % RHETT REALTY

10194 BALTIMORE NATIONAL PIKE ELLICOTT CITY, MARYLAND 21043

PROJECT: CHRISTIAN WOMEN'S THRIFT SHOP TAX MAP 24 PARCEL II AND PT.OF PARCEL IO PARCEL E PINE ORCHARD PARK

SEE RECORDED PLAT C.M.P. NO.5032 2" ELECTION DIST. HOWARD COUNTY, MARYLAND

REVISION

DETAILS RIEMER AND ASSOCIATES - 8659 Baltimore National Ръс Ellicott Circ. Mary and 1, 1, 4% 13. 1. 4FT 2690

Land Planning Chisigh & Civil Freshletism 3.17.83 DATE


DESIGNED BY: A.E.M. DRAWN BY GRB.

PROJECT NO 4582 DATE JAN. 19, 1983 SCALE AS SHOWN DRAWING NO. 3 OF 5 PROFESSIONAL ENGR. NO. 8101

INTEGRAL CURB STD T"COMB . CURB & GUTTER HANDICAPPED RAMP

REVIEWED FOR HOWARD AND MEETS TECHNICAL REQUIREMENTS of Cones Al Letin 3-21-83 501L CONSERVATION SERVICE THIS, DEVELOPMENT PLAN IS APPROVED FOR SOIL EROSION AND SEDIMENT CONTROL BY THE HOWARD SOIL COMMENTAL TION DISTRICT 3-21-83 DATE HOMARD 5.C. D.

SDP-83-87

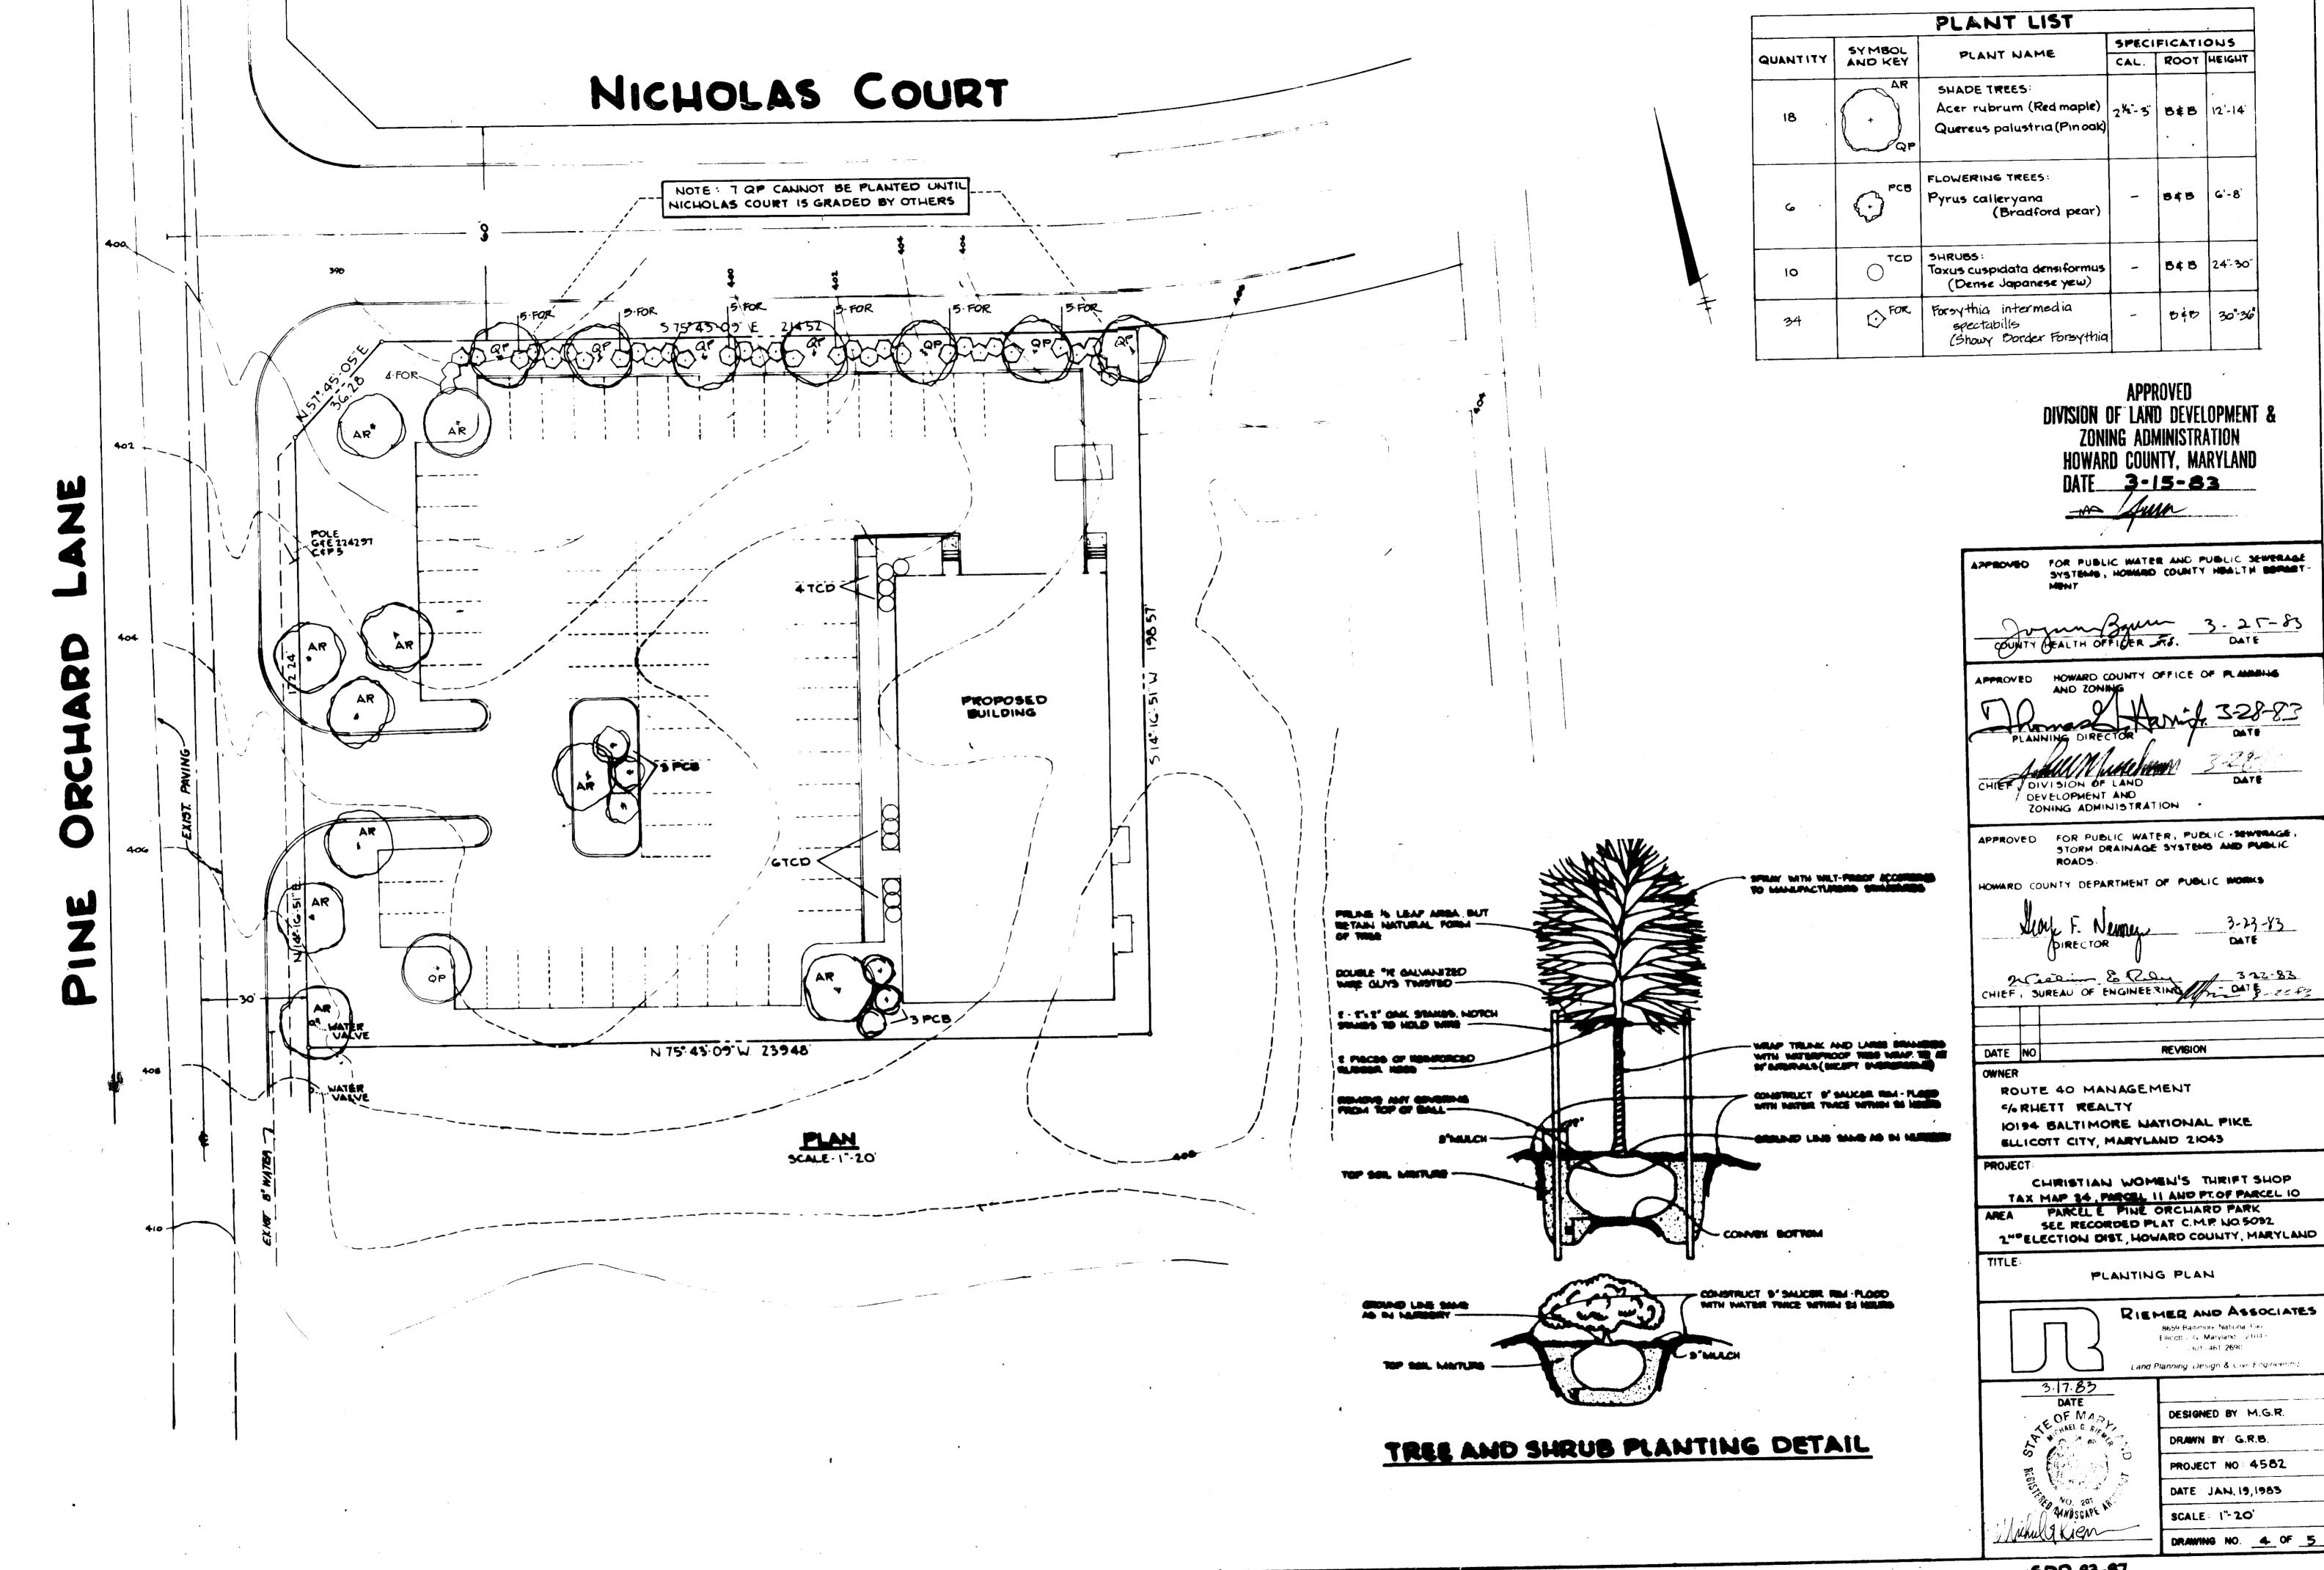

SDP-83-87

SED_MEN! CONTROL CONSTRUCTION NOTES GENERAL NOTES

- A MINIMUM OF 24 HOURS NOTICE MUST BE GIVEN TO THE HOWARD COUNTY OFFICE OF INSPECTION AND PERMITS PRIOR TO THE START OF ANY CONSTRUCTION (922-2070).
- 2. ALL SEDIMENT CONTROL STRUCTURES WILL BE INSTALLED IN ACCORDANCE WITH "THE STANDARDS AND SPECIFICATIONS FOR SOIL EROSION AND SEDIMENT CONTROL IN DEVELOPING AREAS" AS PREPARED BY THE U.S. DEPARTMENT OF AGRICULTURE SOIL CONSERVATION SERVICE.
- 3. SITE GRADING WILL BEGIN ONLY AFTER ALL PERIMETER SEDIMENT CONTROL MEASURES HAVE BEEN INSTALLED AND ARE IN A FUNCTIONING CONDITION.
- ALL DISTURBED AREAS ARE TO BE DRESSED AND STABILIZED ACCORDING TO THE TEMPORARY OR PERMANENT SEEDING SCHEDULES AS SOON AS PROPER WEATHER CONDITIONS EXIST FOR THE ESTABLISHMENT OF A PERMANENT VEGETATIVE COVER.
- 5. SEDIMENT WILL BE REMOVED FROM TRAPS WHEN THE DEPTH REACHES THE CLEAN OUT ELEVATION SHOWN ON THE PLANS.
- 6. FERTILIZER AND LIME RATES MAY BE CHANGED THROUGH AUTHORIZATION BY THE HOWARD SOIL CONSERVATION DISTRICT IF SOIL TESTS DETERMINE A REDUCTION IN THE SPECIFIED RATES IS JUSTIFIED.
- 7. ALL SEDIMENT CONTROL STRUCTURES ARE TO REMAIN IN PLACE AND ARE TO BE MAINTAINED IN OPERATIVE CONDITION UNTIL PERMISSION FOR THEIR REMOVAL HAS BEEN OBTAINED FROM THE HOWARD COUNTY SEDIMENT CONTROL INSPECTOR.
- & REFERENCES CALLED FOR ON THE SEDIMENT CONTROL CONSTRUCTION PLAN AND DETAILS ARE MADE TO "THE STANDARDS AND SPECIFICATIONS FOR SOIL EROSION AND SEDIMENT CONTROL IN DEVELOPING AREAS".
- 9. SEDIMENT CONTROL WILL BE INSTALLED BEFORE CLEARING AND GRUBBING REMAINDER OF SITE.
- 10. NO STORM DRAINS SHALL BE INSTALLED UNDER THIS CONTRACT.

TEMPORARY SEEDING

AREA TO BE SEEDED SHALL BE RECENTLY LOOSENED. IF THE GROUND IS PACKED, CRUSTED OR HARD, THE TOP LAYER OF SOIL SHALL BE LOOSENED BY DISCING, RAKING OR OTHER ACCEPTABLE MEANS.


- A. APPLY 10-20-10 FERTILIZER (OR EQUIVALENT) AT THE RATE OF 600 LBS. PER ACRE OR 15 LBS. PER 1000 SQ. FT.
- B. WHERE SOIL IS KNOWN TO BE HIGHLY ACID, APPLY DOLOMITIC LIMESTONE AT THE RATE OF 1 TON PER ACRE.
- c. work both into soil and seed with cyclone seeder, drill, cultipaker seeder or hydroseeder (slurry will include seed and fertilizer) at the rate of 40 lbs. Per acre of italian or perennial ryegrass.
- D. MULCH WITH UNWEATHERED SMALL GRAIN STRAW AT THE RATE OF $1\ 1/2$ to $2\$ Tons, per acre and anchor with a cutback asphalt or emulsified asphalt at the rate of $5\$ Gal. per $1000\$ sq. ft.


PERMANENT SEEDING

FINAL STABILIZATION WILL TAKE PLACE AS SOON AS POSSIBLE AS WEATHER CONDITIONS PERMIT, AS FOLLOWS:

- A. APPLY DOLOMITIC LIMESTONE AT THE RATE OF 2 TONS PER ACRE (ONE TON PER ACRE IF APPLICATION OF TON PER ACRE WAS MADE FOR TEMPORARY SEEDING).
- B. APPLY 0-20-20 FERTILIZER AT THE RATE OF 600 LBS. PER ACRE HARROW OR DISC LIME AND 0-20-20 FERTILIZER INTO THE SOIL TO A MINIMUM DEPTH OF 3" LAWNS OR HIGH MAINTENANCE AREAS WILL BE DRAGGED AND LEVELED WITH A YORK RAKE. AT THE TIME OF SEEDING APPLY 400 POUNDS OF 38-0-0 UREAFORM FERTILIZER AND 500 LBS. OF 10-20-20 OR EQUIVALENT FERTILIZER PER ACRE.
- C. SEED WITH A MIXTURE OF CERTIFIED "MERION" KENTUCKY BLUEGRASS 40 LBS. PER ACRE; RED FESCUE, PENNLAWN OR JAMESTOWN @ 20 LBS. PER ACRE.
- D. MULCH WITH UNWEATHERED SMALL GRAIN STRAW AT THE RATE OF 1 1/2 TO 2 TONS PER ACRE AND ANCHOR WITH A CUTBACK ASPHALT OR EMULSIFIED ASPHALT AT THE RATE OF 5 GAL. PER 1000 SQ. FT.
- E. SEED ALL SLOPES WITH A MIXTURE OF CERTIFIED KENTUCKY 31 TALL FESCUE 3 50 LBS. PER ACRE, 100 LBS. PER ACRE,

DIVERSION DIKE

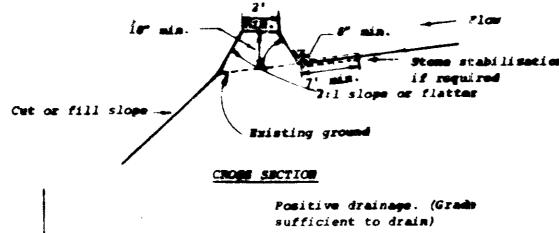

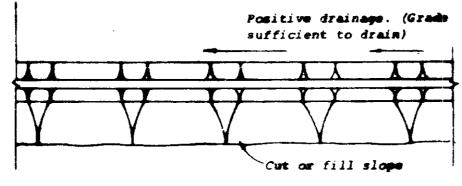

PLAN VIEW

Construction Specifications.

- 1. All dikes shall be machine compected.
- All diversion dikes shall have positive drainage to an outlet.
 A. Diverted runoff from a protected or stabilized area shall outlet directly to an undisturbed stabilized area or into a level
 - spreader or grade stabilization structure.


 B. Diverted runoff from a disturbed or exposed upland area shall be conveyed to a sediment trapping device such as a sediment trap or a sediment basis or to an area protected by any of these practices.
- 4. Stabilization, as specified by the plane, shall be: (1) in accordance with Standard and Specifications for Grassed Waterway, and the area to be stabilized shall be the channel (flow area); or (2) the flow area shall be lined with stone that usets MSMA size No. 2 or AASMTO M43 size No. 2 or 24 which is placed in a 3 inch thick layer and present into the soil. The area covered by the stone shall be as shown on the drawing above.
- 5. Periodic inspection and required maintenance shall be provided.
 - Standard Symbol Jum and mages * Brainage area loss than 5 acres

DIVERSION DIKE

NO SCALE

SEQUENCE OF CONSTRUCTION

- 1. OBTAIN A GRADING PERMIT.
- 2. INSTALL STABILIZED CONSTRUCTION ENTRANCE.
- 3. INSTALL DIVERSION DIKE.
- 4. INSTALL SEDIMENT TRAPS NO. 1 AND 2 WITH STONE OUTLET STRUCTURES AND PERIMETER DIKE. CONSTRUCT SWALE TO PROVIDE POSITIVE DRAINAGE FROM SEDIMENT TRAP NO. 2.
- 5. SEED SEDIMENT TRAPS AND DIKES PER TEMPORARY SEEDING NOTES.
- 6. COMPLETE ALL GRADING.
- 7. CONSTRUCT ALL UTILITIES.
- 8. CONSTRUCT ALL CURB AND GUTTER PAVING, ROADWAYS AND BUILDINGS.
- 9. SEED ALL DISTURBED AREAS IN ACCORDANCE WITH PERMANENT SEEDING NOTES.
- 10. UPON APPROVAL OF SOIL CONSERVATION DISTRICT, THE CONTRACTOR SHALL REMOVE ALL SEDIMENT CONTROL DEVICES AND PERMANENTLY RESEED DISTURBED AREAS.

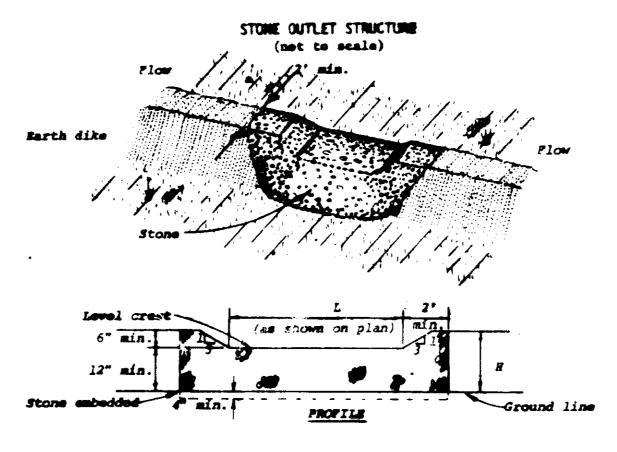

Construction Specifications

- The stone shall be crushed stone. Gravel may be used if crushed stone
 is not available. The stone shall meet MSHA Size No. 2 or AASHTO
 designation M43 Size No. 2 or 24.
- ?. The crest of the stone dike shall be at least six inches lower than the lewest elevation of the top of the earth dike and shall be level.
- 3. The stone outlet structure shall be embedded into the soil a minimum of four inches.
- 4. The minimum length, in feet, of the crest of the stone outlet structure shall be equal to six times the number of acres of contributing drainage
- 5. The stone outlet structure shall be inspected after each rain, and the stone shall be replaced when the structure ceases to function as intended due to silt accumulation among the stone, washout, construction traffic demage, etc.

STONE OUTLET STRUCTURE

NO SCALE

er - ---

3-15-83

APPROVED: FOR PUBLIC WATER AND PUBLIC SEWERAGE SYSTEMS, HOWARD COUNTY HEALTH DEPART-3-25-83 COUNTY HEALTH OFFICED BY THE DEVELOPER: I/WE CERTIFY THAT ALL DEVELOPMENT AND CONSTRUC TION WILL BE DONE ACCORDING TO THIS PLAN, AND THAT ANY RESPONSIBLE PERSONNEL INVOLVED IN THE CON-STRUCTION PROJECT WILL HAVE A CERTIFICATE OF ATTENDANCE AT A DEPARTMENT OF NATURAL RESAMICES APPROVED TRAINING PROGRAM FOR THE CONTROL OF MEDI MENT AND EROSION BEFORE BEGINNING THE PROJECT. I'me . your DEVELOPER THELMA J. LYMAN DATE BY THE ENGINEER I CERTIFY THAT THIS PLAN FOR EROSION AND SECTIONAL CONTROL REPRESENTS A PRACTICAL AND WORKARLE PLAN BASED ON MY PERSONAL KNOWLEDGE OF THE SITE COMEN TIONS AND THAT IT WAS PREPARED IN ACCORDANCE WITH THE REQUIREMENTS OF THE HOMARD SOIL COMMENTS PLONE DISTRICT." Arthu E. Muego 3.17.83 ENGINEER: ARTHUR E. MUEGGE DATE REVIEWED FOR HOWARD S. C. D. AND MEETS TECHNICAL REQUIREMENTS dames H. Nela 5 501L CONSERVATION SERVICE THIS DEVELOPMENT PLAN IS APPROVED FOR SOIL EROSION AND SEDIMENT CONTROL BY THE HOWARD SON COMMENTAL TION DISTRICT 3-24-3-3 APPROVED: HOWARD COUNTY OFFICE OF PLANNING **DATE** き マネース DATE ZONING ADMINISTRATION APPROVED: FOR PUBLIC WATER PUBLIC SEWERAGE STORM DRAINAGE SYSTEMS AND PUBLIC ROADS HOWARD COUNTY DEPARTMENT OF PUBLIC WORKS. CHIEF, BUREAU OF ENGINEERING REVISION DATE NO. OWNER ROUTE 40 MANAGEMENT "ARHETT REALTY 10194 BALTIMORE NATIONAL PIKE ELLICOTT CITY MARYLAND 21043 PROJECT: CHRISTIAN WOMEN'S THRIFT SHOP TAX MAP 24 PARCEL II AND PT. OF PARCEL 10 AREA PARCELE - PINE ORCHARD PARK 2 PELECTION DIST. HOWARD COUNTY, MARYLAND PROFILE AND DETAILS RIEMER AND ASSOCIATES Both Harlinion, National Phys And of its Maryland sgt i 461-269c Land Planning Design & Communication 3-17.83 DESIGNED BY A.E.M. DRAWN BY G.R.B. PROJECT NO 4582 DATE JAN.19,1983

SCALE AS SHOWN

PROFESSIONAL ENGR. NO. 8701

DRAWING NO. 5 OF 5