


| SHEET INDEX | |
|-------------|--------------------------|
| NO. | DESCRIPTION |
| 1 | TITLE SHEET |
| 2 | SITE DEVELOPMENT PLAN |
| 3 | DETAILS |
| 4 | PLANTING PLAN |
| 5 | SEDIMENT CONTROL PLAN |
| 6 | SEDIMENT CONTROL DETAILS |

SITE DEVELOPMENT PLAN

SETTLER'S LANDING

6TH ELECTION DISTRICT

HOWARD COUNTY, MARYLAND

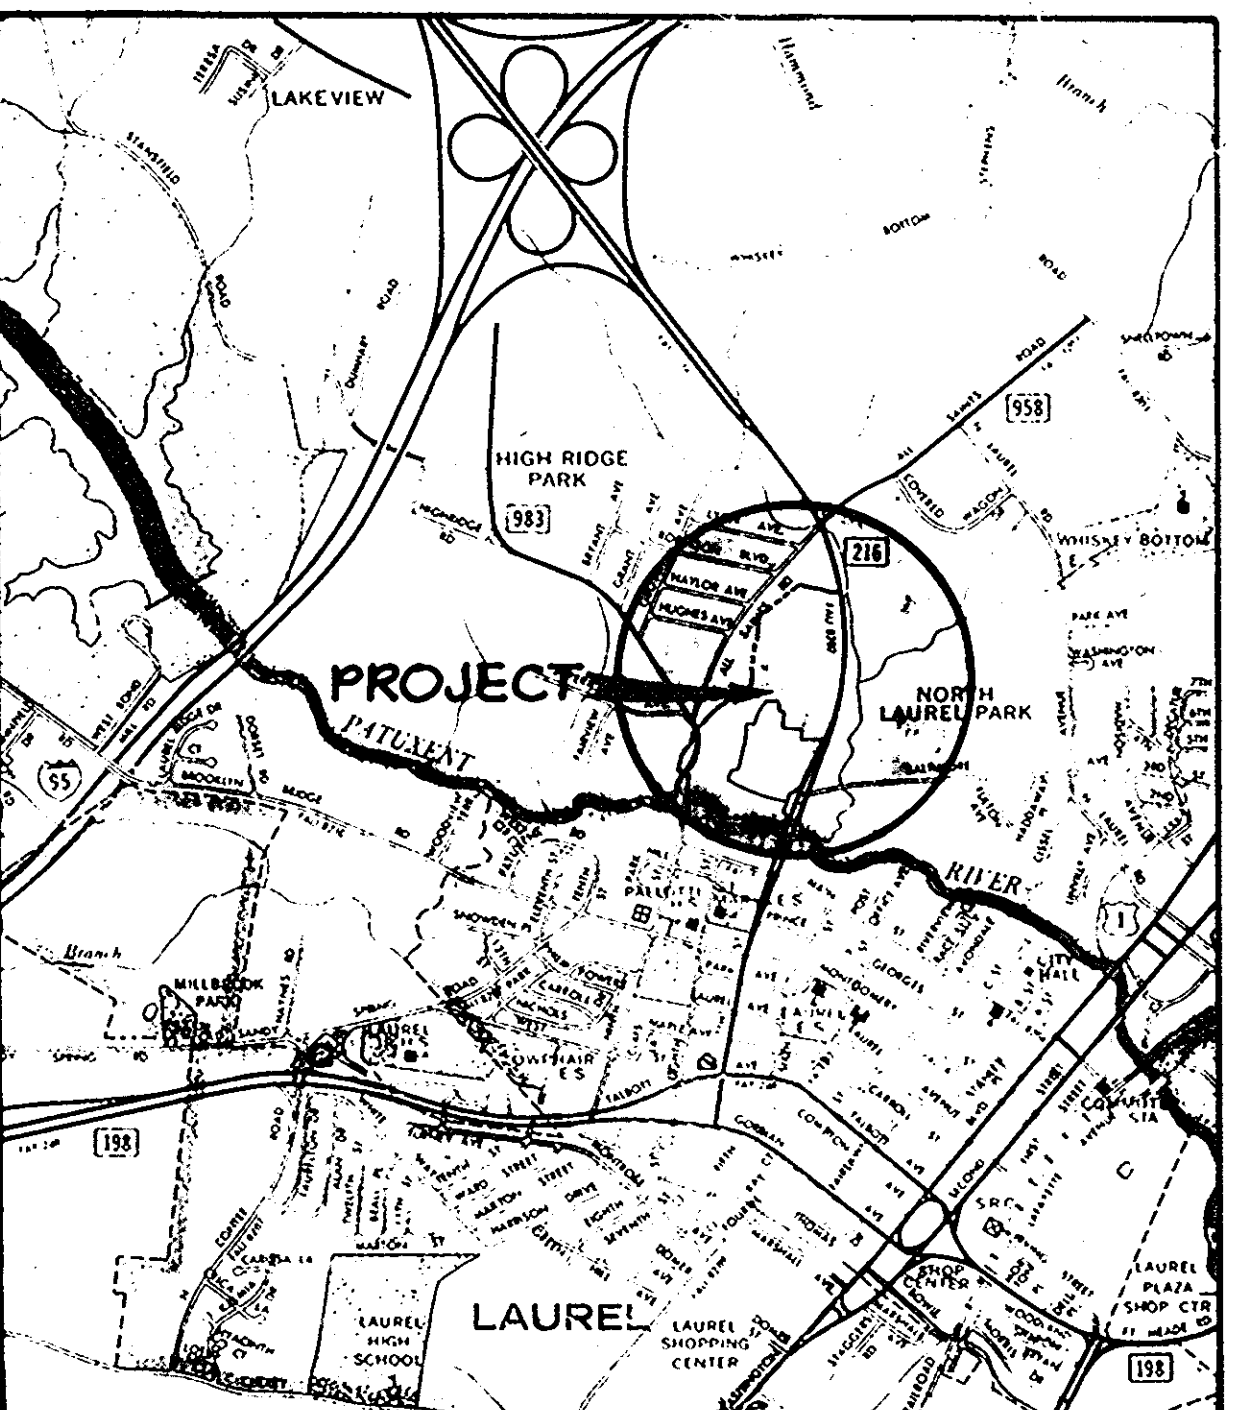


VICINITY MAP
Scale: 1" = 2,000'

- GENERAL NOTES
- TOPOGRAPHY IS BASED ON USC & GS MEAN SEA LEVEL DATUM 1929.
 - PUBLIC WATER AND SEWER FACILITIES ARE TO BE PROVIDED.
 - COMMUNITY OWNED PARCELS WHICH INCLUDE PARKING SPACES AND SIDEWALKS SHALL BE OWNED AND MAINTAINED BY A HOME OWNERS ASSOCIATION.
 - THE DWELLINGS SHOWN HEREON ARE 2 NAD 3 STORY GROUP DWELLINGS WITH FULL BASEMENT AND SINGLE FAMILY ATTACHED UNIT.
 - THE MINIMUM SETBACK FROM ALL PUBLIC STREETS SHALL BE 30' UNLESS OTHERWISE APPROVED BY THE HOWARD COUNTY PLANNING BOARD.
 - ALL FILL OPERATIONS ARE TO BE DONE IN ACCORDANCE WITH H.U.D. DATA SHEET 79G, CONTROLLED FILL UNDER SUPERVISION OF A REGISTERED SOILS ENGINEER.
 - CONTRACTOR TO NOTIFY THE FOLLOWING UTILITIES AT LEAST THREE (3) DAYS BEFORE STARTING WORK SHOWN ON THIS/THESE DRAWINGS:

| | |
|--|----------|
| C & P TELEPHONE COMPANY | 725-9976 |
| HOWARD COUNTY BUREAU OF UTILITIES | 992-2366 |
| AT&T CABLE LOCATION DIVISION | 393-3553 |
| BALTIMORE GAS AND ELECTRIC COMPANY | 685-0123 |
| HOWARD COUNTY CONSTRUCTION/INSPECTION SURVEY DIVISION | 992-2417 |
| (TO BE NOTIFIED 24 HOURS IN ADVANCE OF COMMENCEMENT OF WORK) | 2418 |
 - TOPO TAKEN FROM FIELD RUN SURVEY DATED JUNE, 1980 BY: CLARK, FINEPROCK AND SACKETT.

SITE TABULATION

| EXISTING ZONING: LAND USE TABULATION: | AREA | DWELLING UNITS | | PARKING | |
|--|--------------|----------------|----------|----------|-------------|
| | | PERMITTED | PROPOSED | REQUIRED | PROVIDED |
| Settler's Landing | 42.676 Acres | 341 | - | 682 | - |
| Section I | 7.076 Acres | 56 | 48 | 96 | 97 |
| AREA OF RESIDENTIAL LOTS: | | | | | 1.966 Acres |
| AREA OF COMMUNITY OWNED LOTS: | | | | | 3.196 Acres |
| AREA OF RIGHT-OF-WAY FOR ROADWAYS: | | | | | 1.914 Acres |
| TOTAL AREA: | | | | | 7.076 Acres |
| TOTAL RESIDENTIAL LOTS: | | | | | 48 |
| TOTAL COMMUNITY OWNED LOTS: | | | | | 2 |
| TOTAL LOTS (INCLUDING COMMUNITY OWNED PARCELS) | | | | | 50 |

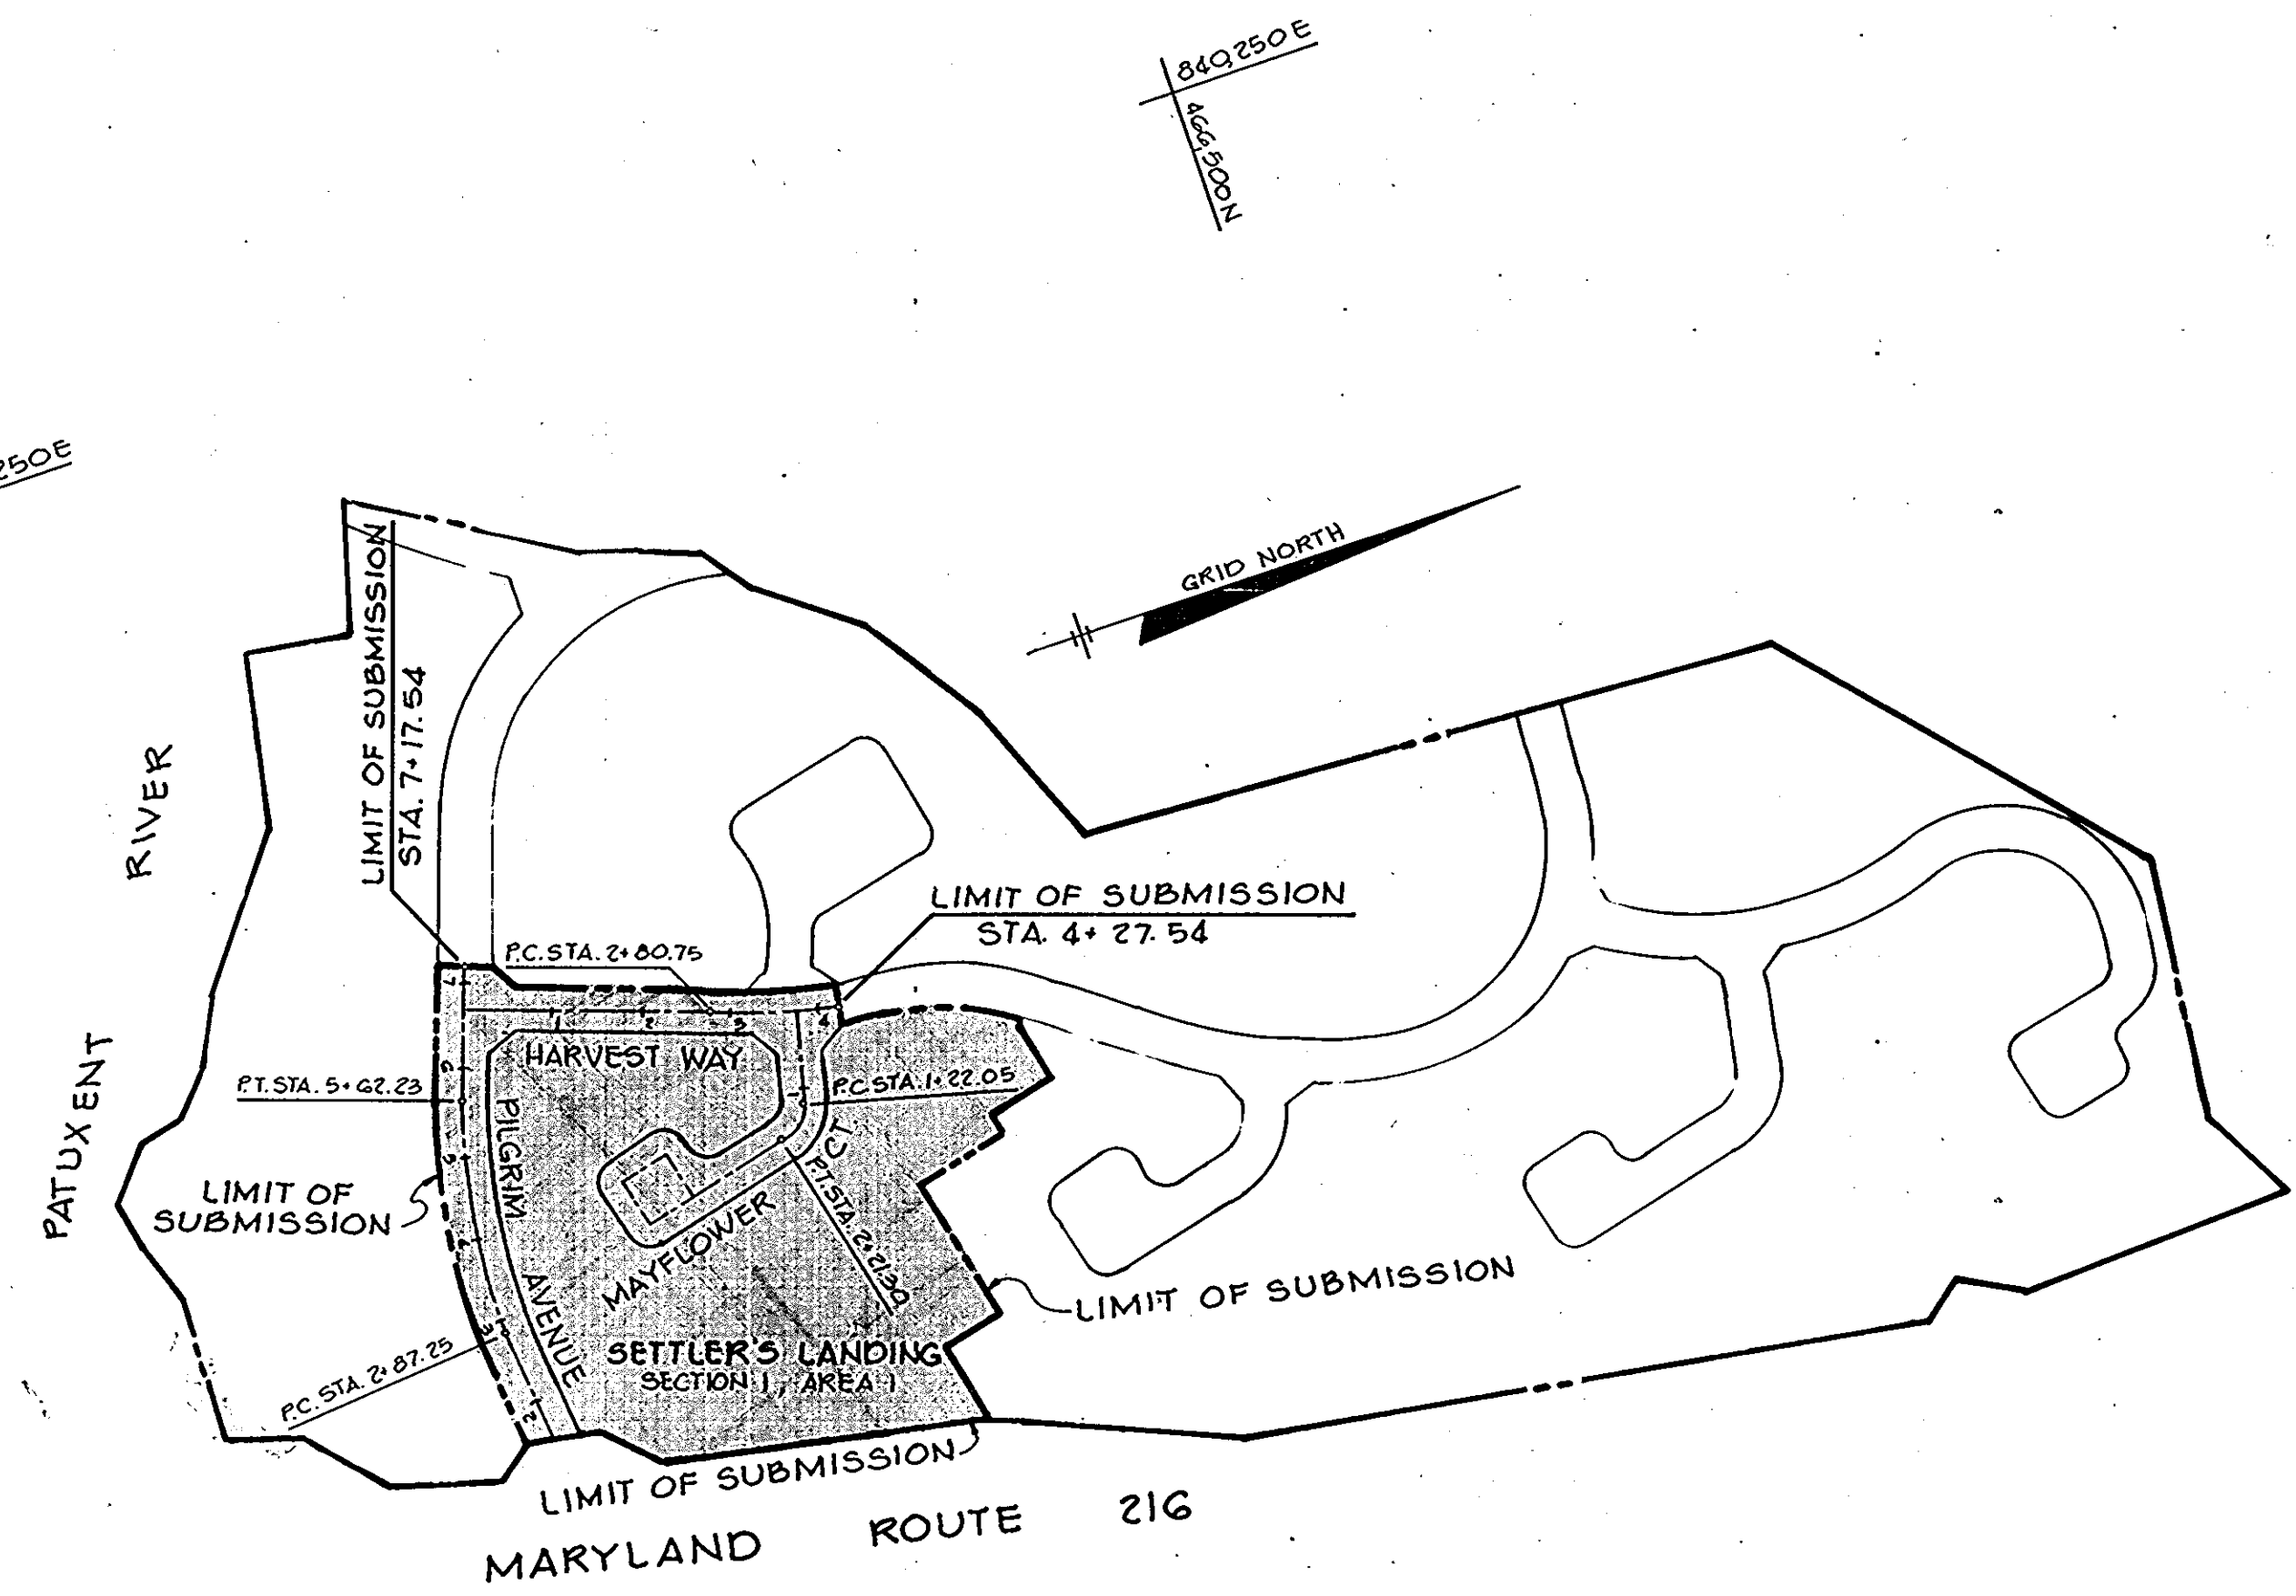

PLAN
Scale: 1" = 200'

APPROVED: HOWARD COUNTY OFFICE OF PLANNING AND ZONING.
Thomas A. Smith 5-4-81
 PLANNING DIRECTOR DATE

William M. Smith 5-4-81
 CHIEF, DIVISION OF LAND DEVELOPMENT AND ZONING ADMINISTRATION DATE

APPROVED: FOR PUBLIC WATER AND PUBLIC SEWERAGE SYSTEMS, HOWARD COUNTY HEALTH DEPARTMENT.
Joyce M. Payne 5-1-81
 COUNTY HEALTH OFFICER DATE

APPROVED: FOR PUBLIC WATER, PUBLIC SEWERAGE, STORM DRAINAGE SYSTEMS AND PUBLIC ROADS.
 HOWARD COUNTY DEPARTMENT OF PUBLIC WORKS
James M. Lee 4-29-81
 DIRECTOR DATE

W. C. ... 4-29-81
 CHIEF, BUREAU OF ENGINEERING DATE

4-15-81 1 REVISED AS PER H.C. COMMENTS DATED 1-15-81
 DATE NO. REVISION

OWNER: EASTON ASSOCIATES
 12400 CLARKSVILLE PIKE
 CLARKSVILLE, MARYLAND 21029

DEVELOPER: EASTON ASSOCIATES
 12400 CLARKSVILLE PIKE
 CLARKSVILLE, MARYLAND 21029

PROJECT: **SETTLER'S LANDING**
 SECTION I, AREA I LOTS 1 THRU 49

AREA RECORD PLAT RECORDING REFERENCE NO 4846
 ELECTION DISTRICT NO 6 HOWARD COUNTY, MARYLAND
 TAX MAP NO 50 PARCEL 34G

TITLE: TITLE SHEET

Riemer - Tracy & Associates, Inc.
 8659 Baltimore National Pike
 Ellicott City, Maryland 21143
 (301) 461-2690
 Land Planning Design & Civil Engineering

DATE: 8-29-80
 FORMERLY EASTON (P-20-20)
 DESIGNED BY: L.J.D.
 DRAWN BY: T.E.S.
 PROJECT NO: 1880
 DATE: 8-29-80
 SCALE: AS SHOWN
 DRAWING NO. 1 OF 6

APPROVED
 DIVISION OF LAND DEVELOPMENT &
 ZONING ADMINISTRATION
 HOWARD COUNTY, MARYLAND
 DATE: 1-16-81



Thomas K. Jones
 PROFESSIONAL ENGR. NO. 9566



NOTE: WATER AND SEWER SERVICE TO THESE LOTS WILL BE GRANTED UNDER THE PROVISIONS OF SECTION 18.12213 OF THE HOWARD COUNTY CODE.

APPROVED: HOWARD COUNTY OFFICE OF PLANNING AND ZONING.
Thomas H. Hough 5-4-81
 PLANNING DIRECTOR DATE
William M. ... 5-4-81
 CHIEF, DIVISION OF LAND DEVELOPMENT AND ZONING ADMINISTRATION DATE

APPROVED: FOR PUBLIC WATER AND PUBLIC SEWERAGE SYSTEMS, HOWARD COUNTY HEALTH DEPARTMENT.
Joseph ... 5-1-81
 COUNTY HEALTH OFFICER DATE

APPROVED: FOR PUBLIC WATER, PUBLIC SEWERAGE, STORM DRAINAGE SYSTEMS AND PUBLIC ROADS.
 HOWARD COUNTY DEPARTMENT OF PUBLIC WORKS
James M. ... 4-29-81
 DIRECTOR DATE
William ... 4-29-81
 CHIEF, BUREAU OF ENGINEERING DATE

4-15-81 REVISED PER H.C. COMMENTS DATED 1-19-81
 DATE NO REVISION

OWNER: EASTON ASSOCIATES
 12400 CLARKSVILLE PIKE
 CLARKSVILLE, MARYLAND 21029

DEVELOPER: EASTON ASSOCIATES
 12400 CLARKSVILLE PIKE
 CLARKSVILLE, MARYLAND 21029


PROJECT: SETTLER'S LANDING
 SECTION 1, AREA 1 LOTS 1 THRU 49

AREA: RECORD PLAT RECORDING REFERENCE NO 4846
 ELECTION DISTRICT NO 6 HOWARD COUNTY, MARYLAND
 TAX MAP NO 50 PARCEL 34G


TITLE: SITE DEVELOPMENT PLAN

Riemer Tracy & Associates, Inc.
 8669 Baltimore National Pike
 Ellicott City, Maryland 21043
 (301) 461-2690
 Land Planning, Design & Civil Engineering


8-29-80 DATE
 FORMERLY EASTON (P-80-20)
 DESIGNED BY: L.J.D.
 DRAWN BY: T.E.S.
 PROJECT NO: 1800
 DATE: 8-29-80
 SCALE: 1"=30'
 DRAWING NO. 2 OF 6
James K. Tracy
 PROFESSIONAL ENGR. NO. 9566

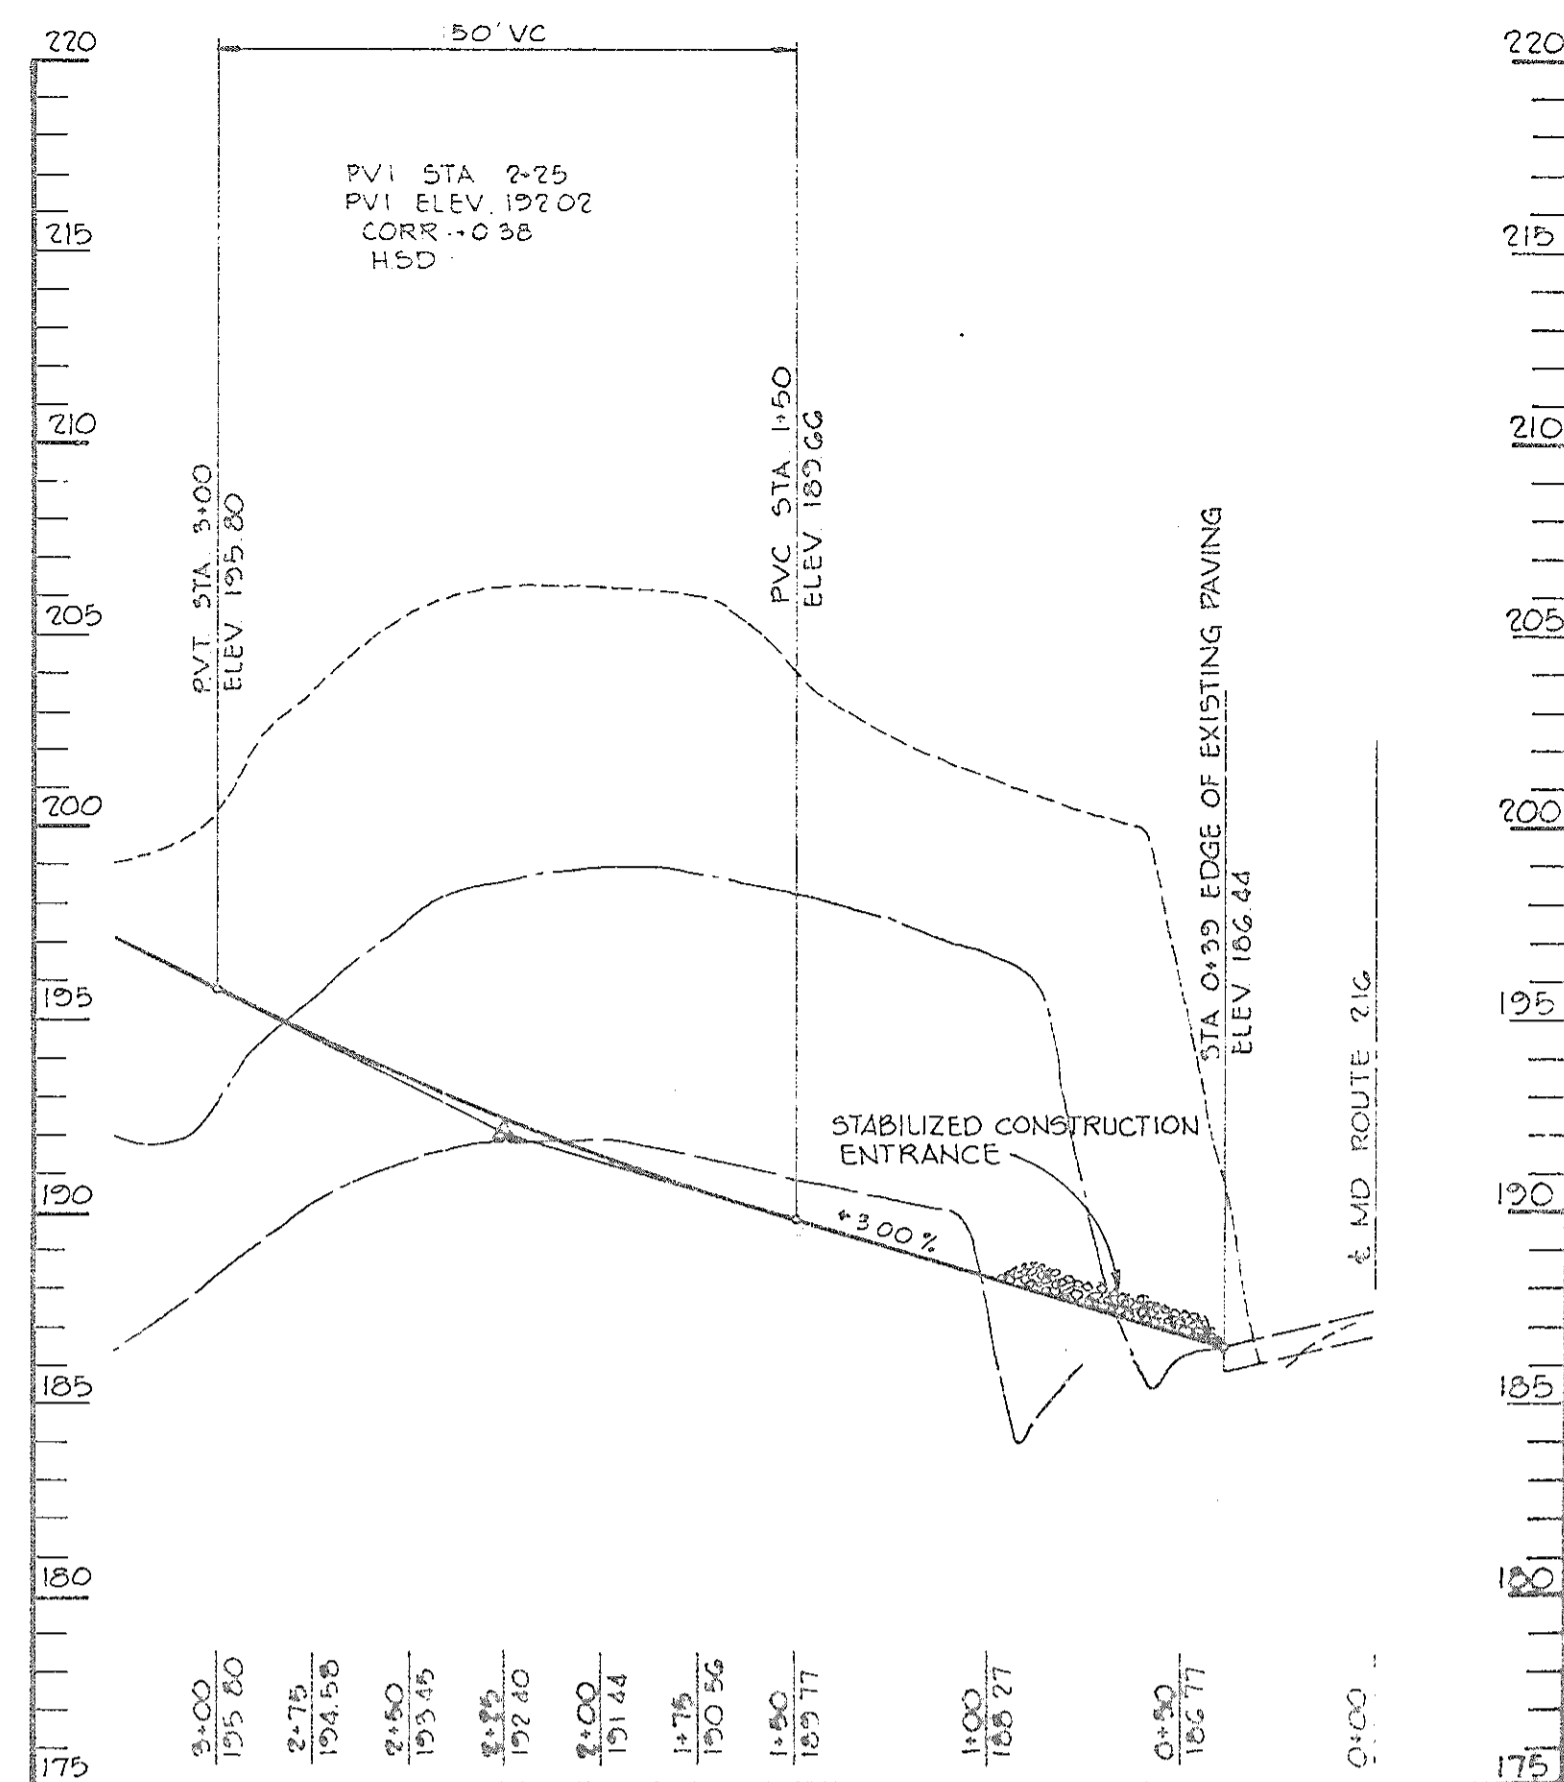


PROFILE - PILGRIM AVENUE ENTRANCE TO SITE
SCALE: H: 1"=50'
V: 1"=5'

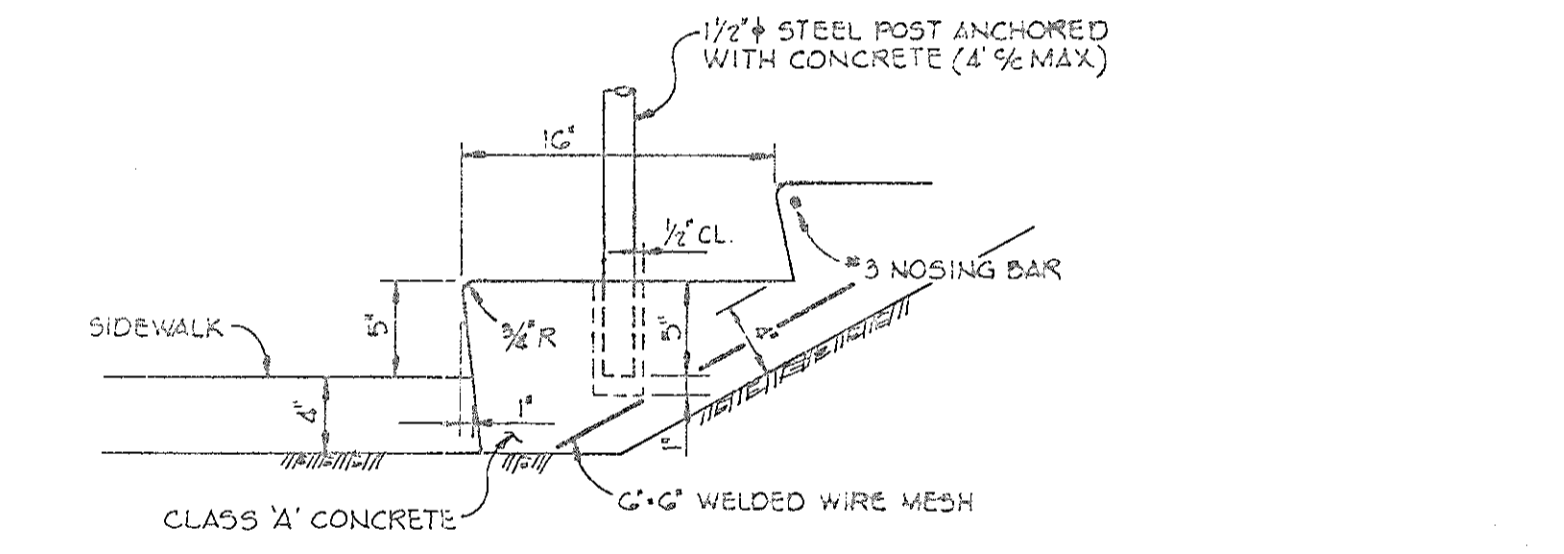


TYPICAL CONCRETE STEP W/RAIL DETAIL
SCALE: 1"=10'

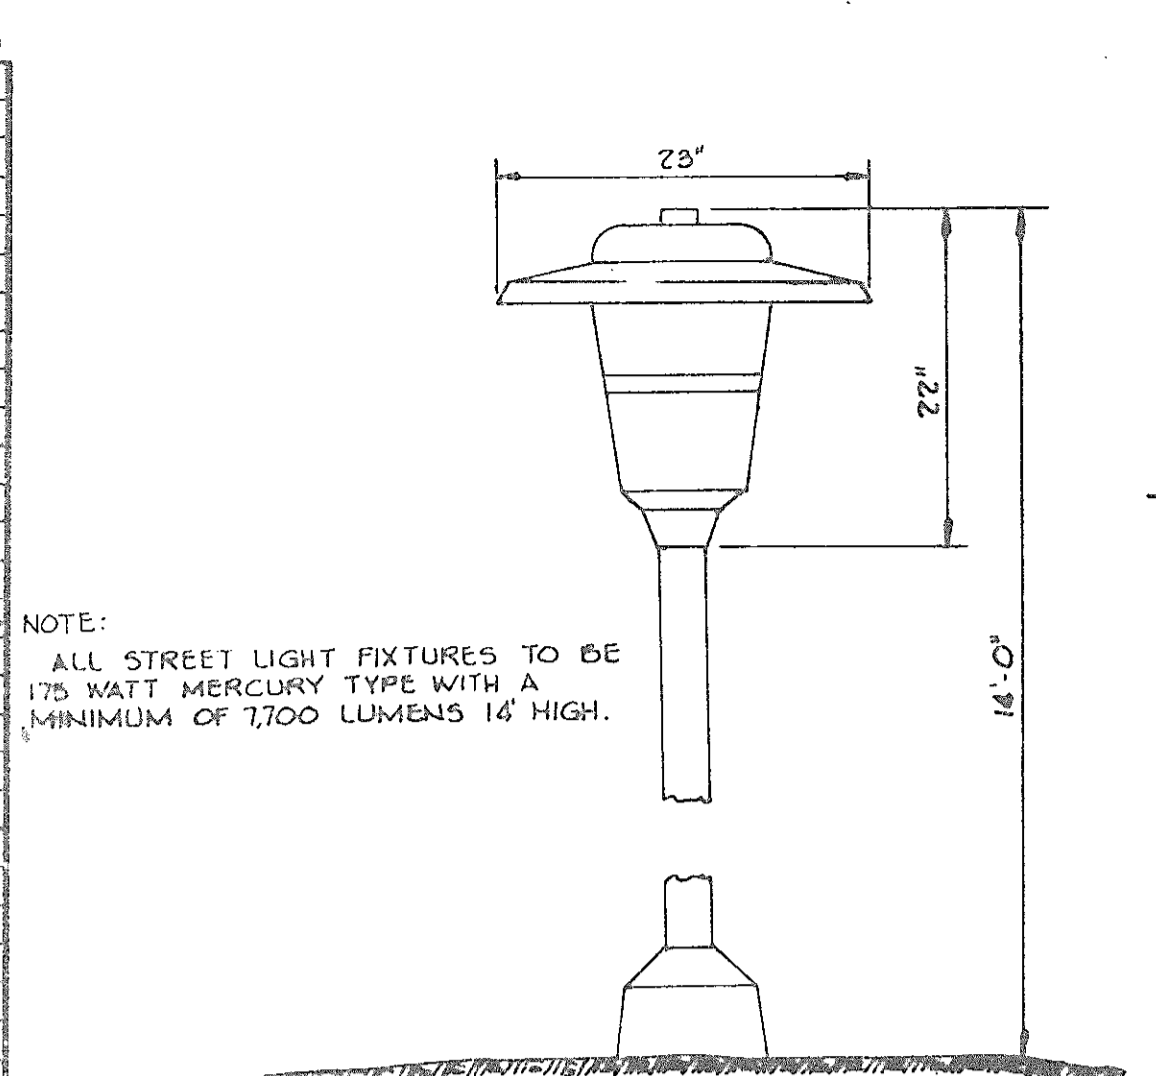


DETAIL - LIGHTING FIXTURE
NO SCALE

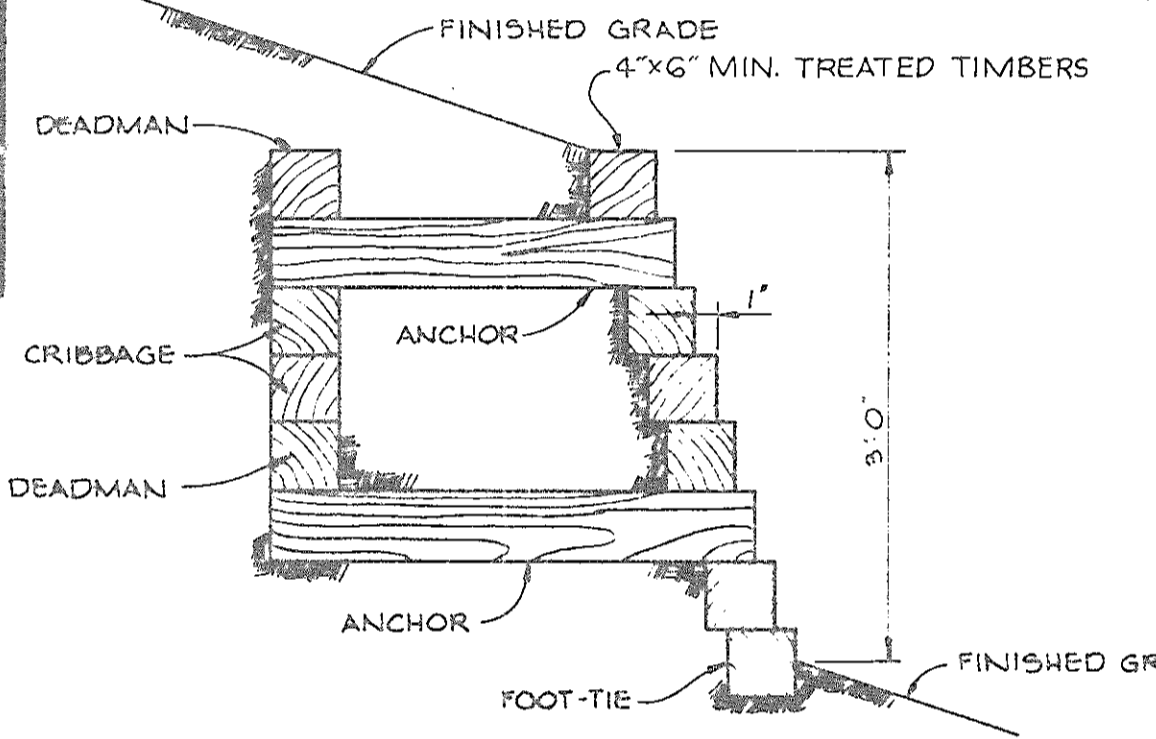


TIMBER RETAINING WALL
No Scale

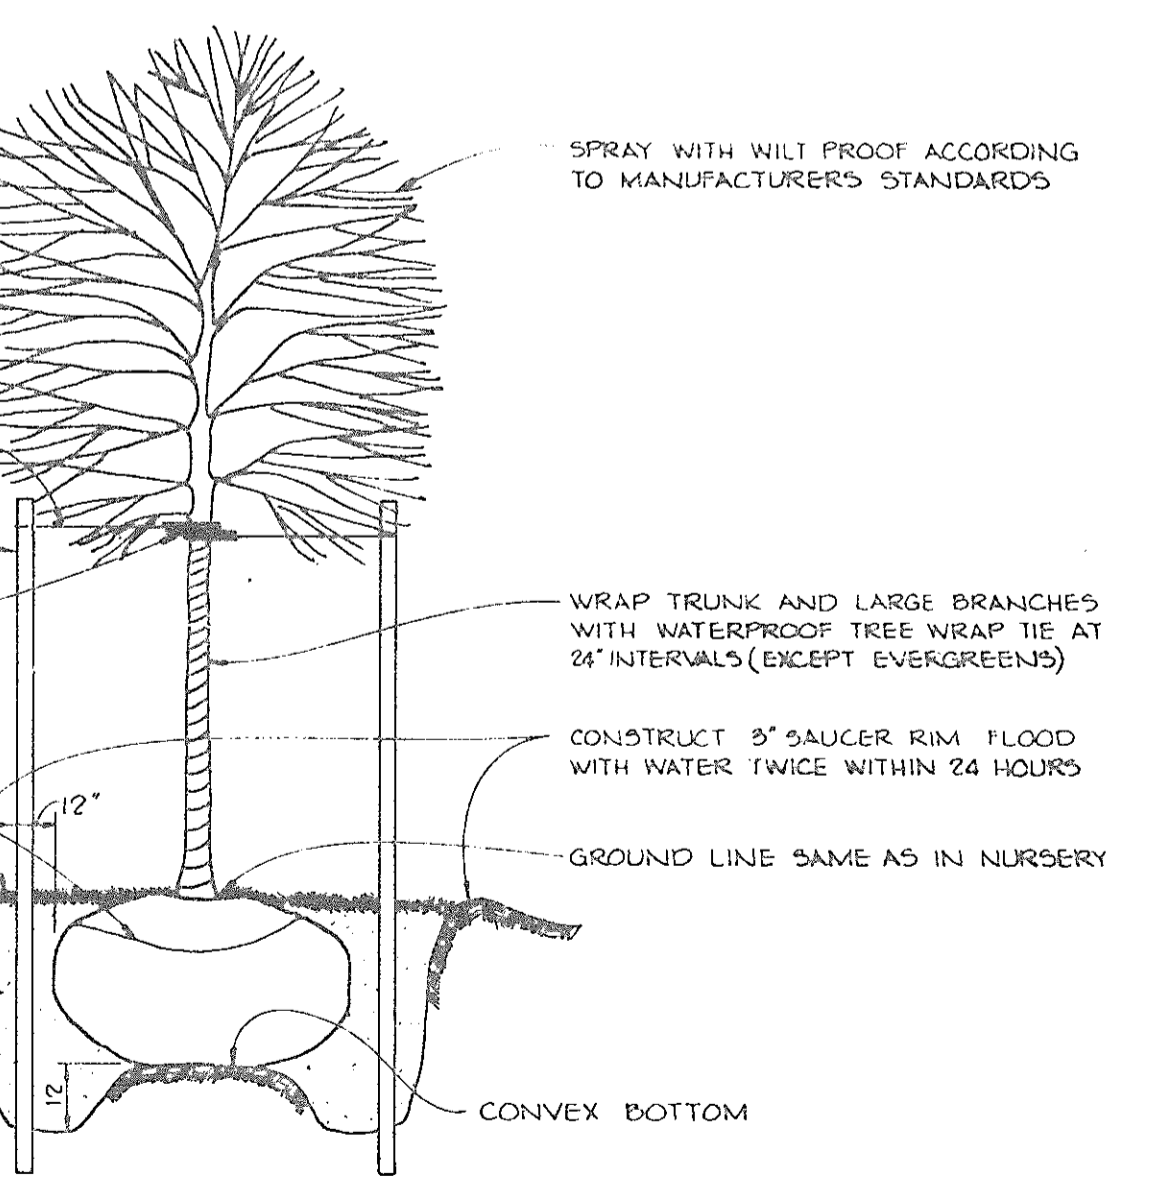


TREE PLANTING DETAIL
No Scale

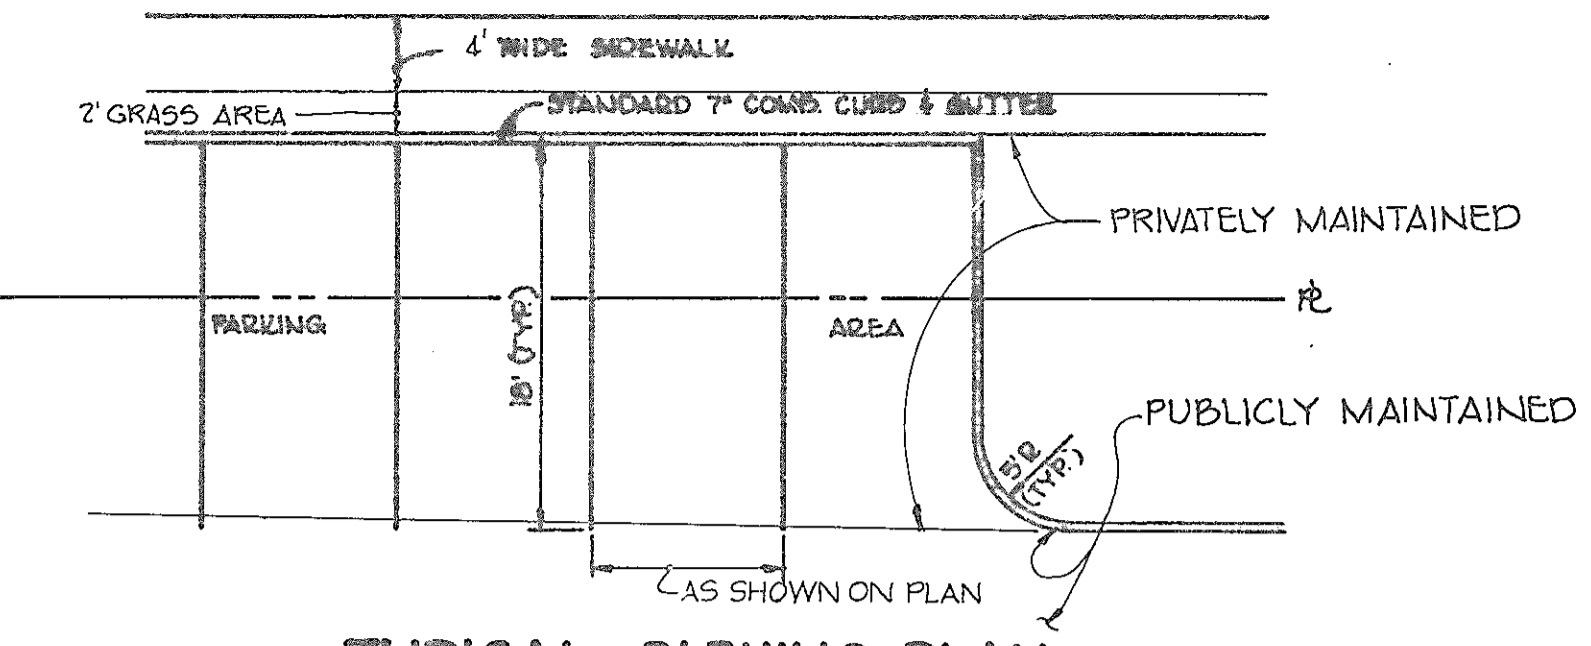


TYPICAL PARKING PLAN
NO SCALE

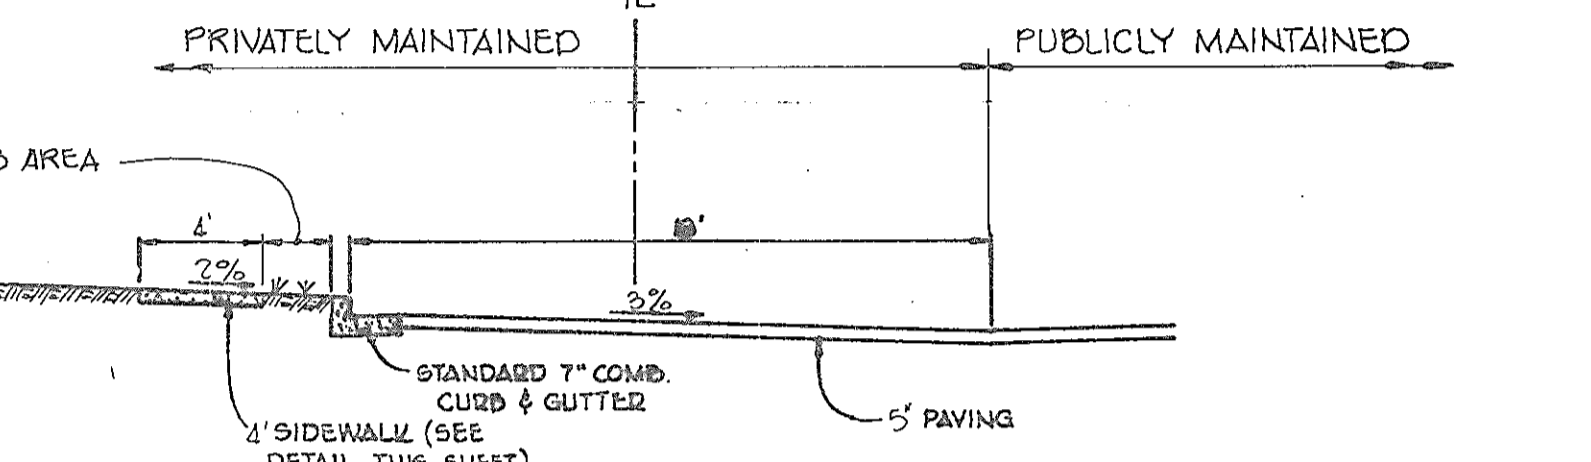


SECTION THROUGH PARKING
NO SCALE

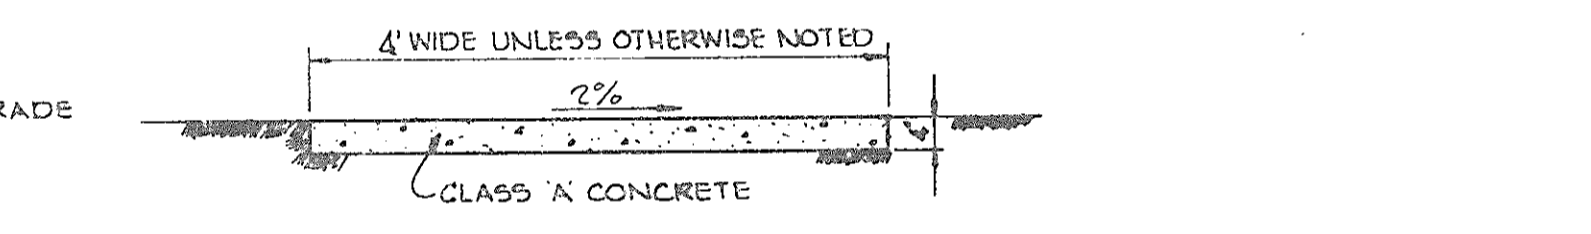


SIDEWALK DETAIL
No Scale

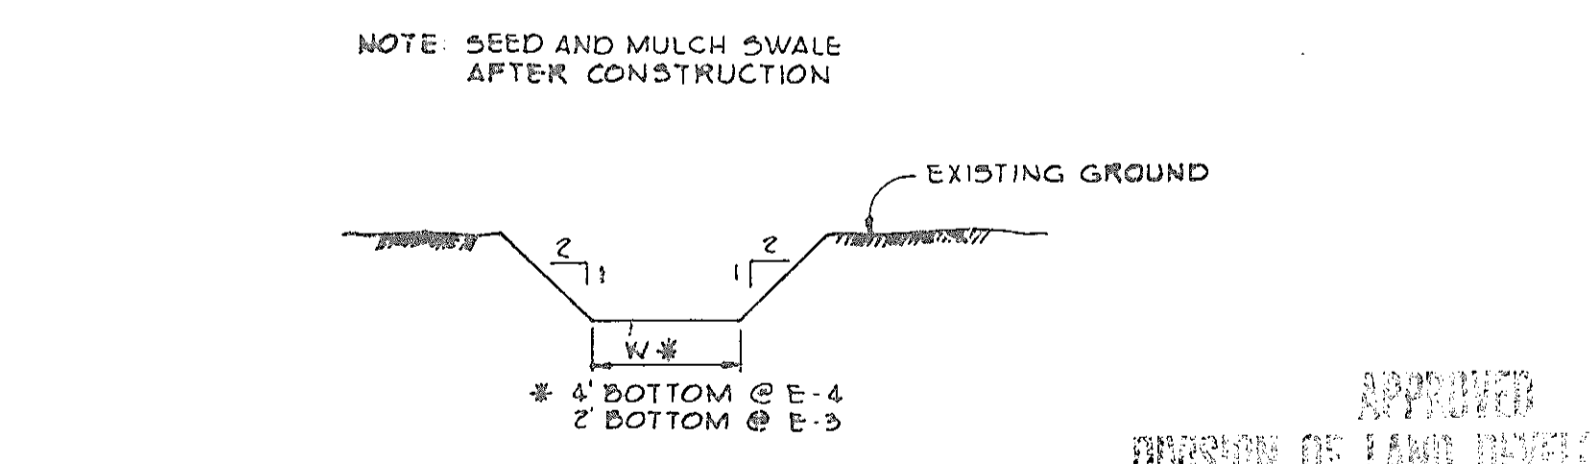

GRASSED CHANNEL
NO SCALE

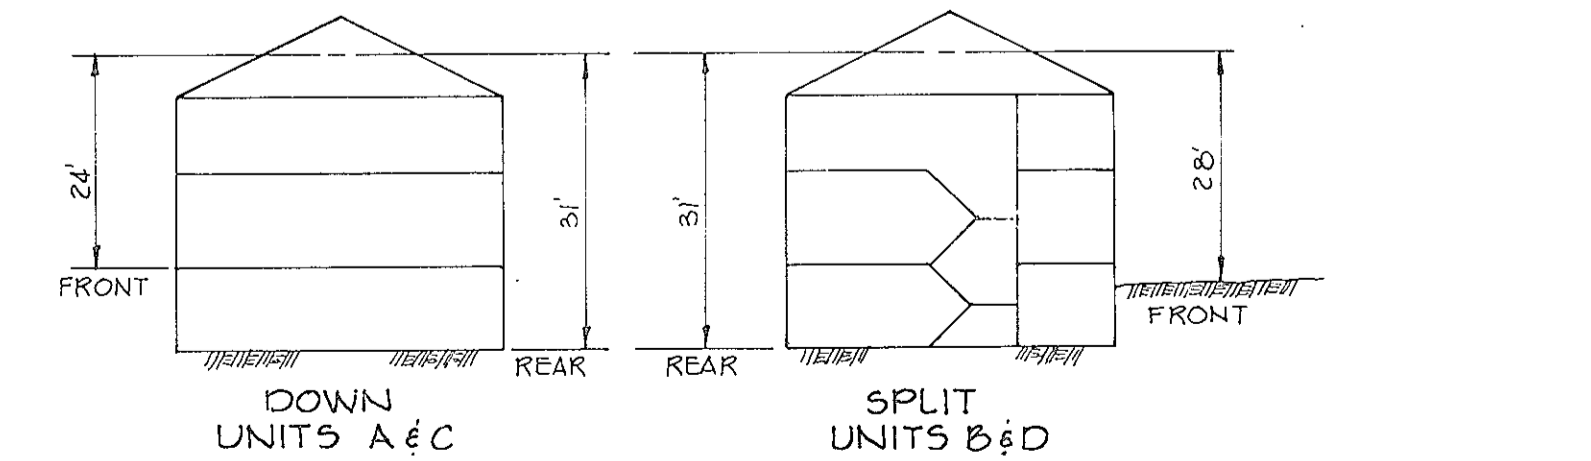

TYPICAL SCHEMATIC BLDG. SECTION
No Scale

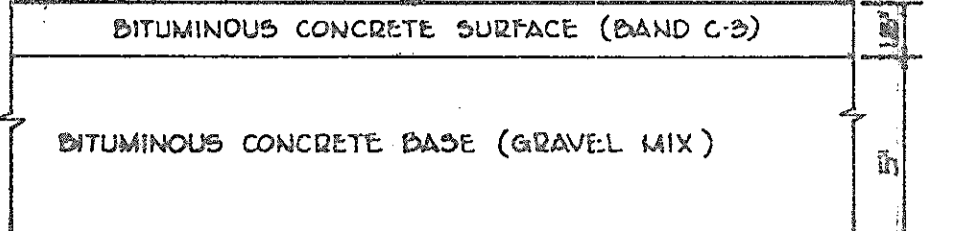

5" PAVING




6 1/2" PAVING


HOWARD COUNTY STANDARD (DRAWING D-15, PAGE 68)
CLEARING AND GRADING ARTICLE C-1
SUBGRADE ARTICLE C-2
BASE COURSE ARTICLE C-51 OR C-55
SURFACE COURSE ARTICLE C-51

HOWARD COUNTY STANDARD (DRAWING D-9, PAGE 60)
CLEARING AND GRADING ARTICLE C-1
SUBGRADE ARTICLE C-2
BASE COURSE ARTICLE C-51
SURFACE COURSE ARTICLE C-51


TYPICAL PAVING SECTIONS
SCALE: 1"=5'

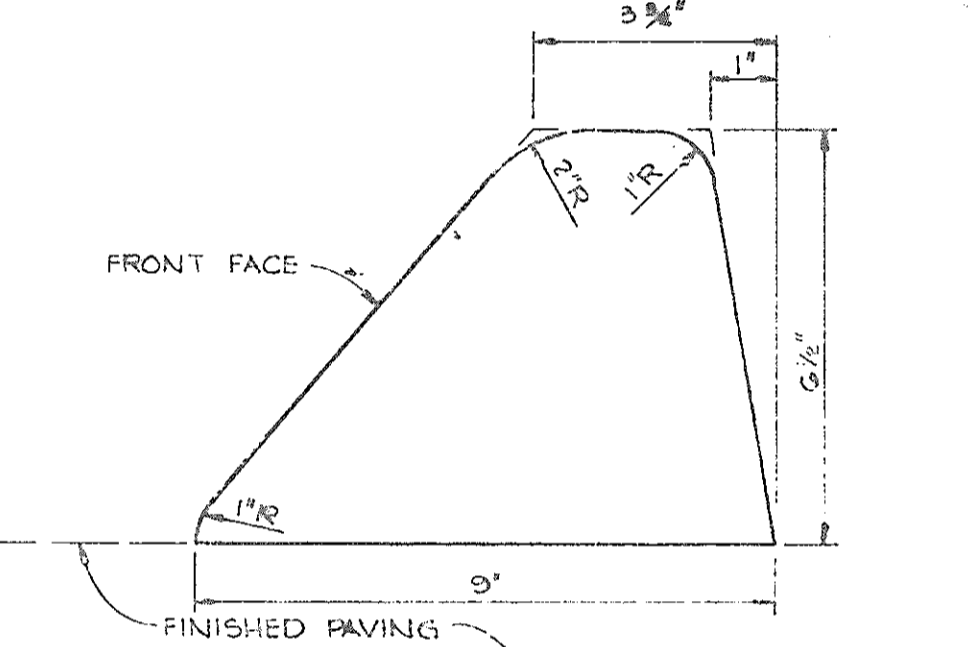


BITUMINOUS CURB
NO SCALE

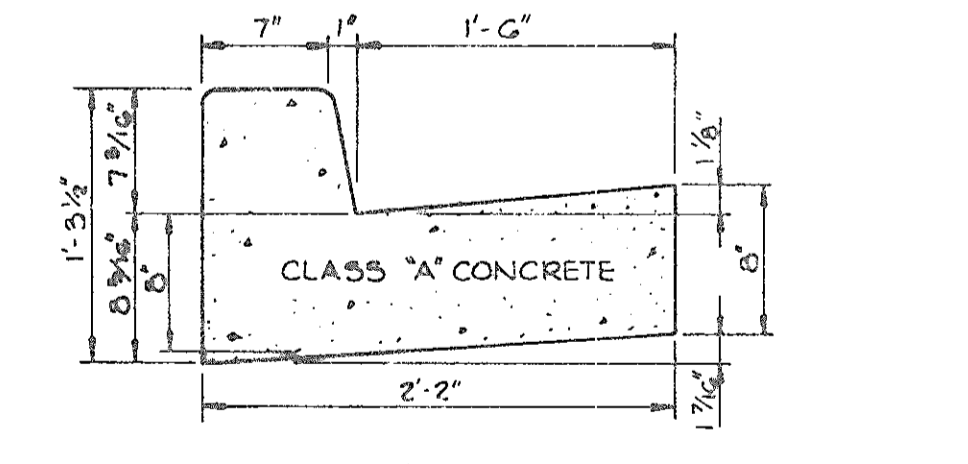

STANDARD 7" COMBINATION CURB AND GUTTER
NO SCALE

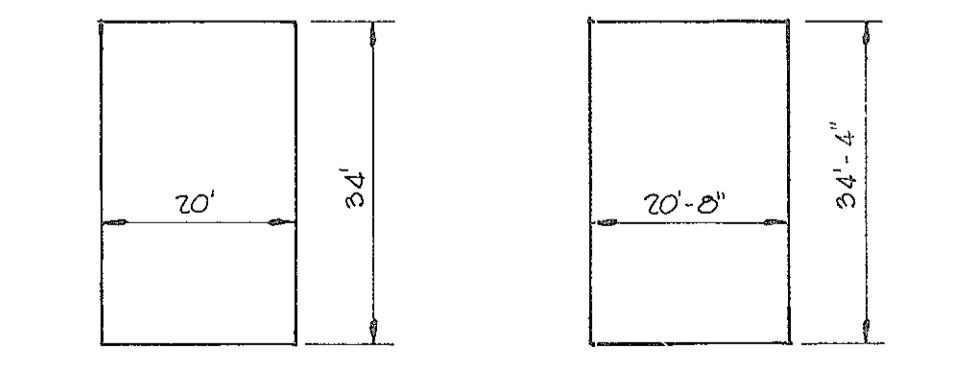

TYPICAL SCHEMATIC BLDG. PLAN
No Scale

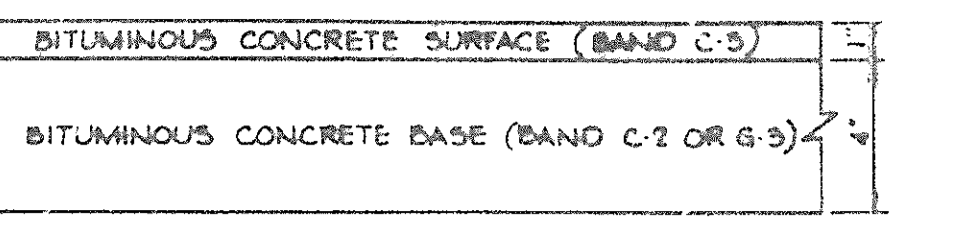

5" PAVING

5" PAVING

NOTES:
1. A TACK COAT IS REQUIRED IN ACCORDANCE WITH SECTION C-51-4 OF THE HOWARD COUNTY ROAD CONSTRUCTION CODE AND SPECIFICATIONS.
2. BASE WILL BE PRIMED IN ACCORDANCE WITH SECTION C-50-3 OF THE HOWARD COUNTY ROAD CONSTRUCTION CODE AND SPECIFICATIONS.
3. TO BE CONSTRUCTED IN ACCORDANCE WITH THE HOWARD COUNTY ROAD CONSTRUCTION CODE AND SPECIFICATIONS.

TYPICAL PAVING SECTIONS
SCALE: 1"=5'

APPROVED: HOWARD COUNTY OFFICE OF PLANNING AND ZONING.
Thomas J. Harris 5-4-81
PLANNING DIRECTOR DATE
William M. Sullivan 5-4-81
CHIEF, DIVISION OF LAND DEVELOPMENT AND ZONING ADMINISTRATION DATE

APPROVED: FOR PUBLIC WATER AND PUBLIC SEWERAGE SYSTEMS, HOWARD COUNTY HEALTH DEPARTMENT.
James M. Sullivan 5-1-81
COUNTY HEALTH OFFICER DATE

APPROVED: FOR PUBLIC WATER, PUBLIC SEWERAGE, STORM DRAINAGE SYSTEMS AND PUBLIC ROADS.
James M. Sullivan 4-29-81
DIRECTOR DATE

William M. Sullivan 4-16-81
CHIEF, BUREAU OF ENGINEERING DATE

1-15-81 Δ REVISOR PER H.C. COMMENTS DATED 1-19-81
DATE NO. REVISION

OWNER: EASTON ASSOCIATES
12400 CLARKSVILLE PIKE
CLARKSVILLE, MARYLAND 21029

DEVELOPER: EASTON ASSOCIATES
12400 CLARKSVILLE PIKE
CLARKSVILLE, MARYLAND 21029


PROJECT: SETTLER'S LANDING
SECTION 1, AREA 1 LOTS 1 THRU 49

AREA: RECORD PLAT REFERENCE N# 4846
ELECTION DISTRICT N#6 HOWARD COUNTY, MARYLAND
TAX MAP N#50 PARCEL 346

TITLE: DETAILS

8-29-80 DATE
FORMERLY EASTON (P-80-20)
DESIGNED BY: R.J.W.
DRAWN BY: T.E.S.
PROJECT NO: 1880
DATE: 8-29-80
SCALE: AS SHOWN
DRAWING NO. 5 OF 6
PROFESSIONAL ENGR. NO. 9566

Riemer - Tracy & Associates, Inc.
8659 Baltimore National Pike
Ellicott City, Maryland 21043
(301) 461-2690
Land Planning, Design & Civil Engineering

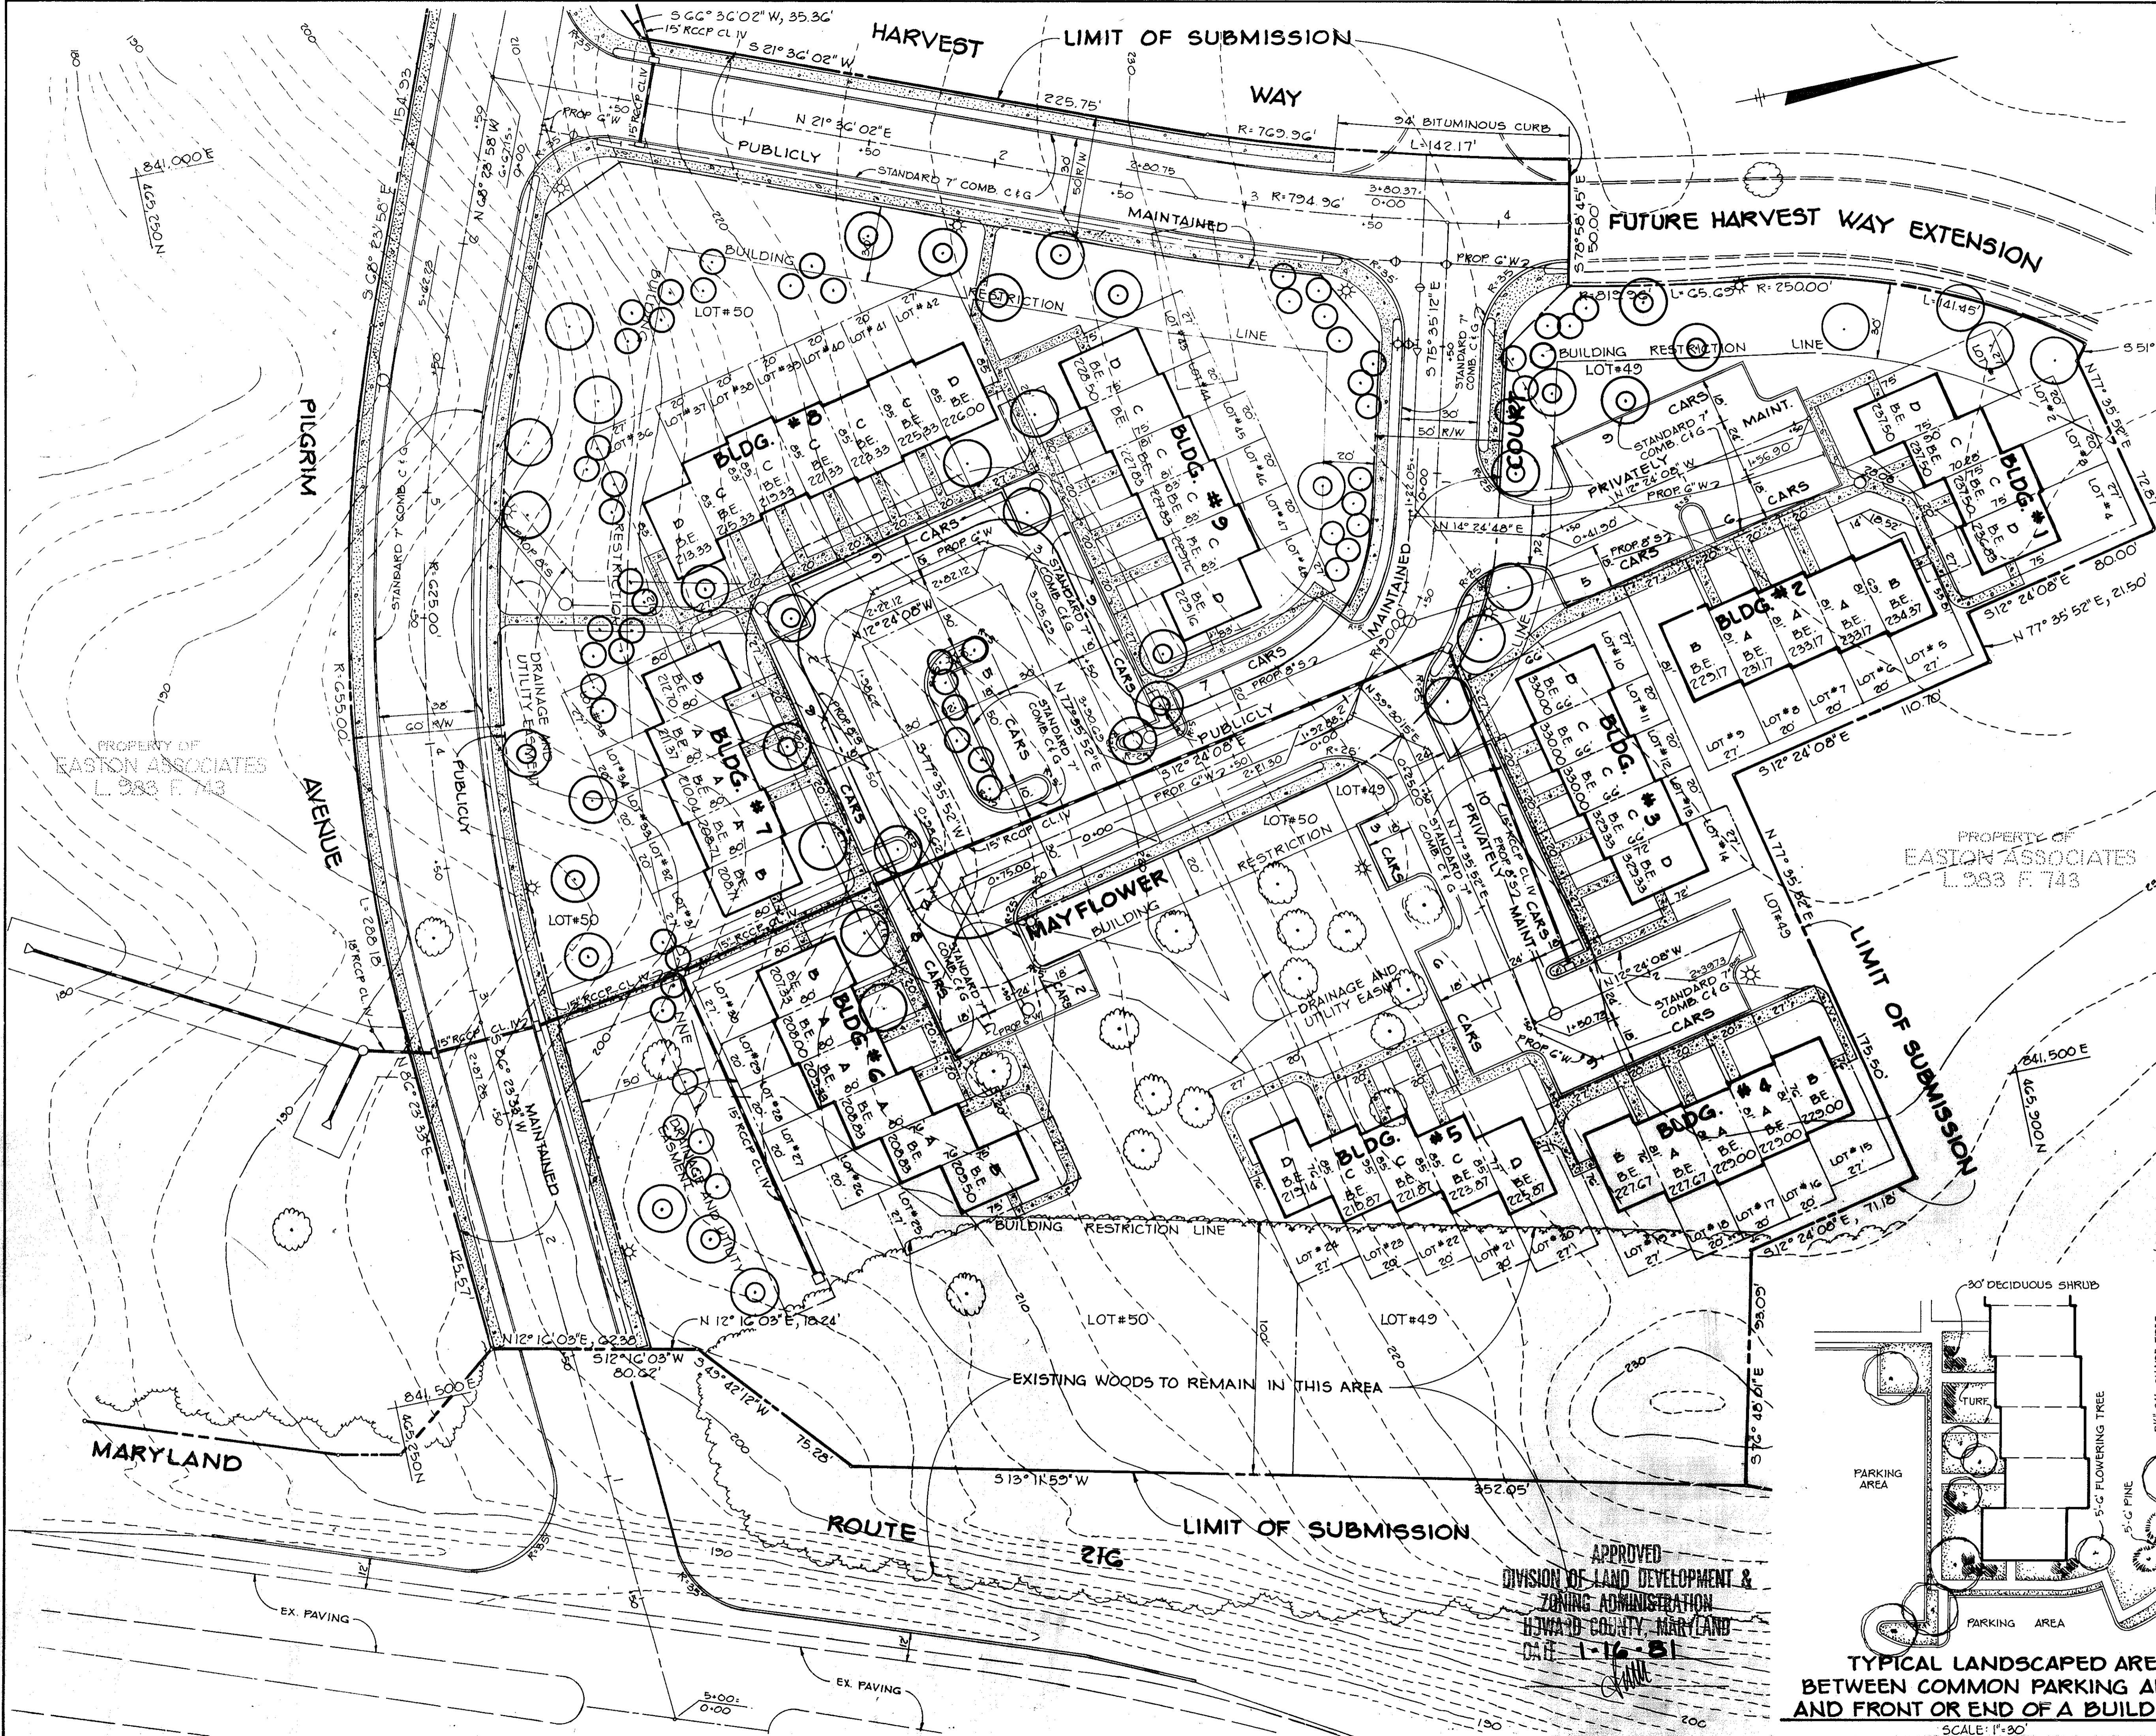

| PLANT LIST | | | |
|------------|-------------------------------|--------------------------------|----------|
| SYMBOL | TYPE | SIZE | QUANTITY |
| ○ | ACER saccharum Sugar Maple | 2-2½" Cal. B&B 12'-14' Hgt. | 10 |
| ⊙ | QUERCUS palustris Pin Oak | 2-2½" Cal. B&B 12'-14' Hgt. | 24 |
| ⊖ | PINUS nigra Austrian Pines | 6'-7" B&B | 58 |

* FOR TREE PLANTING DETAIL SEE DRAWING NO. 3

APPROVED: HOWARD COUNTY OFFICE OF PLANNING AND ZONING.

Donald L. Harris 5-4-81
PLANNING DIRECTOR DATE

John M. Buchanan 5-4-81
CHIEF, DIVISION OF LAND DEVELOPMENT AND ZONING ADMINISTRATION DATE

APPROVED: HOWARD COUNTY HEALTH DEPARTMENT.
Public water + Public Sewer

Joseph M. Boyers 5-1-81
COUNTY HEALTH OFFICER DATE

APPROVED:

HOWARD COUNTY DEPARTMENT OF PUBLIC WORKS

Ronald J. Shaw 4/29/81
DIRECTOR DATE

Robert E. Ray 4/29/81
CHIEF, BUREAU OF ENGINEERING DATE

4-15-81 REVISD PER H.C. COMMENTS DATED 4-15-81

OWNER: EASTON ASSOCIATES
12400 CLARKSVILLE PIKE
CLARKSVILLE, MARYLAND 21029

DEVELOPER: EASTON ASSOCIATES
12400 CLARKSVILLE PIKE
CLARKSVILLE, MARYLAND 21029

PROJECT: SETTLER'S LANDING
SECTION 1, AREA 1 LOTS 1 THRU 49


AREA: RECORD PLAT RECORDING REFERENCE NO 4846
ELECTION DISTRICT 146 HOWARD COUNTY, MARYLAND
TAX MAP NO 50 PARCEL 346

TITLE: PLANTING PLAN



TR **Riener - Tracy & Associates, Inc.**
8000 Baltimore National Pike
Elkton City, Maryland 21043
(301) 461-2800
Land Planning, Design & Civil Engineering

11-21-80 DATE
STATE OF MARYLAND
FORMERLY EASTON (P-80-20)
DESIGNED BY: L.J.D.
DRAWN BY: T.E.S.
PROJECT NO: 1800
DATE: 5-29-80
SCALE: 1"=50'
DRAWING NO. 4 OF 6

APPROVED
DIVISION OF LAND DEVELOPMENT &
ZONING ADMINISTRATION
HOWARD COUNTY, MARYLAND
DATE: 1-16-81

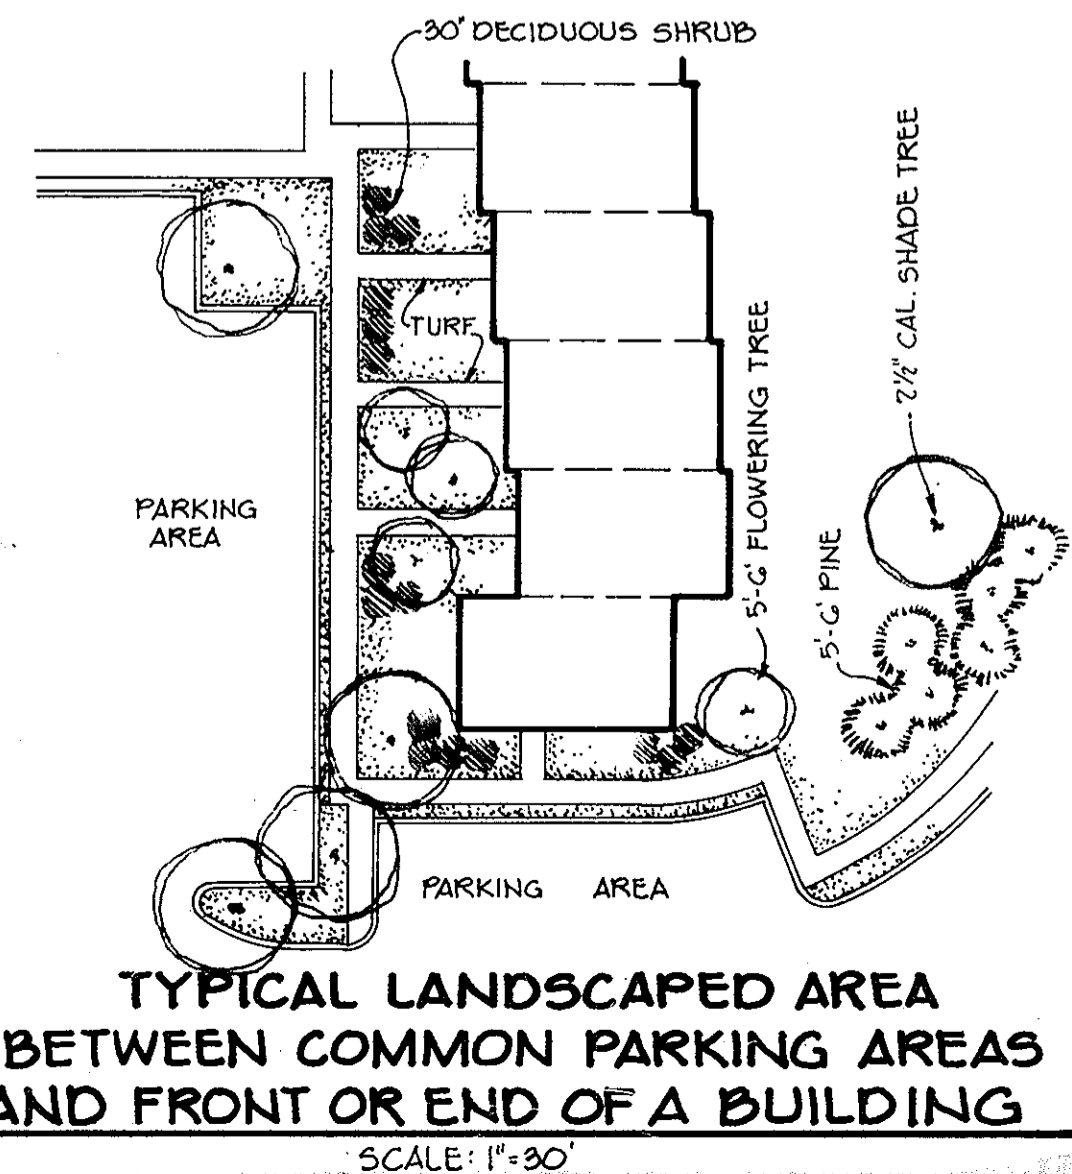

TYPICAL LANDSCAPED AREA
BETWEEN COMMON PARKING AREAS
AND FRONT OR END OF A BUILDING
SCALE: 1"=30'

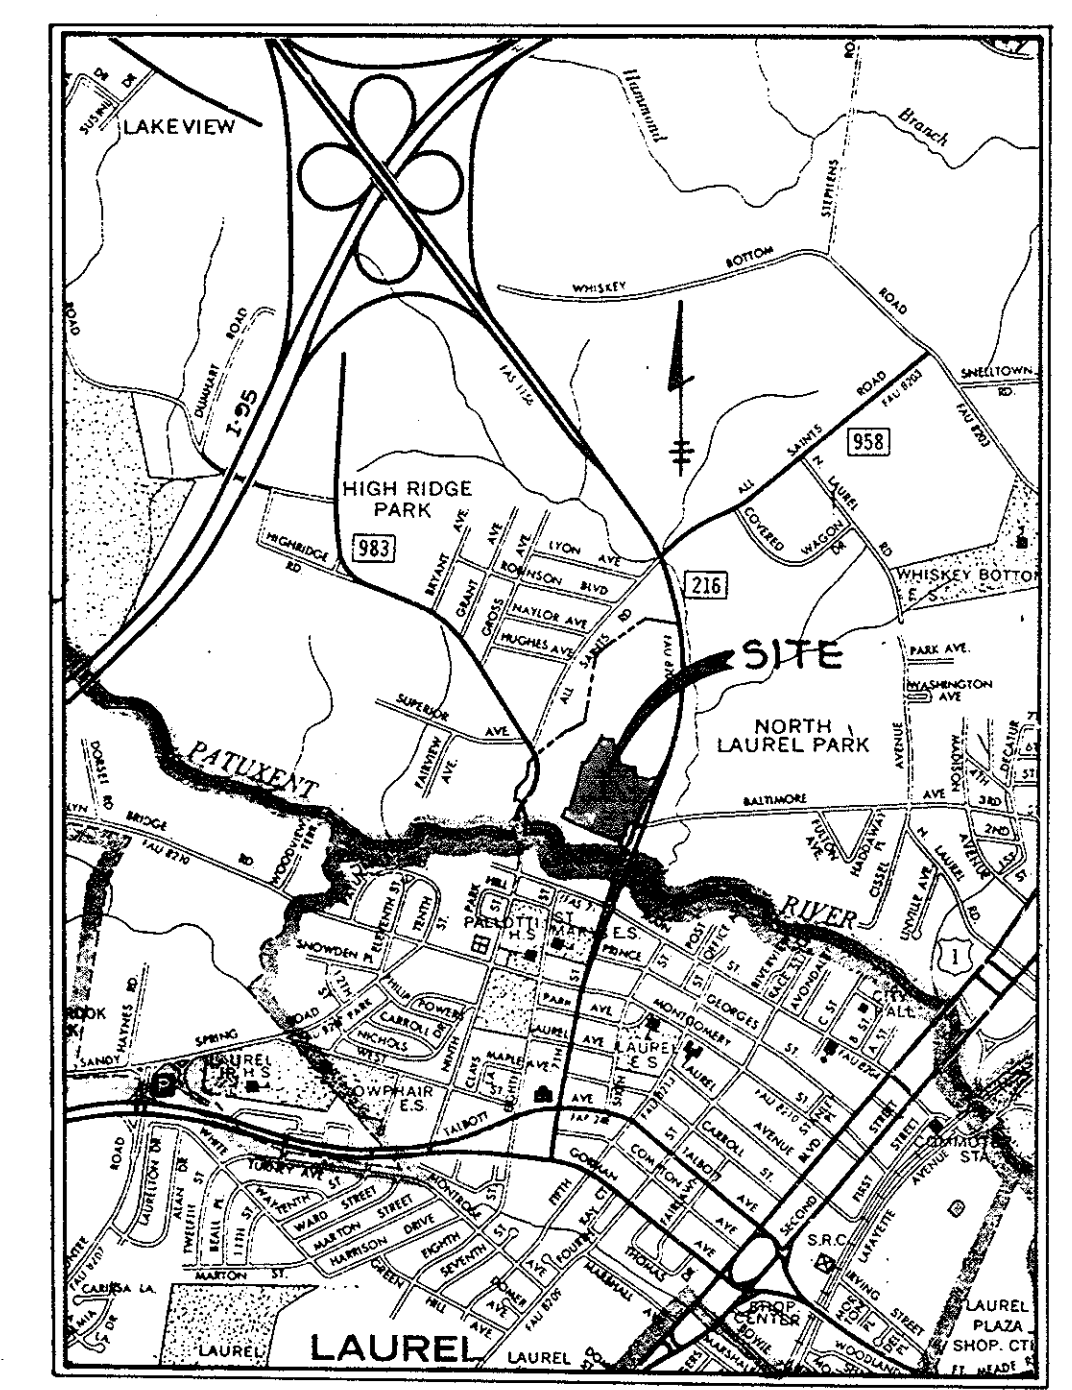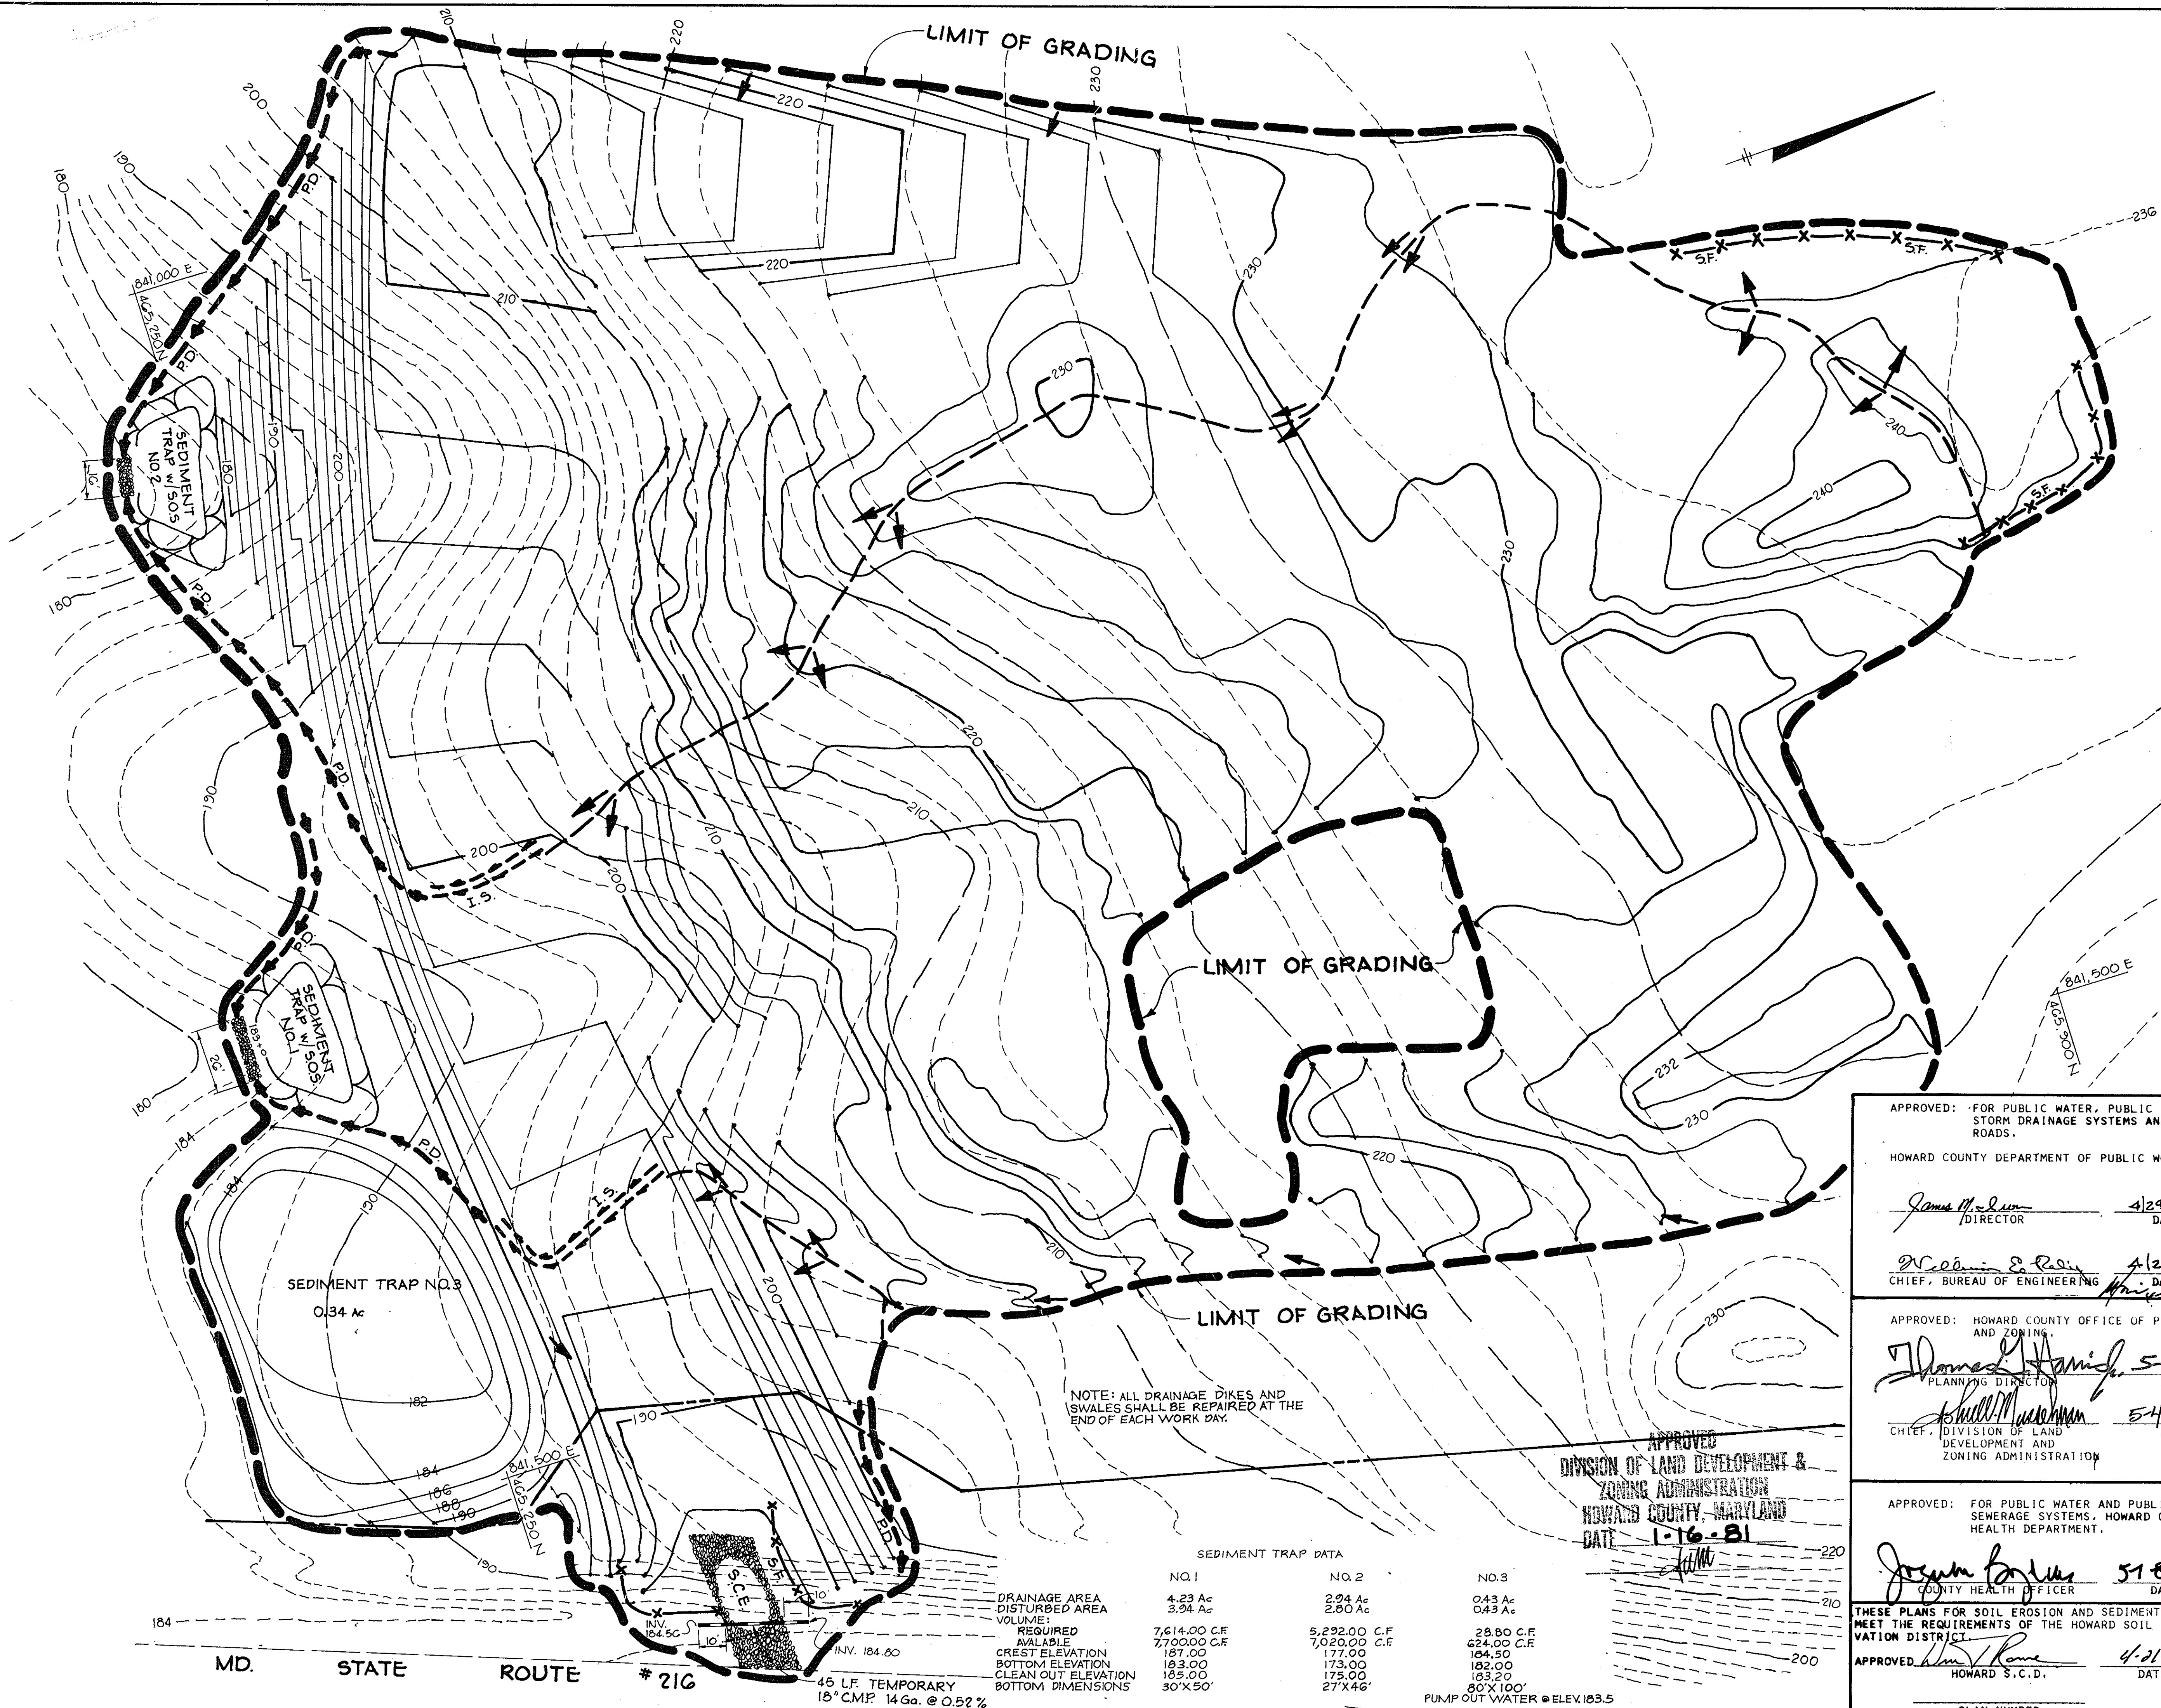

VICINITY MAP
Scale: 1"=2000'

BY THE DEVELOPER:
"I CERTIFY THAT ALL DEVELOPMENT AND/OR CONSTRUCTION WILL BE DONE ACCORDING TO THIS PLAN OF DEVELOPMENT AND PLAN FOR EROSION AND SEDIMENT CONTROL, AND I ALSO AUTHORIZE PERIODIC ON-SITE INSPECTION BY THE HOWARD SOIL CONSERVATION DISTRICT OR THEIR AUTHORIZED AGENTS, AS ARE DEEMED NECESSARY."

Michael B. Glick
DEVELOPER, MICHAEL B. GLICK 9-18-80 DATE

BY THE ENGINEER:
"I CERTIFY THAT THIS PLAN FOR EROSION AND SEDIMENT CONTROL REPRESENTS A PRACTICAL AND WORKABLE PLAN BASED ON MY PERSONAL KNOWLEDGE OF THE SITE CONDITIONS AND THAT IT WAS PREPARED IN ACCORDANCE WITH THE REQUIREMENTS OF THE HOWARD SOIL CONSERVATION DISTRICT."

James V. Tracy
ENGINEER, JAMES V. TRACY 9-18-80 DATE

THESE PLANS HAVE BEEN REVIEWED FOR THE HOWARD SOIL CONSERVATION DISTRICT AND MEET THE TECHNICAL REQUIREMENTS FOR SOIL EROSION AND SEDIMENT CONTROL.

James V. Tracy
U.S. SOIL CONSERVATION SERVICE 4-21-81 DATE

4-15-81 REVISOR PER H.C. COMMENTS DATED 1-19-81
DATE NO. REVISION

OWNER: EASTON ASSOCIATES
12400 CLARKSVILLE PIKE
CLARKSVILLE, MARYLAND 21029

DEVELOPER: EASTON ASSOCIATES
12400 CLARKSVILLE PIKE
CLARKSVILLE, MARYLAND 21029

PROJECT: SETTLER'S LANDING
SECTION 1, AREA 1 LOTS 1 THRU 42

AREA: RECORD PLAT RECORDING REFERENCE NO. 4846
ELECTION DISTRICT NO. 2 HOWARD COUNTY, MARYLAND
TAX MAP NO. 50 PARCEL 346

TITLE: SEDIMENT CONTROL PLAN

TR Riemer - Tracy & Associates, Inc.
8659 Baltimore National Pike
Ellicott City, Maryland 21043
(301) 461-2690
Land Planning, Design & Civil Engineering

DESIGNED BY: J.K.T.
DRAWN BY: D.A.M., L.S.T.

PROJECT NO: 1880
DATE: 8-8-80

SCALE: 1"=30'
DRAWING NO. 5 OF 6

APPROVED: FOR PUBLIC WATER, PUBLIC SEWERAGE,
STORM DRAINAGE SYSTEMS AND PUBLIC
ROADS.

HOWARD COUNTY DEPARTMENT OF PUBLIC WORKS
James M. ... 4/29/81
DIRECTOR DATE

William E. ... 4/29/81
CHIEF, BUREAU OF ENGINEERING DATE

APPROVED: HOWARD COUNTY OFFICE OF PLANNING
AND ZONING.

Thomas ... 5-4-81
PLANNING DIRECTOR DATE

William ... 5-4-81
CHIEF, DIVISION OF LAND
DEVELOPMENT AND
ZONING ADMINISTRATION DATE

APPROVED: FOR PUBLIC WATER AND PUBLIC
SEWERAGE SYSTEMS, HOWARD COUNTY
HEALTH DEPARTMENT.

Joseph ... 5-1-81
COUNTY HEALTH OFFICER DATE

THESE PLANS FOR SOIL EROSION AND SEDIMENT CONTROL
MEET THE REQUIREMENTS OF THE HOWARD SOIL CONSERVATION
DISTRICT.

APPROVED: *James V. Tracy* 4-21-81
HOWARD S.C.D. DATE

PLAN NUMBER


SEDIMENT TRAP DATA

| | NO. 1 | NO. 2 | NO. 3 |
|---------------------|---------------|---------------|-------------|
| DRAINAGE AREA | 4.23 Ac | 2.94 Ac | 0.43 Ac |
| DISTURBED AREA | 3.94 Ac | 2.80 Ac | 0.43 Ac |
| VOLUME REQUIRED | 7,614.00 C.F. | 5,292.00 C.F. | 28.80 C.F. |
| AVAILABLE | 7,700.00 C.F. | 7,020.00 C.F. | 424.00 C.F. |
| CREST ELEVATION | 187.00 | 177.00 | 184.50 |
| BOTTOM ELEVATION | 183.00 | 173.00 | 182.00 |
| CLEAN OUT ELEVATION | 185.00 | 175.00 | 183.20 |
| BOTTOM DIMENSIONS | 30'X50' | 27'X46' | 80'X100' |

45 LF. TEMPORARY
18" CMP 14 Ga. @ 0.52 %
PUMP OUT WATER @ ELEV. 183.5

APPROVED
DIVISION OF LAND DEVELOPMENT &
ZONING ADMINISTRATION
HOWARD COUNTY, MARYLAND
DATE 1-16-81


MD. STATE ROUTE # 216

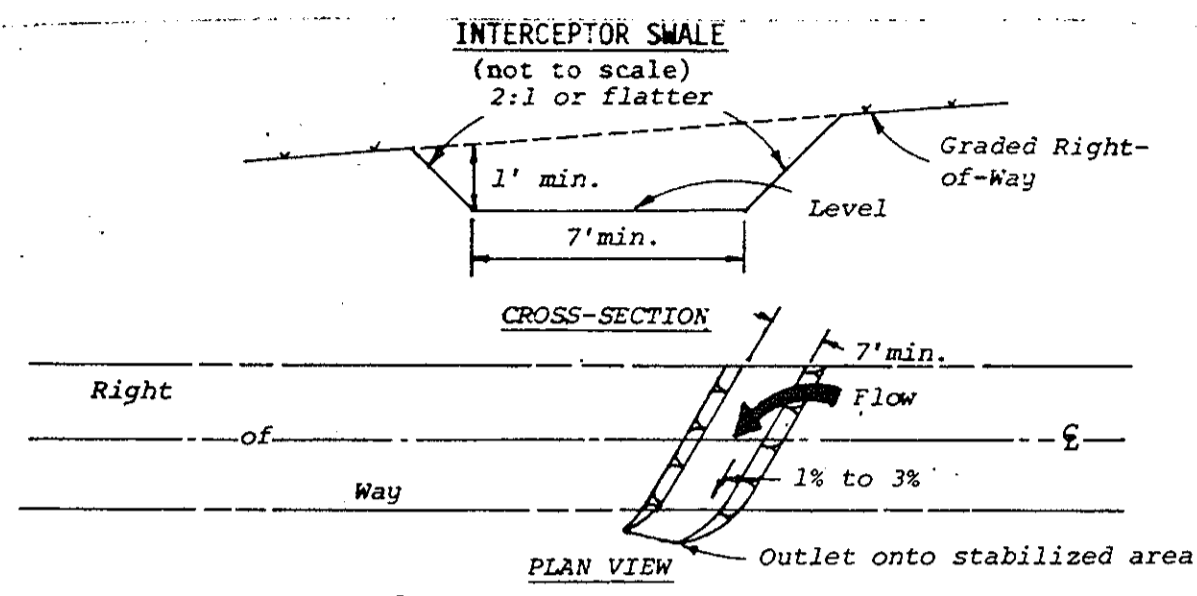


- Construction Specifications**
- All trees, brush, stumps, obstructions, and other objectionable material shall be removed and disposed of so as not to interfere with the proper functioning of the swale.
 - The swale shall be excavated or shaped to line, grade, and cross section as required to meet the criteria specified herein and be free of bank projections or other irregularities which will impede normal flow.
 - Fills shall be compacted as needed to prevent unequal settlement that would cause damage in the complete swale.
 - All earth removed and not needed in construction shall be spread or disposed of so that it will not interfere with the functioning of the swale.
 - Interceptor swales shall have a minimum grade of one percent and the bottom shall be level.
 - An interceptor swale shall have an outlet that functions with a minimum of erosion.
 - Runoff shall be conveyed to a sediment trapping device such as a sediment trap or sediment basin.
 - The on-site location may need to be adjusted to meet field conditions in order to utilize the most suitable outlet.
 - Stabilization shall be: (1) in accordance with the Standard and Specifications for Grassed Waterway; or (2) by lining the flow area with stone that meets MSHA size No. 2 or AASHTO M43 size No. 2 or 24 in a layer at least 3 inches in thickness and pressed into the soil. The lining shall extend across the bottom and up both sides of the channel a height of at least 8 inches vertically above the bottom.
 - Periodic inspection and required maintenance shall be provided.

Standard Symbol IS


INTERCEPTOR SWALE
NO SCALE

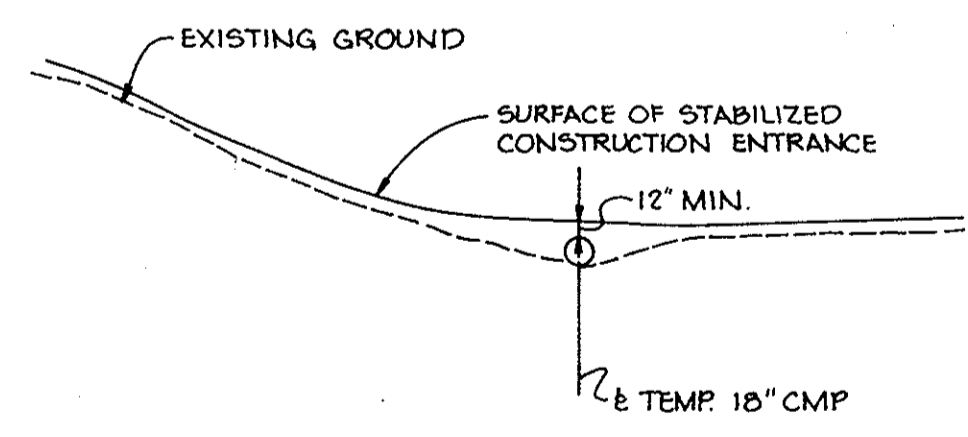

TEMP. 18" D AT STABILIZED CONSTRUCTION ENTRANCE
No Scale

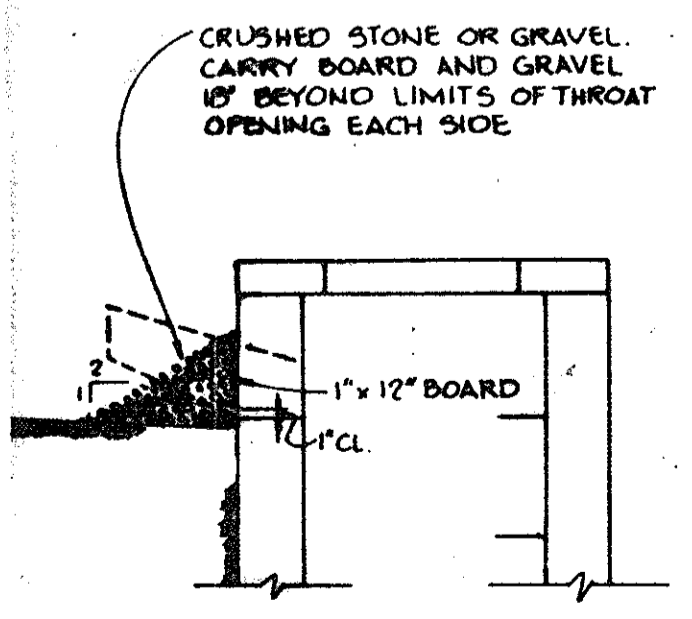


TYPICAL INLET BLOCKING DETAIL
No Scale

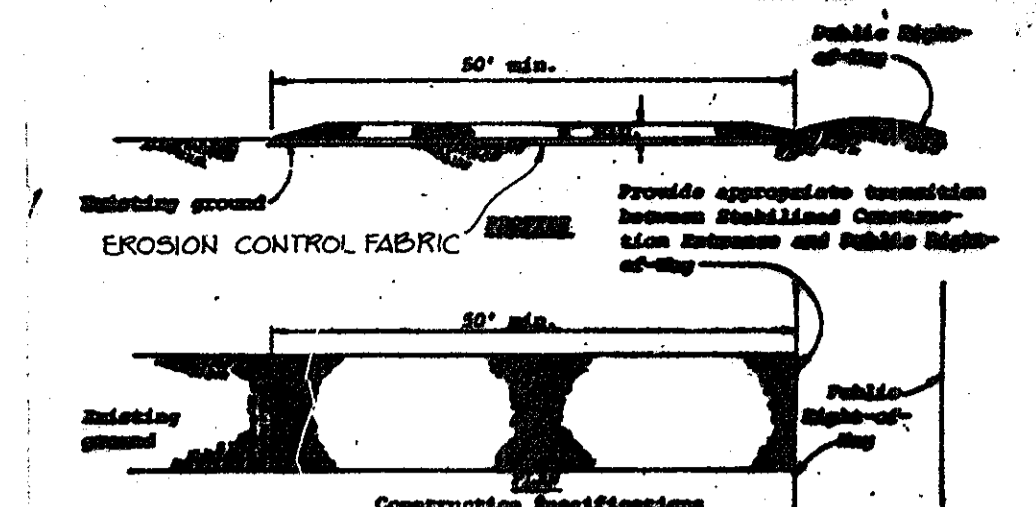



- Construction Specifications**
- Stone size - Use MSHA size No. 2 (3/4" to 1") or AASHTO designation M43, size No. 2 (2-1/2" to 1-1/2"). Use crushed stone.
 - Length - As effective, but not less than 50 feet.
 - Thickness - Not less than eight (8) inches.
 - Width - Not less than full width of all points of ingress or egress.
 - Washing - When necessary, stone shall be cleaned to remove sediment prior to entrance onto public right-of-way. When washing is required, it shall be done on an area stabilized with crushed stone which drains into an approved sediment trap or sediment basin. All sediment shall be prevented from entering any stone drain, ditch, or watercourse through use of sand bags, gravel, boards or other approved methods.
 - Maintenance - The entrance shall be maintained in a condition which will prevent tracking or flinging of sediment onto public right-of-way. This may require periodic top dressing with additional stone or conditions demand and repair and/or placement of any materials used to trap sediment. All sediment spilled, dropped, washed or tracked onto public right-of-way must be removed immediately.

STABILIZED CONSTRUCTION ENTRANCE
NO SCALE

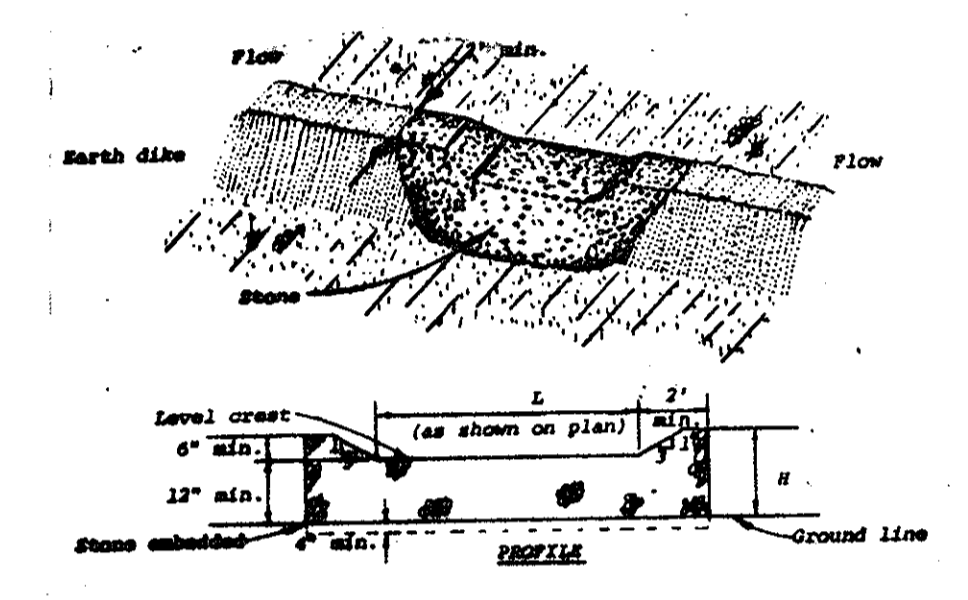

- Construction Specifications**
- The stone shall be crushed stone. Gravel may be used if crushed stone is not available. The stone shall meet MSHA Size No. 2 or AASHTO designation M43 Size No. 2 or 24.
 - The crest of the stone dike shall be at least six inches lower than the lowest elevation of the top of the earth dike and shall be level.
 - The stone outlet structure shall be embedded into the soil a minimum of four inches.
 - The minimum length, in feet, of the crest of the stone outlet structure shall be equal to six times the number of acres of contributing drainage area.
 - The stone outlet structure shall be inspected after each rain, and the stone shall be replaced when the structure ceases to function as intended due to silt accumulation among the stone, washout, construction traffic damage, etc.

STONE OUTLET STRUCTURE
NO SCALE

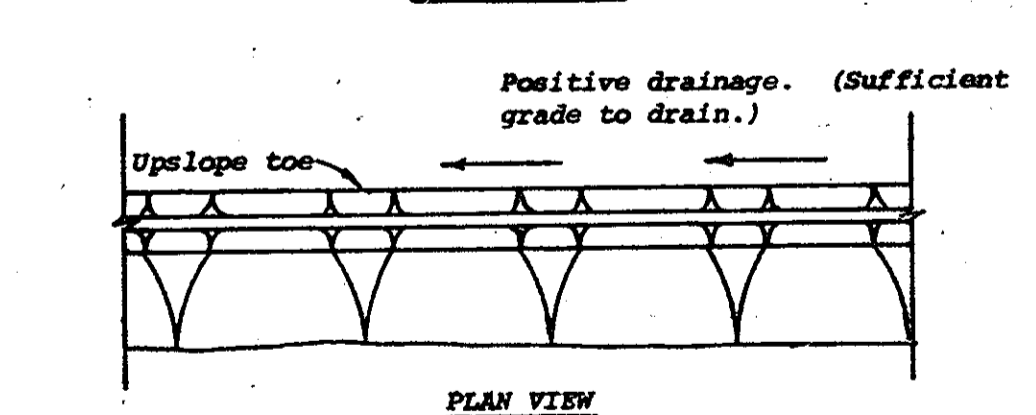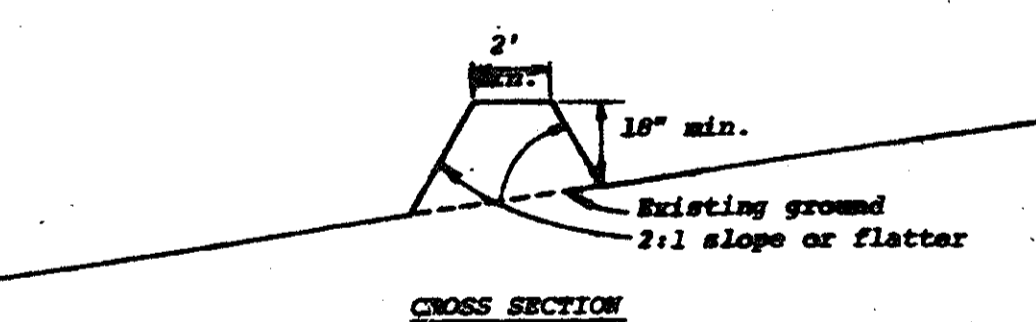

- Construction Specifications**
- All dikes shall be machine compacted.
 - All perimeter dikes shall have positive drainage to an outlet.
 - A. Diverted runoff from a protected or stabilized upland area shall outlet directly onto an undisturbed stabilized area or into a level spreader or grade stabilization structure.
 - B. Diverted runoff from a disturbed or exposed upland area shall be conveyed to a sediment trapping device such as a sediment trap or a sediment basin or to an area protected by any of these practices.
 - Stabilization, when required, shall be done in accordance with Standard and Specifications for Grassed Waterway. The minimum area to be stabilized shall be the channel flow area.
 - Periodic inspection and required maintenance shall be provided.

Standard Symbol PD
* Drainage area less than 5 acres

PERIMETER DIKE
NO SCALE

SEDIMENT CONTROL CONSTRUCTION NOTES
GENERAL NOTES


- A MINIMUM OF 24 HOURS NOTICE MUST BE GIVEN TO THE HOWARD COUNTY OFFICE OF INSPECTION AND PERMITS PRIOR TO THE START OF ANY CONSTRUCTION (922-2070).
- ALL SEDIMENT CONTROL STRUCTURES WILL BE INSTALLED IN ACCORDANCE WITH THE STANDARDS AND SPECIFICATIONS FOR SOIL EROSION AND SEDIMENT CONTROL IN DEVELOPING AREAS AS PREPARED BY THE U.S. DEPARTMENT OF AGRICULTURE SOIL CONSERVATION SERVICE.
- SITE GRADING WILL BEGIN ONLY AFTER ALL PERIMETER SEDIMENT CONTROL MEASURES HAVE BEEN INSTALLED AND ARE IN A FUNCTIONING CONDITION.
- ALL DISTURBED AREAS ARE TO BE DRESSED AND STABILIZED ACCORDING TO THE TEMPORARY OR PERMANENT SEEDING SCHEDULES AS SOON AS PROPER WEATHER CONDITIONS EXIST FOR THE ESTABLISHMENT OF A PERMANENT VEGETATIVE COVER.
- SEDIMENT WILL BE REMOVED FROM TRAPS WHEN THE DEPTH REACHES THE CLEAN OUT ELEVATION SHOWN ON THE PLANS.
- FERTILIZER AND LIME RATES MAY BE CHANGED THROUGH AUTHORIZATION BY THE HOWARD COUNTY SOIL CONSERVATION DISTRICT IF SOIL TESTS DETERMINE A REDUCTION IN THE SPECIFIED RATES IS JUSTIFIED.
- ALL SEDIMENT CONTROL STRUCTURES ARE TO REMAIN IN PLACE AND ARE TO BE MAINTAINED IN OPERATIVE CONDITION UNTIL PERMISSION FOR THEIR REMOVAL HAS BEEN OBTAINED FROM THE HOWARD COUNTY SEDIMENT CONTROL INSPECTOR.
- REFERENCES CALLED FOR ON THE SEDIMENT CONTROL CONSTRUCTION PLAN AND DETAILS ARE MADE TO "THE STANDARDS AND SPECIFICATIONS FOR SOIL EROSION AND SEDIMENT CONTROL IN DEVELOPING AREAS".
- SEDIMENT CONTROL WILL BE INSTALLED BEFORE CLEARING AND GRUBBING REMAINDER OF SITE.

TEMPORARY SEEDING

- AREA TO BE SEEDDED SHALL BE RECENTLY LOOSENEED. IF THE GROUND IS PACKED, CRUSTED OR HARD, THE TOP LAYER OF SOIL SHALL BE LOOSENEED BY DISCING, RACKING OR OTHER ACCEPTABLE MEANS.
- APPLY 10-20-10 FERTILIZER (OR EQUIVALENT) AT THE RATE OF 600 LBS. PER ACRE OR 15 LBS. PER 1000 SQ. FT.
 - WHERE SOIL IS KNOWN TO BE HIGHLY ACID, APPLY DOLOMITIC LIMESTONE AT THE RATE OF 1 TON PER ACRE.
 - WORK BOTH INTO SOIL AND SEED WITH CYCLONE SEEDER, DRILL, CULTIPAKER SEEDER OR HYDROSEEDER (SLURRY WILL INCLUDE SEED AND FERTILIZER) AT THE RATE OF 40 LBS. PER ACRE OF ITALIAN OR PERENNIAL RYEGRASS.
 - MULCH WITH UNWEATHERED SMALL GRAIN STRAW AT THE RATE OF 1 1/2 TO 2 TONS PER ACRE AND ANCHOR WITH A CUTBACK ASPHALT OR EMULSIFIED ASPHALT AT THE RATE OF 5 GAL. PER 1000 SQ. FT.

PERMANENT SEEDING

- FINAL STABILIZATION WILL TAKE PLACE AS SOON AS POSSIBLE AS WEATHER CONDITIONS PERMIT, AS FOLLOWS:
- APPLY DOLOMITIC LIMESTONE AT THE RATE OF 2 TONS PER ACRE (ONE TON PER ACRE IF APPLICATION OF TON PER ACRE WAS MADE FOR TEMPORARY SEEDING).
 - APPLY 0-20-20 FERTILIZER AT THE RATE OF 600 LBS. PER ACRE HARROW OR DISC LIME AND 0-20-20 FERTILIZER INTO THE SOIL TO A MINIMUM DEPTH OF 3" LAWN OR HIGH MAINTENANCE AREAS WILL BE DRAGGED AND LEVELED WITH A YORK RAKE. AT THE TIME OF SEEDING APPLY 400 POUNDS OF 38-0-0 UREAFORM FERTILIZER AND 500 LBS. OF 10-20-20 OR EQUIVALENT FERTILIZER PER ACRE.
 - SEED WITH A MIXTURE OF CERTIFIED "MERION" KENTUCKY BLUEGRASS - 40 LBS. PER ACRE; COMMON KENTUCKY BLUEGRASS @ 40 LBS. PER ACRE; RED FESCUE, PENNLAWN OR JAMESTOWN @ 20 LBS. PER ACRE.
 - MULCH WITH UNWEATHERED SMALL GRAIN STRAW AT THE RATE OF 1 1/2 TO 2 TONS PER ACRE AND ANCHOR WITH A CUTBACK ASPHALT OR EMULSIFIED ASPHALT AT THE RATE OF 5 GAL. PER 1000 SQ. FT.
 - SEED ALL SLOPES WITH A MIXTURE OF CERTIFIED KENTUCKY 31 TALL FESCUE @ 50 LBS. PER ACRE AND INOCULATED KOREAN LESPEDEZA @ 15 LBS. PER ACRE.

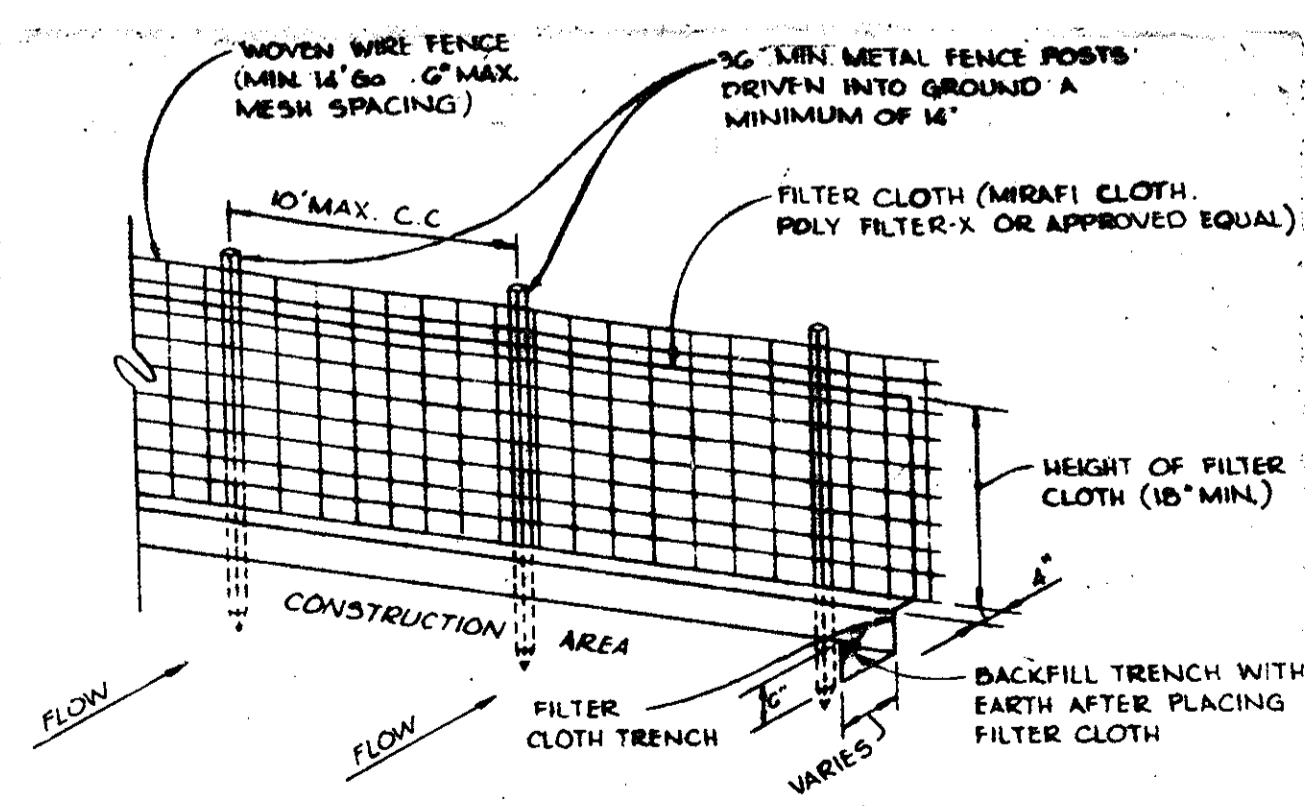

- NOTES:**
- WOVEN WIRE FENCE TO BE FASTENED SECURELY TO FENCE POSTS BY USE OF WIRE TIES.
 - FILTER CLOTH TO BE FASTENED SECURELY TO WOVEN WIRE FENCE BY USE OF WIRE TIES SPACED EVERY 24" X 24".
 - SILT FENCE TO BE PLACED IN LIEU OF STRAW BALES AND/OR DIVERSION DIKES AT THE OPTION OF THE DEVELOPER.

SILT FENCE DETAIL
No Scale

APPROVED
DIVISION OF LAND DEVELOPMENT & ZONING ADMINISTRATION
HOWARD COUNTY, MARYLAND
DATE 1-16-81
JMM

APPROVED: FOR PUBLIC WATER, PUBLIC SEWERAGE, STORM DRAINAGE SYSTEMS AND PUBLIC ROADS.

HOWARD COUNTY DEPARTMENT OF PUBLIC WORKS
James M. ... 4/29/81
DIRECTOR DATE
W. ... 4/29/81
CHIEF, BUREAU OF ENGINEERING DATE

APPROVED: HOWARD COUNTY OFFICE OF PLANNING AND ZONING.
Thomas ... 5-4-81
PLANNING DIRECTOR DATE
John ... 5-4-81
CHIEF, DIVISION OF LAND DEVELOPMENT AND ZONING ADMINISTRATION DATE

APPROVED: FOR PUBLIC WATER AND PUBLIC SEWERAGE SYSTEMS, HOWARD COUNTY HEALTH DEPARTMENT.
Joseph ... 5-1-81
COUNTY HEALTH OFFICER DATE

THESE PLANS FOR SOIL EROSION AND SEDIMENT CONTROL MEET THE REQUIREMENTS OF THE HOWARD COUNTY SOIL CONSERVATION DISTRICT.
APPROVED *William ...* 4-21-81
HOWARD S.C.D. DATE

BY THE DEVELOPER:
"I CERTIFY THAT ALL DEVELOPMENT AND/OR CONSTRUCTION WILL BE DONE ACCORDING TO THIS PLAN OF DEVELOPMENT AND PLAN FOR EROSION AND SEDIMENT CONTROL, AND I ALSO AUTHORIZE PERIODIC ON-SITE INSPECTION BY THE HOWARD COUNTY SOIL CONSERVATION DISTRICT OR THEIR AUTHORIZED AGENTS, AS ARE DEEMED NECESSARY."
Michael B. Glick 9-18-80
DEVELOPER, MICHAEL B. GLICK DATE

BY THE ENGINEER:
"I CERTIFY THAT THIS PLAN FOR EROSION AND SEDIMENT CONTROL REPRESENTS A PRACTICAL AND WORKABLE PLAN BASED ON MY PERSONAL KNOWLEDGE OF THE SITE CONDITIONS AND THAT IT WAS PREPARED IN ACCORDANCE WITH THE REQUIREMENTS OF THE HOWARD COUNTY SOIL CONSERVATION DISTRICT."
James K. Tracy 9-18-80
ENGINEER, JAMES K. TRACY DATE

THESE PLANS HAVE BEEN REVIEWED FOR THE HOWARD COUNTY SOIL CONSERVATION DISTRICT AND MEET THE TECHNICAL REQUIREMENTS FOR SOIL EROSION AND SEDIMENT CONTROL.
Joseph ... 4-7-81
U.S. SOIL CONSERVATION SERVICE DATE

4-15-81 REVISOR PER H.C. COMMENTS DATED 1-19-81
DATE NO. REVISION
OWNER: EASTON ASSOCIATES
12400 CLARKSVILLE PIKE
CLARKSVILLE, MARYLAND 21029
DEVELOPER: EASTON ASSOCIATES
12400 CLARKSVILLE PIKE
CLARKSVILLE, MARYLAND 21029
PROJECT: SETTLER'S LANDING
SECTION 1, AREA 1, LOTS 1-49
AREA: RECORD PLAT RECORDING REFERENCE N° 4846
ELECTION DISTRICT N° 6 HOWARD COUNTY, MARYLAND
TAX MAP N° 50 PARCEL 346
TITLE: SEDIMENT CONTROL DETAILS

9-19-80 DATE

DESIGNED BY: J.K.T.
DRAWN BY: D.A.M.
PROJECT NO: 1880
DATE: SEPT. 18, 1980
SCALE: NONE
DRAWING NO. 6 OF 6
Riemer - Tracy & Associates, Inc.
8859 Baltimore National Pike
Silver Spring, Maryland 21043
(301) 461-2690
Land Planning, Design & Civil Engineering