



I WOVEN WIRE FELICE TO BE FASTELLED SECURELY TO FENCE POSTS BY USE 7. FILTER CLOTH TO BE FASTELIED SECURELY

TO WOVEL WIRE FELICE BY USE OF WIRE TIES.

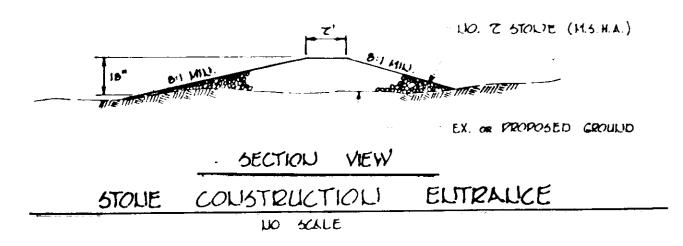

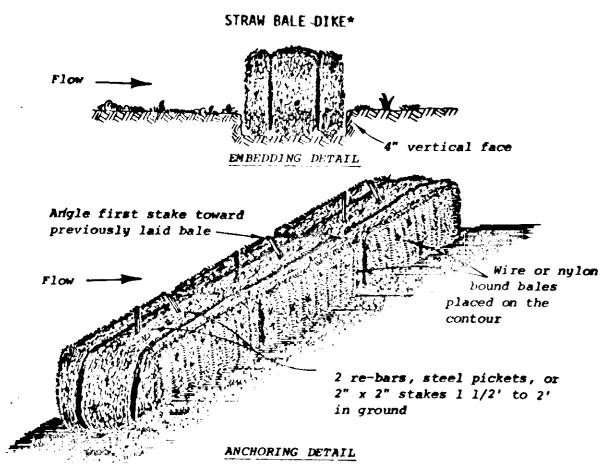



# Construction Specifications


- 1. Bales shall be placed in a row with ends tightly abutting the adjacent bales.
- 2. Each bale shall be embedded in the soil a minimum of 4". 3. Bales shall be securely anchored in place by stakes or re-bars driven through the bales. The first stake in each bale shall be
- angled toward previously laid bale to force bales together. 4. Inspection shall be frequent and repair or replacement shall be
- made promptly as needed. 5. Bales shall be removed when they have served their usefulness so

as not to block or impede storm flow or drainage.

Standard Symbol

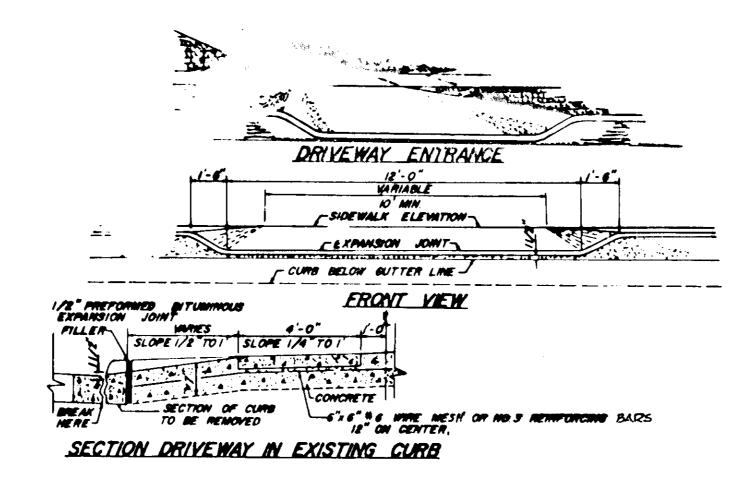

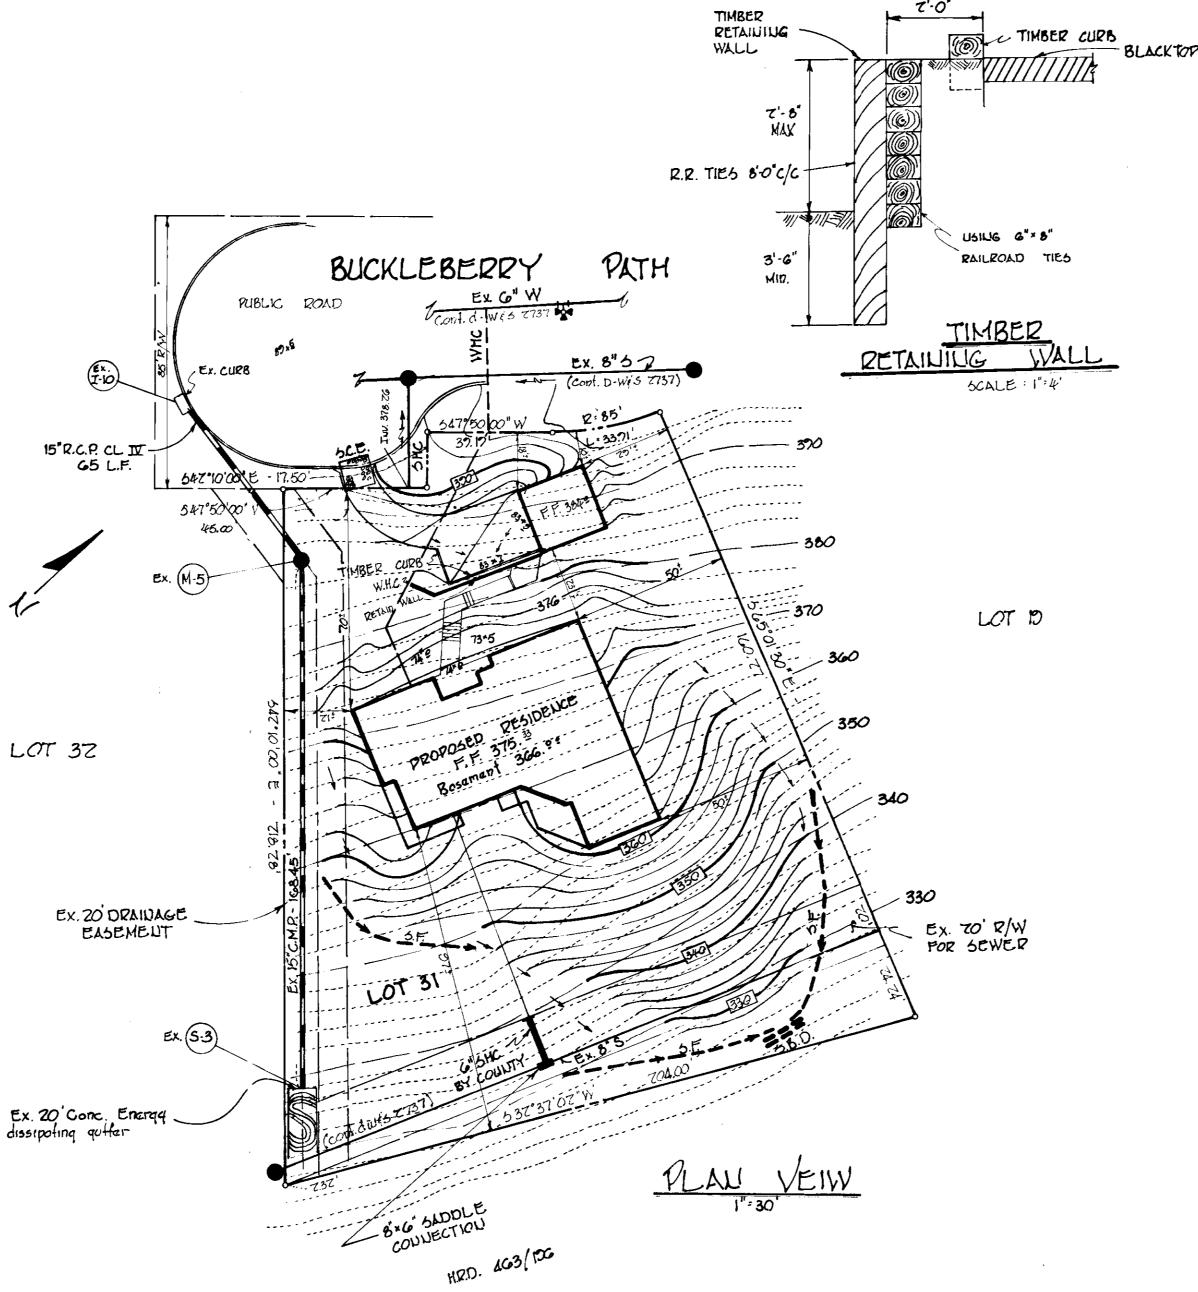

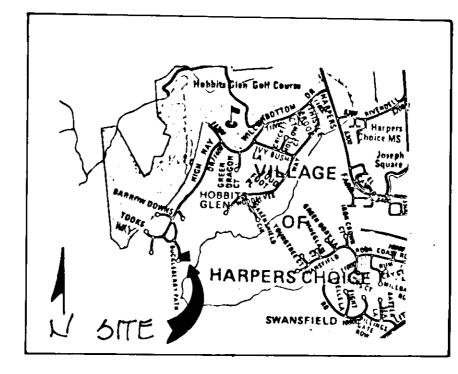

### GENERAL NOTES

- 1. Grading Permits shall be obtained prior to installation of Sediment Control & Grading.
- All Sediment and Erosion Control Measures will be installed and stabilized according to this plan prior to any other grading, clearing or disturbance of the existing surface of the site. See Note #6 for stabilization except that the seed mixture will be annual rye applied at a rate of 1.4 lbs/1000 sf.
- 3. Notify the Bureau of Inspections and Permits at least 24 hours before starting any work.
- 4. All Sediment Control Practices to conform to the "Standards and Specifications for Soil Erosion and Sediment Control in Developing Areas" and shall be adjusted to meet actual field conditions.
- 5. Stabilization of Disturbed Ground to be done as soon after construction as possible.
- 6. All Grading shall be treated in accordance with the following Specifications: a. Seed - certified 85% germination applied at the rate of 3 lbs/1000 sf. Mixture - 40% Kentucky Blue, 20% Chewing Fescue, 20% Kentucky 31, and 20% Annual Rye.
  - b. Fertilizer 10:10:10 applied at the rate of 23 lbs/1000 sq. ft. Ground Agricultural Lime or Dolomitic Lime applied at the rate of 46 lbs/1000 sf. c. Mulch - Weed free grain straw applied at the rate of 70 lbs/1000 sf. Mulch shall be secured to the ground by any approved method i.e. asphalt tacks, chemical binder, wood chips etc.
- 7. All Structural Sediment Control Measures are to remain in place until permission for their removal has been obtained from the Bureau of Inspections and Permits.
- 8. On Site Inspection and Maintenance of all Sediment Control Measures including clean out of sediment traps and dikes, and proper establishment of all planned vegetative measures will be the responsibility of the Developer or his representative on the site, on a continuing day to day basis.
- 9. Protection of stabilized area from sediment runoff shall be provided by the use of an approved Sediment Control Device, i.e. straw bale, diversion dike, etc.
- 10. The Contractor shall keep all public roads free of sediment deposits left from traffic leaving construction site.
- 11. Stabilized Construction Entrances shall be placed at all construction entrances.

### 17. SITE ANALYSIS

: 33,435, or .767 t acre 1. TOTAL AREA T. AREA TO BE ROOFED 3. AREA TO BE PAVED 1,183 # 4. AREA TO BE SEEDED 73,806 \* 4,317 <sup>#</sup> 5. AREA TO BE UNDISTURBED:

# 13. CONSTRUCTION SEQUENCE

1. OBTAIL GRADING PERMIT. 2. INSTALL SEDIMENT : EROSION CONTROL DEVICES AND STABILIZE

3. EXCAVATE FOR FOULDATIONS AND ROUGH GRADE. 4. ERECT STRUCTURES, DRIVEWAYS, SIDEWALKS AND LAY WATER & SEWER HOUSE CONNECTIONS 5. FINAL GRADE AND STABILIZE IN ACCORDANCE WITH

1. The land included in this area is zoned Llaw Town (S.M.F.D.) z. The lot shown on this plan is covared by time! Development Plan Plasa 130-L

3. The area included in this plan is 33,435 sq. fl. 4. Lot 31 is recorded in plot 4148

5. Ex. & proposad SHC Ac-3300 6. Ex & proposad Water house connections is 3/4 copper.

7. Ex. Water Main is Ductile Iron.

# LEGEUD:

15' 6' 79'-4"

I. CONTOUR INTERVAL 7. EXISTING CONTOUR 3. PROPOSED CONTOUR - 330 4.5 POT ELEVATION 7. STONE CONSTRUCTION ENTRANCE & & SCE.

> APPROVED PLANNING BOARD

OF HOWARD COURTS DATE 6-20-79

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APPROVED: FOR PUBLIC WATER AND PUBLIC SEWERAGE SYSTEMS, HOWARD COUNTY HEALTH DEPARTMENT

APPROVED: FOR PUBLIC WATER AND PUBLIC SEWERAGE, STORM DRAINAGE SYSTEMS AND PUBLIC ROADS HOWARD COUNTY DEPARTMENT OF PUBLIC WORKS Chief Bureau of Engineering

### CERTIFICATION BY THE DEVELOPER:

"I CERTIFY THAT ALL DEVELOPMENT AND/OR CONSTRUCTION WI AS ARE DEFINED NECESSARY". DEVIATION FROM THIS PLAN WILL NOT BE MADE UNLESS AUTHORIZED BY THE HOWARD SOIL CONSERVATION DISTRICT.

5/10/79 DATE

### CERTIFICATION BY THE ENGINEER:

"I CERTIFY THAT THIS PLAN FOR EROSION AND SEDIMENT BASED ON MY PERSONAL KNOWLEDGE OF THE SITE CONDITIONS AND THAT IT WAS PREPARED IN ACCORDANCE WITH THE REQUIREMENTS OF THE HOWARD SOIL CONSERVATION DISTRICT"



THESE PLANS HAVE BEEN REVIEWED FOR THE HOWARD SOIL CONSERVATION DISTRICT AND MEET THE TECHNICAL REQUIREMENTS FOR SOIL EROSION AND SEDIMENT CONTROL

6-27-79 U.S. SOIL CONSERVATION SERVICE

THESE PLANS HAVE BEEN REVIEWED FOR THE HOWARD SOIL CONSERVATION DISTRICT AND MEET THE TECHNICAL REQUIREMENTS FOR SOIL EROSION AND SEDIMENT CONTROL.

6-26-79

DATE NO. REVISION DESCRIPTION OWNER: TÉT CORPORATION 5471 WILGBORUE COURT COLUMBIA , MD. 71044 DEVELOPER: TET CORPORATION 5471 WILLGBORUE COURT COLUMBIA, MD 71044 PROJECT:

LOT 31 BUCKLEBERRY PATH PLAT C.M.P. 4148 COLUMBIA

VILLAGE OF HARPER'S CHOICE SEC. 7 AREA 4. FIFTH ELECTION DISTRICT HOWARD COUNTY, MD.

SITE DEVELOPMENT PLAN



8370 COURT AVENUE, ELLICOTT CITY, MD. 21043 465-0660



DESIGNED BY: DRAWN BY: T.L.P. PROJECT NO: 577 DATE: MAY , 1979 SCALE: As Shown PROFESSIONAL ENGR. NO.9566 DRAWING NO \_\_\_ OF \_\_