









**CURB TRANSITION PLAN**  
SCALE: 1" = 50'

APPROVED: HOWARD COUNTY DEPARTMENT OF PLANNING AND ZONING

*Chad Edwards* 5-20-15  
CHIEF, DEVELOPMENT ENGINEERING DIVISION DATE

*Neil Shaban* 6-02-15  
CHIEF, DIVISION OF LAND DEVELOPMENT DATE

*David A. Cagle* 6/1/15  
DIRECTOR DATE

**OWNER/DEVELOPER**  
U.S. HOME CORPORATION  
C/O JOSEPH FORTINO  
10211 WINGOPIN CIRCLE  
SUITE 180  
COLUMBIA, MD 21044  
410-997-5522

NO.	REVISION	DATE
1	REVISE PLAN TO ADD A 4" HIGH ORNAMENTAL WALL AND A 6" HIGH PRIVACY FENCE ALONG THE S-EASTERN PROPERTY LINE	12/21/16

**SITE DEVELOPMENT PLAN**  
**CURB TRANSITION PLAN**  
**BLUE STREAM TOWNS - SECTION 2**  
BLUE STREAM  
LOTS 1-105, AND OPEN SPACE LOT 106  
A RE-SUBDIVISION OF BUILDABLE BULK PARCEL L-1  
TAX MAP 43 GRID 4 PARCEL 14  
1ST ELECTION DISTRICT ZONED: CAC-CL1 HOWARD COUNTY, MARYLAND

**ROBERT H. VOGEL ENGINEERING, INC.**  
ENGINEERS • SURVEYORS • PLANNERS  
8407 MAIN STREET TEL: 410.461.7666  
ELLICOTT CITY, MD 21043 FAX: 410.461.8961


PROFESSIONAL CERTIFICATE

DESIGN BY: RHV  
DRAWN BY: JMR  
CHECKED BY: RHV  
DATE: APRIL 2015  
SCALE: AS SHOWN  
W.O. NO.: 06-26.14

I HEREBY CERTIFY THAT THESE DOCUMENTS WERE PREPARED OR APPROVED BY ME, AND THAT I AM A FULLY LICENSED PROFESSIONAL ENGINEER UNDER THE LAWS OF THE STATE OF MARYLAND, LICENSE NO. 16183, EXPIRATION DATE: 06-27-2014.


4 SHEET OF 13

ROBERT H. VOGEL, PE No. 16183

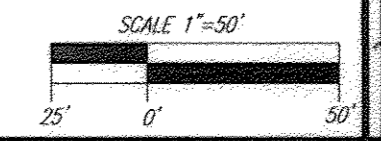

**LEGEND:**

	PROPERTY LINE		SOILS		10' PARKING SETBACK EX. 10' PUBLIC SIDEWALK, STREET LIGHT & STREET TREE MAINTENANCE EASEMENT (PLAT 21558-21564)
	RIGHT-OF-WAY LINE		EXISTING WATER LINE		VARIABLE WIDTH PUBLIC SEWER, WATER & UTILITY EASEMENT (PLAT 23232-42)
	ADJACENT PROPERTY LINE		EXISTING TREENLINE		10' RETAINING WALL CONSTRUCTION BUFFER & NO PLANTING ZONE (PLAT 23232-42)
	EXISTING CURB AND GUTTER		EXISTING TREES		PROPOSED STABILIZED CONSTRUCTION ENTRANCE
	EXISTING UTILITY POLE		EXISTING FENCE		PROPOSED SUPER SILT FENCE
	EXISTING LIGHT POLE		EXISTING STEEP SLOPES		PROPOSED LIMIT OF DISTURBANCE
	EXISTING SIGN		PROPOSED STORMDRAIN		PROPOSED CURB INLET PROTECTION
	EXISTING SANITARY MANHOLE		PROPOSED STORMDRAIN INLET		PROPOSED AT-GRADE INLET PROTECTION
	EXISTING SANITARY LINE		PROPOSED SIDEWALK		PROPOSED TREE PROTECTION FENCE
	EXISTING CLEANOUT		PROPOSED TREENLINE		
	EXISTING FIRE HYDRANT		PROPOSED CURB		
	EXISTING 10' CONTOUR		PROPOSED STREET LIGHT		
	EXISTING 2' CONTOUR		PROPOSED 10' CONTOUR		
	PROPOSED 10' CONTOUR		PROPOSED 2' CONTOUR		
	PROPOSED 2' CONTOUR		PROPOSED SPOT ELEVATION		

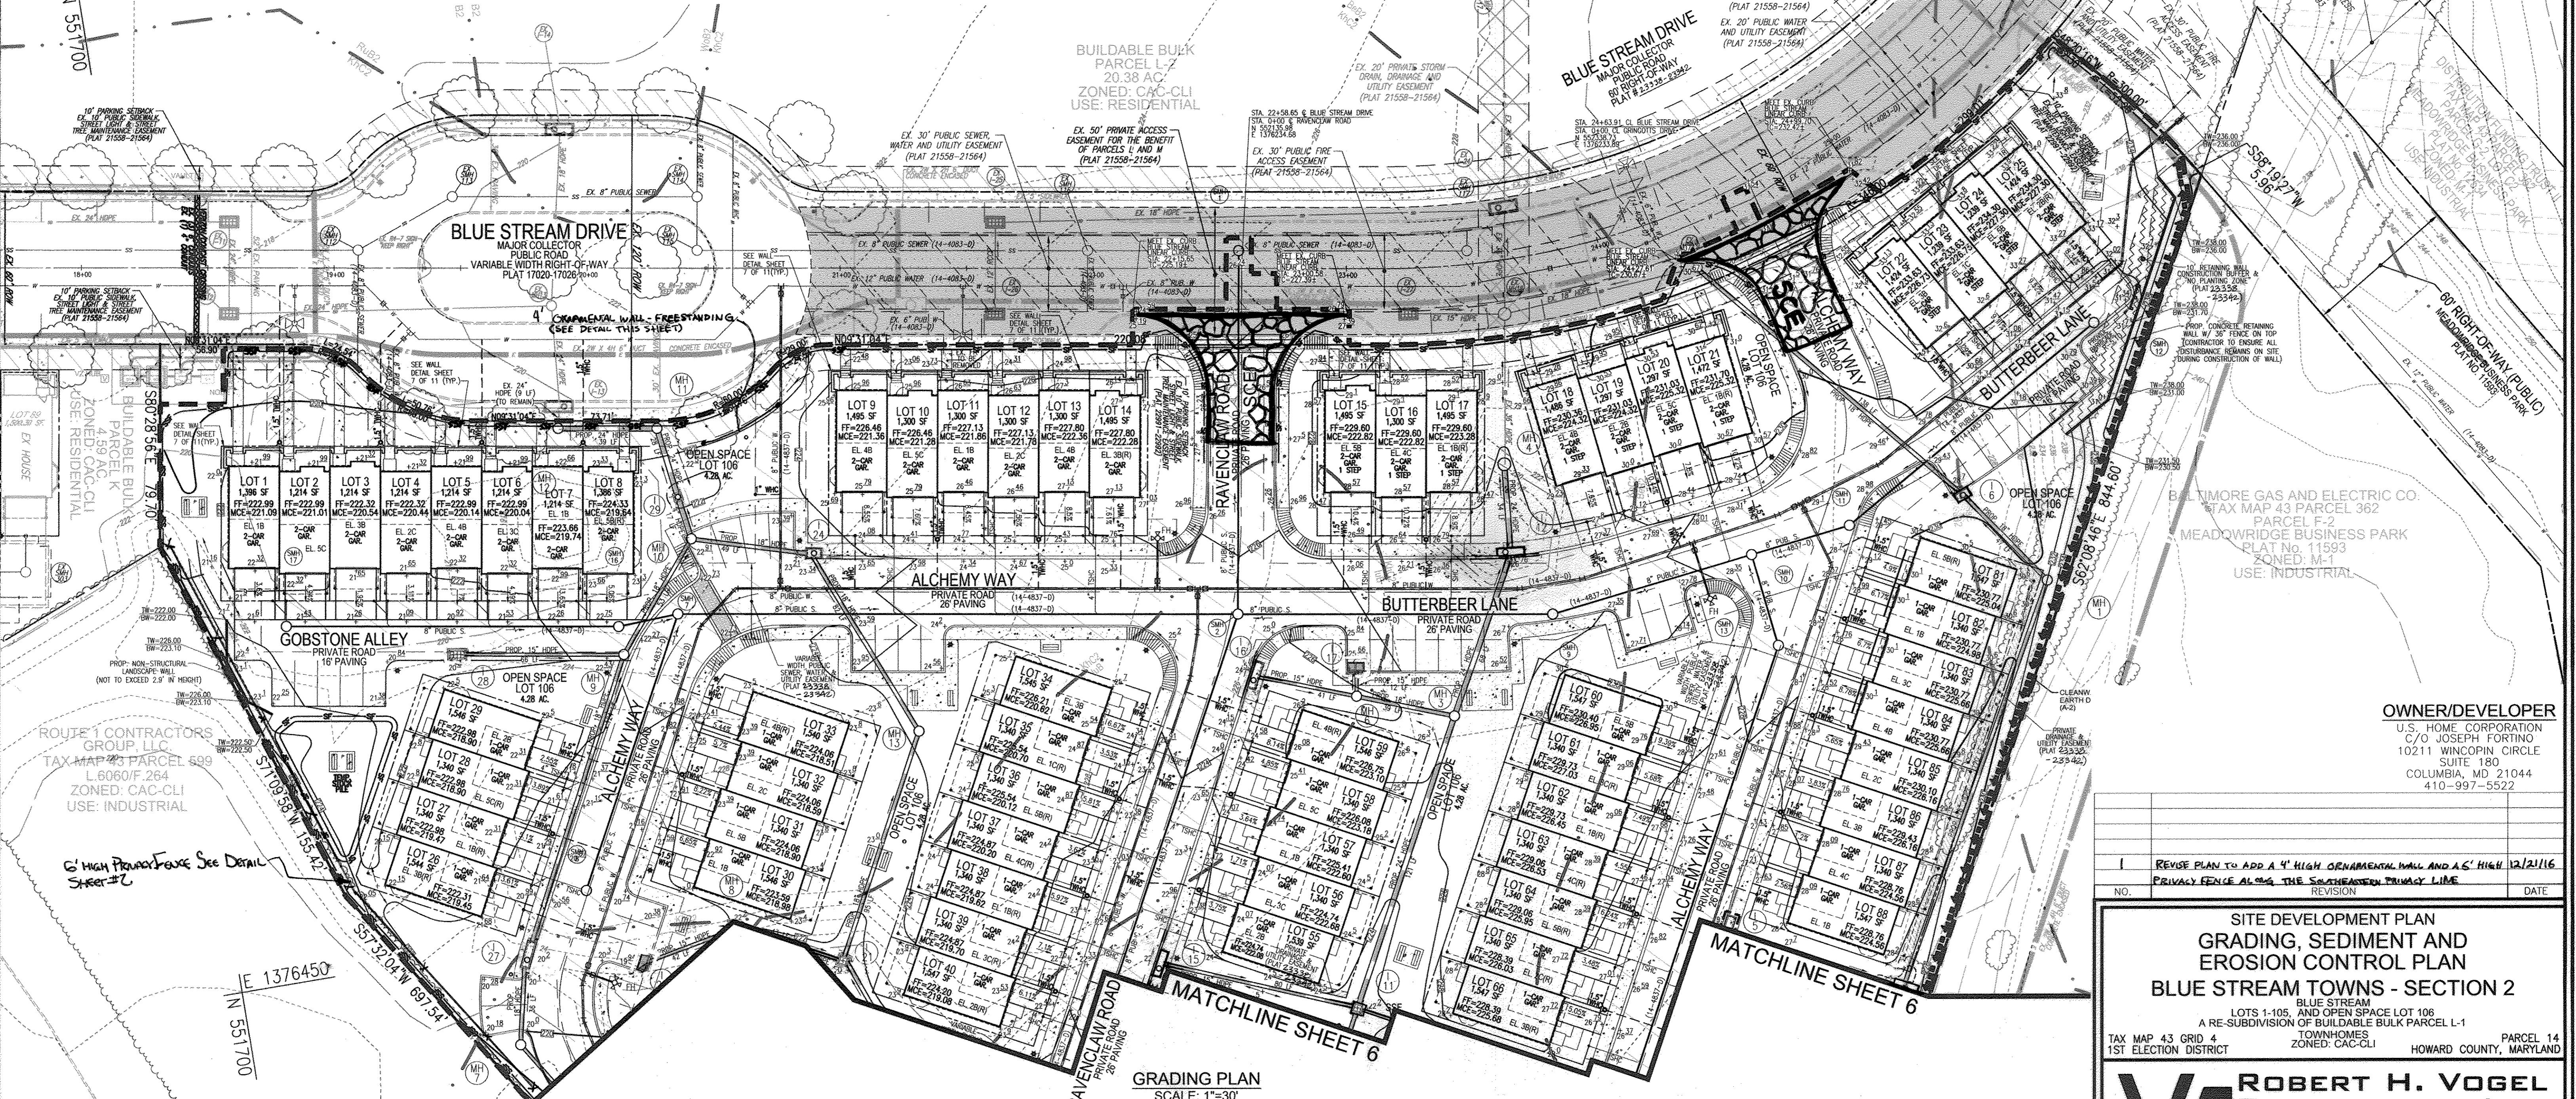

MATCHLINE SHEET 6

GRADING PLAN  
SCALE: 1"=30'

MATCHLINE SHEET 6

APPROVED: HOWARD COUNTY DEPARTMENT OF PLANNING AND ZONING

*Chad P. ...* 5-20-15  
CHIEF, DEVELOPMENT ENGINEERING DIVISION DATE

*Kate ...* 6-02-15  
CHIEF, DIVISION OF LAND DEVELOPMENT DATE

*Masha ...* 6/1/15  
DIRECTOR DATE

BY THE DEVELOPER:

I HEREBY CERTIFY THAT ALL DEVELOPMENT AND CONSTRUCTION WILL BE DONE ACCORDING TO THIS PLAN FOR SEDIMENT AND EROSION CONTROL, AND THAT ALL RESPONSIBLE PERSONNEL INVOLVED IN THE CONSTRUCTION PROJECT WILL HAVE A CERTIFICATE OF ATTENDANCE AT A DEPARTMENT OF THE ENVIRONMENT APPROVED TRAINING PROGRAM FOR THE CONTROL OF SEDIMENT AND EROSION BEFORE BEGINNING THE PROJECT. I ALSO AUTHORIZE PERIODIC ON-SITE INSPECTION BY THE HOWARD SOIL CONSERVATION DISTRICT.

*...* 5/29/15  
SIGNATURE OF DEVELOPER DATE

BY THE ENGINEER:

I CERTIFY THAT THIS PLAN FOR EROSION AND SEDIMENT CONTROL REPRESENTS A PRACTICAL AND WORKABLE PLAN BASED ON MY PERSONAL KNOWLEDGE OF THE SITE CONDITIONS, AND THAT IT WAS PREPARED IN ACCORDANCE WITH THE REQUIREMENTS OF THE HOWARD SOIL CONSERVATION DISTRICT.

*John R. ...* 5/13/15  
SIGNATURE OF ENGINEER DATE

SCALE 1"=30'

15' 0' 30'

THIS DEVELOPMENT PLAN IS APPROVED FOR SOIL EROSION AND SEDIMENT CONTROL BY THE HOWARD SOIL CONSERVATION DISTRICT.

*John R. ...* 5/13/15  
HOWARD S.C.D. DATE

REVISE PLAN TO ADD A 4' HIGH ORNAMENTAL WALL AND A 6" HIGH PRIVATE FENCE ALONG THE SOUTHWESTERN PROPERTY LINE

NO. REVISION DATE

**SITE DEVELOPMENT PLAN  
GRADING, SEDIMENT AND  
EROSION CONTROL PLAN  
BLUE STREAM TOWNS - SECTION 2**


LOT 1-106, AND OPEN SPACE LOT 106  
A RE-SUBDIVISION OF BUILDABLE BULK PARCEL L-1

TOWNHOMES PARCEL 14  
ZONED: CAC-CLI HOWARD COUNTY, MARYLAND

**ROBERT H. VOGEL  
ENGINEERING, INC.**

ENGINEERS • SURVEYORS • PLANNERS

8407 MAIN STREET TEL: 410.461.7666  
ELLCOTT CITY, MD 21043 FAX: 410.461.8961

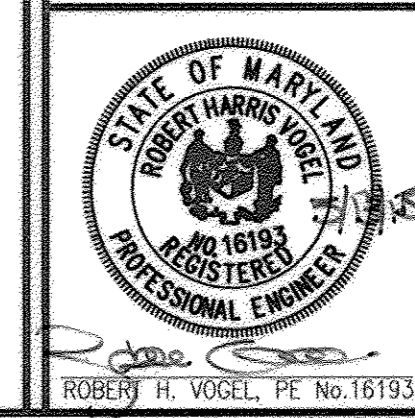

PROFESSIONAL CERTIFICATE

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DESIGN BY: RHV  
DRAWN BY: JMR  
CHECKED BY: RHV  
DATE: APRIL 2015  
SCALE: AS SHOWN  
W.O. NO.: 06-26.14

5 SHEET OF 13

Maryland State Grid Meridian

MATCHLINE SHEET 5

MATCHLINE SHEET 5

MATCHLINE SHEET 5



**LEGEND:**

	PROPERTY LINE		PRIVATE DRAINAGE & UTILITY EASEMENT (PLAT)
	RIGHT-OF-WAY LINE		VARIABLE WIDTH PUBLIC SEWER, WATER & UTILITY EASEMENT (PLAT)
	ADJACENT PROPERTY LINE		PROPOSED SUPER SILT FENCE
	EXISTING CURB AND GUTTER		PROPOSED LIMIT OF DISTURBANCE
	EXISTING UTILITY POLE		PROPOSED CURB INLET PROTECTION
	EXISTING LIGHT POLE		PROPOSED AT-GRADE INLET PROTECTION
	EXISTING SIGN		PROPOSED TREE PROTECTION FENCE
	EXISTING SANITARY MANHOLE		PROPOSED STABILIZED CONSTRUCTION ENTRANCE
	EXISTING SANITARY LINE		
	EXISTING CLEANOUT		
	EXISTING FIRE HYDRANT		
	EXISTING WATER LINE		
	EXISTING TREE LINE		
	EXISTING TREES		
	EXISTING FENCE		
	EXISTING 10' CONTOUR		
	EXISTING 2' CONTOUR		
	SOILS		
	EXISTING STEEP SLOPES		
	PROPOSED STORM DRAIN		
	PROPOSED STORM DRAIN INLET		
	PROPOSED SIDEWALK		
	PROPOSED TREE LINE		
	PROPOSED CURB		
	PROPOSED STREET LIGHT		
	PROPOSED 10' CONTOUR		
	PROPOSED 2' CONTOUR		
	PROPOSED SPOT ELEVATION		

G' HIGH PRIVACY FENCE SEE DETAIL SHEET #2

GRADING PLAN  
SCALE: 1"=30'

APPROVED: HOWARD COUNTY DEPARTMENT OF PLANNING AND ZONING

*[Signature]* 5/20/15  
CHIEF, DEVELOPMENT ENGINEERING DIVISION DATE

*[Signature]* 6-02-15  
CHIEF, DIVISION OF LAND DEVELOPMENT DATE

*[Signature]* 6/15  
DIRECTOR DATE

BY THE DEVELOPER:

"I/WE CERTIFY THAT ALL DEVELOPMENT AND CONSTRUCTION WILL BE DONE ACCORDING TO THIS PLAN FOR SEDIMENT AND EROSION CONTROL, AND THAT ALL RESPONSIBLE PERSONNEL INVOLVED IN THE CONSTRUCTION PROJECT WILL HAVE A CERTIFICATE OF ATTENDANCE AT A DEPARTMENT OF THE ENVIRONMENT APPROVED TRAINING PROGRAM FOR THE CONTROL OF SEDIMENT AND EROSION BEFORE BEGINNING THE PROJECT. I ALSO AUTHORIZE PERIODIC ON-SITE INSPECTION BY THE HOWARD SOIL CONSERVATION DISTRICT."

*[Signature]* 5/20/15  
SIGNATURE OF DEVELOPER DATE

BY THE ENGINEER:



"I CERTIFY THAT THIS PLAN FOR EROSION AND SEDIMENT CONTROL REPRESENTS A PRACTICAL AND WORKABLE PLAN BASED ON MY PERSONAL KNOWLEDGE OF THE SITE CONDITIONS, AND THAT IT WAS PREPARED IN ACCORDANCE WITH THE REQUIREMENTS OF THE HOWARD SOIL CONSERVATION DISTRICT."

*[Signature]* 5/13/15  
SIGNATURE OF ENGINEER DATE

THIS DEVELOPMENT PLAN IS APPROVED FOR SOIL EROSION AND SEDIMENT CONTROL BY THE HOWARD SOIL CONSERVATION DISTRICT.

*[Signature]* 5/13/15  
HOWARD S.C.D. DATE

KNICKERBOCKER PROPERTIES INC XI  
C/O MARVIN F. POER & COMPANY  
TAX MAP 43 PARCEL 362  
LOT E-1  
MEADOWRIDGE BUSINESS PARK  
PLAT No. 10793  
ZONED: M-1  
USE: INDUSTRIAL

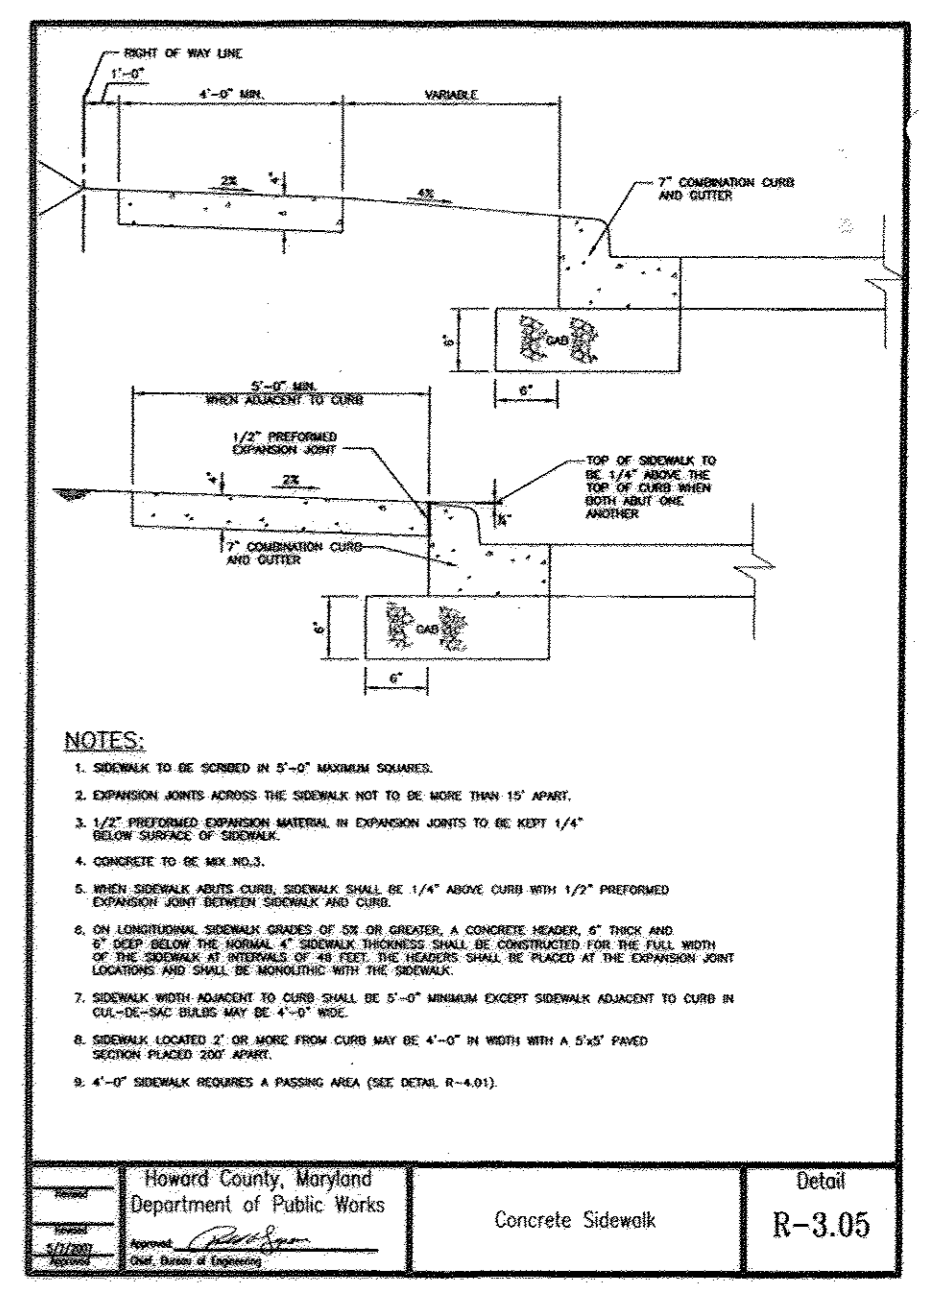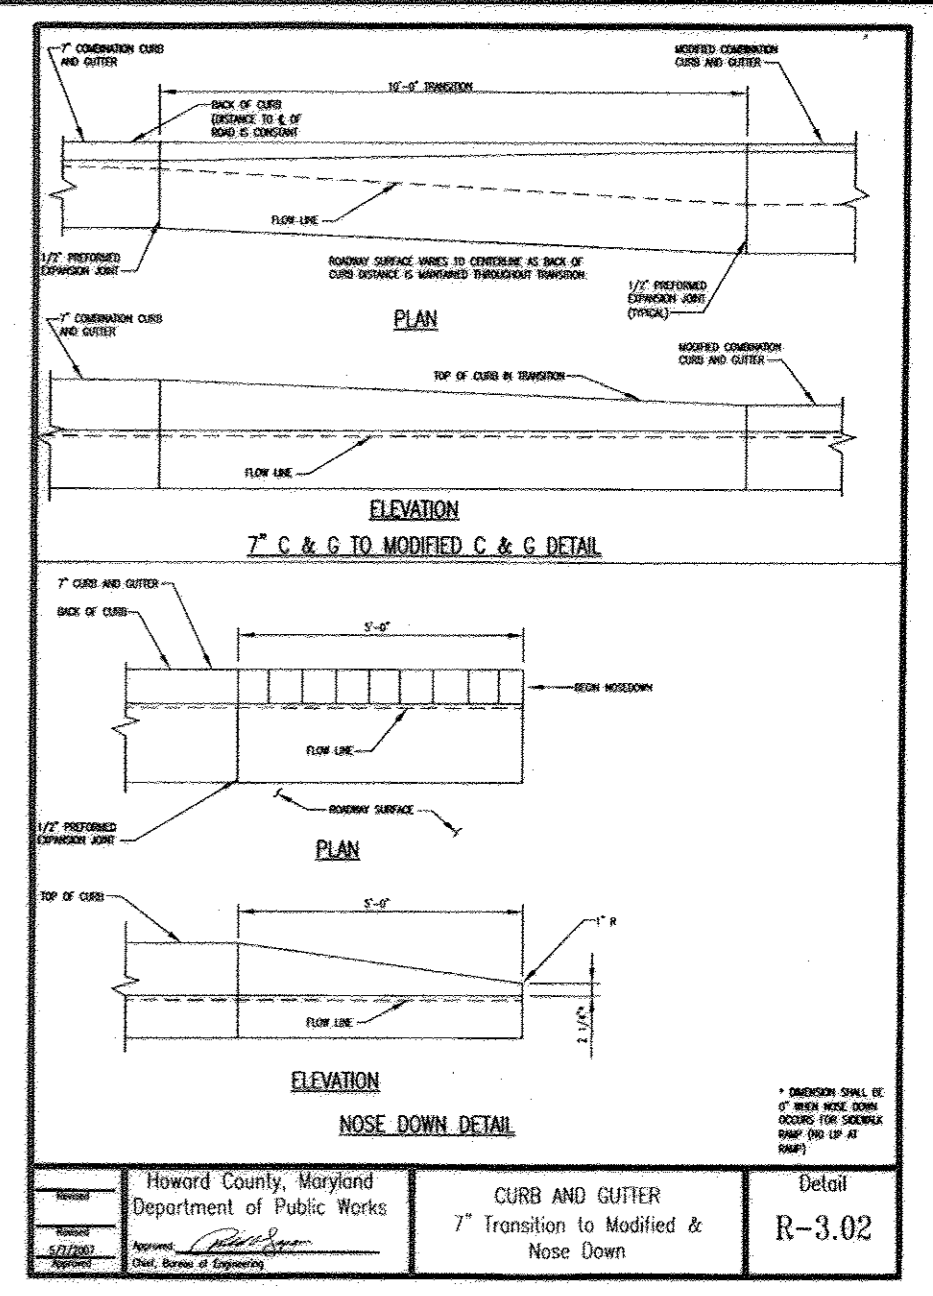

**OWNER/DEVELOPER**  
U.S. HOME CORPORATION  
C/O JOSEPH FORTINO  
10211 WINDOPIN CIRCLE  
SUITE 180  
COLUMBIA, MD 21044  
410-997-5522

NO.	REVISION	DATE
1	REVISE PLAN TO ADD A 4' HIGH ORNAMENTAL WALL AND A 6' HIGH PRIVACY FENCE ALONG THE SOUTHEASTERN PROPERTY LINE	12/21/15

**SITE DEVELOPMENT PLAN  
GRADING, SEDIMENT AND  
EROSION CONTROL PLAN  
BLUE STREAM TOWNS - SECTION 2**

BLUE STREAM  
LOTS 1-105, AND OPEN SPACE LOT 106  
A RE-SUBDIVISION OF BUILDABLE BULK PARCEL L-1  
TOWNHOMES  
ZONED: CAC-CL1  
HOWARD COUNTY, MARYLAND

TAX MAP 43 GRID 4  
1ST ELECTION DISTRICT

PARCEL 14

**ROBERT H. VOGEL  
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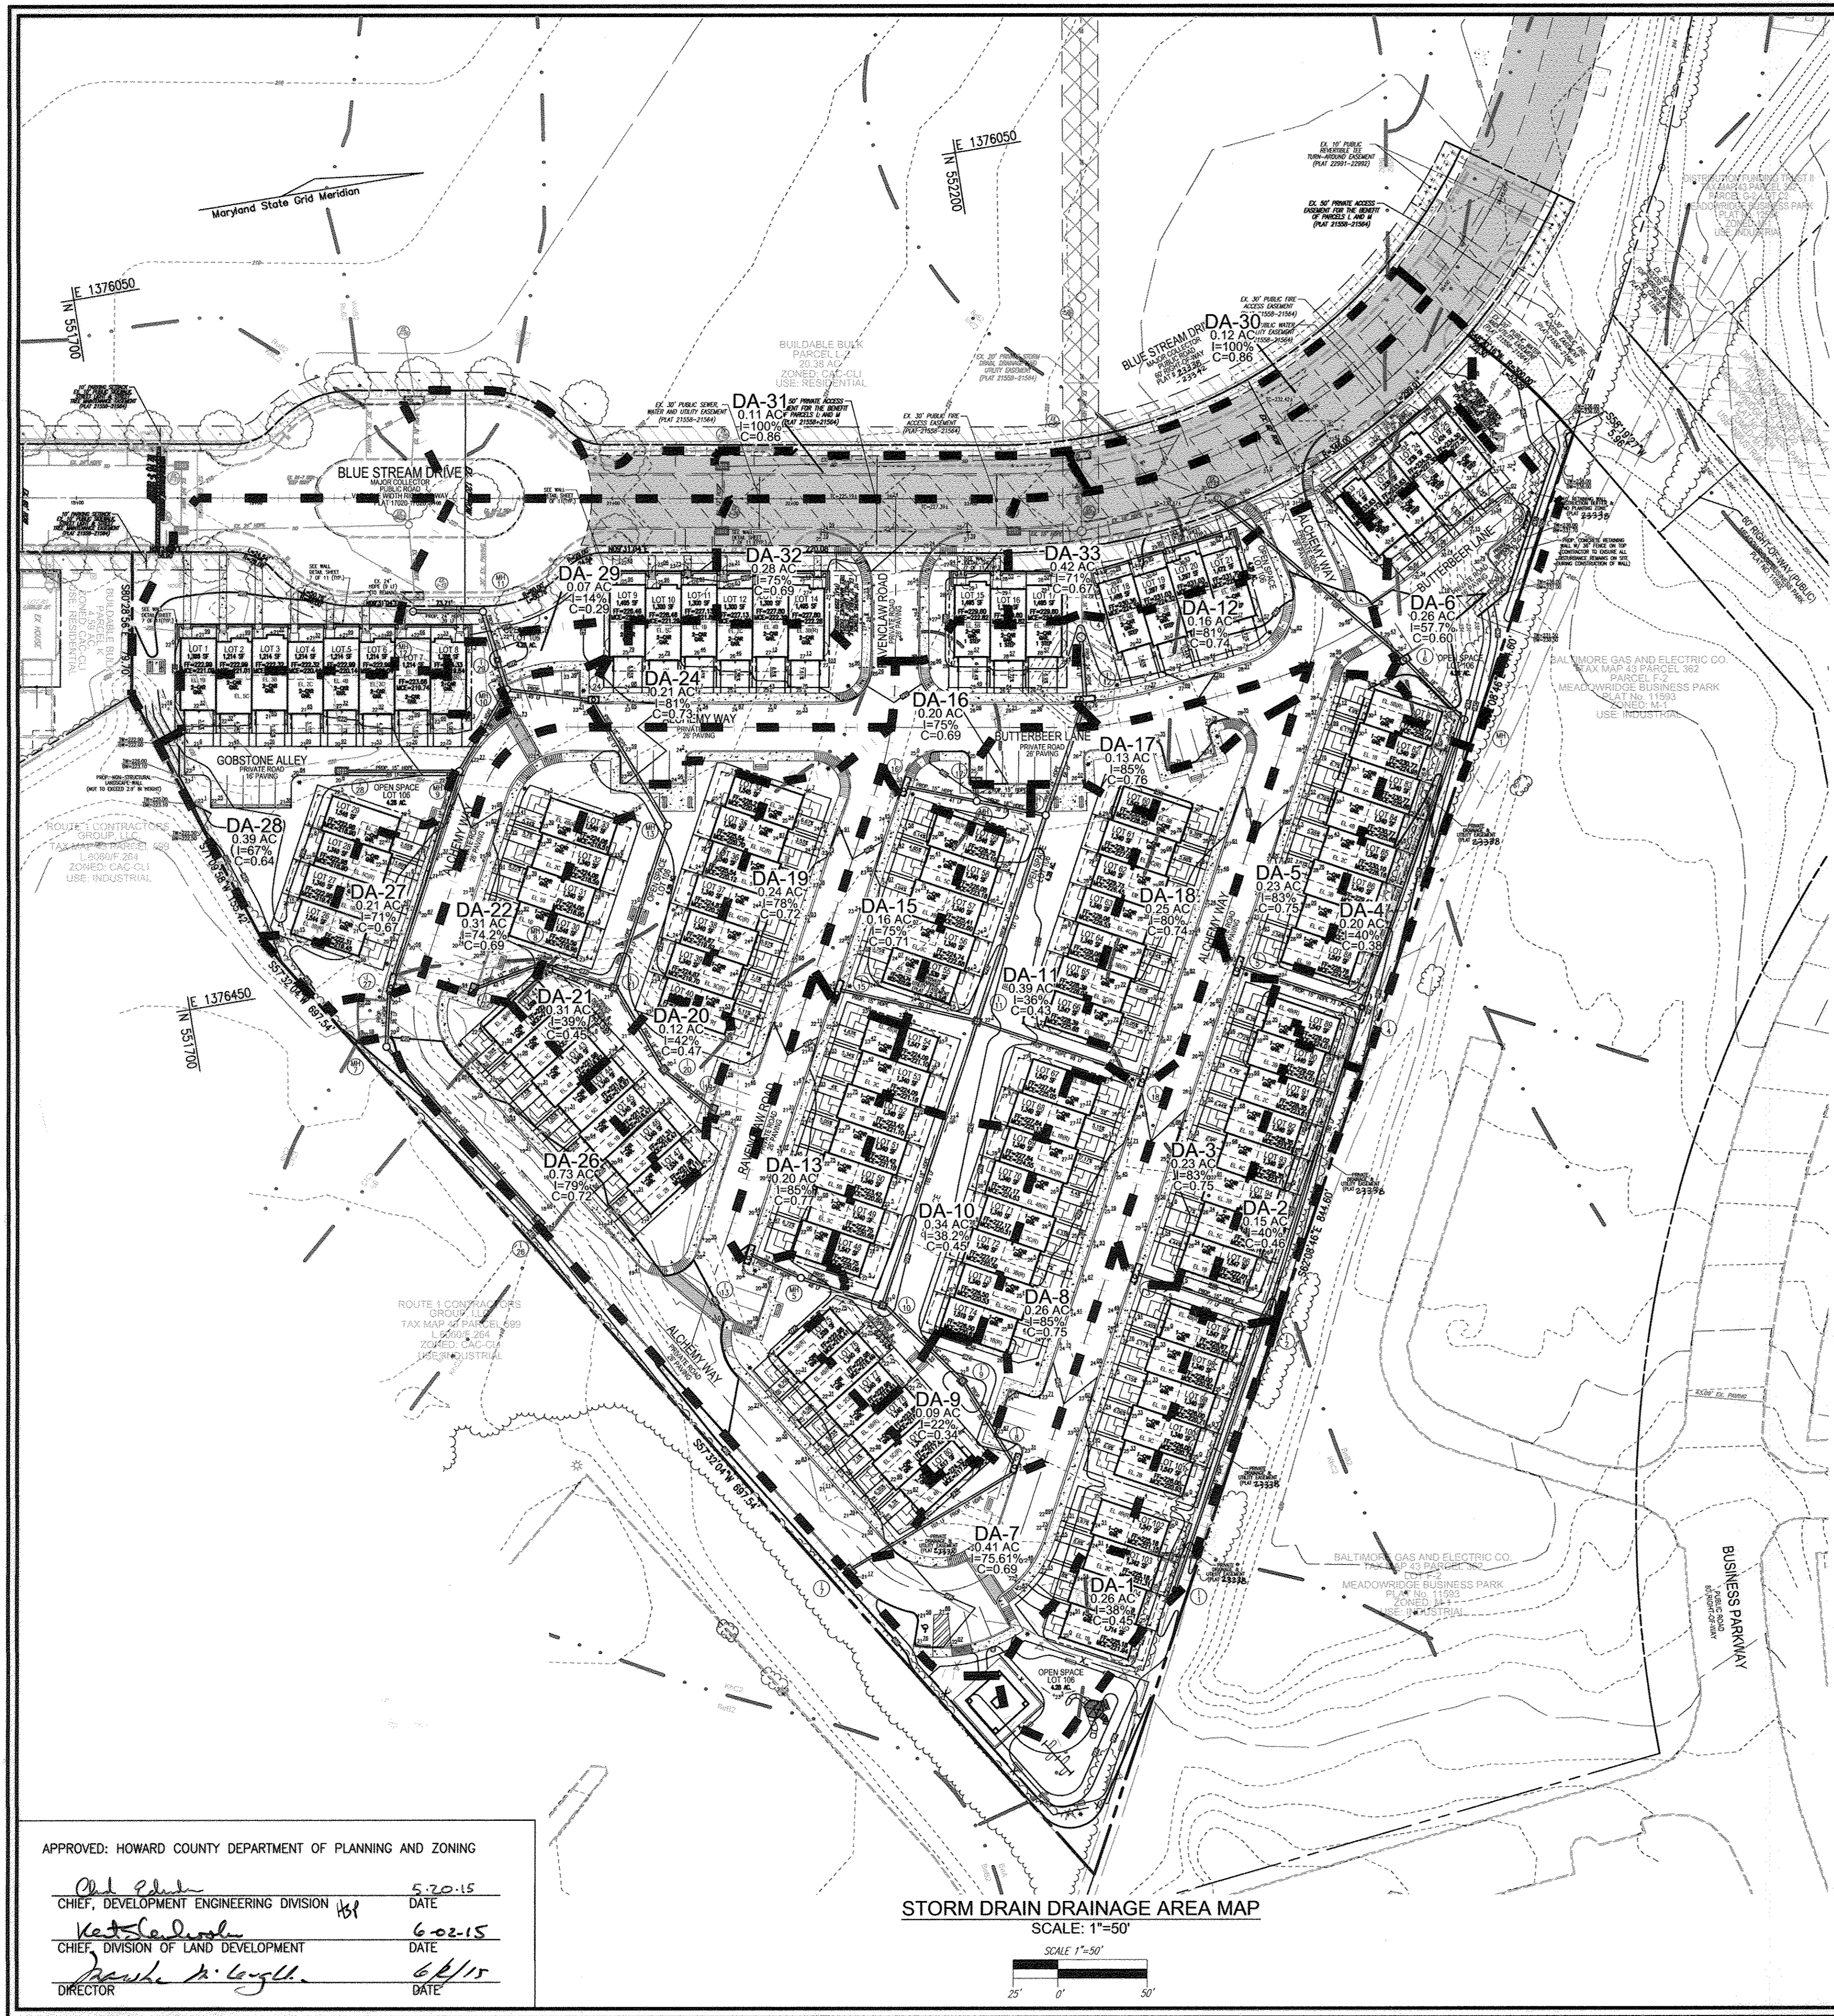
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DESIGN BY: RHV  
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6 SHEET OF 13





**LEGEND:**

- PROPERTY LINE
- RIGHT-OF-WAY LINE
- ADJACENT PROPERTY LINE
- EXISTING CURB AND GUTTER
- EXISTING UTILITY POLE
- EXISTING LIGHT POLE
- EXISTING SIGN
- EXISTING SANITARY MANHOLE
- EXISTING SANITARY LINE
- EXISTING CLEANOUT
- EXISTING FIRE HYDRANT
- EXISTING WATER LINE
- EXISTING TREELINE
- EXISTING FENCE
- EXISTING 10' CONTOUR
- EXISTING 2' CONTOUR
- SOILS
- EXISTING STEEP SLOPES
- PROPOSED STORMDRAIN
- PROPOSED STORMDRAIN INLET
- PROPOSED SIDEWALK
- PROPOSED TREELINE
- PROPOSED CURB
- PROPOSED STREET LIGHT
- PROPOSED 10' CONTOUR
- PROPOSED 2' CONTOUR
- PROPOSED SPOT ELEVATION
- PROPOSED DRAINAGE AREA
- 10' PARKING SETBACK
- EX. 10' PUBLIC SEWER, WATER AND UTILITY EASEMENT (PLAT 21558-21564)
- EX. 30' PUBLIC FIRE ACCESS EASEMENT (PLAT 21558-21564)
- EX. 50' PRIVATE ACCESS EASEMENT FOR THE BENEFIT OF PARCELS 1 AND 18 (PLAT 21558-21564)
- EX. 50' PRIVATE STORM DRAIN, DRAINAGE AND UTILITY EASEMENT (PLAT 21558-21564)
- EX. 50' PRIVATE ACCESS EASEMENT FOR INGRESS & EGRESS TO CEMETARY (PLAT 11593)
- PRIVATE DRAINAGE & UTILITY EASEMENT (PLAT 22991-22992)
- VARIABLE WIDTH PUBLIC SEWER, WATER & UTILITY EASEMENT (PLAT 22991-22992)
- 10' RETAINING WALL CONSTRUCTION BUFFER & NO PLANTING ZONE (PLAT 22991-22992)
- EX. 10' PUBLIC REVERSIBLE TEE TURN-AROUND EASEMENT (PLAT 22991-22992)

APPROVED: HOWARD COUNTY DEPARTMENT OF PLANNING AND ZONING

*John Schuch*  
CHIEF, DEVELOPMENT ENGINEERING DIVISION  
DATE: 5/20/15

*Kurt C. Lavelle*  
CHIEF, DIVISION OF LAND DEVELOPMENT  
DATE: 6/02/15

*Debra M. Lytle*  
DIRECTOR  
DATE: 6/1/15

**STORM DRAIN DRAINAGE AREA MAP**  
SCALE: 1"=50'  
25' 0' 50'

SOILS LEGEND		
SYMBOL	NAME / DESCRIPTION	GROUP
BsA	BELTSVILLE SILT LOAM, 0 TO 1 PERCENT SLOPES	C
BsB	BELTSVILLE SILT LOAM, 1 TO 5 PERCENT SLOPES, MODERATELY ERODED	C
C1C3	CHILLUM GRAVELLY LOAM, 5 TO 10 PERCENT SLOPES, SEVERELY ERODED	C
hB	IUKA LOAM, LOCAL ALLUVIUM, 1 TO 5 PERCENT SLOPES	C
KnC2	KEYPORT SILT LOAM, 3 TO 10 PERCENT SLOPES, MODERATELY ERODED	C
RuB2	RUMFORD LOAMY SAND, 1 TO 5 PERCENT SLOPES, MODERATELY ERODED	B
SsE	SASSAFRAS SOILS, 15 TO 40 PERCENT SLOPES	B
S1B2	SASSAFRAS LOAM, 1 TO 5 PERCENT SLOPES, MODERATELY ERODED	B
WbB2	WOODSTOWN SANDY LOAM, 1 TO 5 PERCENT SLOPES, MODERATELY ERODED	C


NOTE: BASED ON HOWARD SOIL SURVEY.

**OWNER/DEVELOPER**  
U.S. HOME CORPORATION  
C/O JOSEPH FORTINO  
10211 WINCOPIN CIRCLE  
SUITE 180  
COLUMBIA, MD 21044  
410-997-5522

NO.	REVISION	DATE
1	REVISE PLAN TO ADD A 4' HIGH ORNAMENTAL WALL AND A 6' HIGH PRIVACY FENCE ALONG THE SOUTHEASTERN PROPERTY LINE	6/2/15

**SITE DEVELOPMENT PLAN**  
**STORM DRAIN DRAINAGE AREA MAP,**  
**PAVING PLAN, AND SOILS MAP**  
**BLUE STREAM TOWNS - SECTION 2**  
BLUE STREAM  
LOTS 1-105, AND OPEN SPACE LOT 106  
A RE-SUBDIVISION OF BUILDABLE BULK PARCEL L-1  
TOWNHOMES  
TAX MAP 43 GRID 4  
1ST ELECTION DISTRICT  
ZONED: CAC-CL1  
PARCEL 14  
HOWARD COUNTY, MARYLAND

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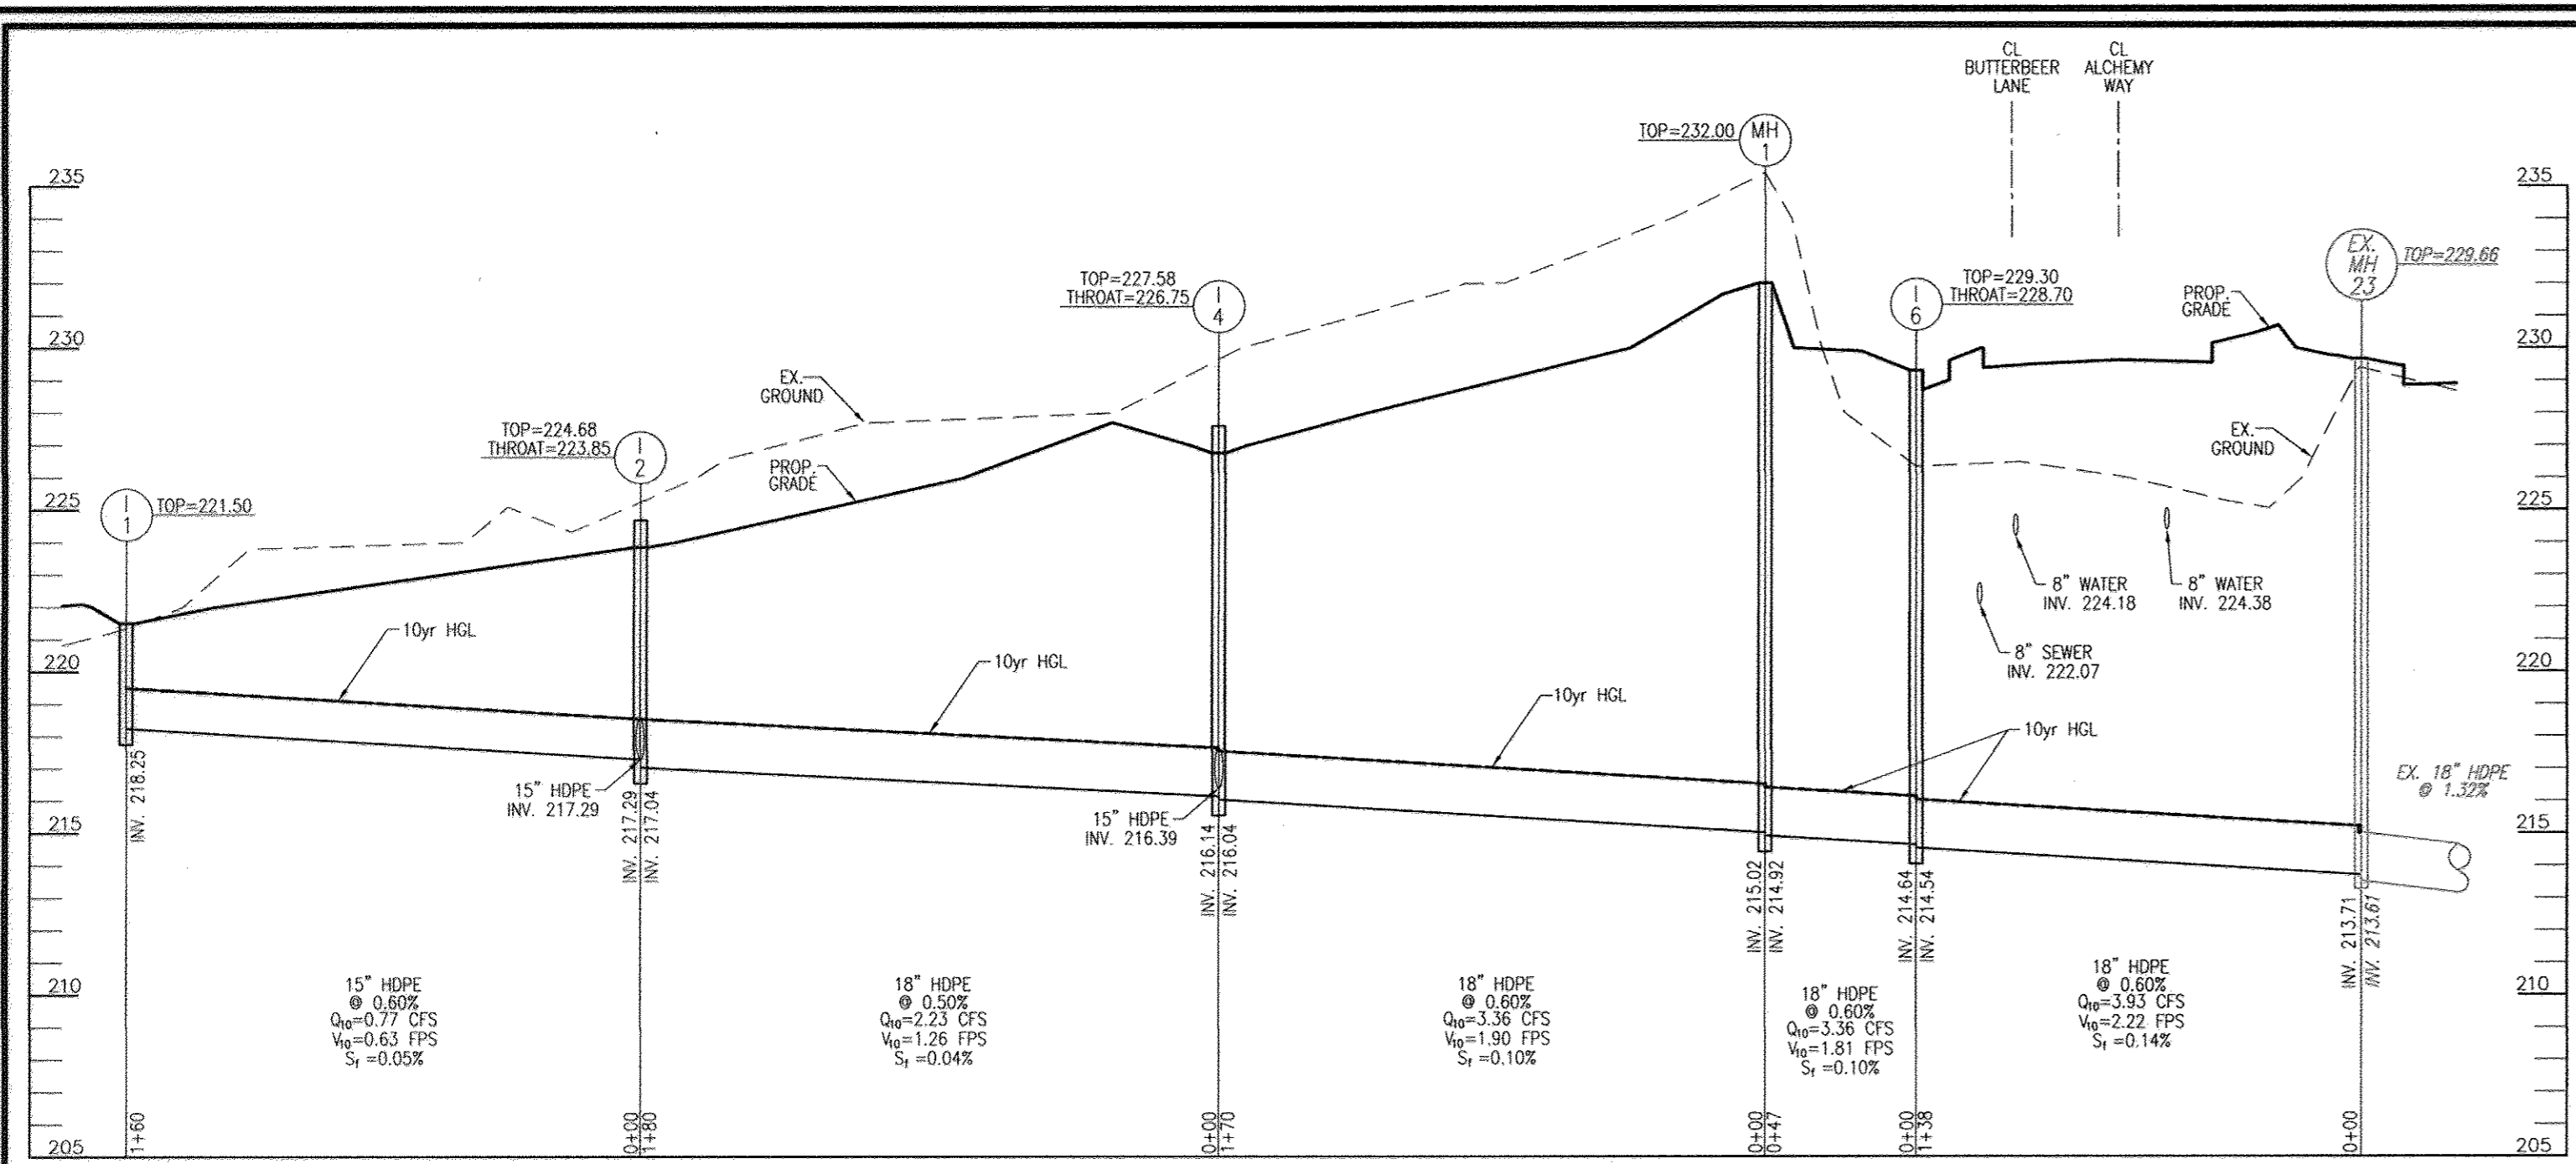

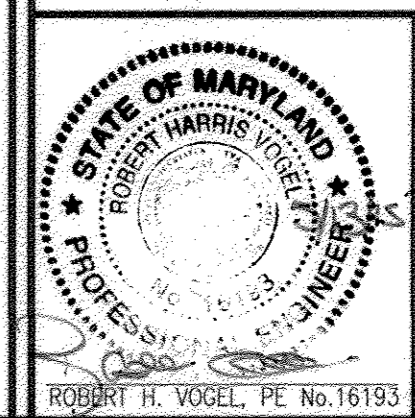
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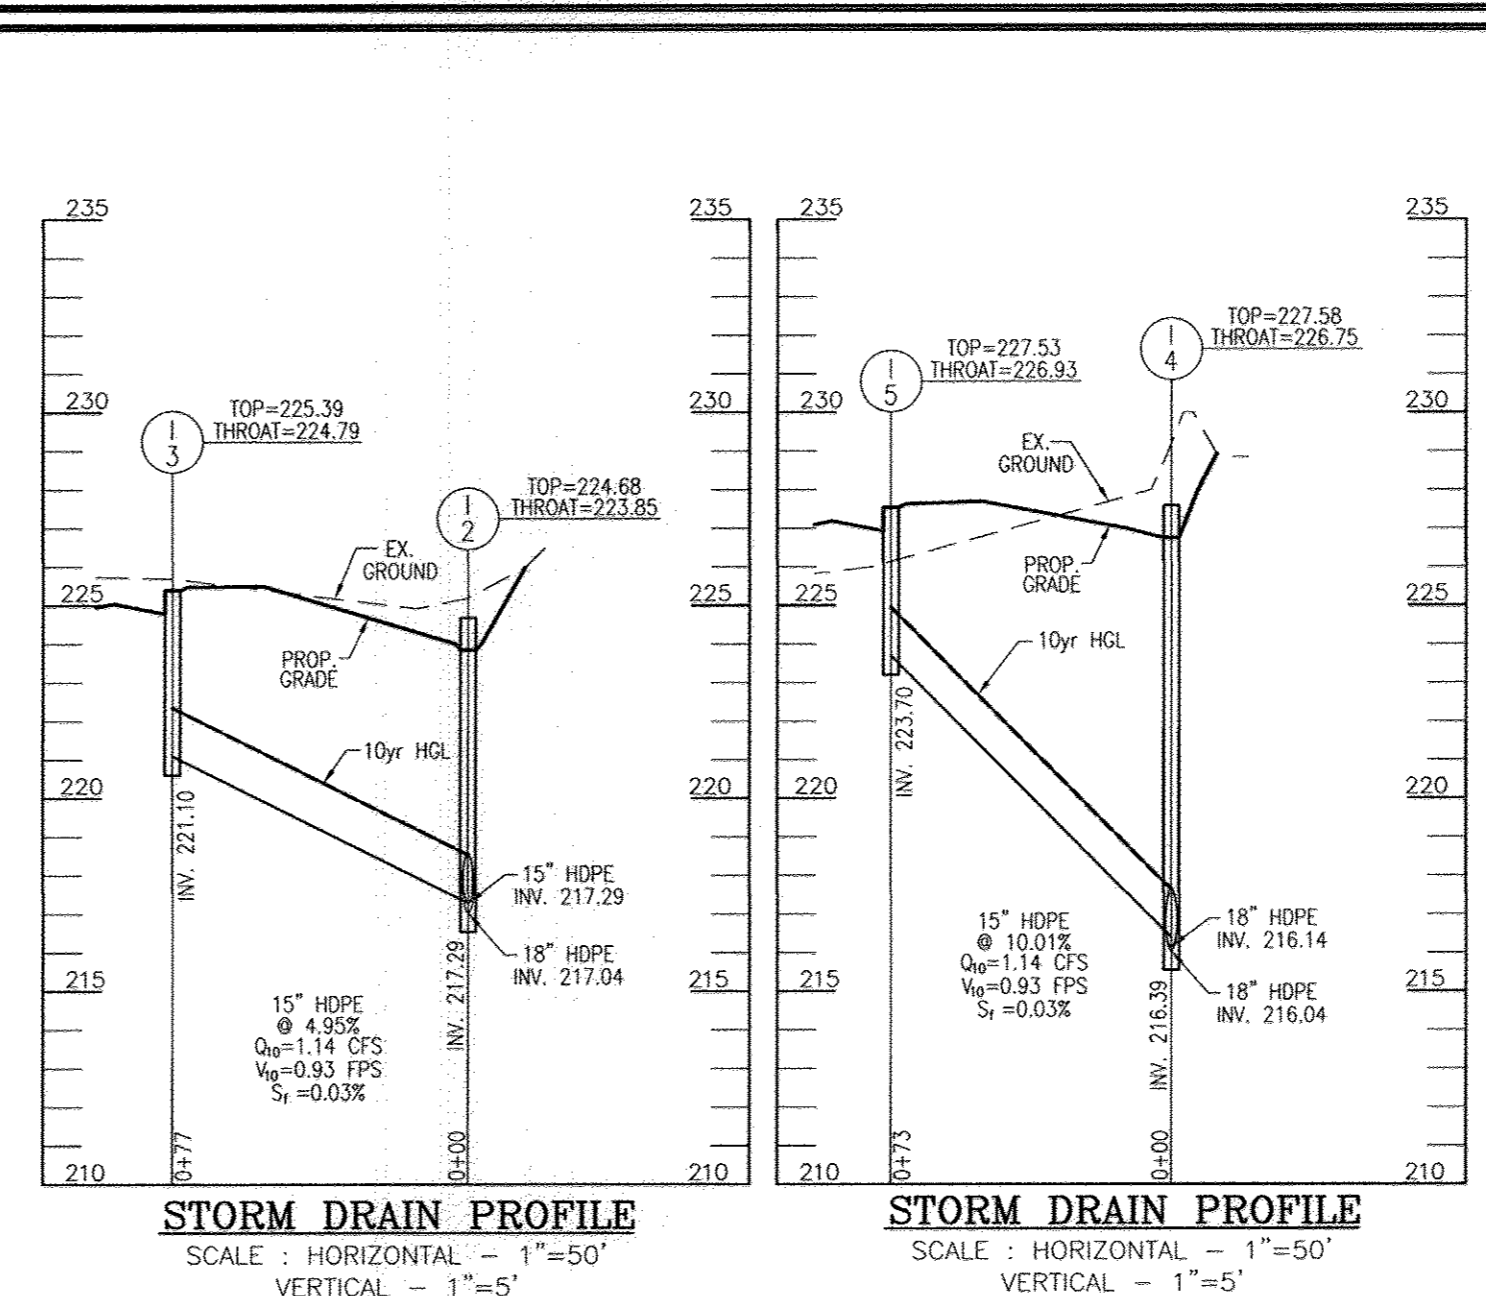
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8 SHEET OF 13







**STORM DRAIN PROFILE**  
SCALE: HORIZONTAL - 1"=50'  
VERTICAL - 1"=5'




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**STORM DRAIN PROFILE**  
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**STORM DRAIN PROFILE**  
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**STORM DRAIN PROFILE**  
SCALE: HORIZONTAL - 1"=50'  
VERTICAL - 1"=5'

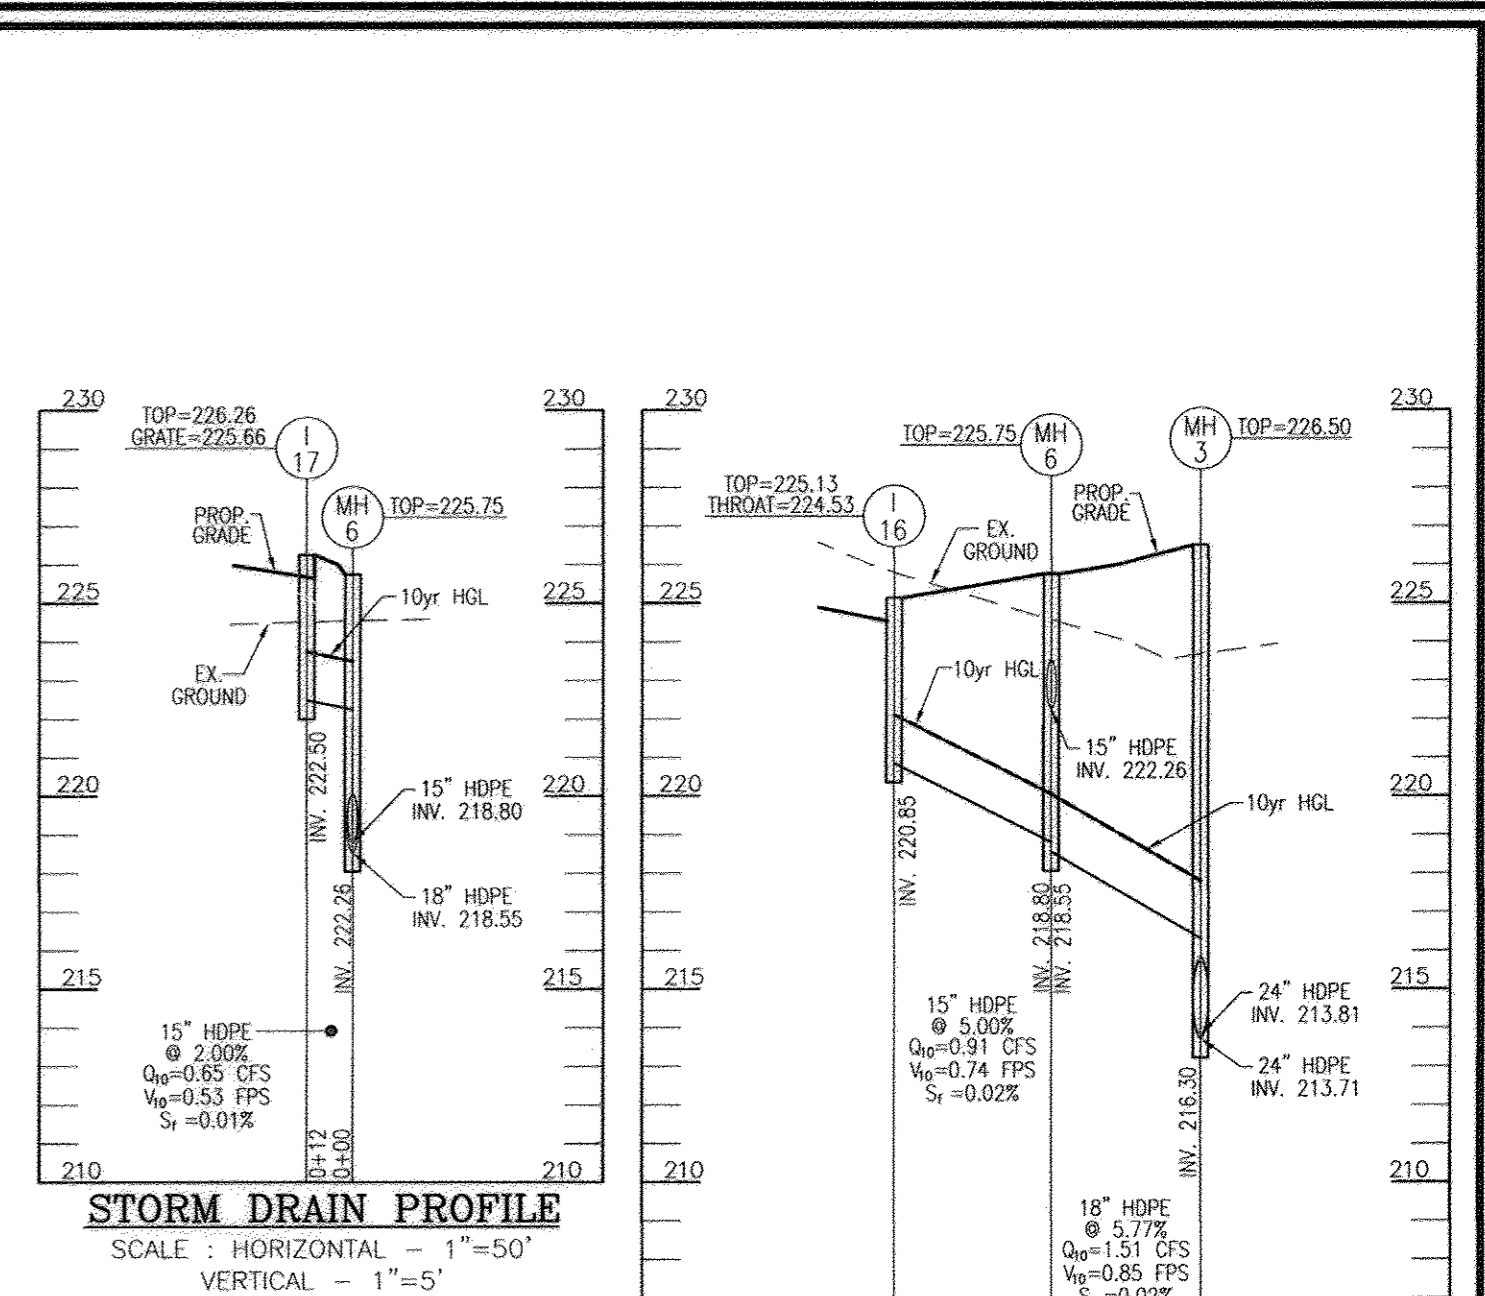OWNER/DEVELOPER  
U.S. HOMES CORPORATION  
C/O JOSEPH PORTINO  
1021 WINDSOR CIRCLE  
COLUMBIA, MARYLAND 21044  
410-997-5522

OWNER/DEVELOPER  
BLUE STREAM TOWNS  
440-BGM-446  
ELICOTT CITY, MD 21041  
C/O ARNOLD GAGNER  
410-465-2020

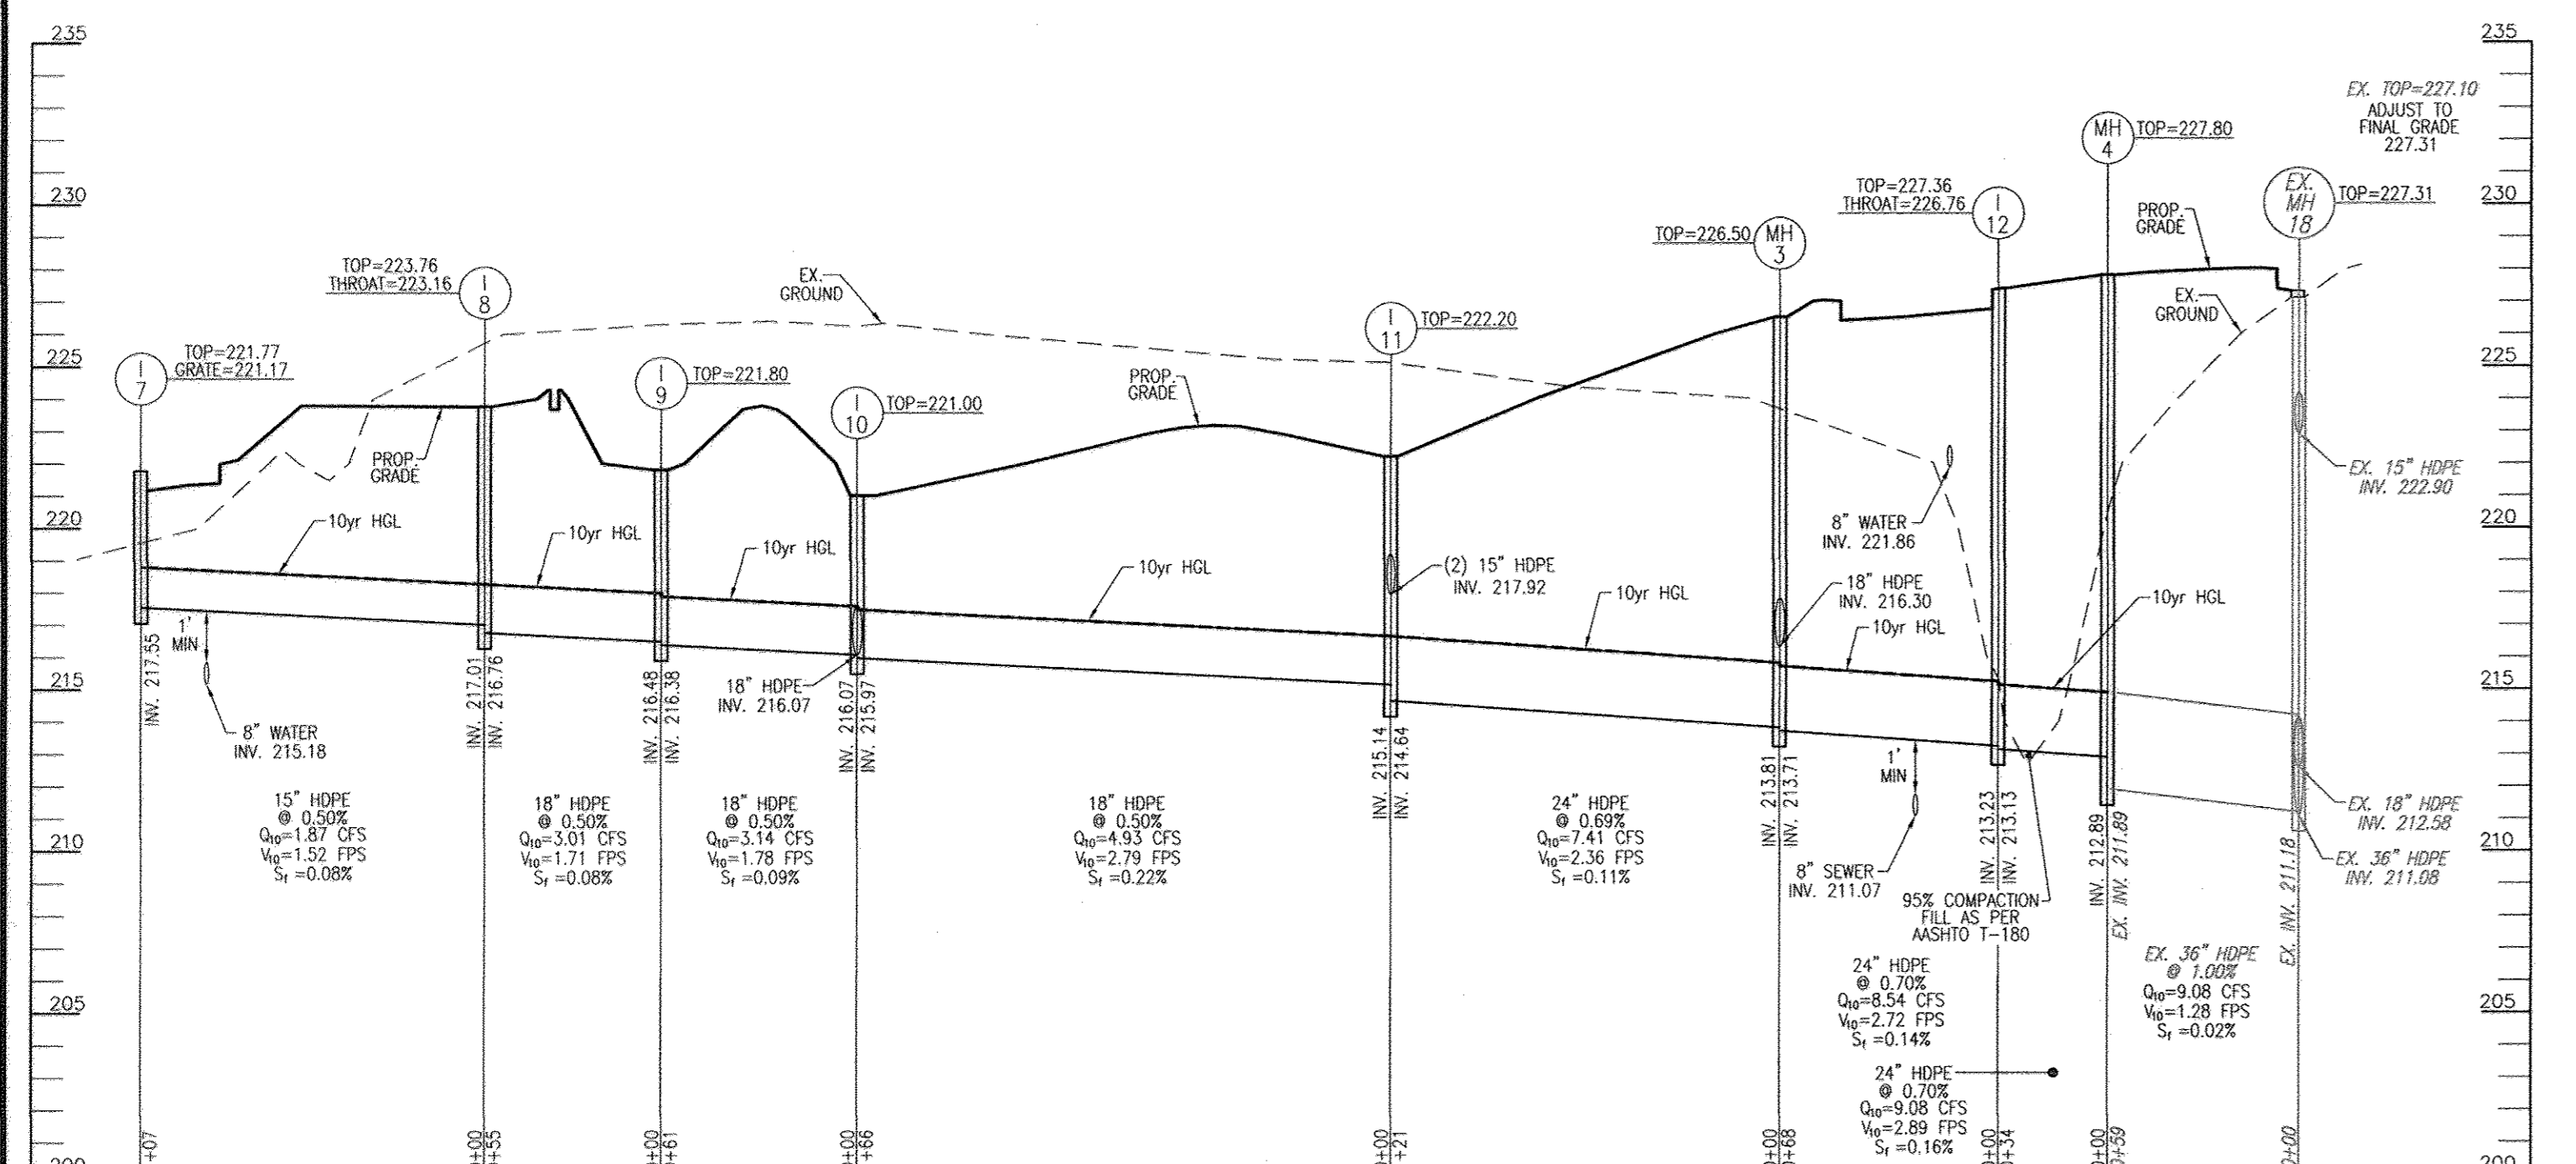NO.	REVISION	DATE
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SITE DEVELOPMENT PLAN  
STORM DRAIN PROFILES  
BLUE STREAM TOWNS - SECTION 2  
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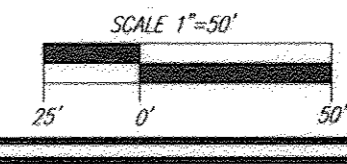
9 SHEET OF 13





APPROVED: HOWARD COUNTY DEPARTMENT OF PLANNING AND ZONING

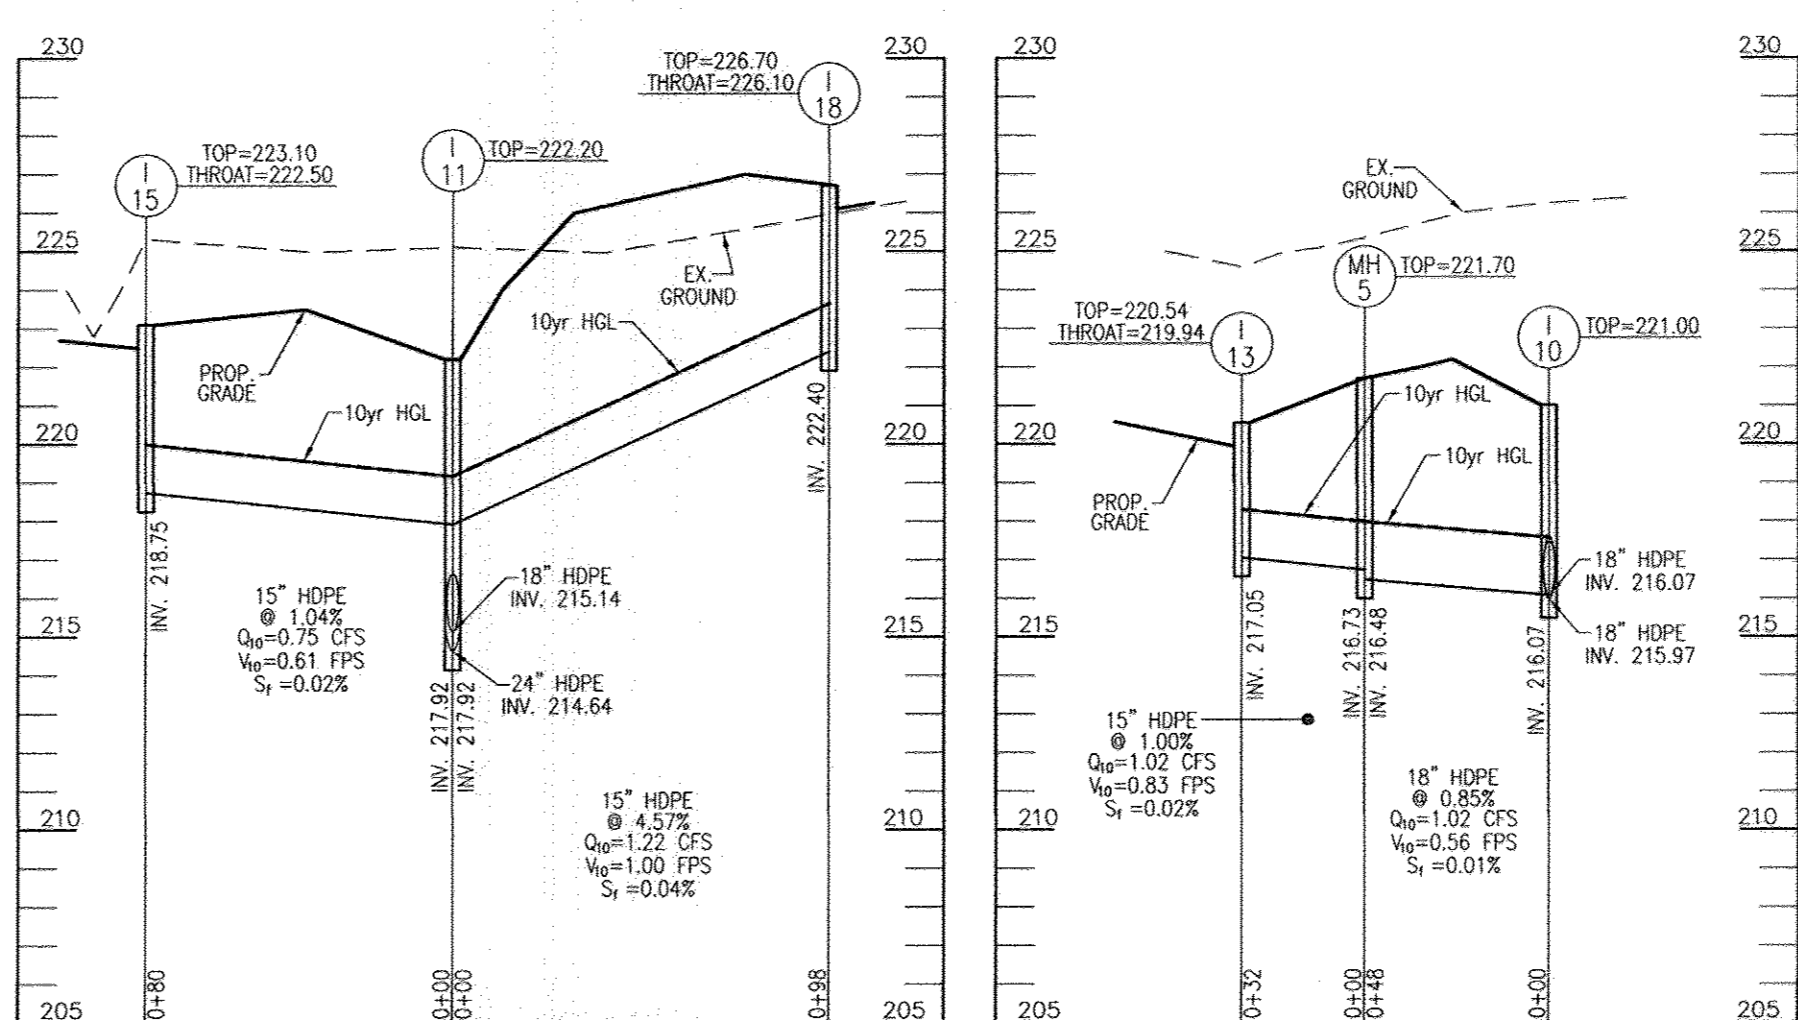*John P. ...* 5-20-15  
CHIEF, DEVELOPMENT ENGINEERING DIVISION DATE

*Kat ...* 6-02-15  
CHIEF, DIVISION OF LAND DEVELOPMENT DATE

*Paul ...* 6/15  
DIRECTOR DATE



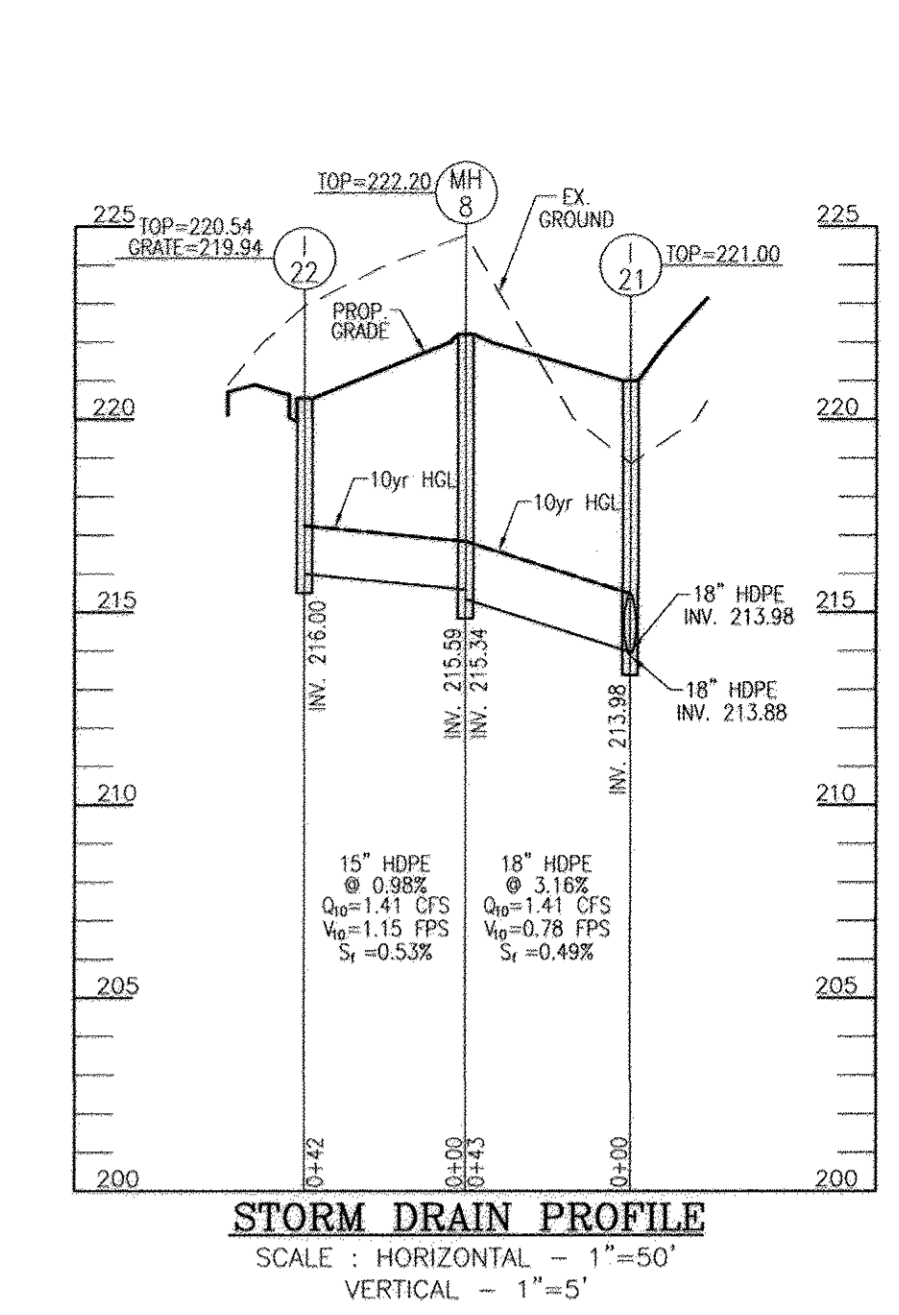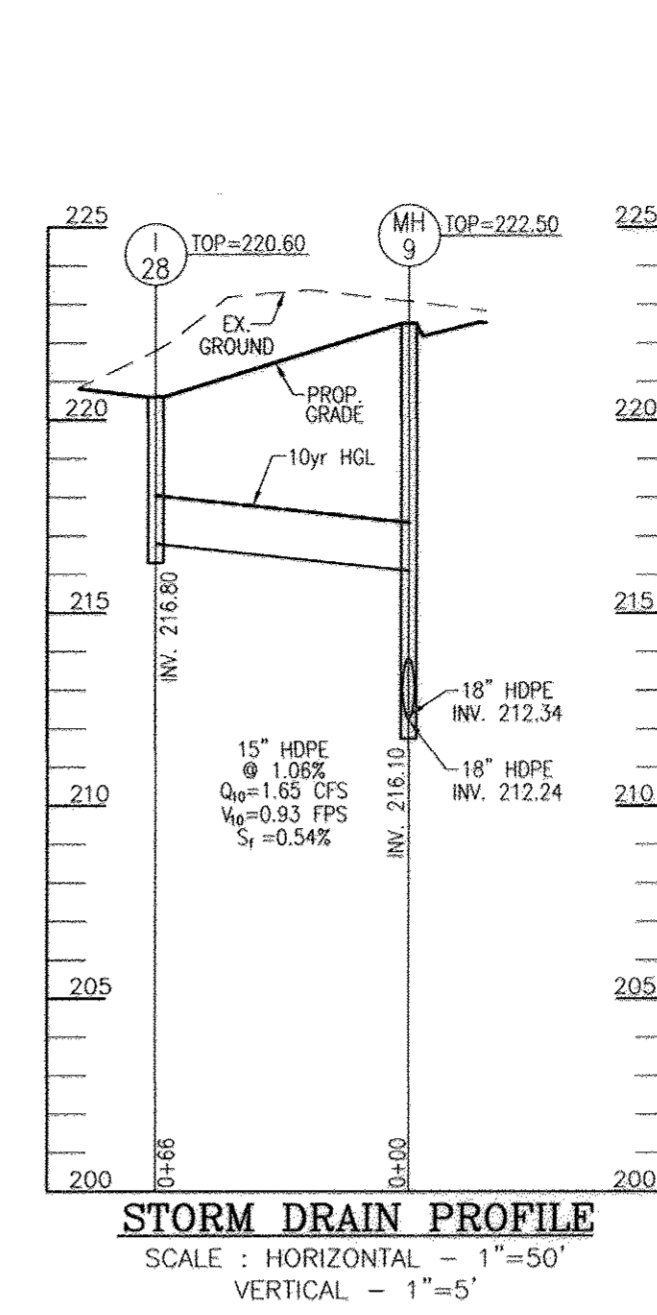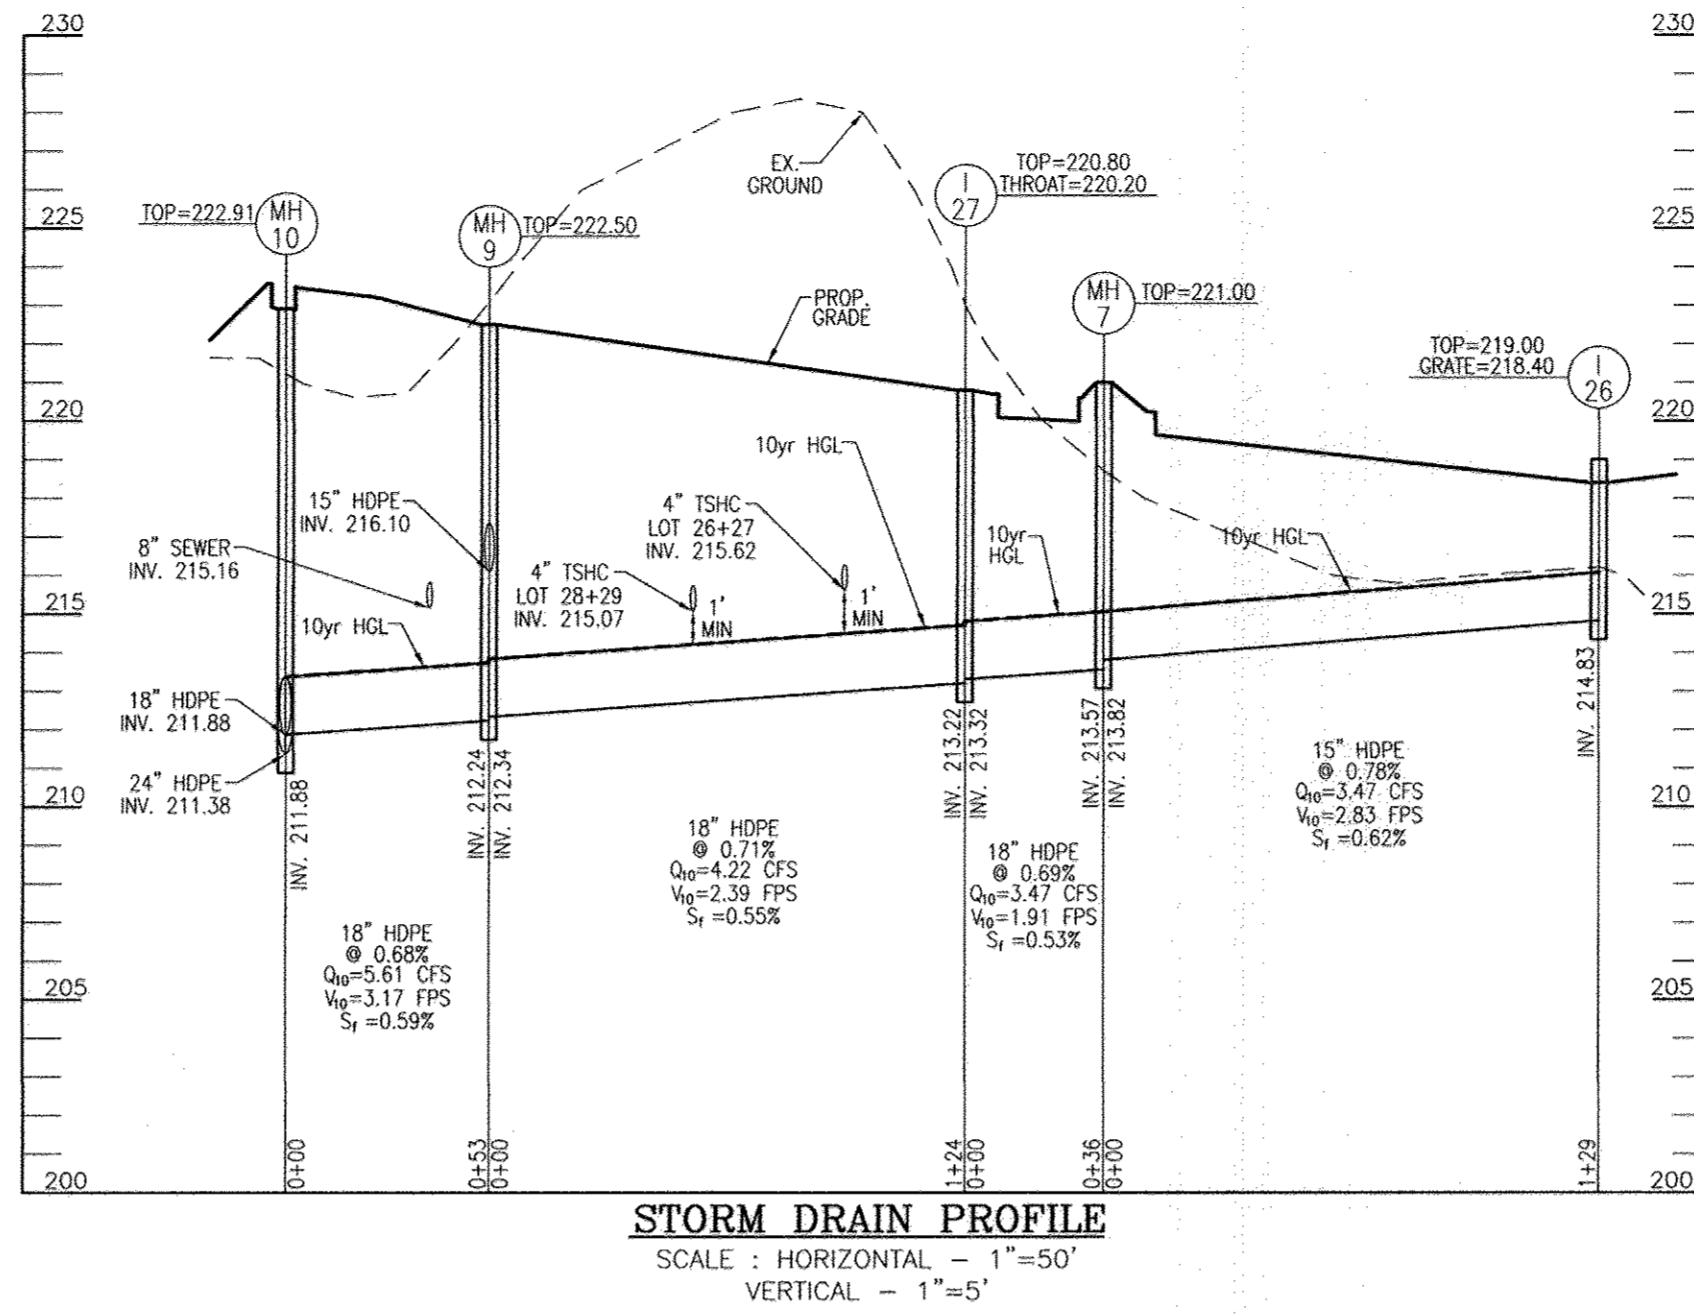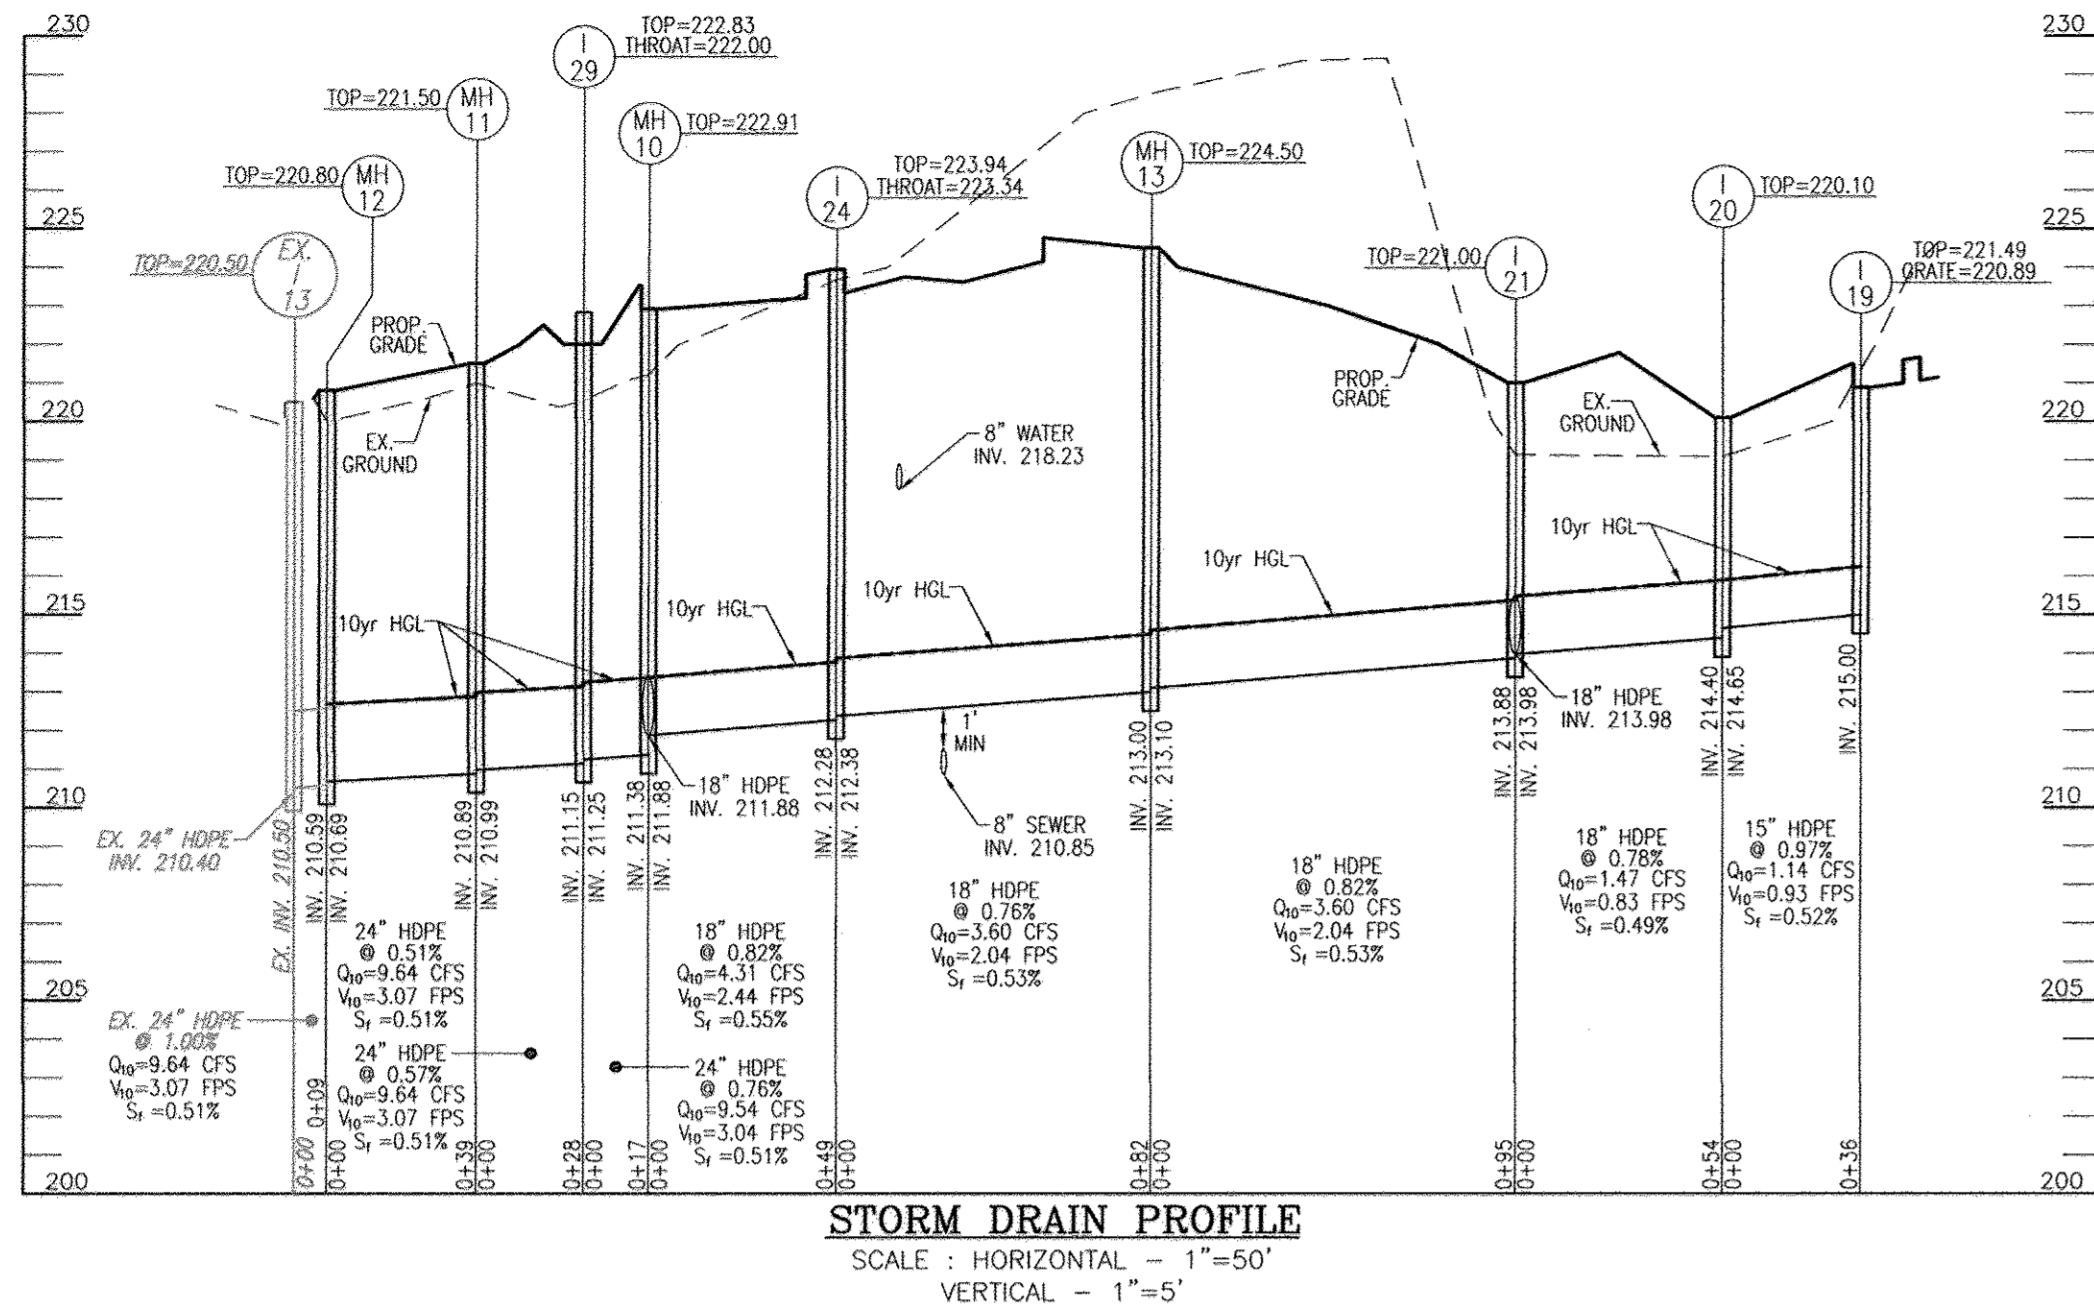

STRUCTURE SCHEDULE								
STR #	TYPE	LOCATION	TOP	THROAT	INV. IN	INV. OUT	DETAIL	REMARKS
I-1	YARD INLET	N 552191.50, E 1376858.90	221.50		-	218.25	D-4.14	
I-2	D	N 552267.01, E 1376717.84	224.68	223.85	217.29 / 217.29	217.04	D-4.10	
I-3	TYPE A-10	N 528142.93, E 1350459.61	225.39	224.79	-	221.10	D-4.03	
I-4	D	N 552347.39, E 1376556.73	227.58	226.75	216.39 / 216.14	216.04	D-4.10	
I-5	TYPE A-10	N 552281.02, E 1376521.66	227.53	226.93	-	223.70	D-4.03	
I-6	TYPE A-5	N 552402.38, E 1376369.57	229.30	228.70	214.64	214.54	D-4.01	
I-7	DOUBLE WR INLET	N 552014.71, E 1376818.27	221.77		-	217.55	D-4.35	
I-8	TYPE A-10	N 552116.77, E 1376775.91	223.76	223.16	217.01	216.76	D-4.03	
I-9	TYPE 'S'	N 552092.78, E 1376724.89	221.80		216.48	216.38	D-4.22	
I-10	TYPE 'S'	N 552055.89, E 1376676.10	221.00		216.07	215.97	D-4.22	
I-11	TYPE 'S'	N 552133.68, E 1376528.90	222.20		217.92 / 215.14	214.64	D-4.22	
I-12	TYPE A-10	N 552222.36, E 1376363.90	227.36	226.76	213.23	213.13	D-4.03	
I-13	TYPE A-10	N 551985.18, E 1376634.95	220.54	219.94	-	217.05	D-4.03	
I-15	TYPE A-10	N 552058.12, E 1376497.84	223.10	222.50	-	218.75	D-4.03	
I-16	TYPE A-10	N 552113.40, E 1376392.31	225.13	224.53	-	220.85	D-4.03	
I-17	DOUBLE WR INLET	N 552155.30, E 1376396.12	226.26		-	222.50	D-4.35	
I-18	TYPE A-10	N 552222.12, E 1376575.64	226.70	226.10	-	222.40	D-4.03	
I-19	DOUBLE WR INLET	N 551980.83, E 1376553.46	221.49		-	215.00	D-4.35	
I-20	TYPE 'S'	N 551956.50, E 1376526.57	220.10		214.65	214.40	D-4.03	
I-21	TYPE 'S'	N 551936.20, E 1376477.02	221.00		213.98 / 213.98	213.88	D-4.03	
I-22	DOUBLE WR INLET	N 551858.02, E 1376464.05	220.54		-	216.00	D-4.35	
I-24	TYPE A-5	N 528528.19, E 1351267.40	223.94	223.34	212.38	212.28	D-4.01	
I-26	DOUBLE WR INLET	N 528712.88, E 1350986.25	219.00		-	214.83	D-4.35	
I-27	TYPE A-10	N 551815.79, E 1376454.88	220.80	220.20	213.82	213.57	D-4.03	
I-28	DOUBLE-S	N 551805.49, E 1376333.08	220.60		-	216.80	D-4.23	
I-29	D	N 551901.68, E 1376286.53	222.83	222.00	211.25	211.15	D-4.10	
M-1	STD. 4' PRECAST MANHOLE	N 552429.69, E 1376408.02	232.00		215.05	214.92	G 5.12	(1)
M-3	STD. 4' PRECAST MANHOLE	N 552190.17, E 1376421.99	226.50		216.30 / 213.81	213.71	G 5.12	(1)
M-4	STD. 5' PRECAST MANHOLE	N 552225.68, E 1376327.72	227.80		212.89	211.89	G 5.13	(1)
M-5	STD. 4' PRECAST MANHOLE	N 552013.19, E 1376653.53	221.70		216.73	216.48	G 5.12	(1)
M-6	STD. 4' PRECAST MANHOLE	N 552153.31, E 1376407.97	225.75		222.26 / 218.80	218.55	G 5.12	(1)
M-7	STD. 4' PRECAST MANHOLE	N 551805.19, E 1376488.51	221.00		213.82	213.57	G 5.12	(1)
M-8	STD. 4' PRECAST MANHOLE	N 551898.55, E 1376457.12	222.20		215.59	215.34	G 5.12	(1)
M-9	STD. 4' PRECAST MANHOLE	N 551870.46, E 1376343.97	222.50		216.10 / 212.34	212.24	G 5.12	(1)
M-10	STD. 4' PRECAST MANHOLE	N 527872.21, E 1351127.08	222.91		211.88 / 211.88	211.38	G 5.12	(1)
M-11	STD. 4' PRECAST MANHOLE	N 528088.17, E 1351212.23	221.50		210.99	210.89	G 5.12	(1)
M-12	STD. 4' PRECAST MANHOLE	N 528247.76, E 1351220.92	220.80		210.69	210.59	G 5.12	(1)
M-13	STD. 4' PRECAST MANHOLE	N 551980.61, E 1376392.97	224.50		213.10	213.00	G 5.12	(1)

(1) Coordinate for Proposed Structure = Centerline of Structure

PIPE SCHEDULE		
Size	Class	Total Length *
15"	HDPE	953
18"	HDPE	1,440
24"	HDPE	614

\* The total length of pipe is linear feet only.  
 HDPE is to be smooth interior. Contractor shall install pipe in accordance with manufacturer's specifications

OWNER/DEVELOPER  
 U.S. HOME CORPORATION  
 1021 W. JOSEPH COATING  
 8750  
 COLLINGSWOOD, MARYLAND 21044  
 410-997-5522

OWNER/DEVELOPER  
 BLUE STREAM LLC  
 #6 BOX 418  
 ELLICOTT CITY, MD 21044  
 C/O: ARNOLD SAGNER  
 410-465-2020

NO.	REVISION	DATE
1	REVISE PLAN TO ADD A 4" HIGH ORNAMENTAL WALL AND A 6" HIGH PRIVACY FENCE ALONG THE SE/NE QUARTER PROPERTY LINE	12/21/16

SITE DEVELOPMENT PLAN  
 STORM DRAIN PROFILES  
 BLUE STREAM TOWNS - SECTION 2  
 BLUE STREAM  
 LOTS 1-105, AND OPEN SPACE LOT 106  
 A RE-SUBDIVISION OF BUILDABLE BULK PARCEL L-1  
 TOWNHOMES  
 ZONED: CAC-CL1  
 HOWARD COUNTY, MARYLAND


**ROBERT H. VOGEL ENGINEERING, INC.**  
 ENGINEERS • SURVEYORS • PLANNERS  
 8407 MAIN STREET  
 ELLICOTT CITY, MD 21043  
 TEL: 410.461.7666  
 FAX: 410.461.8961


PROFESSIONAL CERTIFICATE  
 I HEREBY CERTIFY THAT THESE DOCUMENTS WERE PREPARED OR APPROVED BY ME AND THAT I AM A FULLY LICENSED PROFESSIONAL ENGINEER UNDER THE LAWS OF THE STATE OF MARYLAND, LICENSE NO. 16183 EXPIRATION DATE 09-27-2014

DESIGN BY: RHV  
 DRAWN BY: JMR  
 CHECKED BY: RHV  
 DATE: APRIL 2015  
 SCALE: AS SHOWN  
 W.O. NO.: 06-26.14

10 SHEET OF 13

APPROVED: HOWARD COUNTY DEPARTMENT OF PLANNING AND ZONING  
 [Signature] 5-22-15  
 CHIEF, DEVELOPMENT ENGINEERING DIVISION  
 [Signature] 6-02-15  
 CHIEF, DIVISION OF LAND DEVELOPMENT  
 [Signature] 6/2/15  
 DIRECTOR

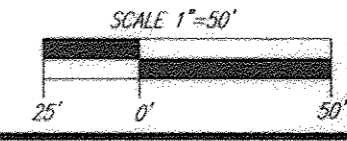

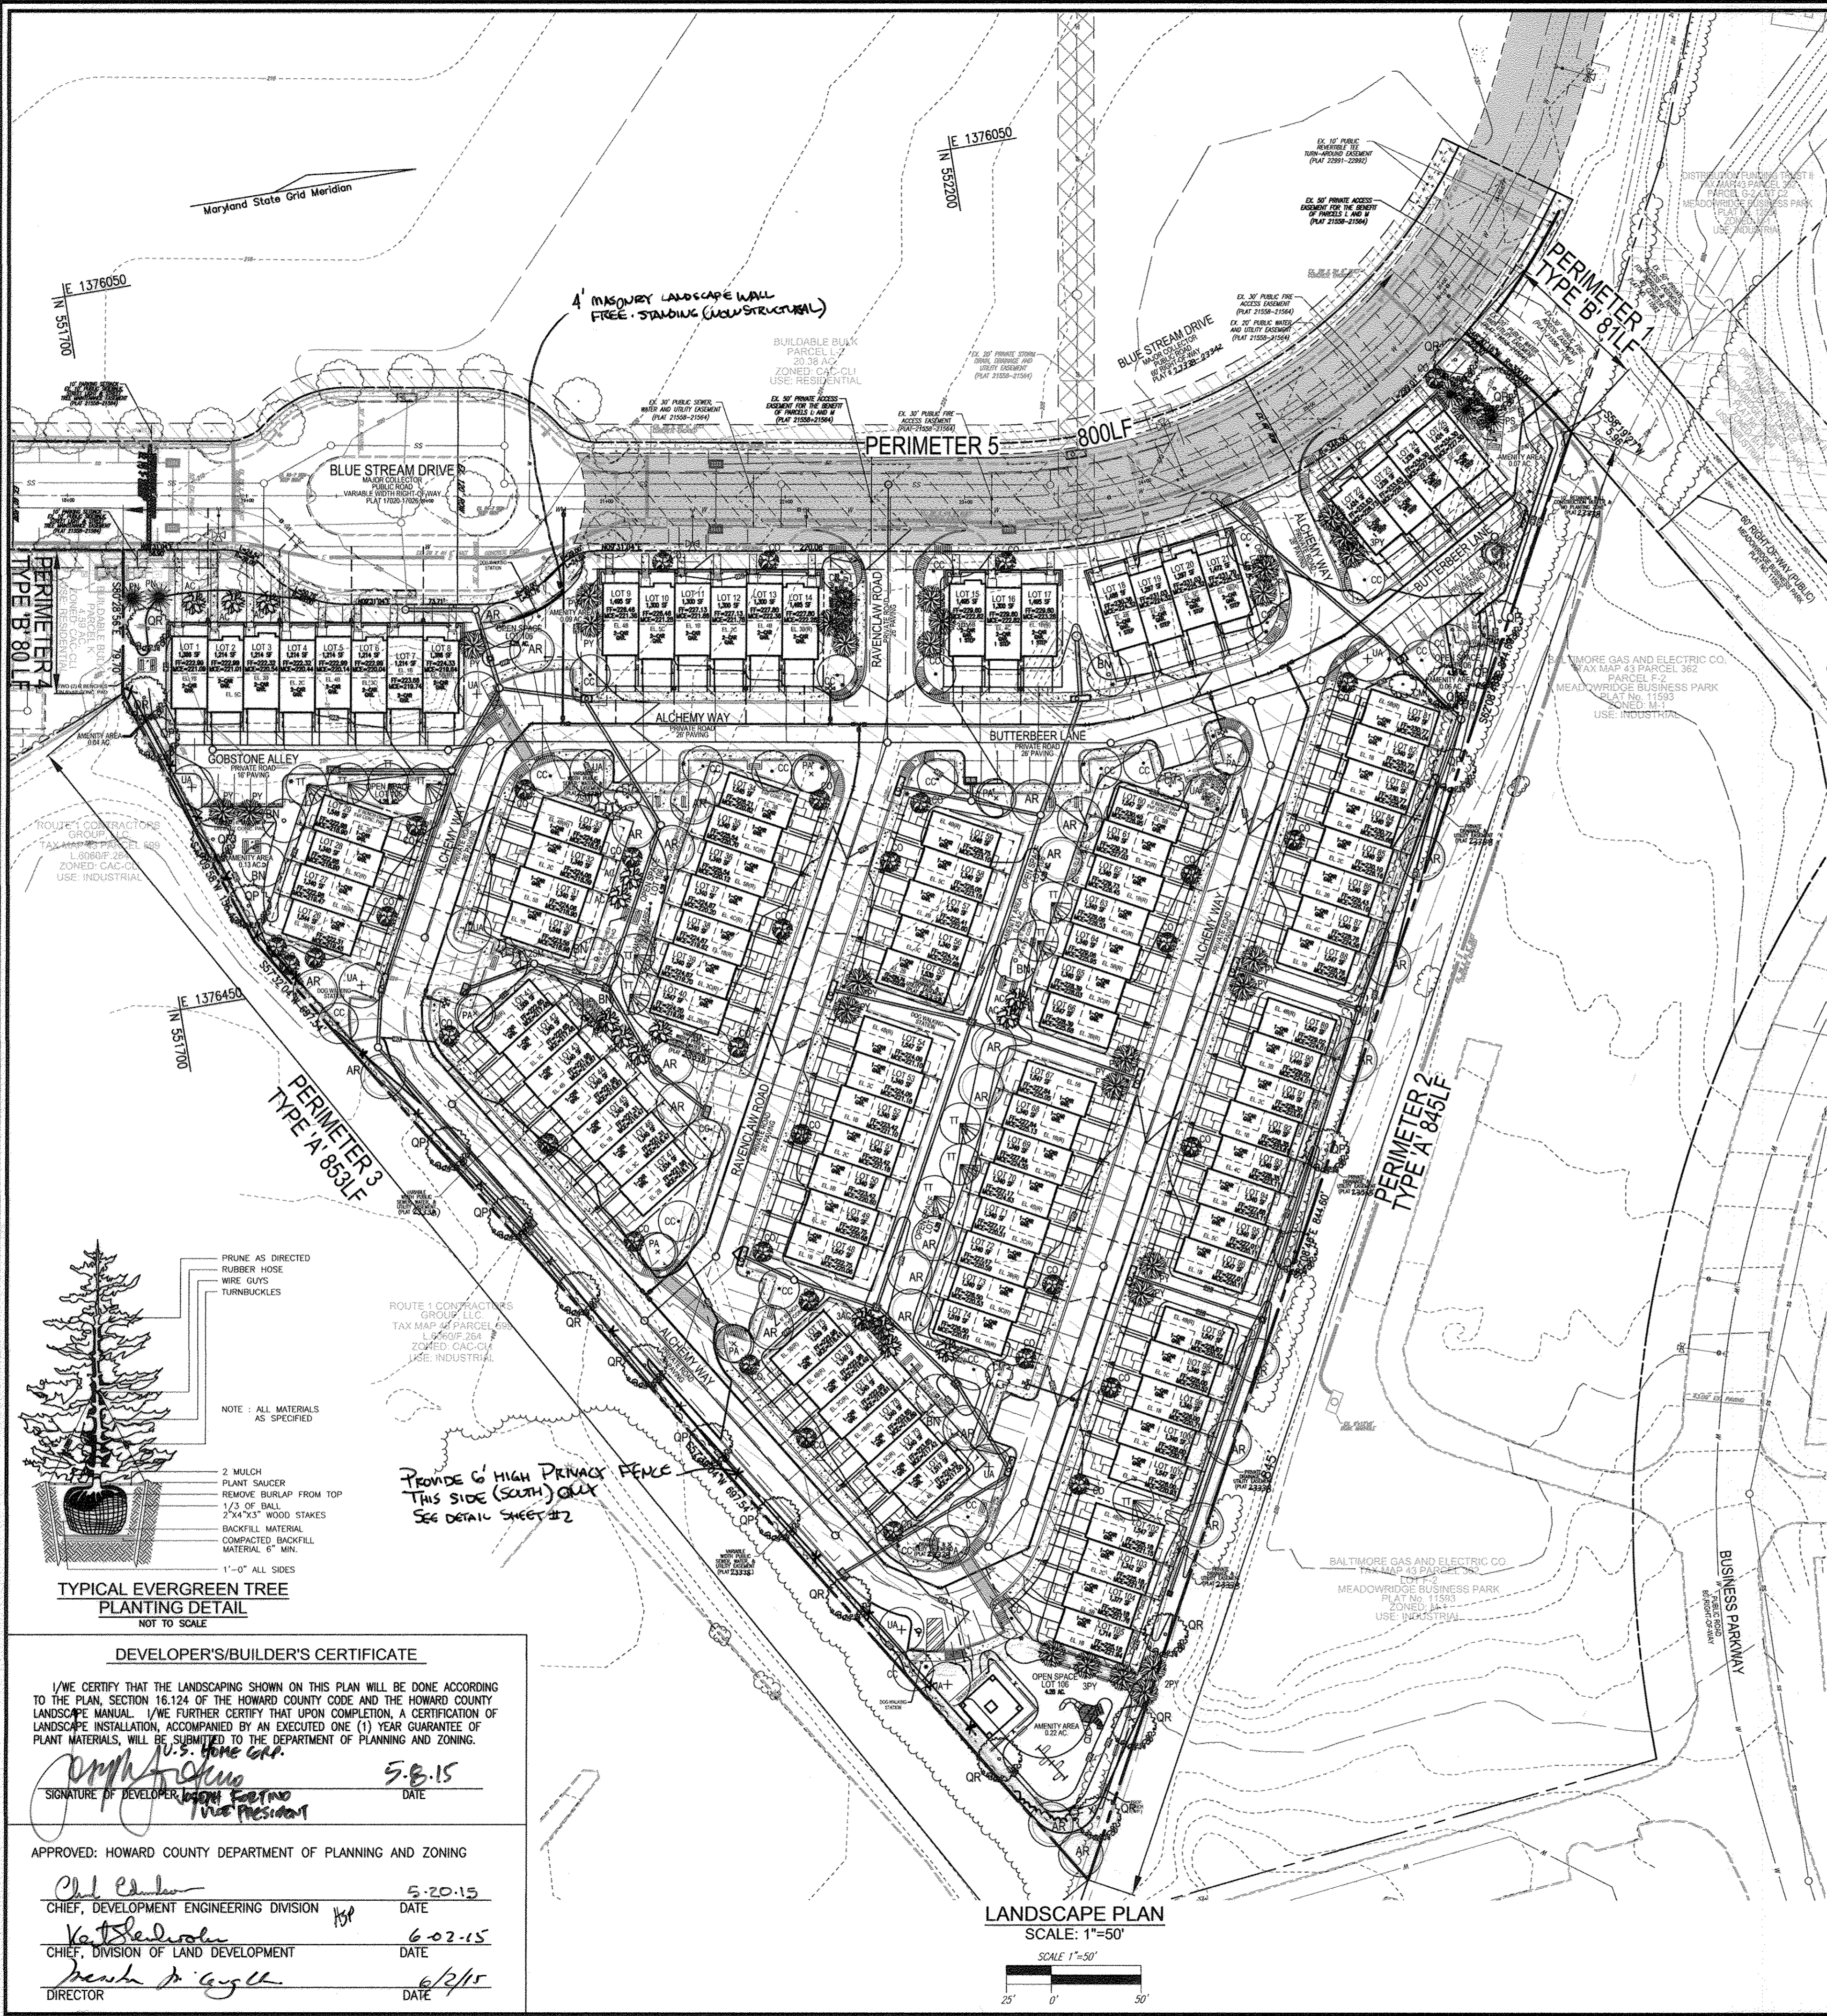

**GENERAL NOTES:**

- THIS PLAN HAS BEEN PREPARED IN ACCORDANCE WITH THE PROVISIONS OF SECTION 16.124 OF THE HOWARD COUNTY CODE AND THE LANDSCAPE MANUAL. THE REQUIRED PARKING AND PERIMETER LANDSCAPING WILL BE BONDED PER THIS SUBMISSION.
- FINANCIAL SURETY FOR THE REQUIRED LANDSCAPING HAS BEEN POSTED AS PART OF THE DEVELOPER'S AGREEMENT FOR THIS SITE DEVELOPMENT PLAN FOR 145 SHADE TREES AND 5 EVERGREEN TREES FOR A SURETY OF \$48,250.00. BID WILL BUILD THE 13 PUBLIC STREET TREES (\$3,900.00) INTO THEIR COST ESTIMATE FOR ROAD CONSTRUCTION. TOTAL OVERALL SURETY DUE IS \$48,150.00.

**LANDSCAPE SCHEDULE NOTE:**

- ALL PLANT MATERIALS SHALL BE FULL AND HEAVY, BE WELL FORMED AND SYMMETRICAL, CONFORM TO THE MOST CURRENT AAN SPECIFICATIONS AND BE INSTALLED IN ACCORDANCE WITH HRD PLANTING SPECIFICATIONS. CONTRACTOR SHALL VERIFY LOCATION OF ALL UNDERGROUND UTILITIES PRIOR TO DIGGING.
- FINAL LOCATION OF PLANT MATERIAL WILL NEED TO VARY TO MEET FINAL FIELD CONDITIONS. TREES SHALL NOT BE PLANTED IN THE BOTTOM OF DRAINAGE SWALES.
- CONTRACTOR SHALL VERIFY PLANT QUANTITIES PRIOR TO BIDDING. IF PLAN DIFFERS FROM LANDSCAPE SCHEDULE, THE PLAN SHALL GOVERN.
- THE OPEN SPACE REQUIREMENTS FOR THE BLUE STREAM SUBDIVISION (20% OF NET ACREAGE = 12.75 AC.) HAS BEEN PROVIDED UNDER F=10-055, OPEN SPACE LOTS G-1 AND G-2 (TOTAL 18.10 AC.).
- THE INDIVIDUAL BUILDABLE PARCELS WITHIN THE BLUE STREAM SUBDIVISION WILL COMBINE TO PROVIDE THE AMENITY AREA REQUIREMENT (50% OF OPEN SPACE REQUIREMENT = 6.37 AC.) WITH THEIR CORRESPONDING SITE DEVELOPMENT PLANS. THIS PLAN ACCOUNTS FOR 0.79 AC. OF AMENITY SPACE. REFER TO THE AMENITY AREA CHART FOR THE BLUE STREAM SUBDIVISION BELOW:

**BLUE STREAM SUBDIVISION AMENITY AREA CHART**  
6.37 AC. REQUIRED

PLAN	PROVIDED	REMAINING
BLUE STREAM (F-02-035)	0.00 AC.	6.37 AC.
CROSSCREEK HOUSE (SDP-11-035)	0.99 AC.	5.38 AC.
DORSET GARDENS (SDP-11-040)	1.02 AC.	4.36 AC.
BLUE STREAM TOWNS - SECTION 2 (SDP-14-029)	1.22 AC.	3.14 AC.
BROMPTON 2 (SDP-14-077)	0.87 AC.	2.27 AC.

**LANDSCAPE SCHEDULE**


KEY	QUAN.	BOTANICAL NAME	SIZE	ROOT	ROOT
AR	27	ACER RUBROM 'OCTOBER CLOVE'	2.5" CAL	B & B	B & B
QR	12	QUERCUS RUBRA	2.5" CAL	B & B	B & B
OP	12	QUERCUS PALUSTRIS PIN OAK	2.5" CAL	B & B	B & B
UA	11	ULMUS AMERICANA 'VALLEY FORGE'	2.5" CAL	B & B	B & B
TT	12	TILIA TOMENTOSA	2.5" CAL	B & B	B & B
BN	7	BETULA NIGRA 'HERITAGE'	12" HT.	B & B	B & B
CC	26	CARPINUS CAROLINIANA AMERICAN HORNBEAM	1.5"-2" CAL	B & B	B & B
PA	7	PLATANUS X ACROBOLIA 'BLOODGOOD'	1.5"-2" CAL	B & B	B & B
PN	2	PRINUS NIGRA	8" HT.	B & B	B & B
PS	2	PRINUS STROBUS	8" HT.	B & B	B & B
CO	34	CERCIS CANADENSIS 'OKLAHOMA'	8" HT.	B & B	B & B
PY	29	PRUNUS Y 'YONKISSIS 'ARABON'	8" HT.	B & B	B & B
AC	15	AMELANCHIER 'CANADENSIS'	1.5"-2" CAL	B & B	B & B
SM	4	SMILAX VULGARIS 'MONROE'	8" HT.	B & B	B & B
CM	4	LACINIUM TUSCARORA	12" HT.	B & B	B & B
AH	1	AMERICAN HOLLY	5' - 6' HT.	B & B	B & B

**LANDSCAPE SCHEDULE 'C'**

NUMBER OF DWELLING UNITS	105 SFA
NUMBER OF TREES REQUIRED (1:10 SFA)	105
NUMBER OF TREES PROVIDED	49
SHADE TREES (2:1 SUBSTITUTION)	112
SHRUBS (10:1 SUBSTITUTION)	-



**SCHEDULE B PARKING LOT INTERNAL LANDSCAPING**

NUMBER OF PARKING SPACES	53
NUMBER OF TREES REQUIRED (1:9 SPACES)	6
NUMBER OF TREES PROVIDED	6
SHADE TREES (2:1 SUBSTITUTION)	-
OTHER TREES (2:1 SUBSTITUTION)	-

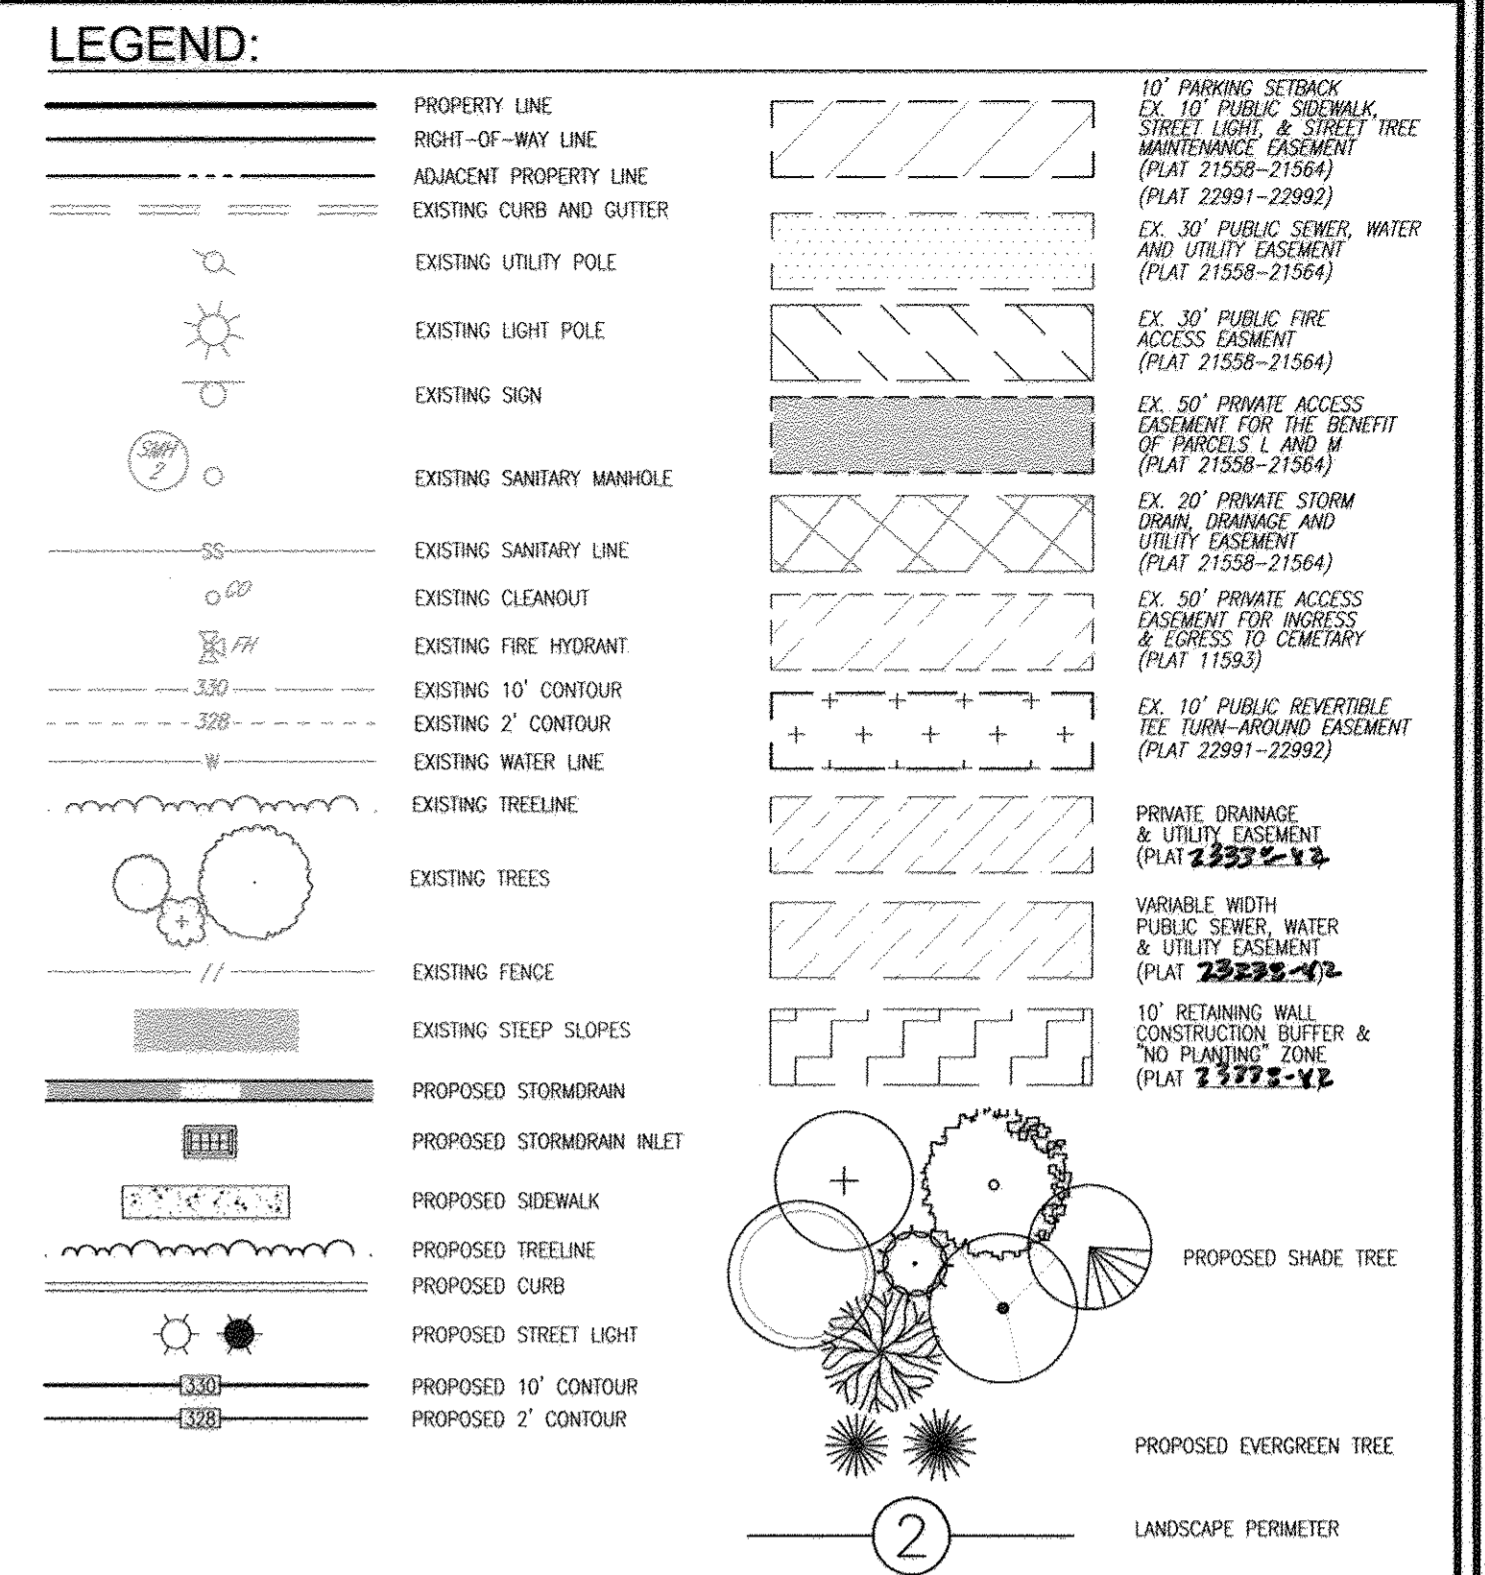


**SCHEDULE A PERIMETER LANDSCAPE EDGE**

CATEGORY	ADJACENT TO ROADWAYS AND PERIMETER PROPERTIES					TOTAL
	1	2	3	4	5	
PERIMETER FRONTAGE DESIGNATION						
LANDSCAPE TYPE						
LINEAR FEET OF ROADWAY FRONTAGE/PERIMETER	81'	845'	853'	80'	800'	
CREDIT FOR EXISTING VEGETATION (YES, NO, LINEAR FEET DESCRIBE BELOW IF NEEDED)	NO	NO	NO	NO	NO	
CREDIT FOR WALL, FENCE OR BERM (YES, NO, LINEAR FEET DESCRIBE BELOW IF NEEDED)	NO	NO	NO	NO	NO	
NUMBER OF PLANTS REQUIRED						
SHADE TREES	1:50 2	1:60 15	1:60 15	1:50 2	1:40 2	34
EVERGREEN TREES	1:40 3	1:60 15	1:60 15	1:50 2	1:40 2	5
SHRUBS	1:10 1	1:10 1	1:10 1	1:10 1	1:10 1	5
NUMBER OF PLANTS PROVIDED						
SHADE TREES	2	14	15	2	2	33
EVERGREEN TREES	1	1	1	1	1	5
OTHER TREES (2:1 SUBSTITUTION)	1	1	1	1	1	5
SHRUBS (10:1 SUBSTITUTION)	1	1	1	1	1	5
EX. SHADE TREES	1	1	1	1	1	5
EX. EVERGREEN TREES	1	1	1	1	1	5
EX. OTHER TREES (2:1 SUBSTITUTION)	1	1	1	1	1	5
DESCRIBE PLANT SUBSTITUTION CREDITS BELOW IF NEEDED						

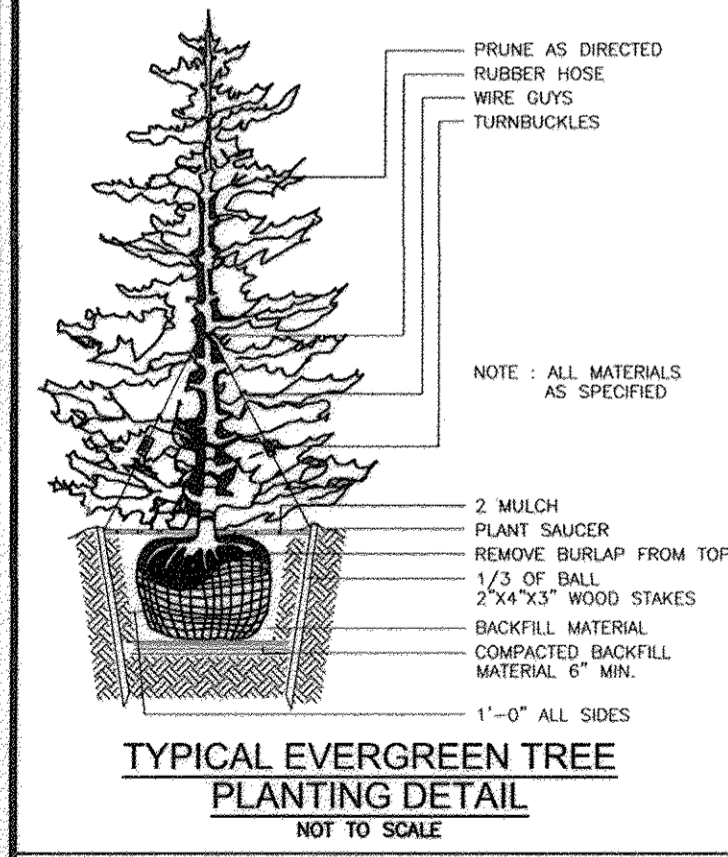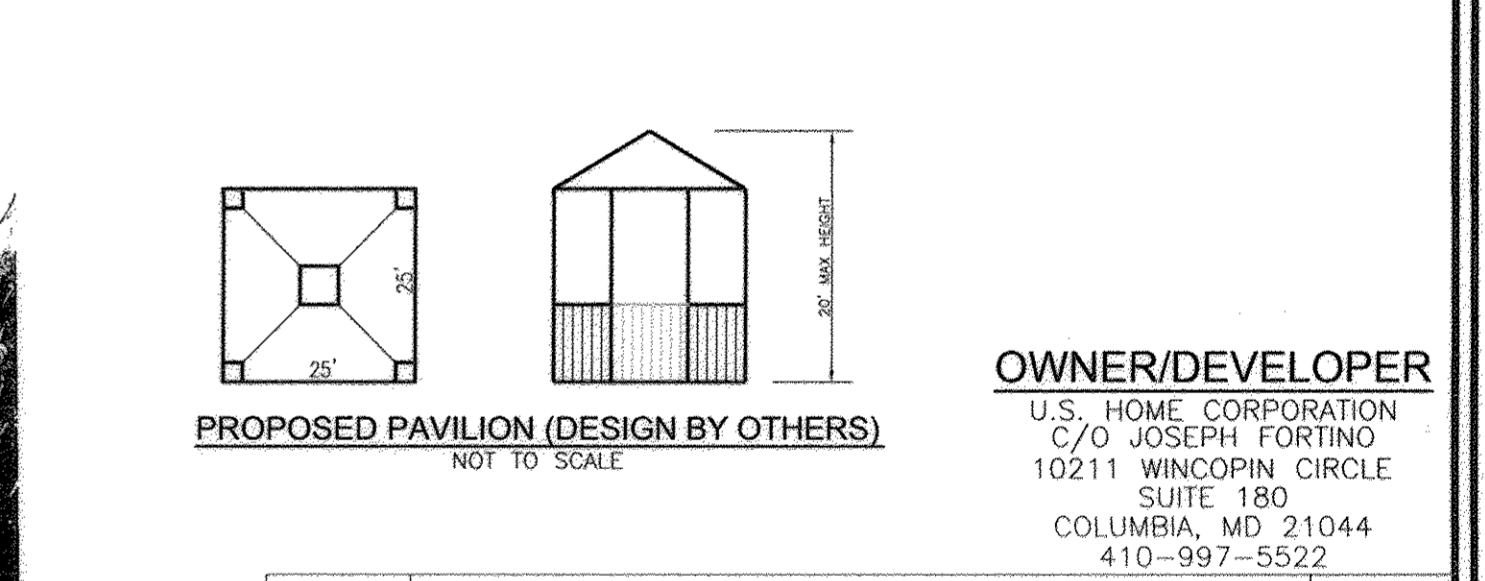

PROVIDE 6' HIGH PRIVACY FENCE THIS SIDE (SOUTH) ONLY SEE DETAIL SHEET #12

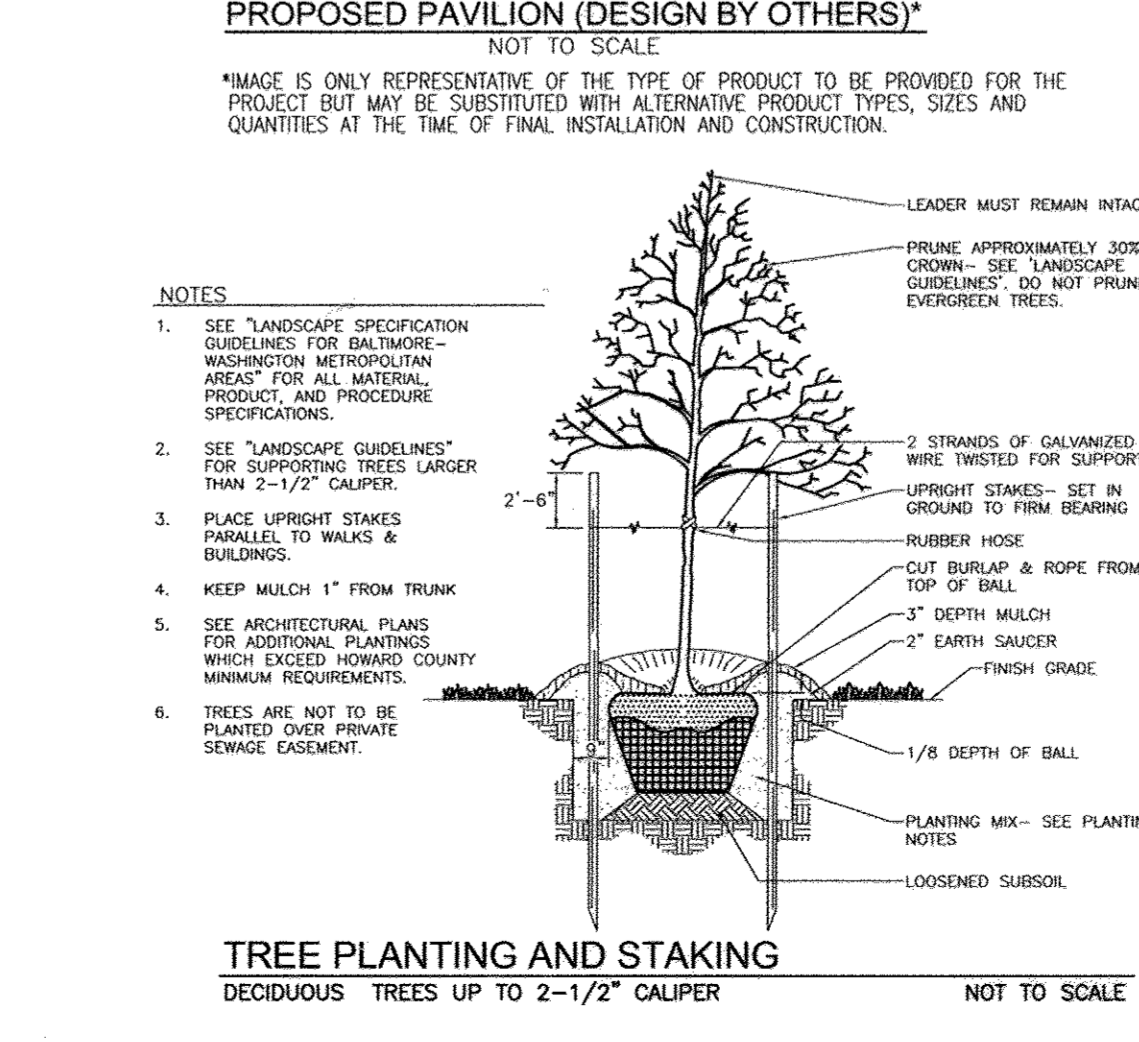

**DEVELOPER'S/BUILDER'S CERTIFICATE**

I/WE CERTIFY THAT THE LANDSCAPING SHOWN ON THIS PLAN WILL BE DONE ACCORDING TO THE PLAN, SECTION 16.124 OF THE HOWARD COUNTY CODE AND THE HOWARD COUNTY LANDSCAPE MANUAL. I/WE FURTHER CERTIFY THAT UPON COMPLETION, A CERTIFICATION OF LANDSCAPE INSTALLATION, ACCOMPANIED BY AN EXECUTED ONE (1) YEAR GUARANTEE OF PLANT MATERIALS, WILL BE SUBMITTED TO THE DEPARTMENT OF PLANNING AND ZONING.

U.S. Home Corp.  
Signature of Developer/Builder: *[Signature]* DATE: 5-8-15

APPROVED: HOWARD COUNTY DEPARTMENT OF PLANNING AND ZONING

Chief, Development Engineering Division: *[Signature]* DATE: 5-20-15

Chief, Division of Land Development: *[Signature]* DATE: 6-02-15

Director: *[Signature]* DATE: 6/2/15

**SITE DEVELOPMENT PLAN  
LANDSCAPE AND AMENITY  
AREA PLAN  
BLUE STREAM TOWNS - SECTION 2**

BLUE STREAM  
LOTS 1-105, AND OPEN SPACE LOT 106  
A RE-SUBDIVISION OF BUILDABLE BULK PARCEL L-1  
TOWNHOMES  
ZONED: CAC-CL1  
PARCEL 14  
HOWARD COUNTY, MARYLAND

TAX MAP 43 GRID A  
1ST ELECTION DISTRICT


**ROBERT H. VOGEL  
ENGINEERS • SURVEYORS • PLANNERS**  
8407 MAIN STREET  
ELLICOTT CITY, MD 21043  
TEL: 410.461.7666  
FAX: 410.461.8961

**PROFESSIONAL CERTIFICATE**


I HEREBY CERTIFY THAT THESE DOCUMENTS WERE PREPARED OR PROVIDED BY ME, AND THAT I AM A FULLY LICENSED PROFESSIONAL ENGINEER UNDER THE LAWS OF THE STATE OF MARYLAND, LICENSE NO. 16193.

DESIGN BY: RHV  
DRAWN BY: JMR  
CHECKED BY: RHV  
DATE: APRIL 2015  
SCALE: AS SHOWN  
W.O. NO.: 05-26.14

11 SHEET OF 13

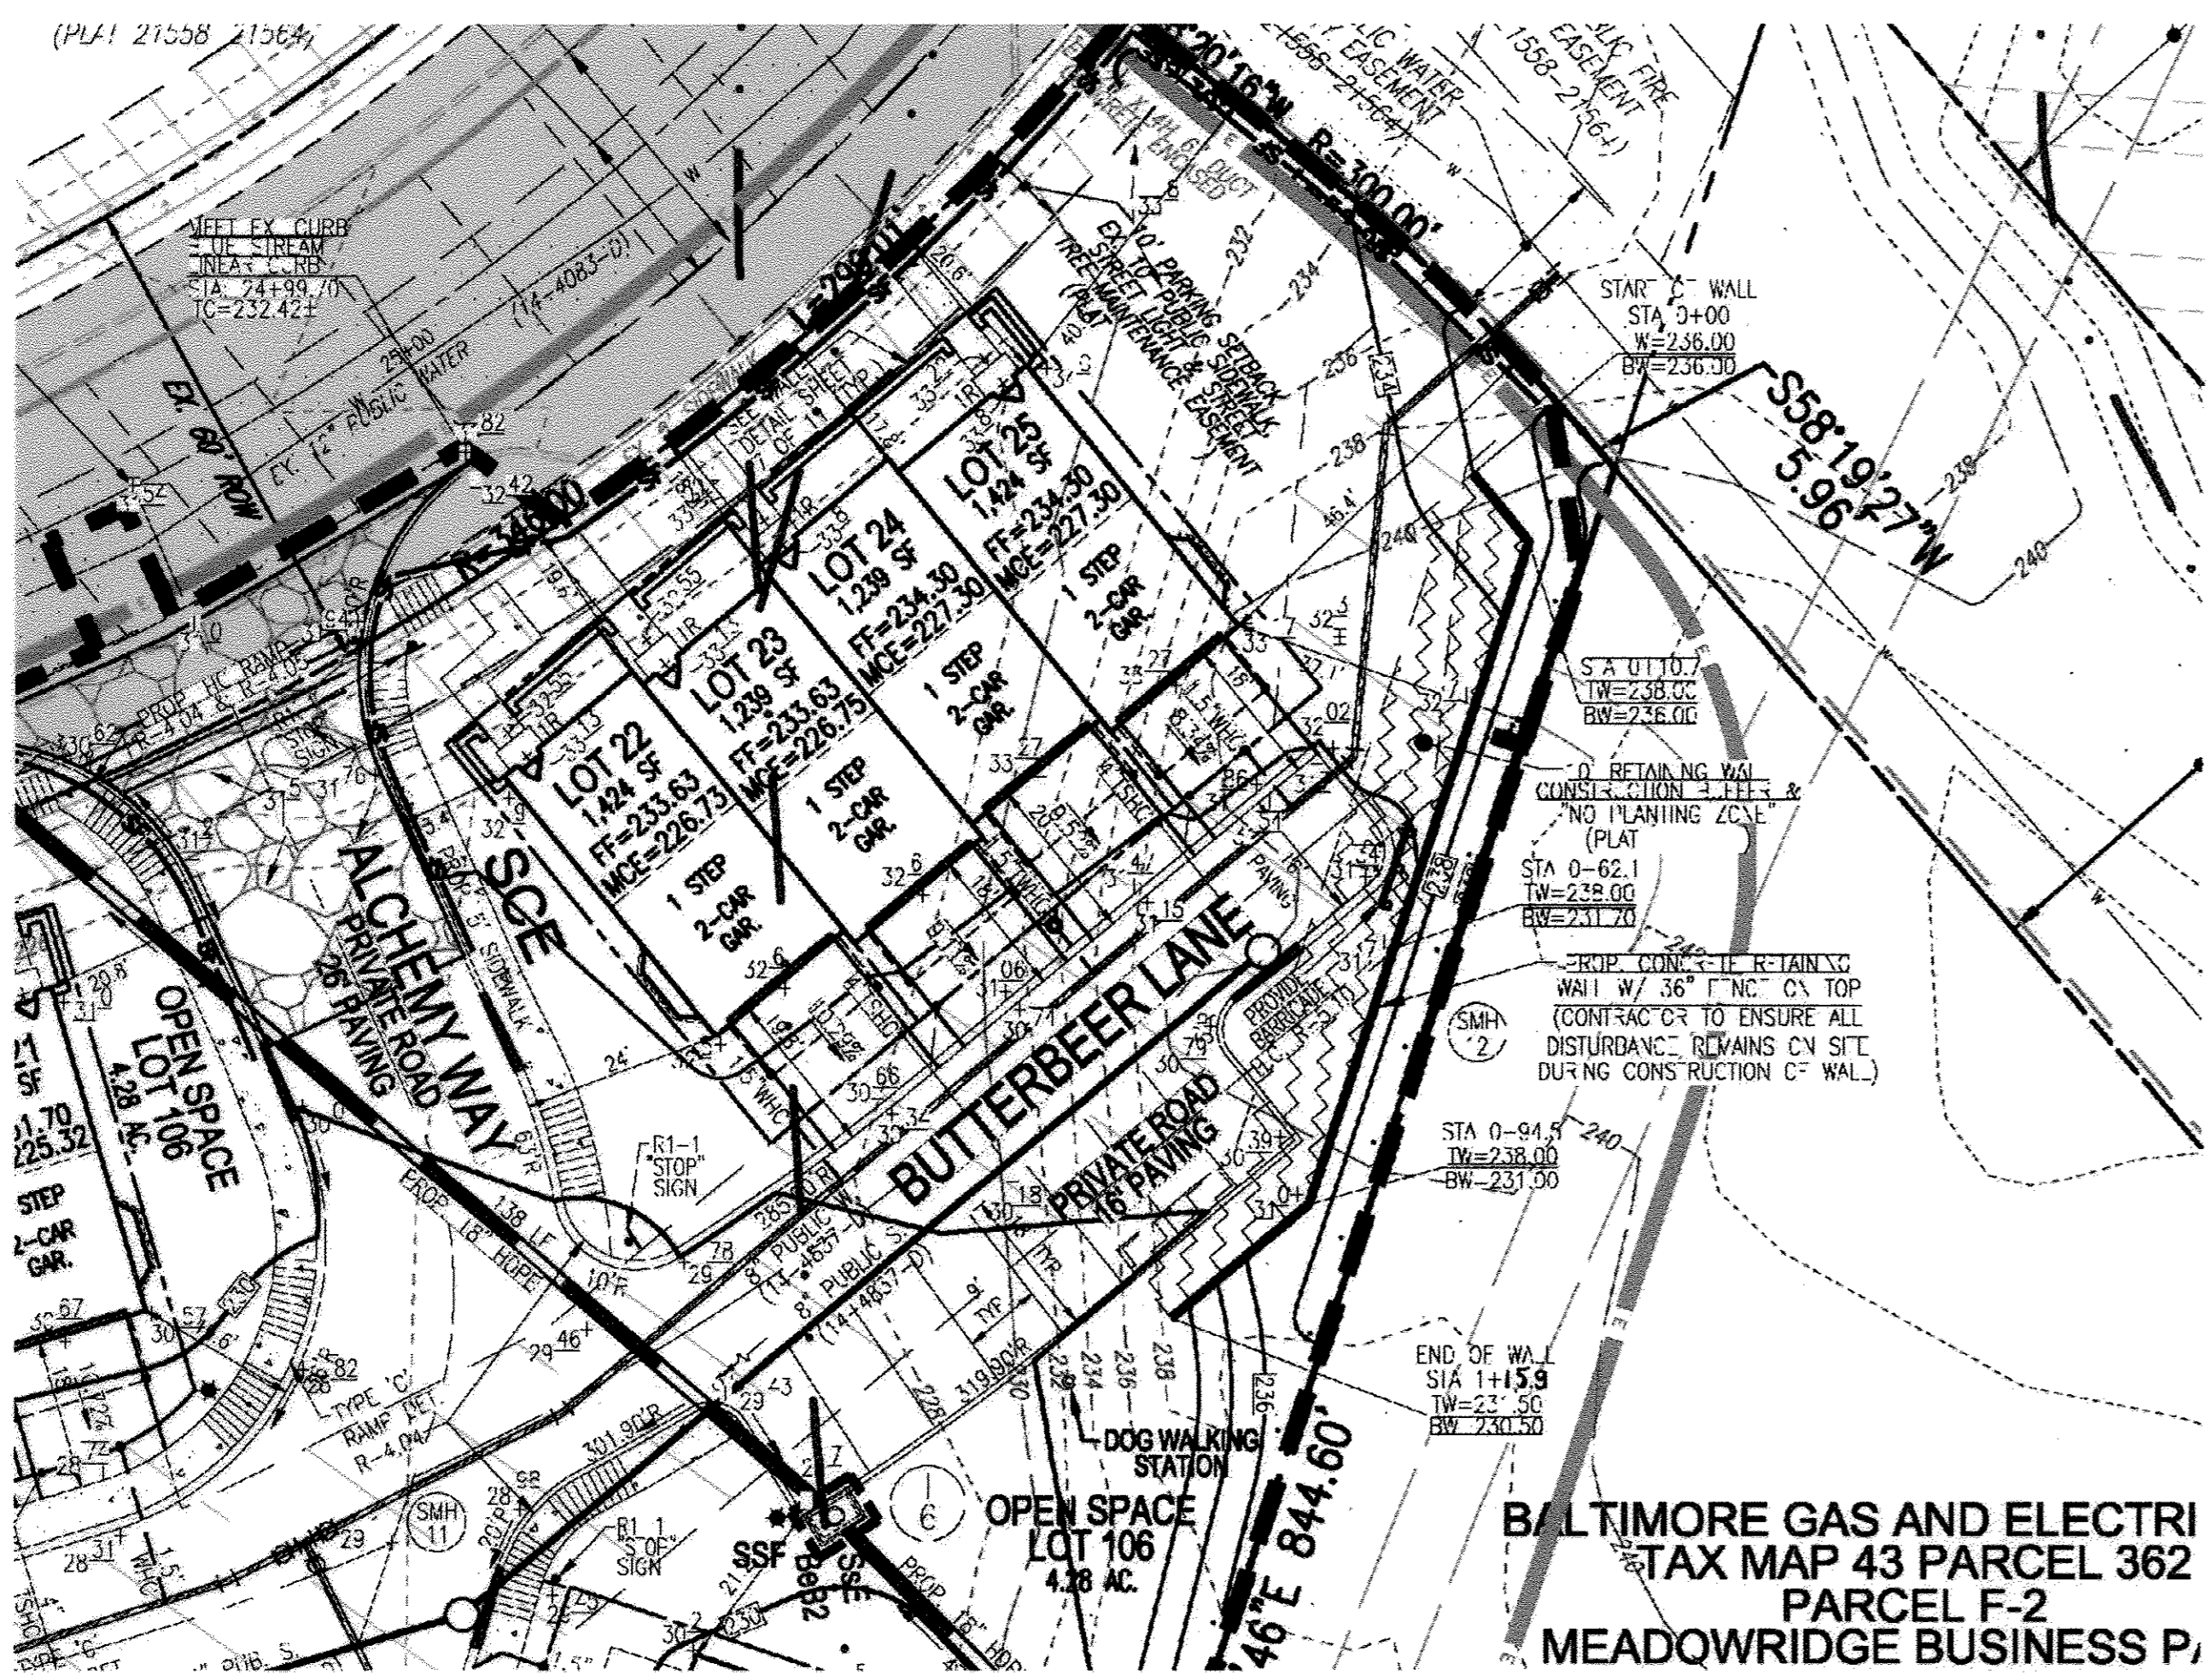

SITE PLAN (BASED ON PLAN PROVIDED BY ROBERT H. VOGEL ENGINEERING, INC) SCALE: 1"=20'

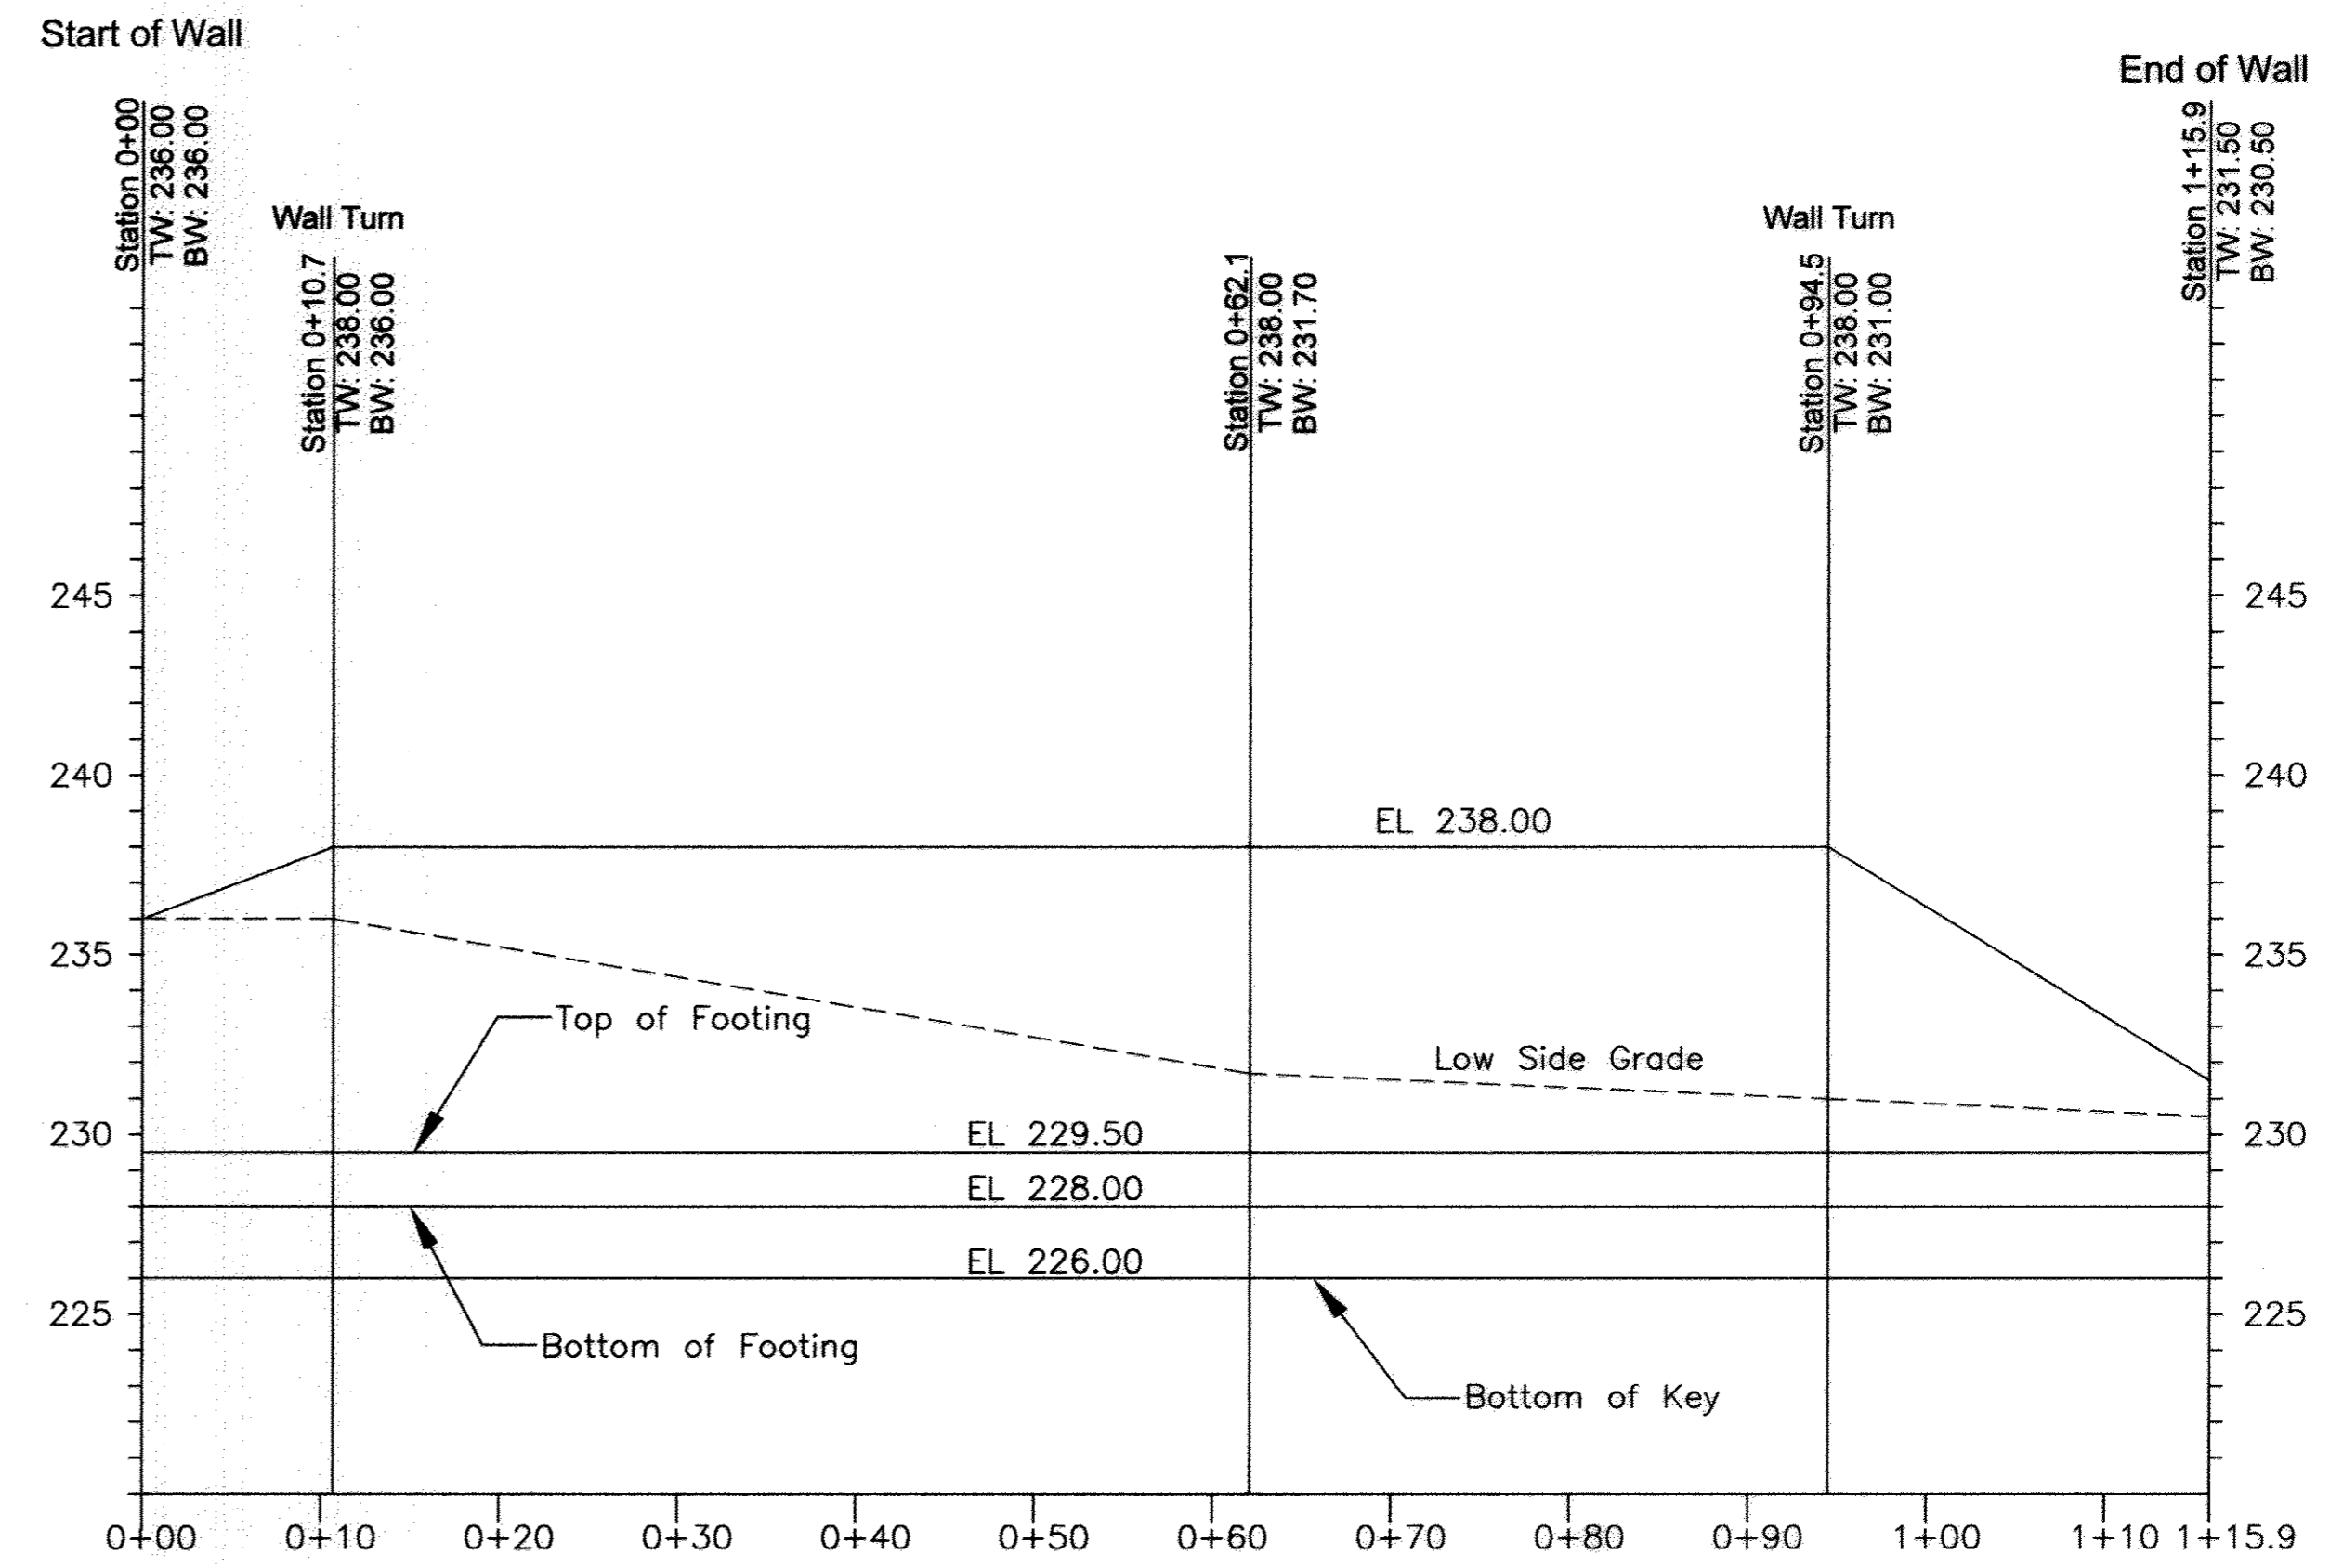

WALL PROFILE HORIZONTAL SCALE: 1"=10' VERTICAL SCALE: 1"=5'

OWNER/DEVELOPER  
U.S. HOME CORPORATION  
1021 WINDSOR CIRCLE  
COLUMBIA, MARYLAND 21044  
410-997-6522

OWNER/DEVELOPER  
BLUE STREAM LLC  
P.O. BOX 416  
ELLCOTT CITY, MD 21044  
C/O: ARNOLD BAGNER  
410-485-2020

NO.	REVISION	DATE
1	REVISE PLAN TO ADD A 4' HIGH ORNAMENTAL WALL AND A 6' HIGH PRIVACY FENCE TO THE SOUTHEASTERN PROPERTY LINE	12/21/16

RETAINING WALL  
PLAN & PROFILE

BLUE STREAM TOWNS - SECTION 2

BLUE STREAM  
LOTS 1-103, AND OPEN SPACE LOT 104  
A RE-SUBDIVISION OF BUILDABLE BULK PARCEL L

TAX MAP 43 GRID 4 TOWNHOMES PARCEL 14  
1ST ELECTION DISTRICT ZONED: CAC-CL1 HOWARD COUNTY, MARYLAND

**ECS**

1340 CHARWOOD ROAD  
SUITE A  
HANOVER, MARYLAND 21076  
PHONE: (410) 859-4300  
FAX: (410) 859-4324

PROFESSIONAL CERTIFICATE

DESIGN BY: HMA  
DRAWN BY: DMA  
CHECKED BY: DMA  
DATE: JANUARY 2015  
SCALE: AS SHOWN  
W.O. NO.: 06-26.14

I HEREBY CERTIFY THAT THESE DOCUMENTS WERE PREPARED OR APPROVED BY ME AND THAT I AM A FULLY LICENSED PROFESSIONAL ENGINEER UNDER THE LAWS OF THE STATE OF MARYLAND, LICENSE NO. 28533 EXPIRATION DATE: 12-31-2015

HASAN M. ABDUMATAR, PE

12 SHEET OF 13

APPROVED: HOWARD COUNTY DEPARTMENT OF PLANNING AND ZONING

Chief, Development Engineering Division  
6-20-15  
DATE

Chief, Division of Land Development  
6-02-15  
DATE

Director  
6/1/15  
DATE

**Retaining Wall Specifications and Guidelines**

**Part 1: General**


- 1.01 Description  
 A. Retaining walls must be constructed under the supervision of a Maryland Registered Professional Engineer.  
 B. Work includes preparation of foundation soils, furnishing all materials, and installing all materials to the lines and grades shown on the construction drawings.
- 1.02 Codes and Standards  
 A. 'International Building Code - 2012', International Code Council, Inc.  
 B. 'ACI Manual of Concrete Practice - Parts 1 Through 5 - 2012'  
 C. 'Manual of Standard Practice' - Concrete Steel Reinforcing Institute  
 D. 'American Society for Testing and Materials'
- 1.03 Damage, Storage, and Handling  
 A. The Contractor shall check the materials upon delivery to assure that the proper materials have been received.  
 B. The Contractor shall properly handle and store the materials to prevent damage to the materials. Damaged materials shall not be incorporated into the wall.
- 1.04 Quality Assurance  
 A. The Owner shall engage a qualified testing agency to provide observation and testing services as described below.  
 B. Concrete Placement  
 1. The agency shall inspect the formwork and reinforcing steel placement for compliance with the contract documents. Reinforcing steel should be inspected for correct size, quantity, and spacing.  
 2. Fresh concrete shall be sampled in accordance with ASTM C 172, and tested for slump, air entrainment, and temperature.  
 3. Test cylinders shall be molded in accordance with ASTM C 31. Four test cylinders shall be molded for each day's pour, or for every 50 cubic yards of concrete placed, whichever is greater.  
 C. Fill Placement  
 1. All soil fills shall be tested in accordance with ASTM D 2922.  
 2. A minimum of one compaction test per lift should be made per 2,500 square feet of fill lift area, but not fewer than two tests per lift should be made.  
 3. The elevations and locations of the field density tests should be clearly identified at the time of fill placement and compaction.

**Part 2: Materials**


- 2.01 Concrete  
 A. Concrete shall conform to Virginia Department of Transportation, State Highway Administration Standard Specifications for Construction and Materials, Section 414  
 B. Concrete shall have a minimum 28-day compressive strength of 3,500 psi.  
 C. Concrete shall have a slump range of 2 to 5 inches and shall be air entrained to 6% (+/- 1%) by volume.  
 D. Concrete shall have a minimum density of 145 pcf and a maximum water-to-cement ratio of 0.45
- 2.02 Steel Reinforcement  
 A. Steel reinforcing shall conform to ASTM A-615, Grade 60.  
 B. Submit shop drawings at least 15 business days before date reviewed submittals will be needed. Shop drawings shall bear the contractor's stamp of approval which shall constitute that he has verified all field measurements, construction criteria, materials, and similar data, and has checked each drawing for completeness, coordination, and compliance with contract documents.
- 2.03 Soil Backfill  
 A. Material should consist of soil classified as SM, SC, or more granular, in accordance with ASTM D 2487.  
 B. Material should have no particle larger than 2.5 inches and shall contain at least 30 percent, by weight, retained on the U.S. No. 200 sieve.  
 C. Materials should have a Liquid Limit less than 40, and a Plasticity Index less than 15.  
 D. Material should have a minimum friction angle of 28 degrees.  
 E. The Contractor should submit samples of the proposed backfill soils to the Geotechnical Engineer of Record for approval prior to their use.
- 2.04 Drainage Board  
 A. Drainage board used behind the walls shall consist of Miradrain 6200.

**Part 3: Construction**


- 3.01 General  
 A. All existing underground utilities shall be properly marked, and relocated if necessary, prior to construction.  
 B. All proposed underground utilities or structures in the general wall area shall be completely installed prior to the construction of the wall.  
 C. Protect all existing and/or new structures from damage by construction equipment. Immediately repair any damage that may occur.
- 3.02 Foundation  
 A. The wall foundation shall be excavated to the grades and lines as shown on the construction drawings. Contractor should take care not to disturb foundation soils beyond the lines and grades shown.  
 B. The foundation shall bear at the minimum embedment depths indicated, as measured from the final grade at the front of the wall.  
 C. The foundation subgrade soils shall be tested by a qualified representative of the Geotechnical Engineer to verify the availability of the design bearing pressure of 3,000 psf.  
 D. If unsuitable soils are encountered at design foundation levels, the unsuitable soils shall be removed and the over-excavated areas shall be replaced with compacted structural fill.
- 3.03 Steel Reinforcement  
 A. All steel reinforcing shall have a minimum clear cover of 2.5 inches unless otherwise noted on the contract documents.  
 B. Where applicable, splices for reinforcing steel shall be made by contact tension lap splices.  
 C. Welding and field-bending of reinforcing steel is not permitted.  
 D. Furnish all accessories, chairs, space bars, supports, etc. necessary to secure reinforcing.
- 3.04 Cast-In-Place Concrete  
 A. Footing Concrete  
 1. The vertical faces of the footing and key excavation may be used as forms for placement of foundation concrete.  
 2. Foundation concrete, or protective mud mats, should be placed the same day that the foundation subgrade is approved.  
 3. Provide concrete protection against freezing during placement and for 5 days thereafter.  
 B. Wall Concrete  
 1. Furnish and erect concrete forms to the lines and grades shown on the construction drawings.  
 2. Locate construction joints as to not impair the strength of the structure, but not more than 60 feet in any direction. Provide continuous bentonite strip waterstrip at all construction joints.  
 3. Make stops in concrete pours using vertical bulkheads.  
 4. All reinforcing shall be continuous through joints and bulkheads.  
 5. Chamfer exposed concrete corners 3/4" by 3/4" minimum.  
 6. Provide 4" diameter weep holes every 8 feet along the bottom of the wall and at wall ends. The weep holes should be formed in place prior to concrete placement by using PVC pipe. Weep hole locations must not interfere with steel reinforcing, and shall be no greater than 4 inches above final grade at the front of the wall.  
 7. Where a fence is required, it is recommended that the fence posts be installed during wall concrete placement. The fence posts shall have a minimum of 24 inches of embedment into the wall, and be located along the center of the wall. Alternatively, provide 4 inch diameter by 24 inch deep post holes at the designated fence post locations along the centerline of the wall. The post holes should be formed in place prior to concrete placement by using PVC pipe.
- 3.05 Backfilling  
 A. All soil backfill shall conform to the material requirements of section 2.03.  
 B. Backfill shall be moisture conditioned to within 2 percentage points of the optimum moisture content, as determined in accordance with ASTM D-698.  
 C. Backfill shall be placed in loose lifts, not exceeding 8 inches in thickness, and then compacted to at least 95 percent of the maximum dry density, as determined in accordance with ASTM D-698.  
 D. Backfilling shall not occur against the wall until the wall concrete has attained at least 75 percent of the 28-day design strength, and no earlier than 3 days after placement.  
 E. Where feasible, maintain equal grades on each side of the wall during backfilling to prevent overturning and lateral movements. When the grade differential at the wall exceeds 12 inches, only hand-operated compaction equipment shall be allowed.  
 F. Drainage boards shall be placed against the wall, extending from the weep hole up within 12 inches of final grade at the top of the wall.
- 3.06 Finish  
 A. Final grades at the wall shall be established by the Contractor in the field.  
 B. Final grades shall be stabilized and seeded per the approved civil plans unless noted otherwise on the site grading plans.  
 C. Install a 4 ft fence at the top of the wall. If fence posts are installed subsequent to wall construction, the fence posts shall be grouted into the PVC post holes using 3,000 psi non-shrink grout.

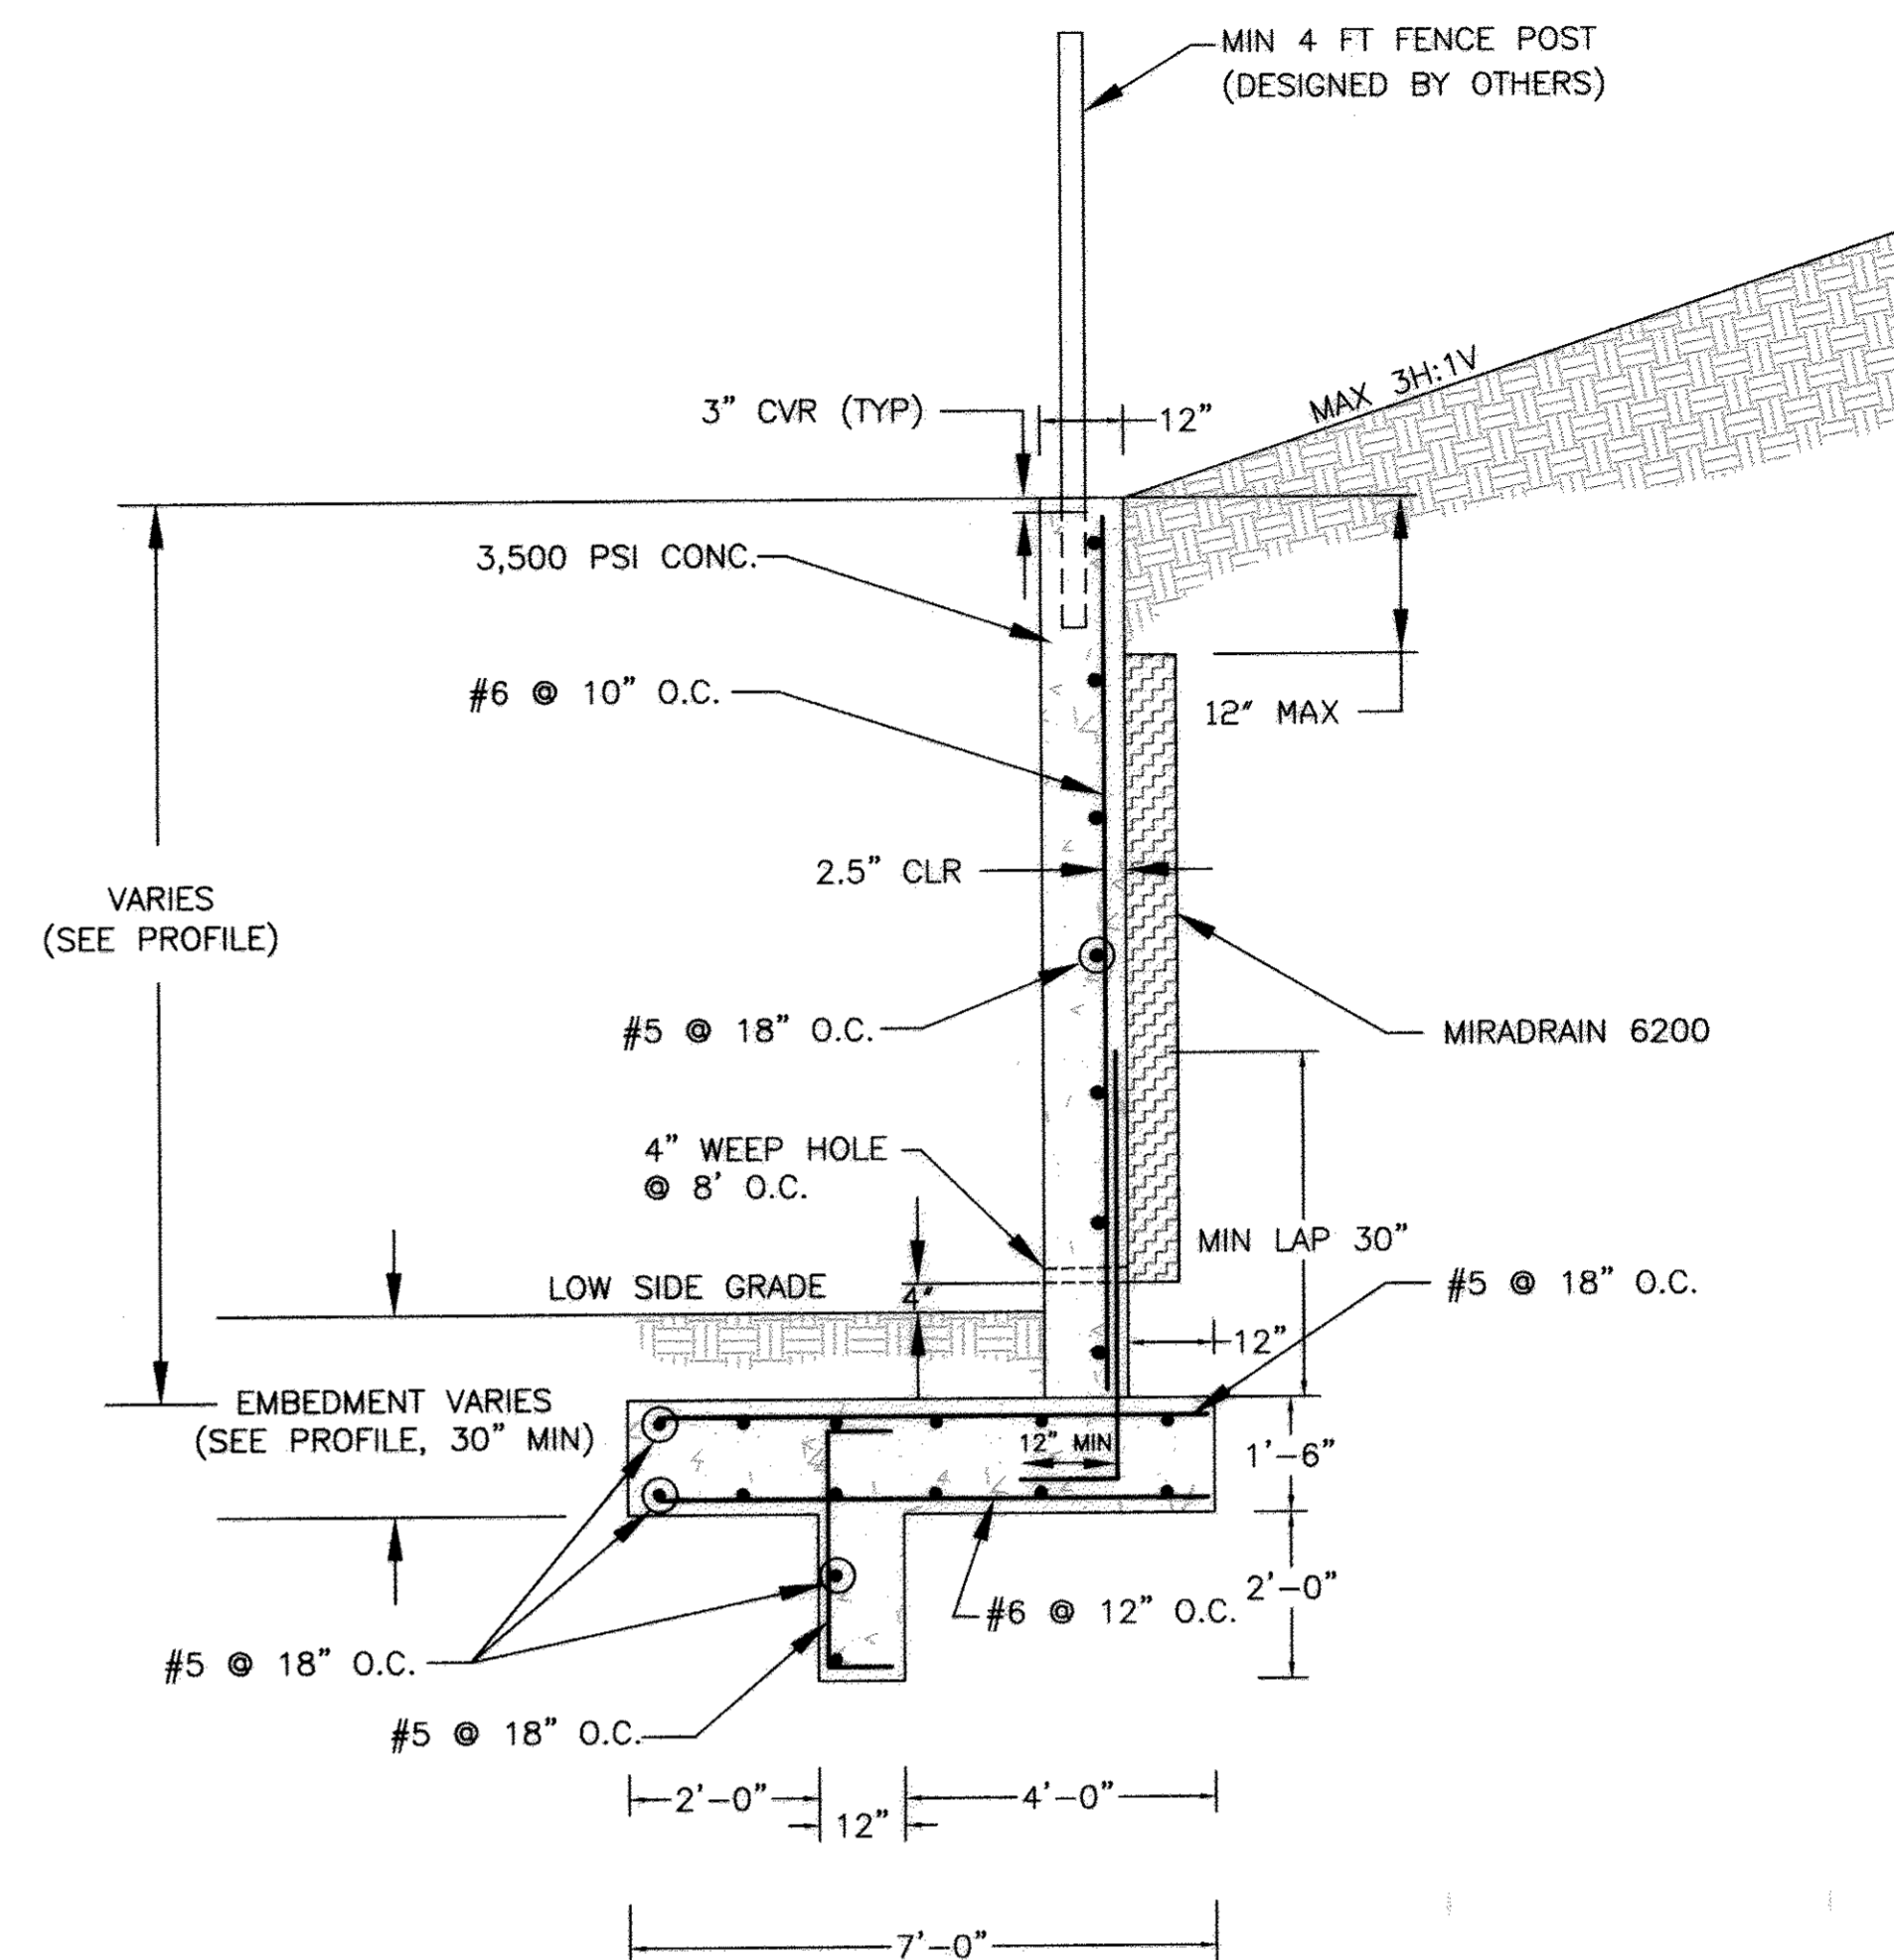

**TYPICAL WALL SECTION**

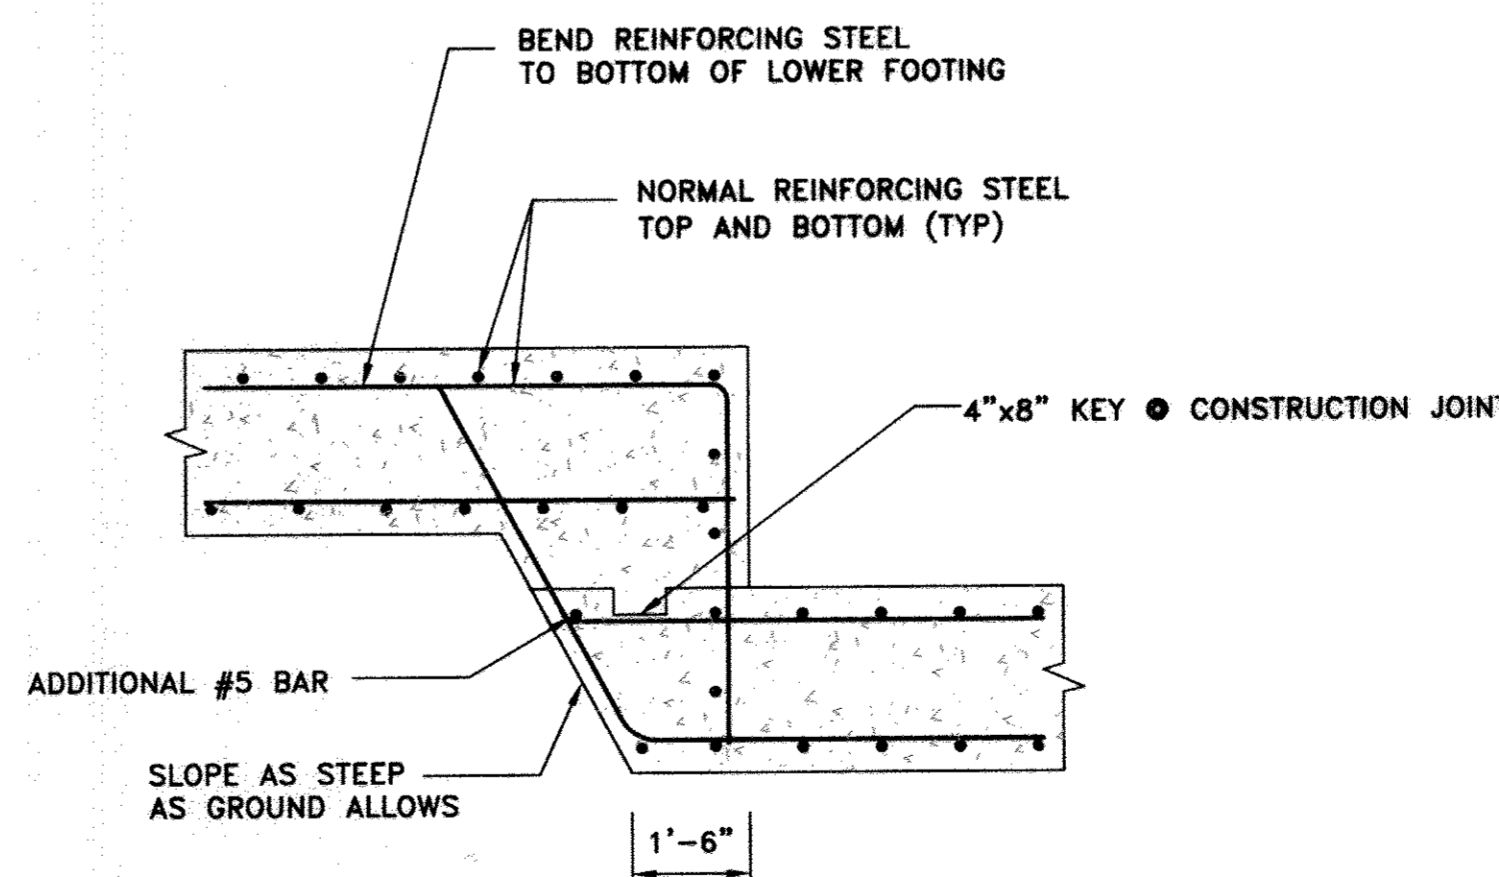

**FOOTING STEP NTS**

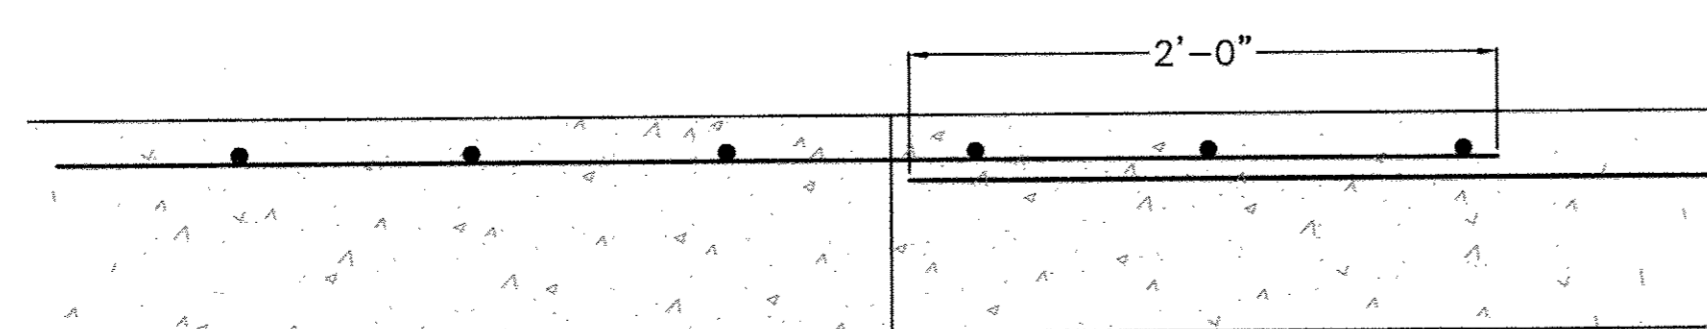

**CONSTRUCTION JOINT NTS**

OWNER/DEVELOPER  
 U.S. HOME CORPORATION  
 C/O JOSEPH FORTINO  
 110211 WINDSOR CIRCLE  
 #180  
 COLUMBIA, MARYLAND 21044  
 410-997-5522

OWNER/DEVELOPER  
 BLUE STREAM LLC  
 P.O. BOX 446  
 ELLICOTT CITY, MD 21041  
 C/O ARNOLD SAGNER  
 410-465-2020

NO.	REVISION	DATE
1	REVISE PLAN TO ADD A 4" HIGH ORNAMENTAL WALL AND A 6" HIGH	12/20/16
	PERMANENT FENCE TO THE SOUTHEASTERN PROPERTY LINE	

**RETAINING WALL  
 DETAILS & SECTIONS**

**BLUE STREAM TOWNS - SECTION 2**

BLUE STREAM  
 LOTS 1-103, AND OPEN SPACE LOT 104  
 A RE-SUBDIVISION OF BUILDABLE BULK PARCEL L

TAX MAP 43 GRID 4  
 1ST ELECTION DISTRICT

TOWNHOMES  
 ZONED: CAC-CLJ

PARCEL 14  
 HOWARD COUNTY, MARYLAND

**ECS**

1340 CHARWOOD ROAD  
 SUITE A  
 HANOVER, MARYLAND 21076  
 PHONE: (410) 859-4300  
 FAX: (410) 859-4324

PROFESSIONAL CERTIFICATE

I HEREBY CERTIFY THAT THESE DOCUMENTS  
 WERE PREPARED OR APPROVED BY ME, AND  
 THAT I AM A FULLY LICENSED PROFESSIONAL  
 ENGINEER UNDER THE LAWS OF THE STATE  
 OF MARYLAND, LICENSE NO. 29553  
 EXPIRATION DATE: 12-31-2015

DESIGN BY: HMA  
 DRAWN BY: DMA  
 CHECKED BY: DMA  
 DATE: JANUARY 2015  
 SCALE: AS SHOWN  
 W.O. NO.: 06-28.14

13 SHEET OF 13

SDP-14-029

APPROVED: HOWARD COUNTY DEPARTMENT OF PLANNING AND ZONING

*Chad Edwards* 5.20.15  
 CHIEF, DEVELOPMENT ENGINEERING DIVISION DATE

*Kathleen* 6.02.15  
 CHIEF, DIVISION OF LAND DEVELOPMENT DATE

*Marvin M. Wright* 6/2/15  
 DIRECTOR DATE