

SITE DEVELOPMENT PLAN

DEMIREL PLAZA


(L.11399/F.313)

2ND ELECTION DISTRICT

HOWARD COUNTY, MARYLAND

GENERAL NOTES

- ALL ASPECTS OF THE PROJECT ARE IN CONFORMANCE WITH THE LATEST HOWARD COUNTY STANDARDS PLUS MSHA STANDARDS AND SPECIFICATIONS IF APPLICABLE UNLESS WAIVERS HAVE BEEN APPROVED.
- THE CONTRACTOR IS TO NOTIFY THE FOLLOWING UTILITIES OR AGENCIES AT LEAST FIVE DAYS BEFORE STARTING WORK ON THESE DRAWINGS:
 - MISS UTILITY: 1-800-257-7777
 - VERIZON TELEPHONE COMPANY: 1-410-954-6281
 - HOWARD COUNTY BUREAU OF UTILITIES: 410-313-2366
 - AT&T CABLE LOCATION DIVISION: 1-800-393-3553
 - B.G. & E. CO. LOCATION SERVICES: 410-850-4620
 - B.G. & E. CO. UNDERGROUND DAMAGE CONTROL: 410-787-4600
 - STATE HIGHWAY ADMINISTRATION: 410-531-5533
- THE CONTRACTOR SHALL NOTIFY "MISS UTILITY" AT 1-800-257-7777 AT LEAST 48 HOURS PRIOR TO ANY EXCAVATION WORK.
- THE CONTRACTOR SHALL NOTIFY THE DEPARTMENT OF PUBLIC WORKS/BUREAU OF ENGINEERING/CONSTRUCTION INSPECTION DIVISION AT (410) 313-1880 AT LEAST FIVE (5) WORKING DAYS PRIOR TO START OF WORK. IN ADDITION, THE CONTRACTOR OR DEVELOPER SHALL CONTACT THE CONSTRUCTION INSPECTION DIVISION 24 HOUR IN ADVANCE OF COMMENCEMENT OF WORK AT (410) 313-1880
- ANY DAMAGE TO PUBLIC RIGHT-OF-WAY, PAVING, OR EXISTING UTILITIES WILL BE CORRECTED AT THE CONTRACTOR'S EXPENSE.
- THE PROPERTY LINES SHOWN HEREON IS BASED ON A FIELD RUN BOUNDARY SURVEY PERFORMED BY ROBERT H. VOGEL ENGINEERING, INC. DATED SEPTEMBER, 2011. THIS SURVEY WAS PREPARED WITHOUT THE BENEFIT OF A TITLE REPORT FROM A CERTIFIED TITLE ABSTRACTOR. A TITLE REPORT COULD REVEAL ADDITIONAL CONVEYANCES, EASEMENTS, OR RIGHT-OF-WAYS NOT SHOWN HEREON.
- DEED REFERENCE:
 - DEMIREL PLAZA LLC LIBER 16057, FOLIO 345 DATED - OCTOBER 14, 2014
- THE COORDINATES SHOWN HEREON ARE BASED UPON THE HOWARD COUNTY GEODETIC CONTROL WHICH IS BASED UPON THE MARYLAND STATE PLANE COORDINATE SYSTEM. HOWARD COUNTY MONUMENT NOS. 0066 AND 2485 WERE USED FOR THIS PROJECT.
- THE SUBJECT PROPERTY IS ZONED OT (OFFICE TRANSITION) PER THE 10/06/13 COMPREHENSIVE ZONING PLAN REFER TO ZB1098M
- THIS PROJECT IS SUBJECT TO COMPLIANCE WITH THE AMENDED FIFTH EDITION OF THE SUBDIVISION AND LAND DEVELOPMENT REGULATIONS. DEVELOPMENT OR CONSTRUCTION ON THIS PROPERTY MUST COMPLY WITH SETBACK AND BUFFER REGULATIONS IN EFFECT AT THE TIME OF SUBMISSION OF THE SITE DEVELOPMENT PLAN, WAIVER PETITION APPLICATION OR BUILDING / GRADING PERMIT APPLICATIONS.
- THE EXISTING TOPOGRAPHY SHOWN HEREON IS FROM A FIELD RUN TOPOGRAPHIC SURVEY PREPARED BY ROBERT H. VOGEL ENGINEERING, INC., PERFORMED ON SEPTEMBER, 2011. OFFSITE TOPOGRAPHY FROM HOWARD COUNTY GIS DATA.
- EXISTING UTILITIES LOCATED FROM ROAD CONSTRUCTION PLANS, FIELD SURVEYS, PUBLIC WATER AND AND SEWER EXTENSION PLANS AND AVAILABLE RECORD DRAWINGS. APPROXIMATE LOCATION OF EXISTING UTILITIES ARE SHOWN FOR THE CONTRACTORS INFORMATION. CONTRACTOR SHALL LOCATE EXISTING UTILITIES WELL IN ADVANCE OF CONSTRUCTION ACTIVITIES AND TAKE ALL NECESSARY PRECAUTIONS TO PROTECT THE EXISTING UTILITIES AND TO MAINTAIN UNINTERRUPTED SERVICE. ANY DAMAGE INCURRED DUE TO CONTRACTOR'S OPERATION SHALL BE REPAIRED IMMEDIATELY AT THE CONTRACTOR'S EXPENSE.
- SOIL TYPES SHOWN HEREON ARE IN ACCORDANCE WITH THE WEB SOIL SURVEY, HOWARD COUNTY MARYLAND.
- SOIL COMPACTION SPECIFICATIONS, REQUIREMENTS, METHODS AND MATERIALS ARE TO BE IN ACCORDANCE WITH THE RECOMMENDATIONS OF THE PROJECT GEOTECHNICAL ENGINEER TO CONFIRM ACCEPTABILITY OF PROPOSED PAVING SECTION, BASED ON SOIL TEST PRIOR TO CONSTRUCTION.
- A GEOTECHNICAL ENGINEER TO CONFIRM PAVING SECTION & PERMEABLE SURFACE THICKNESS PRIOR TO CONSTRUCTION. ALL PAVING EXCEPT, PERMEABLE SURFACES, TO BE MINIMUM P-2 PAVING, UNLESS OTHERWISE NOTED.
- THERE ARE EXISTING STRUCTURES LOCATED ON SITE TO BE REMOVED.
- TO THE BEST OF THE OWNERS KNOWLEDGE, THERE ARE NO BURIAL GROUNDS OR CEMETERIES LOCATED ON THIS PROPERTY.
 - THIS SITE IS NOT LOCATED IN A HISTORIC DISTRICT.
 - THE PROJECT HAS A HISTORIC STRUCTURE KNOWN AS #10111 FREDERICK ROAD (H0843)
 - THE PROJECT HAS GONE BEFORE THE HISTORIC DISTRICT COMMISSION ON 9-12-2013. THE HISTORIC DISTRICT COMMISSION HAD NO OBJECTION TO CONSTRUCTION OF THE STRUCTURE PER LETTER DATED 10-3-2013.
- NO STEEP SLOPES OVER 20,000 SF CONTIGUOUS ARE LOCATED ONSITE.
- AN APPO TRAFFIC STUDY HAS BEEN PREPARED BY MARS GROUP, JULY 2013.
- THIS PORTION OF FREDERICK ROAD IS NOT A SCENIC ROAD.
- FREDERICK ROAD IS CLASSIFIED AS A MINOR ARTERIAL ROAD. A 35MPH SPEED LIMIT IS POSTED.
- A NOISE STUDY IS NOT REQUIRED FOR THIS PROJECT.
- THIS PROPERTY IS LOCATED WITHIN THE METROPOLITAN DISTRICT.
- THIS SITE IS CURRENTLY SERVED BY PUBLIC WATER CONTRACT NO. 27-W.
- THIS SITE IS CURRENTLY SERVED BY PUBLIC SEWER VIA CONTRACT NO. 186-S.
- WATER AND SEWER FOR THIS PROJECT WILL BE PROVIDED THROUGH A PUBLIC EXTENSION OF WATER CONTRACT 27-W AND PUBLIC / PRIVATE EXTENSION OF SEWER CONTRACT 186-S. PUBLIC WATER EXTENSION SHALL BE COMPLETED UNDER THE HOWARD COUNTY ADD PROCESS UNDER THE PROVISIONS OF SECTION 18.122.B OF THE HOWARD COUNTY CODE. ALL CONSTRUCTION SHALL BE IN CONFORMANCE WITH ALL HOWARD COUNTY VOLUME II AND IV DETAILS.
- THERE ARE NO FLOODPLAIN, WETLANDS, WETLAND BUFFERS, STREAMS, STREAM BUFFERS OR STEEP SLOPES WITHIN THE PROJECT.
- THERE ARE NO WETLANDS OR STREAMS ON THIS SITE AS DETERMINED BY ECO-SCIENCE PROFESSIONALS, INC. DATED FEBRUARY 2013.
- FOREST STAND DELINEATION PLAN HAS BEEN PREPARED BY ECO-SCIENCE PROFESSIONALS, INC. DATED FEBRUARY 2013. THERE ARE SPECIMEN TREES ONSITE WITHIN THE LOD PROPOSED TO BE REMOVED.
- THIS PROJECT IS SUBJECT TO WP-14-085. ON FEBRUARY 25, 2014; THE PLANNING DIRECTOR ISSUED NO ACTION TO THE REQUEST. TO WAIVE SECTION 16.1205(A)(7) WHICH REQUESTS THE RETENTION OF SPECIMEN TREES HAVING A DIAMETER OF 30" OR MORE. NO ACTION WAS TAKEN UNTIL COMMENTS WERE ADDRESSED.
- IN APRIL 2014, A REQUEST FOR RECONSIDERATION WAS SUBMITTED AND ON APRIL 16, 2014; THE PLANNING DIRECTOR APPROVED THE REQUEST TO WAIVE SECTION 16.1205(A)(7) OF THE HOWARD COUNTY SUBDIVISION AND LAND DEVELOPMENT REGULATIONS. APPROVAL ALLOWS FOR THE REMOVAL OF FOUR SPECIMEN TREES AS PROPOSED BY THE SITE DEVELOPMENT PLAN. APPROVAL IS SUBJECT TO THE FOLLOWING CONDITIONS:
 - THE PETITIONER SHALL PROVIDE A 1:1 REPLACEMENT PLANTING ONSITE TO MITIGATE REMOVAL OF THE FOUR SPECIMEN TREES. THE REPLACEMENT PLANTINGS SHALL BE MADE PART OF THE LANDSCAPE PLAN AND SHALL CONSIST OF SPECIES SIMILAR TO THE TREES REMOVED AND EQUAL TO OR GREATER THAN THE SIZES AND SPECIFICATIONS FOUND FOR SUCH PLANTINGS IN THE HOWARD COUNTY LANDSCAPE MANUAL. THE PETITIONER SHALL INDICATE AND IDENTIFY THE REPLACEMENT PLANTINGS ON THE LANDSCAPE PLAN.
 - IN ACCORDANCE WITH SECTION 16.1200 OF THE HOWARD COUNTY CODE FOR FOREST CONSERVATION, THE TOTAL FOREST CONSERVATION OBLIGATION OF 0.30 ACRES (13,068 x 0.75 = \$ 9,801.00) WILL BE FULFILLED BY PAYMENT OF A FEE-IN-LIEU.
 - THIS PLAN HAS BEEN PREPARED IN ACCORDANCE WITH SECTION 16.124 OF THE HOWARD COUNTY CODE AND THE LANDSCAPE MANUAL. A FINANCIAL SURETY FOR THE PERMETER LANDSCAPING IN THE AMOUNT OF \$ 20,490.00 FOR THE PROVIDED 16 SHADE TREES (\$4,800), 56 EVERGREENS (\$8,400), 26 SMALL TREES (\$3,900), 4 SHADE TREES / SPECIMEN TREE REPLACEMENT (\$1,200) AND 73 SHRUBS (\$2,190) SHALL BE POSTED WITH THE DEVELOPERS AGREEMENT FOR THIS PLAN.
 - STORMWATER MANAGEMENT FOR THE PROJECT IS PROVIDED BY THE USE OF ALTERNATIVE SURFACES (POROUS CONCRETE / PERMEABLE SURFACE) AND MICRO-SCALE PRACTICES IN ACCORDANCE WITH ENVIRONMENTAL SITE DESIGN CRITERIA. MICRO-SCALE PRACTICES INCLUDE MICRO-BIORETENTION. THESE FACILITIES WILL BE PRIVATELY OWNED AND MAINTAINED.
 - ALL BUILDINGS TO HAVE ROOF LEADERS WHICH EMPTY AND FLOW AS DIRECTED HEREON.
 - TEST PITS WERE COMPLETED BY ROBERT H. VOGEL ENGINEERING, INC. DATED APRIL 2013.
 - ALL CONCRETE SHALL HAVE AN AUTOMATIC FIRE PROTECTION SPRINKLER SYSTEM INSTALLED.
 - ALL REINFORCED CONCRETE FOR STORM DRAIN STRUCTURES SHALL HAVE A MINIMUM OF 28 DAYS STRENGTH OF 3500 P.S.I.
 - ALL CURB AND GUTTER TO BE HOWARD COUNTY STANDARD DETAIL 3.01, UNLESS OTHERWISE NOTED.
 - ALL ELEVATIONS ARE TO FLOWLINE/BOTTOM OF CURB UNLESS OTHERWISE NOTED.
 - ALL DIMENSIONS ARE TO FACE OF CURB UNLESS OTHERWISE NOTED.
 - CONTRACTOR RESPONSIBLE FOR CONSTRUCTING ALL HANDICAP RAMPS AND HANDICAP ACCESS IN ACCORDANCE WITH CURRENT REQUIREMENTS.
 - ALL EXTERIOR LIGHTING TO COMPLY WITH THE REQUIREMENTS FOUND IN ZONING SECTION 134 OF THE HOWARD COUNTY ZONING REGULATIONS.
 - SIGNAGE SHALL BE PROVIDED ON THE BUILDING IDENTIFYING THE BUILDING ADDRESS, AND EACH SUITE SEPARATED BY LETTER IF APPLICABLE.
 - TRAFFIC CONTROL DEVICES:
 - THE R1-(STOP) SIGN FOR THIS DEVELOPMENT MUST BE INSTALLED BEFORE THE BASE PAVING IS COMPLETE.
 - THE TRAFFIC CONTROL DEVICE LOCATIONS SHOWN ON THE PLANS ARE APPROXIMATE AND MUST BE FIELD APPROVED BY HOWARD COUNTY TRAFFIC DIVISION (410-313-5752) PRIOR TO THE INSTALLATION OF ANY OF THE TRAFFIC CONTROL DEVICES.
 - ALL TRAFFIC CONTROL DEVICES AND THEIR LOCATIONS SHALL BE IN ACCORDANCE WITH THE LATEST EDITION OF THE "MARYLAND MANUAL ON UNIFORM TRAFFIC CONTROL DEVICES" (MUTCD).
 - ALL SIGN POST USED FOR TRAFFIC CONTROL SIGNS INSTALLED IN THE COUNTY RIGHT-OF-WAY SHALL BE MOUNTED ON A 2" GALVANIZED STEEL, PERFORATED QUICK PUNCH, SQUARE TUBE POST (14 GAUGE) INSERTED INTO A 2-1/2" GALVANIZED STEEL, PERFORATED QUICK PUNCH, SQUARE TUBE SLEEVE (12 GAUGE, 3' LONG). A GALVANIZED STEEL CAP SHALL BE MOUNTED ON THE TOP OF EACH POST.
 - ALL SIGN POST USED FOR TRAFFIC CONTROL SIGNS INSTALLED IN THE COUNTY RIGHT-OF-WAY SHALL BE MOUNTED ON A 2" GALVANIZED STEEL.
 - TRASH AND RECYCLING SERVICES SHALL BE PROVIDED FOR THIS SITE BY A PRIVATE SERVICE.
 - THE PROPOSED HOURS OF OPERATION FOR THIS SITE AS APPROVED IN ZB-1098M ARE:
 - WEEKDAYS - MONDAY - FRIDAY 6:00 AM UNTIL 10:00 PM
 - WEEKENDS - SATURDAY - SUNDAY 7:00 AM UNTIL 6:00 PM

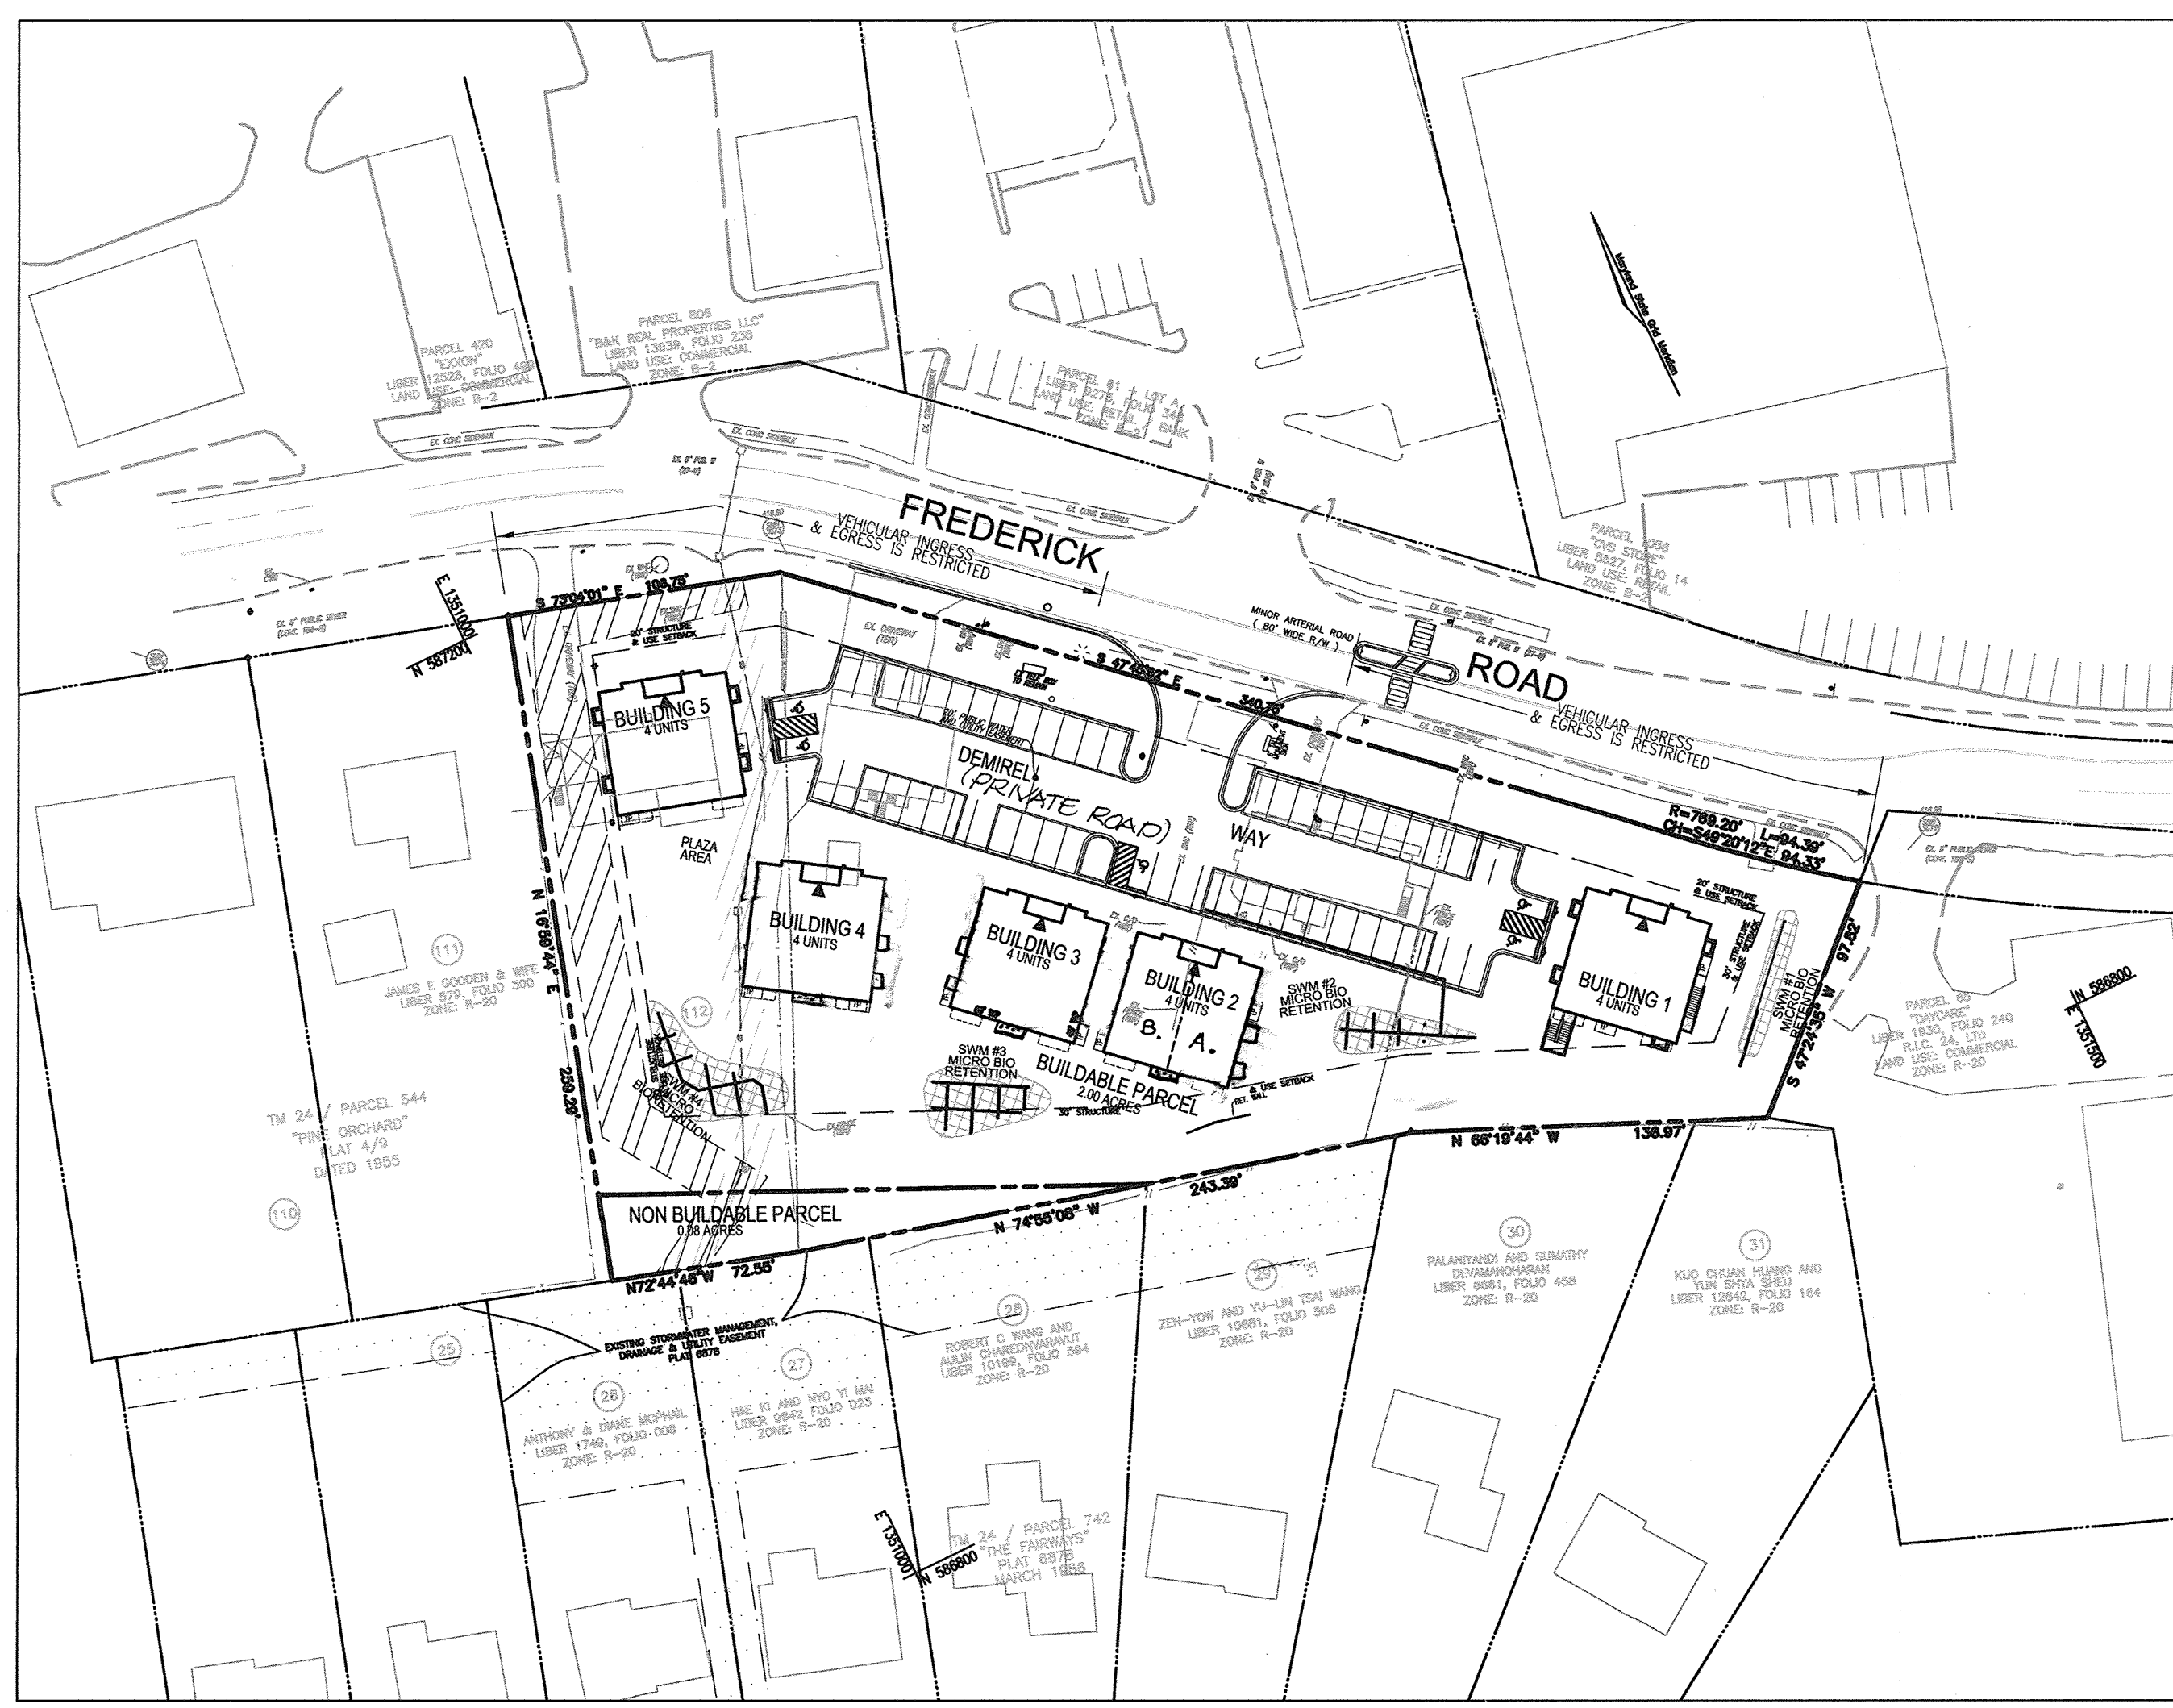

LOCATION MAP

SCALE: 1" = 60'

PARKING TABULATION

1. NUMBER OF PARKING SPACES REQUIRED: 5 PROPOSED BUILDINGS @ 2,460 SF = 12,300 SF
5 BUILDINGS X 2 APARTMENTS = 10 APARTMENTS = 5 BUILDINGS @ 2,460 SF

OFFICE	33	SPACES PER UNIT = 5	=	165
PERSONAL SERVICE	5	SPACES PER UNIT = 5	=	25
APARTMENTS	23	SPACES PER UNIT = 10	=	230
				420

* USE OF SHARED PARKING ALLOWED PER SECTION 133.0.F.1.G OF HOWARD COUNTY ZONING REGULATIONS

2. NUMBER OF PARKING SPACES PROVIDED: 57 SPACES (MINIMUM 57) * SEE SHARED PARKING TABULATION

SHARED PARKING TABULATION*

USE	WEEKDAY				WEEKEND			
	MORNING (6AM-5PM)	MID-DAY (5PM-3PM)	AFTERNOON (3PM-5PM)	EVENING (5PM-10PM)	DAYTIME (6AM-12PM)	EVENING (5PM-10PM)	NIGHTTIME (10PM-2AM)	OVERNIGHT (2AM-6AM)
OFFICE	80%	100%	100%	100%	0%	0%	0%	0%
PERSONAL SERVICE	20%	0%	0%	0%	0%	0%	0%	0%
APARTMENTS	6.2	18.6	10.6	21.9	0.0	31.0	0.0	0.0
RESIDENTIAL	7	19	19	20	0	31	0	0
TOTAL	18.4	38.2	30.2	53.8	0	62	0	0

* NOTE: SECTION 133.0.F.1.a TABULATION MODIFIED PER ALLOWED HOURS OF OPERATION. REFER TO GENERAL NOTE 44.


MAPPED SOILS TYPES

SYMBOL	NAME / DESCRIPTION	GROUP	HYDRIC	PERCENT	K-FACTOR	PERCENT	PERCENT
GhB	GLENELG-URBAN LAND COMPLEX, 0 TO 8 PERCENT SLOPES	B/D	NO	NO	0.20	NO	NO

TAKEN FROM: USCS, SEC-3 WEBSOIL SURVEY, HOWARD COUNTY
NOTE: HIGHLY ERODIBLE SOILS ARE THOSE SOILS WITH A SLOPE GREATER THAN 15 PERCENT OR THOSE SOILS WITH A SOIL INfiltrability FACTOR K GREATER THAN 0.35 AND WITH A SLOPE GREATER THAN 5 PERCENT
K-FACTOR = Kw @ 0-4" DEPTH

SHEET INDEX

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VICINITY MAP
SCALE: 1"=2000'
ADC MAP COORDINATE: 11 97

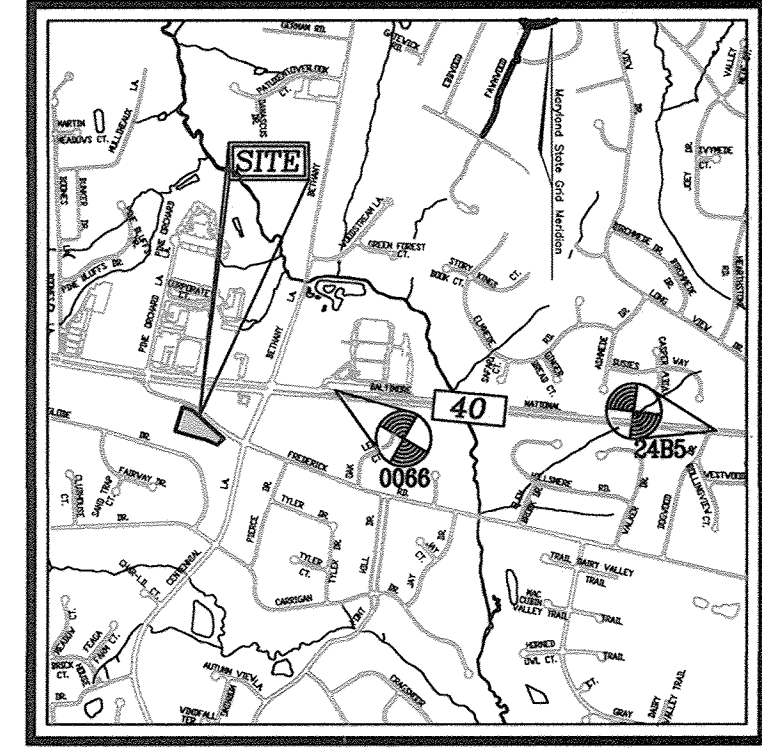BENCHMARKS

HOWARD COUNTY BENCHMARK - 0066
N 587380.5040 E 1352603.4423 ELEV. 386.518
LOCATION: RT 40 BY ENCHANTED FOREST SHOPPING CENTER

HOWARD COUNTY BENCHMARK - 2485
N 586956.2726 E 1356570.7844 ELEV. 390.170
LOCATION: ISLE AT CORNER RT.40 AND DOGWOOD DR.

SITE ANALYSIS DATA CHART

- TOTAL PROJECT AREA: 2.08 AC.
 - AREA OF PLAN SUBMISSION: 2.00 AC.
 - LIMIT OF DISTURBED AREA: SEE SHEET 5
 - PRESENT ZONING DESIGNATION: OT
 - PROPOSED USES FOR SITE AND STRUCTURES: LOW IMPACT OFFICE AND RESIDENTIAL AND PERSONAL SERVICES
 - FLOOR SPACE ON EACH LEVEL: 5,000 SF MAXIMUM GROSS FLOOR AREA
 - EACH BUILDING CONTAINS A COMBINATION OF ONE OFFICE UNIT AND ONE PERSONAL SERVICE UNIT OR TWO OFFICE UNITS OR TWO RESIDENTIAL UNITS ON THE GROUND FLOOR (SEE NOTE 1) AND TWO RESIDENTIAL ON THE SECOND FLOOR.
 - GROSS FLOOR AREA PER BUILDING: 2,460± (1ST) +2,460± (2ND) = 4,920 SF±
 - FLOOR AREA OF RESIDENTIAL UNITS PER BUILDING: 1,198 SF± X 2 UNITS = 2,396 SF±
 - THE RESIDENTIAL UNITS OCCUPY 48.7 % OF THE BUILDING GROSS AREA (50% MAX. ALLOWED)
 - TOTAL NUMBER OF UNITS ALLOWED: 5 BUILDING TOTAL OF 10 RESIDENTIAL UNITS TOTAL OF 10 OFFICE AND/OR PERSONAL SERVICES UNIT REFER TO ZB-1098-M
 - TOTAL NUMBER OF UNITS PROPOSED: 5 BUILDINGS EACH BUILDING CONTAINS ANY COMBINATION OF: ONE OFFICE UNIT AND ONE PERSONAL SERVICES UNIT TWO OFFICE UNITS OR TWO RESIDENTIAL UNITS ON GROUND FLOOR (SEE NOTE) WITH TWO APARTMENTS ON THE SECOND FLOOR TOTAL OF 10 RESIDENTIAL UNITS, TOTAL OF 10 OFFICE AND/OR PERSONAL SERVICES UNIT
 - MAXIMUM # OF EX POSITIVES: N/A REFER TO SHARED PARKING TABULATION, SHOWN HEREON
 - NUMBER OF PARKING SPACES REQUIRED: N/A REFER TO SHARED PARKING TABULATION, SHOWN HEREON
 - NUMBER OF PARKING SPACES PROVIDED: N/A REFER TO SHARED PARKING TABULATION, SHOWN HEREON
 - AREA OF RECREATION OPEN SPACE: N/A
 - BUILDING COVERAGE: 10% - 12,500 SF +/-
 - DPZ FILE REFERENCES: ECP 13-054, ZB 1098 M, WP 14-085, WP 15-099, F14-084
 - ANY OTHER INFORMATION:
 - ERODIBLE SOILS (>0.35): N/A
 - EXISTING IMPERVIOUS AREA: 0.22 AC ± (EXISTING HOMES & DRIVEWAYS)
 - PROPOSED IMPERVIOUS AREA: 0.8 AC (SEE PLAN)
 - PROPOSED GREEN AREA: 1.3 AC
 - AREA OF WETLANDS: 0 SF OR 0.00 AC.
 - AREA OF FLOODPLAIN: 0 SF OR 0.00 AC.
 - AREA OF OPEN SPACE: 0 SF OR 0.00 AC.
 - AREA OF STEEP SLOPES: 0 SF OR 0.00 AC.
 - FLOOR AREA RATIO (FAR): N/A
- NOTE 1: THE ALLOW PERSONAL SERVICE USE FOR THIS PROJECT, PER PROVIDED PARKING, IS LIMITED TO FIVE (5) GROUND FLOOR UNIT SPACES.
- NOTE 2: BUILDING 2 (#3303 B) TO BE DOG GROOMING (PERSONAL SERVICES) SECTION 1173.C.(1)(B)123.

PERMIT INFORMATION CHART

SUBDIVISION NAME	SECTION / AREA	LOT / PARCEL			
DEMIREL PLAZA	-	BUILDINGS 1 - 5			
PLAT REF.	BLOCK NO	ZONE	TAX MAP	ELECT DIST.	CENSUS TR.
23380	1	OT	24	2ND	6023.03

NO.	REVISION	DATE
4	REVISE USE OF BUILDING 2	8/1/18
3	REVISE BUILDING 2, 3 & 4 WINDOW WELL LOCATIONS, AND CONC. PADS	6/15/17
2	REVISE PARKING TABULATION	6/27/16
1	REVISE ADDRESS CHART	2/3/15

SITE DEVELOPMENT PLAN

COVER SHEET

DEMIREL PLAZA

L. 15087 F.313

ZONED: OT
2ND ELECTION DISTRICT
TAX MAP: 24 GRD: 1
PARCELS 62, 63 AND P/O 544 (LOT 112)
HOWARD COUNTY, MARYLAND

ROBERT H. VOGEL ENGINEERING, INC.

ENGINEERS • SURVEYORS • PLANNERS

8407 MAIN STREET
ELlicott CITY, MD 21043
TEL: 410.461.7666
FAX: 410.461.8961



DESIGN BY: EDS.
DRAWN BY: RVE.
CHECKED BY: RHV.
DATE: MAY 2015.
SCALE: AS SHOWN.
W.O. NO.: 11-01.

APPROVED: HOWARD COUNTY DEPARTMENT OF PLANNING AND ZONING

APPROVED: JULY 1, 2014
PLANNING BOARD OF HOWARD COUNTY

APPROVED: FOR PUBLIC WATER AND PUBLIC SEWERAGE SYSTEMS

APPROVED: COUNTY HEALTH OFFICER
HOWARD COUNTY HEALTH DEPARTMENT



APPROVED: JULY 1, 2014
PLANNING BOARD OF HOWARD COUNTY

APPROVED: FOR PUBLIC WATER AND PUBLIC SEWERAGE SYSTEMS

APPROVED: COUNTY HEALTH OFFICER
HOWARD COUNTY HEALTH DEPARTMENT

ATTORNEY
SANG OH
TALKIN & OH, LLP
5100 HURLEY HALL DRIVE
ELlicott CITY, MD 21042
PHONE: (410) 964-0300

OWNER/DEVELOPER
VELI DEMIREL
44087 HIGH POINT ROAD
ELlicott CITY, MD 21042
PHONE: (410) 440-1242

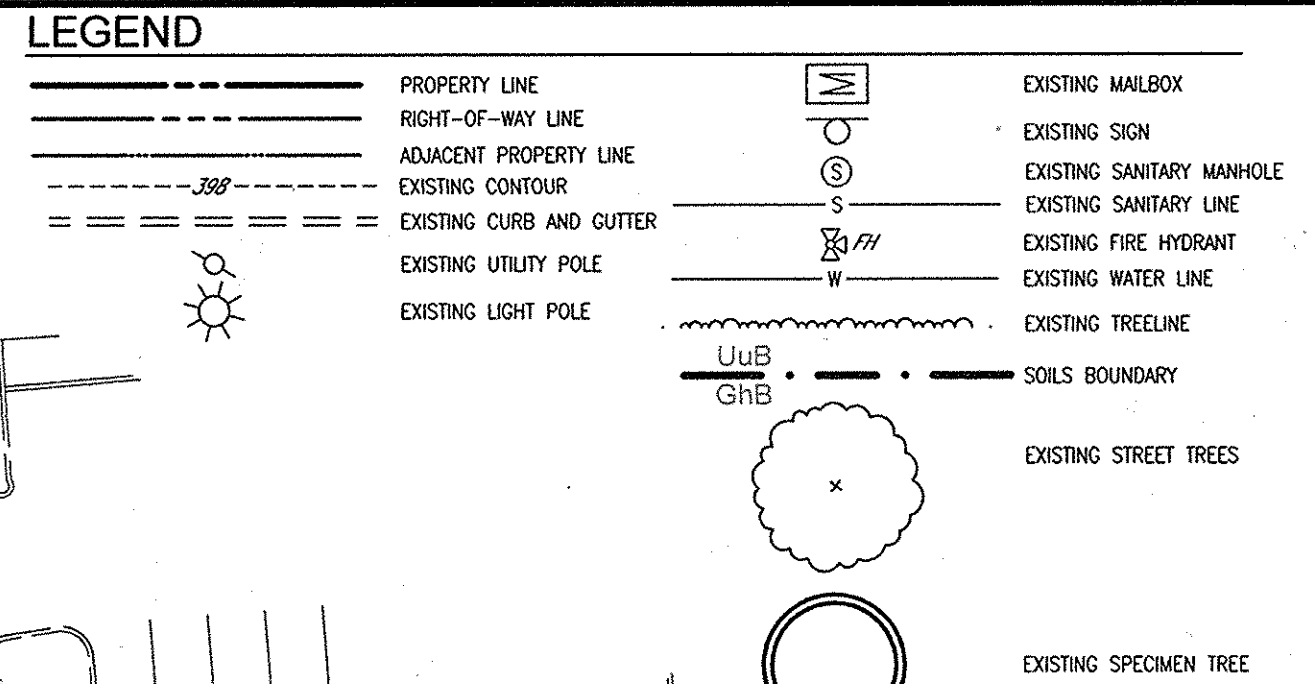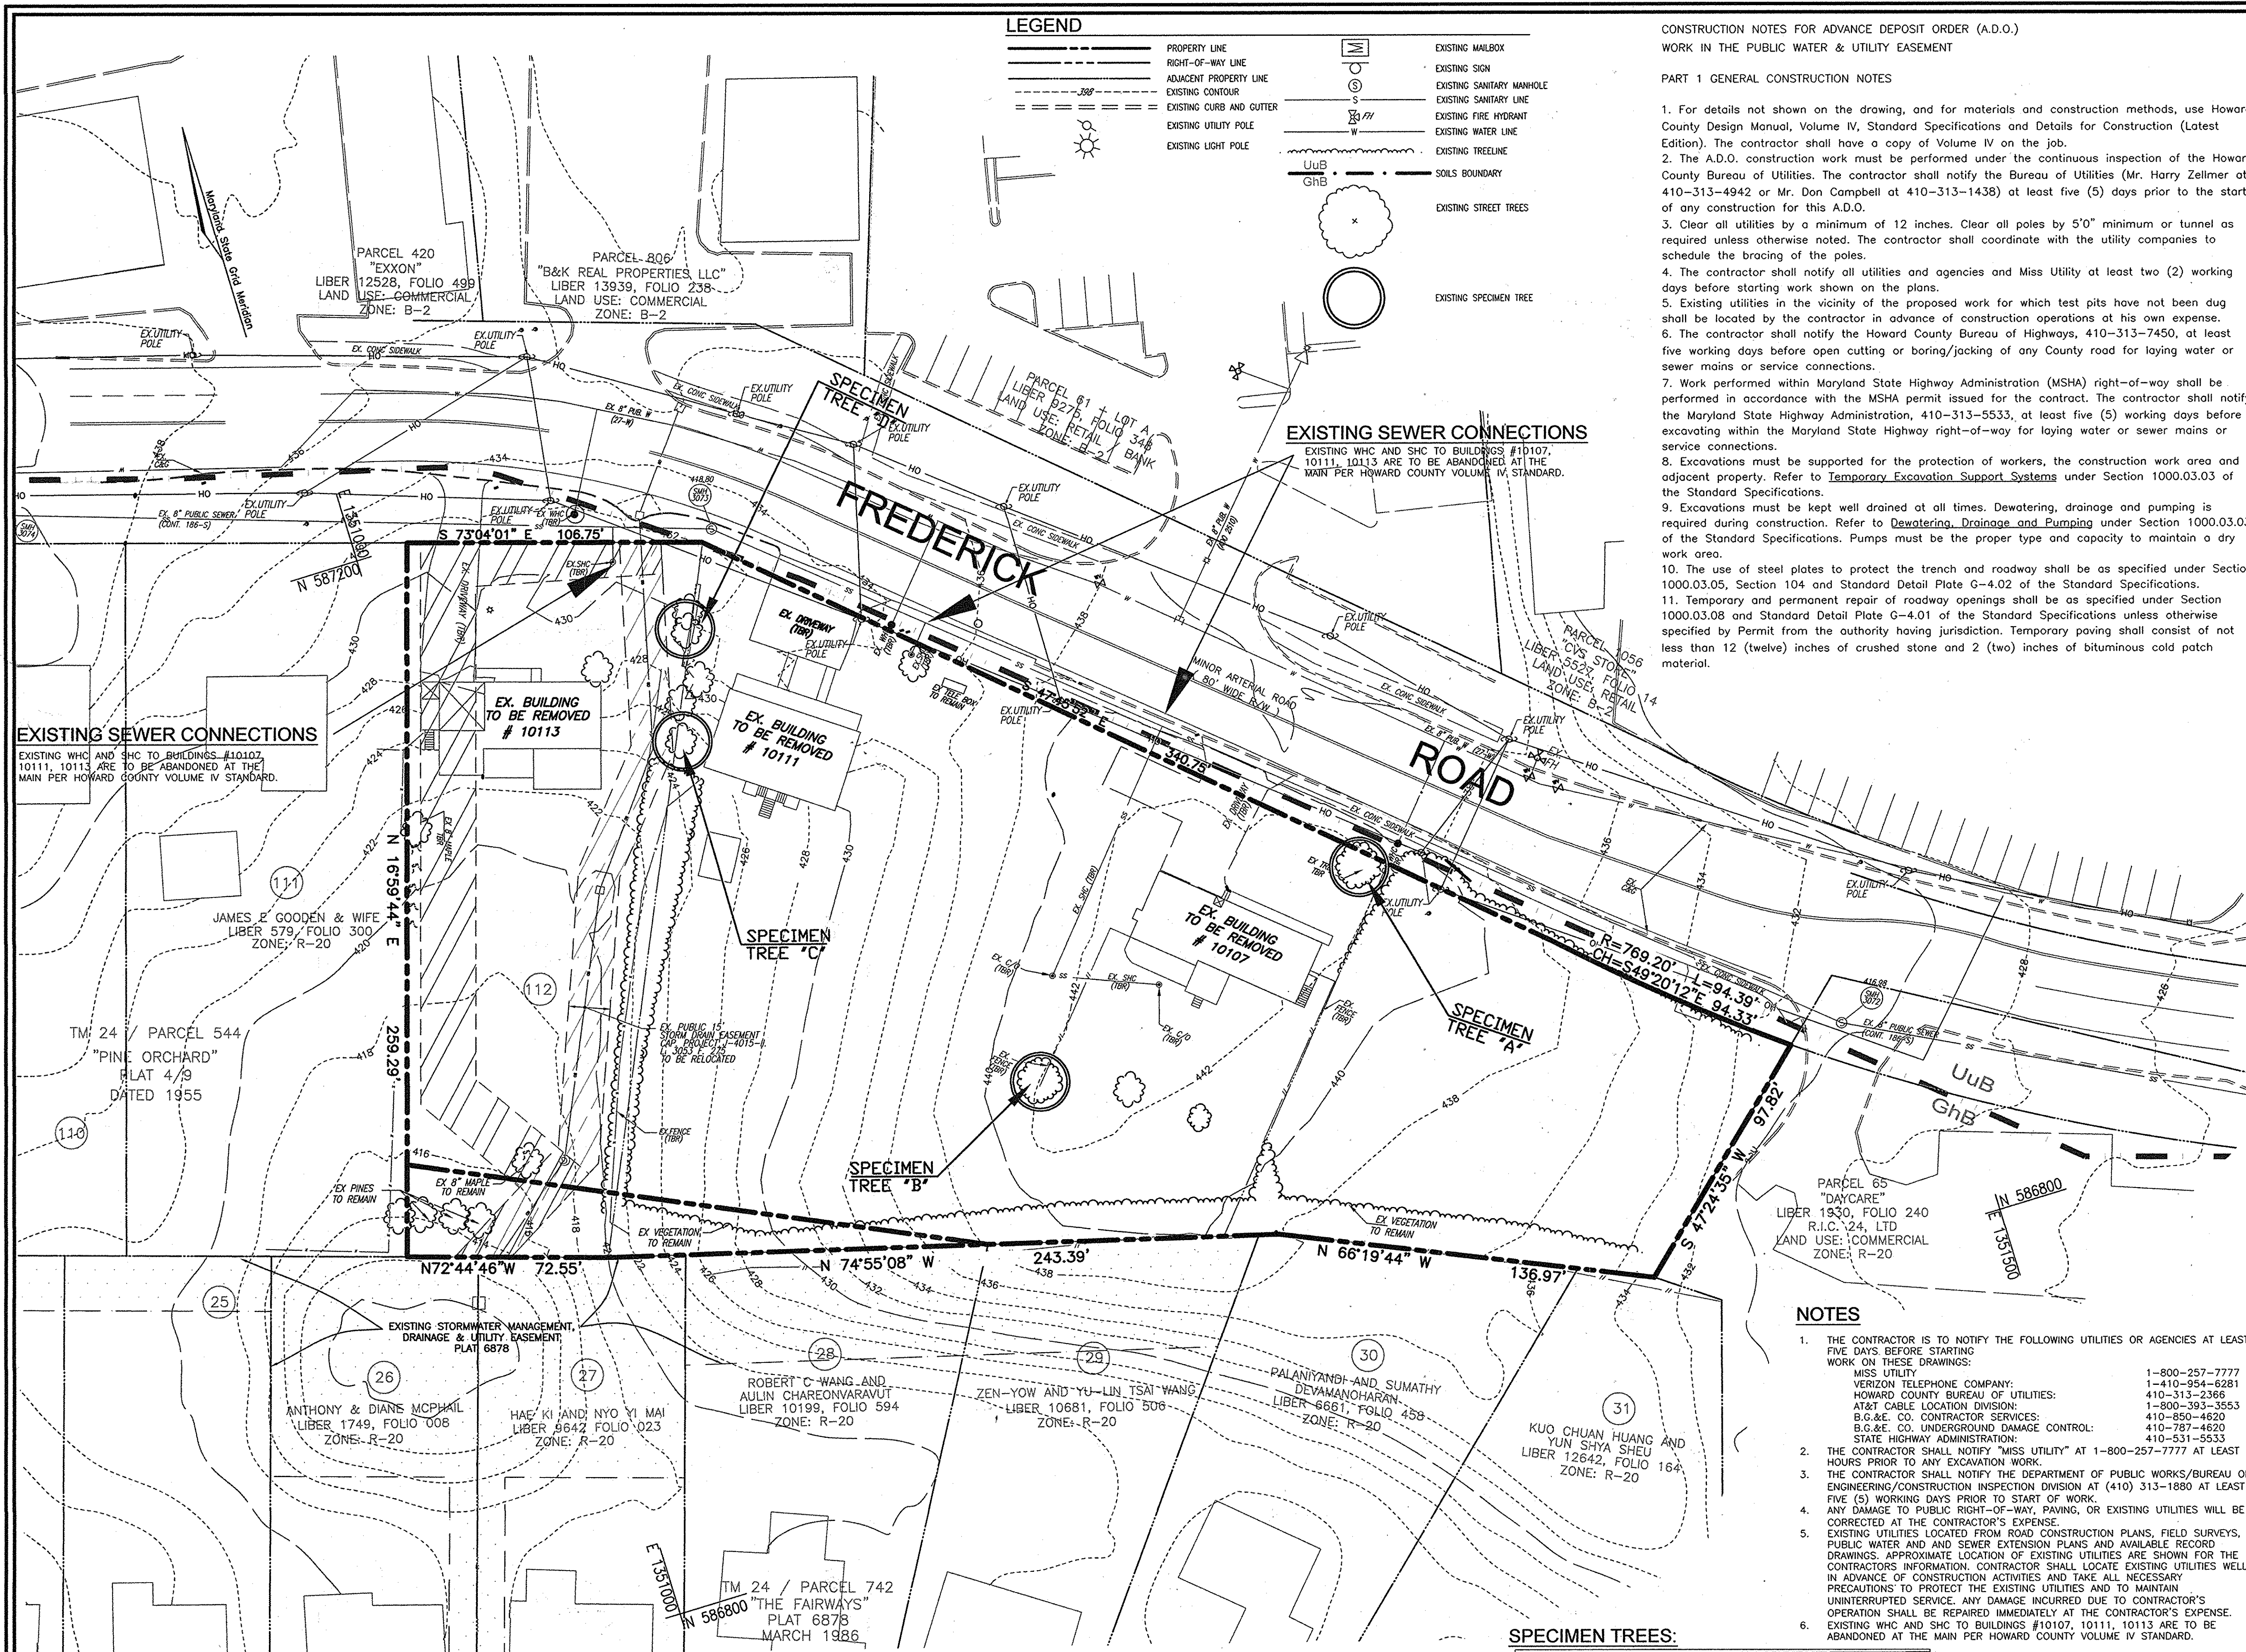

CONSTRUCTION NOTES FOR ADVANCE DEPOSIT ORDER (A.D.O.)
WORK IN THE PUBLIC WATER & UTILITY EASEMENT

PART I GENERAL CONSTRUCTION NOTES

- For details not shown on the drawing, and for materials and construction methods, use Howard County Design Manual, Volume IV, Standard Specifications and Details for Construction (Latest Edition). The contractor shall have a copy of Volume IV on the job.
- The A.D.O. construction work must be performed under the continuous inspection of the Howard County Bureau of Utilities. The contractor shall notify the Bureau of Utilities (Mr. Harry Zellmer at 410-313-4942 or Mr. Don Campbell at 410-313-1438) at least five (5) days prior to the start of any construction for this A.D.O.
- Clear all utilities by a minimum of 12 inches. Clear all poles by 5'0" minimum or tunnel as required unless otherwise noted. The contractor shall coordinate with the utility companies to schedule the bracing of the poles.
- The contractor shall notify all utilities and agencies and Miss Utility at least two (2) working days before starting work shown on the plans.
- Existing utilities in the vicinity of the proposed work for which test pits have not been dug shall be located by the contractor in advance of construction operations at his own expense.
- The contractor shall notify the Howard County Bureau of Highways, 410-313-7450, at least five working days before open cutting or boring/jacking of any County road for laying water or sewer mains or service connections.
- Work performed within Maryland State Highway Administration (MSHA) right-of-way shall be performed in accordance with the MSHA permit issued for the contract. The contractor shall notify the Maryland State Highway Administration, 410-313-5533, at least five (5) working days before excavating within the Maryland State Highway right-of-way for laying water or sewer mains or service connections.
- Excavations must be supported for the protection of workers, the construction work area and adjacent property. Refer to Temporary Excavation Support Systems under Section 1000.03.03 of the Standard Specifications.
- Excavations must be kept well drained at all times. Dewatering, drainage and pumping is required during construction. Refer to Dewatering, Drainage and Pumping under Section 1000.03.03 of the Standard Specifications. Pumps must be the proper type and capacity to maintain a dry work area.
- The use of steel plates to protect the trench and roadway shall be as specified under Section 1000.03.05, Section 104 and Standard Detail Plate G-4.02 of the Standard Specifications.
- Temporary and permanent repair of roadway openings shall be as specified under Section 1000.03.08 and Standard Detail Plate G-4.01 of the Standard Specifications unless otherwise specified by Permit from the authority having jurisdiction. Temporary paving shall consist of not less than 12 (twelve) inches of crushed stone and 2 (two) inches of bituminous cold patch material.

PART II WATER CONSTRUCTION NOTES

- All water mains shall be D.I.P., Class 54 minimum, or AWWA C900/C905 P.V.C. pipe, Class DR18 minimum.
- Tops of all water pipes shall have not less than 4'0" of cover unless otherwise noted.
- Valves adjacent to tees shall be strapped to tees.
- Fire hydrants shall be set to the bury line elevations shown on the Plans. All fire hydrants shall be installed in accordance with Standard Details. The soil around the fire hydrant shall be compacted in accordance with Sections 1000 and 1005 of the Standard Specifications.
- All fittings shall be buttressed or anchored with concrete in accordance with Standard Details unless otherwise provided for on the drawings.
- The contractor shall notify the Bureau of Utilities at least 48 hours in advance of scheduled shutdowns of the existing water main. Shutdowns of the existing water main for new connections and removal of existing service connections shall be as specified under Section 1002.06 - Connections of the Standard Specifications.
- The contractor shall not operate any water main valves on the existing water system.
- Water service connections shall be as specified under Section 1004-Water House Service and Appurtenances of the Standard Specifications and Standard Detail-Plate Service and Appurtenances. The minimum size of a single residential WHC for new residential construction is 1-1/2 inch diameter with 1-inch meter. Installation of the water meter is not part of the A.D.O. construction work. Water service connections include pressure and leak testing, disinfection and bacteriological testing.
- [For commercial meters] The new water meter assembly shall be the (type) per Howard County Detail Plate W-3.24. Installation of the water meter is not part of the A.D.O. construction work.
- If the existing water meter will be moved to the new meter connection inside the building, the contractor shall contact the Meter Division of the Bureau of Utilities at 410-313-4948 to schedule relocation of the meter setting.
- The abandonment of existing water service connections shall be as specified under Section 1015.03 of the Standard Specifications. Removal of the existing corporation stop or tapping saddle requires a scheduled shutdown of the water main. The existing corporation stop shall be removed from the water main and the pipe repaired with a County approved stainless steel full circle repair clamp such as Ford Meter FS2, Mueller 550 or Romac SS2 series.
- Tracer wire and continuity test stations shall be installed on all water mains in accordance with Detail Plate G-8.21 of the Standard Specifications.
- Proper Assembly of Gasketed PVC Pipe Joints. The manufacturer's insertion line of gasketed PVC pipe joints indicates the maximum depth of insertion of the spigot into the bell. After assembly of the joint, the line shall remain visible. Dual insertion lines on gasketed PVC pipe indicate the maximum and minimum depth of insertion of the spigot into the bell.
- Tees, crosses, bends greater than 5 degrees, and similar fittings for use with C-900 PVC water pipe shall be ductile iron conforming to AWWA C153.
- All changes in horizontal or vertical direction of PVC water pipe shall be made with high-deflection couplings, 5 degree sweeps or standard bends. No bending of pipe or deflection of PVC pipe joints is permitted.
- Seventeen (17) pound sacrificial anodes shall be installed on all valves and metallic fittings used with PVC water mains in accordance with the Standard Specifications and Details. Magnesium anodes shall be installed on all iron valves and ductile iron fittings including restraints and harnesses. Zinc anodes shall be installed on all stainless steel fittings and saddles used with PVC water mains.

PART III SEWER CONSTRUCTION NOTES

- All sewer mains shall be D.I.P. or P.V.C. unless otherwise noted.
- All manholes shall be 4'0" inside diameter unless otherwise noted.
- Sewer force mains shall be D.I.P. unless otherwise noted.
- Sewer house connections shall be as specified under Section 1009.03 of the Standard Specifications and the Standard Details.
- House(s) with the symbol "C.N.S." indicates that the cellar cannot be served by a gravity sewer service connection.

NOTES

- THE CONTRACTOR IS TO NOTIFY THE FOLLOWING UTILITIES OR AGENCIES AT LEAST FIVE DAYS BEFORE STARTING WORK ON THESE DRAWINGS:
MISS UTILITY: 1-800-257-7777
HOWARD COUNTY BUREAU OF UTILITIES: 410-313-2366
AT&T CABLE LOCATION DIVISION: 1-800-393-3553
B.G.&E. CO. CONTRACTOR SERVICES: 410-850-4620
B.G.&E. CO. UNDERGROUND DAMAGE CONTROL: 410-787-4620
STATE HIGHWAY ADMINISTRATION: 410-521-5533
- THE CONTRACTOR SHALL NOTIFY "MISS UTILITY" AT 1-800-257-7777 AT LEAST 48 HOURS PRIOR TO ANY EXCAVATION WORK.
- THE CONTRACTOR SHALL NOTIFY THE DEPARTMENT OF PUBLIC WORKS/BUREAU OF ENGINEERING/CONSTRUCTION INSPECTION DIVISION AT (410) 313-1880 AT LEAST FIVE (5) WORKING DAYS PRIOR TO START OF WORK.
- ANY DAMAGE TO PUBLIC RIGHT-OF-WAY, PAVING, OR EXISTING UTILITIES WILL BE CORRECTED AT THE CONTRACTOR'S EXPENSE.
- EXISTING UTILITIES LOCATED FROM ROAD CONSTRUCTION PLANS, FIELD SURVEYS, PUBLIC WATER AND SEWER EXTENSION PLANS AND AVAILABLE RECORD DRAWINGS. APPROXIMATE LOCATION OF EXISTING UTILITIES ARE SHOWN FOR THE CONTRACTOR'S INFORMATION. CONTRACTOR SHALL LOCATE EXISTING UTILITIES WELL IN ADVANCE OF CONSTRUCTION ACTIVITIES AND TAKE ALL NECESSARY PRECAUTIONS TO PROTECT THE EXISTING UTILITIES AND TO MAINTAIN UNINTERRUPTED SERVICE. ANY DAMAGE INCURRED DUE TO CONTRACTOR'S OPERATION SHALL BE REPAIRED IMMEDIATELY AT THE CONTRACTOR'S EXPENSE.
- EXISTING WHC AND SHC TO BUILDINGS #10107, 10111, 10113 ARE TO BE ABANDONED AT THE MAIN PER HOWARD COUNTY VOLUME IV STANDARD.

SPECIMEN TREES:

Key	Species, Size (dbh)	Condition	Critical Root Zone (radius)
A	Ginkgo, 42"	Good, non-native	63'
B	Silver maple, 38"	Good	57'
C	Black locust, 42"	Fair, poor shape, leaning over house	65'
D	Silver maple, 31"	Fair, some dieback notes, power lines run through canopy, leaning	46.5'

NOTES:

- PER THE PLAN PROPOSAL SHOWN HEREON, ALL SPECIMEN TREES ARE TO BE REMOVED. REFER TO GENERAL NOTE 27, SHEET 1 REGARDING WP 14-085

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TALKIN & LLP
1100 DORSEY HALL DRIVE
ELICOTT CITY, MD. 21042
PHONE: (410) 964-0300

OWNER/DEVELOPER

VELI DEMIREL
44087 HIGH POINT ROAD
ELICOTT CITY, MD 21042
PHONE: (410) 440-1242

APPROVED: HOWARD COUNTY DEPARTMENT OF PLANNING AND ZONING
6.8.15
DATE
16.07.15
DATE
7-7-15
DATE

APPROVED JULY 17, 2014
PLANNING BOARD OF HOWARD COUNTY

EXISTING CONDITIONS / DEMO PLAN
SCALE: 1"=30'

MAPPED SOILS TYPES - ELLICOTT CITY SW MAP #13

SYMBOL NAME / DESCRIPTION	GROUP	HYDRO	PERCENT SAND	K-FACTOR	PERCENT CLAY	PERCENT SILT
GhB CLENELG-URBAN LAND COMPLEX, 0 TO 8 PERCENT SLOPES	B/D	NO	NO	0.20	NO	NO

TAKEN FROM: USDA, SCS-WEB SOIL SURVEY, HOWARD COUNTY
K-FACTOR = $K_w \times (0.4 - \text{DEPTH})$

NOTE:
HONEY ENDOBLE SOILS ARE THOSE SOILS WITH A SLOPE GREATER THAN 15 PERCENT OR THOSE SOILS WITH A SOIL ERODIBILITY FACTOR K GREATER THAN 0.35 AND WITH A SLOPE GREATER THAN 5 PERCENT

Eco-Science Professionals, Inc.
Consulting Ecologists
P.O. Box 5006 Glen Arve, Maryland 21027
Telephone: (410) 875-2408 Fax: (410) 875-2405

NO.	REVISION	DATE

SITE DEVELOPMENT PLAN
EXISTING CONDITIONS / DEMO PLAN
DEMIREL PLAZA
L15837 F345

2ND ELECTION DISTRICT
TAX MAP: 24 GRID: 1

PARCELS 62, 63 AND P/O 544 (LOT 112)
HOWARD COUNTY, MARYLAND

ROBERT H. VOGEL ENGINEERING, INC.
ENGINEERS • SURVEYORS • PLANNERS
8407 MAIN STREET
ELICOTT CITY, MD 21043
TEL: 410.461.7666
FAX: 410.461.8961


DESIGN BY: EDS.
DRAWN BY: RVE
CHECKED BY: RHY
DATE: MAY 2015
SCALE: AS SHOWN
W.O. NO.: 11-01

PROFESSIONAL CERTIFICATE
I HEREBY CERTIFY THAT THESE DOCUMENTS WERE PREPARED OR APPROVED BY ME, AND THAT I AM A DULY LICENSED PROFESSIONAL ENGINEER UNDER THE LAWS OF THE STATE OF MARYLAND, LICENSE NO. 16193, EXPIRATION DATE: 09-27-2016

ROBERT H. VOGEL, PE No.16193

2 SHEET OF 15

STREET LIGHT LOCATION CHART		
STREET NAME	LOCATION	FIXTURE/POLE TYPE
FREDERICK ROAD	N 587094 E 1351213	450-WATT-HPS-VAPOR-PREMIER POST-TOP-FIXTURE MOUNTED ON 14" BLACK FIBERGLASS POLE
FREDERICK ROAD	NORTHWEST OF PEDESTRIAN CROSSING	250 WATT HPS VAPOR FIXTURE MOUNTED ON EXISTING BGE POLE DETAILED HEREON

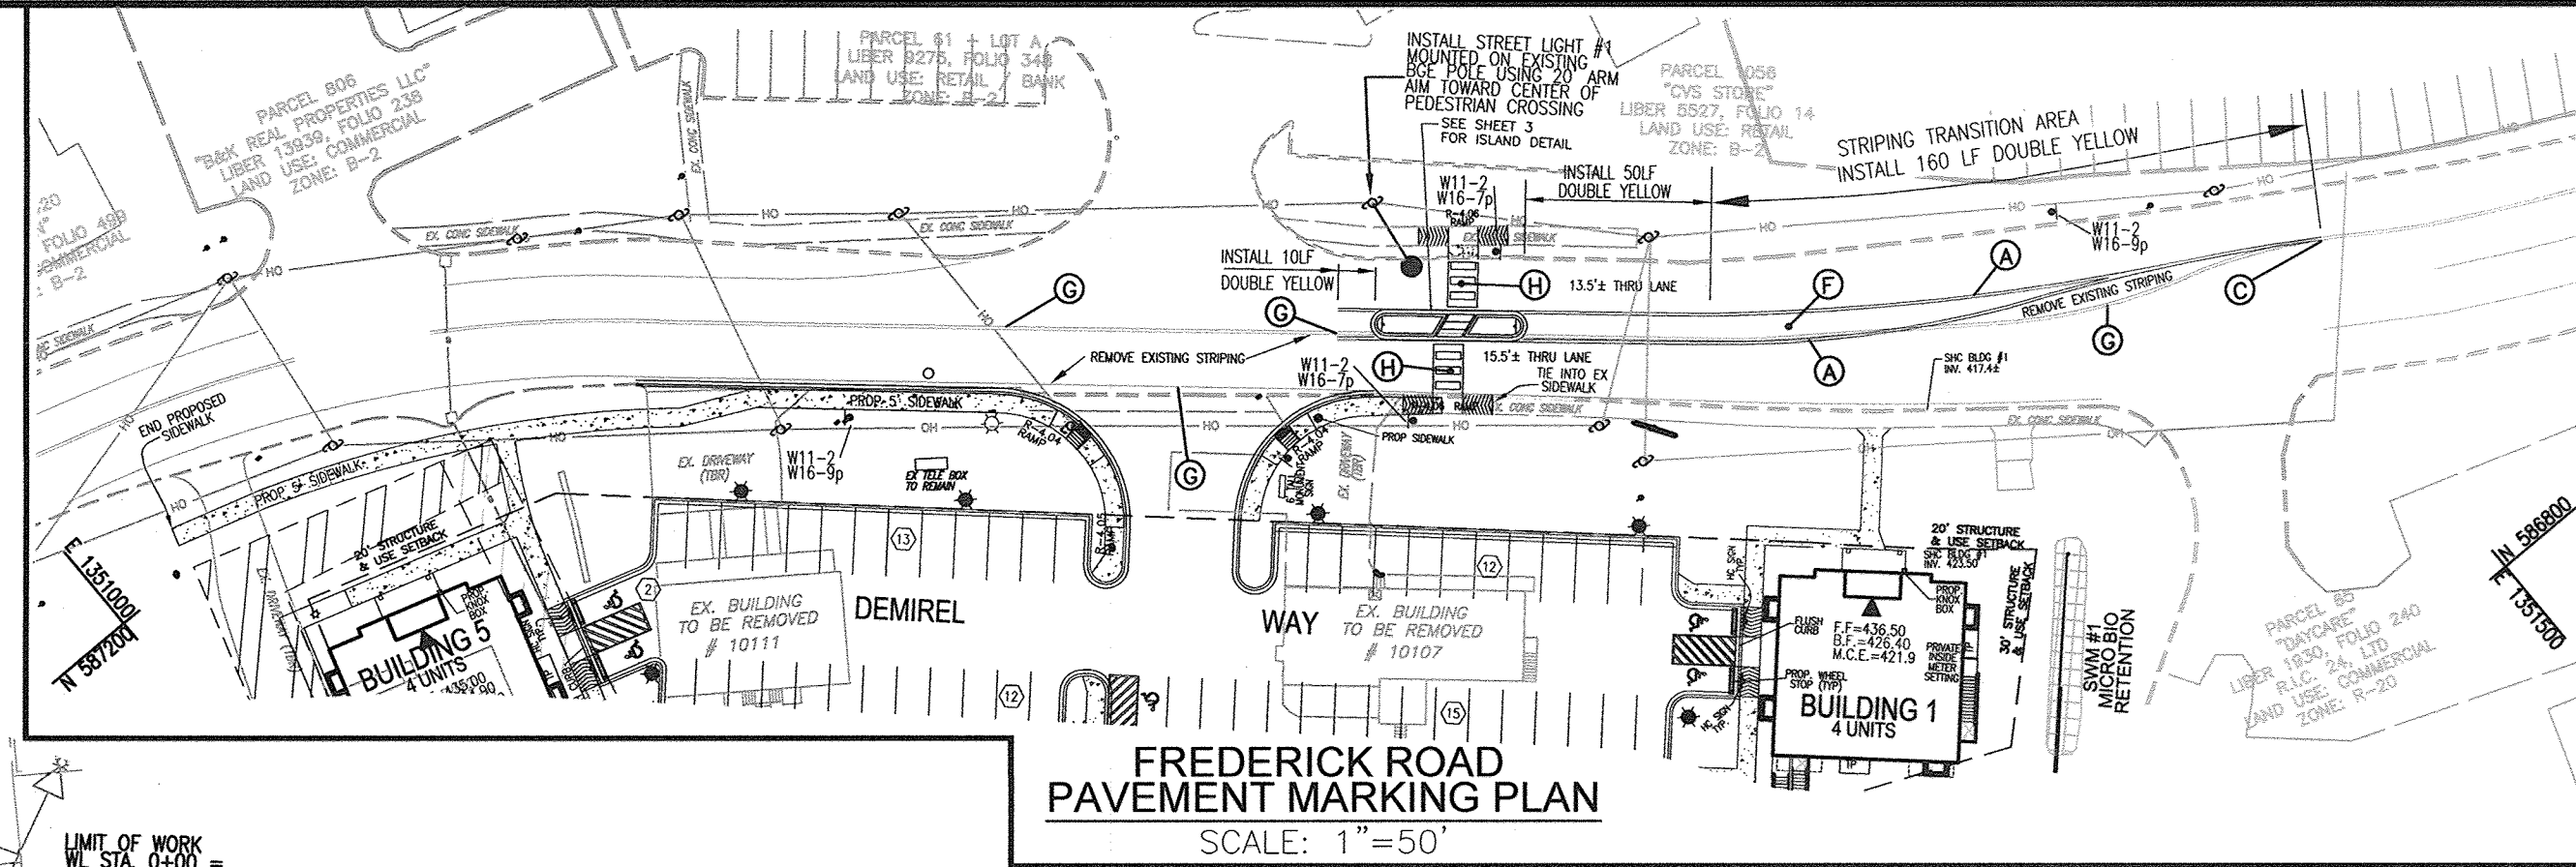


LEGEND	
	PROPERTY LINE
	RIGHT-OF-WAY LINE
	ADJACENT PROPERTY LINE
	EXISTING CURB AND GUTTER
	PROPOSED CURB AND GUTTER
	EXISTING UTILITY POLE
	EXISTING LIGHT POLE
	EXISTING MAILBOX
	EXISTING SIGN
	EXISTING SANITARY MANHOLE
	EXISTING SANITARY LINE
	EXISTING FIRE HYDRANT
	EXISTING WATER LINE
	PROPOSED STORM DRAIN
	PROPOSED STORM DRAIN INLETS
	EXISTING TREE LINE
	MICRO-BIORETENTION FACILITY
	PERMEABLE SURFACE PARKING PAD
	PROPOSED SIDEWALK
	TRASH PAD (4' x 8')
	PROPOSED STREET LIGHT

PAVEMENT MARKING LEGEND	
	A) 5" YELLOW PAINT LINE
	B) 5" WHITE PAINT LINE
	C) TIE TO EXISTING MARKINGS
	D) 10" WIDE YELLOW HATCH MARKINGS - PAINT AS DIRECTED BY HOWARD COUNTY TRAFFIC
	E) REMOVE EXISTING PAVEMENT MARKINGS BY GRINDING. EXTENT OF REMOVAL AS DIRECTED BY HOWARD COUNTY TRAFFIC
	F) HOWARD COUNTY CROSSWALK

LEGEND: NUMBER RELATES TO STREET SIGN LOCATION SCHEDULE	
	PROPOSED STREET SIGN

STREET SIGN LOCATION SCHEDULE			
NO.	STREET NAME	STATION / OFFSET	SIGN TYPE / DESCRIPTION
1	FREDERICK ROAD	N 586951 E 1351467	PEDESTRIAN (W11-2) W/ "AHEAD PLAQUE (W16-9p)
2	FREDERICK ROAD	N 587039 E 1351346	DBL SIDED FYG PEDESTRIAN (W11-2) W/ (W16-7p)
3	FREDERICK ROAD	SEE MEDIAN ISLAND DETAIL	R4-7 W/ OM1-3
4	FREDERICK ROAD	SEE MEDIAN ISLAND DETAIL	R4-7 W/ OM1-3
5	FREDERICK ROAD	N 587018 E 1351300	DBL SIDED FYG PEDESTRIAN (W11-2) W/ (W16-7p)
6	DEMIREL WAY	N 587033 E 1351288	R1-1 STOP SIGN
7	FREDERICK ROAD	N 587117 E 1351185	PEDESTRIAN (W11-2) W/ "AHEAD PLAQUE (W16-9p)

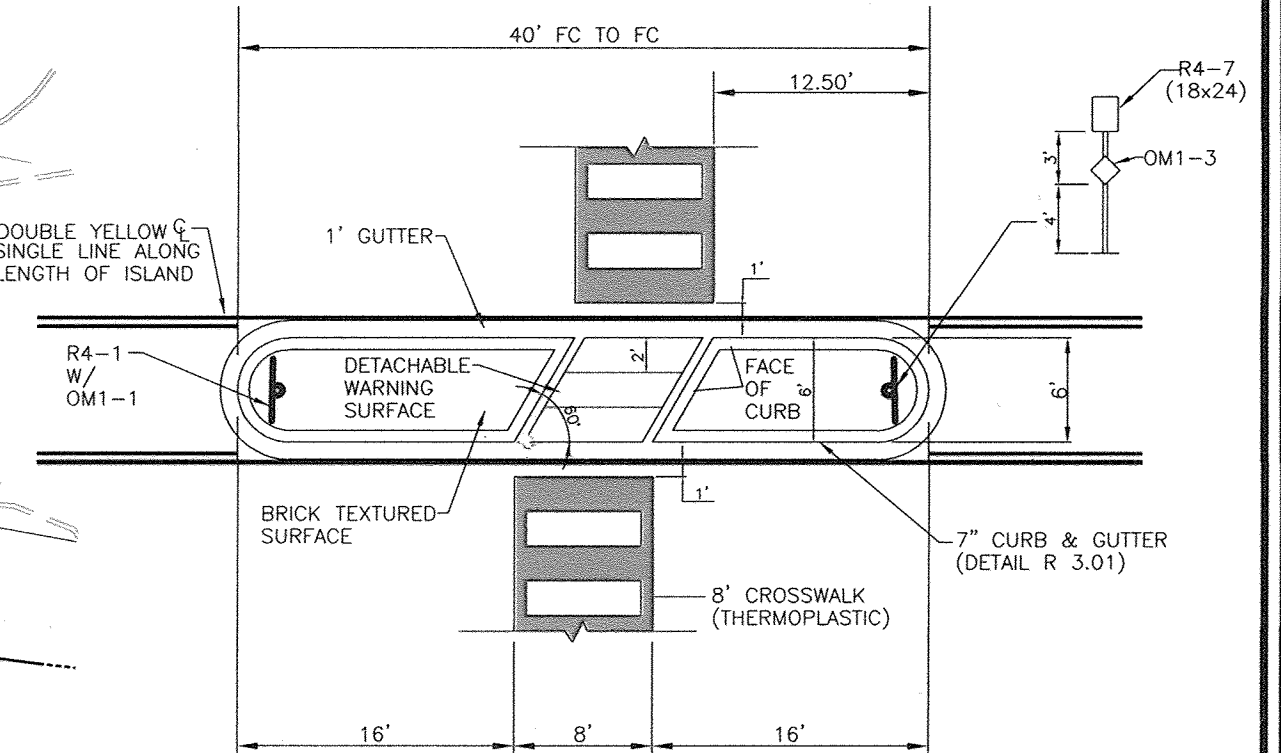

NO.	REVISION	DATE
4	REVISE USE OF BUILDING 2	8/1/18
3	REVISE BUILDING 2, 3 & 4 WINDOW/ WELL LOCATIONS, ADD CONC. PADS	6/15/17
2	UPDATE SHARED PARKING	4/27/16
1	REVISE STORM DRAIN AND SHO TO BUILDING 1	12-9-15

SITE DEVELOPMENT PLAN
LAYOUT & PAVEMENT MARKING PLAN
DEMIREL PLAZA
L.15837.P.345

2ND ELECTION DISTRICT
TAX MAP: 24 GRID: 1

PARCELS 62, 63 AND P/O 544 (LOT 112)
HOWARD COUNTY, MARYLAND

ROBERT H. VOGEL
ENGINEERS • SURVEYORS • PLANNERS

8407 MAIN STREET
ELLICOTT CITY, MD 21043

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DESIGN BY: EDS.
DRAWN BY: RVE.
CHECKED BY: RHV.
DATE: MAY 2015.
SCALE: AS SHOWN.
W.O. NO.: 11-01


3 SHEET OF 15

APPROVED JULY 17, 2014
PLANNING BOARD OF HOWARD COUNTY

APPROVED: HOWARD COUNTY DEPARTMENT OF PLANNING AND ZONING


Chief, Development Engineering Division: *[Signature]* DATE: 6-8-15
 Chief, Division of Land Development: *[Signature]* DATE: 7-07-15
 Director: *[Signature]* DATE: 7-7-15







- NOTES:**
- WATER AND SEWER FOR THIS PROJECT WILL BE PROVIDED THROUGH A PUBLIC EXTENSION OF WATER CONTRACT 27-W AND PUBLIC / PRIVATE EXTENSION OF SEWER CONTRACT 186-S. UTILITY EXTENSIONS SHALL BE COMPLETED UNDER THE HOWARD COUNTY ADD PROCESS UNDER THE PROVISIONS OF SECTION 18.122.B OF THE HOWARD COUNTY CODE. ALL CONSTRUCTION SHALL BE IN CONFORMANCE WITH ALL HOWARD COUNTY VOLUME II AND IV DETAILS.
 - REFER TO DETAILS HEREON.
 - A KNOX BOX (FIRE DEPARTMENT ACCESS BOX) IS REQUIRED TO BE PLACED ON THE FRONT OF THE BUILDINGS. IT SHALL BE PLACED TO THE LEFT OF THE MAIN ENTRANCE AT A RANGE OF 4-5 FT IN HEIGHT AND NO MORE THAN 6 FT LATERALLY FROM THE DOOR. THE BOX SHALL BE ELECTRONICALLY SUPERVISED TO NOTIFY THE OWNER THAT IS BEING ACCESSED (INTEGRATED WITH THE FIRE ALARM SYSTEM), NFPA-1 10.12.1.
 - THE PROPOSED BUILDINGS WILL BE REQUIRED TO HAVE A SPRINKLER SYSTEM INSTALLED.
 - ALL WATER CONNECTIONS SHALL BE 4" REFERENCE STANDARD DETAIL W-3.24.
 - BUILDINGS SHALL UTILIZE INSIDE COMBINED FIRE / DOMESTIC (1-1/2") WATER METER SETTINGS. THERE ARE FOUR (4) UNITS PER BUILDING: TWO (2) RESIDENTIAL AND TWO (2) COMMERCIAL USES.
 - REFER TO "CONSTRUCTION NOTES FOR ADVANCE DEPOSIT ORDER (A.D.O.) WORK IN THE PUBLIC WATER & UTILITY EASEMENT

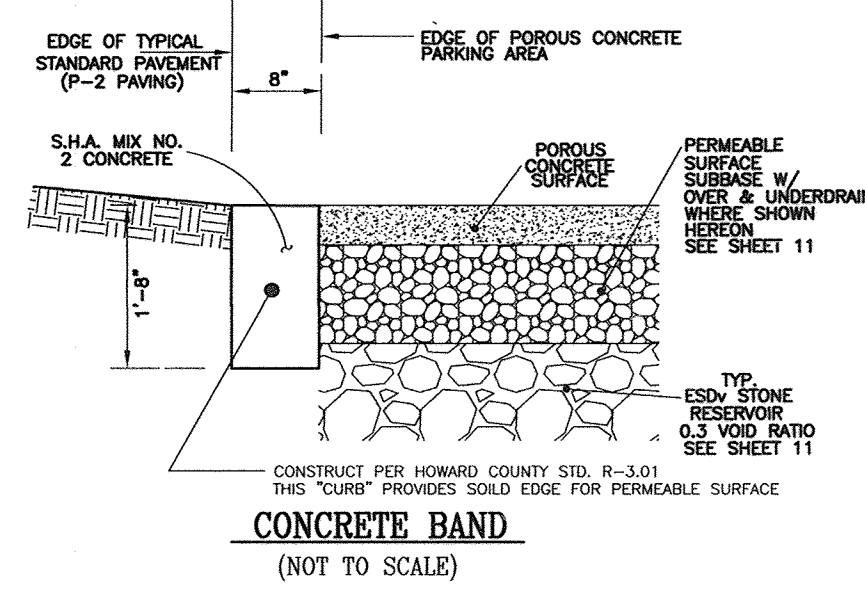

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TALKIN & OH, LLP
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PHONE: (410) 964-0300

OWNER/DEVELOPER
VELI DEMIREL
44087 HIGH POINT ROAD
ELLICOTT CITY, MD. 21042
PHONE: (410) 440-1242

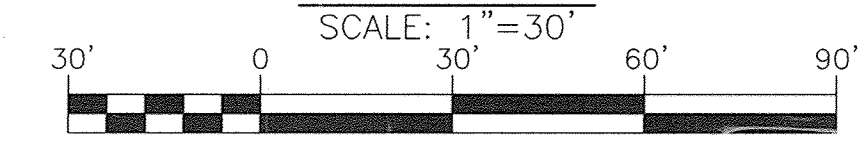

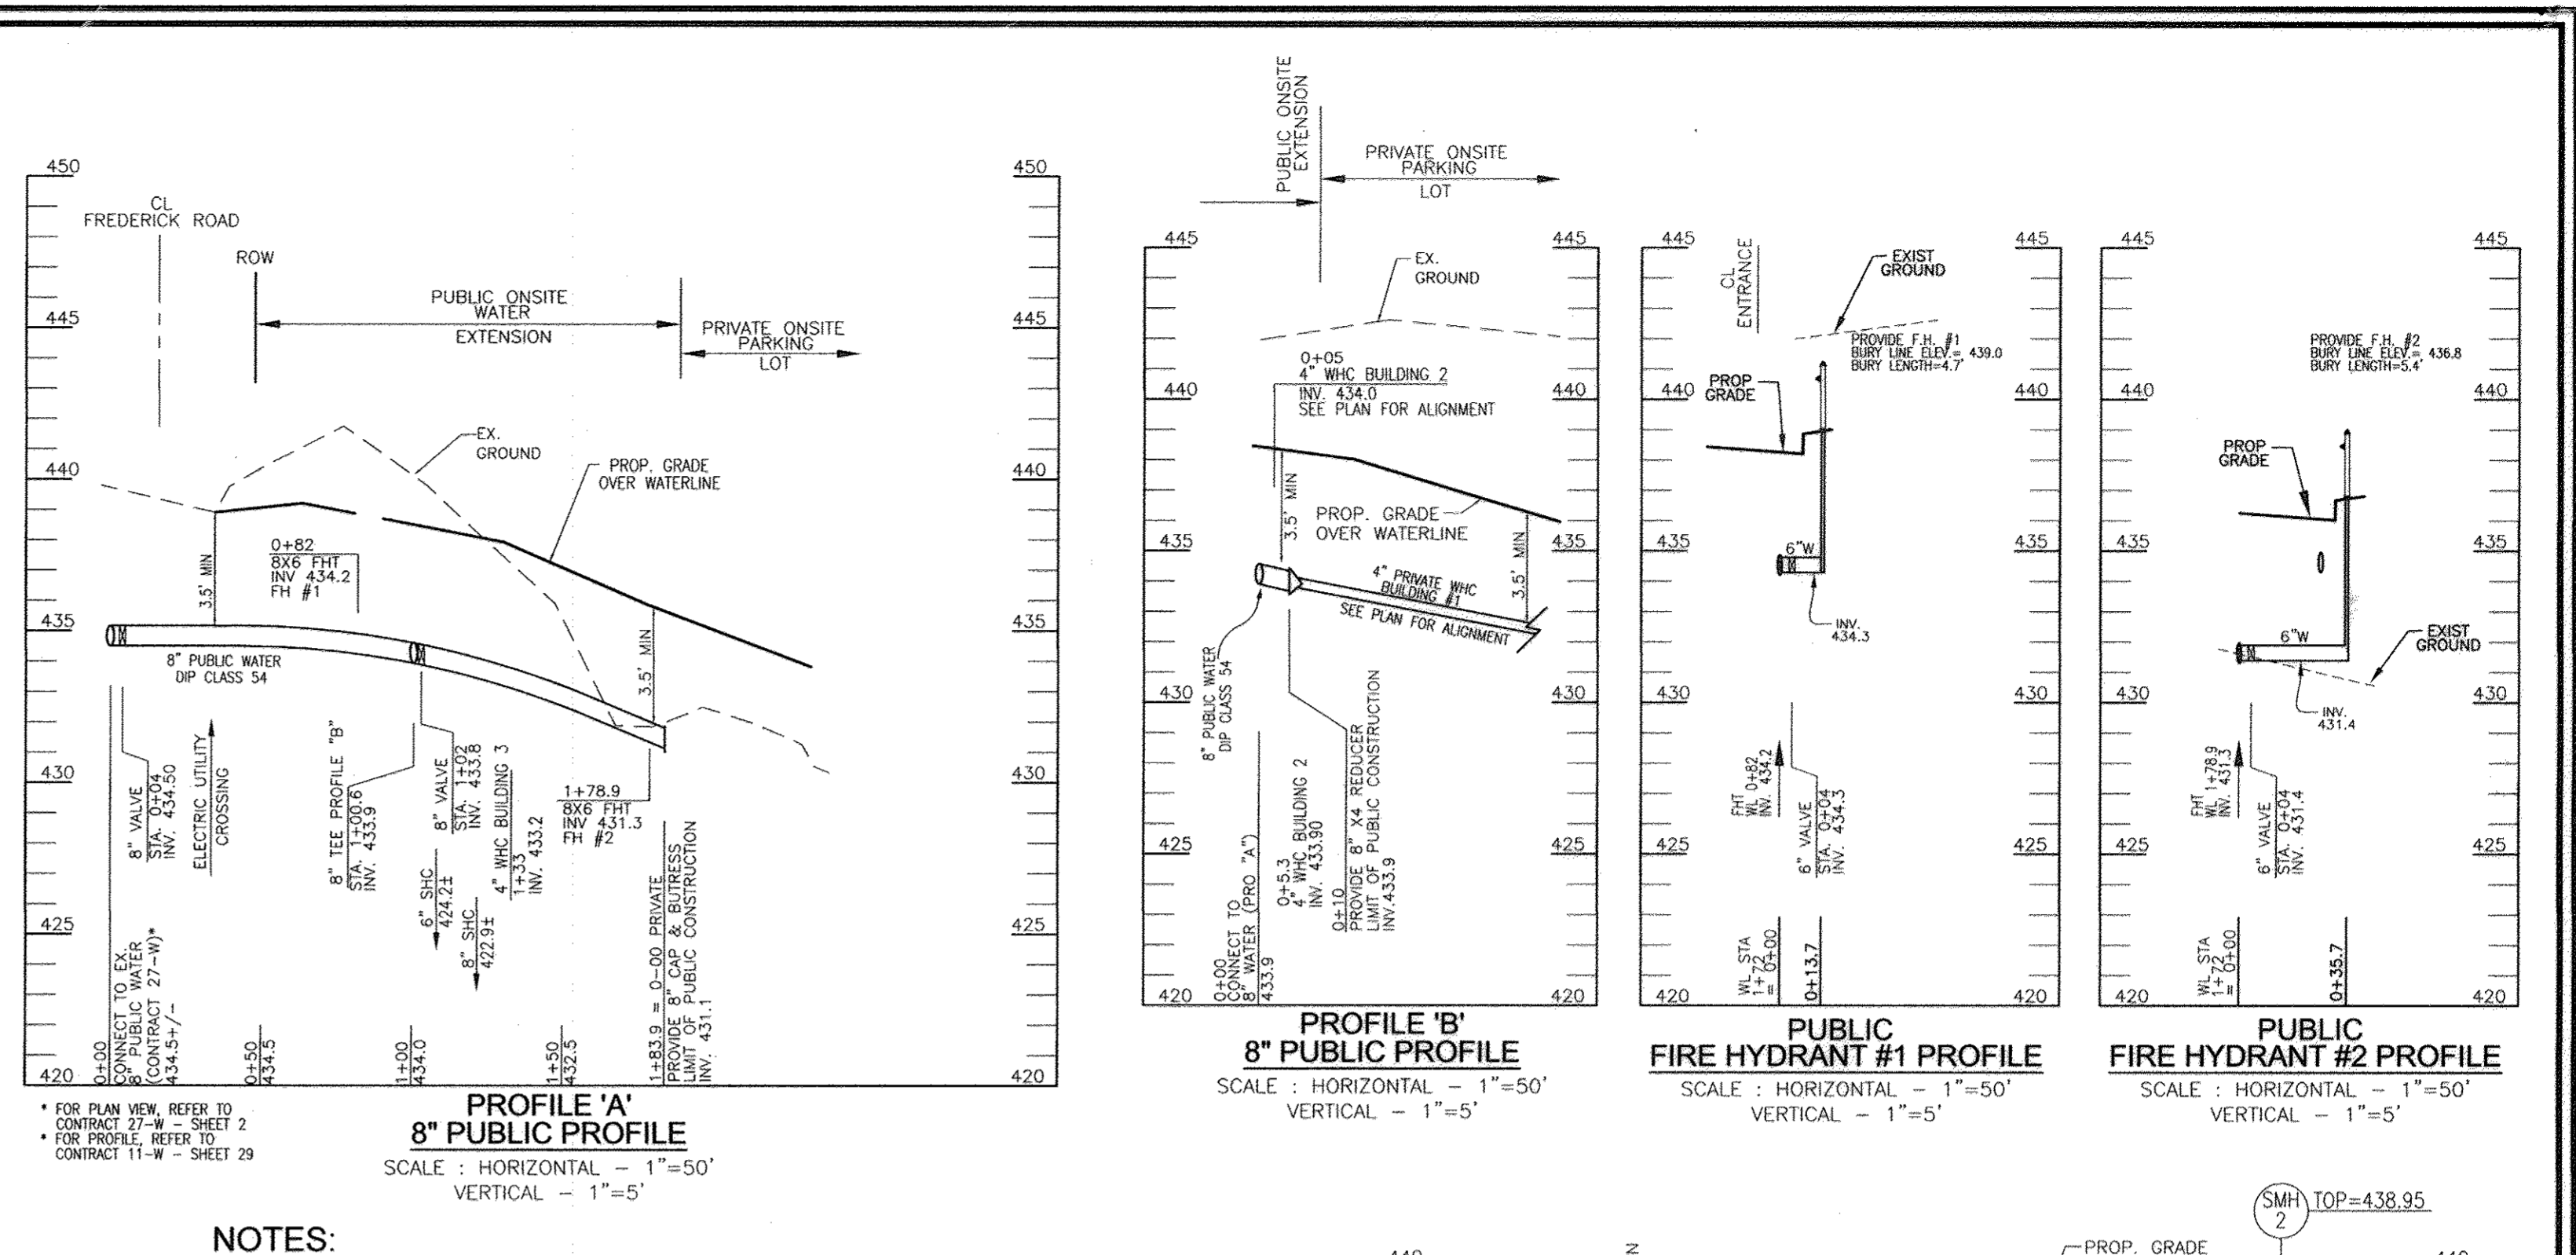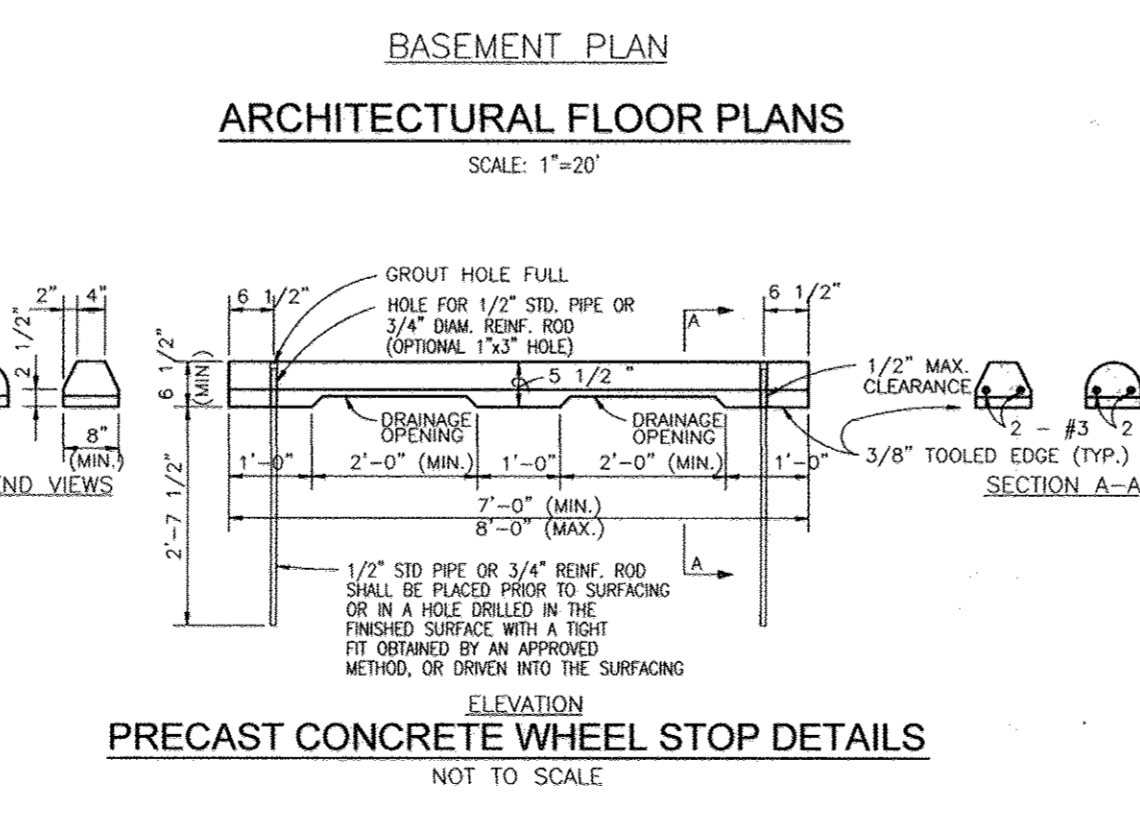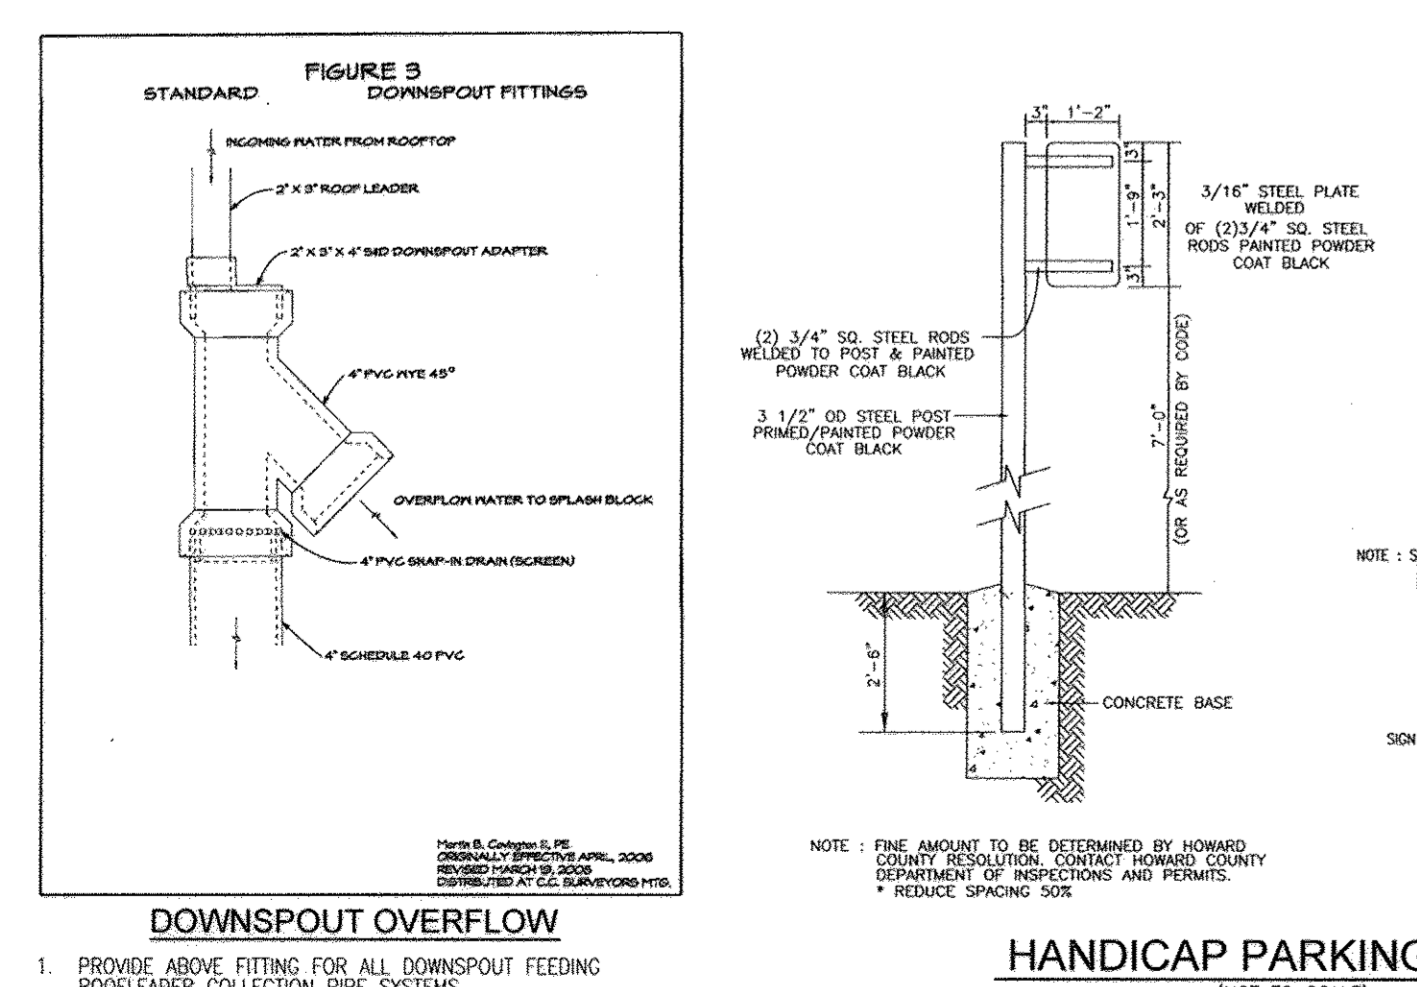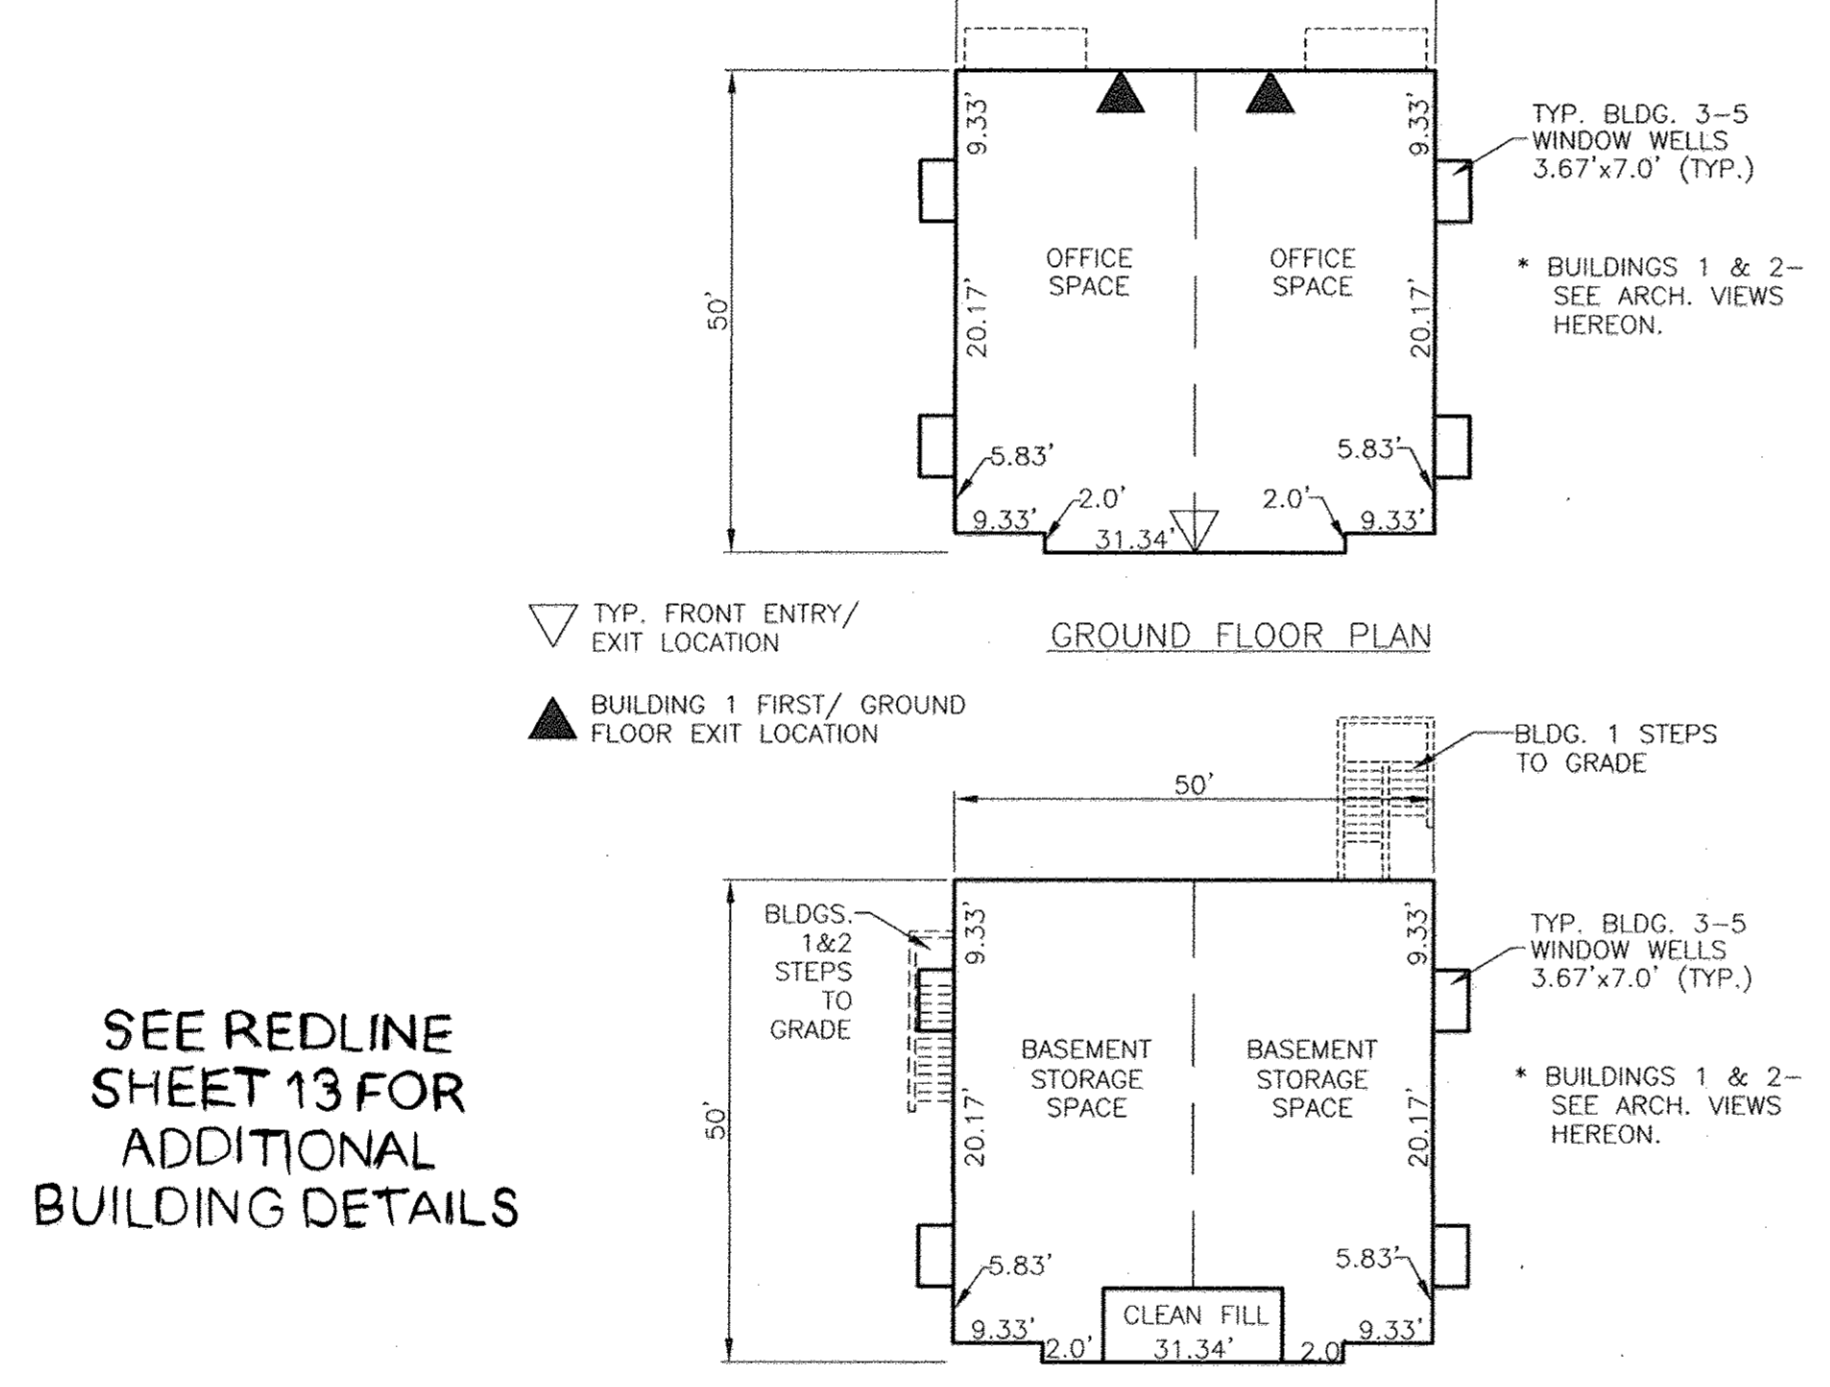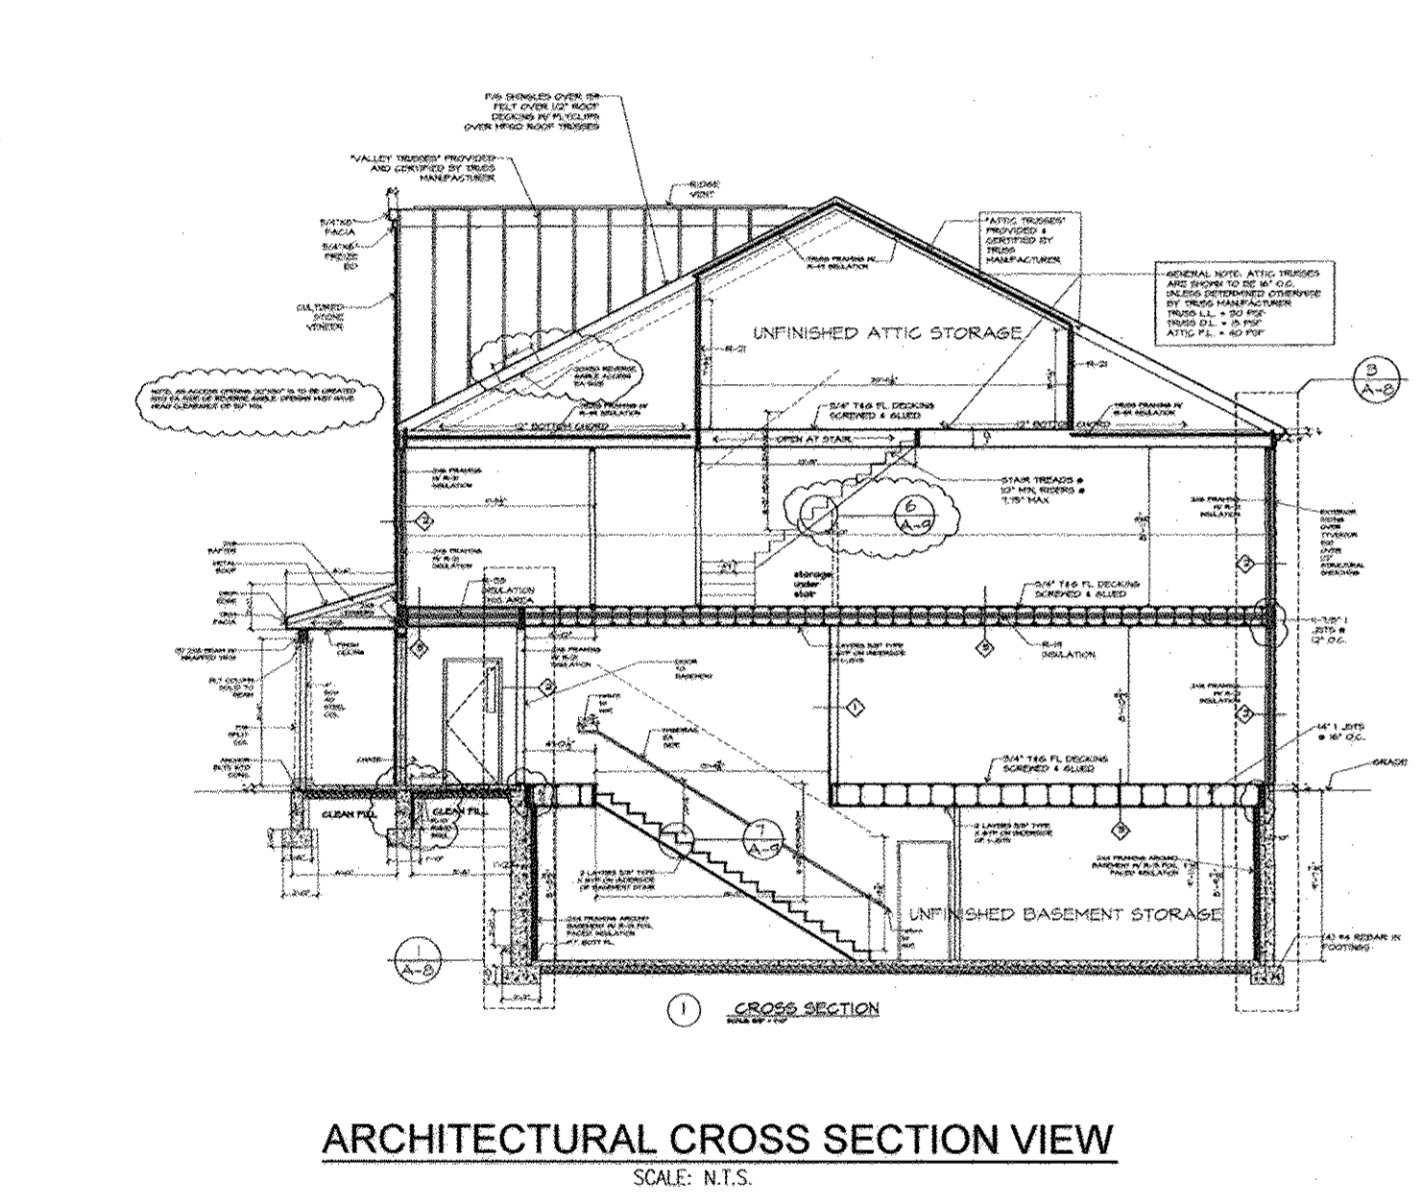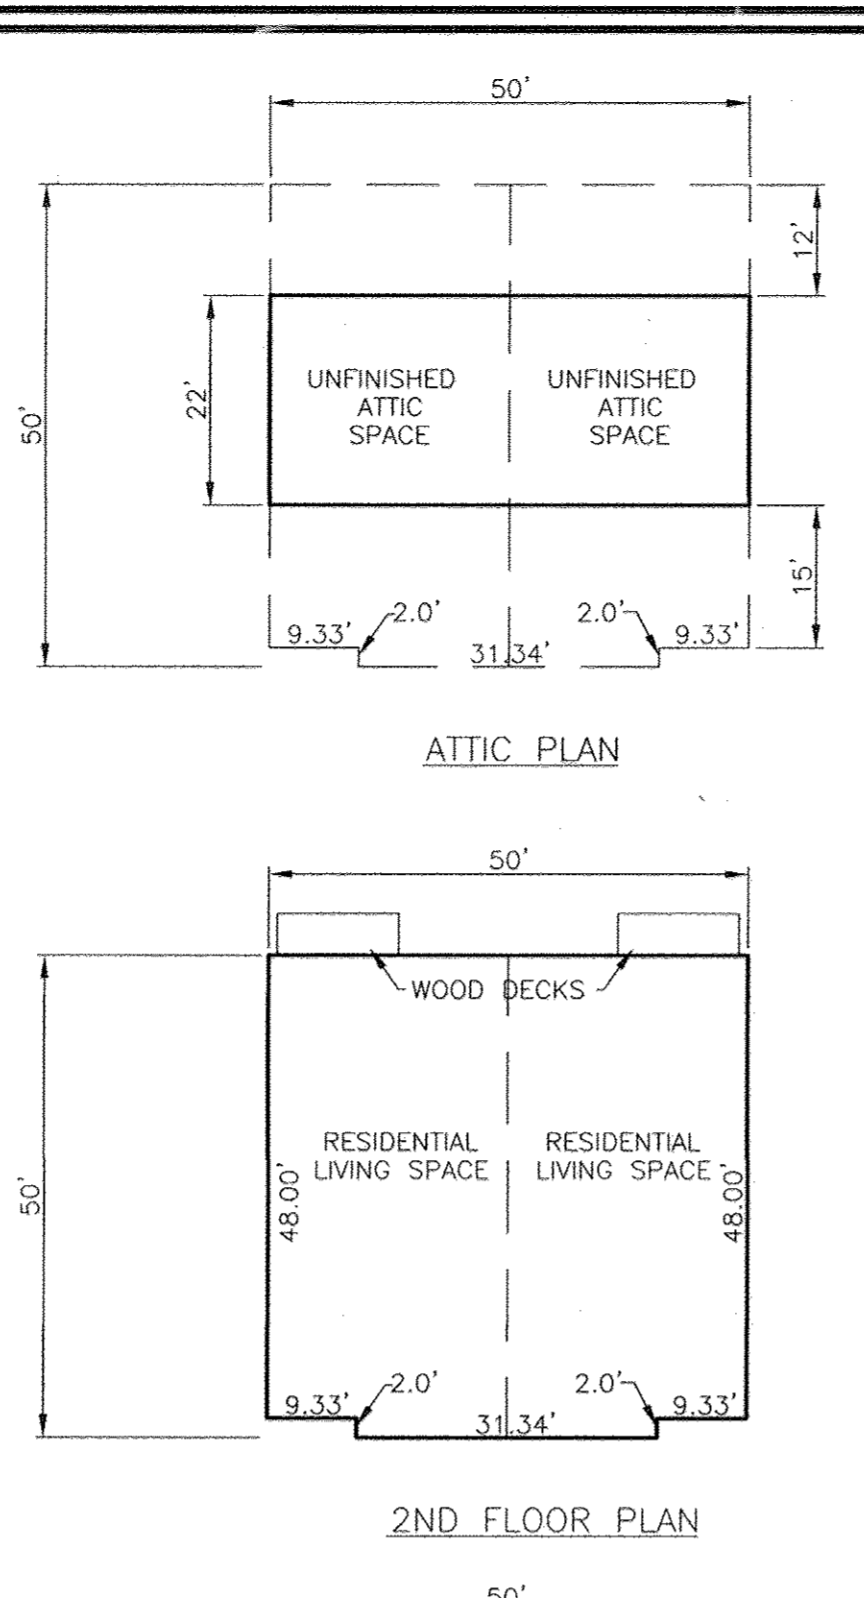


- NOTES:**
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 - REFER TO DETAILS HEREON.
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 - THE PROPOSED BUILDINGS WILL BE REQUIRED TO HAVE A SPRINKLER SYSTEM INSTALLED.
 - ALL WATER CONNECTIONS SHALL BE 4" REFERENCE STANDARD DETAIL W-3.2.4.
 - BUILDINGS SHALL UTILIZE INSIDE COMBINED FIRE / DOMESTIC (1-1/2") WATER METER SETTINGS. THERE ARE FOUR (4) UNITS PER BUILDING: TWO (2) RESIDENTIAL AND TWO (2) COMMERCIAL USES.
 - REFER TO "CONSTRUCTION NOTES FOR ADVANCE DEPOSIT ORDER (A.D.O.) WORK IN THE PUBLIC WATER & UTILITY EASEMENT"

SEWER MANHOLE SCHEDULE

NO.	TYPE	LOCATION	EASTING	NORTHING	TOP ELEV.	INV. IN	INV. OUT
EX 3073	EXISTING MH	HO. CO. STD. DET. G5 12	E 1351095	N 587137	432.528	419.0	418.8
SMH 1	STD. PRECAST MH	HO. CO. STD. DET. G5 12	E 1351217	N 587027	434.4	419.25	419.35
SMH 2	STD. PRECAST MH	HO. CO. STD. DET. G5 12	E 1351217	N 587027	438.95	424.12	423.00

* CONTRACTOR SHALL VERIFY EXISTING INVERT

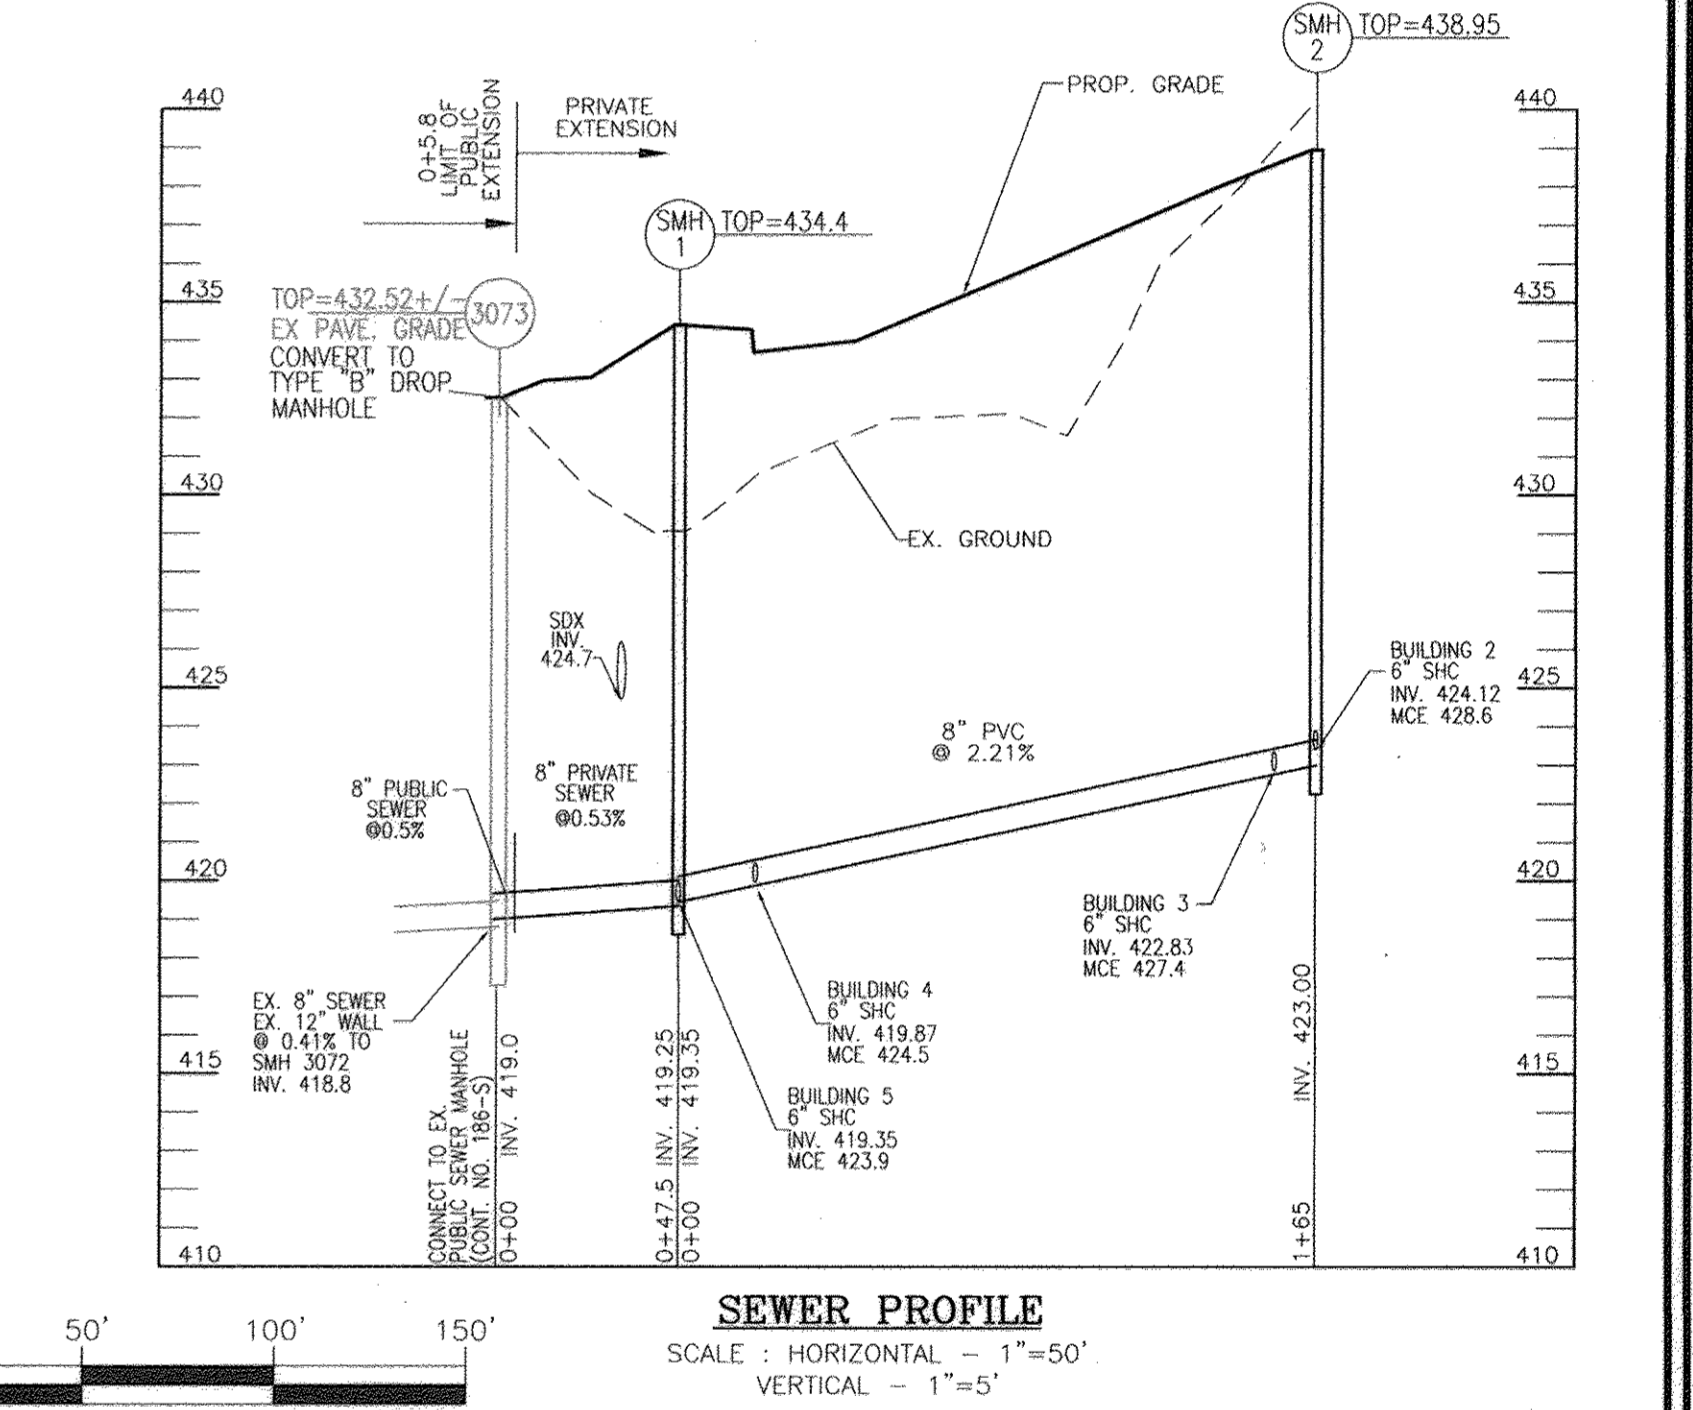

APPROVED: HOWARD COUNTY DEPARTMENT OF PLANNING AND ZONING

Paul Frank
CHIEF, DEVELOPMENT ENGINEERING DIVISION
DATE: 6-8-15

K. A. Spivey
CHIEF, DIVISION OF LAND DEVELOPMENT
DATE: 7-07-15

Walter J. ...
DIRECTOR
DATE: 7-7-15


APPROVED JULY 17, 2014
PLANNING BOARD OF HOWARD COUNTY

PLANNING DIRECTOR

THIS DEVELOPMENT PLAN IS APPROVED FOR SOIL EROSION AND SEDIMENT CONTROL BY THE HOWARD COUNTY DISTRICT

APPROVED: *[Signature]*
DATE: *[Date]*

HOWARD COUNTY, MARYLAND
Department of Public Works
Concrete Sidewalk
Detail
R-3.05

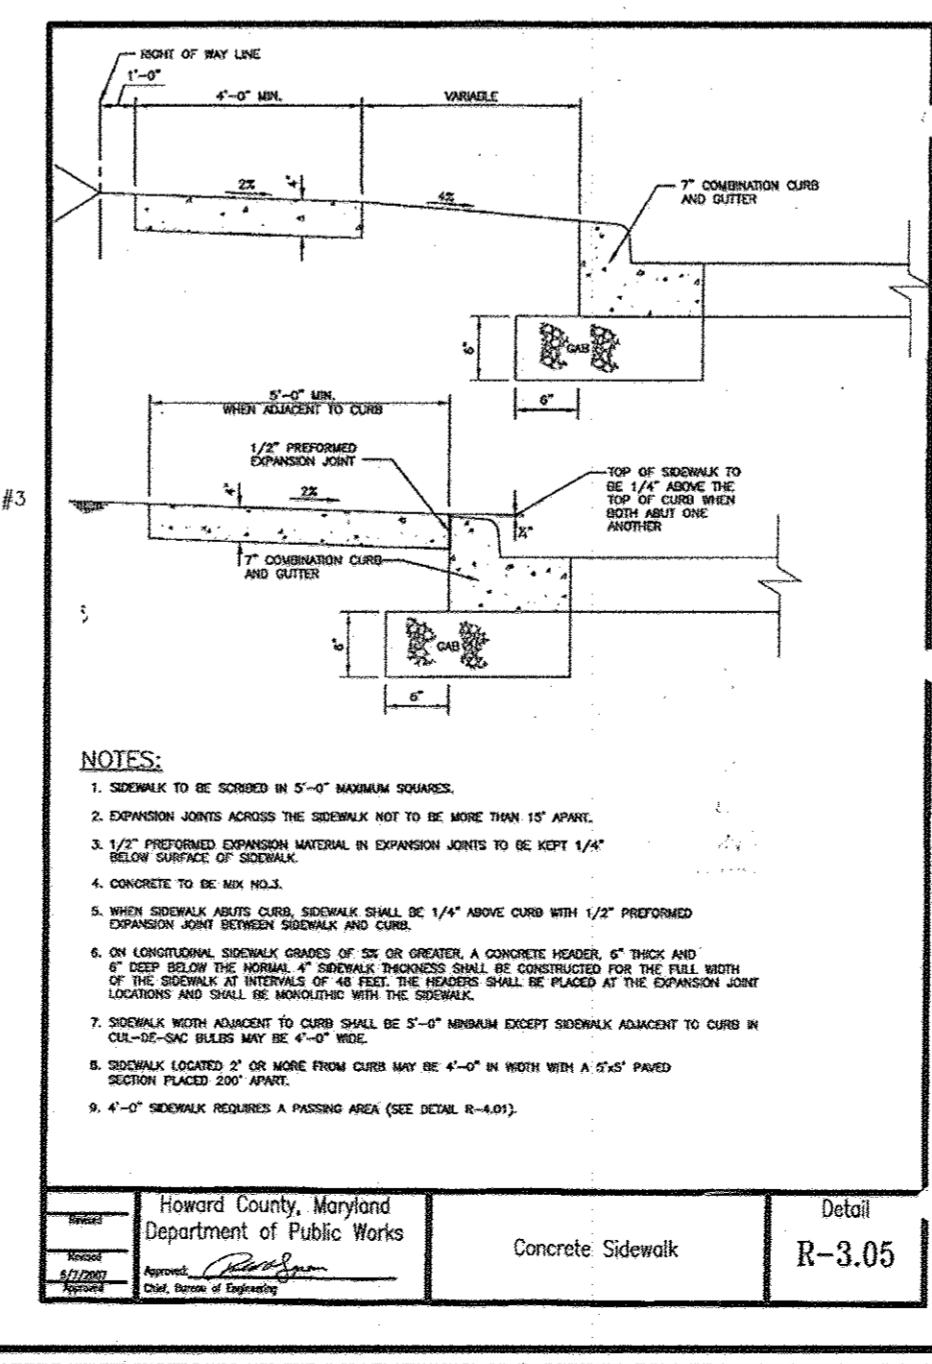

ATTORNEY
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PHONE: (410) 440-1242

3 REVERSE BUILDING 2, 3 & 4 WINDOW WELL LOCATIONS, ADD CONC. PADS 6/15/17

SITE DEVELOPMENT PLAN
SITE DETAILS
DEMIREL PLAZA
L 15037 F 345

2ND ELECTION DISTRICT
TAX MAP: 24 GRID: 1

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ENGINEERS • SURVEYORS • PLANNERS
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PROFESSIONAL CERTIFICATE
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DESIGN BY: EDS.
DRAWN BY: RVE.
CHECKED BY: RHY.
DATE: MAY 2015.
SCALE: AS SHOWN.
W.O. NO.: 11-01

4 SHEET OF 15

GRADING PLAN
SCALE: 1"=30'

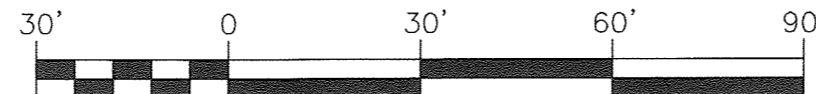




Table R.1: Temporary Seeding for Site Stabilization

Plant Species	Seeding Rate ¹ lb/acre	Seeding Depth ² (inches)	Recommended Seeding Dates by Plant Hardiness Zone ³			
			5b and 6a	6b	7a and 7b	
Cool-Season Grasses						
Annual Ryegrass (<i>Lolium perenne</i>) <i>var. multiflorum</i>	40	1.0	Mar 15 to May 31; Aug 1 to Sep 30	Mar 1 to May 15; Aug 1 to Oct 15	Feb 15 to Apr 30; Aug 15 to Nov 30	
Barley (<i>Hordeum vulgare</i>)	96	2.2	Mar 15 to May 31; Aug 1 to Sep 30	Mar 1 to May 15; Aug 1 to Oct 15	Feb 15 to Apr 30; Aug 15 to Nov 30	
Oats (<i>Avena sativa</i>)	72	1.7	Mar 15 to May 31; Aug 1 to Sep 30	Mar 1 to May 15; Aug 1 to Oct 15	Feb 15 to Apr 30; Aug 15 to Nov 30	
Wheat (<i>Triticum aestivum</i>)	120	2.8	Mar 15 to May 31; Aug 1 to Sep 30	Mar 1 to May 15; Aug 1 to Oct 15	Feb 15 to Apr 30; Aug 15 to Nov 30	
Cereal Rye (<i>Secale cereale</i>)	112	2.8	Mar 15 to May 31; Aug 1 to Oct 31	Mar 1 to May 15; Aug 1 to Nov 15	Feb 15 to Apr 30; Aug 15 to Dec 15	
Warm-Season Grasses						
Foxtail Millet (<i>Setaaria italica</i>)	30	0.7	Jun 1 to Jul 31	May 16 to Jul 31	May 1 to Aug 14	
Pearl Millet (<i>Pennisetum glaucum</i>)	20	0.5	Jun 1 to Jul 31	May 16 to Jul 31	May 1 to Aug 14	

NOTES:
1/ Seeding rates for the warm-season grasses are in pounds of Pure Live Seed (PLS). Actual planting rates shall be adjusted to reflect percent seed germination and purity, as noted. Adjustments are usually not needed for the cool-season grasses.
Seeding rates listed above are for temporary seedings, when planted alone. When planted as a nurse crop with permanent seed mixes, use 1/3 of the seeding rate listed above for barley, oats, and wheat. For smaller-seeded grasses (annual ryegrass, pearl millet, foxtail millet), do not exceed more than 3% (by weight) of the overall permanent seeding mix. Cereal rye generally should not be used as a nurse crop, unless planting will occur in very fall beyond the seeding dates for other temporary seedings. Consult the local seed supplier for the germination and growth of other grasses. If it must be used as a nurse crop, seed at 1/2 of the rate listed above.
Oats are the recommended nurse crop for warm-season grasses.

2/ For sandy soils, plant seeds at twice the depth listed above.
3/ The planting dates listed are averages for each Zone and may require adjustment to reflect local conditions, especially near the boundaries of the zone.
NOTE: EITHER PERMANENT OR TEMPORARY STABILIZATION IS TO BE APPLIED AT THE DIRECTION OF THE SEDIMENT CONTROL INSPECTOR REGARDLESS OF DAYS/DATES IN THE STANDARD SEDIMENT CONTROL NOTES AND/OR SEEDING SPECIFICATIONS.


LEGEND

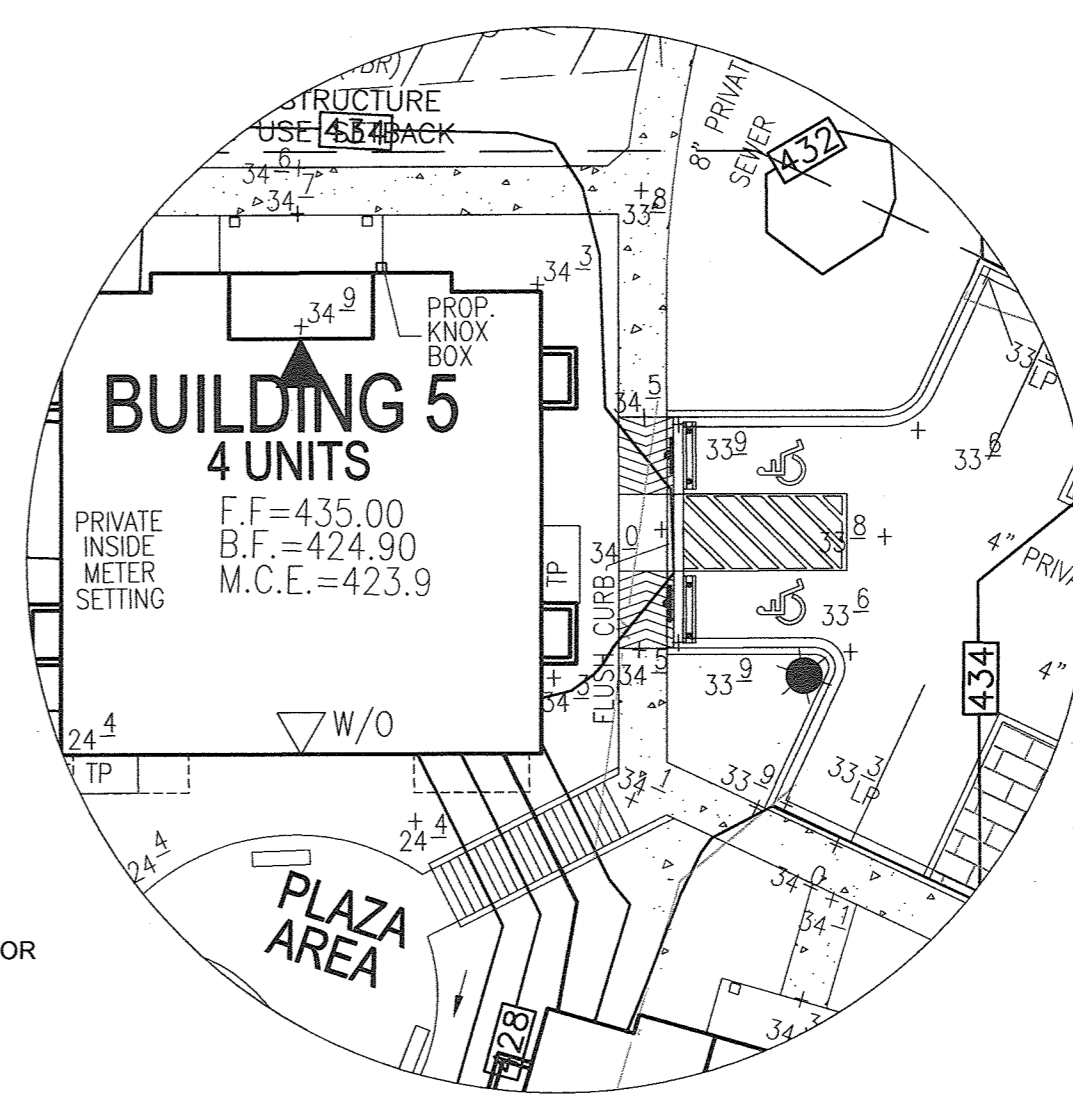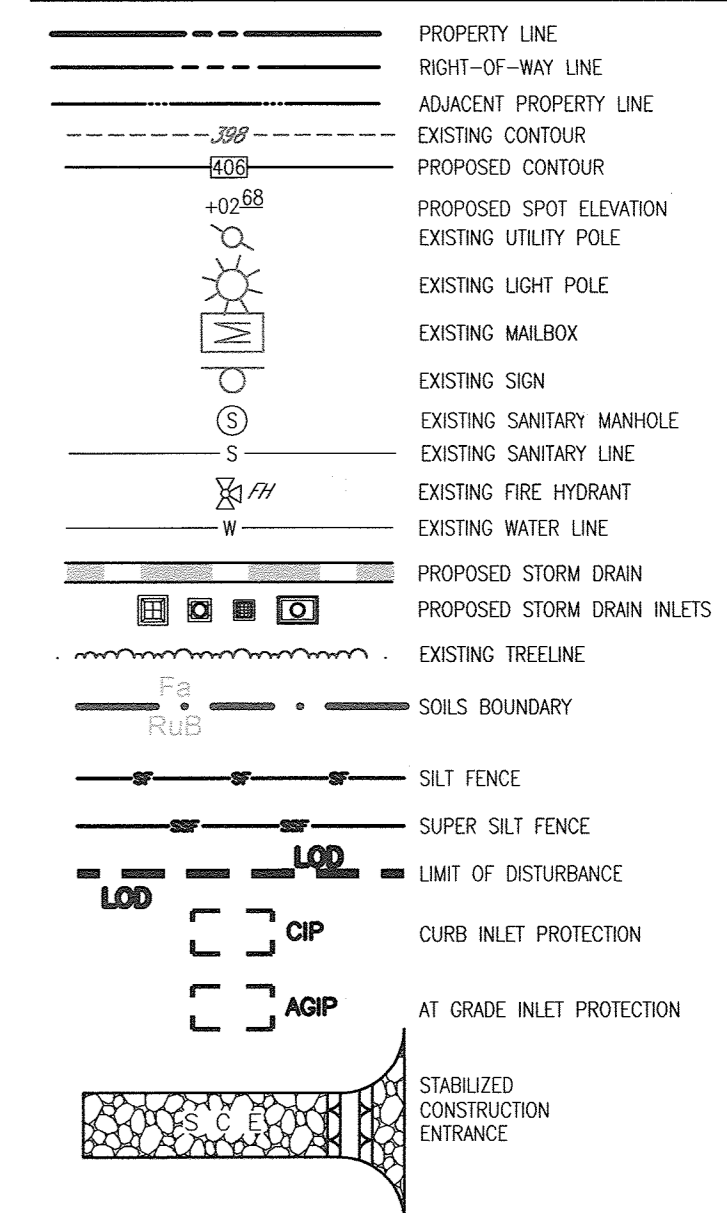


SIDEWALK INSET DETAIL
SCALE: 1"=20'

NOTES

- REFER TO SHEET 7 FOR SEQUENCE OF CONSTRUCTION
- REFER TO SHEET 7 FOR TRAP SCHEDULE
- REFER TO SHEETS 6 & 7 FOR STANDARD DETAILS AND STABILIZATION NOTES

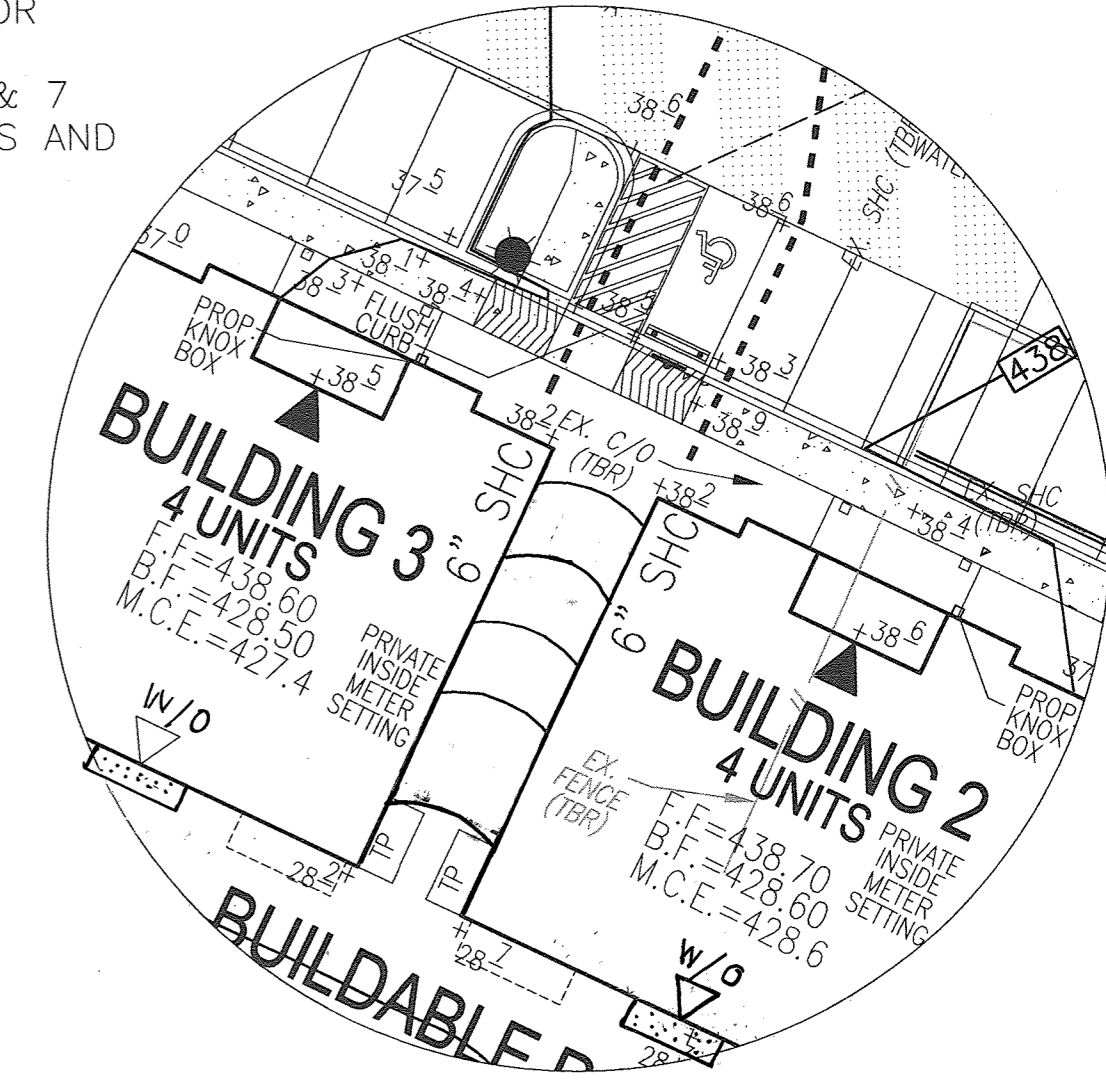

SIDEWALK INSET DETAIL
SCALE: 1"=20'

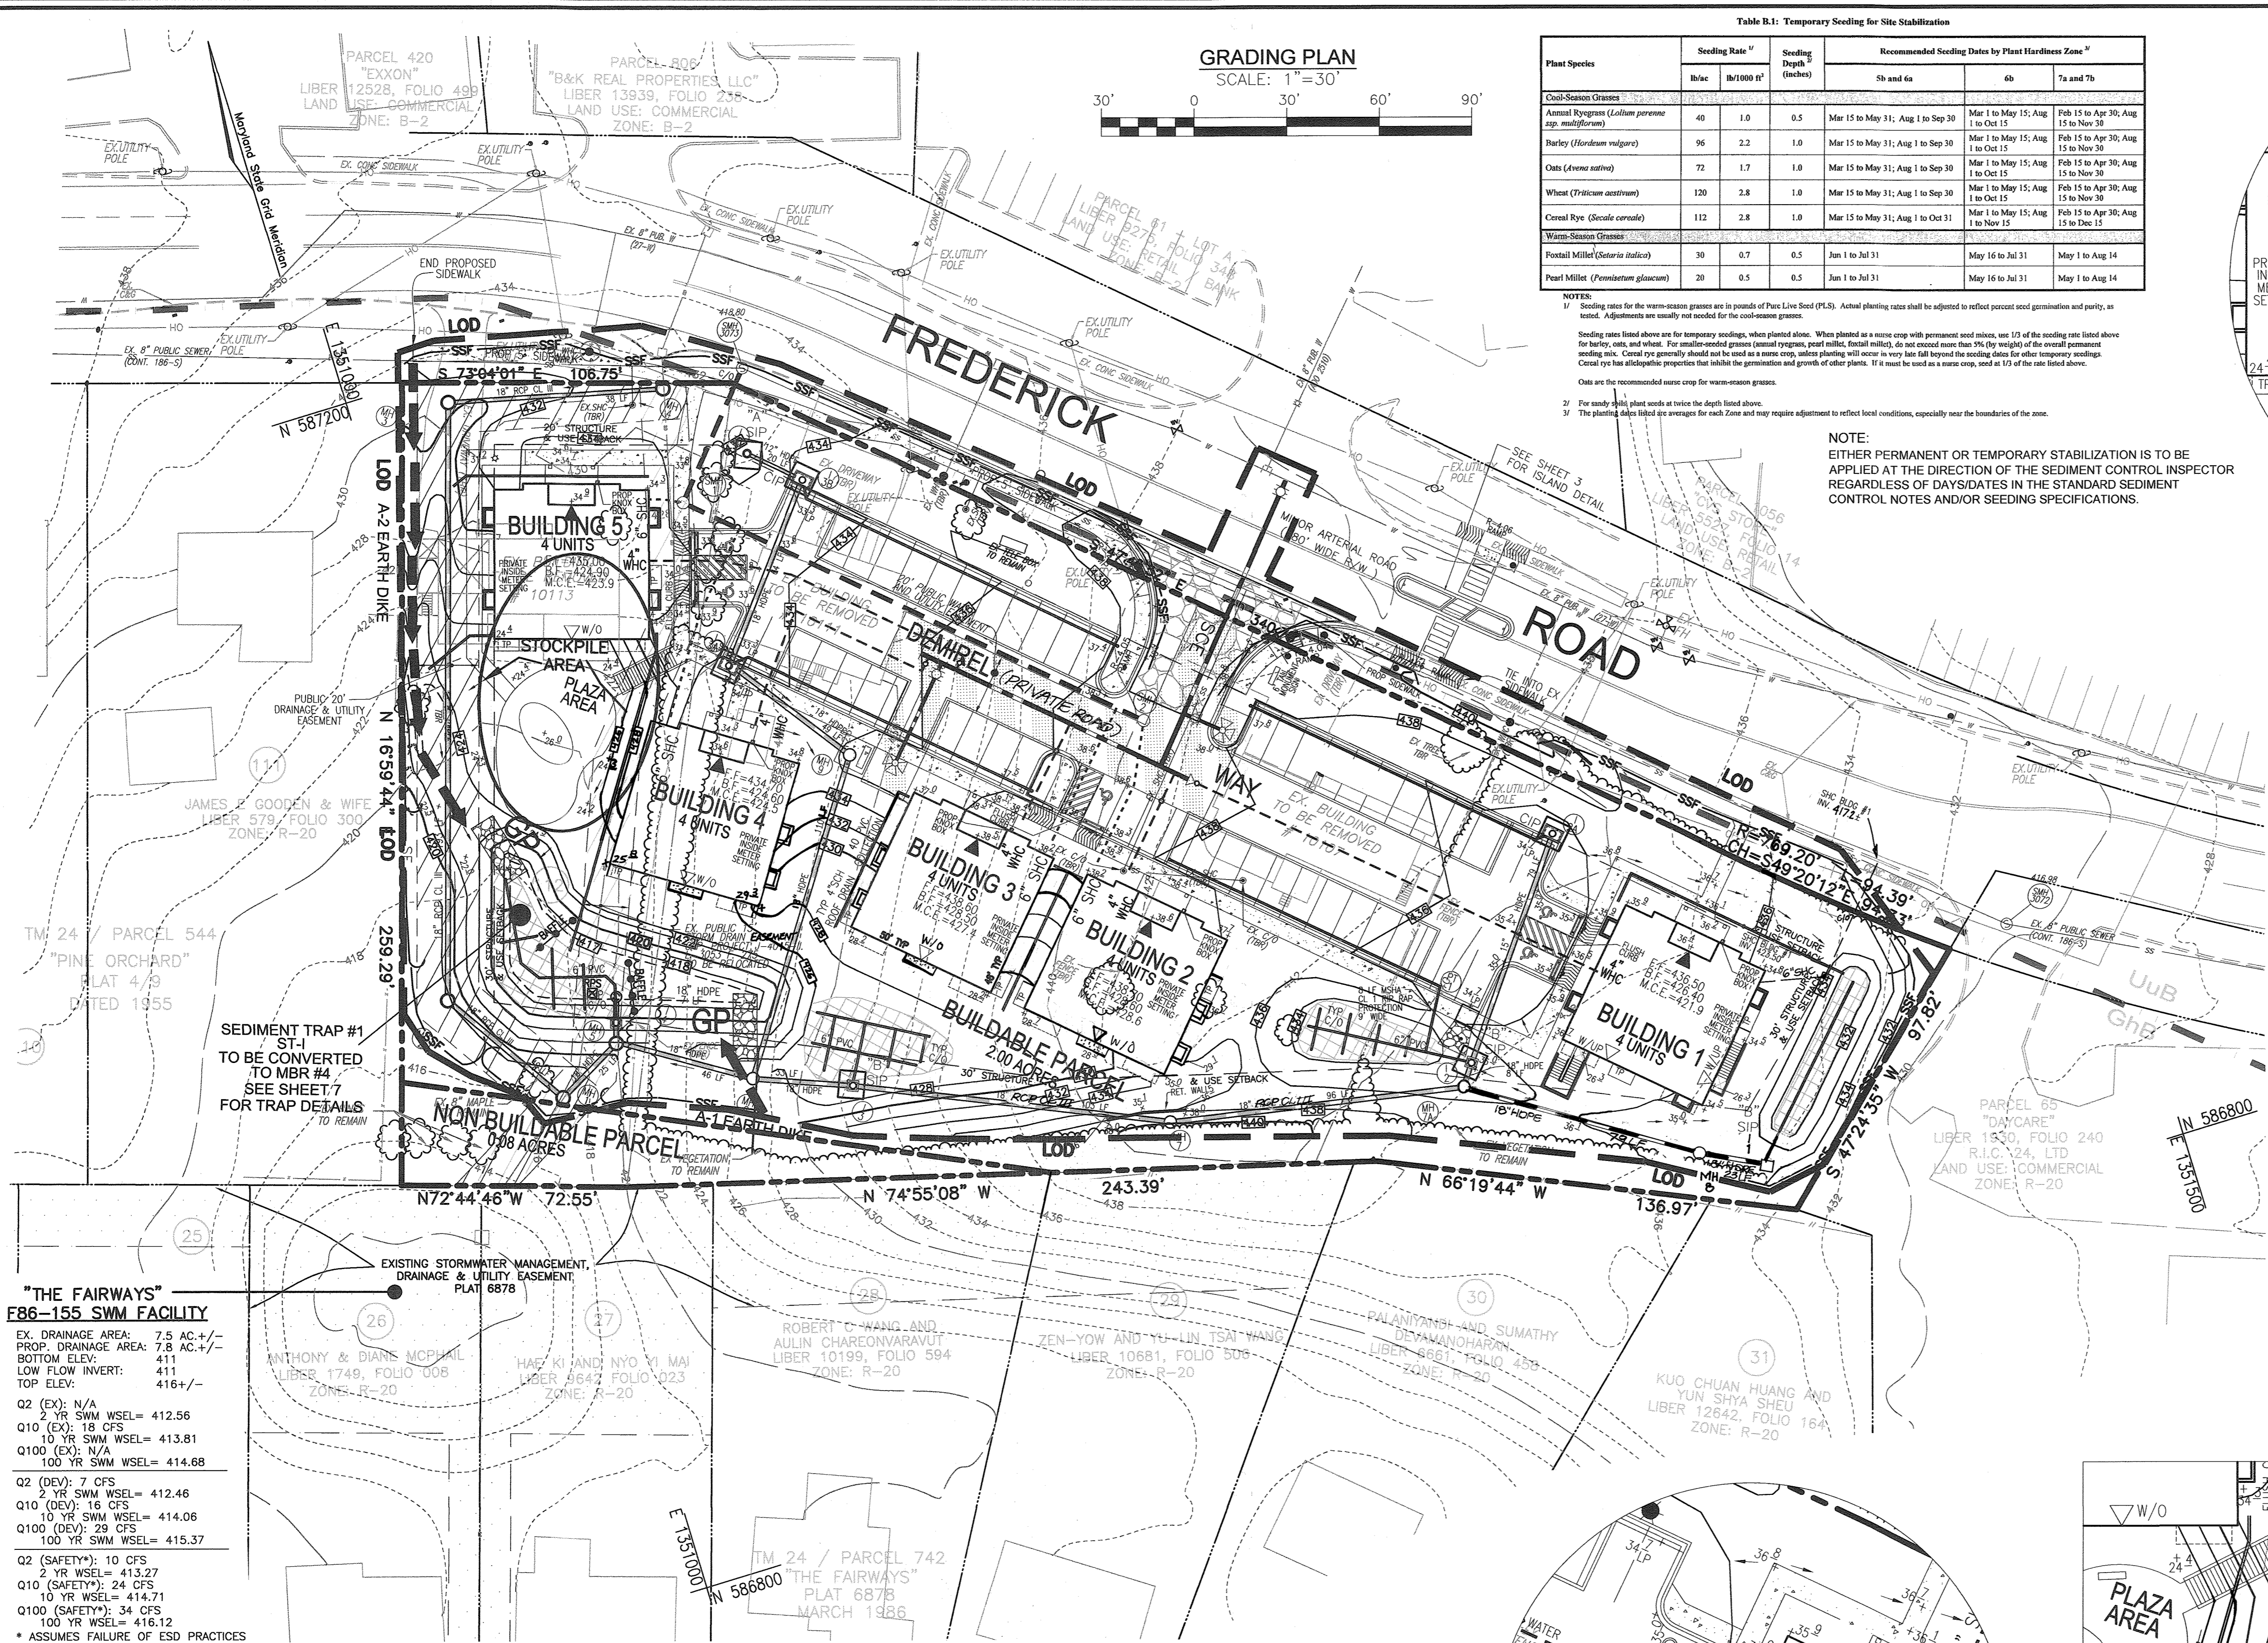

"THE FAIRWAYS" F86-155 SWM FACILITY

EX. DRAINAGE AREA:	7.5 AC +/-
PROP. DRAINAGE AREA:	7.8 AC +/-
BOTTOM ELEV.:	411
LOW FLOW INVERT:	411
TOP ELEV.:	416 +/-
Q2 (EX):	N/A
2 YR SWM WSEL:	412.56
Q10 (EX):	18 CFS
10 YR SWM WSEL:	413.81
Q100 (EX):	N/A
100 YR SWM WSEL:	414.68
Q2 (DEV):	7 CFS
2 YR SWM WSEL:	412.46
Q10 (DEV):	18 CFS
10 YR SWM WSEL:	414.06
Q100 (DEV):	29 CFS
100 YR SWM WSEL:	415.37
Q2 (SAFETY):	10 CFS
2 YR WSEL:	413.27
Q10 (SAFETY):	24 CFS
10 YR WSEL:	414.71
Q100 (SAFETY):	34 CFS
100 YR WSEL:	416.12

* ASSUMES FAILURE OF ESD PRACTICES

- NOTE:**
- CONTRACTOR TO PROVIDE IMMEDIATE REPAIR OF ANY EARTH DIKES INTERRUPTED DURING CONSTRUCTION.
 - CONTRACTOR TO PROVIDE IMMEDIATE REPAIR OF ANY SEDIMENT CONTROLS INTERRUPTED OR DAMAGED BY THE INSTALLATION OF THE STORM DRAIN SYSTEMS.

APPROVED JULY 17, 2014
PLANNING BOARD OF HOWARD COUNTY

APPROVED: HOWARD COUNTY DEPARTMENT OF PLANNING AND ZONING

Chief, Development Engineering Division: *Phil Edwards* 6-8-15
 Chief, Division of Land Development: *Kristal Decker* 7-07-15
 Director: *William J. J. J.* 7-7-15

NOTE:

- SILT FENCE IS TO BE REPLACED WITH SUPER SILT FENCE AT THE DIRECTION OF THE SEDIMENT CONTROL INSPECTOR.
- SILT FENCE SHALL BE CURLED UPHILL WHERE IT RUNS DOWNHILL, NO MORE THAN 35 FEET APART
- DOUBLE ROWS OF SUPER SILT FENCE SHALL BE INSTALLED AT THE DIRECTION OF THE SEDIMENT CONTROL INSPECTOR.


NOTE: LOCATE STOCKPILE AS SHOWN HEREON OR AS DIRECTED BY THE SEDIMENT CONTROL INSPECTOR. STOCKPILES EXCEEDING 15 FEET IN HEIGHT SHALL BE BENCHED.

MAPPED SOILS TYPES - ELLICOTT CITY SW MAP #13


SYMBOL	NAME / DESCRIPTION	GROUP	HYDROIC	PERCENT SAND	K-FACTOR	PERCENT CLAY	PERCENT SILT
CHB	GLENELE-URBAN LAND COMPLEX, 0 TO 8 PERCENT SLOPES	B/D	NO	NO	0.20	NO	NO

TAKEN FROM: USDA, SCS-WEB SOIL SURVEY, HOWARD COUNTY
 K-FACTOR = $k_w @ 0-4" \text{ DEPTH}$

NOTE: HIGHLY ERODIBLE SOILS ARE THOSE SOILS WITH A SLOPE GREATER THAN 15 PERCENT OR THOSE SOILS WITH A SOIL ERODIBILITY FACTOR K GREATER THAN 0.35 AND WITH A SLOPE GREATER THAN 5 PERCENT

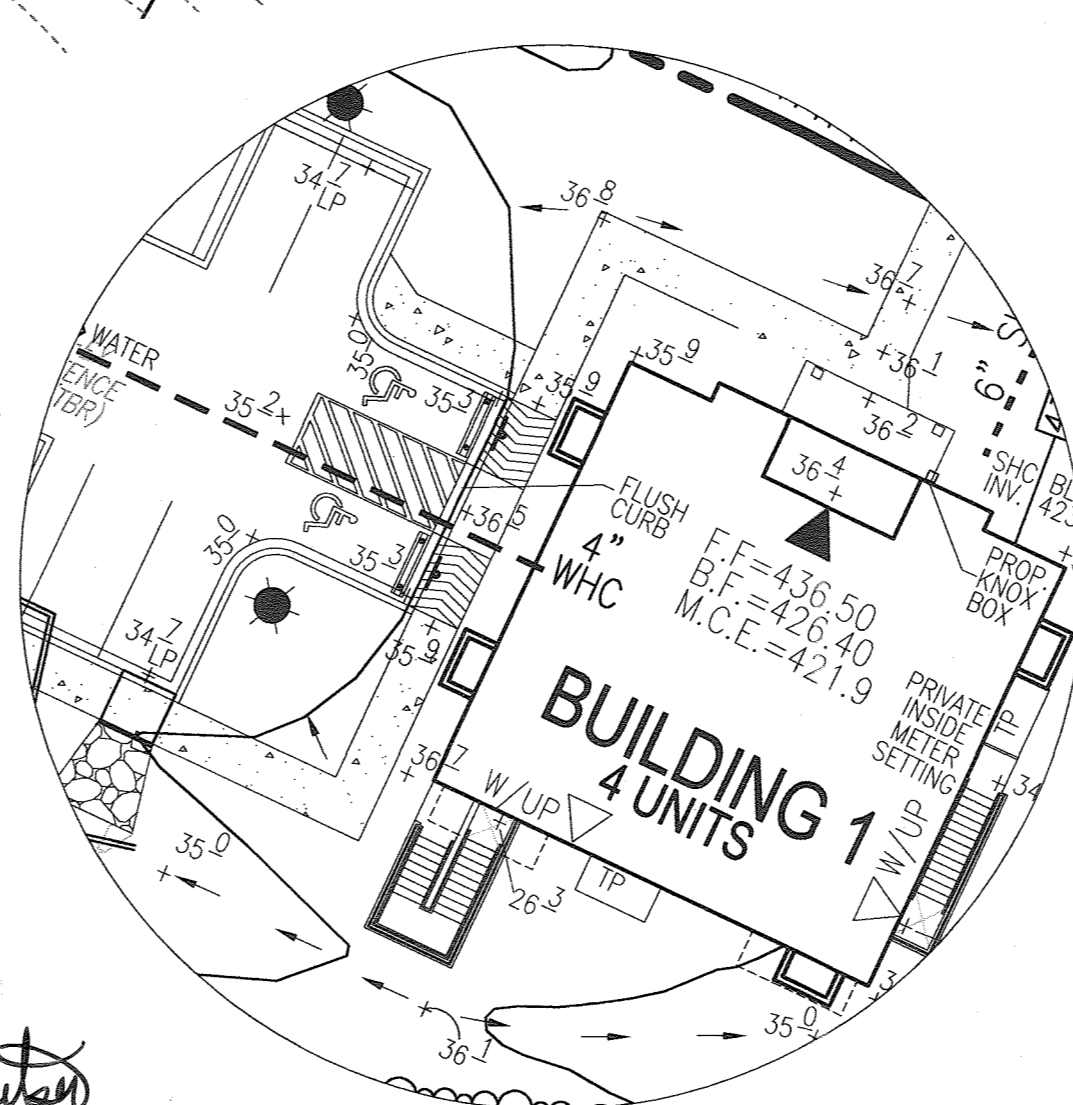

SIDEWALK INSET DETAIL
SCALE: 1"=20'

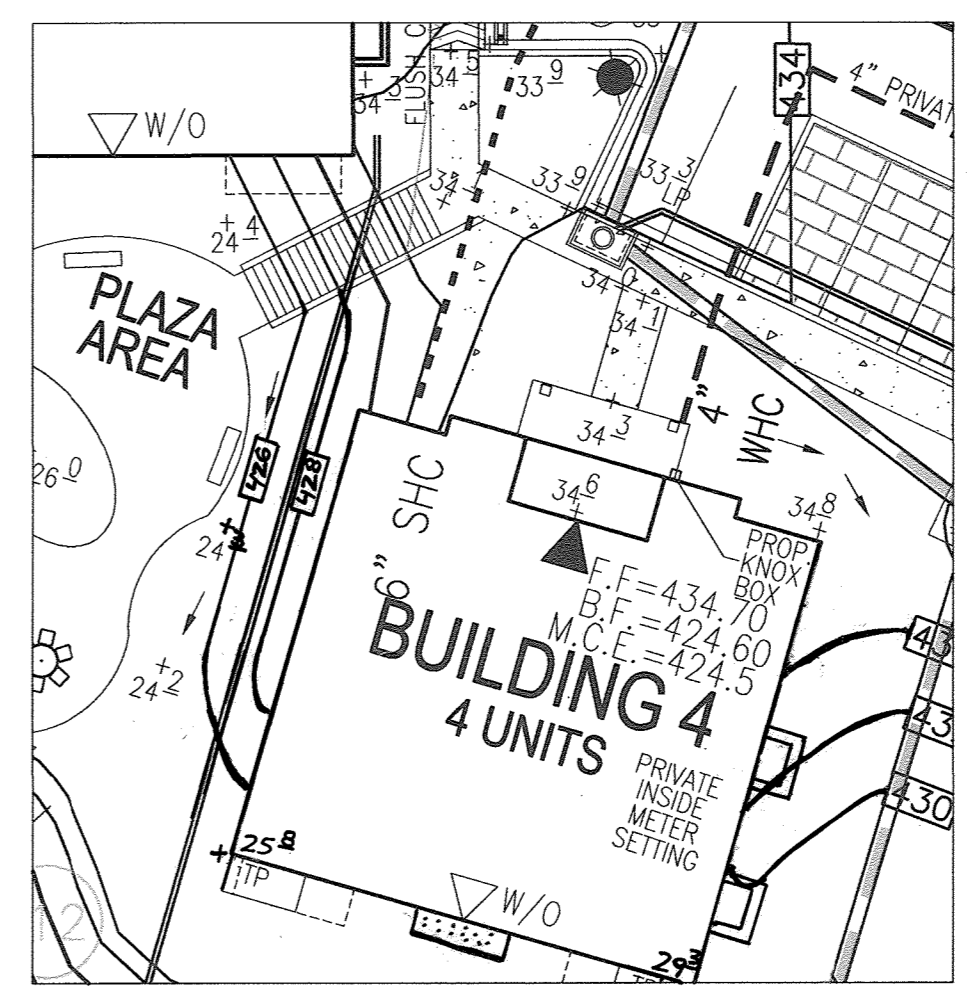

SIDEWALK INSET DETAIL
SCALE: 1"=20'

5	REVISE GRADES AROUND BUILDING 4	5-7-20
3	REVISE BUILDING 2, 3 & 4 WINDOW WELL LOCATIONS, ADD CONC. PADS	6/15/17
1	REVISE STORMDRAIN AND SHC TO BUILDING 1	12-9-15

NO. REVISION DATE

SITE DEVELOPMENT PLAN
SOILS, GRADING AND SOIL EROSION AND SEDIMENT CONTROL PLAN
DEMIREL PLAZA
 L.15037 F.345

2ND ELECTION DISTRICT PARCELS 62, 63 AND P/O 544 (LOT 112) ZONED: O1
 TAX MAP: 24 GRID: 1 PARCELS 62, 63 AND P/O 544 (LOT 112) HOWARD COUNTY, MARYLAND


ROBERT H. VOGEL ENGINEERING, INC.
 ENGINEERS • SURVEYORS • PLANNERS
 8407 MAIN STREET TEL: 410.461.7666
 ELLICOTT CITY, MD 21043 FAX: 410.461.8961

DESIGN BY: EDS
 DRAWN BY: RVE
 CHECKED BY: RHV
 DATE: MAY 2015
 SCALE: AS SHOWN
 W.O. NO.: 11-91














PROFESSIONAL CERTIFICATE
 I HEREBY CERTIFY THAT THESE DOCUMENTS WERE PREPARED OR APPROVED BY ME, AND THAT I AM A DAILY LICENSED PROFESSIONAL ENGINEER UNDER THE LAWS OF THE STATE OF MARYLAND, LICENSE NO. 16193 EXPIRATION DATE: 09-27-2016

STATE OF MARYLAND
 ROBERT H. VOGEL
 PROFESSIONAL ENGINEER

5 SHEET OF 15

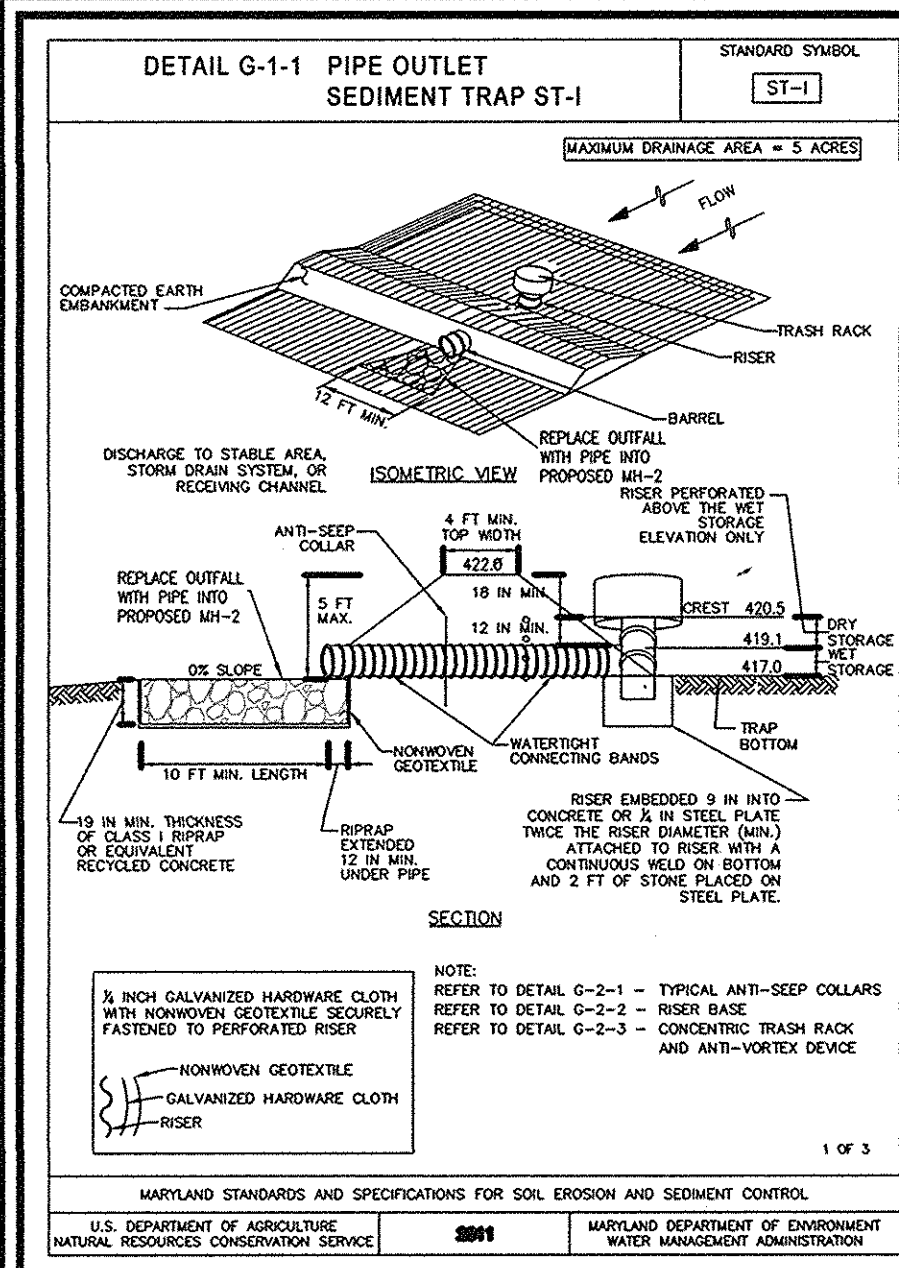

PIPE OUTLET SEDIMENT TRAP ST-1 TRAP NO. 1	
DRAINAGE AREA - INITIAL	1.30 ACRES
DRAINAGE AREA - FINAL	1.20 ACRES
TOTAL STORAGE REQUIRED	7,200 CF
TOTAL STORAGE PROVIDED	7,218 CF
NET STORAGE REQUIRED	3,600 CF
NET STORAGE PROVIDED	3,617 CF
DRY STORAGE REQUIRED	3,601 CF
DRY STORAGE PROVIDED	3,601 CF
TRAP BOTTOM ELEVATION	417.00 FT
TRAP BOTTOM DIMENSIONS	10' X 90' 4" - SEE PLAN
RISER CREST (DRY STORAGE) ELEVATION	420.50 FT
OUTLET (WET STORAGE) ELEVATION	419.10 FT
CLEANOUT ELEVATION	418.20 FT
TOP OF EMBANKMENT ELEVATION	422.00 FT
SIDE SLOPE	2:1 H:V BATIO
EMBANKMENT TOP WIDTH	4' FT
PRINCIPAL SPRINKLER MATERIAL (BARREL, RISER, ANTI-SEEP COLLAR)	PER STD. DETAIL
RISER DIAMETER	27" IN
BARREL DIAMETER	18" IN
TRASH RACK DIAMETER	42" IN
TRASH RACK HEIGHT	21" IN
ANTI-SEEP COLLAR DIMENSIONS (OUTLET PROTECTION - LENGTH)	5.5' X 5.5' FT
OUTLET PROTECTION - WIDTH	N/A FT
OUTLET PROTECTION - DEPTH	N/A FT

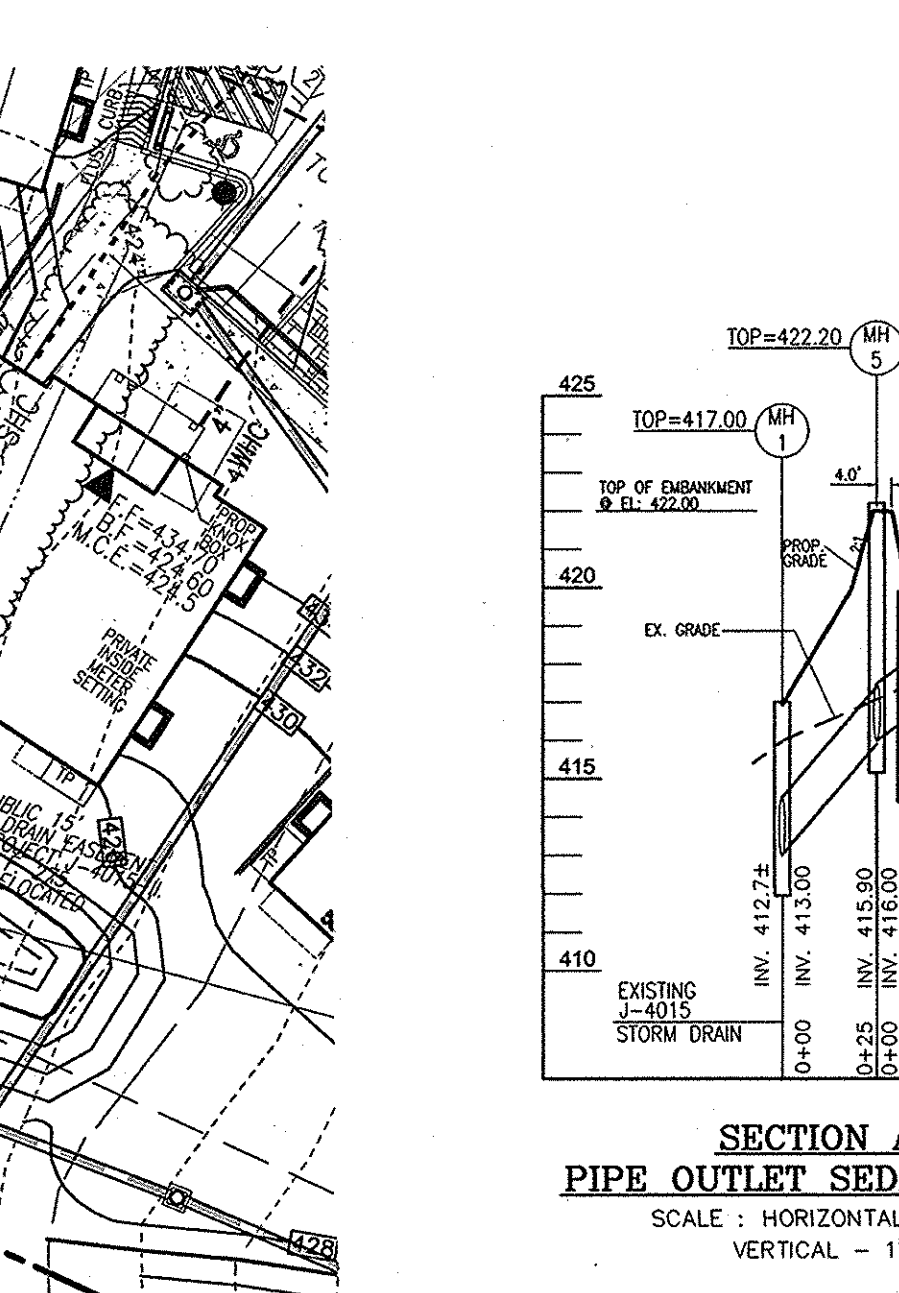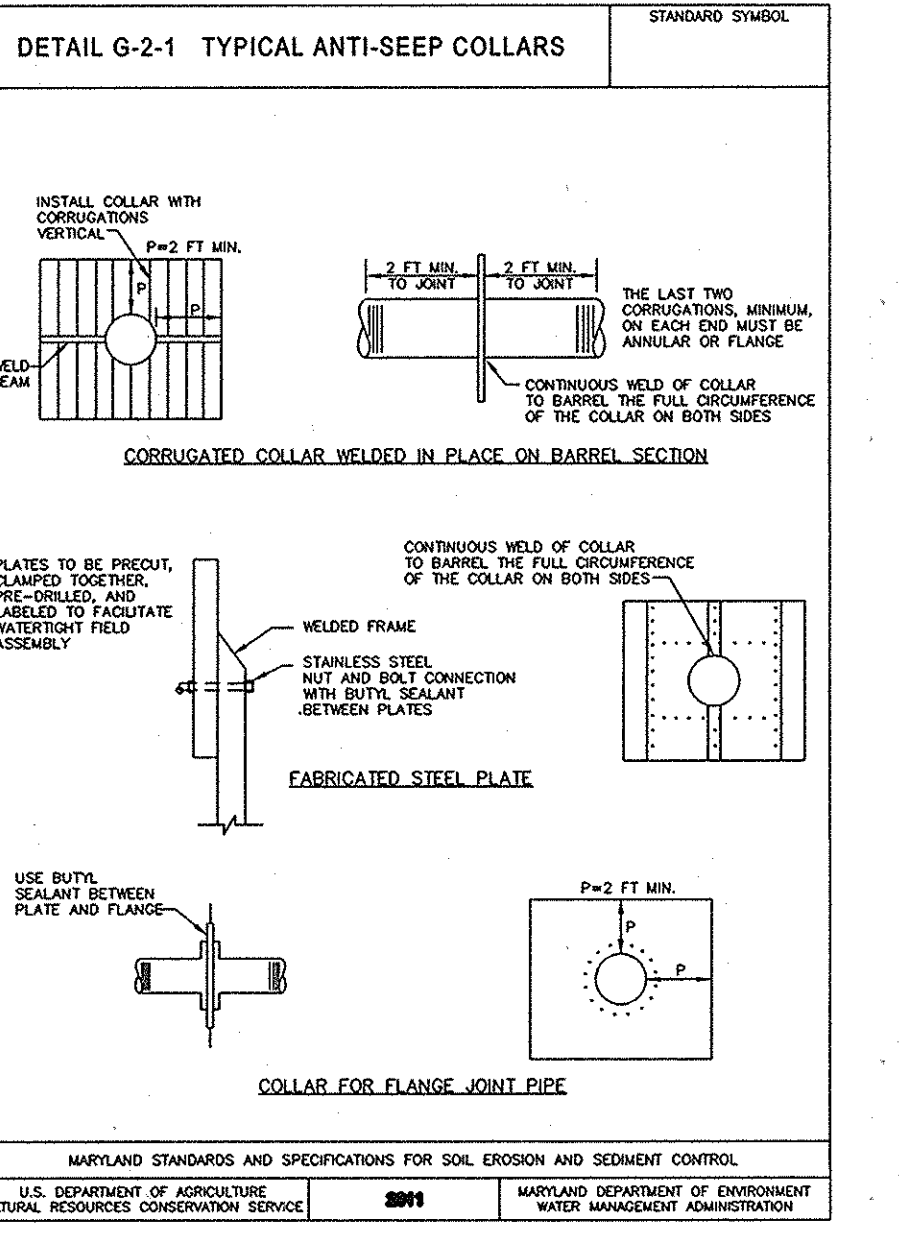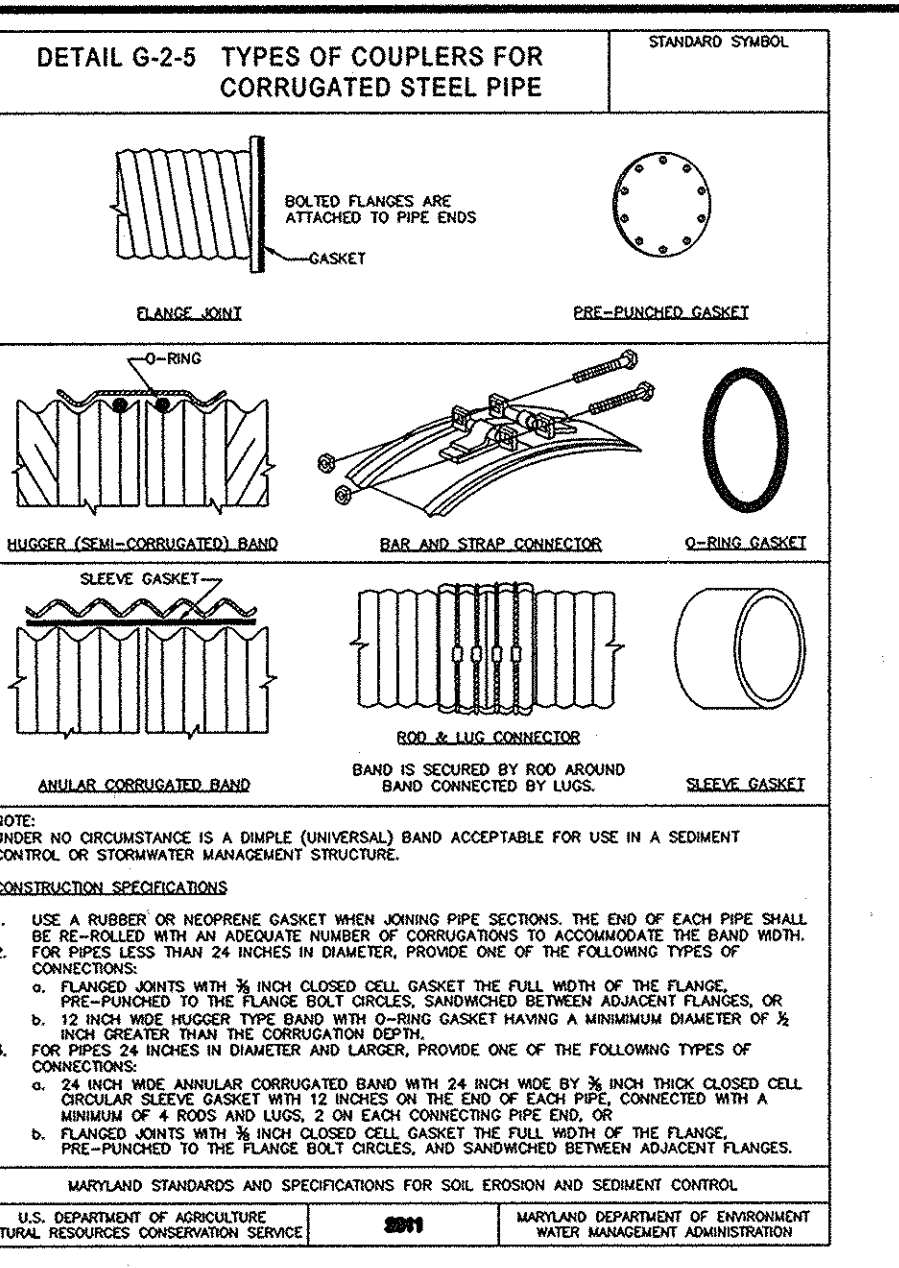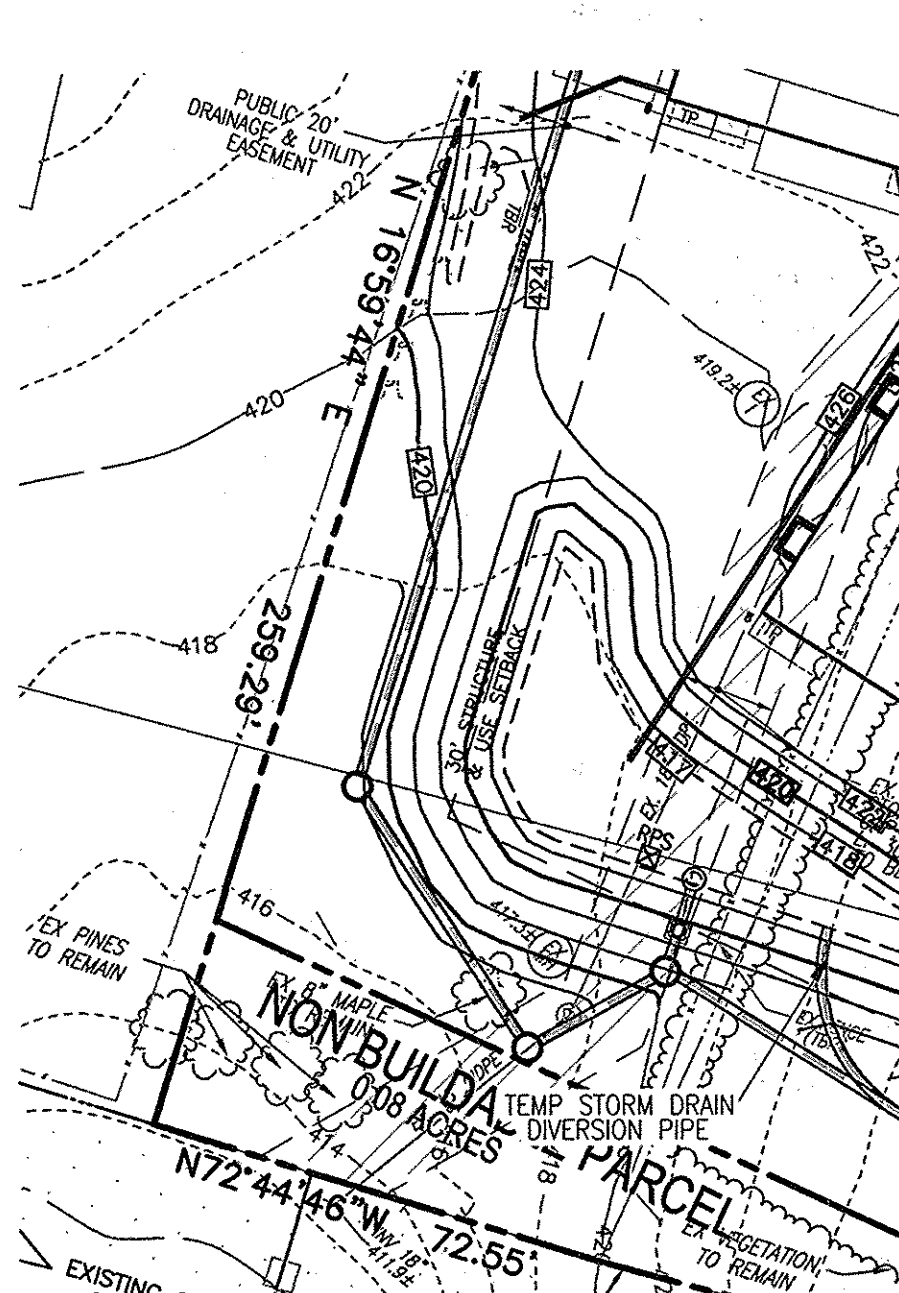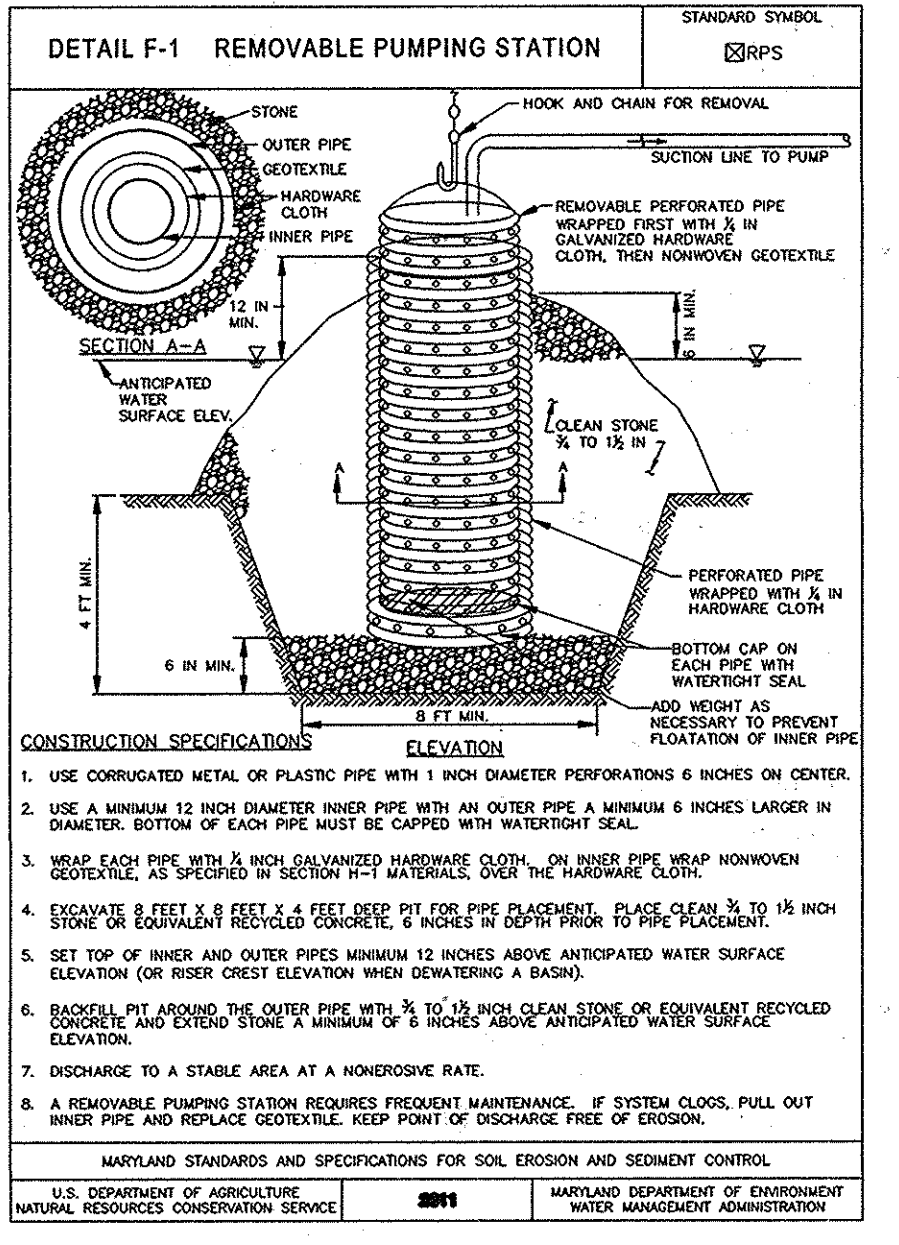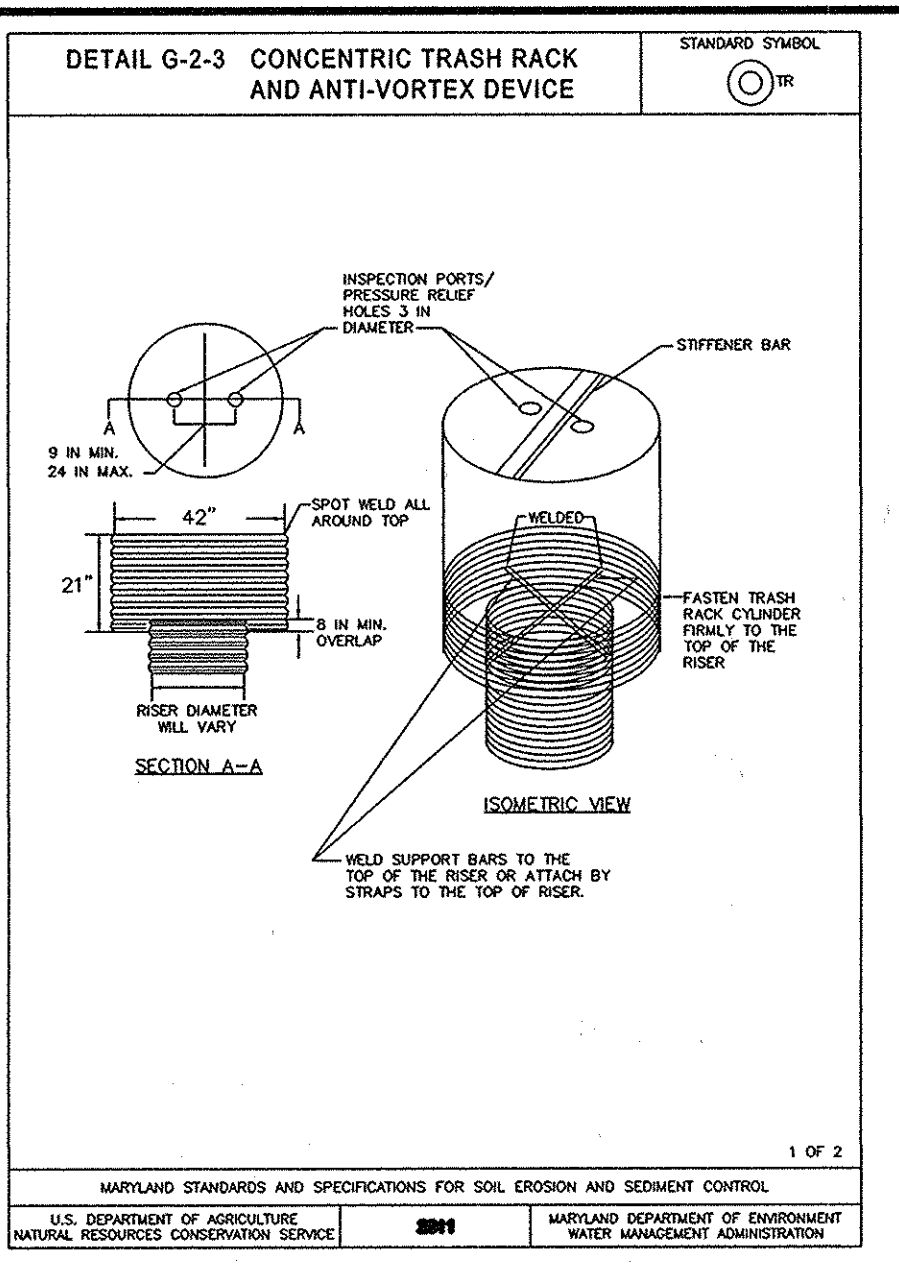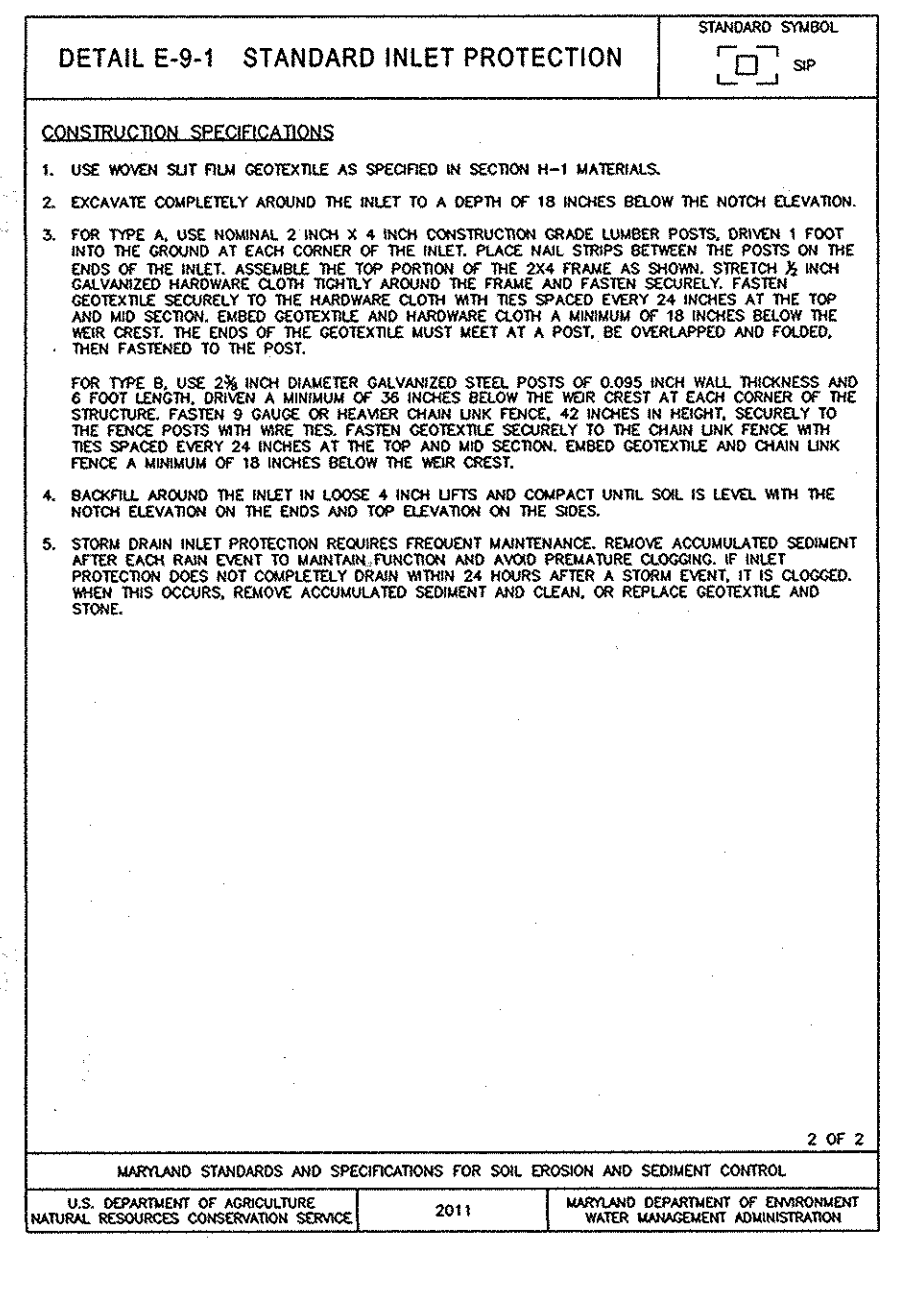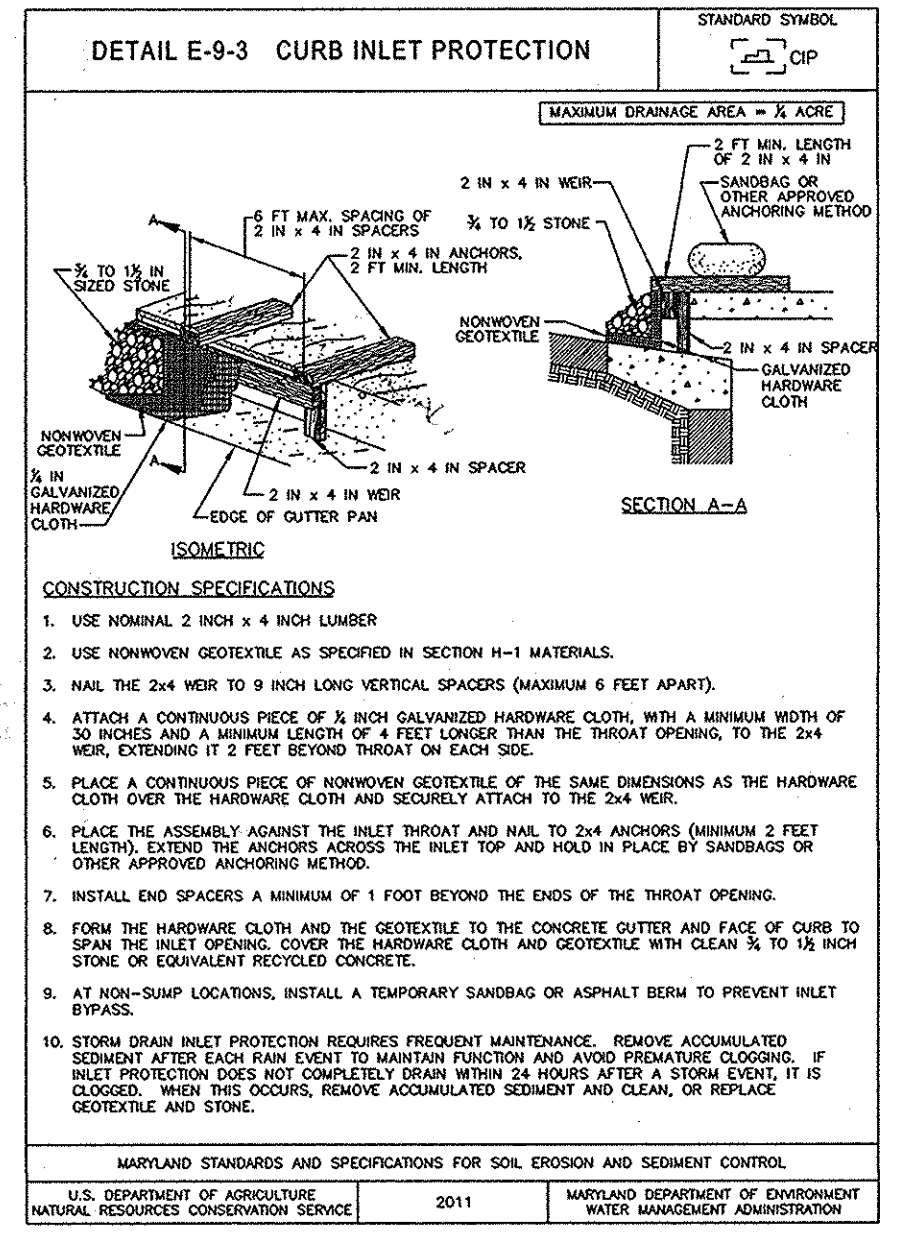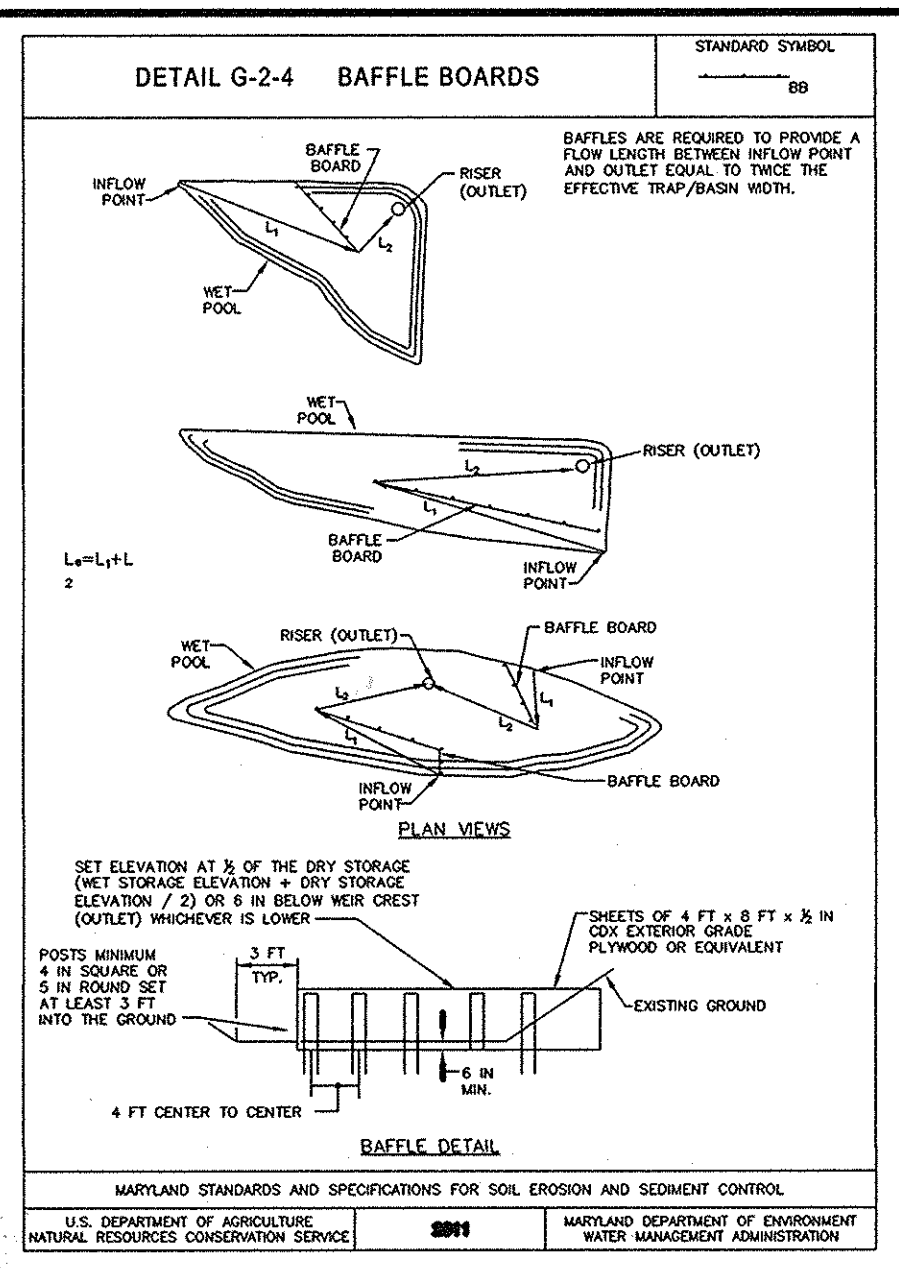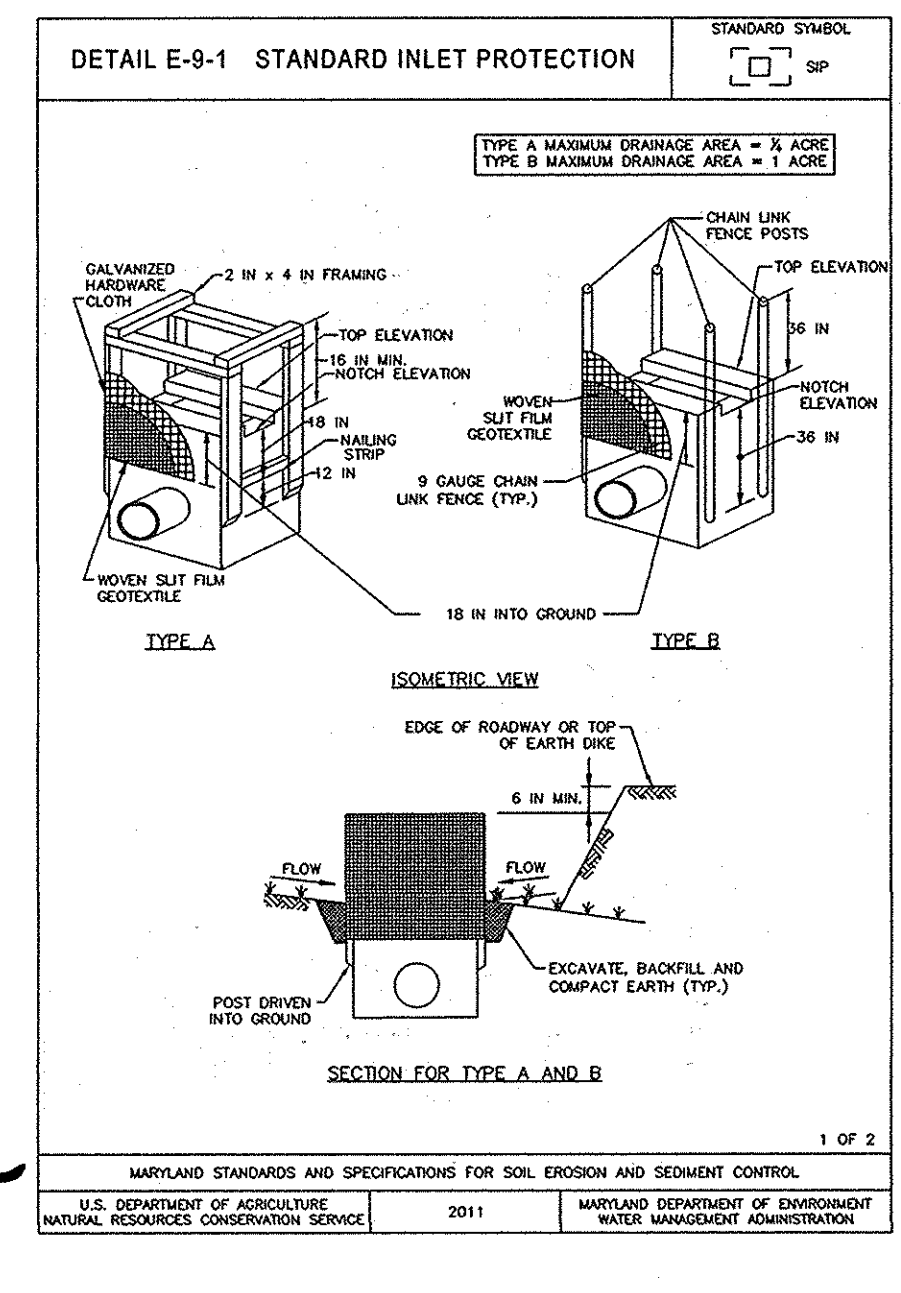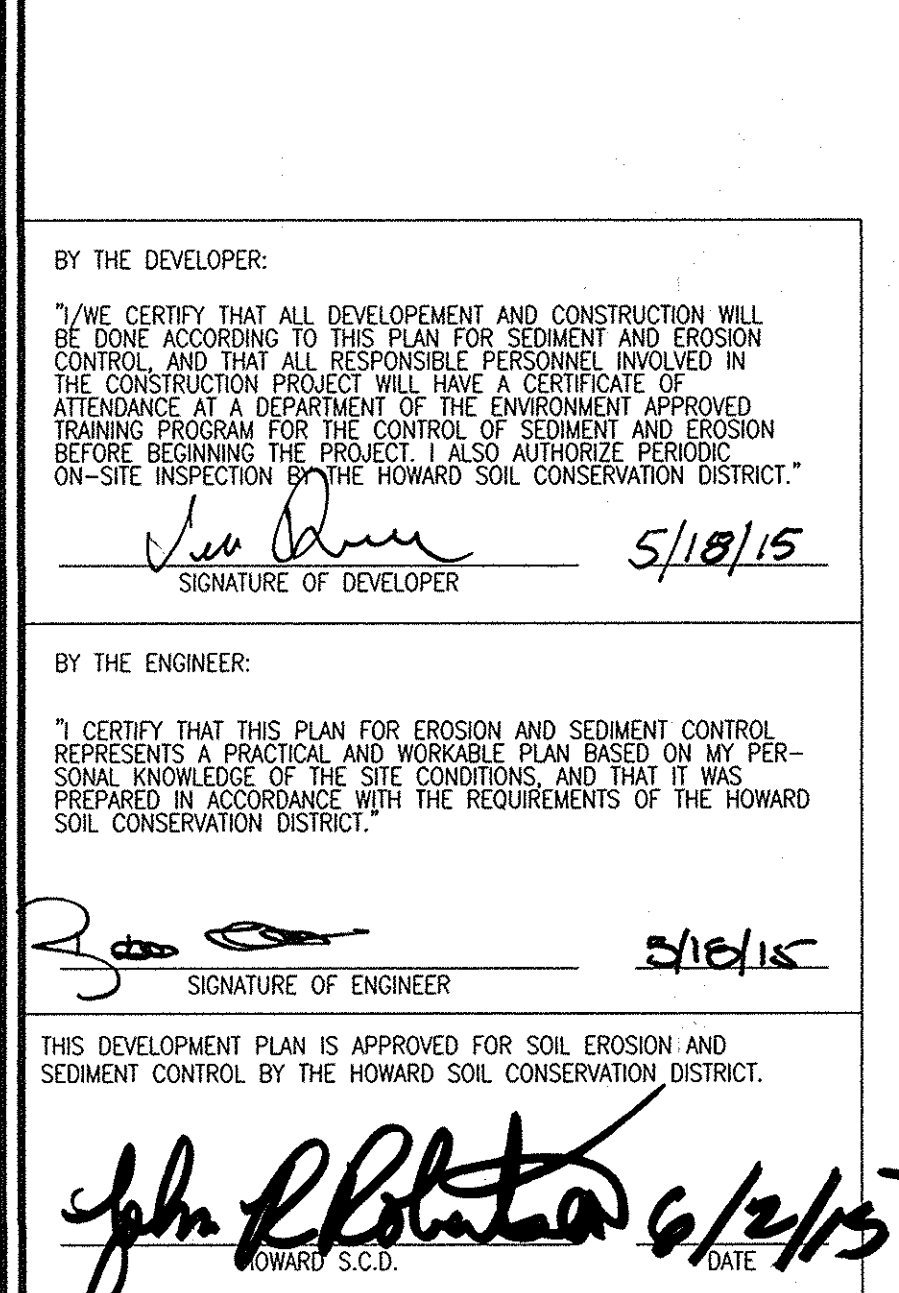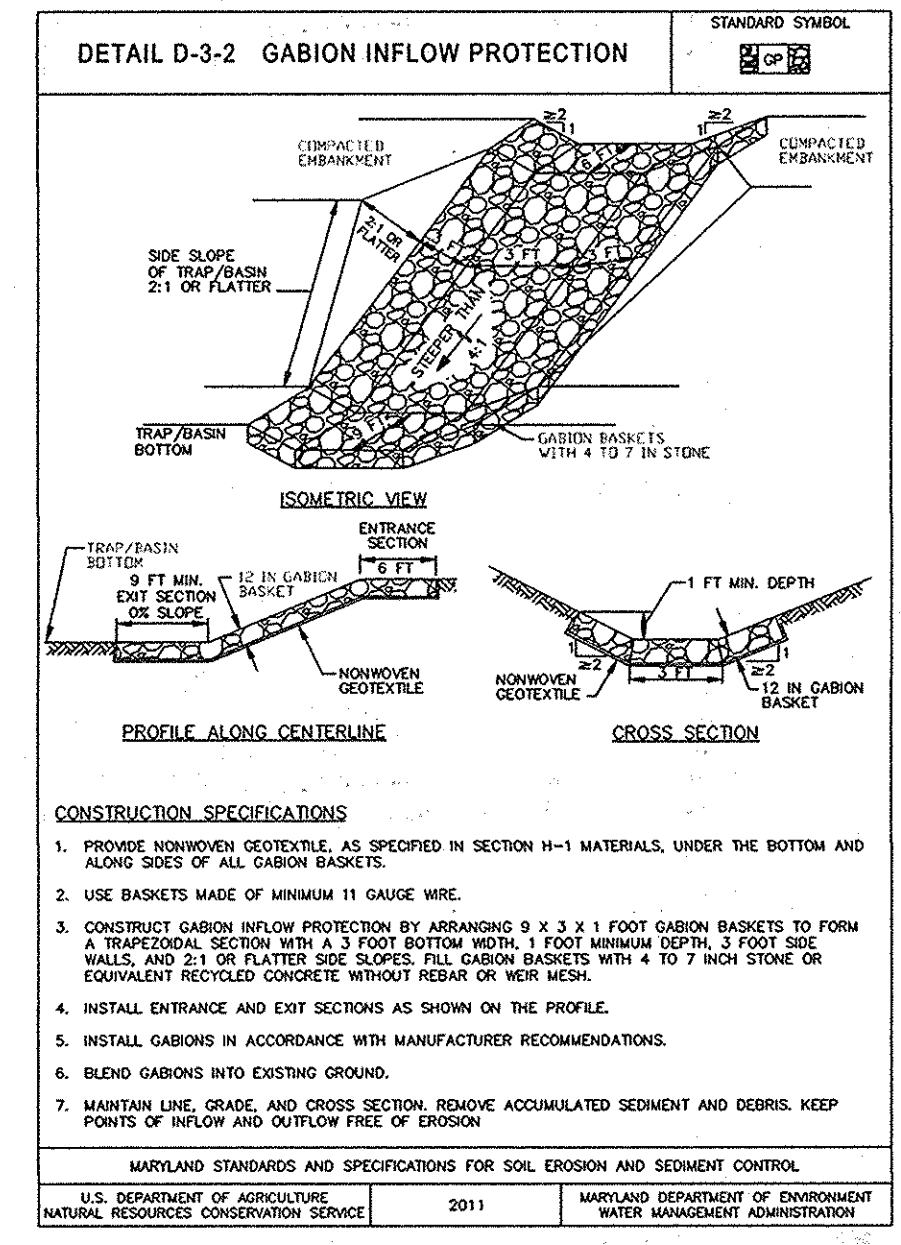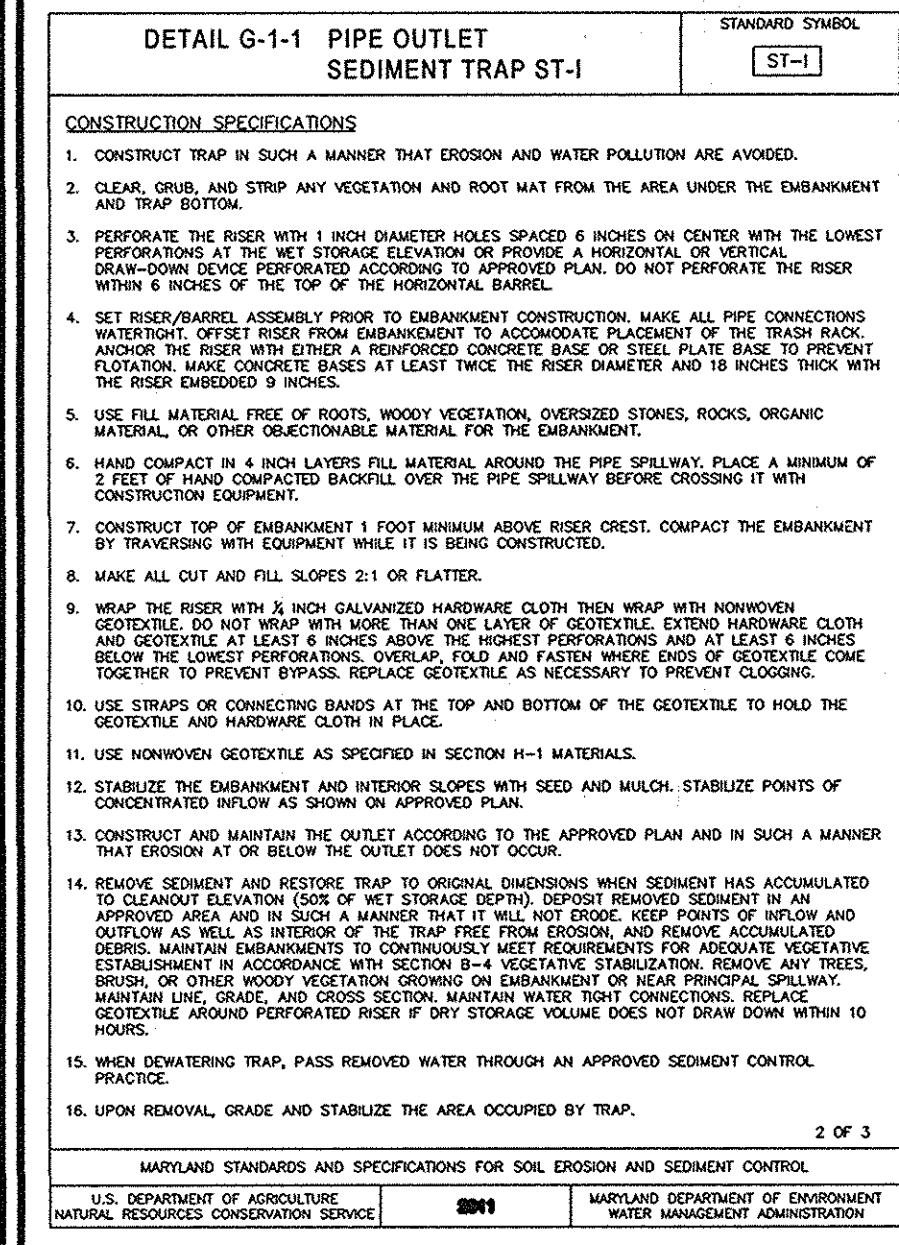

SEQUENCE OF CONSTRUCTION

- OBTAIN GRADING PERMIT. (1 DAY)
 - DEVELOPER / CONTRACTOR SHALL REQUEST A PRE-CONSTRUCTION MEETING WITH THE APPROPRIATE ENFORCEMENT AUTHORITY PRIOR TO BEGINNING CONSTRUCTION. (1 DAY)
 - NOTIFY HOWARD COUNTY BUREAU OF INSPECTORS AND PERMITS (410-313-1880) AT LEAST 24 HOURS BEFORE STARTING ANY WORK. (1 DAY)
- PHASE 1
- THE CONSTRUCTION IS LIMITED TO THE SOUTH WESTERN MOST PORTION OF THE SITE.
- CLEAR AND GRUB FOR THE INSTALLATION OF PERIMETER CONTROLS (1 DAY)
 - INSTALL STABILIZED CONSTRUCTION ENTRANCE AND PERIMETER CONTROLS AS SHOWN HEREON AND STABILIZE DISTURBANCES. (2 DAYS)
 - WITH PERMISSION OF THE SEDIMENT CONTROL INSPECTOR, PROCEED WITH THE INSTALLATION OF OFFSITE DIVERSION STORM DRAIN SYSTEM MH-1 TOWARD MH-3 AND MH-3 TOWARD MH-4. EXISTING STORM DRAIN SYSTEM SHALL REMAIN IN SERVICE UNTIL THE OFFSITE DIVERSION STORM DRAIN SYSTEM INSTALLATION IS COMPLETE. (5 DAYS)
 - TEMPORARILY INSTALL SILT FENCE ALONG THE EXISTING HOME # 10113. THIS STRUCTURE SHALL BE RAZED AT THIS TIME. THE REMOVAL OF THE EXISTING STORM DRAIN SYSTEM CAN BE COMPLETED, MH-2 THROUGH MH-4 JUST SOUTH OF FREDERICK ROAD. (5 DAYS)
- NOTE: EXISTING STORM DRAIN SYSTEM SHALL REMAIN IN SERVICE UNTIL THE OFFSITE DIVERSION STORM DRAIN SYSTEM INSTALLATION IS COMPLETE. THIS REALIGNMENT SHALL BE COMPLETED FROM ITS EXISTING LOCATION TO THE PROPOSED LOCATION PRIOR TO MOVING ON TO THE PHASE 2 WORK. AFTER OBTAINING PERMISSION FROM THE SEDIMENT CONTROL INSPECTOR TO PROCEED TO PHASE 2
- PHASE 2
- WITH FREDERICK ROAD STORM DRAIN DIVERSION IN PLACE AND FUNCTIONING, CLEAR & GRUB AREA COMMON TO THE SEDIMENT TRAP. (5 DAYS)
 - REMOVE EXISTING MANHOLE NEAR MH-1 AND INSTALL STORM DRAIN SYSTEMS MH-1 TO MH-5 AND MH-5 TO MH-6, WITH TRAP COMPLETE, INSTALL TEMPORARY DIVERSION PIPE INTO SEDIMENT TRAP FROM MH-6. (5 DAYS)
 - COMPLETE CONSTRUCTION OF SEDIMENT TRAP PER THE DETAILS AND SPECIFICATIONS SHOWN HEREON AND EARTH Dikes CONVEYING RUNOFF TO THE TRAP. EXCAVATED MATERIAL SHALL BE STOCKPILED OR USED AS FILL MATERIAL. PER THE OVERALL SITE GRADING PROFILES, TRAP PIPE OUTLET SHALL BE CONNECTED AND OUTFALL INTO BYPASS STORM DRAIN VIA MH-5. (5 DAYS)
- NOTE: WITH THE OFFSITE DIVERSION STORM DRAIN SYSTEM IN PLACE THE REMAINING PORTIONS OF THE EXISTING STORM DRAIN, WHICH GOES THROUGH THE TRAP LOCATION, CAN BE REMOVED.
- STABILIZE STABILIZE THE DISTURBED AREAS FROM THE AFORESAID DISTURBANCES WITH TEMPORARY SEEDING MIXTURE AND STRAW MULCH. (1 DAY)
 - THE SEDIMENT SHALL BE REMOVED FROM THE SEDIMENT TRAP WHEN THE CLEANOUT ELEVATION HAS BEEN REACHED. (2 DAYS)
 - THE CONTRACTOR SHALL INSPECT AND PROVIDE NECESSARY MAINTENANCE ON THE SEDIMENT AND EROSION CONTROLS SHOWN HEREON AFTER EACH RAINFALL AND ON A DAILY BASIS. (1 DAY)
 - THE SEDIMENT TRAP SHALL BE Dewatered BY PUMPING. THE ACCUMULATED SEDIMENT FROM THE TRAPS SHALL BE PLACED UP GRADE FROM THE STRUCTURE IN SUCH A MANNER AS NOT TO INTERFERE WITH CONSTRUCTION OPERATIONS OR CAUSE EROSION DOWN GRADE FROM THE STRUCTURE. (2 DAYS)
 - AFTER OBTAINING PERMISSION FROM THE SEDIMENT CONTROL INSPECTOR TO PROCEED WITH THE REMOVAL OF THE REMAINING EXISTING HOMES AND GRADE THE SITE WITHIN THE INSTALLED PERIMETER CONTROLS, BRINGING SITE TO SUBGRADE ELEVATIONS AND COMPACTED FILLS FOR PROPOSED BUILDING CONSTRUCTION. (2 WEEKS)
 - STABILIZE AREAS PLACED TO FINAL GRADE WITH PERMANENT SEEDING MIXTURE AND STRAW MULCH OR AS DIRECTED BY THE SEDIMENT CONTROL INSPECTOR. (2 DAYS)
 - COMPLETE INSTALLATION OF STORM DRAIN SYSTEM & WATER AND SEWER UTILITY EXTENSIONS. (2 WEEKS)
 - INSTALL INLET PROTECTION AS SHOWN HEREON OR AS DIRECTED BY THE SEDIMENT CONTROL INSPECTOR. (1 DAY)
 - OBTAIN PERMISSION FROM THE SEDIMENT CONTROL INSPECTOR TO PROCEED. (1 DAY)
 - INSTALL PERMANENT SURFACE PARKING AREA "CURBING", STONE RESERVOIR, STONE SUBBASE AND ASSOCIATED UNDERDRAIN. (5 DAYS)
 - INSTALL REMAINING PARKING LOT CURB AND GUTTER AND GRADE FOR PAVED AREAS. (5 DAYS)
 - INSTALL BASE COURSE PAVEMENT. (1 DAY)
 - INSTALL SIDEWALK. (5 DAYS)
 - INSTALL LANDSCAPING. (5 DAYS)
 - WITH BUILDING CONSTRUCTION COMPLETE, INSTALL SURFACE COURSE PAVEMENT. (1 DAY)
 - WITH CONTRIBUTE AREA STABILIZED WITH A 2" STAND OF GRASS, CONSTRUCT MICRO-BIOS TO RECEIVE RUNOFF PER SHEET DRAINAGE AREAS. (5 DAYS)
 - UPON COMPLETION OF MICROBIOPRETENTION FACILITIES, IMMEDIATELY STABILIZE PERMANENT SEEDING MIXTURE AND STRAW MULCH AND INSTALL REQUIRED LANDSCAPING. (1 DAY)
 - COMPLETE ANY REMAINING FINE GRADING WITHIN THE INSTALLED PERIMETER CONTROLS AND STABILIZE WITH PERMANENT SEEDING MIXTURE AND STRAW MULCH. (5 DAYS)
 - UPON STABILIZATION OF ALL DISTURBED AREAS AND WITH THE APPROVAL OF THE SEDIMENT CONTROL INSPECTOR, REMOVE ALL SEDIMENT CONTROL DEVICES AND STABILIZE DISTURBANCES WITH PERMANENT SEEDING MIXTURE AND STRAW MULCH.
- NOTE: ANY CHANGES OR REVISIONS TO THE SEQUENCE OF CONSTRUCTION MUST BE REVIEWED AND APPROVED BY THE PLAN APPROVAL AUTHORITY PRIOR TO PROCEEDING WITH CONSTRUCTION.

BY THE DEVELOPER:

I/WE CERTIFY THAT ALL DEVELOPMENT AND CONSTRUCTION WILL BE DONE ACCORDING TO THIS PLAN AND EROSION AND SEDIMENT CONTROL AND THAT ALL RESPONSIBLE PERSONNEL INVOLVED IN THE CONSTRUCTION PROJECT WILL HAVE A CERTIFICATE OF ATTENDANCE AT A DEPARTMENT OF ENVIRONMENT APPROVED TRAINING PROGRAM FOR THE CONTROL OF SEDIMENT AND EROSION BEFORE BEGINNING THE PROJECT. I ALSO AUTHORIZE PERIODIC ON-SITE INSPECTION BY THE HOWARD SOIL CONSERVATION DISTRICT.

John Robertson 5/18/15
SIGNATURE OF DEVELOPER

BY THE ENGINEER:

I CERTIFY THAT THIS PLAN FOR EROSION AND SEDIMENT CONTROL REPRESENTS A PRACTICAL AND WORKABLE PLAN BASED ON MY PERSONAL KNOWLEDGE OF THE SITE CONDITIONS, AND THAT IT WAS PREPARED IN ACCORDANCE WITH THE REQUIREMENTS OF THE HOWARD SOIL CONSERVATION DISTRICT.

John Robertson 5/18/15
SIGNATURE OF ENGINEER



THIS DEVELOPMENT PLAN IS APPROVED FOR SOIL EROSION AND SEDIMENT CONTROL BY THE HOWARD SOIL CONSERVATION DISTRICT.

APPROVED: HOWARD COUNTY DEPARTMENT OF PLANNING AND ZONING

John Robertson 6/2/15
DATE

APPROVED JULY 17, 2014
PLANNING BOARD OF HOWARD COUNTY

DATE: 6-8-15
DATE: 7-07-15
DATE: 7-7-15

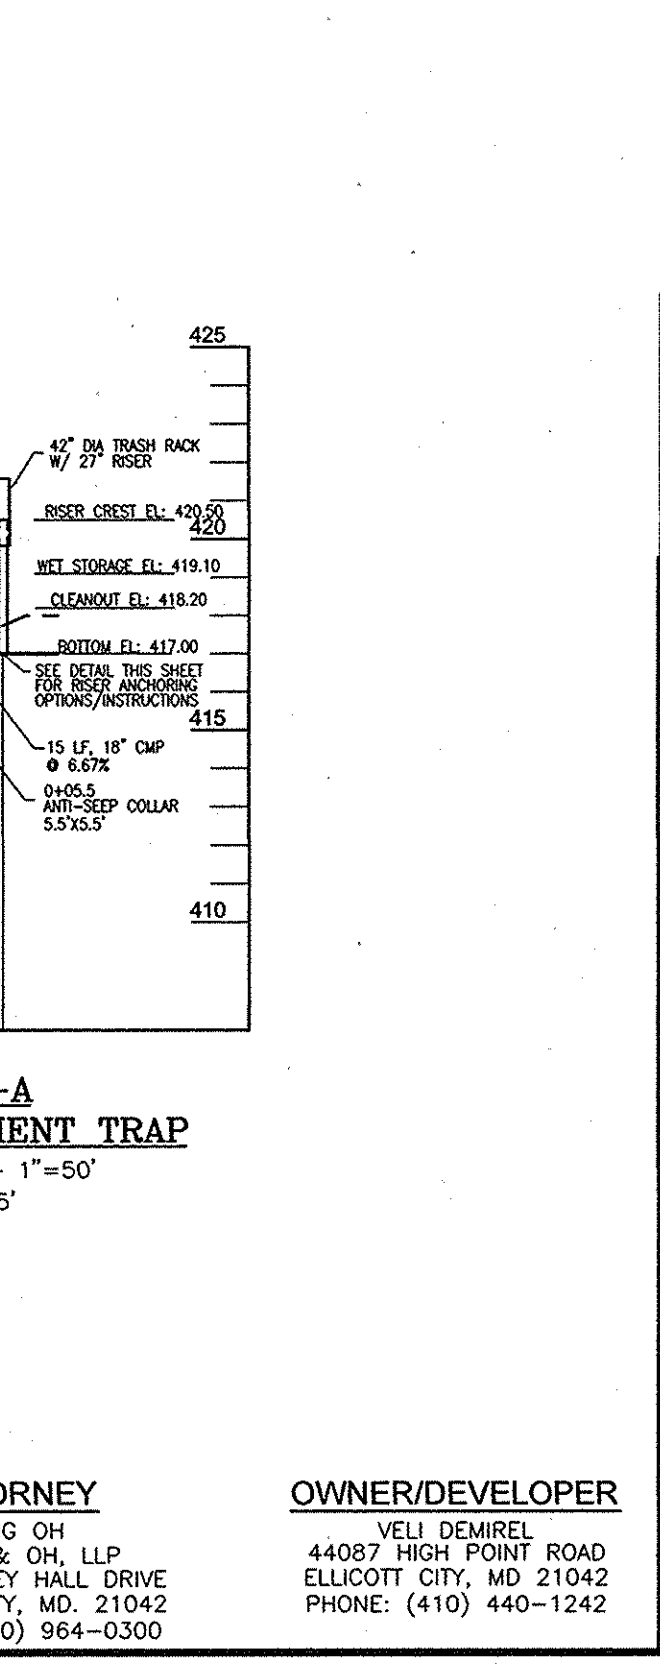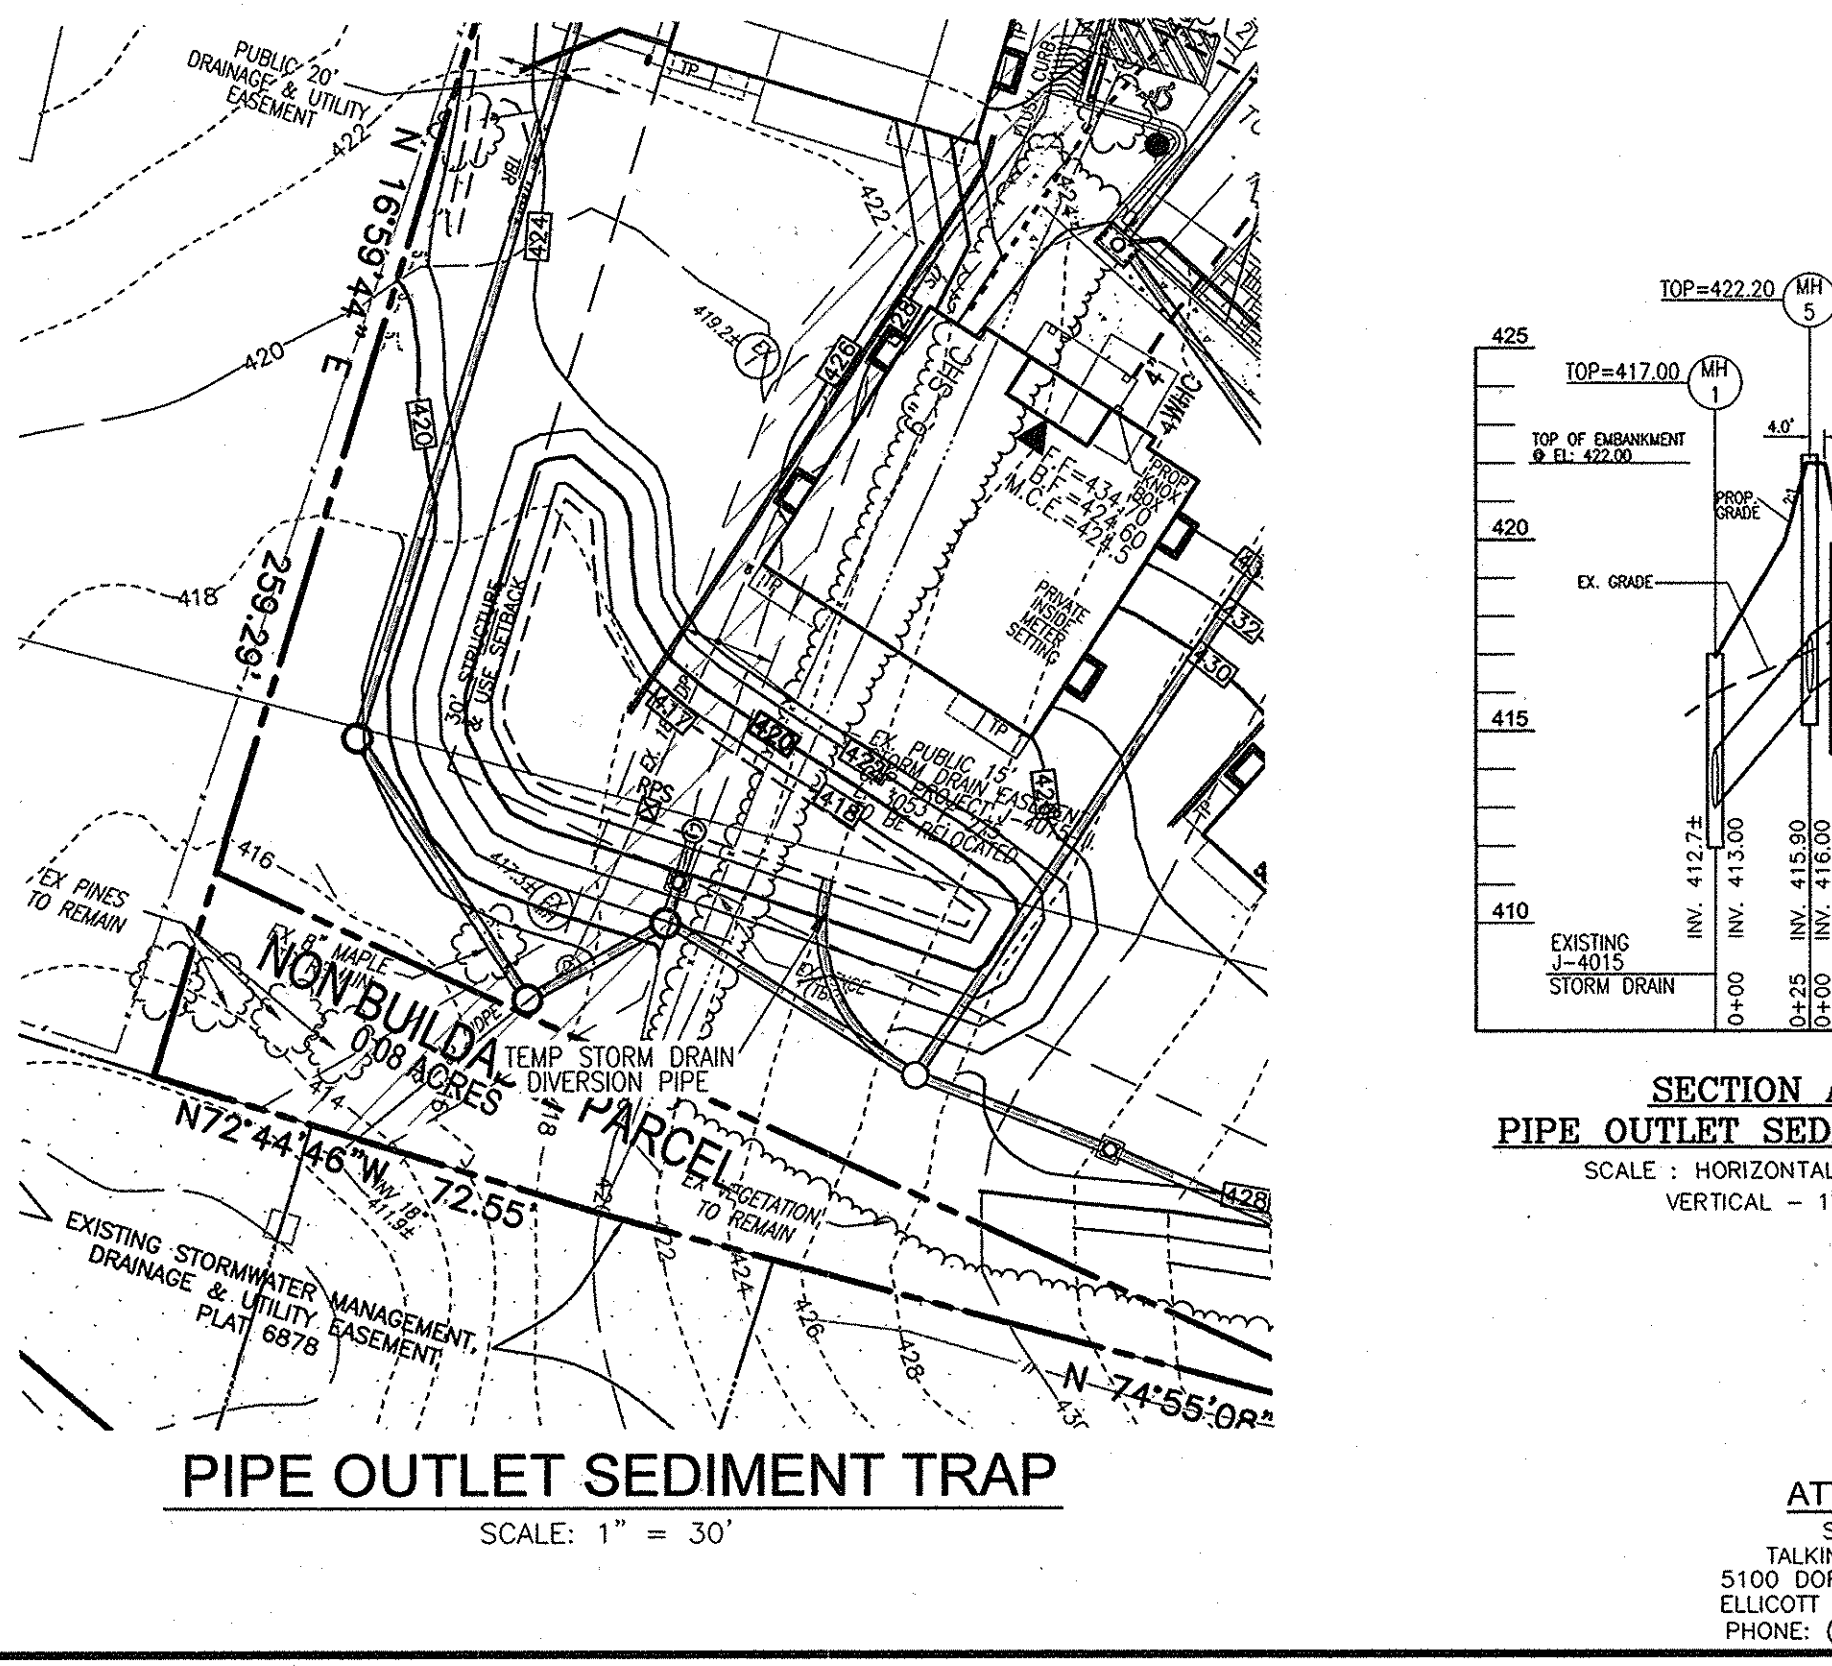

NO. _____ REVISION _____ DATE _____

**SITE DEVELOPMENT PLAN
GRADING AND SOIL EROSION,
AND SEDIMENT CONTROL PLAN - DETAILS**

DEMIREL PLAZA
L15087 F345

2ND ELECTION DISTRICT
TAX MAP 24 GRID: 1

ZONED: OF
PARCELS 62, 63 AND P/O 544 (LOT 112)
HOWARD COUNTY, MARYLAND

**ROBERT H. VOGEL
ENGINEERING, INC.**
ENGINEERS • SURVEYORS • PLANNERS

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ELLCOTT CITY, MD 21043
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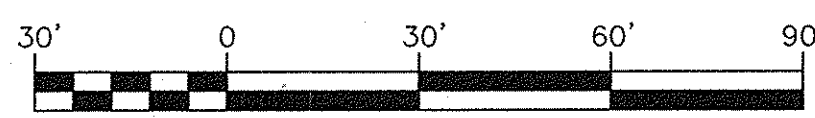
DESIGN BY: EDS.
DRAWN BY: RVE.
CHECKED BY: RAV.
DATE: MAY 2015
SCALE: AS SHOWN
W.O. NO.: 11-01

PROFESSIONAL CERTIFICATE
I HEREBY CERTIFY THAT THESE DOCUMENTS WERE PREPARED OR APPROVED BY ME, AND THAT I AM A DAILY LICENSED PROFESSIONAL ENGINEER UNDER THE LAWS OF THE STATE OF MARYLAND, LICENSE NO. 1853, EXPIRATION DATE: 09-27-2016

7 SHEET OF 15

DRAINAGE AREA MAP

SCALE: 1"=30'



MAPPED SOILS TYPES - ELLICOTT CITY SW MAP #13									
SYMBOL	NAME / DESCRIPTION	GROUP	HYDRIC	PERCENT	K-FACTOR	PERCENT	PERCENT	PERCENT	PERCENT
GhB	GLENELG-URBAN LAND COMPLEX, 0 TO 8 PERCENT SLOPES								


TAKEN FROM: USDA, SCS-WEB SOIL SURVEY, HOWARD COUNTY
K-FACTOR = Kw @ 0-4" DEPTH

NOTE:
HIGHLY ERODIBLE SOILS ARE THOSE SOILS WITH A SLOPE GREATER THAN 15 PERCENT OR THOSE SOILS WITH A SOIL ERODIBILITY FACTOR K GREATER THAN 0.35 AND WITH A SLOPE GREATER THAN 5 PERCENT

LEGEND

- PROPERTY LINE
- RIGHT-OF-WAY LINE
- ADJACENT PROPERTY LINE
- EXISTING CONTOUR
- PROPOSED CONTOUR
- PROPOSED SPOT ELEVATION
- EXISTING UTILITY POLE
- EXISTING LIGHT POLE
- EXISTING MAILBOX
- EXISTING SIGN
- EXISTING SANITARY MANHOLE
- EXISTING SANITARY LINE
- EXISTING FIRE HYDRANT
- EXISTING WATER LINE
- PROPOSED STORM DRAIN
- PROPOSED STORM DRAIN INLETS
- EXISTING TREE LINE
- SOILS BOUNDARY
- DRAINAGE DIVIDE

DRAINAGE AREA ZONING
C' FACTOR AREA % IMPERVIOUS

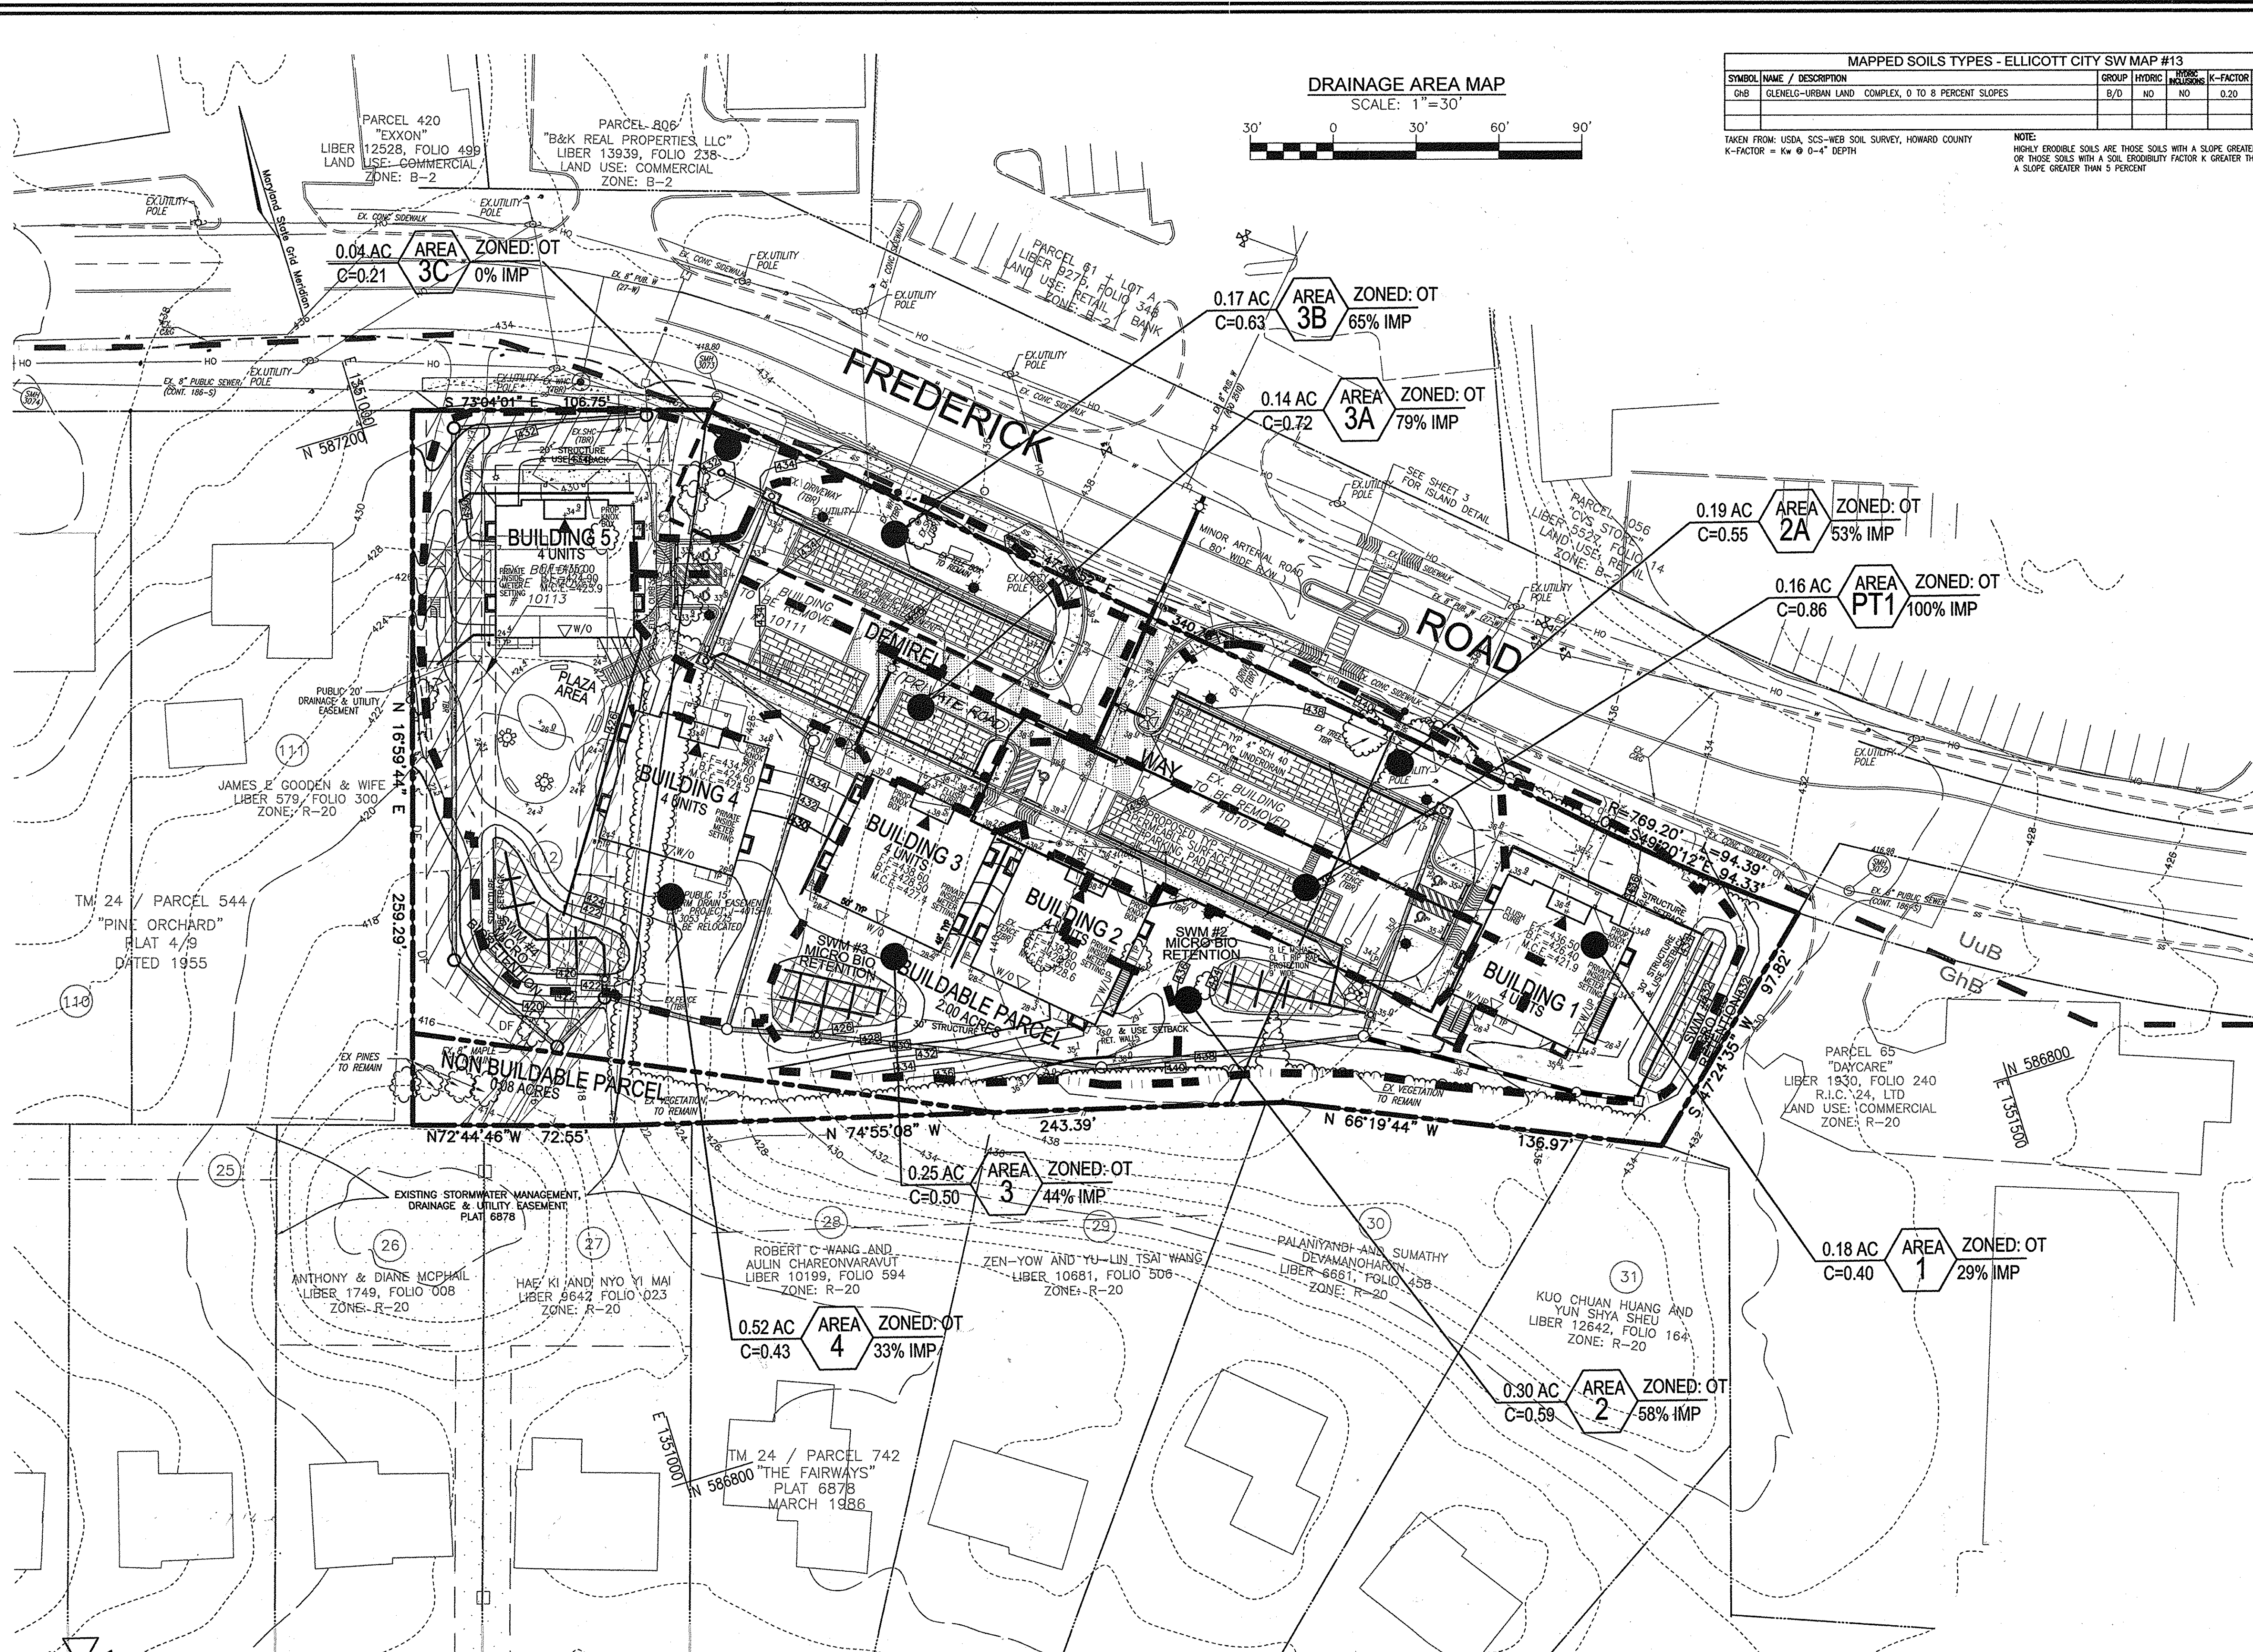

NOTES:
1. WORST CASE 5 MIN. TC ASSUMED THROUGHOUT DESIGN.

NO.	REVISION	DATE
1	REVISE STORM DRAIN AND SHG TO BUILDING 1	12-9-15

SITE DEVELOPMENT PLAN
STORM DRAIN
DRAINAGE AREA MAP
DEMIREL PLAZA
L18837 F.345

2ND ELECTION DISTRICT TAX MAP: 24 GRID: 1 PARCELS 62, 63 AND P/O 544 (LOT 112) HOWARD COUNTY, MARYLAND

ROBERT H. VOGEL ENGINEERING, INC.
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DESIGN BY: EDS
DRAWN BY: RVE
CHECKED BY: RHY
DATE: MAY 2015
SCALE: AS SHOWN
W.O. NO.: 11-01


8 SHEET OF 15

APPROVED: HOWARD COUNTY DEPARTMENT OF PLANNING AND ZONING
6-8-15
DATE


APPROVED: JULY 17, 2014
PLANNING BOARD OF HOWARD COUNTY

ATTORNEY
SANG OH
TALKIN & OH, LLP
5100 DORSEY HALL DRIVE
ELLICOTT CITY, MD 21042
PHONE: (410) 964-0300


OWNER/DEVELOPER
VELI DEMIREL
44087 HIGH POINT ROAD
ELLICOTT CITY, MD 21042
PHONE: (410) 440-1242

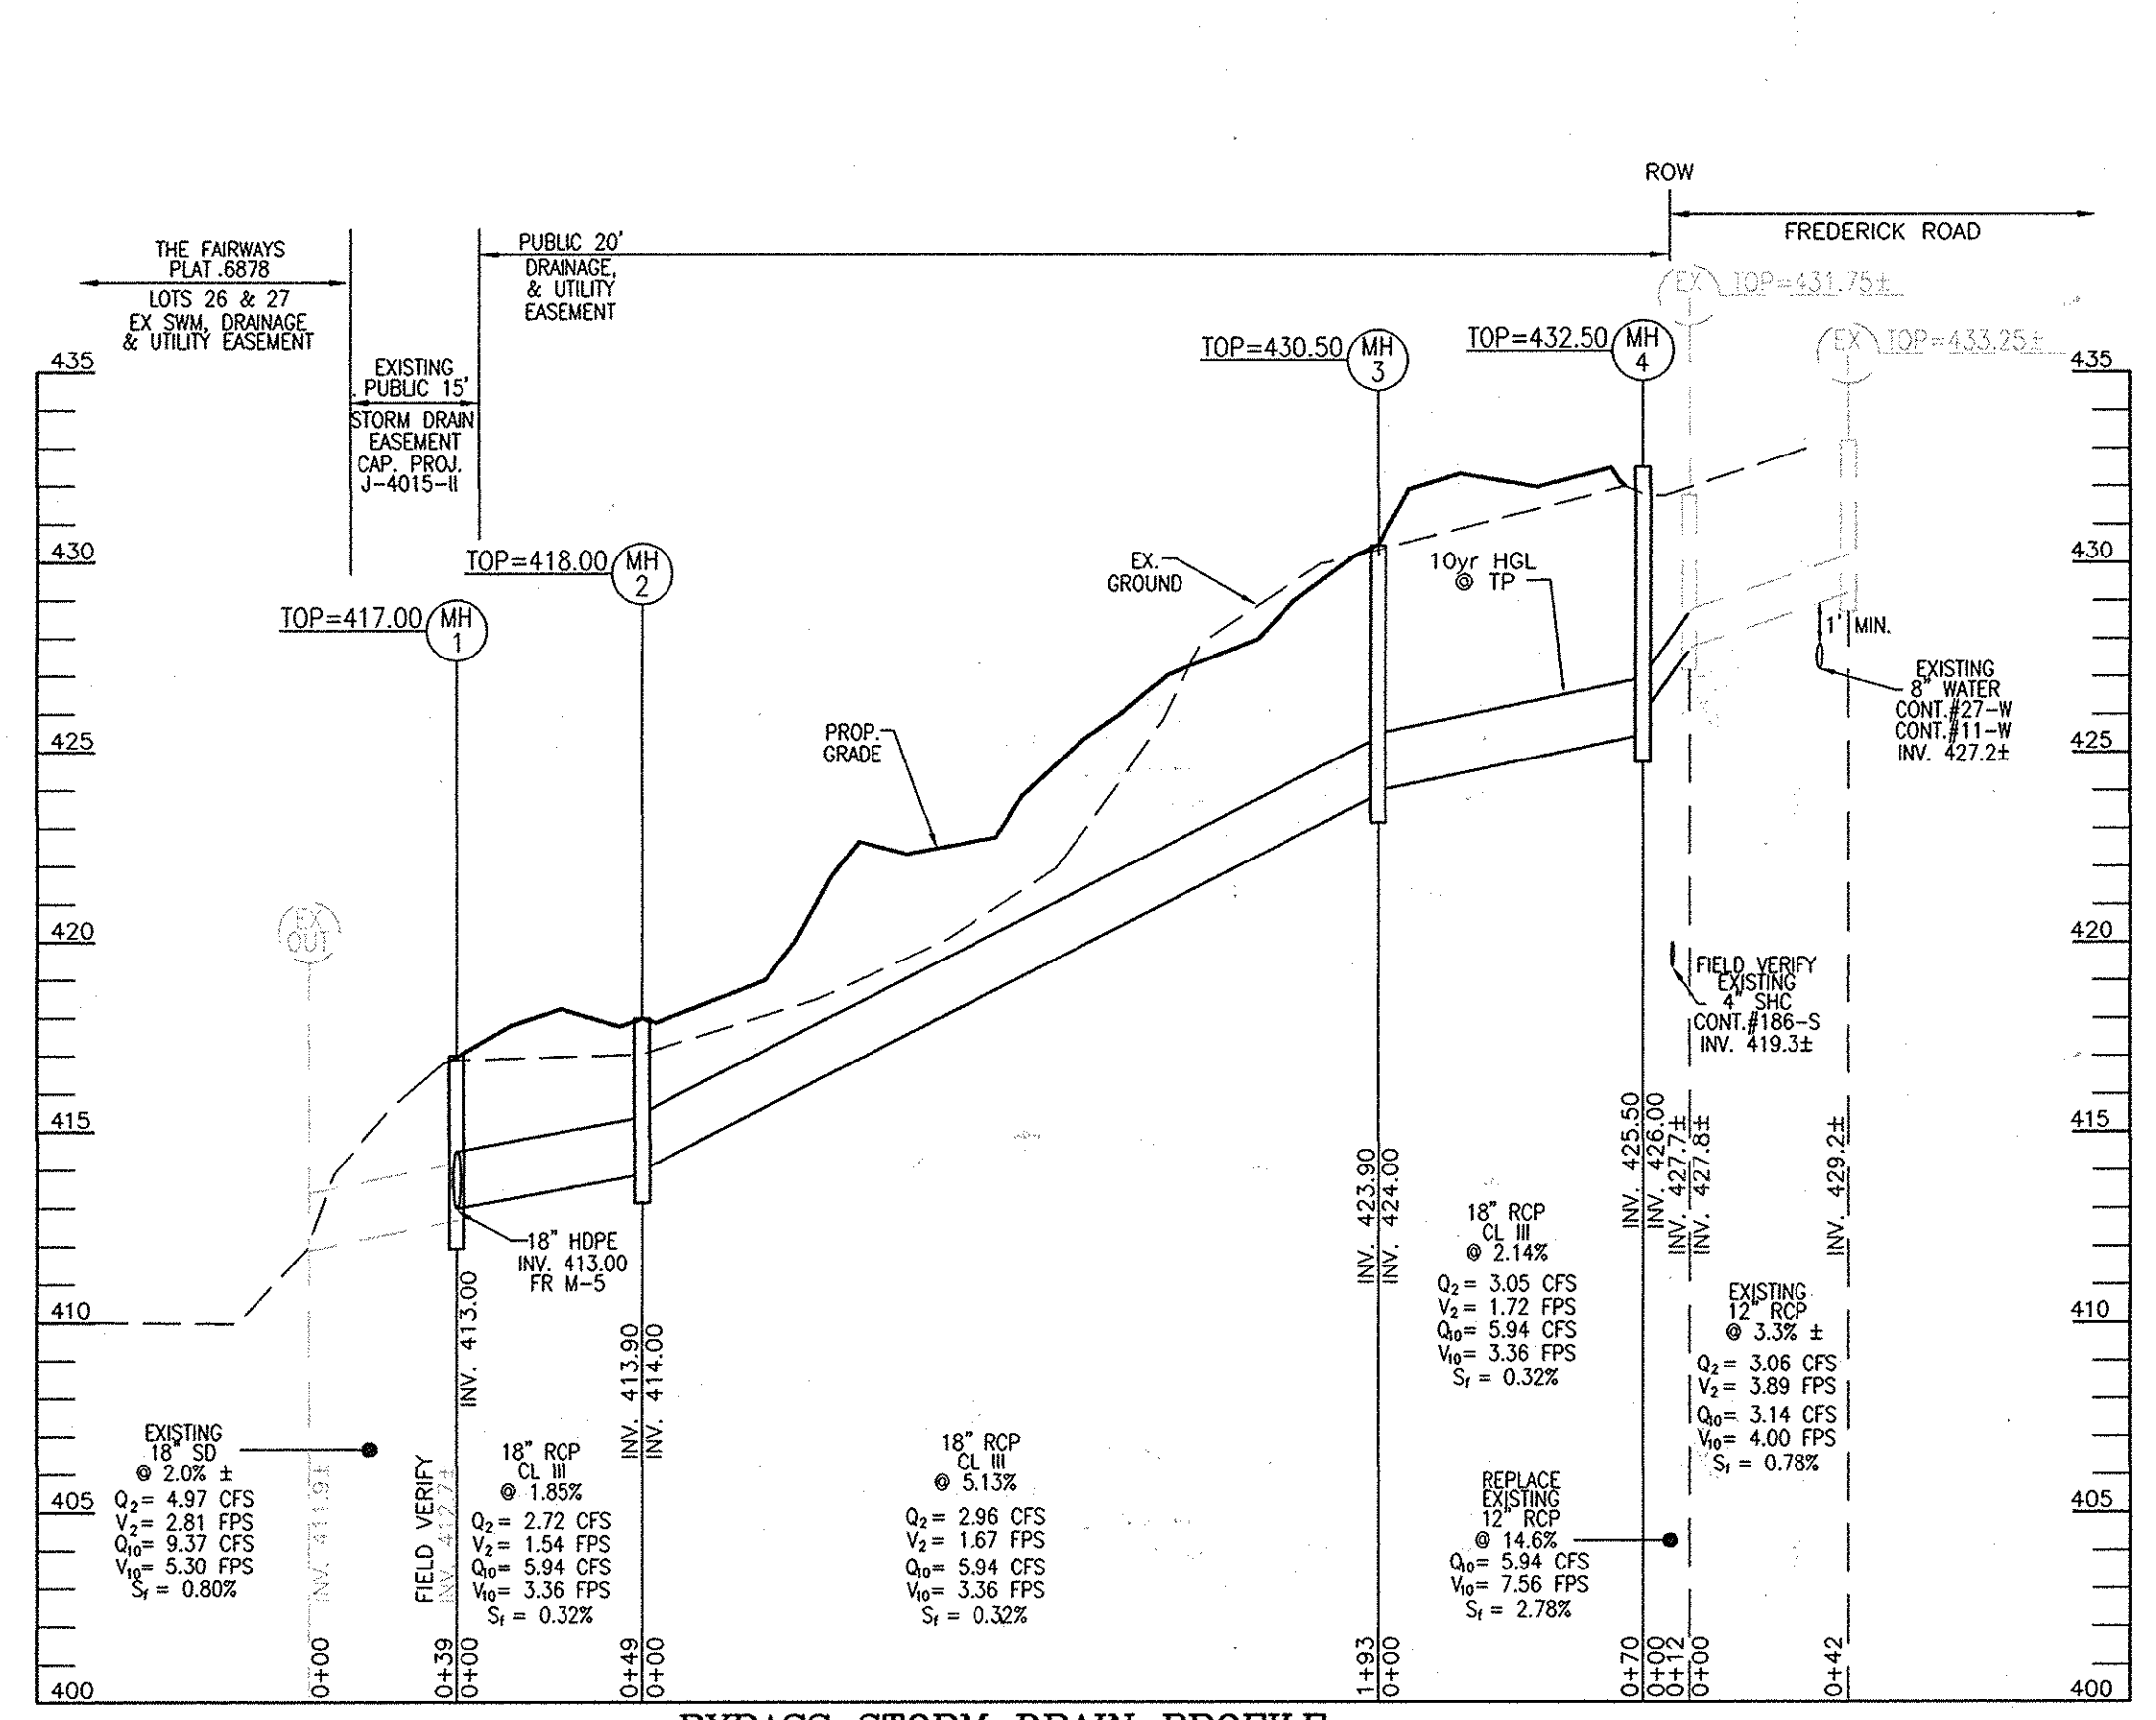

BYPASS STORM DRAIN PROFILE
SCALE: HORIZONTAL - 1"=50'
VERTICAL - 1"=5'

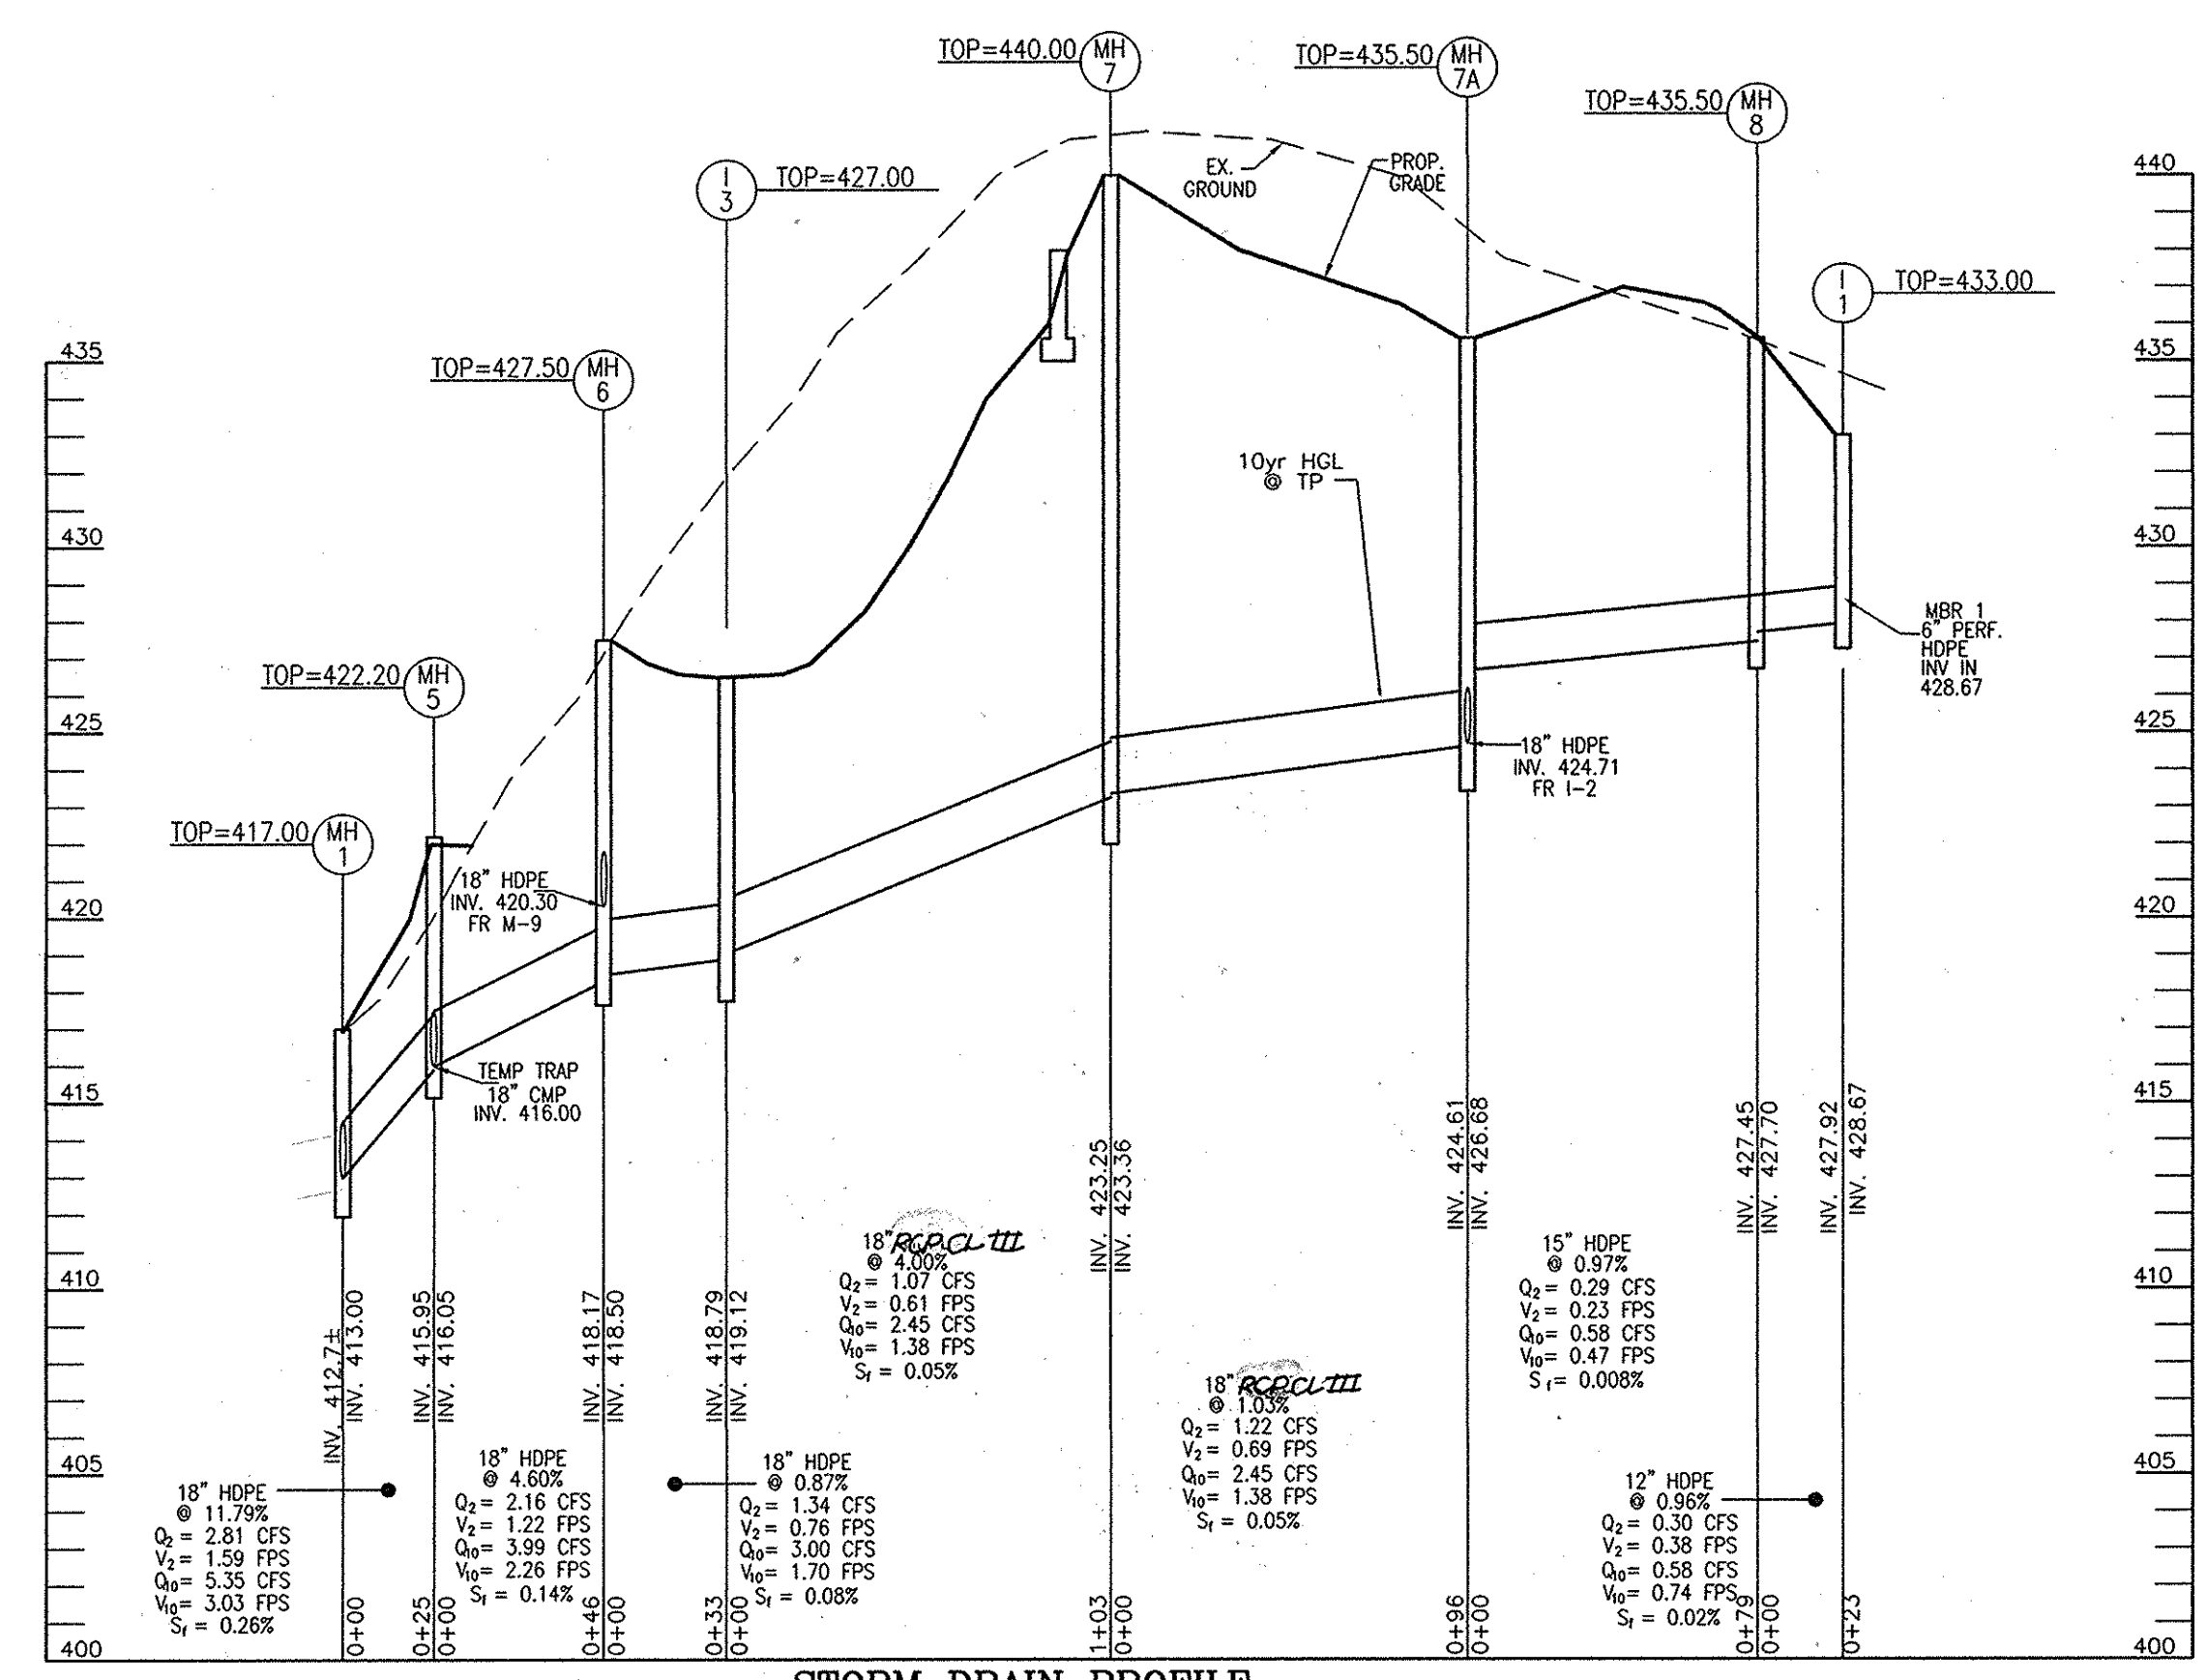


STORM DRAIN PROFILE
SCALE: HORIZONTAL - 1"=50'
VERTICAL - 1"=5'

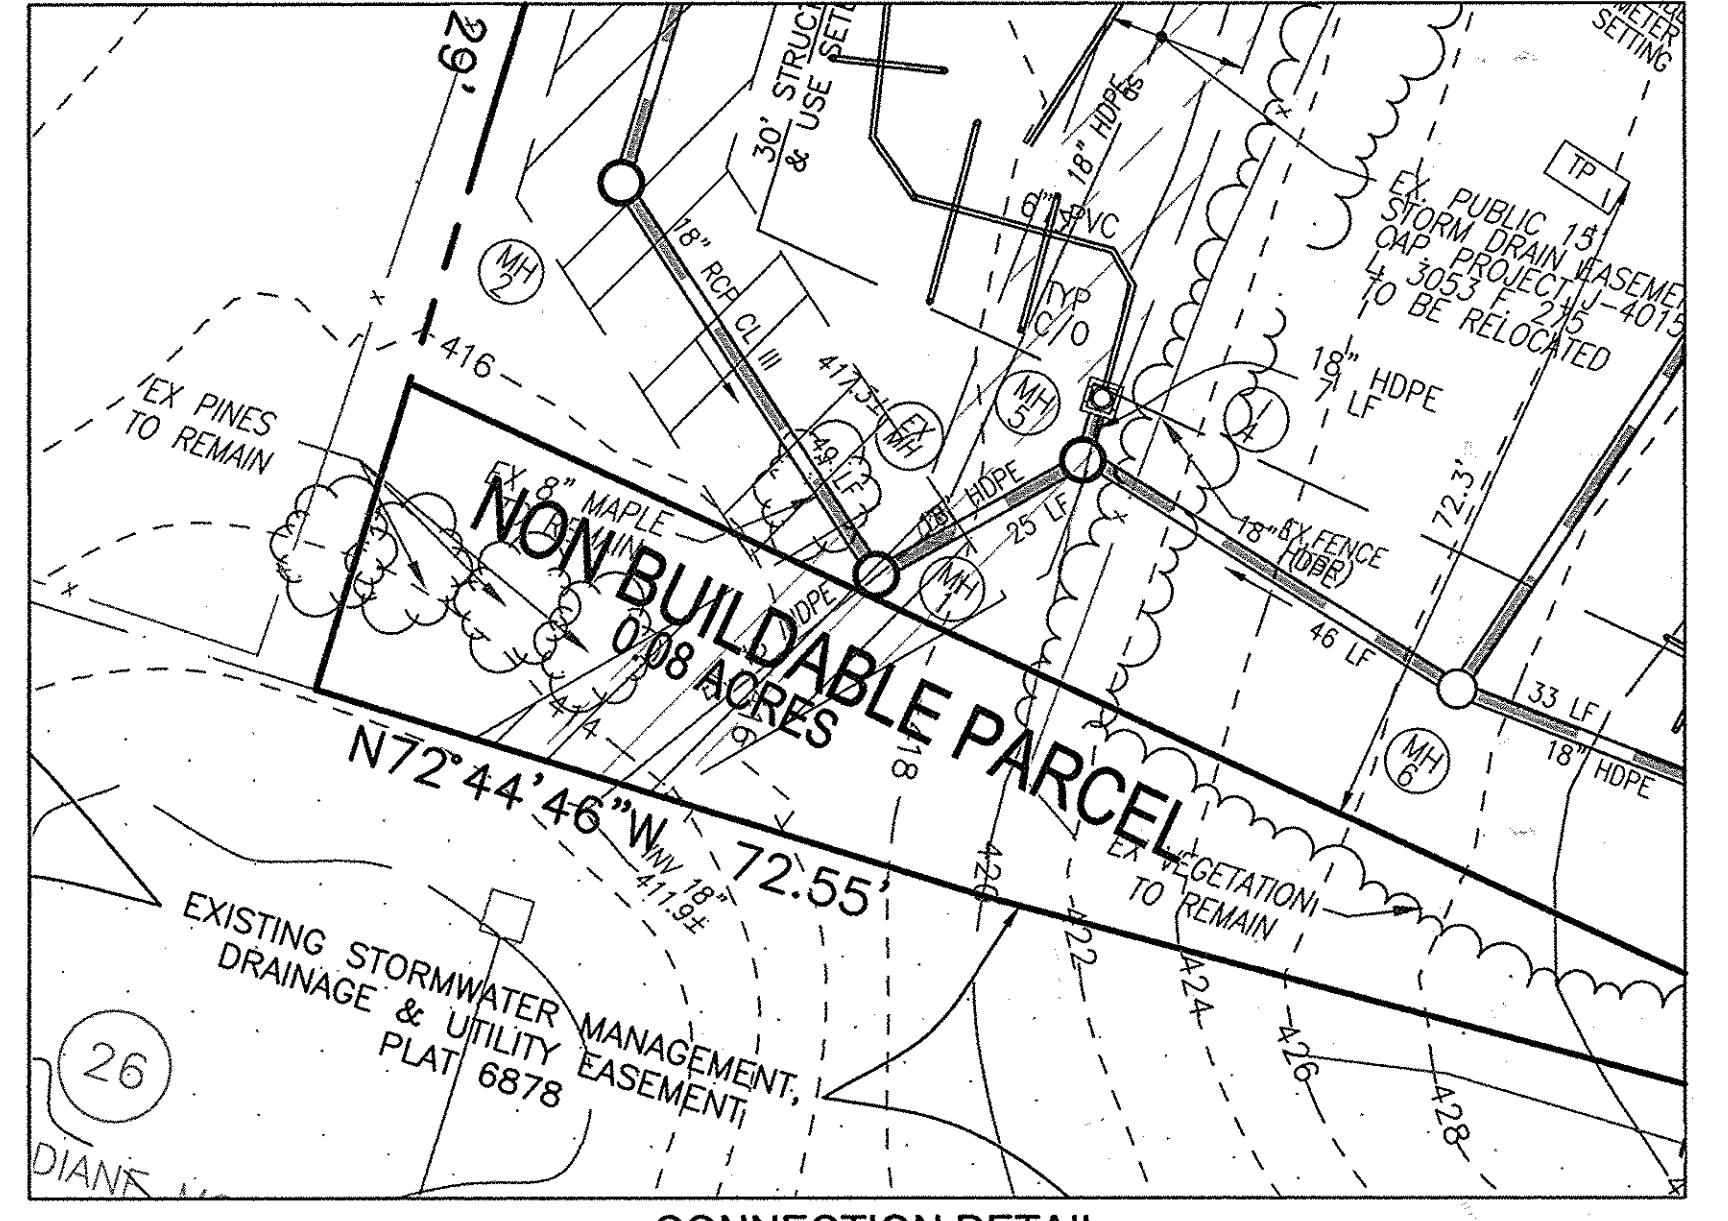


**CONNECTION DETAIL
M-1 TO EX STORM DRAIN**
SCALE: 1"=20'


- NOTES**
- INSTALL OFFSITE DIVERSION STORM DRAIN SYSTEM MH-1 TOWARD MH-3 AND MH-3 TOWARD MH-4. EXISTING STORM DRAIN SYSTEM SHALL REMAIN IN SERVICE UNTIL THE OFFSITE DIVERSION STORM DRAIN SYSTEM INSTALLATION IS COMPLETE.
 - INSTALL SILT FENCE AROUND THE EXISTING HOME # 10113. THIS STRUCTURE SHALL BE RAZED AT THIS TIME. WITH THIS STRUCTURE (#10113) REMOVED, THE REMAINDER OF THE OFFSITE DIVERSION STORM DRAIN SYSTEM CAN BE COMPLETED; MH-2 THROUGH MH-4 JUST SOUTH OF FREDERICK ROAD.

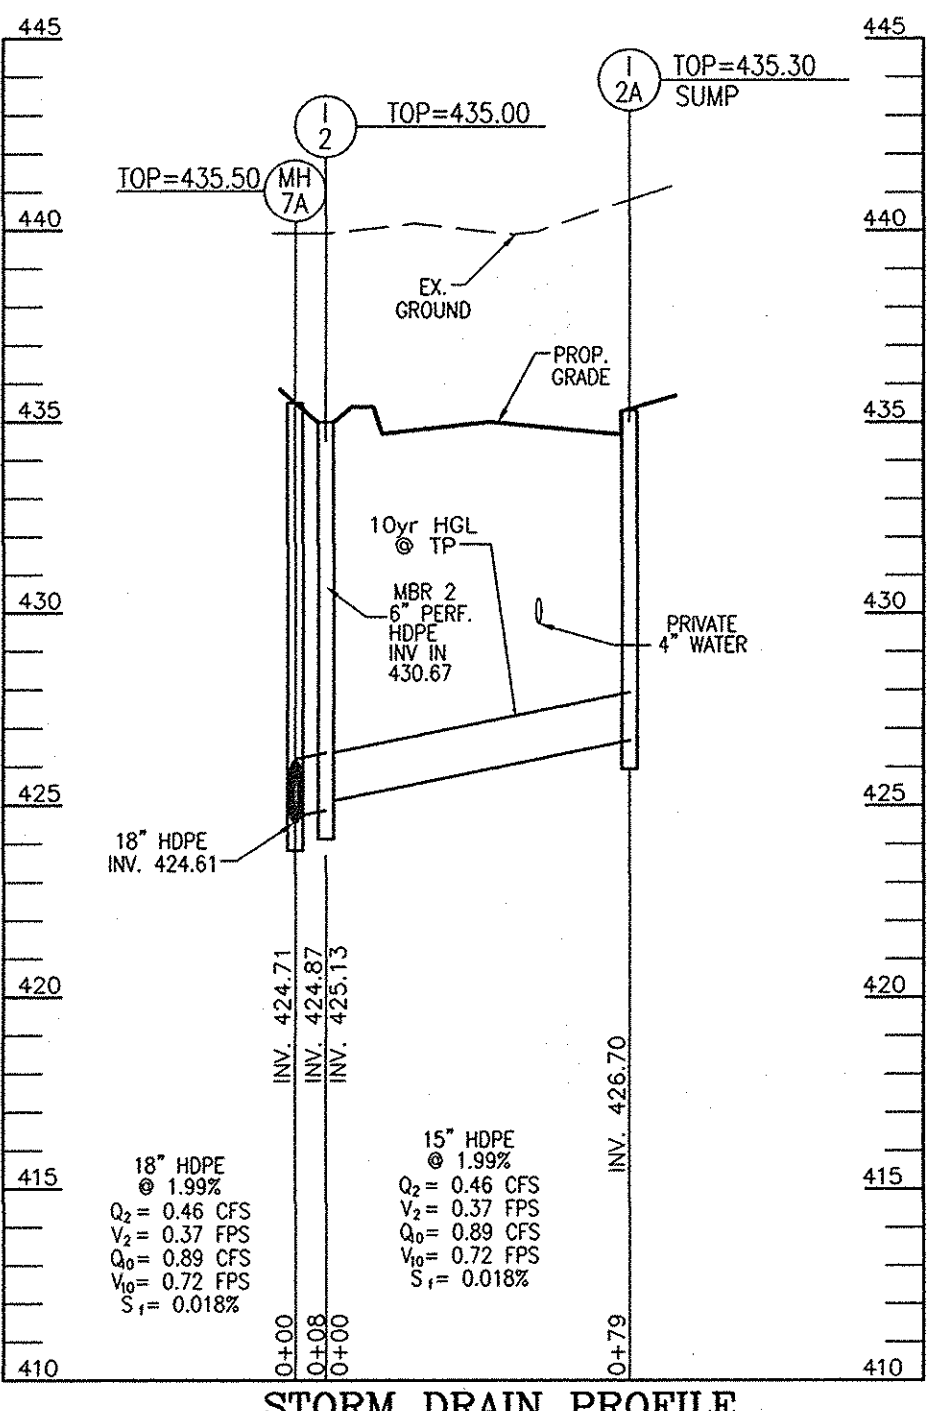


STORM DRAIN PROFILE
SCALE: HORIZONTAL - 1"=50'
VERTICAL - 1"=5'

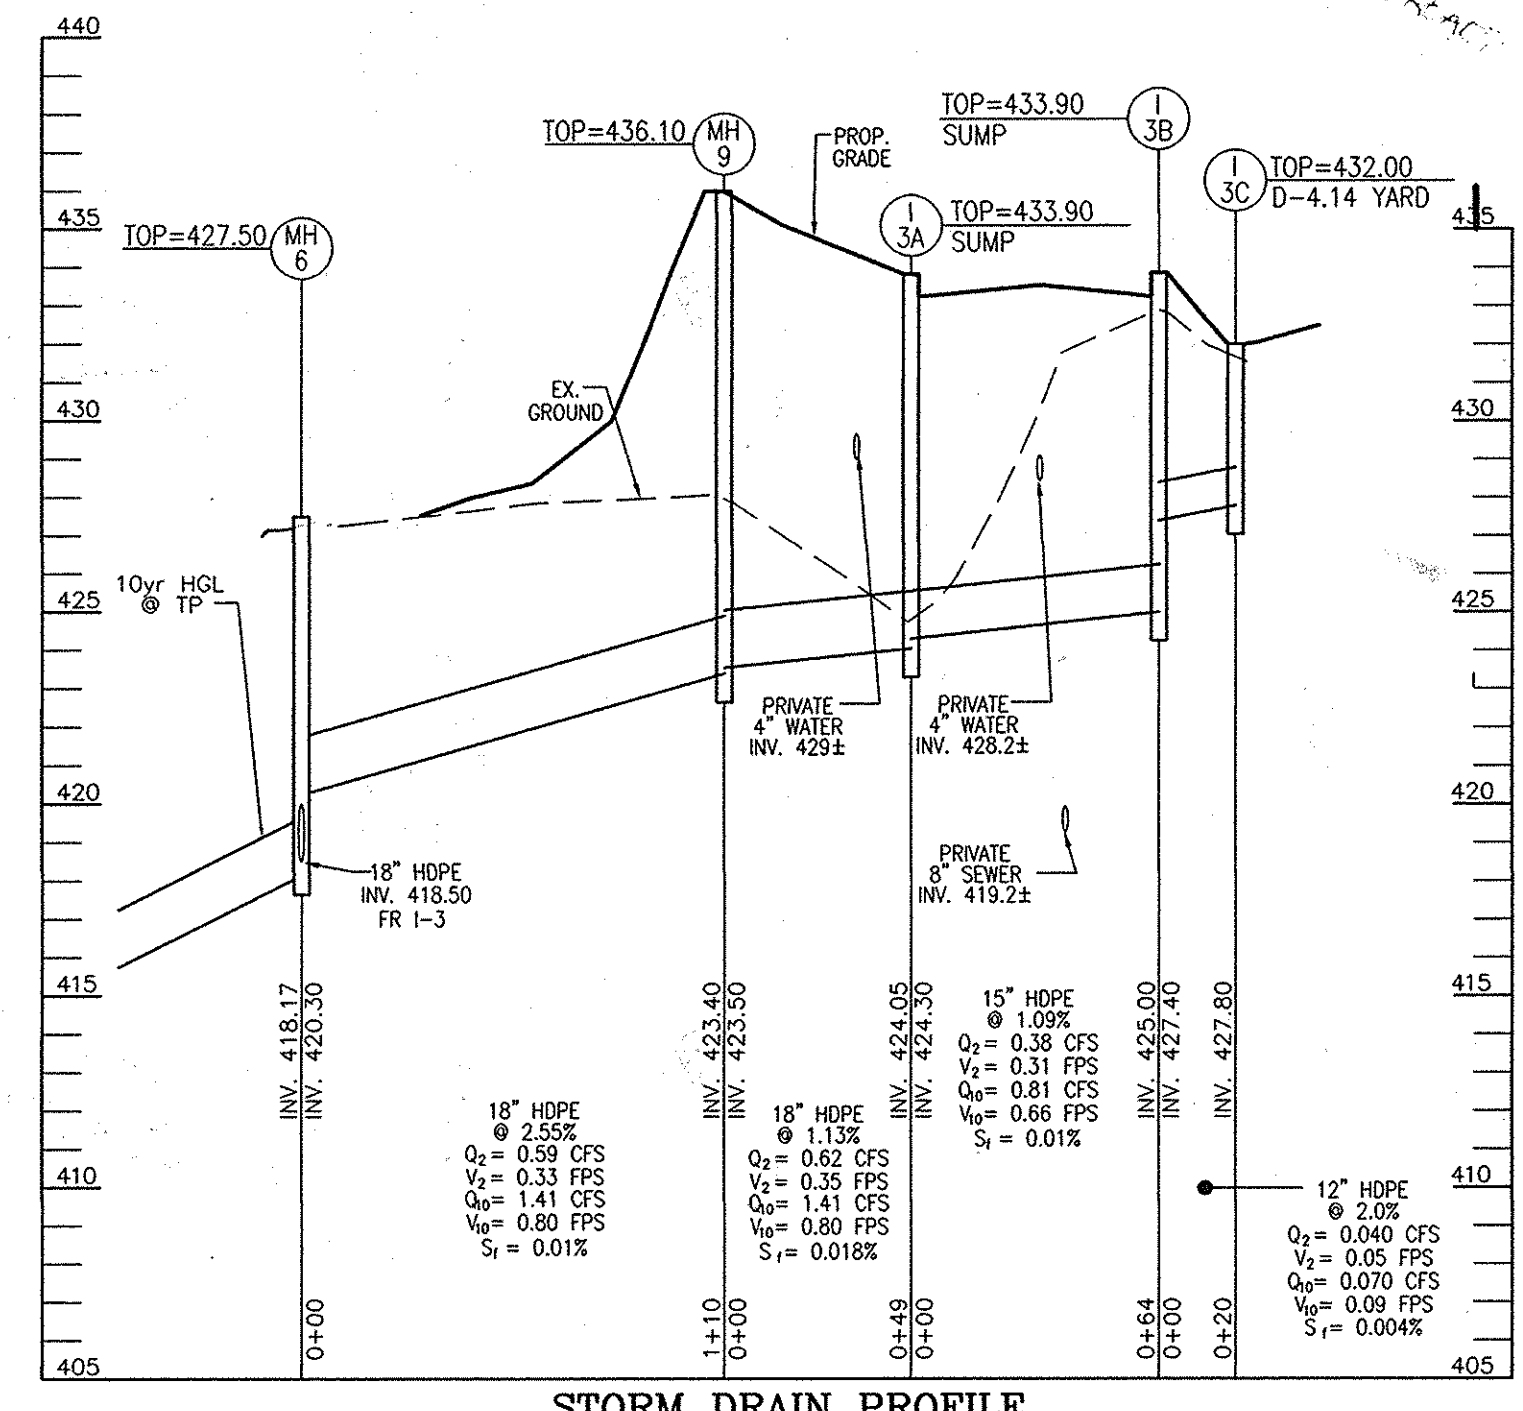

STORM DRAIN PROFILE
SCALE: HORIZONTAL - 1"=50'
VERTICAL - 1"=5'

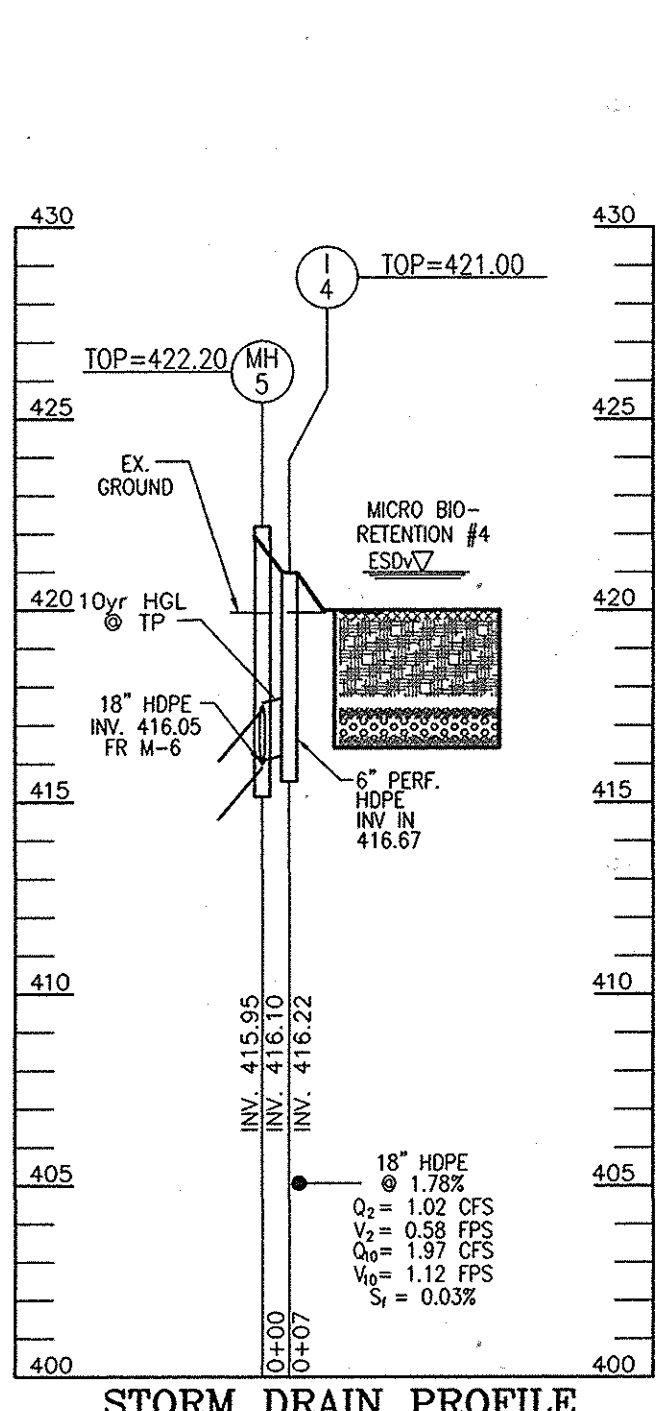

STORM DRAIN PROFILE
SCALE: HORIZONTAL - 1"=50'
VERTICAL - 1"=5'

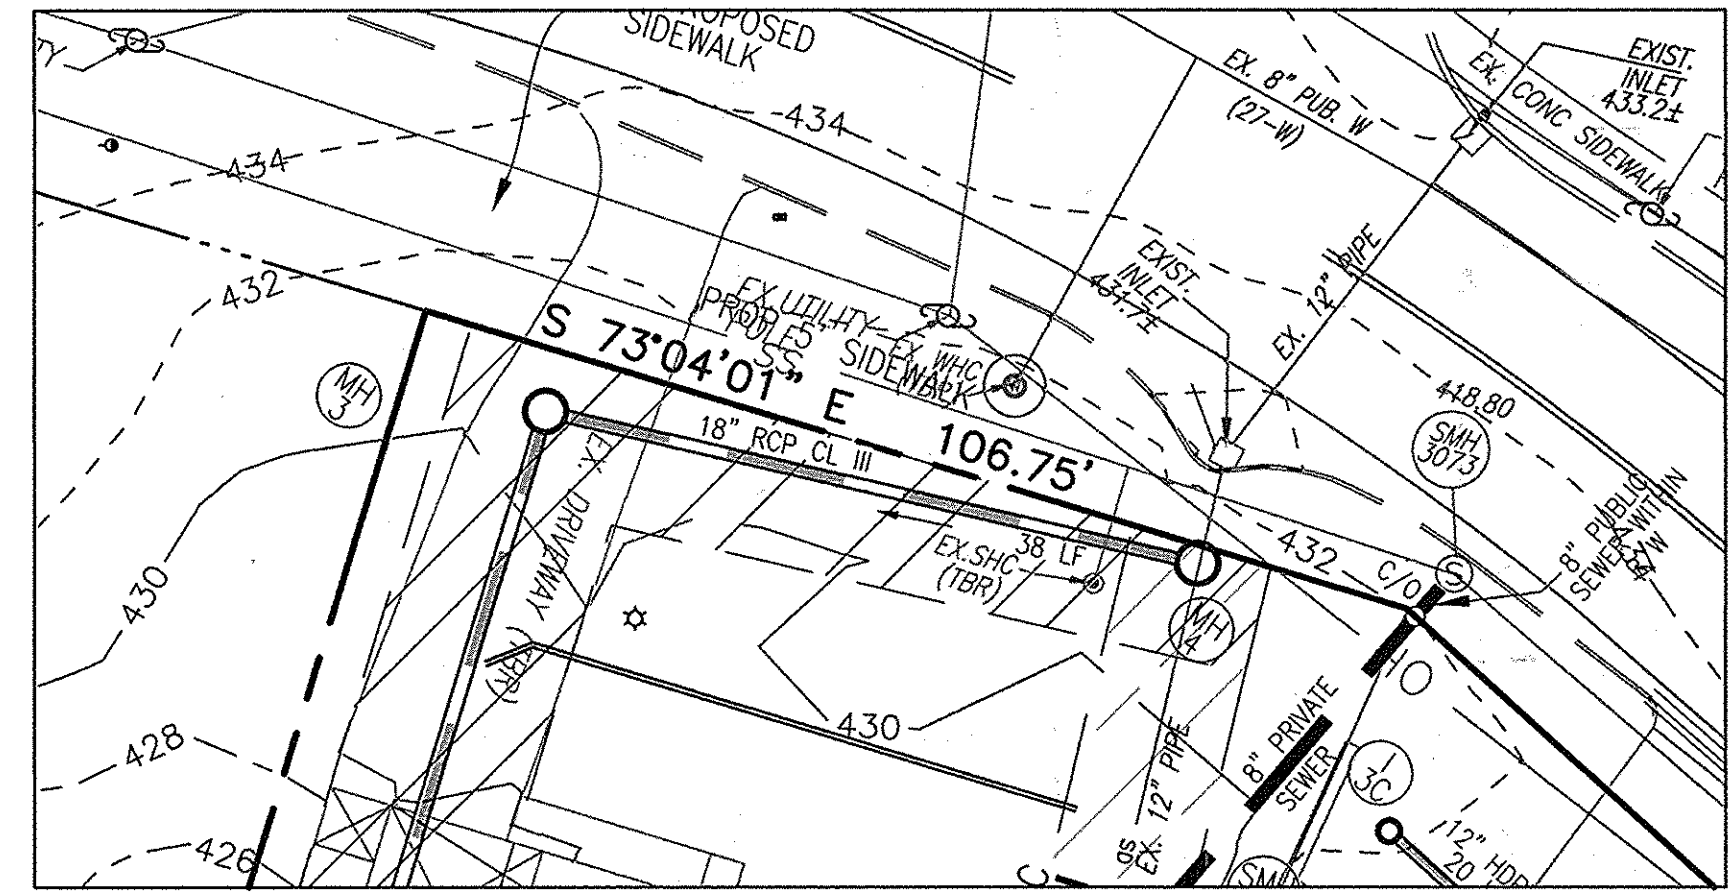

**CONNECTION DETAIL
M-4 TO EX STORM DRAIN**
SCALE: 1"=20'

STRUCTURE SCHEDULE

STR #	TYPE	INV. IN	INV. OUT	TOP ELEV	THROAT ELEV	DETAIL	LOCATION	REMARKS
I-1	S	428.67	427.92	433.00	-	D-4.22	N 586834.4 E 1351370.9	
I-2	S	425.13	424.87	435.00	-	D-4.22	N 586896.5 E 1351266.4	
I-2A	A-S	428.70	435.30	-	-	D-4.01	N 586950.9 E 1351351.7	(1) SLUMP PILEY
I-3	S	419.12	418.79	427.00	-	D-4.22	N 586941.2 E 1351062.7	
I-3A	A-S	424.30	424.05	433.90	-	D-4.01	N 587084.4 E 1351055.4	(1) SLUMP PILEY
I-3B	A-S	427.40	425.00	433.90	-	D-4.01	N 587131.5 E 1351132.8	(1) SLUMP PILEY
I-3C	YARD	427.50	432.00	-	-	D-4.14	N 587146.8 E 1351133.4	(1) SLUMP PILEY
I-4	S	416.67	416.22	421.00	-	D-4.22	N 586963.2 E 1351025.3	
PT-1	FLOW THRU	-	435.30	-	-	MD 374.68	N 586906.4 E 1351291.5	(1) Top L#8' Depth#6'
M-1	48" MH	413.00	412.77	417.00	-	G-5.12	N 586964.9 E 1351001.7	(1)
M-2	48" MH	414.00	413.90	418.00	-	G-5.12	N 587005.7 E 1350975.2	(1)
M-3	48" MH	424.00	423.90	430.50	-	G-5.12	N 587190.5 E 1351031.7	(1)
M-4	48" MH	426.00	425.00	432.50	-	G-5.12	N 587174.8 E 1351089.5	(1)
M-5	48" MH	416.00	415.95	422.00	-	G-5.12	N 587146.8 E 1351133.4	(1)
M-6	48" MH	418.50	418.17	427.50	-	G-5.12	N 586963.2 E 1351025.3	(1)
M-7	48" MH	423.36	423.25	440.00	-	G-5.12	N 586899.9 E 1351187.8	(1)
M-7A	48" MH	424.71	424.68	435.50	-	G-5.12	N 586882.7 E 1351281.7	(1)
M-8	48" MH	427.70	427.45	435.50	-	G-5.12	N 586844.4 E 1351030.6	(1)
M-9	48" MH	424.50	423.40	438.10	-	G-5.12	N 587043.8 E 1351122.9	(1)


(1) Coordinate for Proposed Structure = Centerline of Structure * FIELD VERIFY

PIPE SCHEDULE

Size	Class	Total Length*
12"	RCP CL III	12
18"	RCP CL III	575
12"	HDPE	43
15"	HDPE	222
18"	HDPE	278

* The total length of pipe is linear feet only.

HDPE is to be smooth interior. Contractor shall install pipe in accordance with manufacturer's specifications

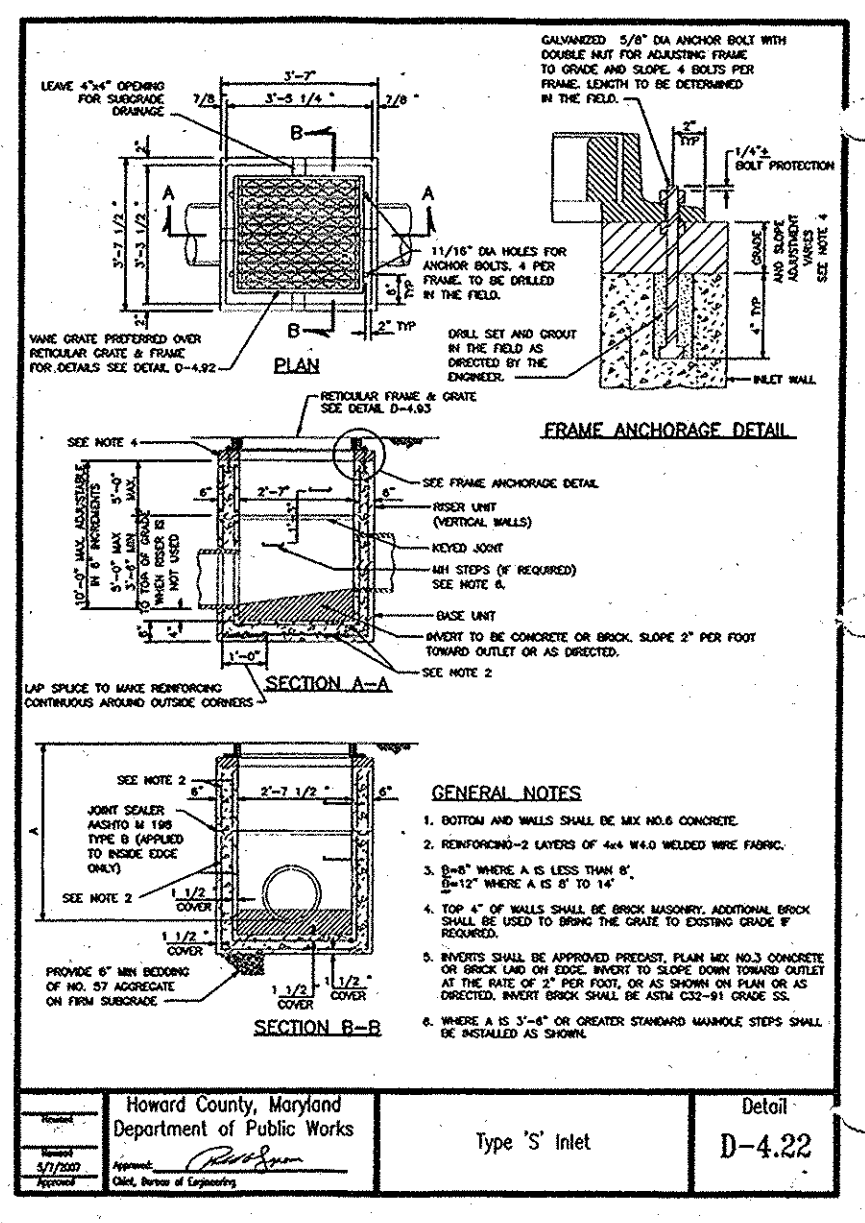

ATTORNEY
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PHONE: (410) 964-0300

OWNER/DEVELOPER
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44087 HIGH POINT ROAD
ELLICOTT CITY, MD 21042
PHONE: (410) 440-1242

NO. _____ REVISION _____ DATE _____

**SITE DEVELOPMENT PLAN
STORM DRAIN PROFILES**

DEMIREL PLAZA
L15037 F.345

2ND ELECTION DISTRICT TAX MAP: 24 GRID: 1 PARCELS 62, 63 AND P/O 544 ZONED: OT (LOT 112) HOWARD COUNTY, MARYLAND

ROBERT H. VOGEL, INC.
ENGINEERS • SURVEYORS • PLANNERS
8407 MAIN STREET ELLICOTT CITY, MD 21043 TEL: 410.461.7666 FAX: 410.461.8961

PROFESSIONAL CERTIFICATE
I HEREBY CERTIFY THAT THESE DOCUMENTS WERE PREPARED OR APPROVED BY ME, AND THAT I AM A DULY LICENSED PROFESSIONAL ENGINEER UNDER THE LAWS OF THE STATE OF MARYLAND, LICENSE NO. 16193 EXPIRATION DATE: 09-27-2016

DESIGN BY: EDS.
DRAWN BY: RVE.
CHECKED BY: RHY.
DATE: MAY 2015
SCALE: AS SHOWN
W.O. NO.: 11-01

9 SHEET OF 15

APPROVED JULY 17, 2014
PLANNING BOARD OF HOWARD COUNTY

APPROVED: HOWARD COUNTY DEPARTMENT OF PLANNING AND ZONING

Chief, Development Engineering Division
DATE: 6-8-15

Chief, Division of Land Development
DATE: 7-07-15

Director
DATE: 7-7-15

STORMWATER MANAGEMENT - DRAINAGE AREA MAP

SCALE: 1"=30'



MAPPED SOILS TYPES - ELLICOTT CITY SW MAP #13						
SYMBOL NAME / DESCRIPTION	GROUP	HYDRIC	PERCENT ORGANICS	K-FACTOR	TOPOGRAPHIC	PERCENT SAND
GhB GLENELG-URBAN LAND COMPLEX, 0 TO 8 PERCENT SLOPES	B/D	NO	NO	0.20	NO	NO

TAKEN FROM: USDA, SCS-WEB SOIL SURVEY, HOWARD COUNTY
K-FACTOR = $K_w \cdot 0.4^{\text{DEPTH}}$


NOTE: HIGHLY ERODIBLE SOILS ARE THOSE SOILS WITH A SLOPE GREATER THAN 15 PERCENT OR THOSE SOILS WITH A SOIL ERODIBILITY FACTOR K GREATER THAN 0.35 AND WITH A SLOPE GREATER THAN 5 PERCENT

LEGEND

- PROPERTY LINE
- RIGHT-OF-WAY LINE
- ADJACENT PROPERTY LINE
- EXISTING CONTOUR
- EXISTING CURB AND GUTTER
- PROPOSED CURB AND GUTTER
- EXISTING UTILITY POLE
- EXISTING LIGHT POLE
- EXISTING MAILBOX
- EXISTING SIGN
- EXISTING SANITARY MANHOLE
- EXISTING SANITARY LINE
- EXISTING FIRE HYDRANT
- EXISTING WATER LINE
- PROPOSED STORM DRAIN
- PROPOSED STORM DRAIN INLETS
- EXISTING TREELINE
- UuB GbB SOILS BOUNDARY
- MICRO-BIORETENTION FACILITY
- PERMEABLE SURFACE PARKING PAD
- DRAINAGE DIVIDE

AREA 4
0.56 AC.

DRAINAGE AREA DESCRIPTION

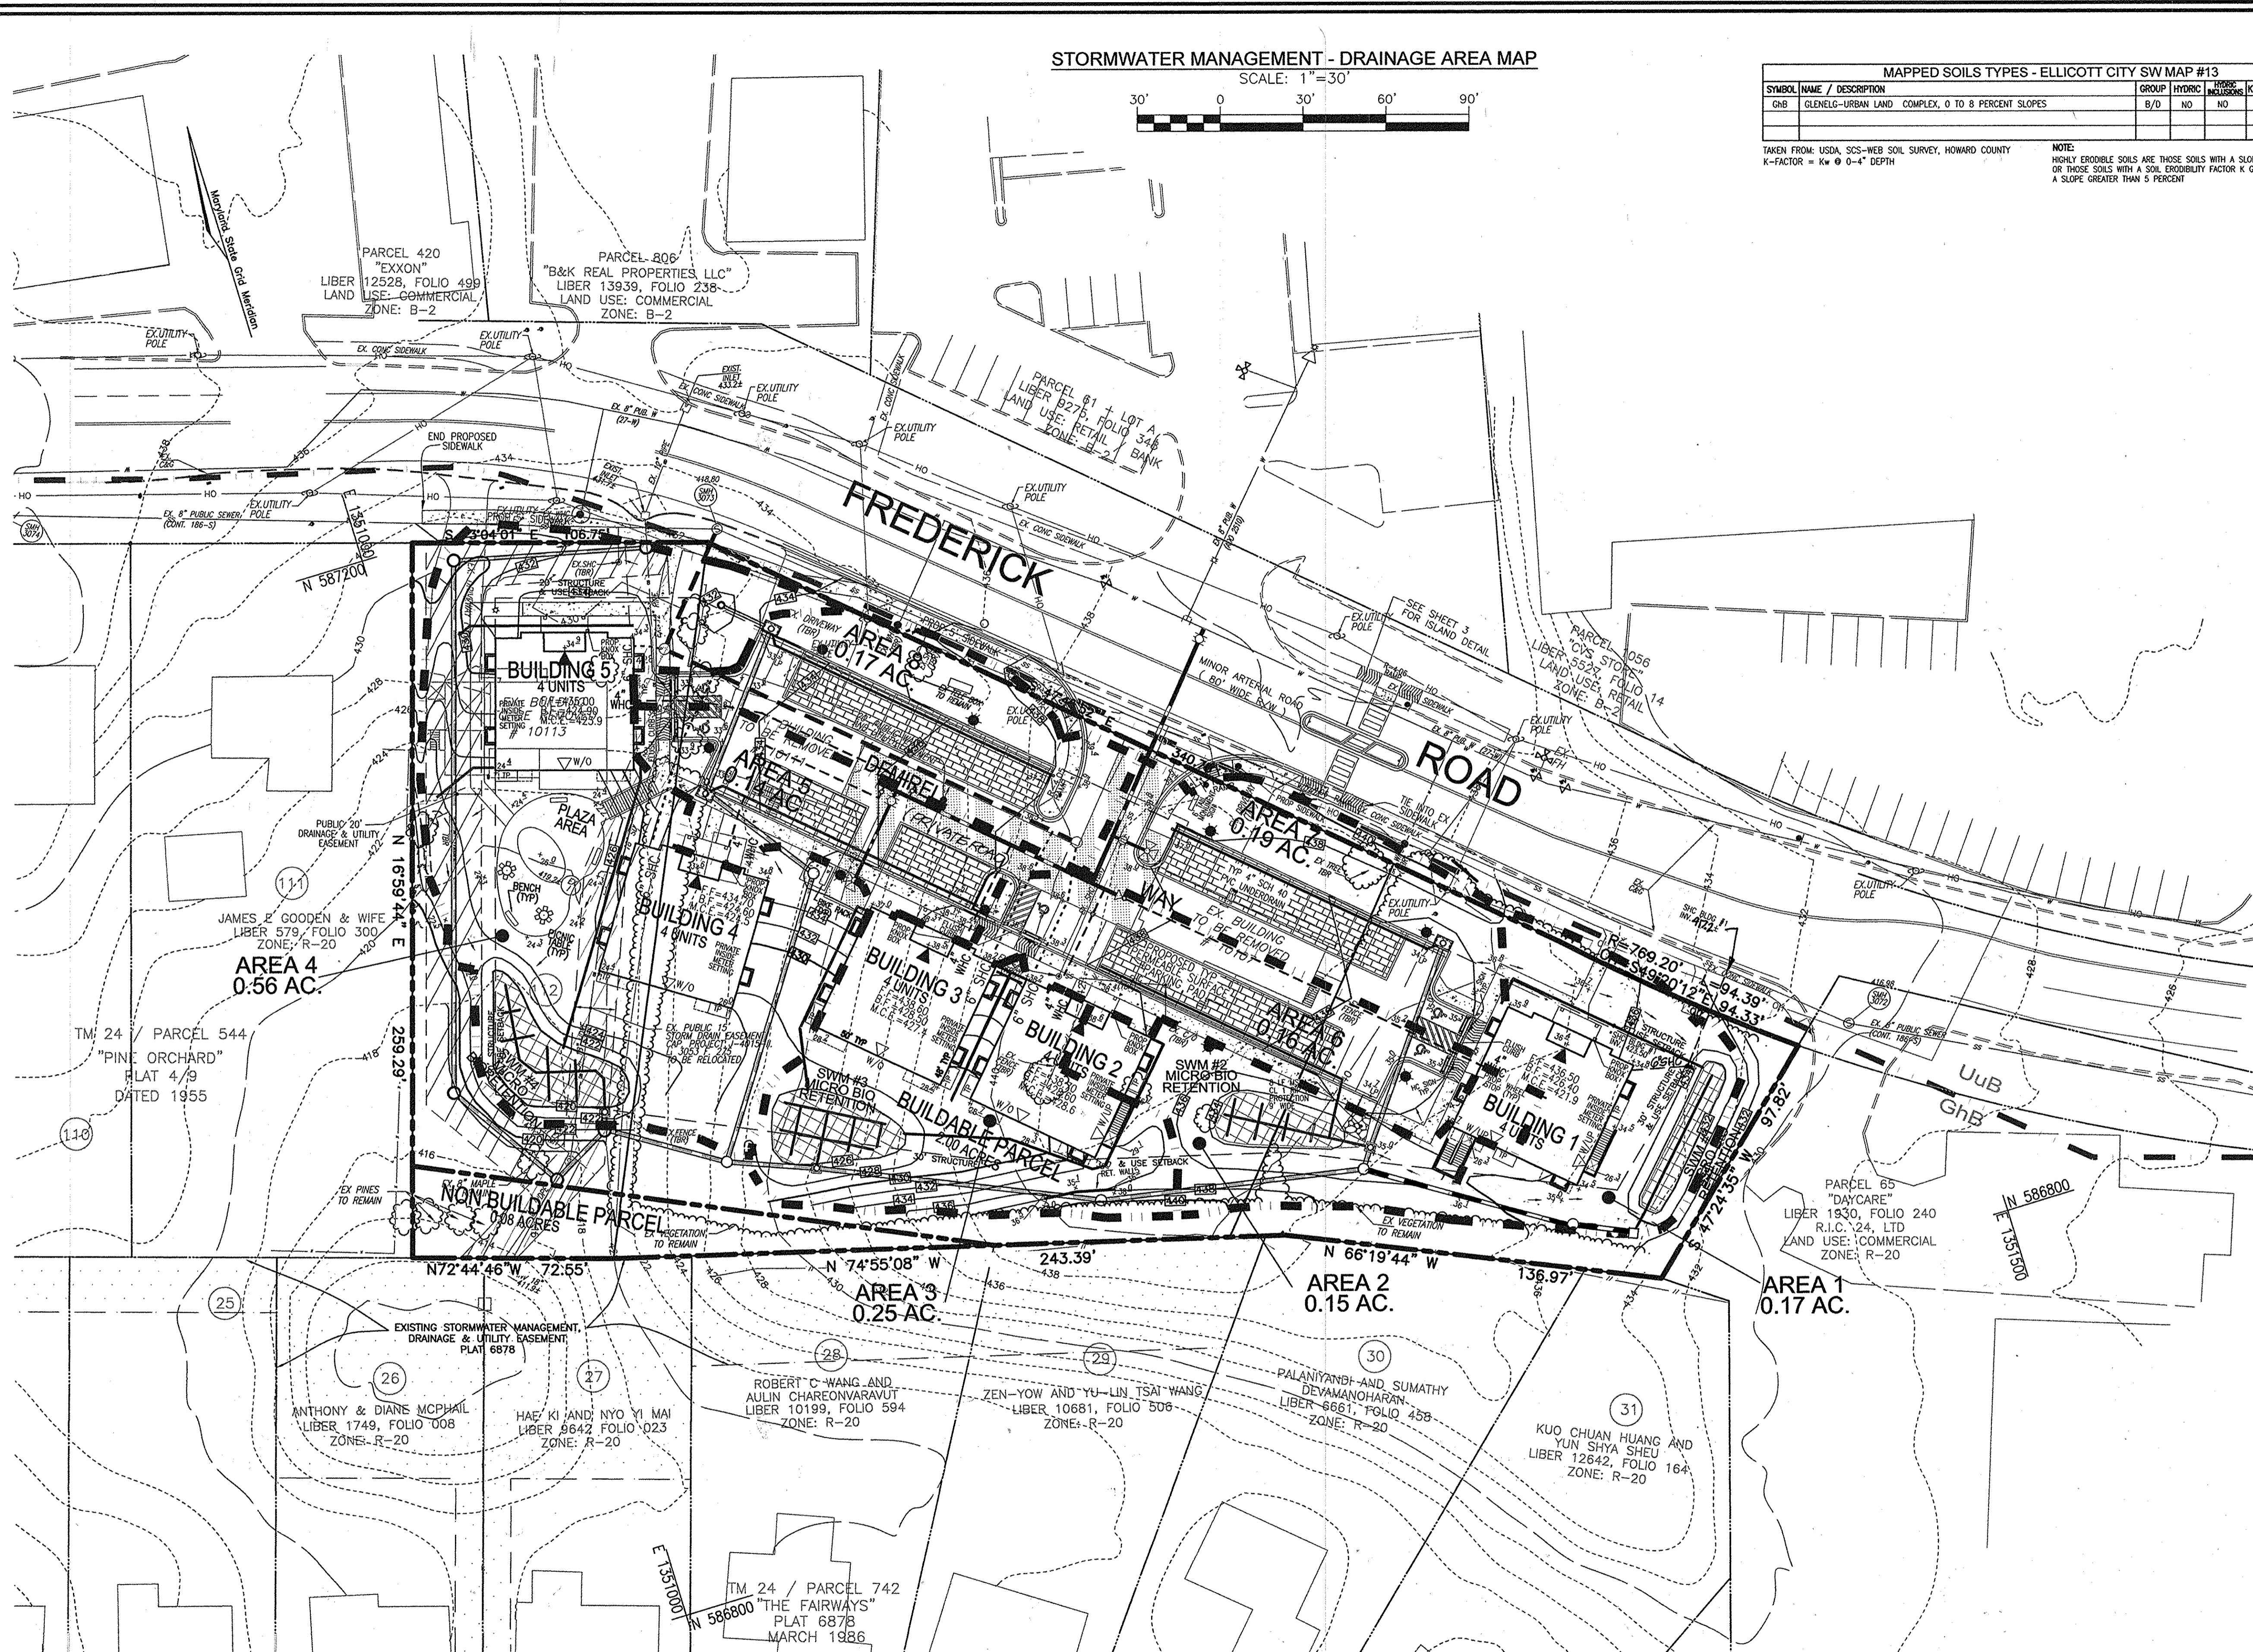

NO.	REVISION	DATE
1	REVISE STORM DRAIN AND SHG TO BUILDING 1	12-9-15

SITE DEVELOPMENT PLAN
STORMWATER MANAGEMENT
ESDv DRAINAGE AREA MAP
DEMIREL PLAZA
L15837 R.345

2ND ELECTION DISTRICT PARCELS 62, 63 AND P/O 544 (LOT 112) ZONED: OT
HOWARD COUNTY, MARYLAND

ROBERT H. VOGEL ENGINEERING, INC.
ENGINEERS • SURVEYORS • PLANNERS
8407 MAIN STREET TEL: 410.461.7666
ELLICOTT CITY, MD 21042 FAX: 410.461.8961

DESIGN BY: EDS
DRAWN BY: RVE
CHECKED BY: RHY
DATE: MAY 2015
SCALE: AS SHOWN
W.O. NO.: 11-01

PROFESSIONAL CERTIFICATE
I HEREBY CERTIFY THAT THESE DOCUMENTS WERE PREPARED OR APPROVED BY ME, AND THAT I AM A DULY LICENSED PROFESSIONAL ENGINEER UNDER THE LAWS OF THE STATE OF MARYLAND, LICENSE NO. 16193, EXPIRATION DATE: 09-27-2016

STATE OF MARYLAND
ROBERT H. VOGEL
REGISTERED PROFESSIONAL ENGINEER
NO. 16193

APPROVED: HOWARD COUNTY DEPARTMENT OF PLANNING AND ZONING
DATE: 6-8-15
CHIEF, DEVELOPMENT ENGINEERING DIVISION

APPROVED: JULY 17, 2014
PLANNING BOARD OF HOWARD COUNTY

CHIEF, DIVISION OF LAND DEVELOPMENT
DATE: 7-07-15
DATE: 7-7-15

ATTORNEY
SANG OH
TALKIN & OH, LLP
5100 DORSEY HALL DRIVE
ELLICOTT CITY, MD 21042
PHONE: (410) 964-0300

OWNER/DEVELOPER
VELI DEMIREL
44087 HIGH POINT ROAD
ELLICOTT CITY, MD 21042
PHONE: (410) 440-1242

APPENDIX B.4.C SPECIFICATIONS FOR MICRO-BIORETENTION, RAIN GARDEN, LANDSCAPE INFILTRATION & INFILTRATION BERMS

1. MATERIAL SPECIFICATIONS

THE ALLOWABLE MATERIALS TO BE USED IN THESE PRACTICES ARE DETAILED IN TABLE B.4.1.
2. FILTERING MEDIA OR PLANTING SOIL
THE SOIL SHALL BE A UNIFORM MIX, FREE OF STONES, STUMPS, ROOTS OR OTHER SIMILAR OBJECTS LARGER THAN TWO INCHES...


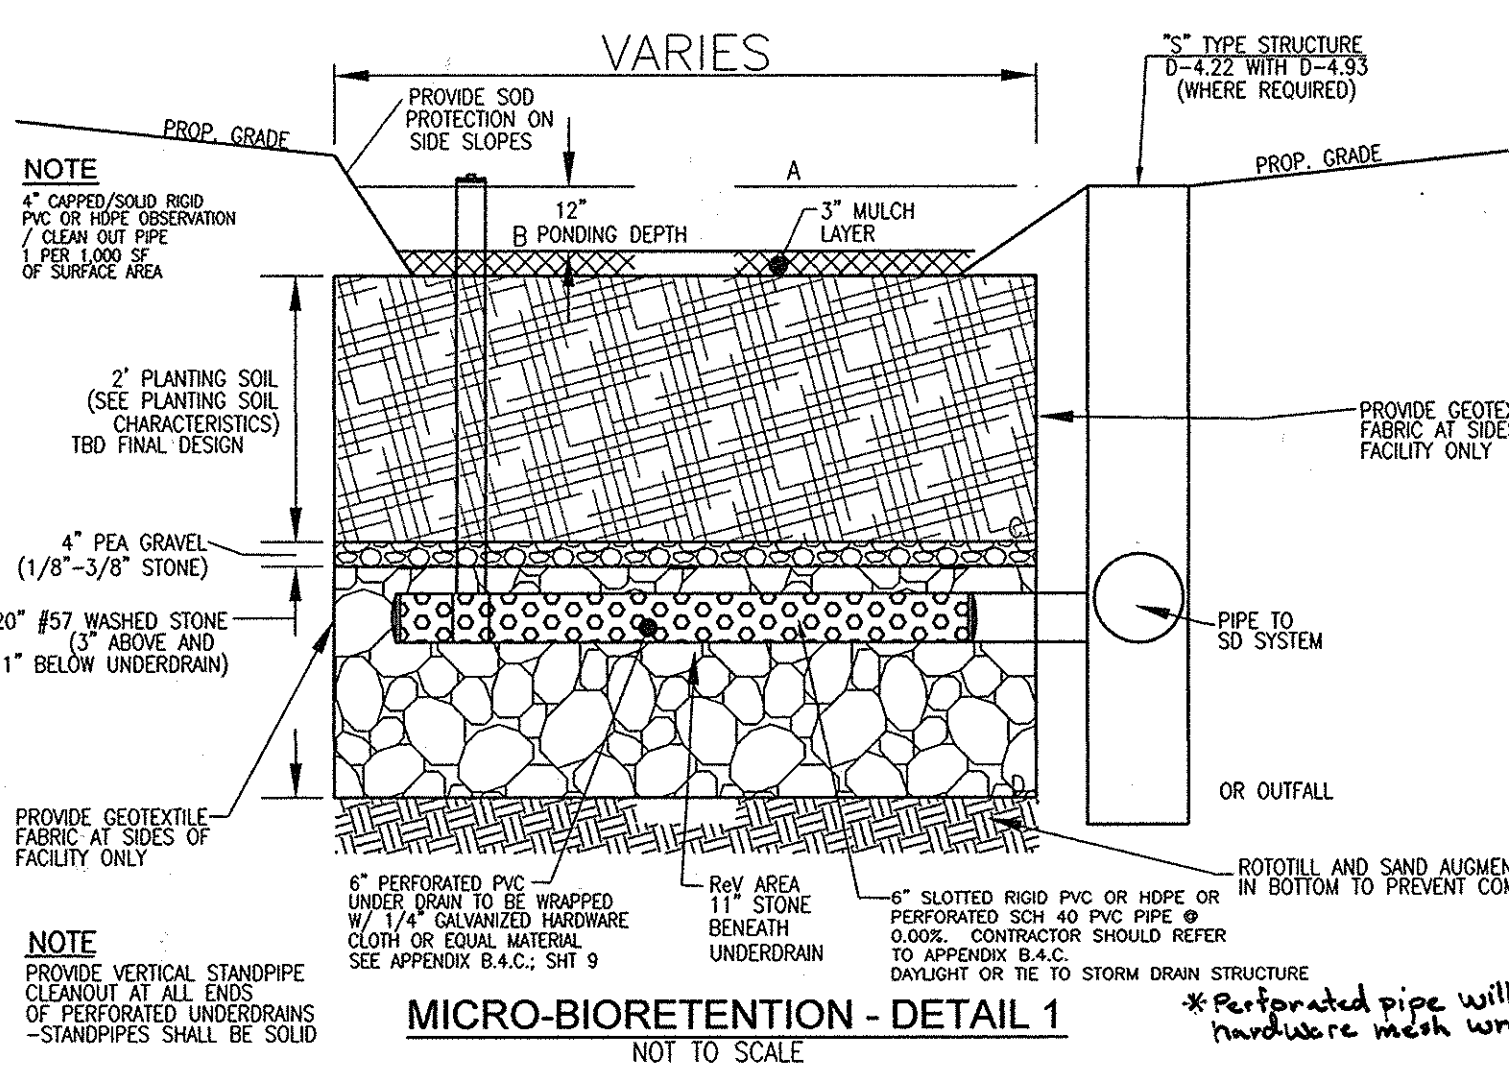


Table with 7 columns: MBR FACILITY, A, B, C, D, SURFACE AREA, APPROX. DIMENSIONS. Lists MBR #1 through #4 with their respective dimensions and surface areas.

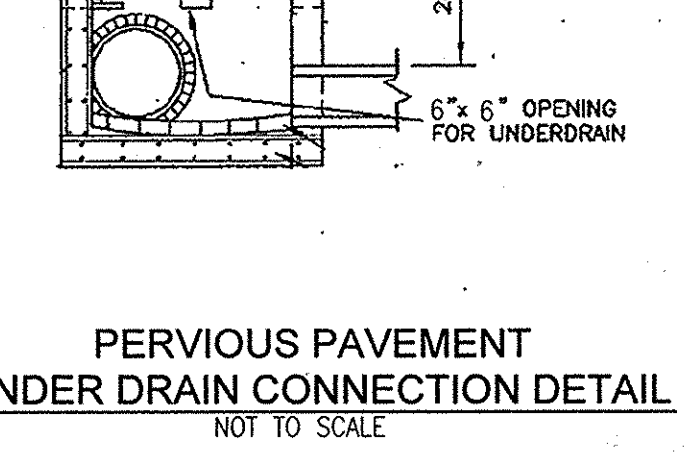

A-2. PERMEABLE PAVEMENTS

CONSTRUCTION CRITERIA:

- EROSION AND SEDIMENT CONTROL: FINAL GRADING FOR INSTALLATION SHOULD NOT TAKE PLACE UNTIL THE SURROUNDING SITE IS STABILIZED.
SOIL COMPACTION: SUB SOILS SHALL NOT BE COMPACTED.
DISTRIBUTION SYSTEMS: OVERDRAIN, UNDERDRAIN, AND DISTRIBUTION PIPES SHALL BE CHECKED TO ENSURE THAT BOTH THE MATERIAL AND PERFORATIONS MEET SPECIFICATIONS.

INSPECTION:


- DURING EXCAVATION TO SUB GRADE.
DURING PLACEMENT AND BACKFILL OF ANY DRAINAGE OR DISTRIBUTION SYSTEM(S).
DURING PLACEMENT OF THE CRUSHED STONE SUBBASE MATERIAL.

MAINTENANCE CRITERIA:

- PAVEMENTS SHOULD BE USED ONLY WHEN REGULAR MAINTENANCE CAN BE PERFORMED.
PAVEMENT SURFACES SHOULD BE SWEEP AND VACUUMED TO REDUCE SEDIMENT ACCUMULATION.
DRAINAGE PIPES, INLETS, STONE EDGE DRAINS, AND OTHER STRUCTURES WITHIN OR DRAINING TO THE SUBBASE SHOULD BE CLEANED OUT AT REGULAR INTERVALS.

HOWARD COUNTY - OPERATION AND MAINTENANCE SCHEDULE FOR PRIVATELY OWNED AND MAINTAINED PERMEABLE PAVEMENT (A-2)


- A. THE OWNER SHALL PERIODICALLY SWEEP (OR VACUUM POROUS CONCRETE PAVEMENT) THE PAVEMENT SURFACES TO REDUCE SEDIMENT ACCUMULATION AND ENSURE CONTINUED SURFACE POROSITY.
B. THE OWNER SHALL PERIODICALLY CLEAN DRAINAGE PIPES, INLETS, STONE EDGE DRAINS AND OTHER STRUCTURES WITHIN OR DRAINING TO THE SUBBASE.

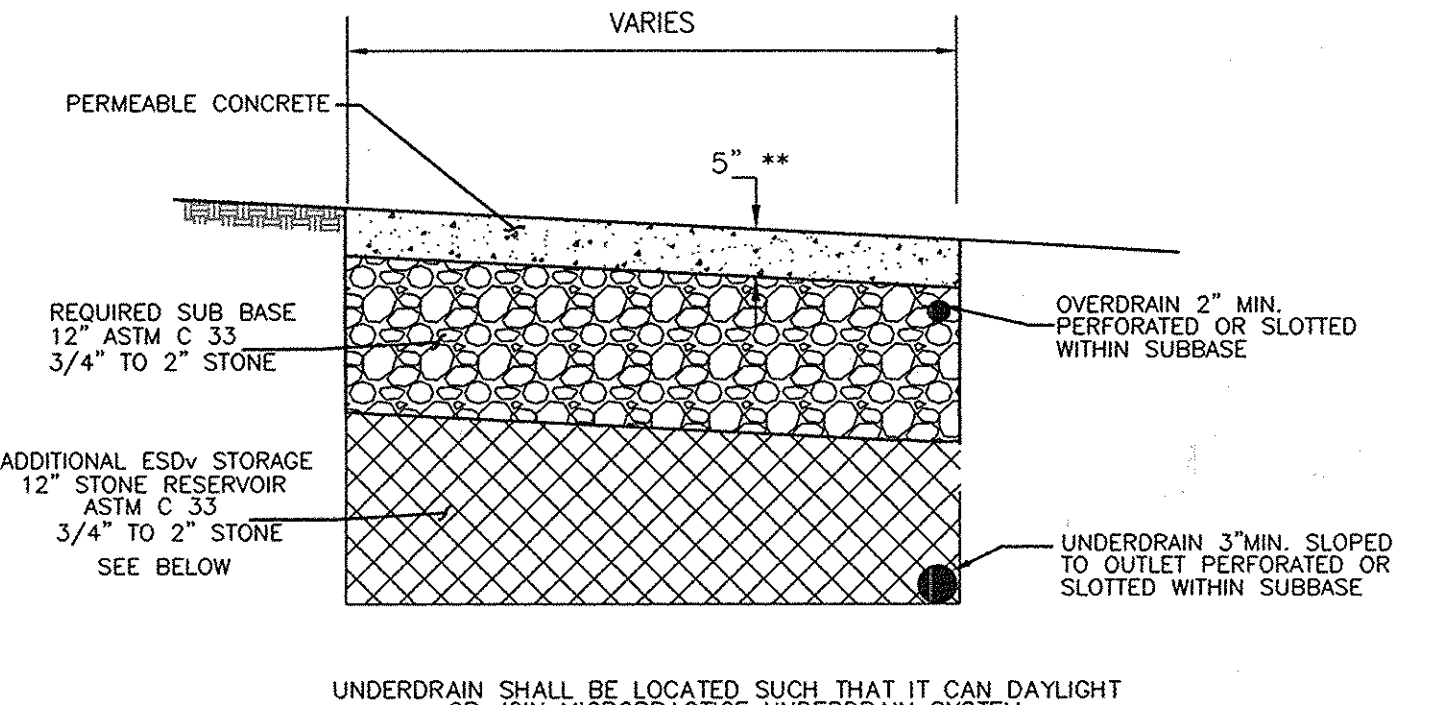

DETAIL - PERMEABLE CONCRETE PARKING (NOT TO SCALE)
** ALL PERMEABLE CONCRETE THICKNESS, MIX AND SUB-BASE TO BE DETERMINED BY GEOTECHNICAL ENGINEER ON-SITE.

B.4.B SPECIFICATIONS FOR PERMEABLE PAVEMENTS & REINFORCED TURF

DESIGN THICKNESS - PERVIOUS CONCRETE APPLICATIONS SHALL BE DESIGNED SO THAT THE THICKNESS OF THE CONCRETE SLAB SHALL SUPPORT THE TRAFFIC AND VEHICLE TYPES THAT WILL BE CARRIED.
REINFORCED TURF - REINFORCED GRASS PAVEMENT (RGP) - WHETHER USED WITH GRASS OR GRAVEL, THE RGP THICKNESS SHALL BE AT LEAST 1-3/4" THICK...

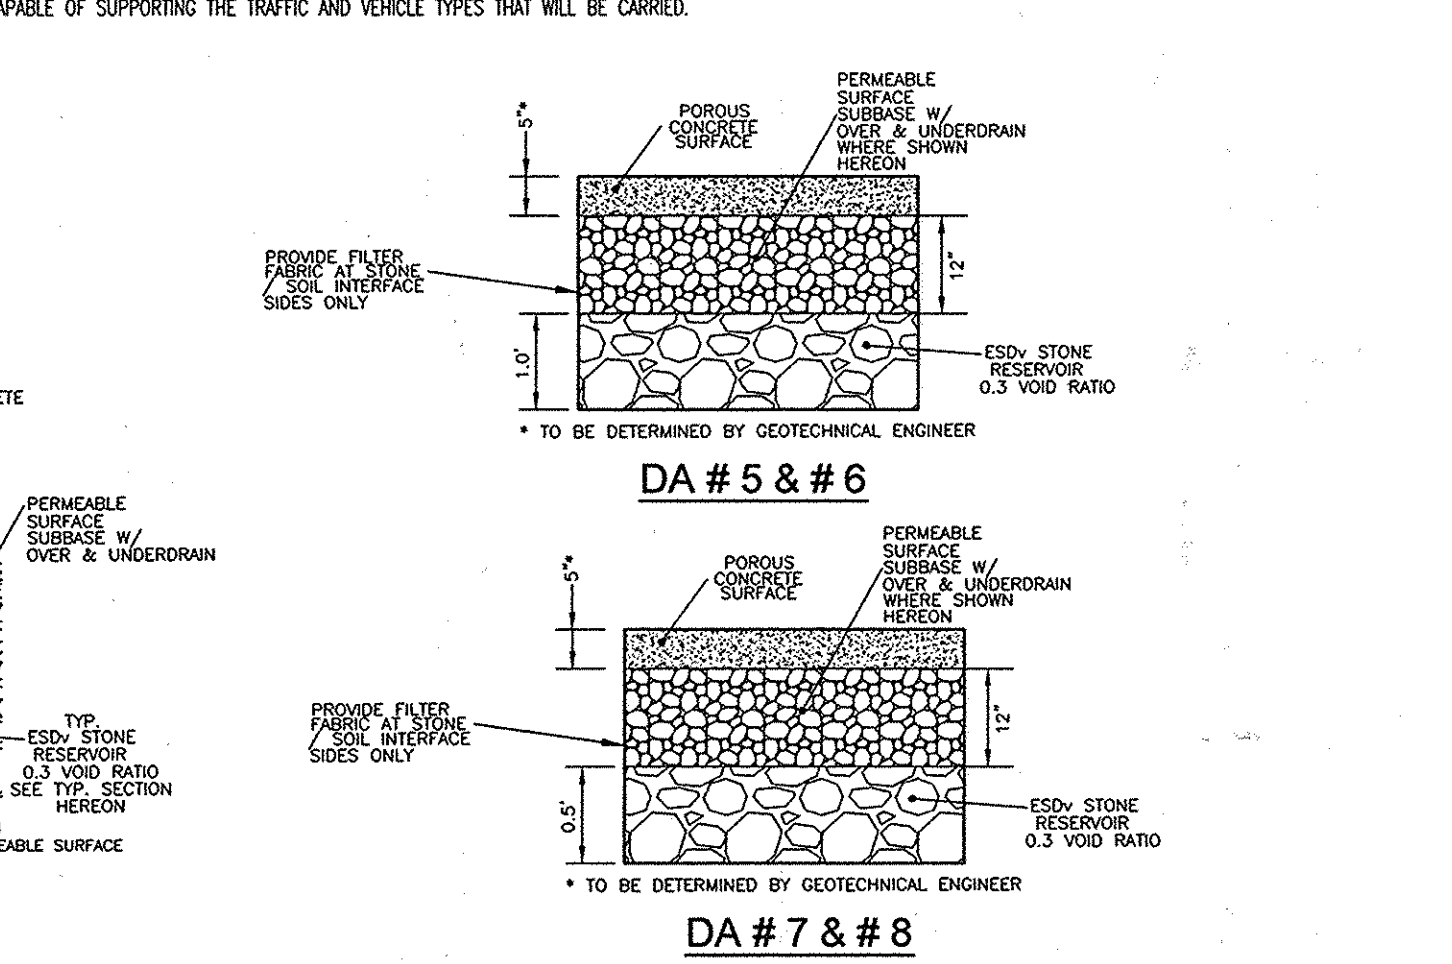

PERMEABLE SURFACE TYPICAL SECTIONS (NOT TO SCALE)

OPERATION AND MAINTENANCE SCHEDULE FOR (M-6) MICROBIORETENTION AREAS

- 1. ANNUAL MAINTENANCE OF PLANT MATERIAL, MULCH LAYER AND SOIL LAYER IS REQUIRED.
2. SCHEDULE OF PLANT INSPECTION WILL BE TWICE A YEAR IN SPRING AND FALL.
3. MULCH SHALL BE INSPECTED EACH SPRING. REMOVE PREVIOUS MULCH LAYER BEFORE APPLYING NEW LAYER EVERY 2 TO 3 YEARS.

Appendix B.4. Construction Specifications for Environmental Site Design Practices

Table B.4.1 Materials Specifications for Micro-Bioretention, Rain Gardens & Landscape Infiltration. Columns: Material, Specification, Size, Notes.

DEMIREL PROPERTY - FINAL PLAN ESDv COMPUTATIONS

Table with columns: DA #, IMPERV, Rv, ReV, DA, DA, MINIMUM VOLUME, MAXIMUM VOLUME, 1.8" VOLUME PROVIDED, IMPERV (SF), IMPERV (AC), GREEN AREA, REMARKS. Includes building footprints and parking lots.


MAPPED SOILS TYPES - ELLICOTT CITY SW MAP #13. Table with columns: SYMBOL, NAME / DESCRIPTION, GROUP, HYDRIC, MOISTURE REGIMEN, K-FACTOR, PERCENT SAND, TEXTURE CLASSIFICATION.

APPROVED: HOWARD COUNTY DEPARTMENT OF PLANNING AND ZONING
CHIEF, DEVELOPMENT ENGINEERING DIVISION
CHIEF, DIVISION OF LAND DEVELOPMENT
DIRECTOR

APPROVED JULY 17, 2014
PLANNING BOARD OF HOWARD COUNTY
PLANNING DIRECTOR

ATTORNEY: SANG OH, TALKIN & OH, LLP
OWNER/DEVELOPER: VELL DEMIREL
PROFESSIONAL CERTIFICATE: ROBERT H. VOGEL, PE NO. 16193

Site Development Plan: Stormwater Management - Notes & Details. Demirel Plaza. Includes logos for Robert H. Vogel Engineering, Inc. and the State of Maryland Professional Engineer seal.

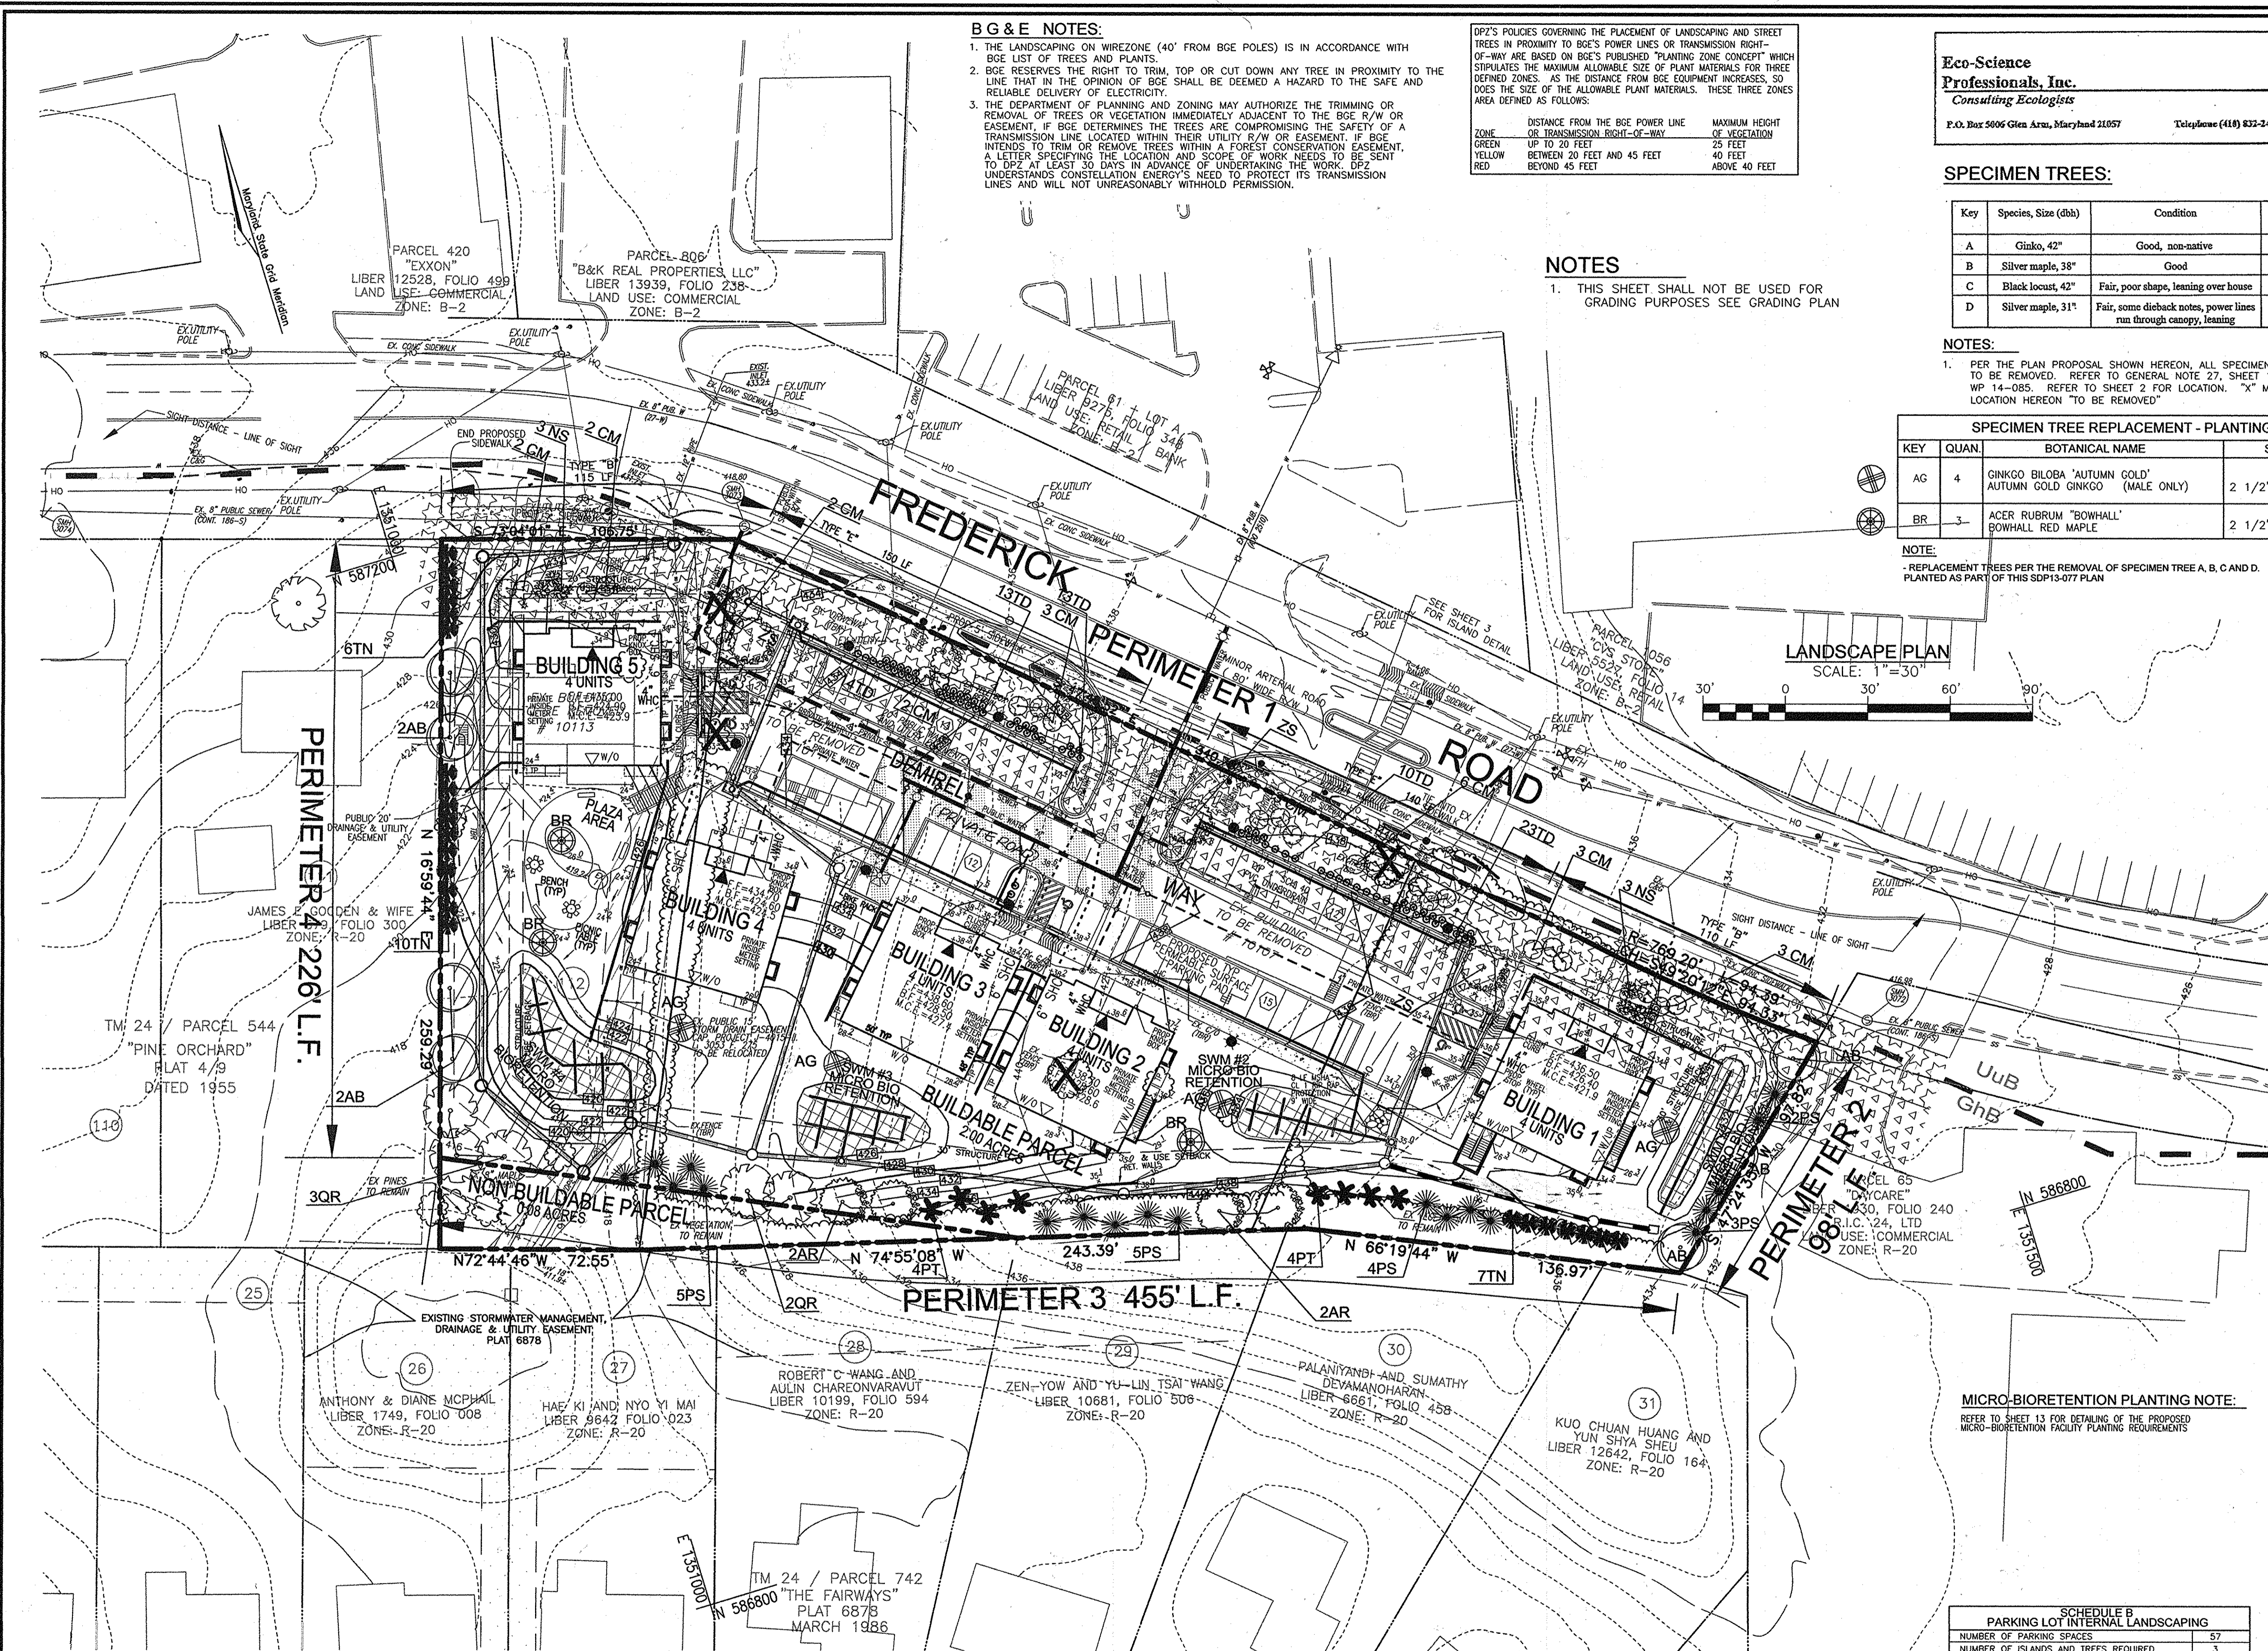

B G & E NOTES:

1. THE LANDSCAPING ON WIREZONE (40' FROM BGE POLES) IS IN ACCORDANCE WITH BGE LIST OF TREES AND PLANTS.
2. BGE RESERVES THE RIGHT TO TRIM, TOP OR CUT DOWN ANY TREE IN PROXIMITY TO THE LINE THAT IN THE OPINION OF BGE SHALL BE DEEMED A HAZARD TO THE SAFE AND RELIABLE DELIVERY OF ELECTRICITY.
3. THE DEPARTMENT OF PLANNING AND ZONING MAY AUTHORIZE THE TRIMMING OR REMOVAL OF TREES OR VEGETATION IMMEDIATELY ADJACENT TO THE BGE R/W OR EASEMENT, IF BGE DETERMINES THE TREES ARE COMPROMISING THE SAFETY OF A TRANSMISSION LINE LOCATED WITHIN THEIR UTILITY R/W OR EASEMENT. IF BGE INTENDS TO TRIM OR REMOVE TREES WITHIN A FOREST CONSERVATION EASEMENT, A LETTER SPECIFYING THE LOCATION AND SCOPE OF WORK NEEDS TO BE SENT TO DPZ AT LEAST 30 DAYS IN ADVANCE OF UNDERTAKING THE WORK. DPZ UNDERSTANDS CONSTELLATION ENERGY'S NEED TO PROTECT ITS TRANSMISSION LINES AND WILL NOT UNREASONABLY WITHHOLD PERMISSION.

DPZ'S POLICIES GOVERNING THE PLACEMENT OF LANDSCAPING AND STREET TREES IN PROXIMITY TO BGE'S PUBLISHED "PLANTING ZONE CONCEPT" WHICH STIPULATES THE MAXIMUM ALLOWABLE SIZE OF PLANT MATERIALS FOR THREE DEFINED ZONES, AS THE DISTANCE FROM BGE EQUIPMENT INCREASES, SO DOES THE SIZE OF THE ALLOWABLE PLANT MATERIALS. THESE THREE ZONES ARE DEFINED AS FOLLOWS:

ZONE	DISTANCE FROM THE BGE POWER LINE OR TRANSMISSION RIGHT-OF-WAY	MAXIMUM HEIGHT OF VEGETATION
GREEN	UP TO 20 FEET	25 FEET
YELLOW	BETWEEN 20 FEET AND 45 FEET	40 FEET
RED	BEYOND 45 FEET	ABOVE 40 FEET

NOTES

1. THIS SHEET SHALL NOT BE USED FOR GRADING PURPOSES SEE GRADING PLAN

Eco-Science Professionals, Inc.
Consulting Ecologists
 P.O. Box 5006 Glen Arun, Maryland 21057 Telephone (410) 832-2450 Fax (410) 832-2458

SPECIMEN TREES:

Key	Species, Size (dbh)	Condition	Critical Root Zone (radius)
A	Ginkgo, 42"	Good, non-native	63'
B	Silver maple, 38"	Good	57'
C	Black locust, 42"	Fair, poor shape, leaning over house	63'
D	Silver maple, 31"	Fair, some dieback notes, power lines run through canopy, leaning	46.5'

NOTES:

1. PER THE PLAN PROPOSAL SHOWN HEREON, ALL SPECIMEN TREES ARE TO BE REMOVED. REFER TO GENERAL NOTE 27, SHEET 1 REGARDING WP 14-085. REFER TO SHEET 2 FOR LOCATION. "X" MARKS LOCATION HEREON TO BE REPLACED

SPECIMEN TREE REPLACEMENT - PLANTING SCHEDULE

KEY	QUAN.	BOTANICAL NAME	SIZE	REM.
AG	4	GINKGO BILOBA 'AUTUMN GOLD' / AUTUMN GOLD GINKGO (MALE ONLY)	2 1/2"-3" CAL.	B & B
BR	3	ACER RUBRUM 'BOWHALL' / BOWHALL RED MAPLE	2 1/2"-3" CAL.	B & B

NOTE:
 -REPLACEMENT TREES PER THE REMOVAL OF SPECIMEN TREE A, B, C AND D. PLANTED AS PART OF THIS SDP13-077 PLAN

LANDSCAPE PLAN
 SCALE: 1"=30'

LEGEND

- PROPERTY LINE
- RIGHT-OF-WAY LINE
- ADJACENT PROPERTY LINE
- EXISTING CONTOUR
- EXISTING CURB AND GUTTER
- PROPOSED CURB AND GUTTER
- EXISTING UTILITY POLE
- EXISTING LIGHT POLE
- EXISTING MAILBOX
- EXISTING SIGN
- EXISTING SANITARY MANHOLE
- EXISTING SANITARY LINE
- EXISTING FIRE HYDRANT
- EXISTING WATER LINE
- PROPOSED STORM DRAIN
- PROPOSED STORM DRAIN INLETS
- EXISTING TRENCH
- SOILS BOUNDARY
- MICRO-BIORETENTION FACILITY
- PERMEABLE SURFACE PARKING PAD
- PROPOSED SHADE TREES
- PROPOSED EVERGREEN TREES
- PROPOSED LANDSCAPE BUFFER
- EX. SPECIMEN TREE
- EX. SPECIMEN TREE TO BE REMOVED
- BG & E GREEN ZONE
- BG & E YELLOW ZONE

LANDSCAPE SCHEDULE

KEY	QUAN.	BOTANICAL NAME	SIZE	CAT
AR	4	ACER RUBRUM 'OCTOBER GLORY' / RED MAPLE	2 1/2"-3" CAL.	B & B
QR	5	QUERCUS RUBRA 'NORTHER RED OAK'	2 1/2"-3" CAL.	B & B
ZS	3	ZELCOVA SERRATA 'VILLAGE GREEN' / VILLAGE GREEN JAPANESE ZELCOVA	2 1/2"-3" CAL.	B & B
AB	7	BLOODGOOD JAPANESE RED MAPLE (MAX. HEIGHT=25')	4"-6" HT.	B & B
CM	26	LODICESTRUM TUSCORA 'TUSCARORA CRAPE MYRTLE'	4"-8" HT. (MAX. HEIGHT=25')	B & B
PS	19	PRUNUS STROBILIS 'EASTERN WHITE PINE'	6"-8" HT.	B & B
TN	23	TRILIA PLICATA 'GREEN GIANT' / GIANT ARBORVITAE	5"-6" HT.	B & B
TD	73	YAXUS MEDIA 'DENSIFORMIS' / DENSIFORMIS YEW	2 1/2"-3" HT.	B & B
PT	8	PRUNUS THUNBERGIANA 'JAPANESE BLACK PINE'	6"-8" HT.	B & B
NS	6	ILEX 'NELLIE R. STEVENS' / NELLIE R. STEVENS HOLLY	5"-6" HT.	B & B

- LANDSCAPE SCHEDULE NOTE:**
1. ALL PLANT MATERIALS SHALL BE FULL AND HEAVY, BE WELL FORMED AND SYMMETRICAL, CONFORM TO THE MOST CURRENT AM SPECIFICATIONS AND BE INSTALLED IN ACCORDANCE WITH HED PLANTING SPECIFICATIONS. CONTRACTOR SHALL VERIFY LOCATION OF ALL UNDERGROUND UTILITIES PRIOR TO DIGGING.
 2. FINAL LOCATION OF PLANT MATERIAL MAY NEED TO VARY TO MEET FINAL FIELD CONDITIONS. TREES SHALL NOT BE PLANTED IN THE BOTTOM OF DRAINAGE SWALES.
 3. CONTRACTOR SHALL VERIFY PLANT QUANTITIES PRIOR TO BIDDING. IF PLAN DIFFERS FROM LANDSCAPE SCHEDULE, THE PLAN SHALL GOVERN.

MICRO-BIORETENTION PLANTING NOTE:
 REFER TO SHEET 13 FOR DETAILING OF THE PROPOSED MICRO-BIORETENTION FACILITY PLANTING REQUIREMENTS

SCHEDULE B PARKING LOT INTERNAL LANDSCAPING

NUMBER OF PARKING SPACES	57
NUMBER OF ISLANDS AND TREES REQUIRED	3
NUMBER OF ISLANDS AND TREES PROVIDED	3
ISLANDS AND SHADE TREES OTHER TREES (2:1 SUBSTITUTION)	3

MAPPED SOILS TYPES - ELLICOTT CITY SW MAP #13

SUBSOIL NAME / DESCRIPTION	GROUP	HYDRIC	PERCENT CLAY	K-FACTOR	PERCENT SAND	PERCENT SILT	PERCENT CLAY	PERCENT SILT	PERCENT CLAY
GMB GLENELG-URBAN LAND COMPLEX, 0 TO 8 PERCENT SLOPES	B/D	NO	NO	0.20	NO	NO	NO	NO	NO

TAKEN FROM: USDA, SSC-NEB SOIL SURVEY, HOWARD COUNTY
 NOTE: HIGHLY ERODIBLE SOILS ARE THOSE SOILS WITH A SLOPE GREATER THAN 15 PERCENT OR THOSE SOILS WITH A SOIL ERODIBILITY FACTOR K GREATER THAN 0.35 AND WITH A SLOPE GREATER THAN 5 PERCENT

DEVELOPER'S/OWNER'S LANDSCAPE CERTIFICATE

I/WE CERTIFY THAT LANDSCAPING SHOWN ON THIS PLAN WILL BE DONE ACCORDING TO THE PLAN, SECTION 16.124 OF THE HOWARD COUNTY CODE AND THE LANDSCAPE MANUAL. I/WE FURTHER CERTIFY THAT UPON COMPLETION OF THE PROJECT, A LETTER OF LANDSCAPE INSTALLATION, ACCOMPANIED BY AN EXECUTED ONE YEAR GUARANTEE OF PLANT MATERIALS, WILL BE SUBMITTED TO THE DEPARTMENT OF PLANNING AND ZONING.

DEVELOPER'S/OWNER'S NAME: *Van Der ...*

APPROVED: HOWARD COUNTY DEPARTMENT OF PLANNING AND ZONING

Phil ... 6-8-15
 CHIEF, DEVELOPMENT ENGINEERING DIVISION

Keith ... 7-7-15
 CHIEF, DIVISION OF LAND DEVELOPMENT

William ... 7-7-15
 DIRECTOR

APPROVED JULY 17, 2014
 PLANNING BOARD OF HOWARD COUNTY

1. REVISE STORM DRAIN AND SHC TO BUILDING 1 12/9/15

SITE DEVELOPMENT PLAN
LANDSCAPE PLAN
DEMIREL PLAZA
 L150537.F 345

2ND ELECTION DISTRICT TAX MAP: 24 GRID: 1 PARCELS 62, 63 AND P/O 544 (LOT 112) HOWARD COUNTY, MARYLAND ZONED: OT

ROBERT H. VOGEL ENGINEERING, INC.
 ENGINEERS • SURVEYORS • PLANNERS
 8407 MAIN STREET ELLICOTT CITY, MD 21043 TEL: 410-481-7666 FAX: 410-481-1895

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12 SHEET OF 15

HOWARD COUNTY FOREST CONSERVATION WORKSHEET

ZONED OT
NET TRACT AREA:
A. TOTAL TRACT AREA 2.00 AC
B. AREA WITHIN 100 YEAR FLOODPLAIN 0.00 AC
C. AREA TO REMAIN IN AGRICULTURAL PRODUCTION 0.00 AC
D. NET TRACT AREA 2.00 AC

LAND USE CATEGORY
INPUT THE NUMBER "1" UNDER THE APPROPRIATE LAND USE ZONING, AND LIMIT TO ONLY ONE ENTRY. BASED UPON ZONED R20

ARA	MDR	IDA	HDR	MPD	CIA
0	0	0	0	1	0

E. AFFOREST THRESHOLD 15% X 2.00 = 0.30 AC
F. CONSERVATION THRESHOLD 15% X 2.00 = 0.30 AC

EXISTING FOREST COVER:
G. EXISTING FOREST COVER = 0.00 AC
H. AREA OF FOREST ABOVE AFFORESTATION THRESHOLD = 0.00 AC
I. AREA OF FOREST ABOVE CONSERVATION THRESHOLD = 0.00 AC

BREAK EVEN POINT:
(2 x 1) + F = BREAK EVEN POINT (0 AC)

J. FOREST RETENTION WITH NO MITIGATION = 0.00 AC
K. CLEARING PERMITTED WITHOUT MITIGATION = 0.00 AC

PROPOSED FOREST CLEARING:
L. TOTAL AREA OF FOREST TO BE CLEARED = 0.00 AC
M. TOTAL AREA OF FOREST TO BE RETAINED = 0.00 AC

PLANTING REQUIREMENTS:
N. REFORESTATION FOR CLEARING ABOVE CONSERVATION THRESHOLD (L X 25) = 0.00 AC
O. REFORESTATION FOR CLEARING BELOW CONSERVATION THRESHOLD = 0.00 AC
P. CREDIT FOR RETENTION ABOVE CONSERVATION THRESHOLD (M-F) = 0.00 AC
R. TOTAL REFORESTATION REQUIRED (N+P-O) = 0.00 AC
S. TOTAL AFFORESTATION REQUIRED = 0.30 AC
T. TOTAL REFORESTATION AND AFFORESTATION REQUIRED = 0.30 AC

FOREST CONSERVATION EASEMENT HAVE BEEN ESTABLISHED TO FULFILL THE REQUIREMENTS OF SECTION 16.1200 OF THE HOWARD COUNTY FOREST CONSERVATION MANUAL.
TOTAL FOREST CONSERVATION OBLIGATION: 0.30 ACRES (13,068 x 0.75 = \$ 9,801.00 FOR THIS PROJECT TO BE FULFILLED BY PAYMENT OF A FEE-IN-LIEU.

GENERAL NOTES:

- THIS PLAN HAS BEEN PREPARED IN ACCORDANCE WITH SECTION 16.124 OF THE HOWARD COUNTY CODE AND THE LANDSCAPE MANUAL. A FINANCIAL SURETY FOR THE PERIMETER LANDSCAPING IN THE AMOUNT OF \$ 20,490.00 FOR THE PROVIDED 16 SHADE TREES (\$4,800), 56 EVERGREENS (\$8,400), 26 SMALL TREES (\$3,500), 73 SHRUBS / TREE REPLACEMENT (\$1,200) AND 73 SHRUBS (\$2,190) SHALL BE POSTED WITH THE DEVELOPERS AGREEMENT FOR THIS PLAN.
- THE REMOVAL OF TREES 30" OR GREAT DBH IS PROHIBITED WITHOUT COUNTY WAIVER APPROVAL. REFER TO WP 14-085, SHEET 1, GENERAL NOTE 27.

CATEGORY	ADJACENT TO PERIMETER PROPERTIES					TOTAL
	E	B	C	C	C	
PERIMETER/FRONTAGE DESIGNATION						
LANDSCAPE TYPE						
LINEAR FEET OF ROADWAY FRONTAGE/PERIMETER	290'	225'	98'	455'	226'	
CREDIT FOR EXISTING VEGETATION (YES, NO, LINEAR FEET) (DESCRIBE BELOW IF NEEDED)	NO	NO	NO	NO*	NO	
CREDIT FOR WALL, FENCE OR BERM (YES, NO, LINEAR FEET) (DESCRIBE BELOW IF NEEDED)	NO	NO	NO	NO	NO	
NUMBER OF PLANTS REQUIRED	290'	225'	98'	455'	226'	34
SHADE TREES	1:40 8	1:50 5	1:40 3	1:40 12	1:40 6	56
EVERGREEN TREES	1:4 73	-	1:20 5	1:20 23	1:20 12	46
SHRUBS	-	-	-	-	-	73
NUMBER OF PLANTS PROVIDED						
SHADE TREES	-	6	3	9	4	16
EVERGREEN TREES	16	10	5	29	16	56
OTHER TREES (2:1 SUBSTITUTION)	73	-	-	-	-	26
SHRUBS (10:1 SUBSTITUTION)	-	-	-	-	-	73
(DESCRIBE PLANT SUBSTITUTION CREDITS BELOW IF NEEDED)						

* FULL PERIMETER BUFFER PROVIDED IN ADDITION TO EXISTING EVERGREEN SCREEN TO REMAIN

LANDSCAPE NOTES

- AT THE TIME OF PLANT INSTALLATION, ALL SHRUBS AND TREES LISTED AND APPROVED ON THE LANDSCAPE PLAN, SHALL COMPLY WITH THE PROPER HEIGHT REQUIREMENT IN ACCORDANCE WITH THE HOWARD COUNTY LANDSCAPE MANUAL. IN ADDITION, NO SUBSTITUTIONS OR RELOCATIONS OF THE REQUIRED PLANTINGS MAY BE MADE WITHOUT PRIOR REVIEW AND APPROVAL FROM THE DEPARTMENT OF PLANNING AND ZONING. ANY DEVIATION FROM THE APPROVED LANDSCAPE PLAN MAY RESULT IN DENIAL OR DELAY IN THE RELEASE OF LANDSCAPE SURETY UNTIL SUCH TIME AS ALL REQUIRED MATERIALS ARE PLANTED AND/OR REVISIONS ARE MADE TO THE APPLICABLE PLANS.
- THE OWNER, TENANT AND/OR THEIR AGENTS SHALL BE RESPONSIBLE FOR MAINTENANCE OF THE REQUIRED LANDSCAPING INCLUDING BOTH PLANT MATERIALS AND BERMS, FENCES AND WALLS. ALL PLANT MATERIALS SHALL BE MAINTAINED IN GOOD GROWING CONDITION, AND WHEN NECESSARY, REPLACED WITH NEW MATERIALS TO ENSURE CONTINUED COMPLIANCE WITH APPLICABLE REGULATIONS. ALL OTHER REQUIRED LANDSCAPING SHALL BE PERMANENTLY MAINTAINED IN GOOD CONDITION, AND WHEN NECESSARY, REPAIRED OR REPLACED.
- SHOULD ANY TREE DESIGNATED FOR PRESERVATION FOR WHICH LANDSCAPING CREDIT IS GIVEN, DIE PRIOR TO RELEASE OF BONDS, THE OWNER WILL BE REQUIRED TO REPLACE THE TREE WITH THE EQUIVALENT SPECIES OR WITH A TREE WHICH WILL OBTAIN THE SAME HEIGHT, SPREAD, AND GROWTH CHARACTERISTICS. THE REPLACEMENT TREE MUST BE A MINIMUM OF 3 INCHES IN CALIPER AND INSTALLED AS REQUIRED IN THE HOWARD COUNTY LANDSCAPE MANUAL.
- PLANTINGS SHOWN HEREON ARE THE RESPONSIBILITY OF THE DEVELOPER TO INSTALL DURING THE CONSTRUCTION OF THE FINAL PLAN.

NOTES:

- THE FOREST STAND & WETLAND ANALYSIS WAS COMPLETED BY ECO-SCIENCE PROFESSIONALS, INC. C/O MR. JOHN CANOVES, FEBRUARY 2013
- THERE ARE NO WETLANDS, STREAMS OR BUFFERS ON-SITE.
- THE PROJECT SITE IS WITHIN THE LITTLE PATUXENT RIVER (UPPER) AREA # 2131105A

FOREST CONSERVATION / FSD NOTES:

- SURROUNDING LAND USE IS RESIDENTIAL.
- NO FOREST RESOURCES ARE PRESENT ON THE SITE.
- THIS PLAN HAS BEEN PREPARED IN ACCORDANCE WITH THE PROVISIONS OF SECTION 16.124 OF THE HOWARD COUNTY CODE.

Eco-Science Professionals, Inc.
Consulting Ecologists




P.O. Box 5006 Glen Artn, Maryland 21057 Telephone (410) 832-2488 Fax (410) 832-2488

SPECIMEN TREES:

Key	Species, Size (dbh)	Condition	Critical Root Zone (radius)
A	Ginkgo, 42"	Good, non-native	63"
B	Silver maple, 38"	Good	57"
C	Black locust, 42"	Fair, poor shape, leaning over house	63"
D	Silver maple, 31"	Fair, some dieback notes, power lines run through canopy, leaning	46.5"

NOTES:

- PER THE PLAN PROPOSAL SHOWN HEREON, ALL SPECIMEN TREES ARE TO BE REMOVED. REFER TO GENERAL NOTE 27, SHEET 1 REGARDING WP 14-085

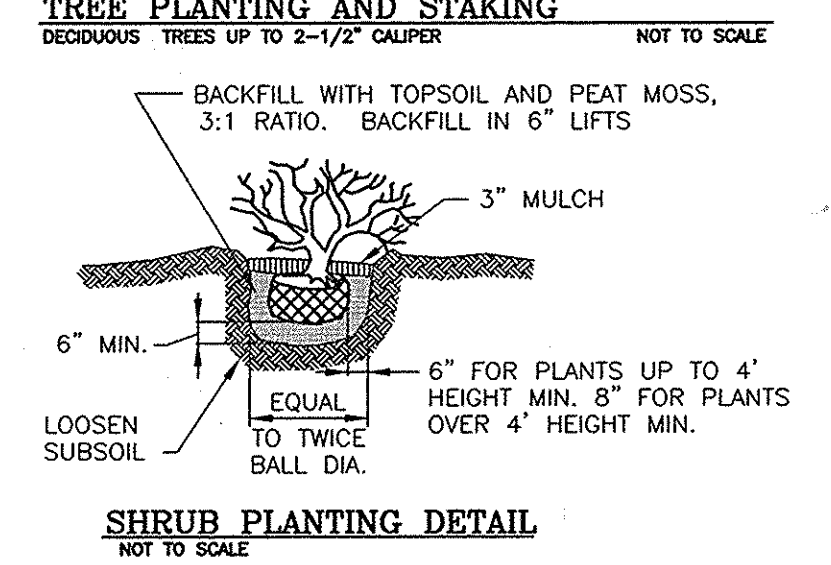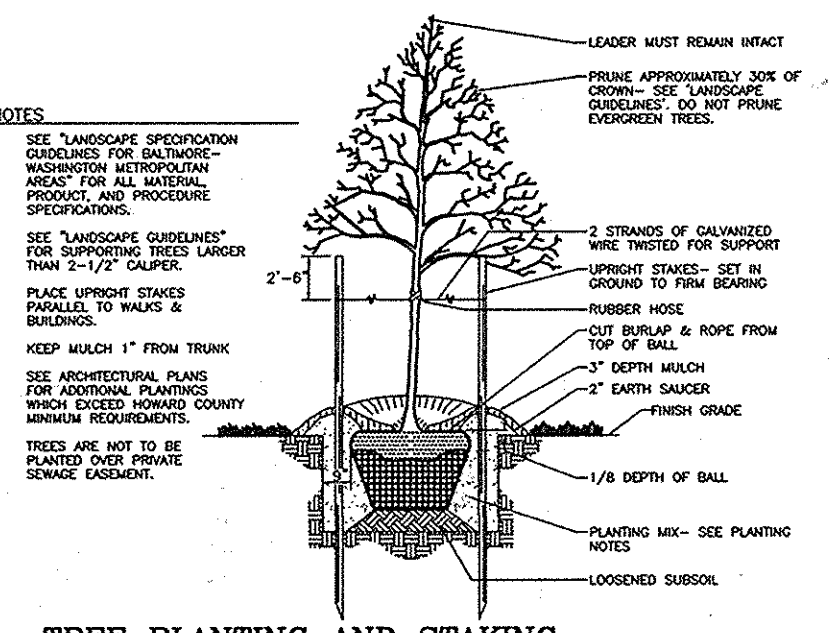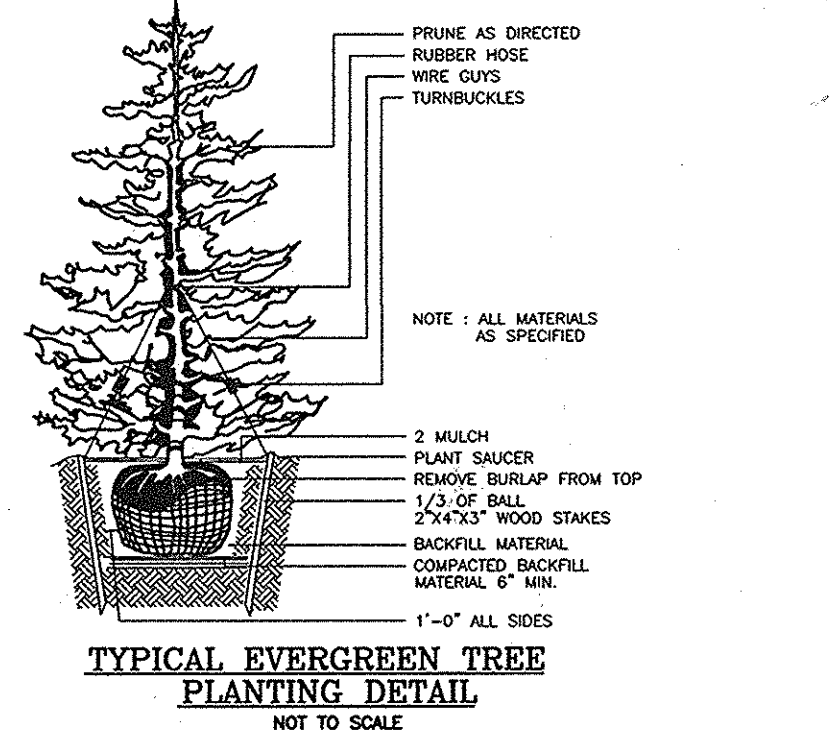

APPROVED JULY 17, 2014
PLANNING BOARD OF HOWARD COUNTY

APPROVED: HOWARD COUNTY DEPARTMENT OF PLANNING AND ZONING

Chief, Development Engineering Division: *[Signature]* DATE: 6-8-15

Chief, Division of Land Development: *[Signature]* DATE: 7-07-15

Director: *[Signature]* DATE: 7-7-15

DEVELOPER'S/OWNER'S LANDSCAPE CERTIFICATE


I/WE CERTIFY THAT LANDSCAPING SHOWN ON THIS PLAN WILL BE DONE ACCORDING TO THE PLAN, SECTION 16.124 OF THE HOWARD COUNTY CODE AND THE LANDSCAPE MANUAL. I/WE FURTHER CERTIFY THAT UPON COMPLETION OF THE PROJECT, A LETTER OF LANDSCAPE INSTALLATION, ACCOMPANIED BY AN EXECUTED ONE YEAR GUARANTEE OF PLANT MATERIALS, WILL BE SUBMITTED TO THE DEPARTMENT OF PLANNING AND ZONING.

DEVELOPER'S/OWNER'S NAME: *[Signature]*

MICRO-BIORETENTION PLANTING SCHEDULE

QTY	BOTANICAL NAME/COMMON NAME	SIZE	REMARKS
16	LINERA BENZON SPICEBUSH	5 GALLON	CONT
70	ILEX GLABRA INKERRY	3 GALLON	CONT
58	VIBURNUM TROBRIAN AMERICAN HIGHBUSH CRANBERRY	3 GALLON	CONT

SF X 75% X .0229 STEMS PER SQUARE FOOT = PLANTS REQUIRED




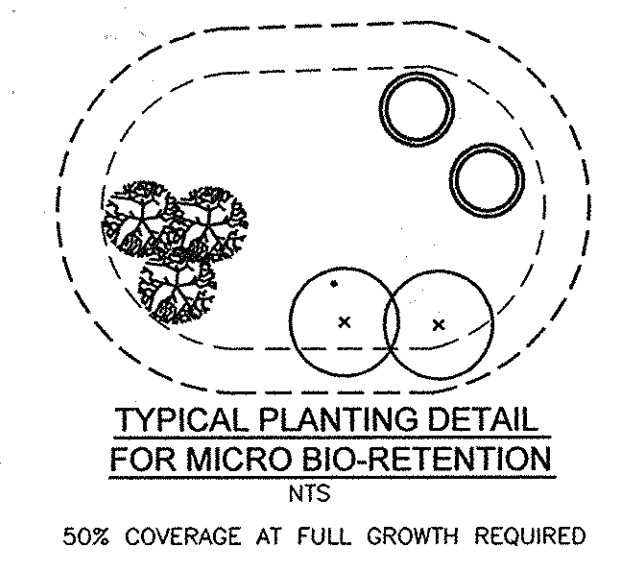


"MICRO-BIORETENTION" PLANTING SCHEDULE NOTES:

- ALL PLANT MATERIALS SHALL BE FULL AND HEAVY, BE WELL FORMED AND SYMMETRICAL, CONFORM TO THE MOST CURRENT AAS SPECIFICATIONS AND BE INSTALLED IN ACCORDANCE WITH HOWARD COUNTY PLANTING SPECIFICATIONS.
- CONTRACTOR SHALL VERIFY LOCATION OF ALL UNDERGROUND UTILITIES PRIOR TO DIGGING.
- FINAL LOCATION OF PLANT MATERIAL MAY NEED TO VARY TO MEET FINAL FIELD CONDITIONS. TREES SHALL NOT BE PLANTED IN THE BOTTOM OF DRAINAGE SWALES.
- CONTRACTOR SHALL VERIFY PLANT QUANTITIES PRIOR TO BIDDING. IF PLAN DIFFERS FROM LANDSCAPE SCHEDULE, THE PLAN SHALL GOVERN.
- SEE SHEET FOR TYPICAL PLANTING SPECIFICATIONS AND DETAILS.
- MICROBIORETENTION AREAS ARE TO BE PLANTED BASED ON A MINIMUM DENSITY OF 1000 STEMS PER PLANTED ACRE (0.2229 STEMS PER SQUARE FOOT). ABOVE PLANTING RATIOS ARE TO BE APPLIED TO THE AREAS PROVIDED IN THE ESDV SUMMARY.

MBR FACILITY	SURFACE AREA	REQUIRED PLANTINGS	PLANTINGS
MBR #1	450 SF	8	2 SPICEBUSH 8 INKERRY 6 AMERICAN HIGHBUSH CRANBERRY
MBR #2	550 SF	10	2 SPICEBUSH 10 INKERRY 8 AMERICAN HIGHBUSH CRANBERRY
MBR #3	450 SF	8	2 SPICEBUSH 8 INKERRY 6 AMERICAN HIGHBUSH CRANBERRY
MBR #4	450 SF	8	2 SPICEBUSH 8 INKERRY 6 AMERICAN HIGHBUSH CRANBERRY
MBR #5	550 SF	10	2 SPICEBUSH 10 INKERRY 8 AMERICAN HIGHBUSH CRANBERRY
MBR #6	600 SF	11	2 SPICEBUSH 10 INKERRY 10 AMERICAN HIGHBUSH CRANBERRY
MBR #7	500 SF	9	2 SPICEBUSH 8 INKERRY 8 AMERICAN HIGHBUSH CRANBERRY
MBR #8	450 SF	8	2 SPICEBUSH 8 INKERRY 6 AMERICAN HIGHBUSH CRANBERRY

50% COVERAGE AT FULL GROWTH REQUIRED

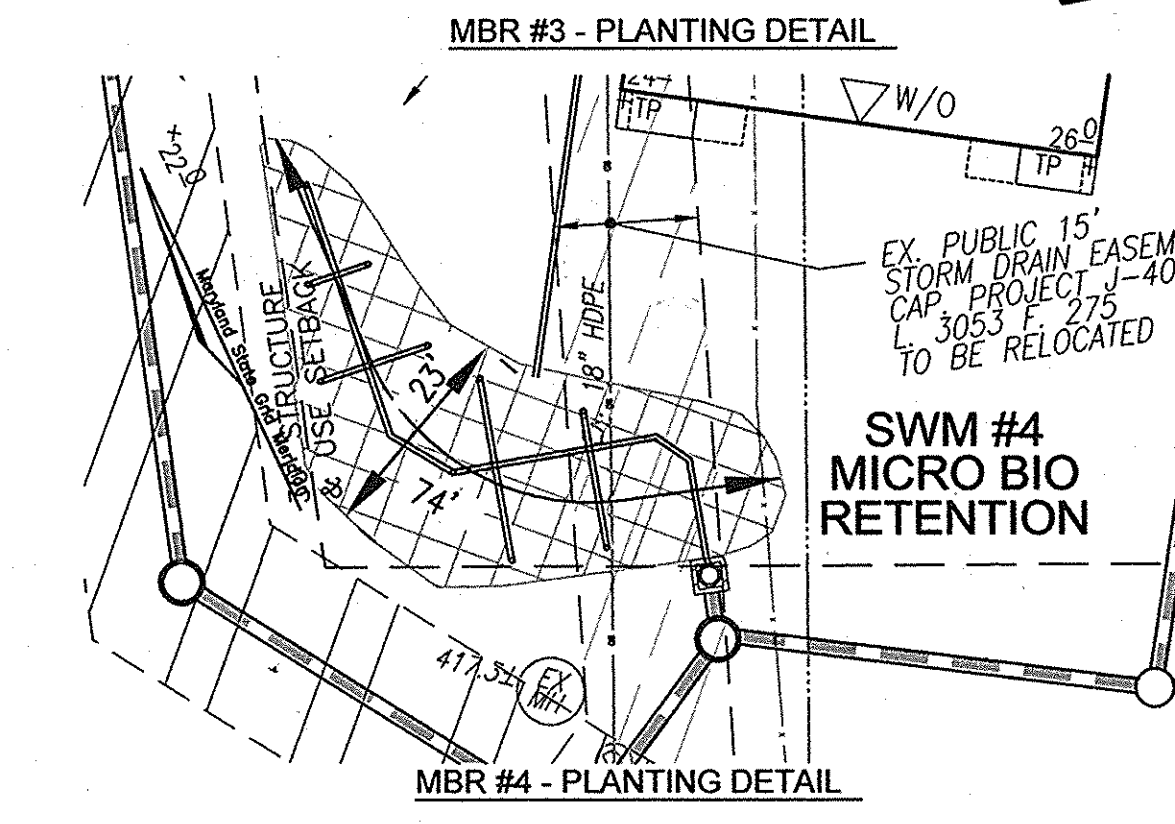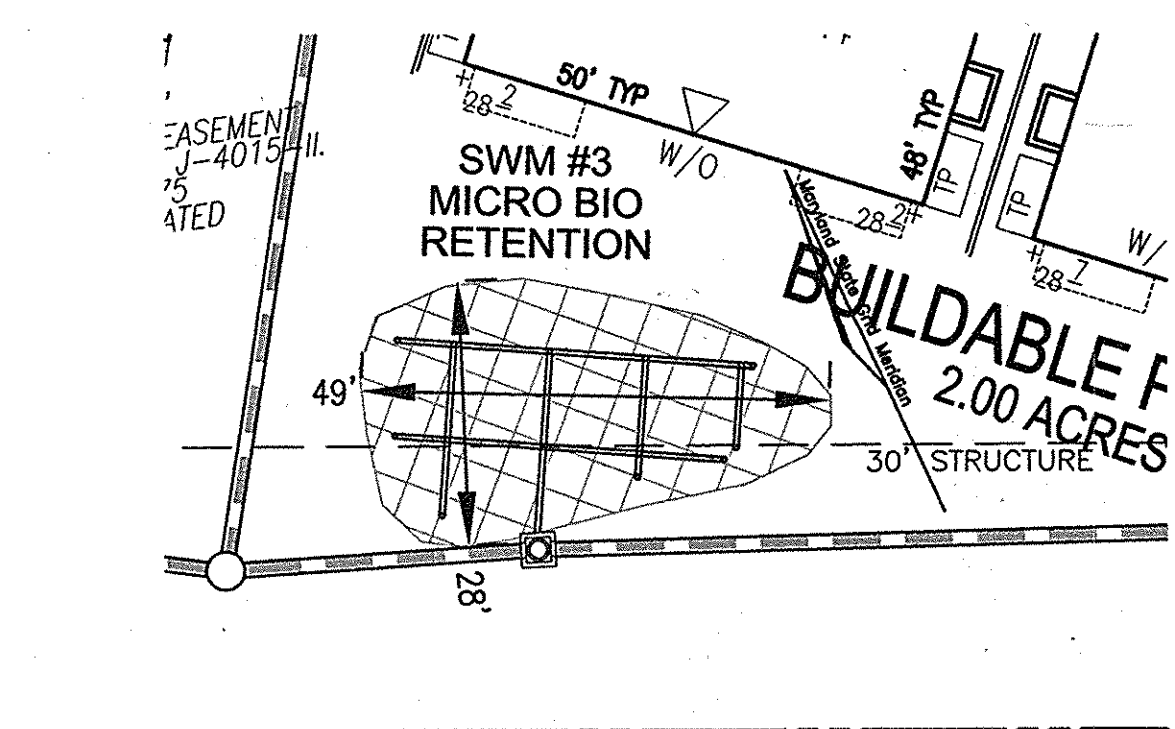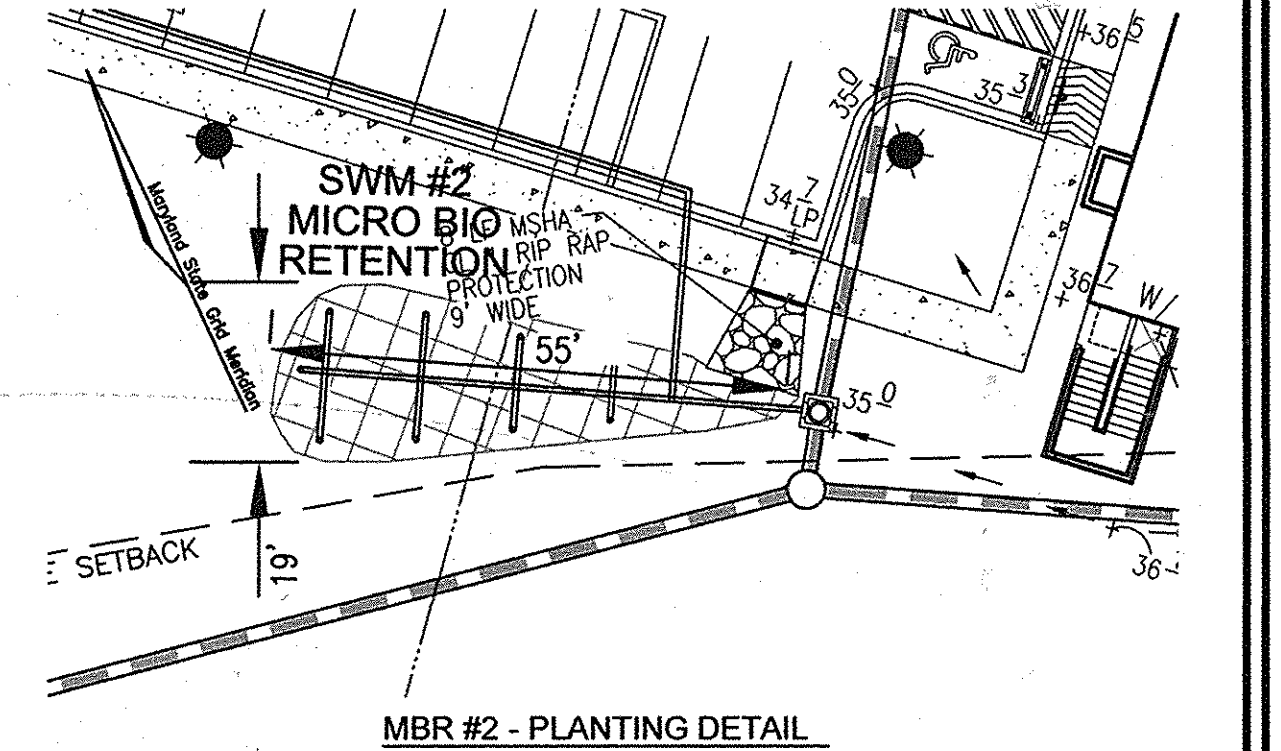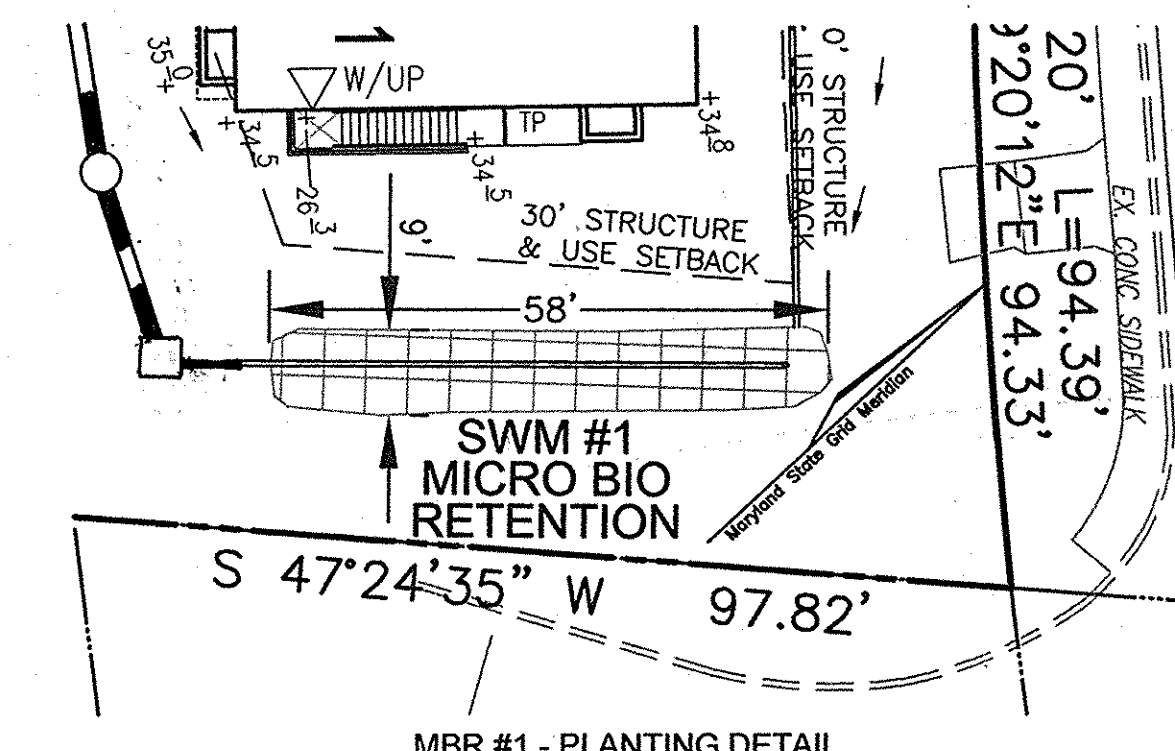

NO.	REVISION	DATE
1	REVISE STORM DRAIN AND SHC TO BUILDING	12/9/15

**SITE DEVELOPMENT PLAN
LANDSCAPE AND FOREST
CONSERVATION PLAN - NOTES AND DETAILS**

DEMIREL PLAZA
L15837-F-345

2ND ELECTION DISTRICT TAX MAP: 24 GRID: 1 PARCELS 62, 63 AND P/O 544 (LOT 112) HOWARD COUNTY, MARYLAND ZONED: OT

ROBERT H. VOGEL ENGINEERING, INC.
ENGINEERS • SURVEYORS • PLANNERS
8407 MAIN STREET ELLICOTT CITY, MD 21043 TEL: 410.461.7666 FAX: 410.461.8961

DESIGN BY: EDS
DRAWN BY: RVE
CHECKED BY: RHW
DATE: MAY 2015
SCALE: AS SHOWN
W.O. NO.: 11-01


PROFESSIONAL CERTIFICATE
I HEREBY CERTIFY THAT THESE DOCUMENTS WERE PREPARED OR APPROVED BY ME AND THAT I AM A DULY LICENSED PROFESSIONAL ENGINEER UNDER THE LAWS OF THE STATE OF MARYLAND, LICENSE NO. 16193 EXPIRATION DATE: 09-27-2016

ROBERT H. VOGEL, PE No. 16193


13 SHEET OF 15

LIGHTING PLAN

SCALE: 1"=30'

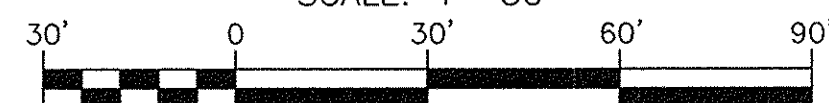


WASHINGTON Series
Cast Aluminum Posts

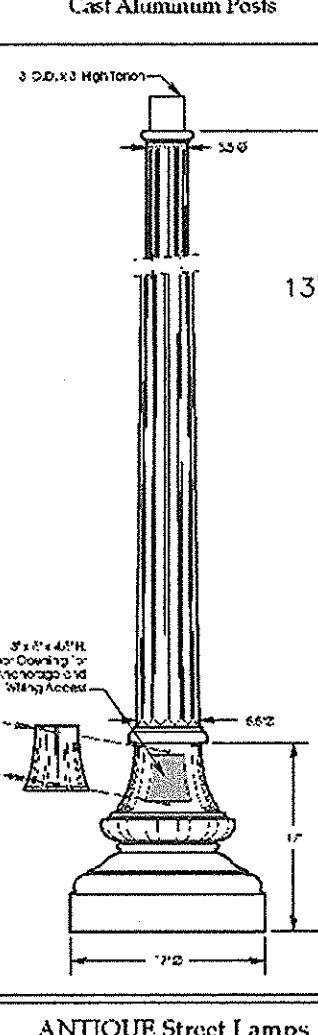


ORDERING INFORMATION

Item	Material	Quantity	Notes
1. Post	ALUMINUM	1	See Notes
2. Base	ALUMINUM	1	See Notes
3. Cap	ALUMINUM	1	See Notes
4. Bolt	ALUMINUM	1	See Notes
5. Nut	ALUMINUM	1	See Notes
6. Washer	ALUMINUM	1	See Notes
7. Sealant	SILICONE	1	See Notes

ANCHORAGE GUIDE

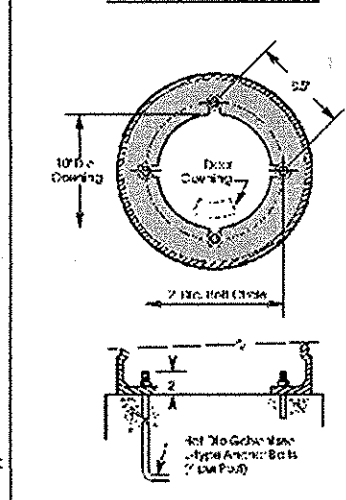

ANTIQUE RG LED SERIES
STREET LAMPS

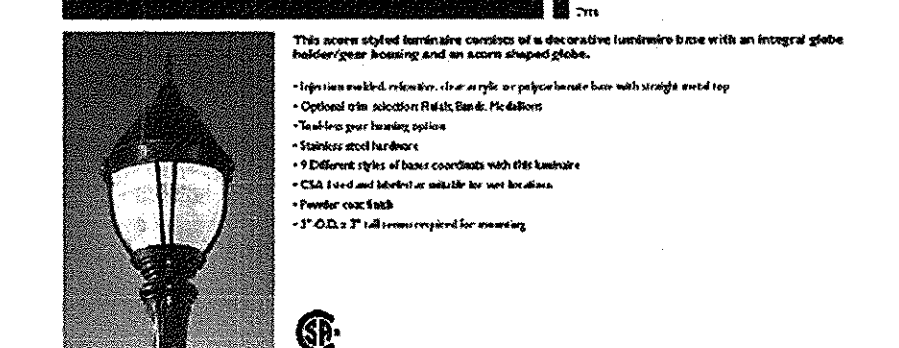

Model	Height	Finish	Options
AD 9	13'-7"	Black	LED, 150W, 120V
AD 10	13'-7"	Black	LED, 150W, 120V
AD 11	13'-7"	Black	LED, 150W, 120V
AD 12	13'-7"	Black	LED, 150W, 120V
AD 13	13'-7"	Black	LED, 150W, 120V
AD 14	13'-7"	Black	LED, 150W, 120V
AD 15	13'-7"	Black	LED, 150W, 120V
AD 16	13'-7"	Black	LED, 150W, 120V
AD 17	13'-7"	Black	LED, 150W, 120V
AD 18	13'-7"	Black	LED, 150W, 120V
AD 19	13'-7"	Black	LED, 150W, 120V
AD 20	13'-7"	Black	LED, 150W, 120V

LEGEND



- PROPERTY LINE
- RIGHT-OF-WAY LINE
- ADJACENT PROPERTY LINE
- EXISTING CONTOUR
- EXISTING CURB AND GUTTER
- PROPOSED CURB AND GUTTER
- EXISTING UTILITY POLE
- EXISTING LIGHT POLE
- EXISTING MAILBOX
- EXISTING SIGN
- EXISTING SANITARY MANHOLE
- EXISTING SANITARY LINE
- EXISTING FIRE HYDRANT
- EXISTING WATER LINE
- EXISTING TREELINE

LUMINAIRE SCHEDULE

Symbol	Label	Qty	Catalog Number	Description	Lamp	File	Lumens	LLF	Watts
■	AD 9	9	ROUX X 30LED	RG LED ACORN POST	30 LED ARRAY	ROUX X 30LED	3000	0.85	78.5

NOTE

1. ANY LIGHTING TO ILLUMINATE OFF-STREET PARKING AREAS SHALL BE SO ARRANGED AS TO DIRECT THE LIGHT DOWN TOWARDS THE PARKING AREA, AND AWAY FROM THE ADJOINING LOT IN RESIDENTIAL DISTRICTS AND ANY PUBLIC STREET RIGHT-OF-WAY, IN ACCORDANCE WITH SECTION 134.D OF THE ZONING REGULATIONS. LIGHT TRESPASS ONTO ANY OTHER PROPERTY ZONED OR USED FOR RESIDENTIAL PURPOSES SHALL BE LIMITED TO 0.1 FOOT CANDLES.

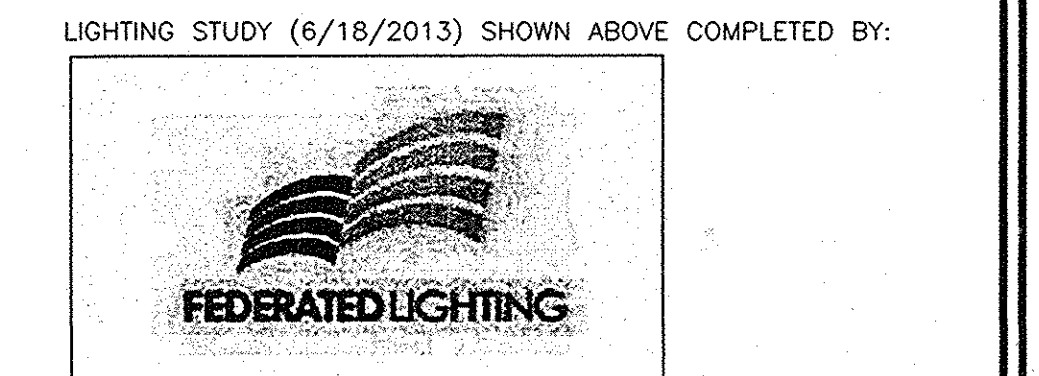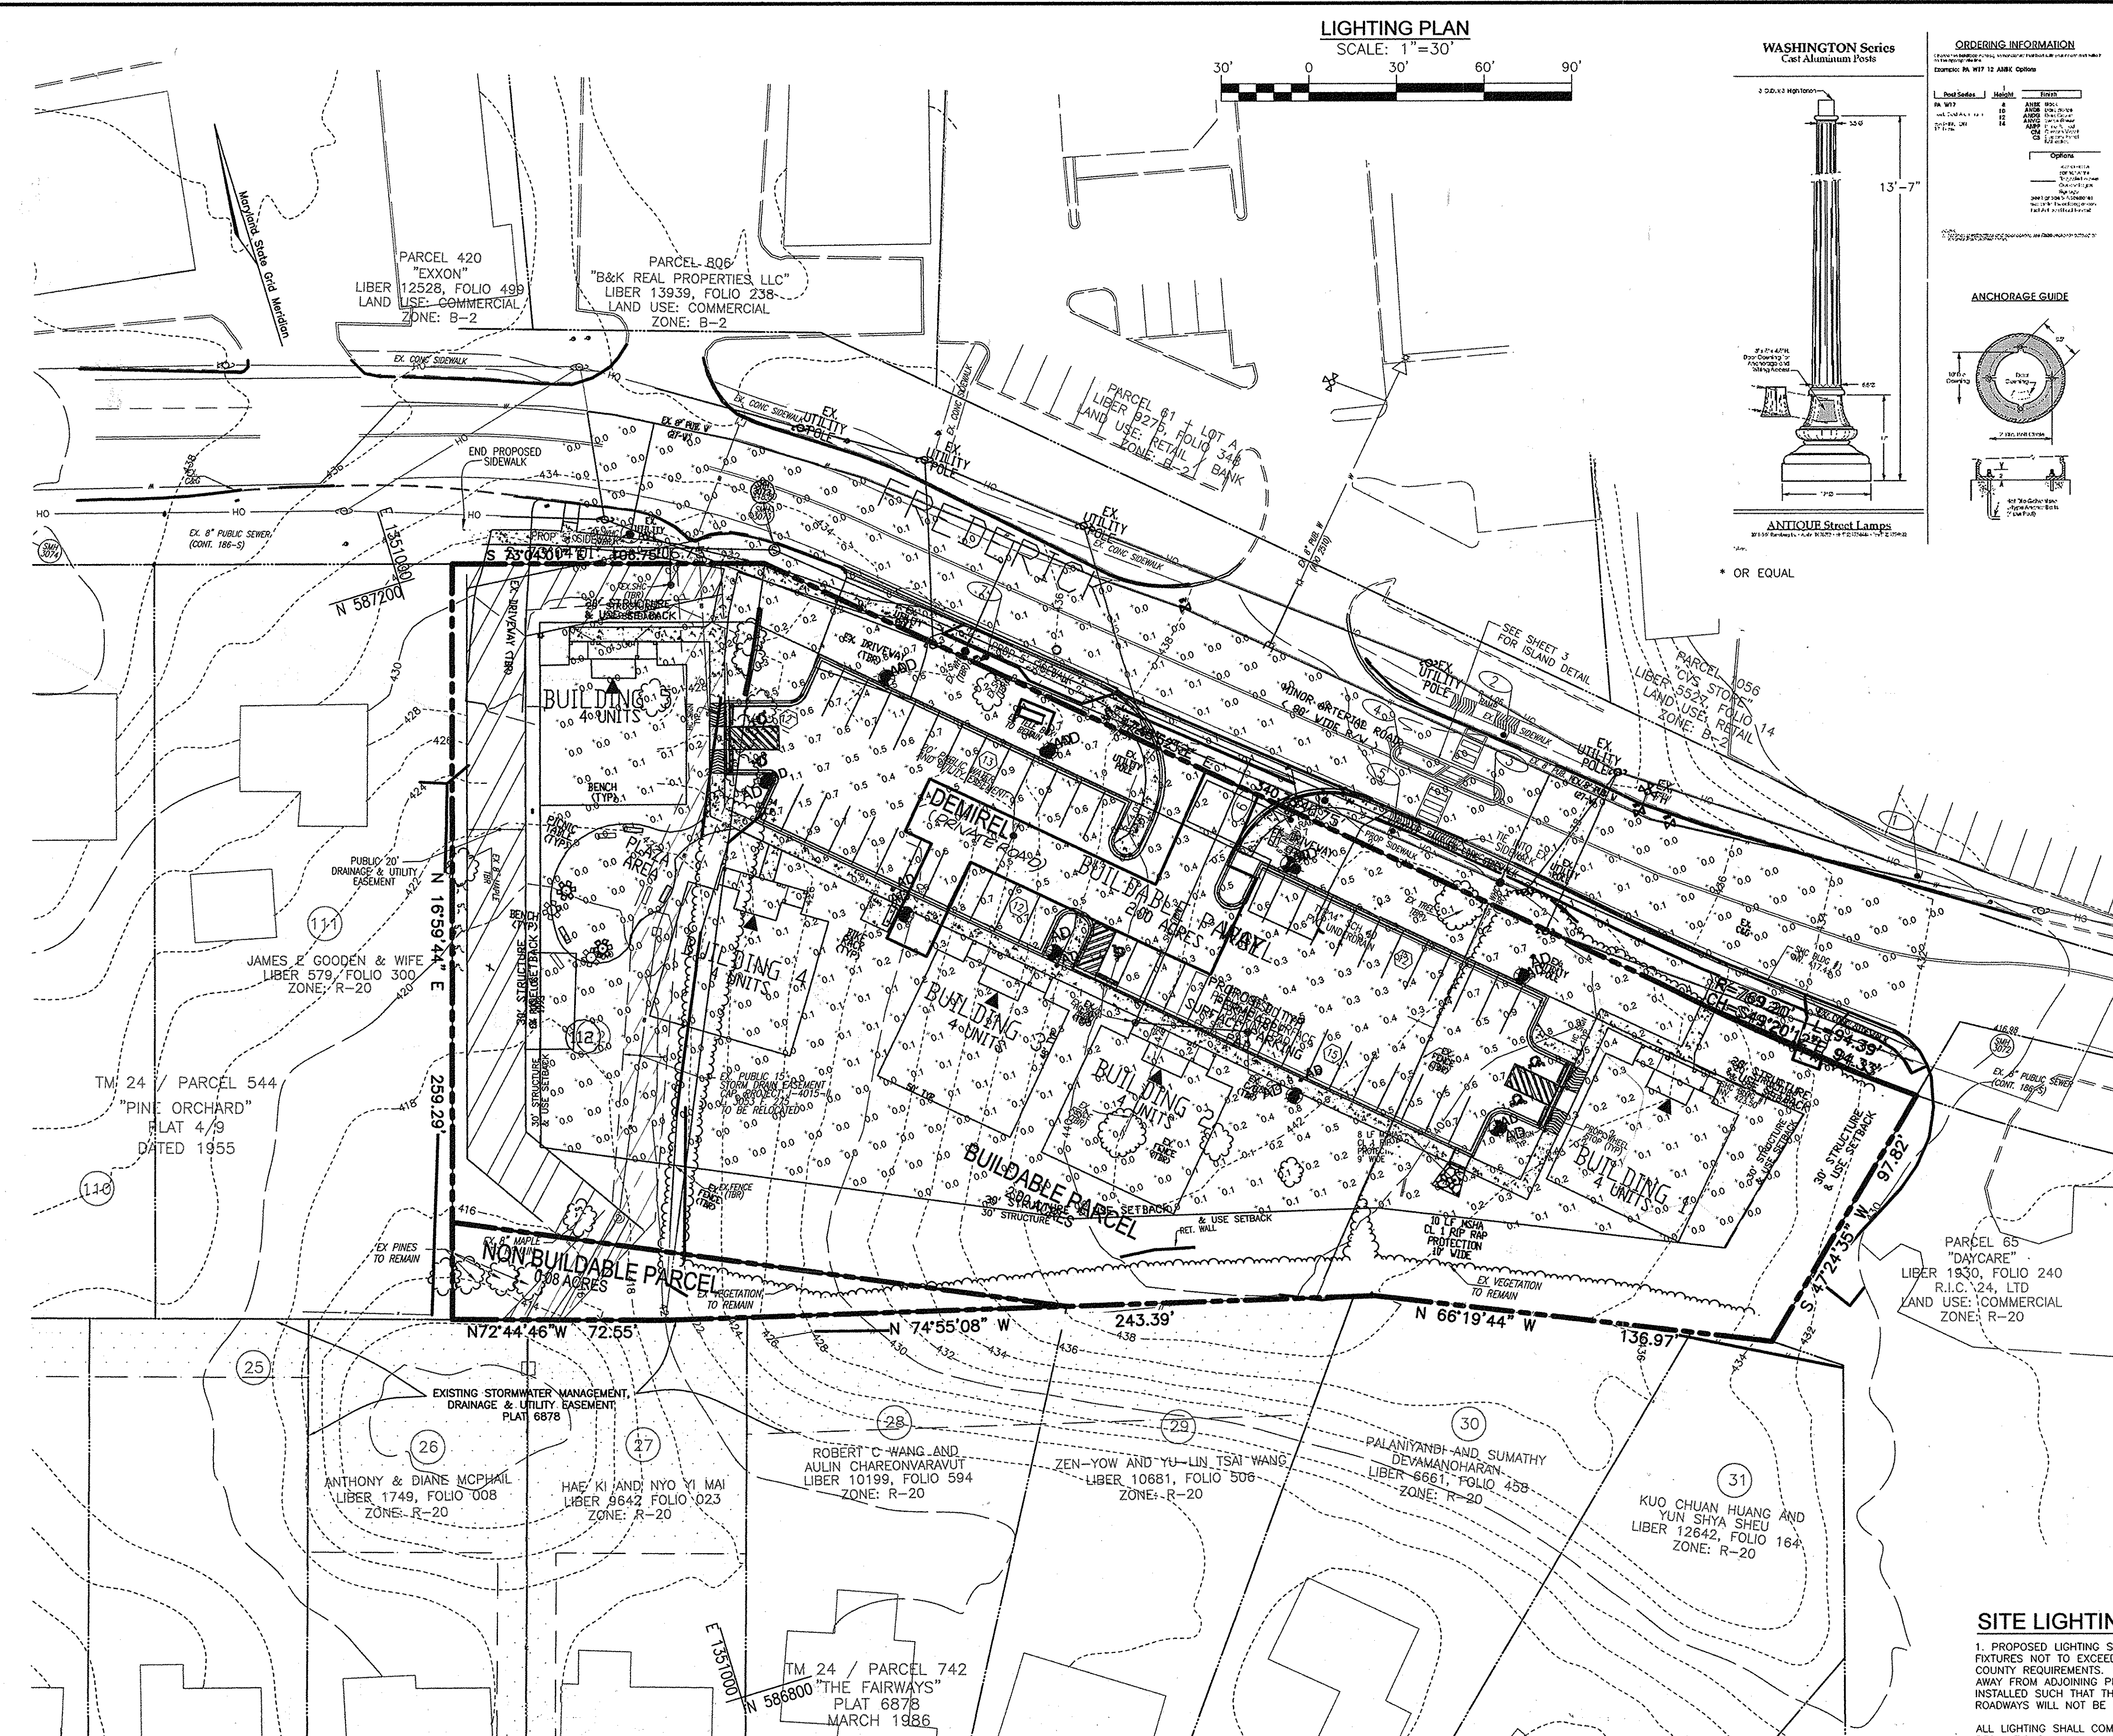

SITE LIGHTING:

- PROPOSED LIGHTING SHALL BE LIMITED TO BOLLARD OR OVERHEAD FIXTURES NOT TO EXCEED 14FT. IN HEIGHT AND SHALL MEET ALL COUNTY REQUIREMENTS. ALL LIGHTING SHALL BE DIRECTED DOWN AND AWAY FROM ADJOINING PROPERTIES VIA CUTOFF SHIELDS AND SHALL BE INSTALLED SUCH THAT THE SURROUNDING RESIDENTIAL AREAS AND ROADWAYS WILL NOT BE IMPACTED.
- ALL LIGHTING SHALL COMPLY WITH SECTION 134 OF THE ZONING REGULATIONS.
- LOCATE LIGHTING POLES A MINIMUM OF 3'-0" BEHIND FACE OF CURB TO CENTER, OR 1'-0" OFF EDGE OF SIDEWALK.
- POLE LOCATIONS SHALL BE COORDINATED WITH LANDSCAPING.

ATTORNEY

SANG OH
TALKIN & OH, LLP
5100 DORSEY HALL DRIVE
ELLCOTT CITY, MD 21042
PHONE: (410) 964-0300

OWNER/DEVELOPER

VELI DEMIREL
44087 HIGH POINT ROAD
ELLCOTT CITY, MD 21042
PHONE: (410) 440-1242

APPROVED: HOWARD COUNTY DEPARTMENT OF PLANNING AND ZONING
 [Signature] 6-8-15
 CHIEF, DEVELOPMENT ENGINEERING DIVISION
 [Signature] 7-7-15
 CHIEF, DIVISION OF LAND DEVELOPMENT
 [Signature] 7-7-15
 DIRECTOR

APPROVED JULY 17, 2014
 PLANNING BOARD OF HOWARD COUNTY
 [Signature]

NOTES

Disclaimer:
 Calculations are based on procedures established by the IESNA or standard industry practice. Output performance is based on input data as provided to Federated Lighting by others and believed to be accurate.
 This study is intended to assist with lighting design and is not a substitute for an independent lighting analysis and testing for lighting safety and suitability. Federated Lighting cannot be held responsible for variations in actual situations which can effect calculated output.

NO. _____ REVISION _____ DATE _____

SITE DEVELOPMENT PLAN
LIGHTING PLAN
DEMIREL PLAZA
 L.15837.F.345

2ND ELECTION DISTRICT PARCELS 62, 63 AND P/O 544 (LOT 112) HOWARD COUNTY, MARYLAND

ROBERT H. VOGEL ENGINEERING, INC.
 ENGINEERS • SURVEYORS • PLANNERS
 8407 MAIN STREET TEL: 410.461.7666
 ELLICOTT CITY, MD 21043 FAX: 410.461.8961

DESIGN BY: EDS
 DRAWN BY: RVE
 CHECKED BY: RHY
 DATE: MAY 2015
 SCALE: AS SHOWN
 W.O. NO.: 11-01

14 SHEET OF 15

NOTE:



ALL TRAFFIC CONTROL SIGNAGE TO BE LOCATED IN FIELD AS DIRECTED BY HOWARD COUNTY TRAFFIC

NOTE:


REFER TO SEQUENCE OF CONSTRUCTION - SHEET 7
 PEDESTRIAN REFUGE ISLAND CONSTRUCTION SHALL OCCUR UPON THE COMPLETION OF ONSITE WORK SIMULTANEOUSLY WITH FREDERICK ROAD IMPROVEMENTS AND SITE ENTRANCE WORK.
 CONTACT THE HOWARD COUNTY TRAFFIC DIVISION TO FIELD LOCATE SIGNS FOR EACH REQUIRED CONSTRUCTION SEQUENCE

GENERAL NOTES

1. CONTACT HOWARD COUNTY TRAFFIC DIVISION (410-313-5752) PRIOR TO INSTALLATION OF SIGNS AND STRIPING.
2. SIGNAGE / MAINTENANCE OF TRAFFIC SHALL BE AS DIRECTED BY THE MARYLAND STANDARD MD-104.02-06 (SHOWN HEREON). ANY REVISIONS TO THIS STANDARD SHALL BE AS DIRECTED BY THE HOWARD COUNTY TRAFFIC DIVISION (410) 313-5752
3. HOWARD COUNTY TRAFFIC DIVISION TO INSPECT AND APPROVE CURB FORMS PRIOR TO POURING CONCRETE.
4. PEDESTRIAN CROSSING STRIPING WILL BE PROVIDED IN ACCORDANCE WITH SHEET 3.
5. SEE SHEET 3 FOR SIGNING AND MARKINGS.

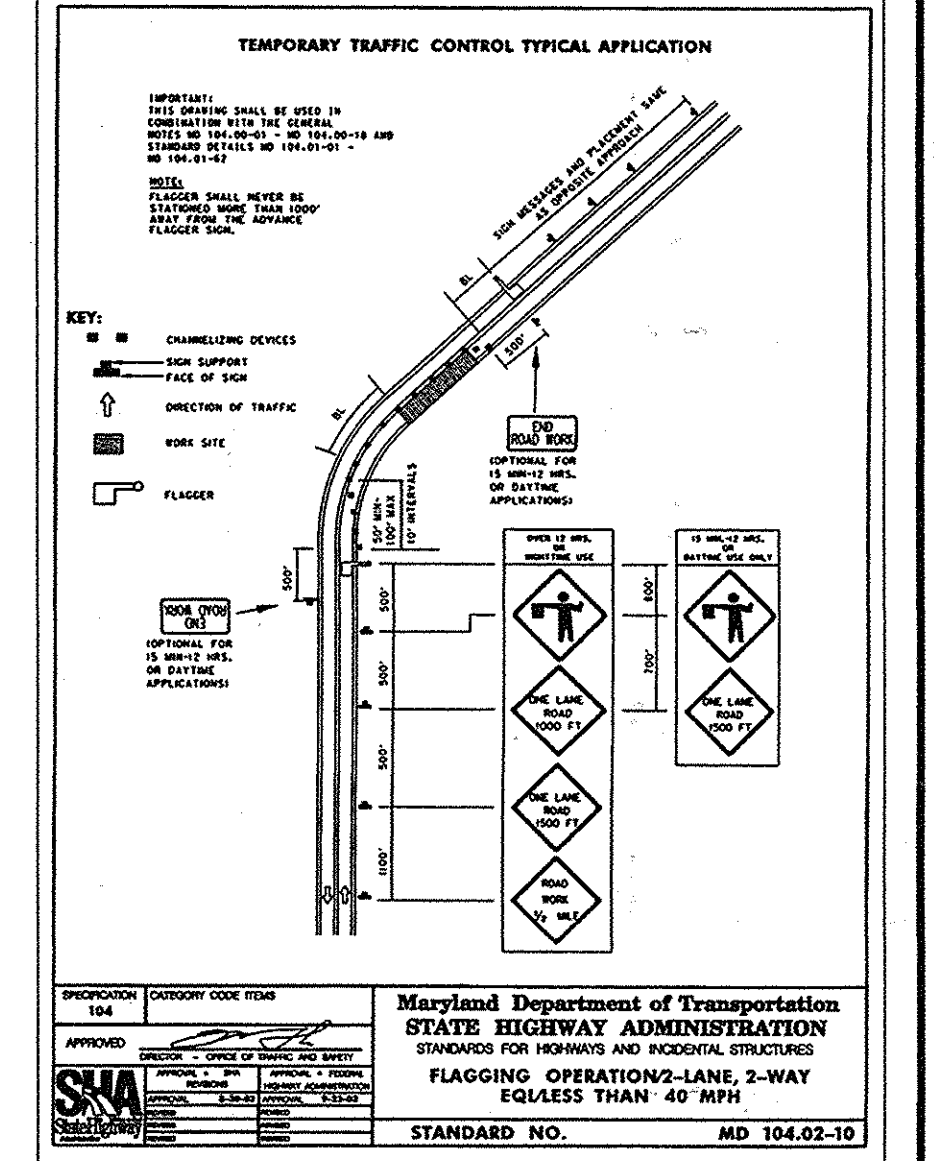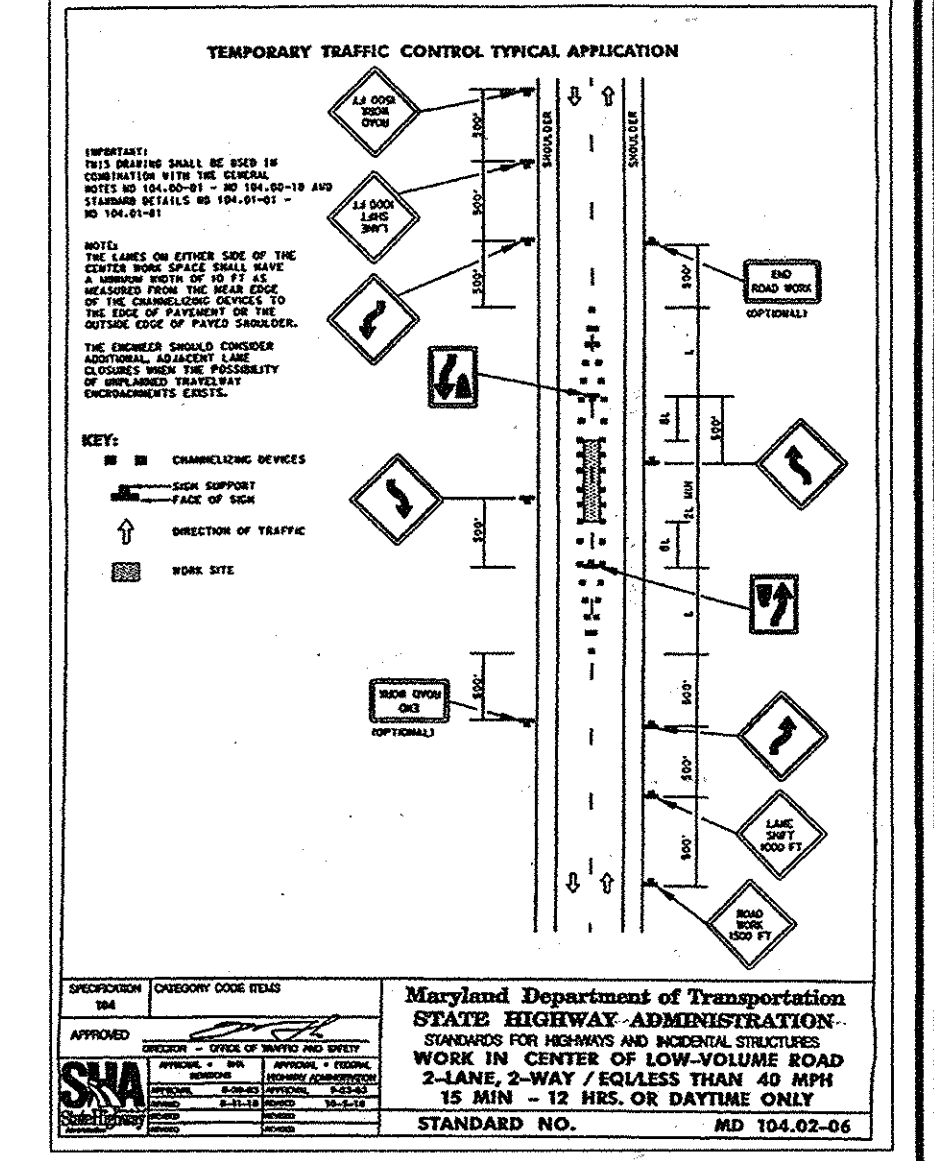

NOTE:
 A PRE-CONSTRUCTION MEETING WITH THE TRAFFIC DIVISION AND C.I.D. WILL BE REQUIRED.
 PRIOR TO THE START OF CONSTRUCTION OF THE PEDESTRIAN REFUGE ISLAND, THE CONTRACTOR SHALL MEET WITH THE CONSTRUCTION INSPECTION DIVISION (C.I.D.) INSPECTOR AND HOWARD COUNTY TRAFFIC TO REVIEW THE CONSTRUCTION SEQUENCE AND GO OVER THE MAINTENANCE OF TRAFFIC (M.O.T.) PLAN AND ANY DETAILS NOT INCLUDED ON THESE PLANS

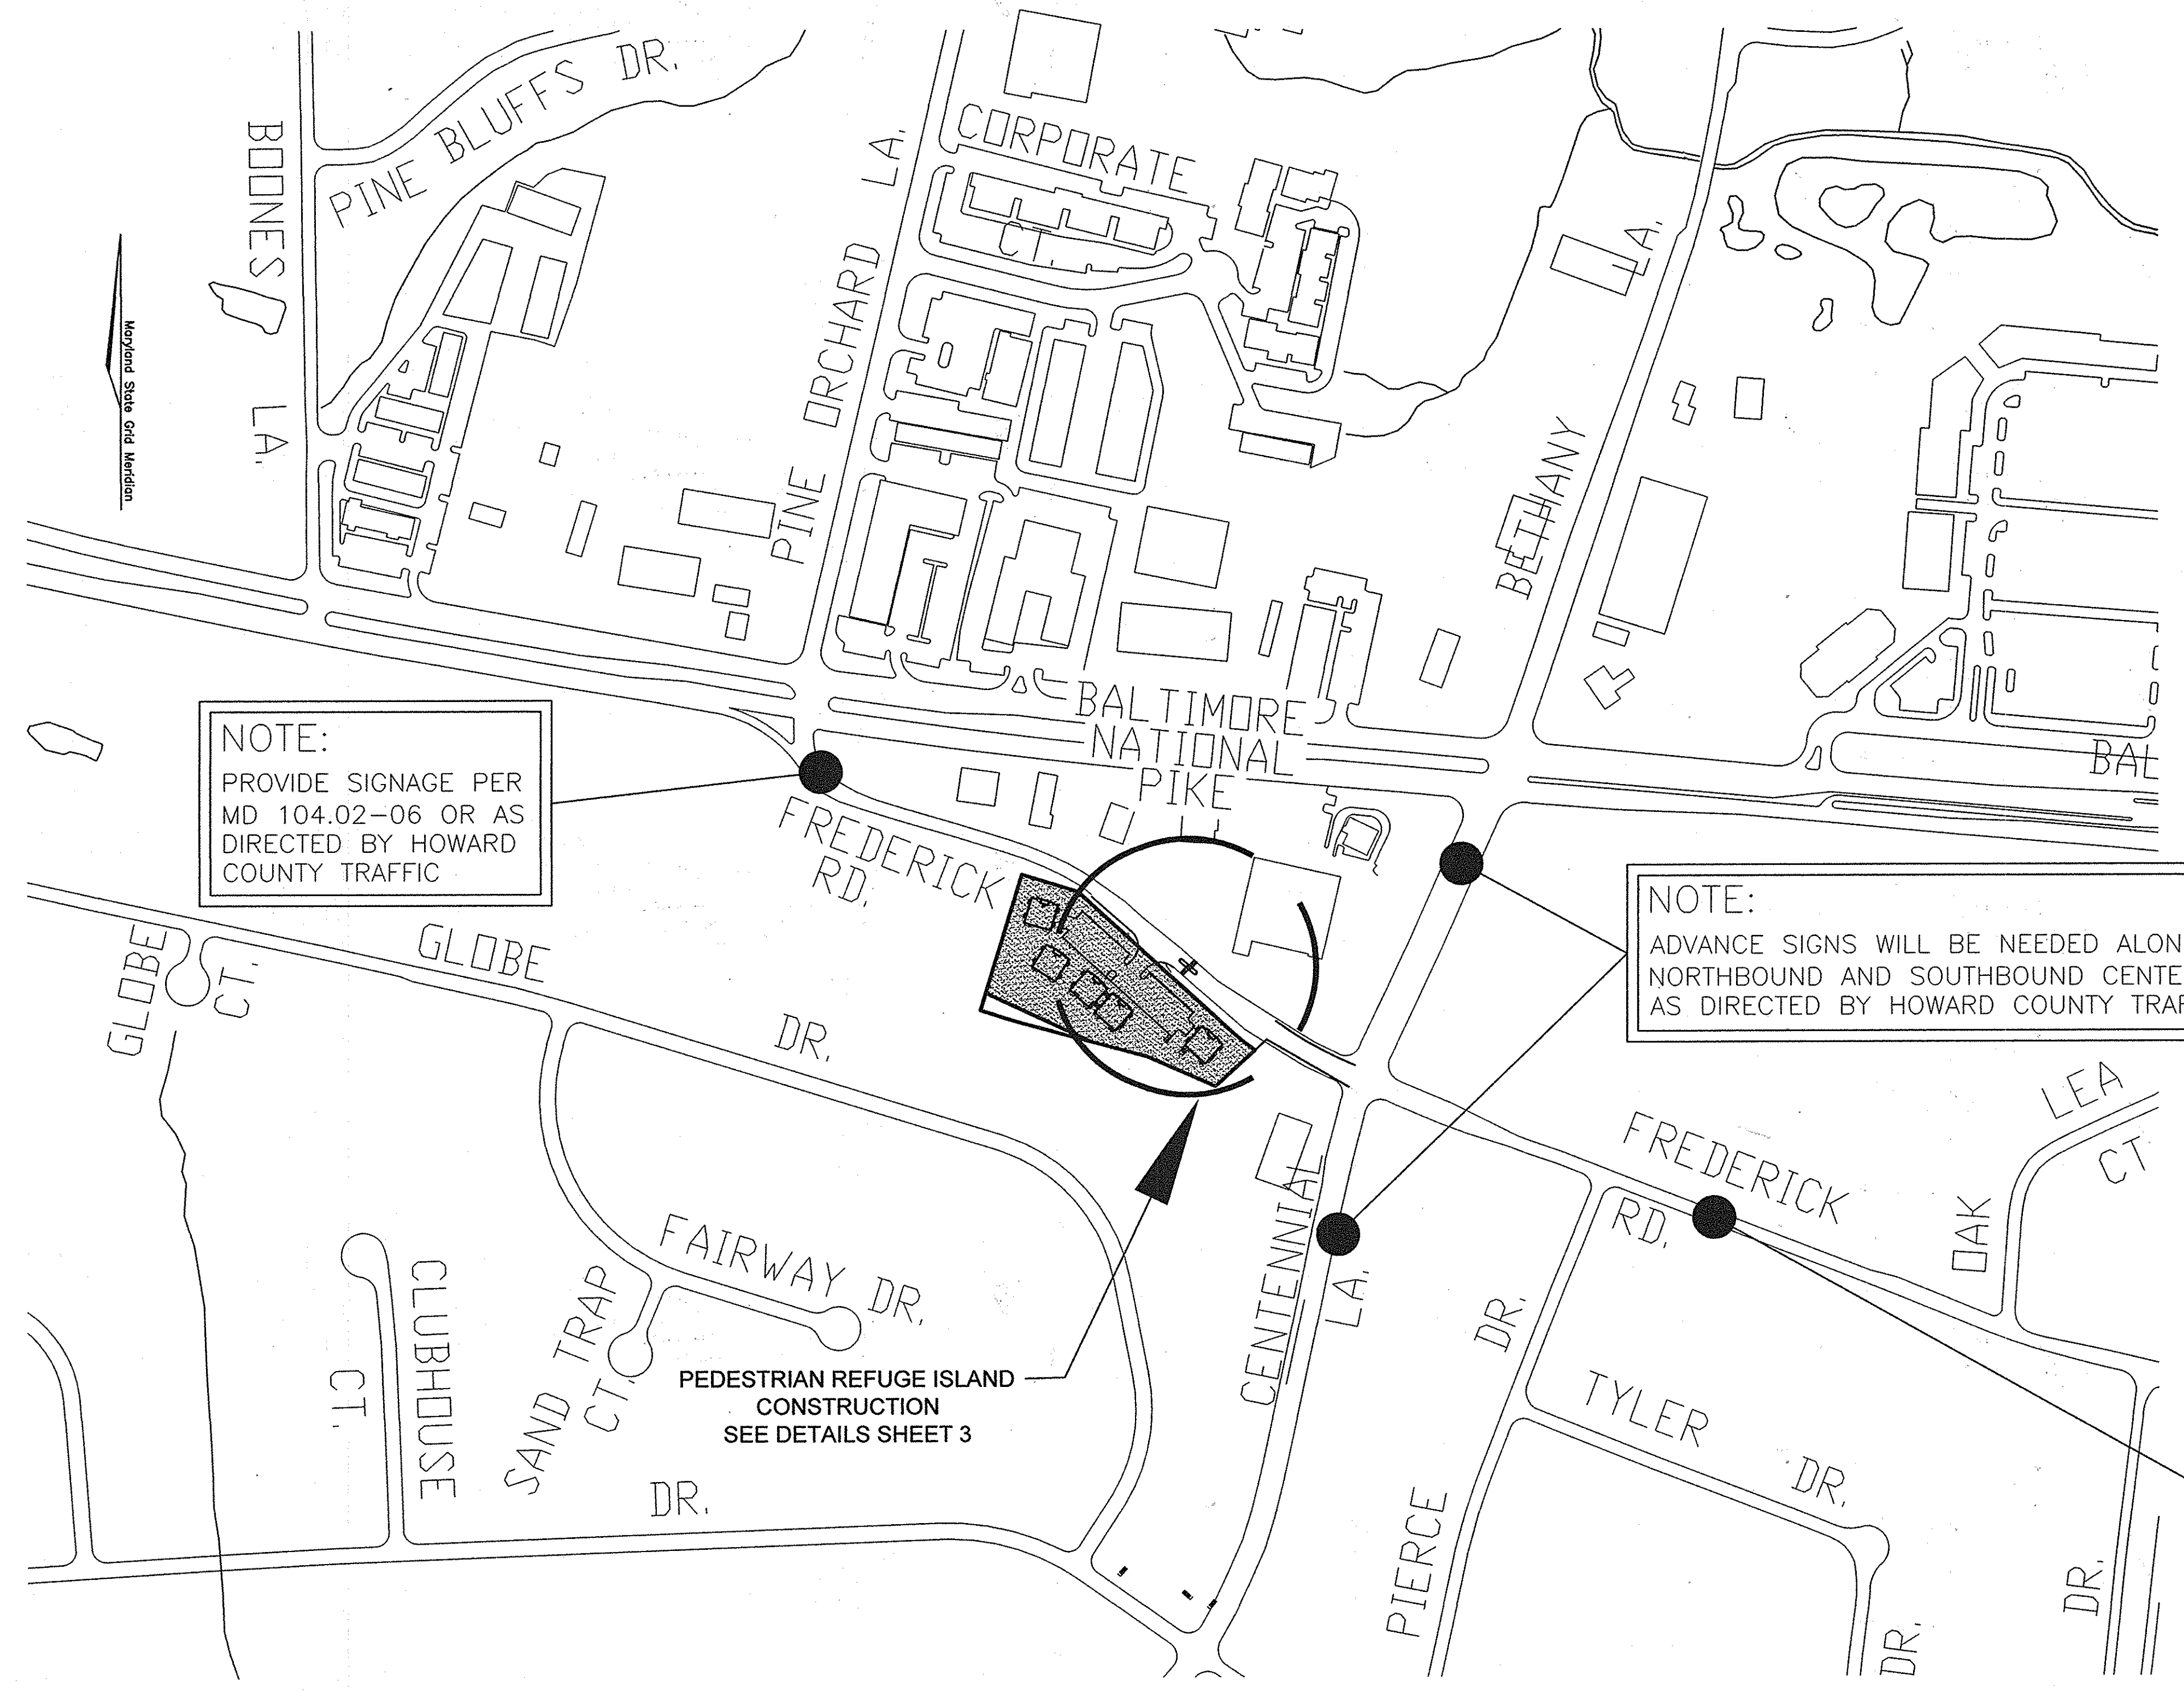

NOTE:
 PROVIDE SIGNAGE PER MD 104.02-06 OR AS DIRECTED BY HOWARD COUNTY TRAFFIC

NOTE:
 ADVANCE SIGNS WILL BE NEEDED ALONG BOTH NORTHBOUND AND SOUTHBOUND CENTENNIAL LANE AS DIRECTED BY HOWARD COUNTY TRAFFIC

NOTE:
 PROVIDE SIGNAGE PER MD 104.02-06 OR AS DIRECTED BY HOWARD COUNTY TRAFFIC

MAINTENANCE OF TRAFFIC PLAN
 SCALE: 1"=200'


NOTE:

- REFER TO SHEET 3 FOR:
1. FREDERICK ROAD PAVEMENT MARKING DETAILS
 2. PEDESTRIAN REFUGE ISLAND / ROAD SIGNAGE LOCATIONS
 3. PEDESTRIAN REFUGE ISLAND DETAIL

APPROVED: HOWARD COUNTY DEPARTMENT OF PLANNING AND ZONING
 [Signature] 6-16-15
 CHIEF, DEVELOPMENT ENGINEERING DIVISION DATE
 [Signature] 7-7-15
 CHIEF, DIVISION OF LAND DEVELOPMENT DATE
 [Signature] 7-7-15
 DIRECTOR DATE

ATTORNEY
 SANG OH
 TALKIN & OH, LLP
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PROFESSIONAL CERTIFICATE
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NO.	REVISION	DATE

SITE DEVELOPMENT PLAN
MAINTENANCE OF TRAFFIC PLAN
DEMIREL PLAZA
 L15837 F345
 2ND ELECTION DISTRICT PARCELS 62, 63 AND P/O 544 (LOT 112)
 TAX MAP: 24 GRID: 1 HOWARD COUNTY, MARYLAND
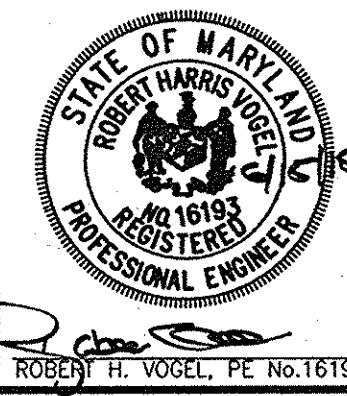
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