SHEET INDEX DESCRIPTION TITLE SHEET EXISTING CONDITIONS PLAN AND SOILS MAP SITE DEVELOPMENT PLAN FINAL GRADING AND SEDIMENT CONTROL PLAN SEDIMENT CONTROL AND STORM WATER NOTES AND DETAILS

SITE DEVELOPMENT PLAN VIIIAGE OF HARPERS CHOICE

GENERAL NOTES

WATER AND SEWER PROFILES

. ALL CONSTRUCTION SHALL BE IN ACCORDANCE WITH THE LATEST STANDARDS AND SPECIFICATIONS. OF HOWARD COUNTY PLUS MSHA STANDARDS AND SPECIFICATIONS, IF APPLICABLE.

THE CONTRACTOR SHALL NOTIFY THE DEPARTMENT OF PUBLIC WORKS/BUREAU OF ENGINEERING/ CONSTRUCTION INSPECTION DIVISION AT (410) 313-1880 AT LEAST FIVE (5) WORKING DAYS PRIOR TO THE START OF WORK.

THE CONTRACTOR SHALL NOTIFY "MISS UTILITY" AT 1-800-257-7777 AT LEAST 48 HOURS PRIOR TO ANY EXCAVATION WORK

. TRAFFIC CONTROL DEVICES, MARKINGS, AND SIGNING SHALL BE IN ACCORDANCE WITH THE LATEST EDITION OF THE MANUAL ON JNIFORM TRAFFIC CONTROL DEVICES (MUTCD). ALL STREET AND REGULATORY SIGNS SHALL BE IN PLACE PRIOR TO THE PLACEMENT OF ANY ASPHALT.

ALL PLAN DIMENSIONS ARE TO EDGE OF PAVEMENT UNLESS OTHERWISE NOTED.

. THE PROPERTY BOUNDARY AND EXISTING TOPOGRAPHY IS TAKEN FROM FIELD RUN SURVEY WITH MAXIMUM TWO FOOT CONTOUR INTERVALS PREPARED BY PATTON HARRIS RUST & ASSOCIATES DATED JUNE 2006.

THE COORDINATES SHOWN HEREON ARE BASED UPON THE HOWARD COUNTY GEODETIC CONTROL WHICH IS BASED UPON THE MARYLAND STATE PLANE COORDINATE SYSTEM. HOWARD COUNTY MONUMENT NOS. 29G5 AND 29GA WERE USED FOR THIS

8. WATER IS PUBLIC.

9. SEWER IS PUBLIC.

D. THE EXISTING UTILITIES ARE BASED ON INFORMATION GATHERED FROM THE DEPT. OF PUBLIC WORKS; CONTRACT NO. 34-3307-D

11. ANY DAMAGED TO THE COUNTY'S RIGHT—OF—WAY SHALL BE CORRECTED AT THE DEVELOPER'S EXPENSE.

12. SHC ELEVATIONS SHOWN ARE LOCATED AT THE PROPERTY.

13. THE STORMWATER MANAGEMENT REQUIREMENTS FOR THIS SITE WILL BE MET BY THE USE OF STORMWATER CREDITS IN ACCORDANCE WITH THE MARYLAND 2000 STORMWATER MANAGEMENT DESIGN MANUAL AND THE HOWARD COUNTY DESIGN MANUAL CREDITS INCLUDE ROOFTOP AND NON-ROOFTOP DISCONNECT AND GRASS CHANNEL CREDITS.

4. APPROXIMATE LOCATION OF EXISTING UTILITIES ARE SHOWN. THE CONTRACTOR SHALL TAKE ALL NECESSARY PRECAUTIONS TO PROTECT THE EXISTING UTILITIES AND MAINTAIN UNINTERRUPTED SERVICE. ANY DAMAGE INCURRED DUE TO CONTRACTOR'S OPERATION SHALL BE REPAIRED IMMEDIATELY AT THE CONTRACTOR'S EXPENSE. EXISTING UTILITIES ARE SHOWN BASED ON THE BEST AVAILABLE INFORMATION.

15. THERE IS NO FLOODPLAIN ON THIS SITE BASED ON FIRM MAP # 240044, PANEL 0027.

16. THE SUBJECT PROPERTY ZONED (NT) NEW TOWN PER THE 2/2/04 COMPREHENSIVE ZONING PLAN AND PER THE "COMP LITE" ZONING REGULATION AMENDMENTS EFFECTIVE 7/28/06.

17. ALL ELEVATIONS SHOWN ARE BASED ON THE U.S.C. AND G.S. MEAN SEA LEVEL DATUM, 1929.

18. THE CONTRACTOR SHALL TEST PIT EXISTING UTILITIES AT LEAST (5) DAYS BEFORE STARTING WORK SHOWN ON THESE DRAWINGS.

19. CONTRACTOR IS SOLELY RESPONSIBLE FOR CONSTRUCTION MEANS, METHODS, TECHNIQUES, SEQUENCES, PROCEDURES, AND SAFETY PRECAUTIONS AND PROGRAMS.

20. PIPE SHALL NOT BE INSTALLED BY THE CONTRACTOR UNTIL THE LENGTH CALLED FOR AT EACH STATION HAS BEEN APPROVED BY THE ENGINEER IN THE FIELD.

21. NO PIPE SHALL BE LAID UNTIL LINES OF EXCAVATION HAVE BEEN BROUGHT WITHIN 6" OF FINISHED GRADE

22. ALL PIPE ELEVATIONS SHOWN ARE INVERT ELEVATIONS.

23. PROFILE STATIONS SHALL BE ADJUSTED AS NECESSARY TO CONFORM TO PLAN DIMENSIONS.

24. ALL FILL AREAS WITHIN ROADWAY AND UNDER STRUCTURES TO BE COMPACTED TO A MINIMUM OF 95% COMPACTION OF AASHTO T180.

BUFFERS, STREAM BUFFERS, FLOODPLAIN, OR STEEP SLOPES,

25. GRADING, REMOVAL OF VEGETATIVE COVER AND TREES AND PAVING ARE NOT PERMITTED IN WETLANDS, STREAMS, WETLAND

26. BASED ON AVAILABLE COUNTY MAPS AND RECORDS, THERE ARE NO HISTORIC STRUCTURES OR KNOWN CEMETERIES LOCATED ON THE SUBJECT PROPERTY.

27. THIS SITE IS EXEMPT FROM FOREST CONSERVATION (AS PER SECTION 16.1202(b)(1)(iv) OF THE SUBDIVISION AND LAND DEVELOPMENT REGULATIONS) DUE TO THE FACT THAT IT IS PART OF A PLANNED UNIT DEVELOPMENT WHICH HAS PRELIMINARY DEVELOPMENT PLAN APPROVAL AND 50% OR MORE OF THE LAND IS RECORDED AND SUBSTANTIALLY DEVELOPED BEFORE

28. THIS PLAN HAS BEEN PREPARED IN ACCORDANCE WITH THE PROVISIONS OF THE HOWARD COUNTY LANDSCAPE MANUAL, WHICH HAS NO REQUIREMENTS FOR LANDSCAPING FOR THIS SITE.

29. FOR FLAG OR PIPE STEM LOTS, REFUSE COLLECTION, SNOW REMOVAL AND ROAD MAINTENANCE ARE PROVIDED TO THE JUNCTION OF THE FLAG OR PIPE STEM AND THE ROAD RIGHT-OF-WAY LINE ONLY AND NOT ONTO THE FLAG OR PIPE STEM LOT

30. THIS LOT SHOWN COMPLIES WITH THE MINIMUM OWNERSHIP WIDTH AND LOT AREA AS REQUIRED BY THE MARYLAND DEPARTMENT OF THE ENVIRONMENT AND HOWARD COUNTY.

31. THE EXISTING SITE INFORMATION CONTAINS NO STEEP SLOPES OR MARLBORO CLAYS, WHICH WAS VERIFIED BY FIELD SURVEY.

32. SEE DEPT. OF PLANNING AND ZONING FILE NO.: F -94-11, FDP -194-A, SP-92-21, WP-92-218, WP-94-20, F-93-141,

33. IN ACCORDANCE WITH FDP PHASE 194-A, BAY WINDOWS OR CHIMNEYS NOT MORE THAN 10 FEET IN WIDTH MAY PROJECT NO MORE THAN 4 FEET INTO ANY SETBACKS, PORCHES OR DECKS MAY PROJECT NOT MORE THAN 3 FEET INTO THE FRONT OR REAR YARD SETBACKS. EXTERIOR BASEMENT AREAWAYS/STAIRWAYS MAY NOT ENCROACH INTO ANY BRL (APPLIES TO NEW TOWN RESIDENTIAL SDP'S).

34. DRIVEWAYS SHALL BE PROVIDED PRIOR TO ISSUANCE OF A USE AND OCCUPANCY PERMIT FOR ANY NEW DWELLINGS TO INSURE SAFE ACCESS FOR FIRE AND EMERGENCY VEHICLES PER THE FOLLOWING MINIMUM REQUIREMENTS: A. WIDTH - 12' (16' SERVING MORE THAN ONE RESIDENCE);


B. SURFACE - 6" OF COMPACTED CRUSHER RUN BASE W/TAR AND CHIP COATING $(1-\frac{1}{2}$ " MIN.);

GEOMETRY - MAX. 15% GRADE, MAX. 10% GRADE CHANGE AND MIN. 45' TURNING RADIUS;

D. STURCTURES (CULVERTS/BRIDGES) - CAPABLE OF SUPPORTING 25 GROSS TONS (H25 LOADING); DRAINAGE ELEMENTS - CAPABLE OF SAFELY PASSING 100-YEAR FLOOD WITH NO MORE THAN 1 FOOT DEPTH


OVER DRIVEWAY SURFACE; F. MAINTENANCE - SUFFICIENT TO INSURE ALL WEATHER USE.

35. THE DRIVEWAY SHALL BE CONSTRUCTED IN ACCORDANCE WITH HOWARD COUNTY DESIGN MANUAL, VOLUME IV, STANDARD DETAIL R-605.

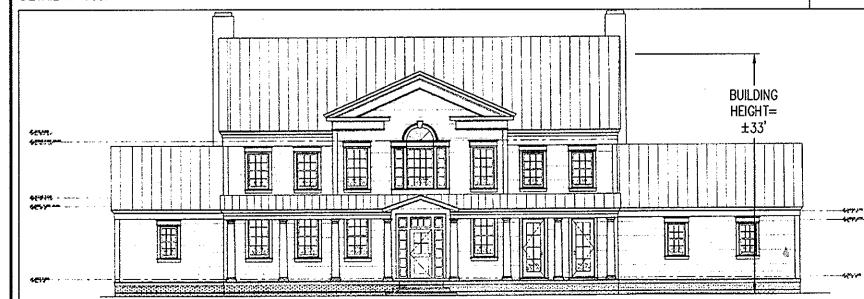

SEC. 5, AREA 9, LOT 15

5TH ELECTION DISTRICT HOWARD COUNTY, MARYLAND

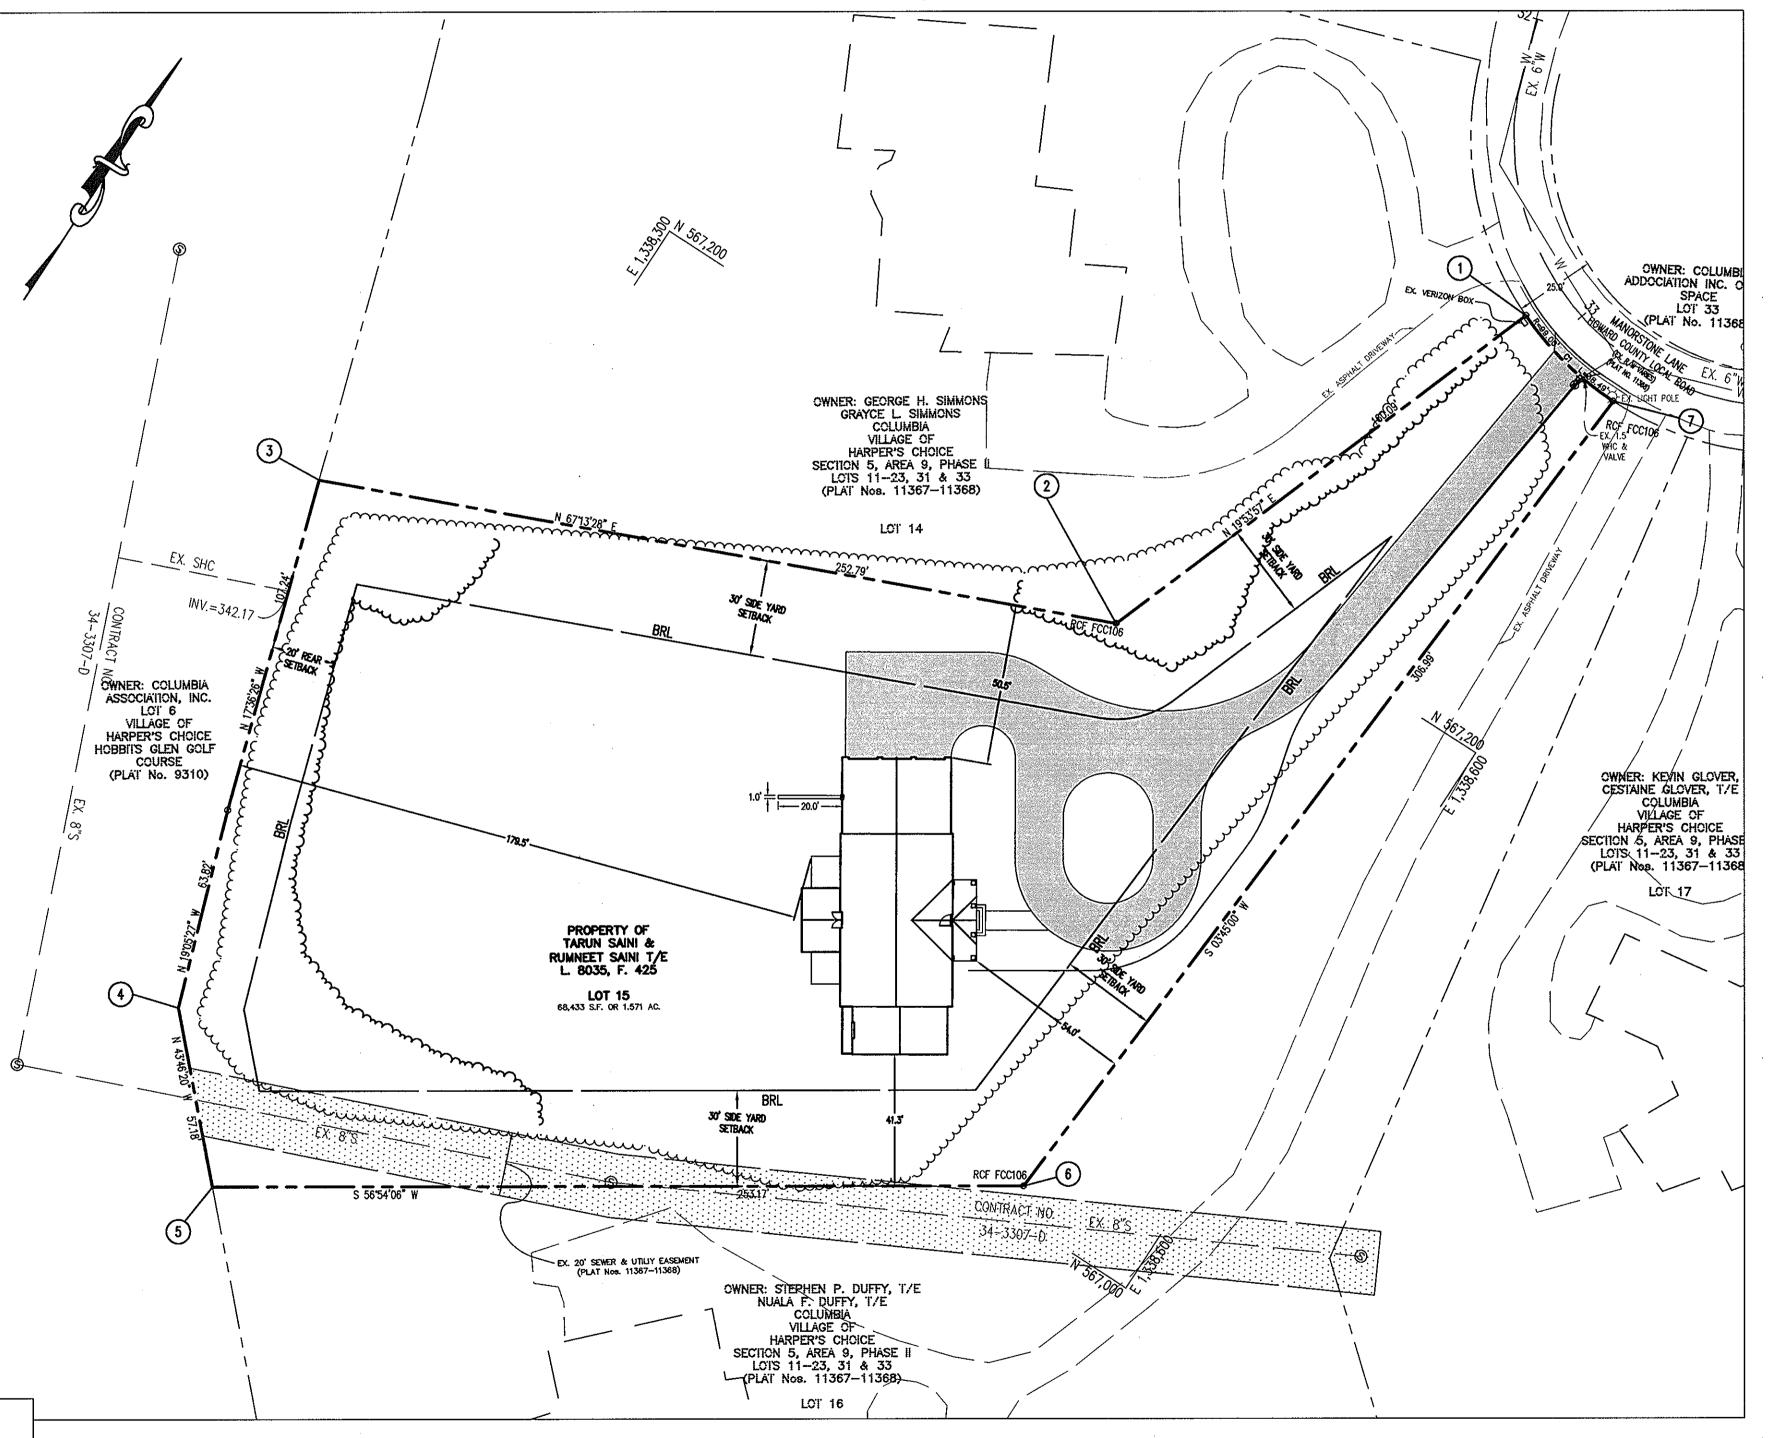

OVERALL SITE PLAN


| PERM | AIT INF | FORMA | ATION | CHA | ART | | ADDRESS CHART |
|--------------------------------------|-----------|-------------|-----------------------|---------|---------------------------------|------------|---|
| SUBDIVISION NAME VILLAGE OF HARPER'S | CHOICE . | | ./AREA TION 5, ARE | I | LOT NO. 15 | LOT NUMBER | STREET ADDRESS |
| PLAT NO. 11367, 11368 | GRID # ZO | ONING TAX N | MAP NO. E | LECT. C | DIST. CENSUS TRACT TH 605502 | 15 | 11556 MANORSTONE LANE, COLUMBIA, MD 21040 |
| WATER CODE IO3 | ER CODE | 6740000 | FCP NO. | F | DP -194-A | | |

SITE ANALYSIS DATA CHART

NT (NEW TOWN) EXISTING ZONING: GROSS AREA OF SITE: 1.57 ACRES (68,433 SF) NET TRACT AREA: 1.57 ACRES PROPOSED WATER AND SEWER: PUBLIC VACANT EXISTING USES: PROPOSED USES: TOTAL NUMBER OF UNITS: 1 DU LIMIT OF DISTURBED AREA:

BUILDING COVERAGE OF THE SITE:

SINGLE-FAMILY DETACHED 1.18 ACRES 15% (10,258 SF)

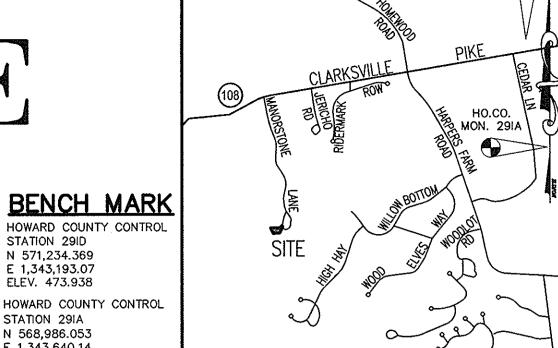

HO.CO. MON. 291D

HOWARD COUNTY CONTROL STATION 291A N 568,986.053 E 1,343,640.14 ELEV. 482.291 VICINITY MAP ADC MAP COORDIATE SCALE: 1" = 2000' MAP No. 14 - K4

HOWARD COUNTY CONTROL

STATION 29ID


N 571,234.369

E 1,343,193.07

ELEV. 473.938

| COOF | RDINATE LI | ST |
|---------------------|------------|--------------|
| PROPERTY CORNER NO. | NORTHING | EASTING |
| 1) | 567,323.40 | 1,338,538.42 |
| 2 | 567,172.90 | 1,338,483.94 |
| 3 | 567,075.04 | 1,338,250.87 |
| 4) | 566,912.51 | 1,338,304.18 |
| 5 | 566,871.22 | 1,338,343.73 |
| 6 | 567,009.48 | 1,338,555.82 |
| 7 | 567,315.72 | 1,338,575.90 |

LEGEND PROPOSED DRIVEWAY PROPERTY LINE EXISTING 20' SEWER/ EXISTING TREELINE UTILITY EASEMENT EXISTING BUILDING PROPOSED TREELINE PROPOSED BUILDING PROPOSED LOT LINE EXISTING SOILS EXISTING CONTOURS PROPERTY CORNER NO

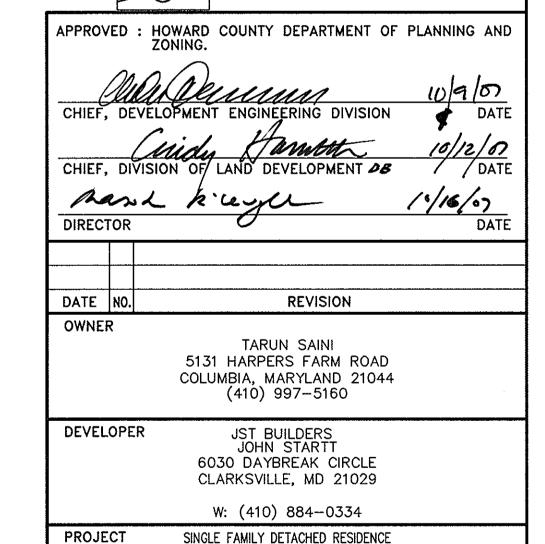

TAX MAP 29, GRID 21 PARCEL 370 5TH ELECTION DISTRICT ZONED NT-NEW TOWN HOWARD COUNTY, MARYLAND

TITLE SHEET


VILLAGE OF HARPERS CHOICE, FDP-194-A

SECTION 5, AREA 9, PHASE II, LOT 15

Patton Harris Rust & Associates, pc Engineers. Surveyors. Planners. Landscape Architects.


TITLE

8818 Centre Park Drive Columbia, MD 21045 T 410.997.8900 **F** 410.997.9282 I HEREBY CERTIFY THAT THESE DOCUMENTS WERE PREPARE OR APPROVED BY ME, AND THAT I AM A DULY LICENSED

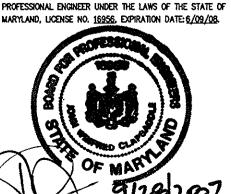

DESIGNED BY : PHRA DRAWN BY: JML PROJECT NO : 14426-1-0 DATE: SEPT. 27, 2007

SCALE : AS SHOWN DRAWING NO. 1 OF 6

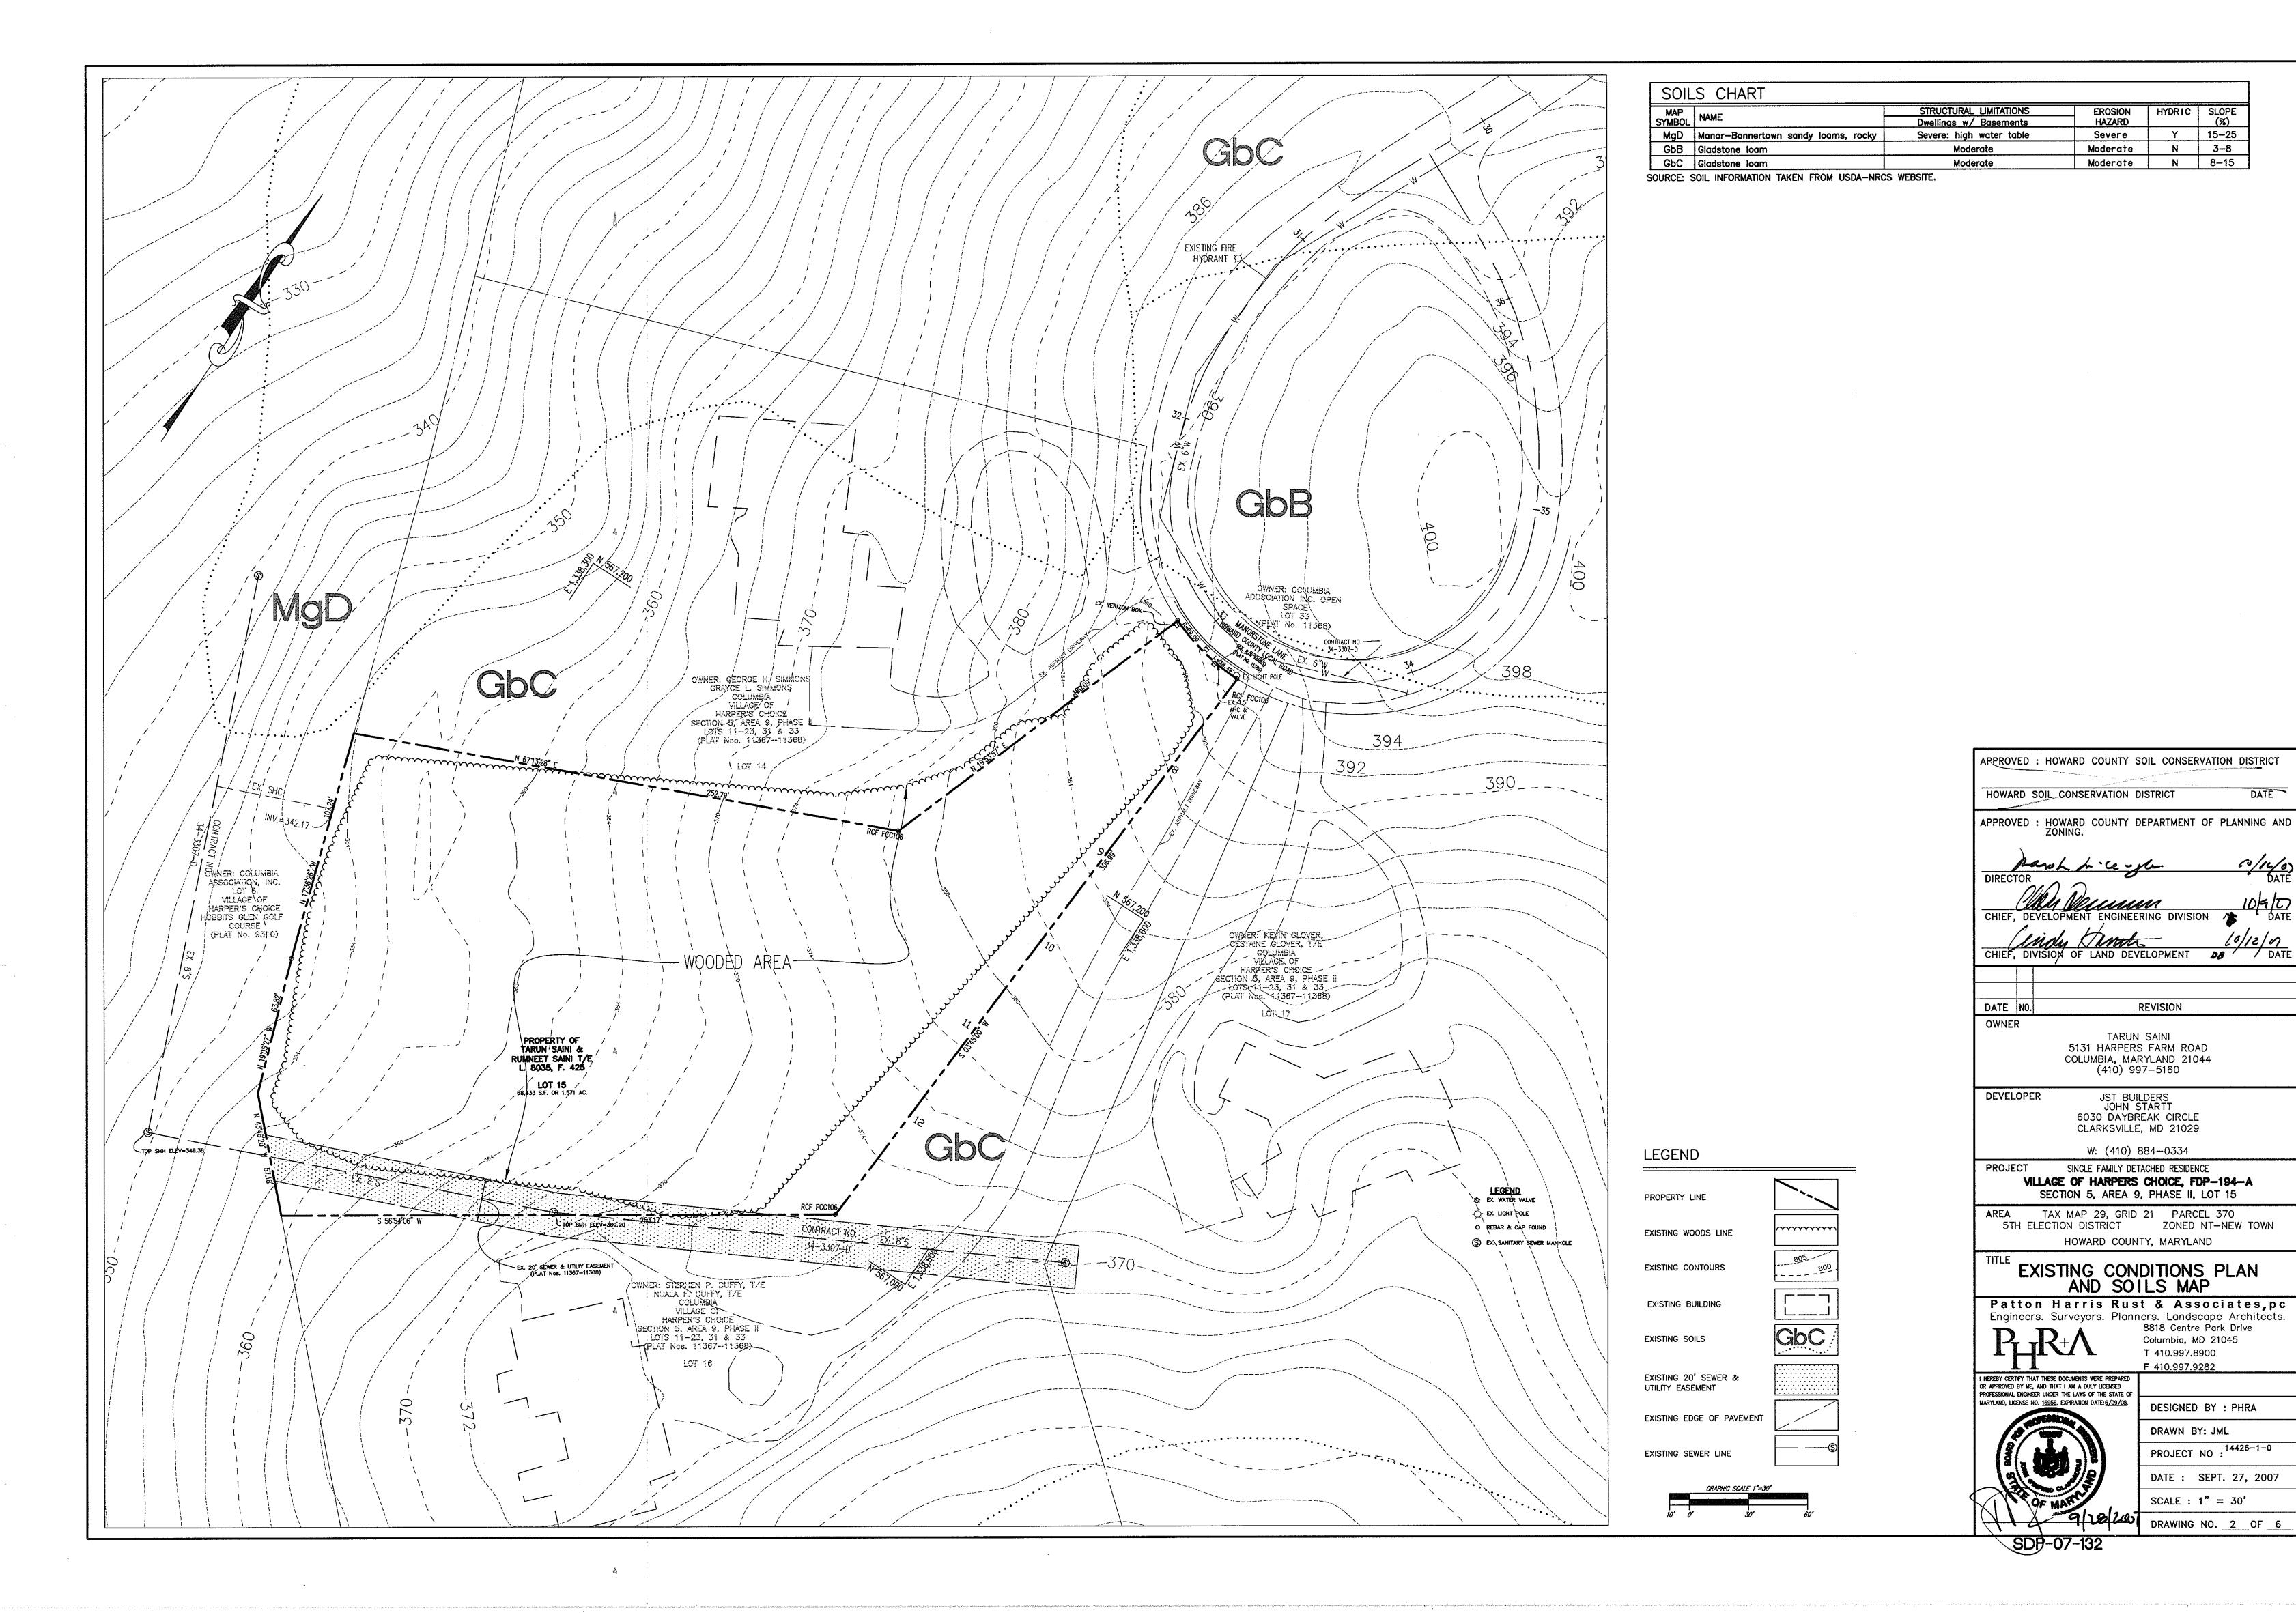

EROSION

Y 15-25

REVISION

8818 Centre Park Drive

DESIGNED BY : PHRA

PROJECT NO : 14426-1-0

DATE: SEPT. 27, 2007

DRAWING NO. 2 OF 6


SCALE : 1" = 30'


Columbia, MD 21045 **T** 410.997.8900

DRAWN BY: JML

F 410.997.9282

TARUN SAINI

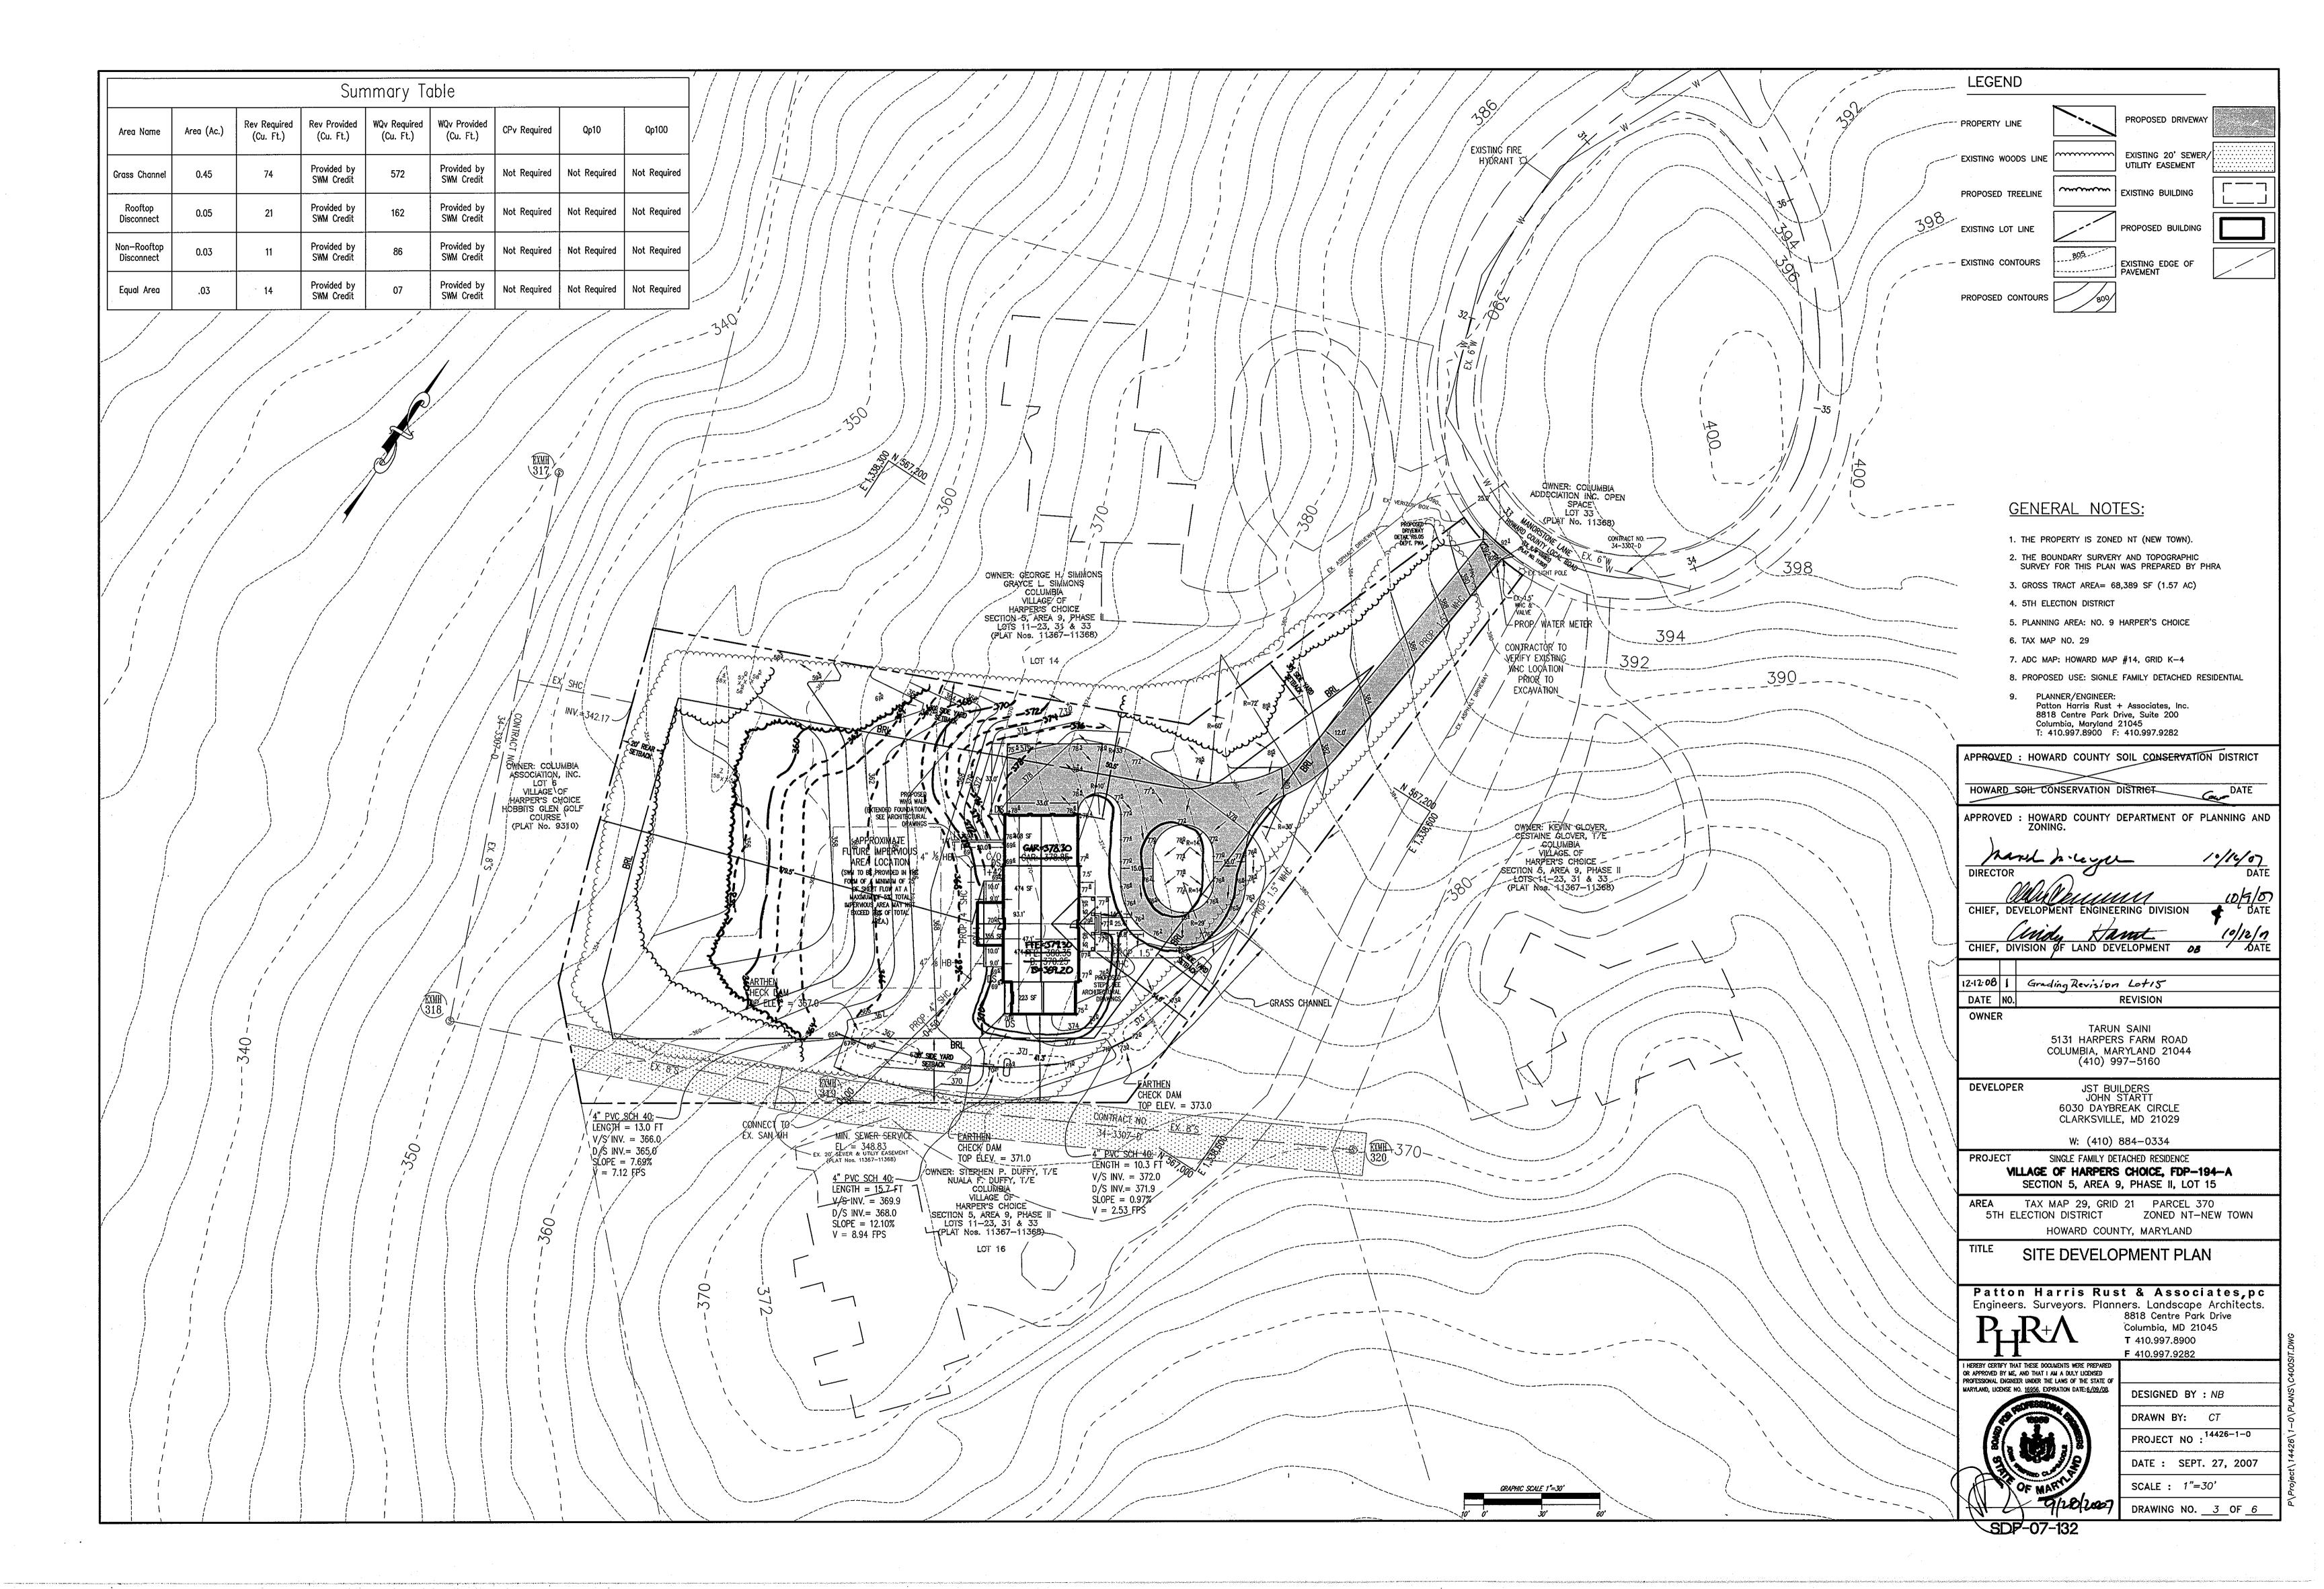

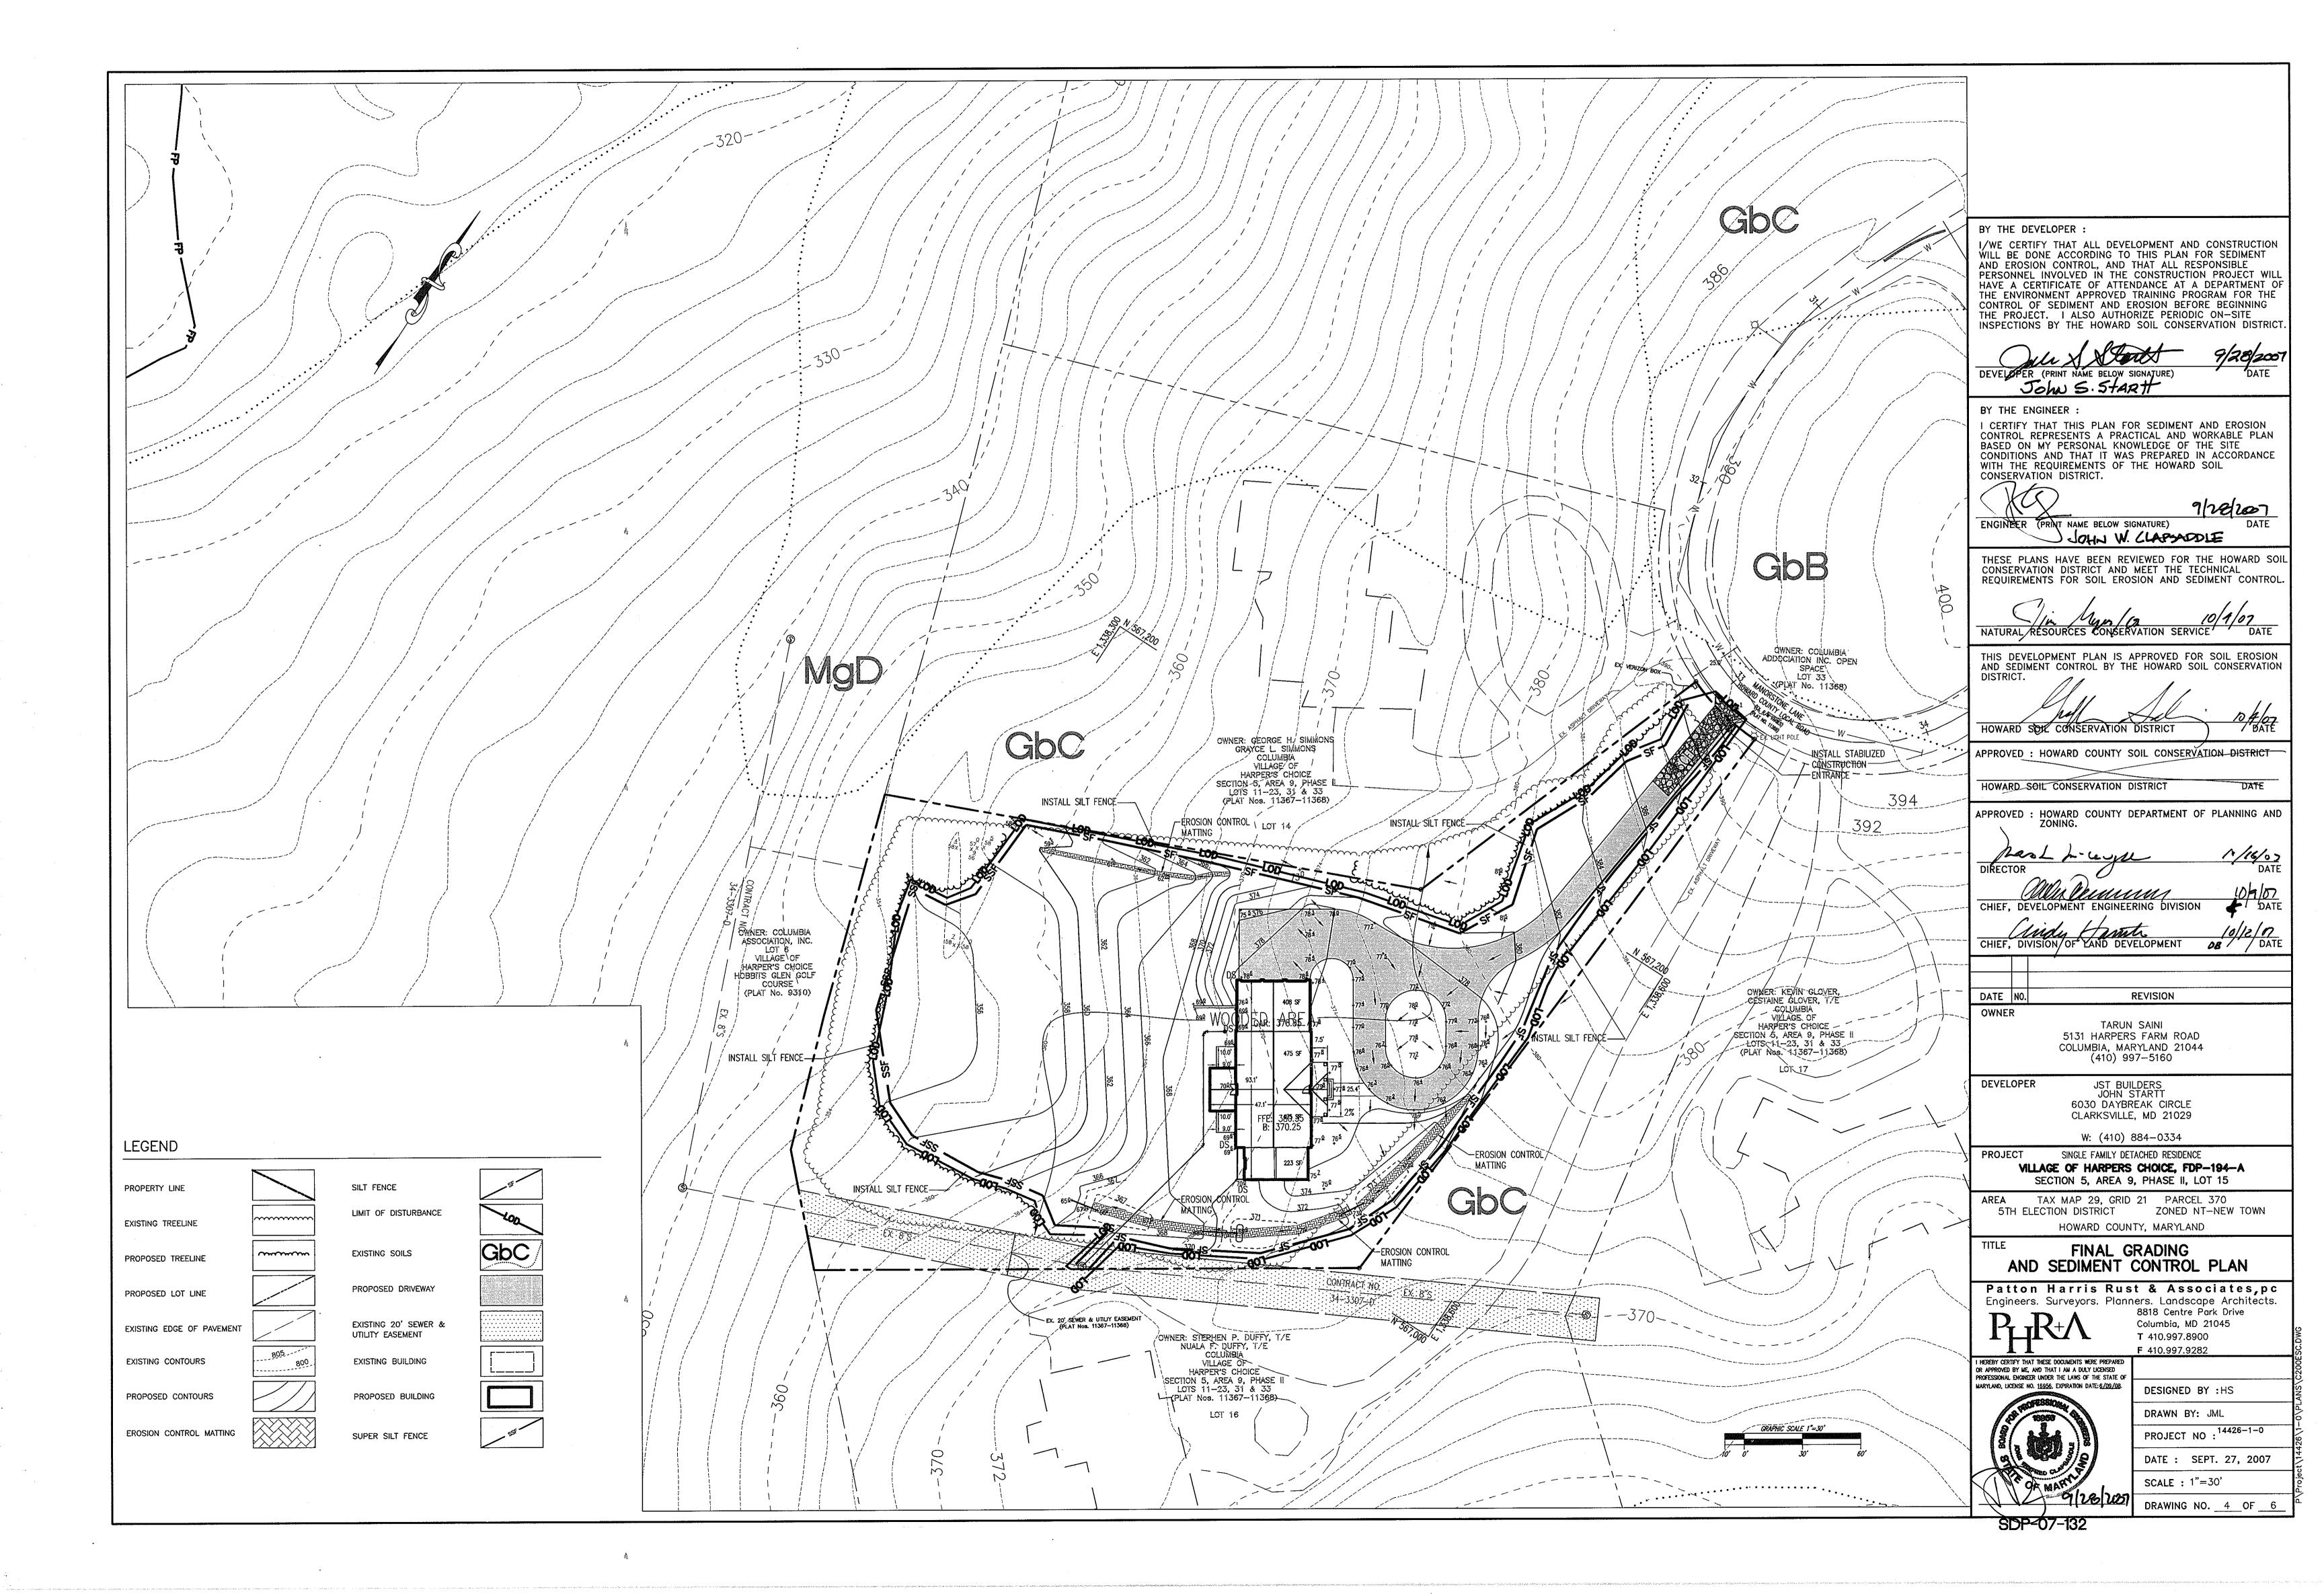

21.0 STANDARD AND SPECIFICATIONS FOR TOPSOIL

DEFINITION

PLACEMENT OF TOPSOIL OVER A PREPARED SUBSOIL PRIOR TO ESTABLISHMENT OF PERMANENT VEGETATION.

TO PROVIDE A SUITABLE SOIL MEDIUM FOR VEGETATIVE GROWTH. SOILS OF CONCERN HAVE LOW MOISTURE CONTENT, LOW NUTRIENT LEVELS, LOW PH, MATERIALS TOXIC TO PLANTS, AND/OR UNACCEPTABLE SOIL GRADATION.

CONDITIONS WHERE PRACTICE APPLIES

- I. THIS PRACTICE IS LIMITED TO AREAS HAVING 2:1 OR FLATTER SLOPES WHERE: --a. THE TEXTURE OF THE EXPOSED SUBSOIL/PARENT MATERIAL IS NOT ADEQUATE
- TO PRODUCE VEGETATIVE GROWTH. -b. THE SOIL MATERIAL IS SO SHALLOW THAT THE ROOTING ZONE IS NOT DEEP ENOUGH TO SUPPORT PLANTS OR FURNISH CONTINUING SUPPLIES OF MOISTURE AND PLANT NUTRIENTS.
- --c. THE ORIGINAL SOIL TO BE VEGETATED CONTAINS MATERIAL TOXIC TO PLANT --d. THE SOIL IS SO ACIDIC THAT TREATMENT WITH LIMESTONE IS NOT FEASIBLE.
- II. FOR THE PURPOSE OF THESE STANDARDS AND SPECIFICATIONS, AREAS HAVING SLOPES STEEPER THAN 2:1 REQUIRE SPECIAL CONSIDERATION AND DESIGN FOR ADEQUATE STABILIZATION. AREAS HAVING SLOPES STEEPER THAN 2:1 SHALL HAVE THE APPROPRIATE STABILIZATION SHOWN ON THE PLANS.

CONSTRUCTION AND MATERIAL SPECIFICATIONS

- I. TOPSOIL SALVAGED FROM THE EXISTING SITE MAY BE USED PROVIDED THAT IT MEETS THE STANDARDS AS SET FORTH IN THESE SPECIFICATIONS. TYPICALLY, THE DEPTH OF TOPSOIL TO BE SALVAGED FOR A GIVEN SOIL TYPE CAN BE FOUND IN THE REPRESENTATIVE SOIL PROFILE SECTION IN THE SOIL SURVEY PUBLISHED BY USDA-SCS IN COOPERATION WITH MARYLAND AGRICULTURAL EXPERIMENTATION STATION.
- II. TOPSOIL SPECIFICATIONS SOIL TO BE USED AS TOPSOIL MUST MEET THE
- FOLLOWING: -i. TOPSOIL SHALL BE A LOAM, SANDY LOAM, CLAY LOAM, SILT LOAM, SANDY CLAY LOAM, LOAMY SAND. OTHER SOILS MAY BE USED IF RECOMMENDED BY AN AGRONOMIST OR SOIL SCIENTIST AND APPROVED BY THE APPROPRIATE APPROVAL AUTHORITY. REGARDLESS, TOPSOIL SHALL NOT BE A MIXTURE OF CONTRASTING TEXTURED SUBSOILS AND SHALL CONTAIN LESS THAN 5% BY VOLUME OF CINDERS, STONES, SLAG, COARSE FRAGMENTS, GRAVEL, STICKS, ROOTS, TRASH, OR OTHER MATERIALS LARGER THAN 1-1/2" IN DIAMETER.
- -ii. TOPSOIL MUST BE FREE OF PLANTS OR PLANT PARTS SUCH AS BERMUDA GRASS, QUACKGRASS, JOHNSONGRASS, NUTSEDGE, POISON IVY, THISTLE, OR OTHERS AS SPECIFIED.
- -iii. WHERE SUBSOIL IS EITHER HIGHLY ACIDIC OR COMPOSED OF HEAVY CLAYS, GROUND LIMESTONE SHALL BE SPREAD AT THE RATE OF 4-8 TONS/ACRE (200-400 POUNDS PER 1,000 SQUARE FEET) PRIOR TO THE PLACEMENT OF TOPSOIL. LIME SHALL BE DISTRIBUTED UNIFÓRMLY OVER DESIGNATED AREAS AND WORKED INTO THE SOIL IN CONJUNCTION WITH TILLAGE OPERATIONS AS DESCRIBED IN THE FOLLOWING PROCEDURES.
- III. FOR SITES HAVING DISTURBED AREAS UNDER 5 ACRES:
- -i. PLACE TOPSOIL (IF REQUIRED) AND APPLY SOIL AMENDMENTS AS SPECIFIED IN 20.0 VEGETATIVE STABILIZATION - SECTION I - VEGETATIVE STABILIZATION
- IIII. FOR SITES HAVING DISTURBED AREAS OVER 5 ACRES: -i. ON SOIL MEETING TOPSOIL SPECIFICATIONS, OBTAIN TEST RESULTS DICTATING
- FERTILIZER AND LIME AMENDMENTS REQUIRED TO BRING THE SOIL INTO COMPLIANCE WITH THE FOLLOWING: -- a. PH FOR TOPSOIL SHALL BE BETWEEN 6.0 AND 7.5. IF THE TESTED SOIL
- DEMONSTRATES A PH OF LESS THAN 6.0, SUFFICIENT LIME SHALL BE PRESCRIBED TO RAISE THE PH TO 6.5 OR HIGHER. -- b. ORGANIC CONTENT OF TORSOIL SHALL BE NOT LESS THAN 1.5 PERCENT BY
- --c. TOPSOIL HAVING SOLUBLE SALT CONTENT GREATER THAN 500 PARTS PER MILLION SHALL NOT BE USED.
- --d. NO SOD OR SEED SHALL BE PLACED ON SOIL WHICH HAS BEEN TREATED WITH SOIL STERILANTS OR CHEMICALS USED FOR WEED CONTROL UNTIL SUFFICIENT TIME HAS ELAPSED (14 DAYS MIN.) TO PERMIT DISSIPATION OF PHYTO-TOXIC MATERIALS.
- NOTE: TOPSOIL SUBSTITUTES TO AMENDMENTS, AS RECOMMENDED BY A QUALIFIED AGRONOMIST OR SOIL SCIENTIST AND APPROVED BY THE APPROPRIATE APPROVAL AUTHORITY MAY BE USED IN LIEU OF NATURAL TOPSOIL.
- -ii. PLACE TOPSOIL (IF REQUIRED) AND APPLY SOIL AMENDMENTS AS SPECIFIED IN 20.0 VEGETATIVE STABILIZATION - SECTION I - VEGETATIVE STABILIZATION METHODS AND MATERIALS.
- V. TOPSOIL APPLICATION
- -i. WHEN TOPSOILING, MAINTAIN NEEDED EROSION AND SEDIMENT CONTROL PRACTICES SUCH AS DIVERSIONS, GRADE STABILIZATION STRUCTURES, EARTH DIKES, SLOPE SILT FENCE AND SEDIMENT TRAPS AND BASINS. -ii. GRADES ON THE AREAS TO BE TOPSOILED, WHICH HAVE BEEN PREVIOUSLY
- ESTABLISHED, SHALL BE MAINTAINED, ALBEIT 4" 8" HIGHER IN ELEVATION. -iii. TOPSOIL SHALL BE UNIFORMLY DISTRIBUTED IN A 4" - 8" LAYER AND LIGHTLY COMPACTED TO A MINIMUM THICKNESS OF 4". SPREADING SHALL BE PERFORMED IN SUCH A MANNER THAT SODDING OR SEEDING CAN PROCEED WITH A MINIMUM OF ADDITIONAL SOIL PREPARATION AND TILLAGE. ANY IRREGULARITIES IN THE SURFACE RESULTING FROM TOPSOILING OR OTHER OPERATIONS SHALL BE CORRECTED IN ORDER TO PREVENT THE FORMATION OF
- DEPRESSIONS OR WATER POCKETS. -iv. TOPSOIL SHALL NOT BE PLACED WHILE THE TOPSOIL OR SUBSOIL IS IN A FROZEN OR MUDDY CONDITION, WHEN THE SUBSOIL IS EXCESSIVELY WET OR IN A CONDITION THAT MAY OTHERWISE BE DETRIMENTAL TO PROPER GRADING AND SEEDBED PREPARATION.
- VI. ALTERNATIVE FOR PERMANENT SEEDING INSTEAD OF APPLYING THE FULL AMOUNTS OF LIME AND COMMERCIAL FERTILIZER, COMPOSTED SLUDGE AND
- AMENDMENTS MAY BE APPLIED AS SPECIFIED BELOW: -i. COMPOSTED SLUDGE MATERIAL FOR USE AS A SOIL CONDITIONER FOR SITES HAVING DISTURBED AREAS OVER 5 ACRES SHALL BE TESTED TO PRESCRIBE AMENDMENTS AND FOR SITE HAVING DISTURBED AREAS UNDER 5 ACRES SHALL
- CONFORM TO THE FOLLOWING REQUIREMENTS: --a. COMPOSTED SLUDGE SHALL BE SUPPLIED BY, OR ORIGINATE FROM, A PERSON OR PERSONS THAT ARE PERMITTED (AT THE TIME OF ACQUISITION OF THE COMPOST) BY THE MARYLAND DEPARTMENT OF THE ENVIRONMENT UNDER
- COMAR 26.04.06. --b. COMPOSTED SLUDGE SHALL CONTAIN AT LEAST 1 PERCENT NITROGEN. 1.5 PERCENT PHOSPHORUS, AND 0.2 PERCENT POTASSIUM AND HAVE A PH OF 7.0 TO 8.0. IF COMPOST DOES NOT MEET THESE REQUIREMENTS. THE APPROPRIATE CONSTITUENTS MUST BE ADDED TO MEET THE REQUIREMENTS
- --c. COMPOSTED SLUDGE SHALL BE APPLIED AT A RATE OF 1 TON/1,000 SQUARE
- --d. COMPOSTED SLUDGE SHALL BE AMENDED WITH A POTASSIUM FERTILIZER APPLIED AT THE RATE OF 4 LB/1,000 SQUARE FEET, AND 1/3 THE NORMAL LIME APPLICATION RATE. REFERENCES: GUIDELINE SPECIFICATIONS, SOIL PREPARATION AND SODDING. MD-VA, PUB. #1, COOPERATIVE EXTENSION SERVICE, UNIVERSITY OF MARYLAND AND VIRGINIA POLYTECHNIC INSTITUTES.

STANDARD SEDIMENT CONTROL NOTES

- 1. A MINIMUM OF 48 HOURS NOTICE MUST BE GIVEN TO THE HOWARD COUNTY DEPARTMENT OF INSPECTIONS, LICENSES AND PERMITS, SEDIMENT CONTROL DIVISION PRIOR TO THE START OF ANY CONSTRUCTION (313-1855).
- 2. ALL VEGETATIVE AND STRUCTURAL PRACTICES ARE TO BE INSTALLED ACCORDING TO THE PROVISIONS OF THIS PLAN AND ARE TO BE IN CONFORMANCE WITH THE 1994 MARYLAND STANDARDS AND SPECIFICATIONS FOR SOIL EROSION AND SEDIMENT CONTROL AND REVISIONS THERETO.
- 3. FOLLOWING INITIAL SOIL DISTURBANCE OR RE-DISTURBANCE, PERMANENT OR TEMPORARY STABILIZATION SHALL BE COMPLETED WITHIN: A)7 CALENDAR DAYS FOR ALL PERIMETER SEDIMENT CONTROL STRUCTURES, DIKES, PERIMETER SLOPES, AND ALL SLOPES STEEPER THAN 3:1, B) 14 DAYS AS TO ALL OTHER DISTURBED OR GRADED AREAS ON THE PROJECT SITE.
- 4. ALL SEDIMENT TRAPS/BASINS SHOWN MUST BE FENCED AND WARNING SIGNS POSTED AROUND THE PERIMETER IN ACCORDANCE WITH VOL. 1, CHAPTER 7, OF THE HOWARD COUNTY DESIGN MANUAL, STORM DRAINAGE.
- 5. ALL DISTURBED AREAS MUST BE STABILIZED WITHIN THE TIME PERIOD SPECIFIED ABOVE IN ACCORDANCE WITH THE 1994 MARYLAND STANDARDS AND SPECIFICATIONS FOR SOIL EROSION AND SEDIMENT CONTROL FOR PERMANENT SEEDING, SOD, TEMPORARY SEEDING, AND MULCHING (SEC. G.), TEMPORARY STABILIZATION WITH MULCH ALONE SHALL ONLY BE DONE WHEN RECOMMENDED SEEDING DATES DO NOT ALLOW FOR PROPER GERMINATION AND ESTABLISHED
- 6. ALL SEDIMENT CONTROL STRUCTURES ARE TO REMAIN IN PLACE AND ARE TO BE MAINTAINED IN OPERATIVE CONDITION UNTIL PERMISSION FOR THEIR REMOVAL

HAS BEEN OBTAINED FROM THE HOWARD COUNTY SEDIMENT CONTROL INSPECTOR.

7. SITE ANALYSIS:

TOTAL AREA OF SITE AREA DISTURBED AREA TO BE ROOFED OR PAVED AREA TO BE VEGETATIVELY STABILIZED TOTAL CUT TOTAL FILL

1.18 ACRES 0.25 ACRES 1.32 ACRES 168 CU. YARDS 168 CU. YARDS OFFSITE WASTE AREA LOCATION TO HAVE ACTIVE GRADING PERMIT

1.57 ACRES

- 8. ANY SEDIMENT CONTROL PRACTICE WHICH IS DISTURBED BY GRADING ACTIVITY FOR PLACEMENT OF UTILITIES MUST BE REPAIRED ON THE SAME DAY OF
- 9. ADDITIONAL SEDIMENT CONTROLS MUST BE PROVIDED, IF DEEMED NECESSARY BY THE HOWARD COUNTY SEDIMENT CONTROL INSPECTOR.
- 10. ON ALL SITES WITH DISTURBED AREAS IN EXCESS OF 2 ACRES. APPROVAL OF THE INSPECTION AGENCY SHALL BE REQUESTED UPON COMPLETION OF INSTALLATION OF PERIMETER EROSION AND SEDIMENT CONTROLS, BUT BEFORE PROCEEDING WITH ANY OTHER EARTH DISTURBANCE OR GRADING. OTHER BUILDING OR GRADING INSPECTION APPROVALS MAY NOT BE AUTHORIZED UNTIL THIS INITIAL APPROVAL BY THE INSPECTION AGENCY IS MADE.
- 11. TRENCHES FOR THE CONSTRUCTION OF UTILITIES IS LIMITED TO THREE PIPE LENGTHS OR THAT WHICH SHALL BE BACK-FILLED AND STABILIZED WITHIN ONE WORKING DAY, WHICHEVER IS SHORTER.
- 12. SITE GRADING WILL BEGIN ONLY AFTER ALL PERIMETER SEDIMENT CONTROL MEASURES HAVE BEEN INSTALLED AND ARE IN A FUNCTIONING CONDITION.
- 13. SEDIMENT WILL BE REMOVED FROM TRAPS WHEN ITS DEPTH REACHES CLEAN OUT ELEVATION SHOWN ON THE PLANS.
- 14. CUT AND FILL QUANTITIES PROVIDED UNDER SITE ANALYSIS DO NOT REPRESENT BID QUANTITIES. THESE QUANTITIES DO NOT DISTINGUISH BETWEEN TOPSOIL, STRUCTURAL FILL OR EMBANKMENT MATERIAL, NOR DO THEY REFLECT CONSIDERATION OF UNDERCUTTING OR REMOVAL OF UNSUITABLE MATERIAL. THE CONTRACTOR SHALL FAMILIARIZE HIMSELF WITH SITE CONDITIONS WHICH MAY

SEQUENCE OF CONSTRUCTION

(1 DAY)

(1 DAY)

(2 DAYS)

(2 WEEKS)

(1 WEEK)

(1 WEEK)

(6 WEEKS)

- OBTAIN GRADING PERMIT. SCHEDULE AND ATTEND THE PRECONSTRUCTION
- INSTALL THE STABILIZED CONSTRUCTION ENTRANCE AS SHOWN ON THE PLAN. INSTALL SILT FENCE WITHIN LIMIT OF DISTURBANCE AS SHOWN ON THE
- AFTER OBTAINING PERMISSION FROM THE INSPECTOR, BEGIN CLEARING AND GRADING THE SITE. THE SWALES ALONG THE DRIVEWAY AND AT THE BACK OF THE HOUSE WILL NOT BE GRADED UNTIL EVERYTHING ELSE HAS BEEN INSTALLED ON SITE AND THE HOUSE HAS BEEN CONSTRUCTED TO AVOID SHALLOW CONCENTRATED FLOW ON THE SITE WHILE GRADING OPERATIONS ARE BEING PERFORMED ON THE SITE. ALSO, DELAY THE CONSTRUCTION OF
 - INSTALL WATER & SEWER HOUSE CONNECTIONS ON-SITE, STABILIZE ALL THE DISTURBED AREAS WITH APPROPRIATE TEMPORARY SEEDING.

APPROVED PLAN.

- CONSTRUCT SUBGRADE FOR THE DRIVEWAY; DELAY THE FINAL PAVING UNTIL THE HOUSE HAS BEEN CONSTRUCTED AND ALL THE HEAVY MACHINERY HAS BEGIN HOUSE CONSTRUCTION AND FINISH CONSTRUCTING ALL THE ITEMS ON
 - IMMEDIATELY STABILIZE ALL THE DISTURBED AREAS ON-SITE WITH (2 DAYS) PERMANENT SEEDING AS PER SPECIFICATIONS.
 - APPLY FINAL PAVING ON THE DRIVEWAY. (1 WEEK) 10. GRADE THE SWALES ON THE SITE (ALONG THE DRIVEWAY) AND THE CHECK (1 WEEK) DAMS AS SHOWN ON THE APPROVED PLAN.
 - (2 DAYS) 11. STABILIZE ALL THE DISTURBED AREAS WITH PERMANENT SEEDING. 12. WITH THE PERMISSION OF SEDIMENT CONTROL INSPECTOR, REMOVE THE (2 DAYS)
 - SEDIMENT CONTROL DEVICES INSTALLED ON THE SITE (SILT FENCE AND STABILIZED CONSTRUCTION ENTRANCE).

TEMPORARY SEEDING NOTES

APPLY TO GRADED OR CLEARED AREAS LIKELY TO BE REDISTURBED WHERE A SHORT-TERM VEGETATIVE COVER IS NEEDED

SEEDBED PREPARATION: LOOSEN UPPER THREE INCHES OF SOIL BY RAKING. DISCING OR OTHER ACCEPTABLE MEANS BEFORE SEEDING, IF NOT PREVIOUSLY

SOIL AMENDMENTS: APPLY 600 LBS. PER ACRE 10-10-10 FERTILIZER (14 LBS. PER 1000 SQ.FT.)

SEEDING: FOR PERIODS MARCH 1 THRU APRIL 30 AND FROM AUGUST 15 THRU NOVEMBER 15, SEED WITH 2-1/2 BUSHELS PER ACRE OF ANNUAL RYE (3.2 LBS. PER 1000 SQ.FT.). FOR THE PERIOD MAY 1 THRU AUGUST 14, SEED WITH 3 LBS. PER ACRE OF WEEPING LOVEGRASS (0.07 LBS. PER 1000 SQ.FT.). FOR THE PERIOD NOVEMBER 16 THRU FEBRUARY 28, PROTECT SITE BY APPLYING 2 TONS PER ACRE OF WELL ANCHORED STRAW MULCH AND SEED AS SOON AS POSSIBLE IN THE SPRING, OR USE SOD.

MULCHING: APPLY 1-1/2 TO 2 TONS PER ACRE (70 TO 90 LBS. PER 1000 SQ.FT.) OF UNROTTED SMALL GRAIN STRAW IMMEDIATELY AFTER SEEDING. ANCHÓR MULCH IMMEDIATELY AFTER APPLICATION USING MULCH ANCHORING TOOL OR 218 GAL. PER ACRE (5 GAL. PER 1000 SQ.FT.) OF EMULSIFIED ASPHALT ON FLAT AREAS. ON SLOPES, 8 FT. OR HIGHER, USE 347 GAL. PER ACRE (8 GAL. PER 1000 SQ.FT.) FOR ANCHORING.

REFER TO THE 1994 MARYLAND STANDARDS AND SPECIFICATIONS FOR SOIL EROSION AND SEDIMENT CONTROL FOR RATE AND METHODS NOT COVERED.

PERMANENT SEEDING NOTES

APPLY TO GRADED OR CLEARED AREAS NOT SUBJECT TO IMMEDIATE FURTHER DISTURBANCE WHERE A PERMANENT LONG-LIVED VEGETATIVE COVER IS NEEDED.

SEEDBED PREPARATION: LOOSEN UPPER THREE INCHES OF SOIL BY RAKING. DISCING OR OTHER ACCEPTABLE MEANS BEFORE SEEDING, IF NOT PREVIOUSLY

SOIL AMENDMENTS: IN LIEU OF SOIL TEST RECOMMENDATIONS, USE ONE OF THE FOLLOWING SCHEDULES

- 1) PREFERRED APPLY 2 TONS PER ACRE DOLOMITIC LIMESTONE (92 LBS. PER 1000 SQ.FT.) AND 600 LBS. PER ACRE 10-10-10 FERTILIZER (14 LBS. PER 1000 SQ.FT.) BEFORE SEEDING. HARROW OR DISC INTO UPPER THREE INCHES OF SOIL. AT TIME OF SEEDING, APPLY 400 LBS. PER ACRE 30-0-0 UREAFORM FERTILIZER (9 LBS. PER 1000 SQ.FT.).
- 2) ACCEPTABLE APPLY 2 TONS PER ACRE DOLOMITIC LIMESTONE (92 LBS. PER 1000 SQ.FT.) AND 1000 LBS. PER ACRE 10-10-10 FERTILIZER (23 LBS. PER 1000 SQ.FT.) BEFORE SEEDING. HARROW OR DISC INTO UPPER THREE INCHES OF SOIL.

SEEDING: FOR THE PERIOD MARCH 1 THRU APRIL 30 AND FROM AUGUST 1 THRU OCTOBER 15, SEED WITH 60 LBS. PER ACRE (1.4 LBS. PER 1000 SQ.FT.) OF KENTUCKY 31 TALL FESCUE. FOR THE PERIOD MAY 1 THRU JULY 31, SEED WITH 60 LBS. KENTUCKY 31 TALL FESCUE PER ACRE AND 2 LBS. PER ACRE (0.05 LBS, PER 1000 SQ.FT.) OF WEEPING LOVEGRASS. DURING THE PERIOD OCTOBER 16 THRU FEBRUARY 28, PROTECT SITE BY ONE OF THE FOLLOWING


- 1) 2 TONS PER ACRE OF WELL-ANCHORED MULCH STRAW AND SEED AS SOON AS POSSIBLE IN THE SPRING.
- USE SOD.
- 3) SEED WITH 60 LBS. PER ACRE KENTUCKY 31 TALL FESCUE AND MULCH WITH 2 TONS PER ACRE WELL ANCHORED STRAW.

MULCHING: APPLY 1-1/2 TO 2 TONS PER ACRE (70 TO 90 LBS. PER 1000 SQ.FT.) OF UNROTTED SMALL GRAIN STRAW IMMEDIATELY AFTER SEEDING. ANCHOR MULCH IMMEDIATELY AFTER APPLICATION USING MULCH ANCHORING TOOL OR 218 GAL. PER ACRE (5 GAL. PER 1000 SQ.FT.) OF EMULSIFIED ASPHALT ON FLAT AREAS. ON SLOPES, 8 FT. OR HIGHER, USE 347 GAL. PER ACRE (8 GAL. PER 1000 SQ.FT.) FOR ANCHORING.

MAINTENANCE : INSPECT ALL SEEDED AREAS AND MAKE NEEDED REPAIRS. REPLACEMENTS AND RESEEDINGS.

DEPTH VARIES ALONG CHANNEL - SEED & MULCH, ECM GEOTEXTILE FABRIC WHERE SHOWN ON PLAN.

GRASS CHANNEL TYPICAL SECTION NOT TO SCALE

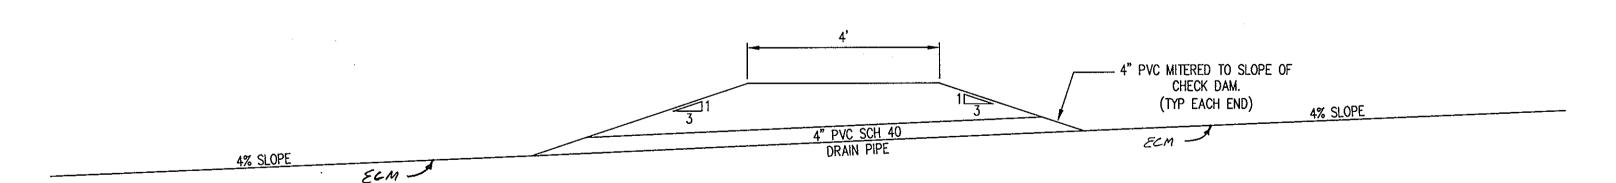

EARTHEN CHECK DAM TYPICAL SECTION

NOT TO SCALE

BY THE DEVELOPER:

I/WE CERTIFY THAT ALL DEVELOPMENT AND CONSTRUCTION WILL BE DONE ACCORDING TO THIS PLAN FOR SEDIMENT AND EROSION CONTROL, AND THAT ALL RESPONSIBLE PERSONNEL INVOLVED IN THE CONSTRUCTION PROJECT WILL HAVE A CERTIFICATE OF ATTENDANCE AT A DEPARTMENT OF THE ENVIRONMENT APPROVED TRAINING PROGRAM FOR THE CONTROL OF SEDIMENT AND EROSION BEFORE BEGINNING THE PROJECT. I ALSO AUTHORIZE PERIODIC ON-SITE INSPECTIONS BY THE HOWARD SOIL CONSERVATION DISTRICT

BY THE ENGINEER

I CERTIFY THAT THIS PLAN FOR SEDIMENT AND EROSION CONTROL REPRESENTS A PRACTICAL AND WORKABLE PLAN BASED ON MY PERSONAL KNOWLEDGE OF THE SITE CONDITIONS AND THAT IT WAS PREPARED IN ACCORDANCE WITH THE REQUIREMENTS OF THE HOWARD SOIL CONSERVATION DISTRICT.

9/28/2007 ENGINEER (PRINT NAME BELOW SIGNATURE) JOHN W. CLAPSAPOUE

THESE PLANS HAVE BEEN REVIEWED FOR THE HOWARD SOIL

REQUIREMENTS FOR SOIL EROSION AND SEDIMENT CONTROL

CONSERVATION DISTRICT AND MEET THE TECHNICAL

THIS DEVELOPMENT PLAN IS APPROVED FOR SOIL EROSION AND SEDIMENT CONTROL BY THE HOWARD SOIL CONSERVATION

HOWARD SOIL CONSERVATION DISTRICT

APPROVED : HOWARD COUNTY SOIL CONSERVATION DISTRICT

HOWARD SOIL CONSERVATION DISTRICT

HOWARD COUNTY DEPARTMENT OF PLANNING AND

CHIEF, DIVISION OF LAND DEVELOPMENT

DATE NO.

OWNER

DISTRICT.

TARUN SAINI 5131 HARPERS FARM ROAD COLUMBIA, MARYLAND 21044 (410) 997-5160

REVISION

DEVELOPER

JST BUILDERS JOHN STARTT 6030 DAYBREAK CIRCLE CLARKSVILLE, MD 21029

SINGLE FAMILY DETACHED RESIDENCE

Patton Harris Rust & Associates.pc


W: (410) 884-0334

VILLAGE OF HARPERS CHOICE, FDP-194-A SECTION 5. AREA 9. PHASE II. LOT 15

TAX MAP 29, GRID 21 PARCEL 370 5TH ELECTION DISTRICT ZONED NT-NEW TOWN HOWARD COUNTY, MARYLAND

SEDIMENT CONTROL AND STORM WATER NOTES & DETAILS

Engineers. Surveyors. Planners. Landscape Architects. 8818 Centre Park Drive Columbia, MD 21045

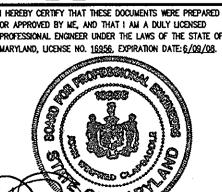


T 410.997.8900 **F** 410.997.9282

DESIGNED BY : HS DRAWN BY: HS

PROJECT NO : 14426-1-0 DATE: SEPT. 27, 2007

SCALE : NOT TO SCALE


DRAWING NO. 5 OF

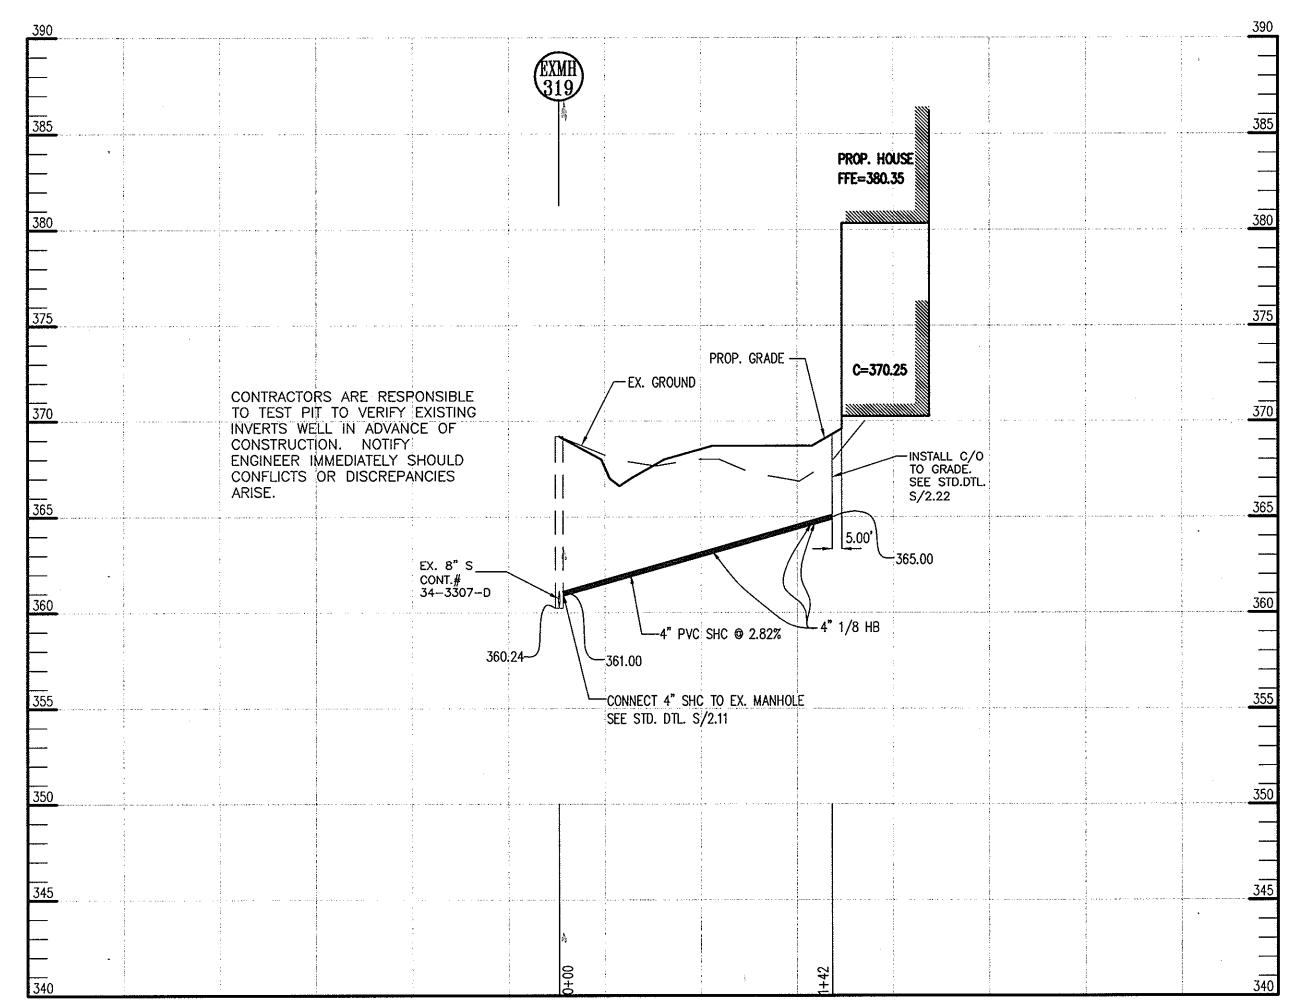


SEWER HOUSE CONNECTION PROFILE SCALE: HORZ: 1"=50' VERT: 1"=5'

| And the second s | | | |
|--|---------------|-----|--|
| | PIPE SCHEDULE | | |
| LENGTH | TYPE | w/s | |
| 142 | 4" PVC | S | |
| 285 | 1.5" COPPER | W | |

| STRUCTURE / FITTING SCHEDULE | | | | | |
|------------------------------|-------------|-----|--|--|--|
| QUANTITY | TYPE | W/S | | | |
| 1 | CO/S 2.22 | S | | | |
| 3 | 4" X 1/8 HB | S | | | |
| | | | | | |
| | | | | | |

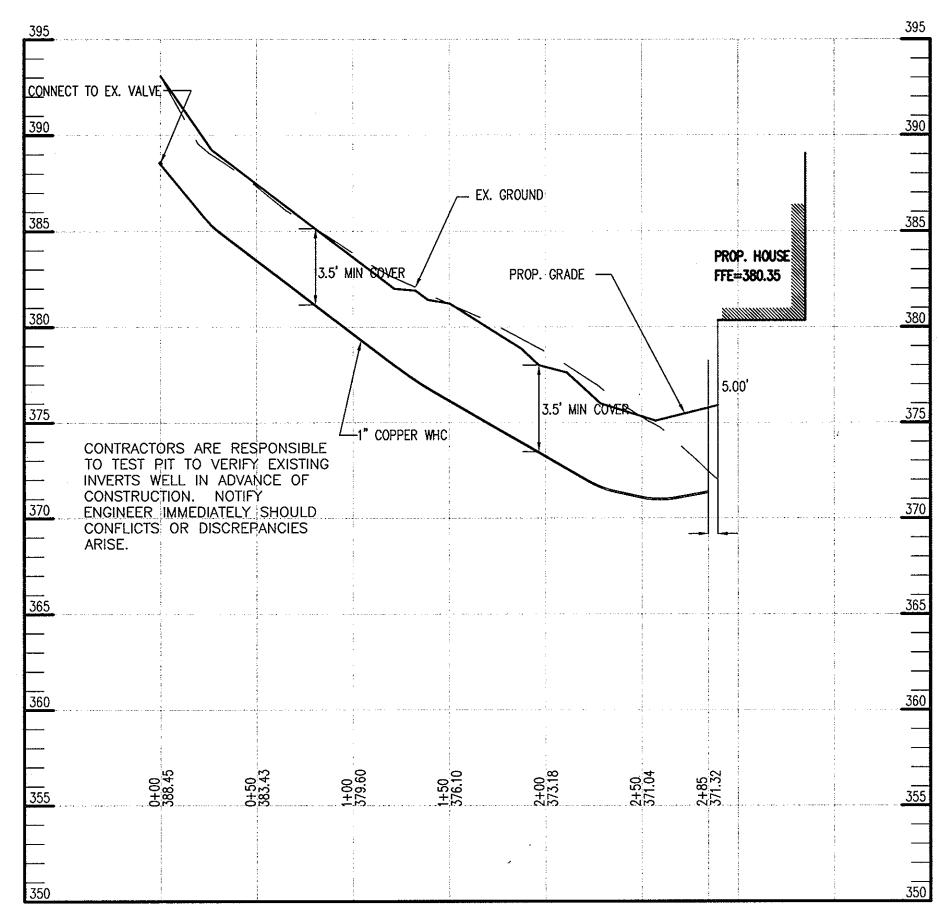

WATER HOUSE CONNECTION PROFILE SCALE : HORZ: 1"=50' VERT: 1"=5'

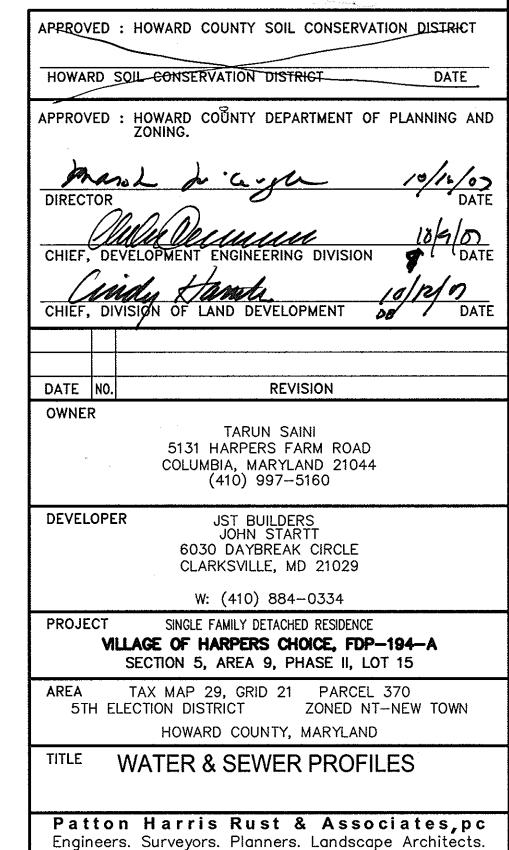

MARYLAND, LICENSE NO. 16956, EXPIRATION DATE: 6/09/08. DRAWING NO. 6 OF 6

OR APPROVED BY ME, AND THAT I AM A DULY LICENSED PROFESSIONAL ENGINEER UNDER THE LAWS OF THE STATE OF

DESIGNED BY : HS DRAWN BY: HS PROJECT NO : 14426-1-0

8818 Centre Park Drive Columbia, MD 21045 T 410.997.8900 **F** 410.997.9282

DATE: SEPT. 27, 2007 SCALE : AS SHOWN