



CURVE TABLE					
CURVE	RADIUS	LENGTH	TANGENT	DELTA	CHORD BEARING & DISTANCE
C9	120.00'	62.04'	31.73'	28°37'11"	N29°28'45"W 61.35'
C10	70.00'	45.99'	23.86'	37°38'29"	N24°09'05"E 45.17'
C11	25.00'	23.18'	12.50'	53°07'48"	S31°53'45"W 22.36'
C12	50.00'	249.81'	37.50'	286°15'37"	N84°40'10"W 60.00'
C13	25.00'	23.18'	12.50'	53°07'48"	N21°14'04"W 22.36'
C14	30.00'	18.88'	9.76'	36°03'30"	N23°21'36"E 18.57'
C15	120.00'	36.18'	18.23'	17°18'32"	N76°01'53"W 36.02'
C20	30.00'	13.90'	7.08'	26°32'30"	S82°03'35"W 13.77'
C21	80.00'	125.66'	80.00'	90°00'00"	N30°40'10"W 113.14'

LEGEND		
EXISTING	DESCRIPTION	PROPOSED
---	PROPERTY LINE	---
---	RIGHT OF WAY LINE	---
---	CENTER LINE	---
---	EASEMENT LINE	---
---	BLDG. RESTRICTION LINE	---
EX. 18" SD	STORM DRAIN & MH	---
EX. 8" S	SEWER LINE & MH	---
EX. 8" W	WATER LINE & MH	---
---	PIPE/GUTTER FLOW DIRECTION	---
---	WATER VALVE	---
---	FIRE HYDRANT	---
---	GAS LINE	---
---	OVERHEAD LINE	---
---	UTILITY POLE	---
---	LIMIT OF DISTURBANCE	LOD
---	SOILS CLASSIFICATION/BOUNDARY	---
---	STABILIZED CONSTRUCTION ENTRANCE	SSCE
---	SUPER SILT FENCE PROVIDED UNDER F-05-104	---
---	INLET PROTECTION PROVIDED UNDER F-05-104	---
---	CURB & GUTTER	---
---	CONTOUR LINE	---
---	SPOT ELEVATION	---
---	STREET SIGN	---
---	STREET LIGHTING	---
---	10' PRIVATE SIGN EASEMENT	---
---	10' PUBLIC TREE MAINTENANCE EASEMENT	---
---	25% OR GREATER SLOPES	---
---	LANDSCAPING APPROVED UNDER F-05-104	---

NOTE: AT THE DISCRETION OF THE SEDIMENT CONTROL INSPECTOR, SILT FENCE OR SUPER SILT FENCE MAY BE REQUIRED TO BE INSTALLED AT THE FRONT OF THESE LOTS.

SOILS DESCRIPTION	
SYMBOL	DESCRIPTION
EKB2	ELOAK SILT LOAM, 3% TO 8% SLOPES, MODERATELY ERODED--TYPE C
GIB2	GLENELG SILT LOAM, 3% TO 8% SLOPES, MODERATELY ERODED--TYPE B
GIC3	GLENELG SILT LOAM, 8% TO 15% SLOPES, SEVERELY ERODED--TYPE B
MIC3	MANOR LOAM, 4% TO 15% SLOPES, SEVERELY ERODED--TYPE B

**OWNERS/DEVELOPERS CERTIFICATION**

I/WE HEREBY CERTIFY THAT ANY CLEARING, GRADING, CONSTRUCTION AND/OR "EVE-TOE" WILL BE DONE PURSUANT TO THIS PLAN AND THAT ANY "RESPONSIBLE PERSONNEL INVOLVED IN THE CONSTRUCTION PROJECT WILL HAVE A CERTIFICATE OF ATTENDANCE AT A DEPARTMENT OF THE ENVIRONMENT APPROVED TRAINING PROGRAM FOR THE CONTROL OF SEDIMENT AND EROSION BEFORE BEGINNING OF THE PROJECT. I ALSO AUTHORIZE PERIODIC ON-SITE INSPECTION BY THE NATURAL RESOURCE CONSERVATION SERVICE.

Signature of Owner/Developer: *Allan Schwebel* 1/13/07  
 Signature of Design Professional: *Stephanie Demchik* 1/13/07

**DESIGN CERTIFICATE**

I CERTIFY THAT THIS PLAN FOR EROSION AND SEDIMENT CONTROL REPRESENTS A PRACTICAL AND WORKABLE PLAN BASED ON MY PERSONAL KNOWLEDGE OF THE SITE CONDITIONS AND THAT IT WAS PREPARED IN ACCORDANCE WITH THE REQUIREMENTS OF THE NATURAL RESOURCE CONSERVATION SERVICE.

Signature of Design Professional: *Stephanie Demchik* 1/13/07


Signature of Natural Resource Conservation Service: *Jim Meyer* 1/24/07

Signature of Howard Soil Conservation District: *John Robertson* 1/24/07


APPROVED DEPARTMENT OF PLANNING AND ZONING: *Chad Williams* 1/24/07

Signature of Director: *Paula M. Leight* 2/5/10

SCALE: 1"=30'

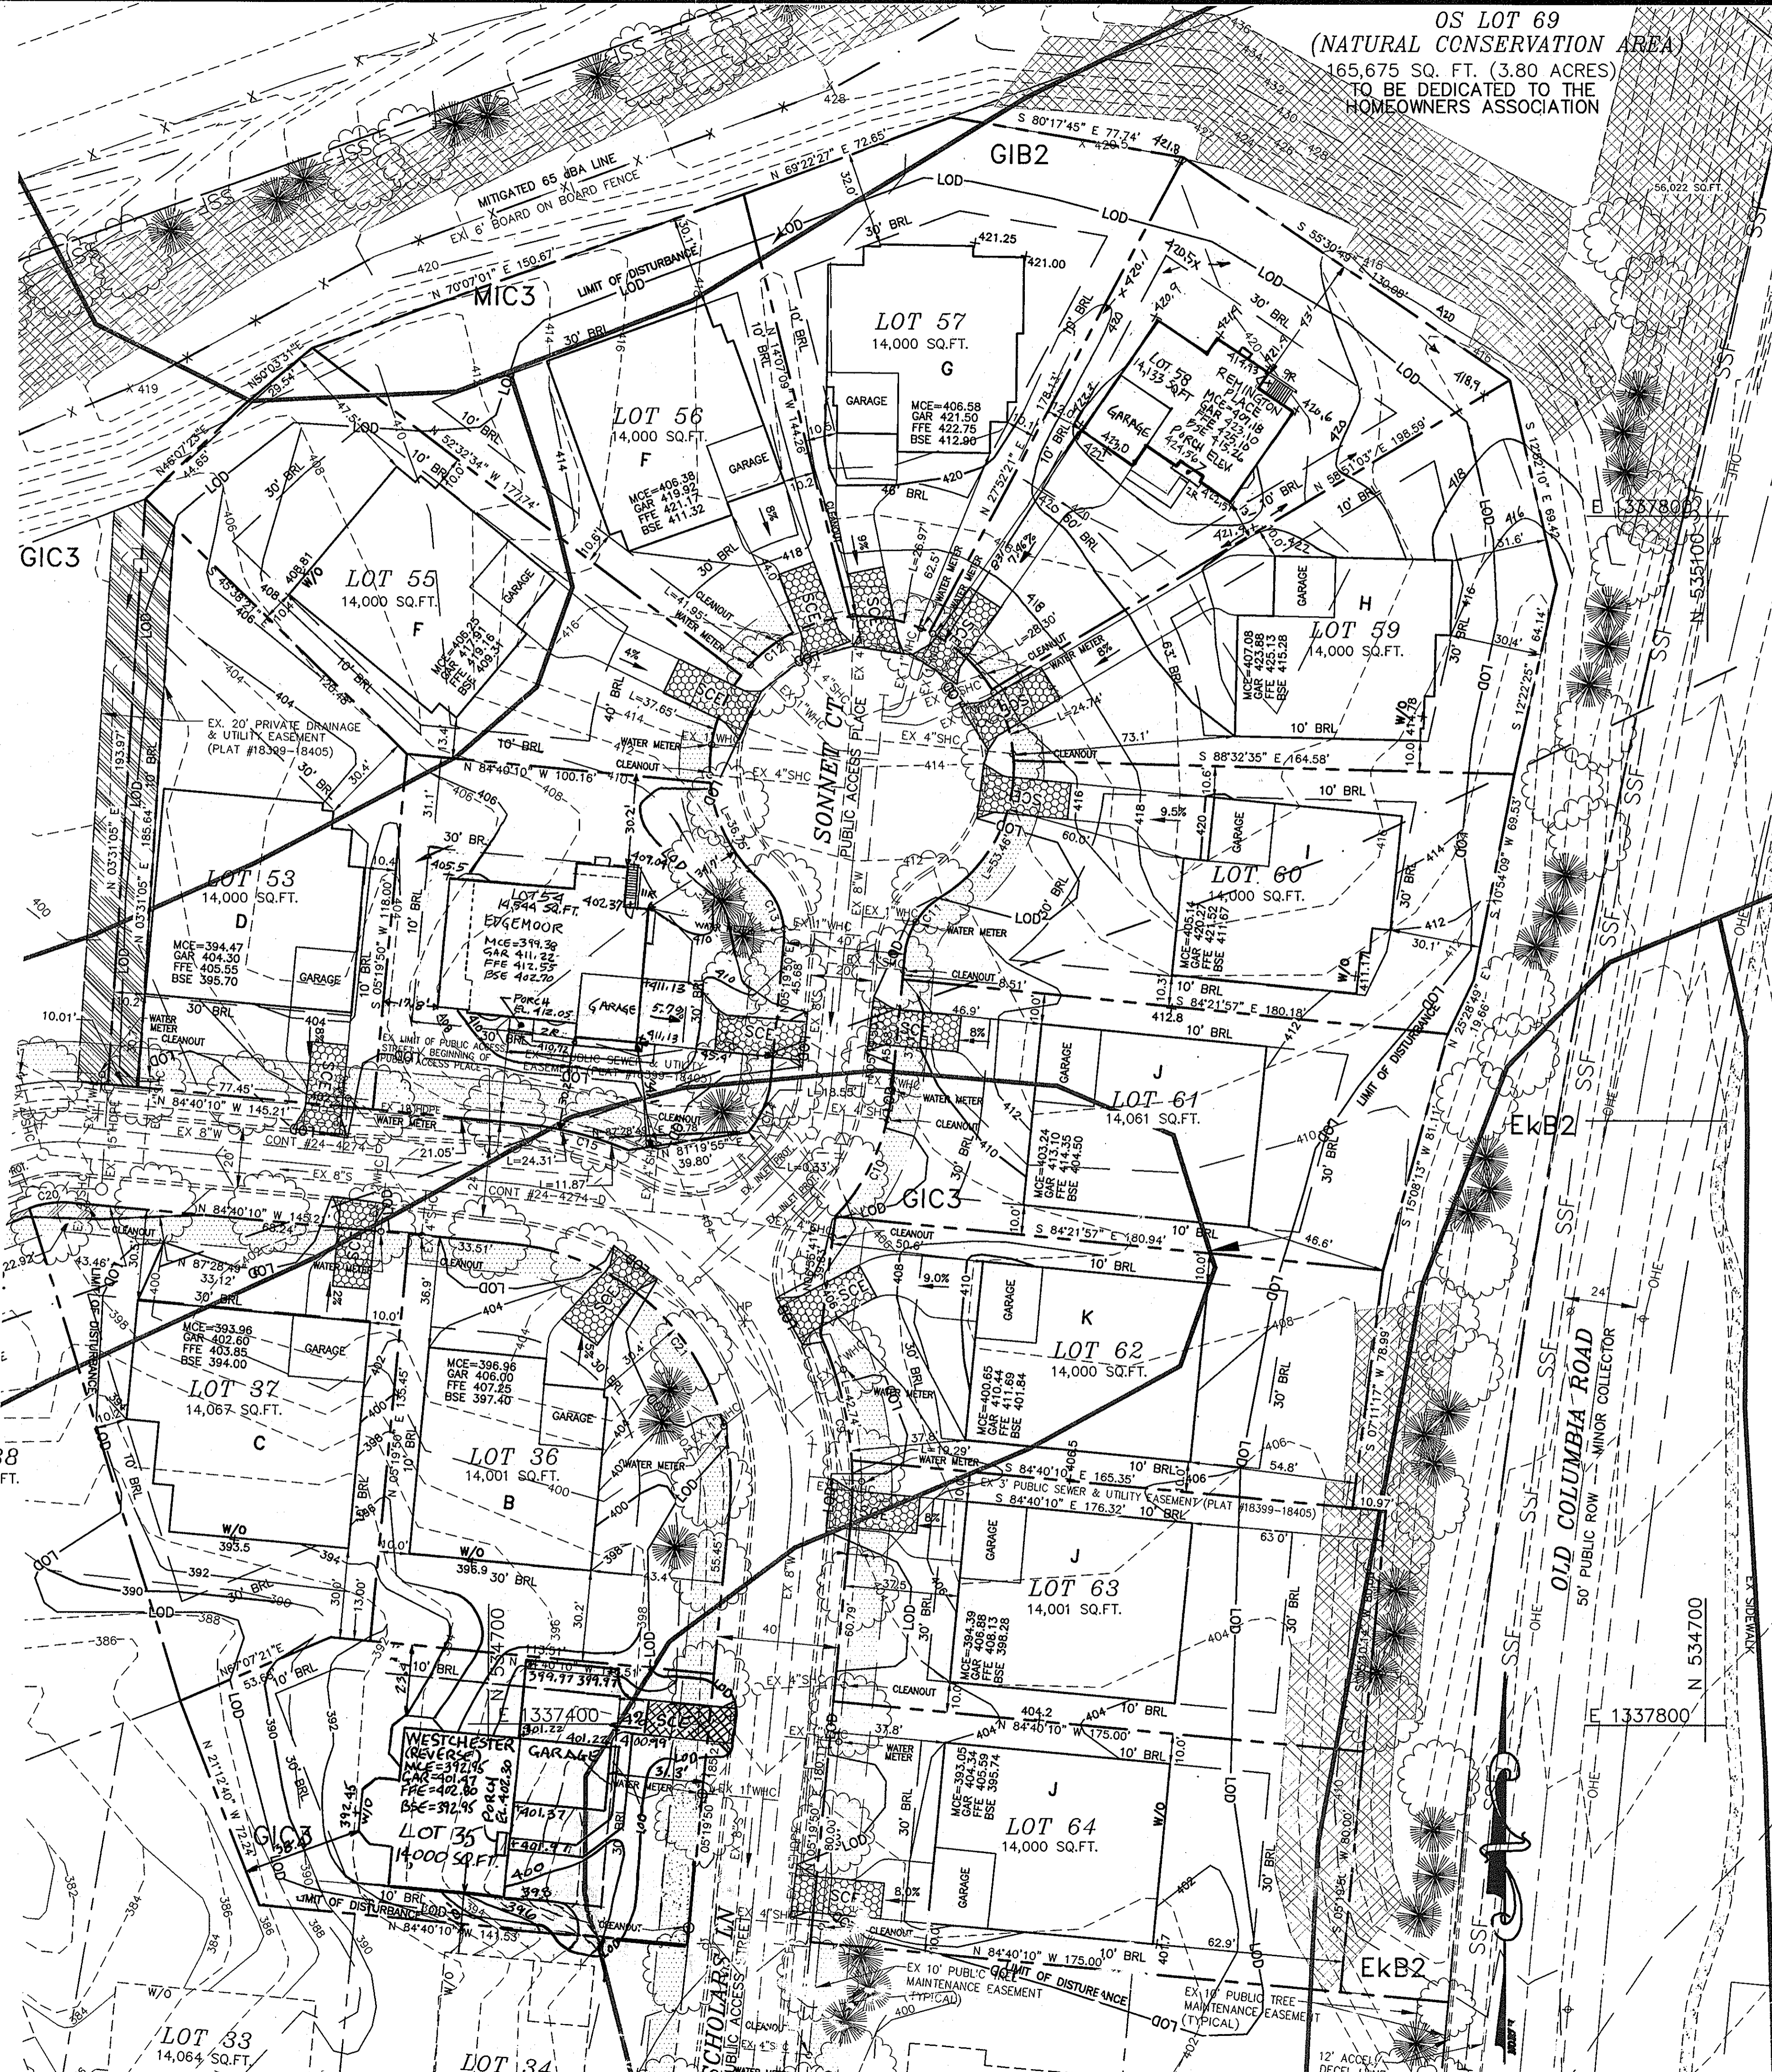

OS LOT 69  
 (NATURAL CONSERVATION AREA)  
 165,675 SQ. FT. (3.80 ACRES)  
 TO BE DEDICATED TO THE  
 HOMEOWNERS ASSOCIATION

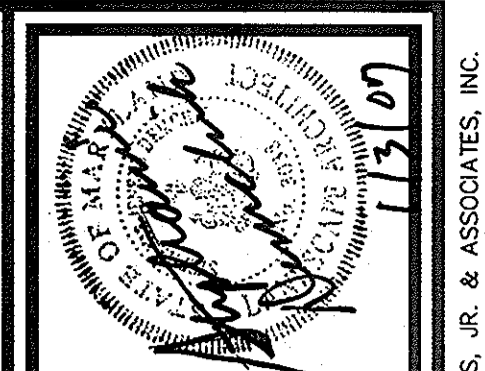

**HARMS**  
 ENGINEERS • PLANNERS • SURVEYORS  
 41 EAST ALL SAINTS STREET, SUITE 210, FREDERICK, MARYLAND 21701  
 Office: 301/631-2027 FAX: 301/631-2028

NO.	REVISION	DATE
1	Hand-drawn	11/18/07
2	As per notes	1/13/08
3	As per notes	6/19/08
4	As per notes	1/23/10

**SITE DEVELOPMENT PLAN**  
**JAMESTOWN LANDING, SECTION II,**  
**LOTS 35-37 & 53-64**  
 TAX MAP: 46 - PARCEL: 229 & 352  
 FIFTH ELECTION DISTRICT - HOWARD COUNTY, MARYLAND

**2nd BUILDER**  
 NV HOMES  
 6085 MARSHALL DRIVE, SUITE 130  
 ELKRUNGE, MARYLAND 21075  
 (410) 379-5956

**BUILDER/DEVELOPER**  
 CRAFTMARK HOMPS  
 4820 ELM ST., SUITE 200  
 MCLEAN, VIRGINIA 22101  
 (703)-928-6940


**OWNER**  
 JAMESTOWN LANDING, LC  
 8820 ELM ST., SUITE 200  
 MCLEAN, VIRGINIA 22101  
 (703)-734-9730

DESIGNED BY: SJD  
 DRAWN BY: SJD  
 CHECKED BY: SJD  
 DATE: JAN 2007  
 P.L.C. NO. 08-06-014A


2 OF 5

SDP-07-010


Date: 01/03/2007 User: sdcmbk  
 Drawing Path: \\D:\2006\Projects\Jamestown II, SP-HOW Co\08-06-014\DWG Site Plans\PHASE 3\UNSTN-SP-PH-3-03-GEN BOXES.dwg XREF File(s):

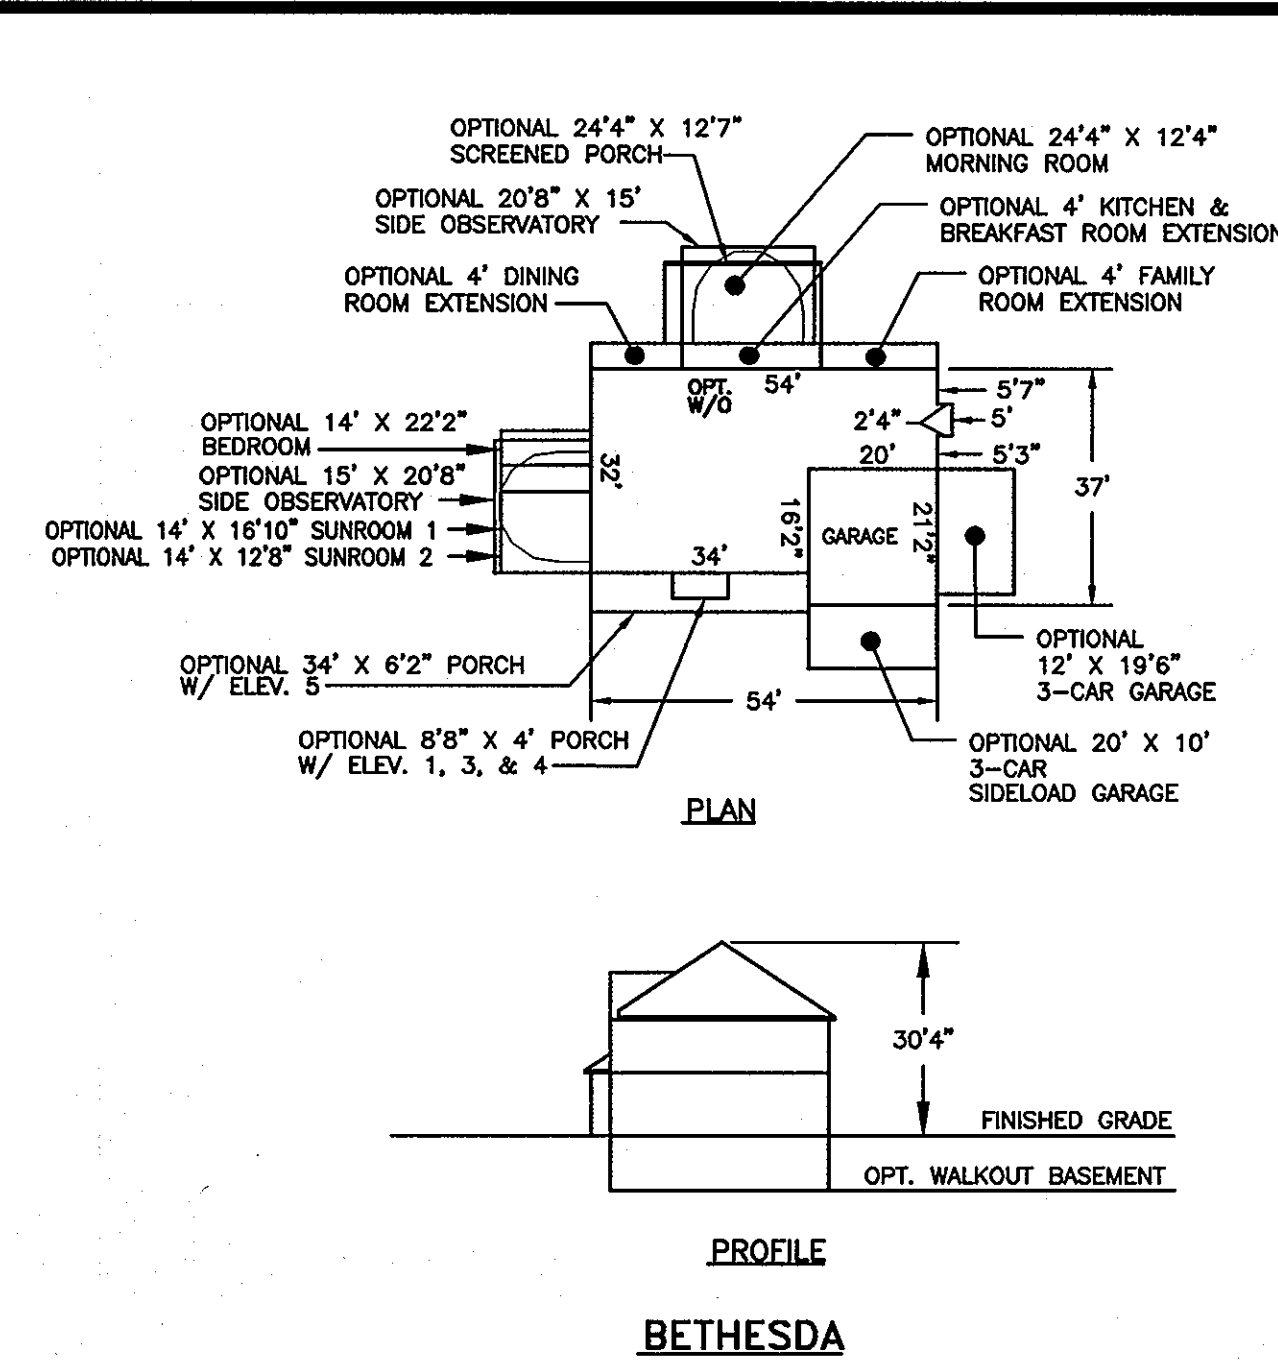


**BETHESDA**

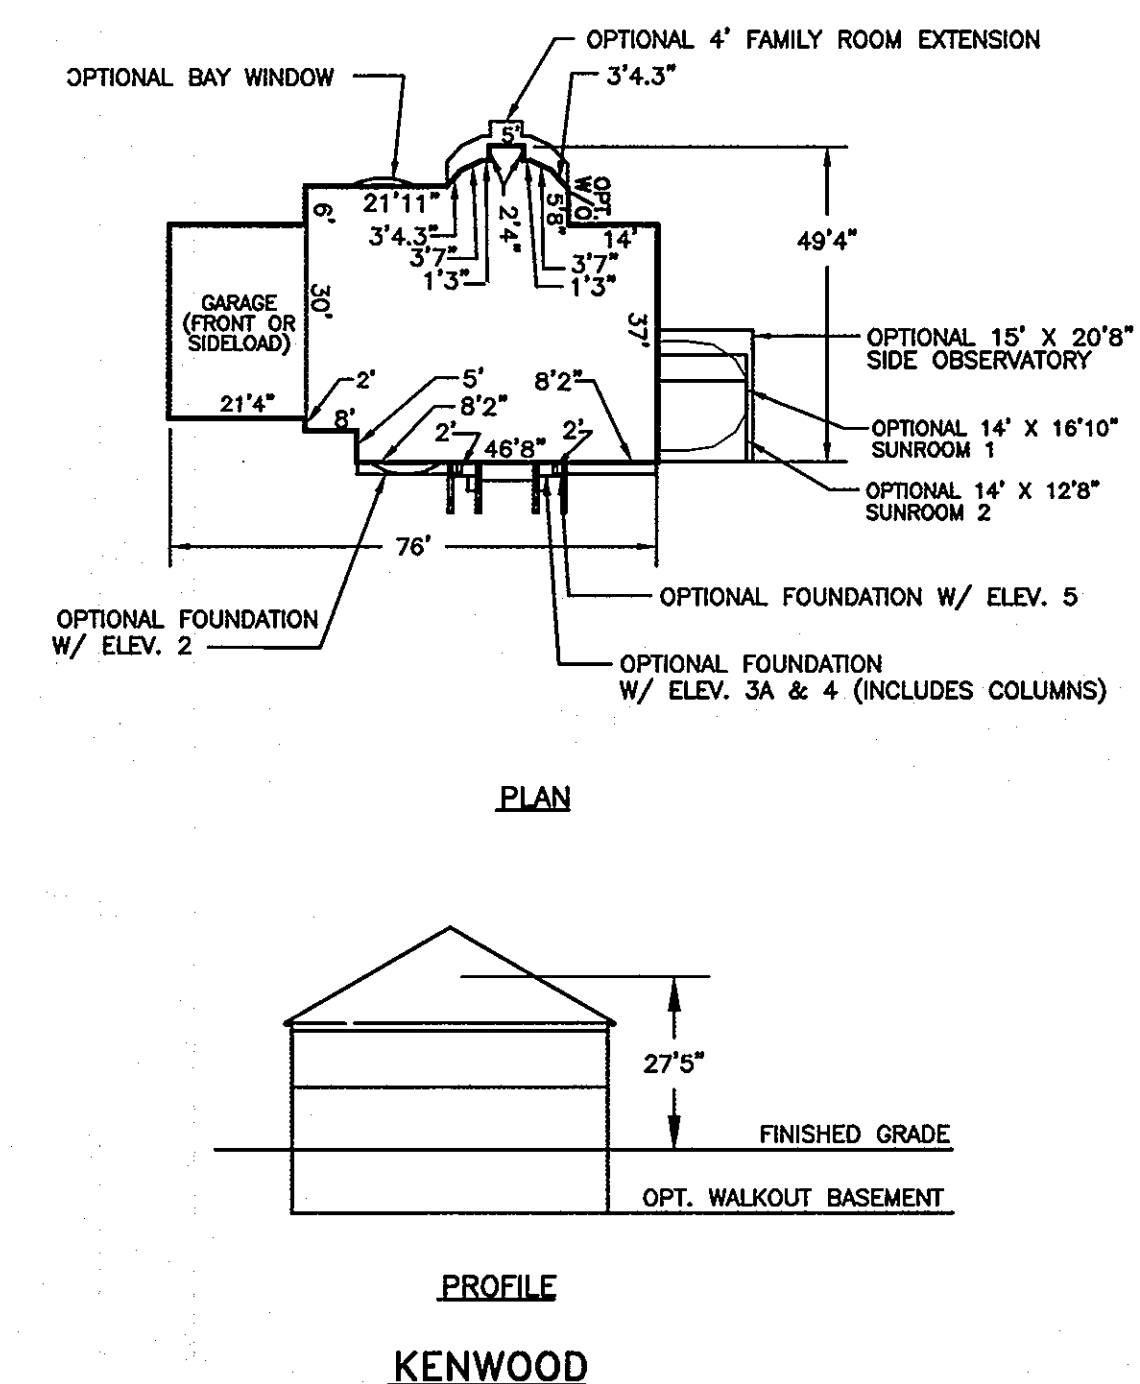


**KENWOOD**

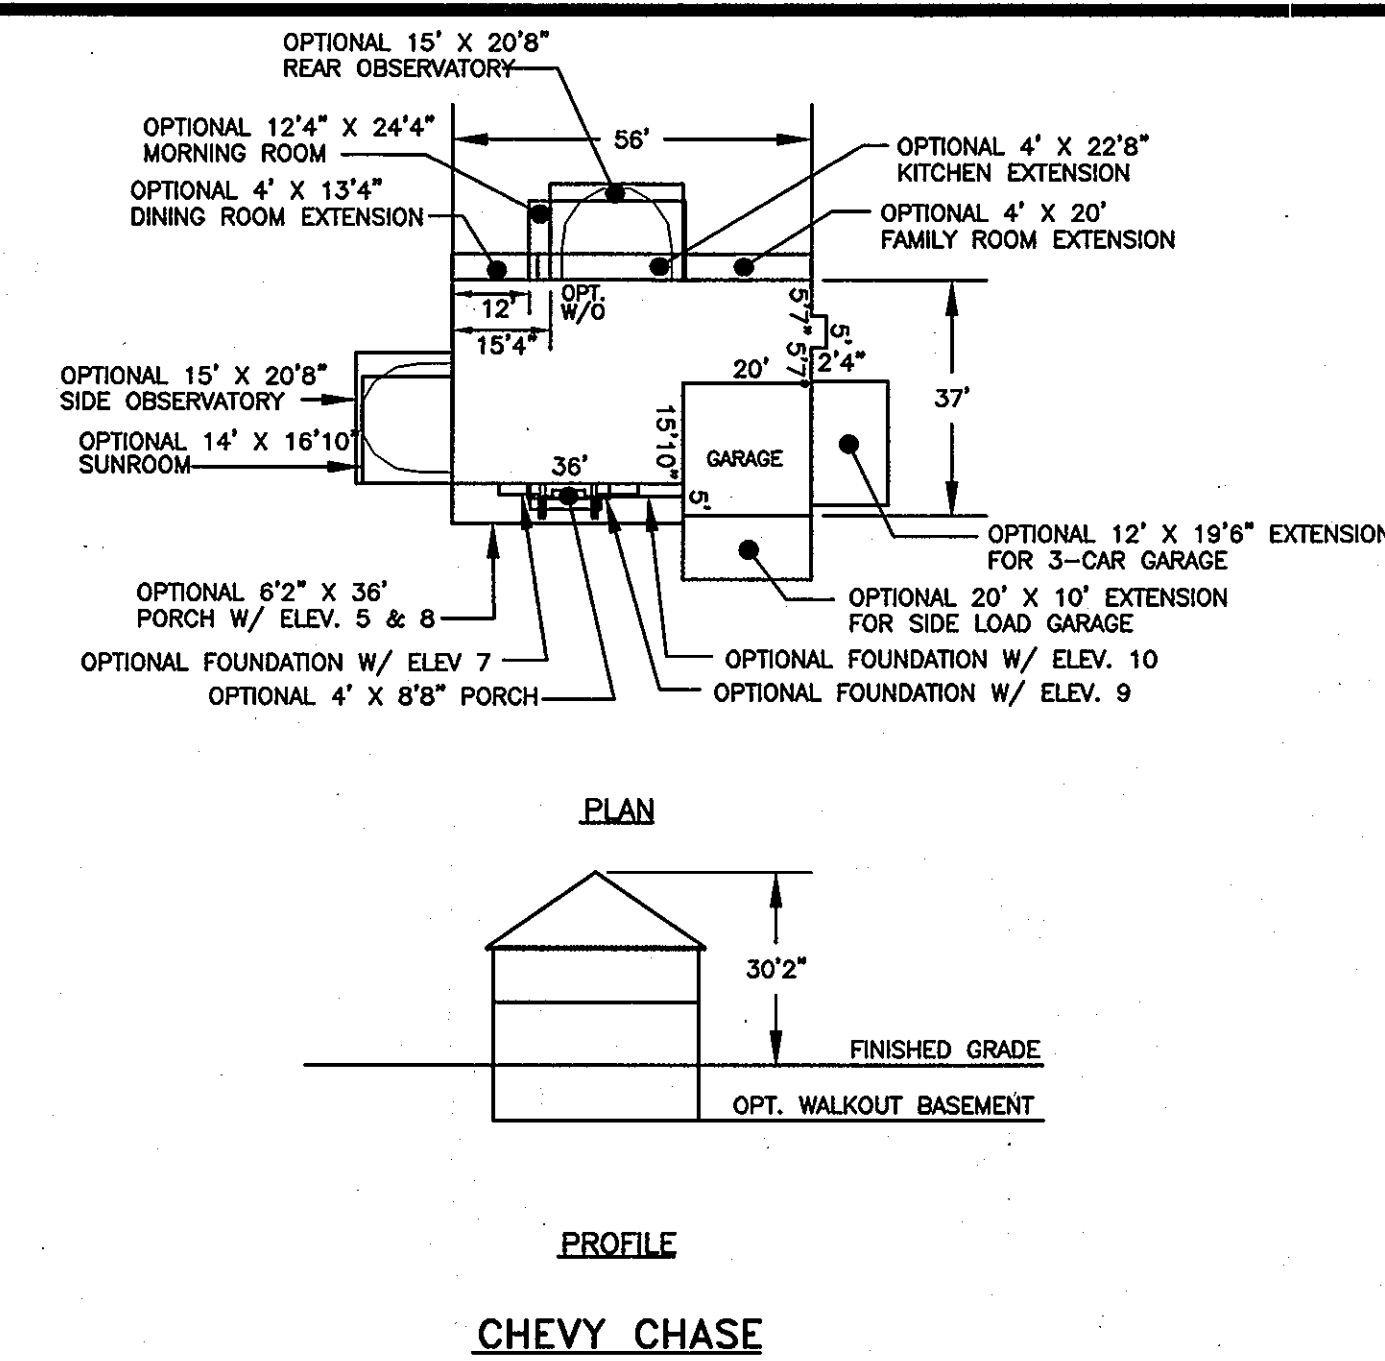


**CHEVY CHASE**

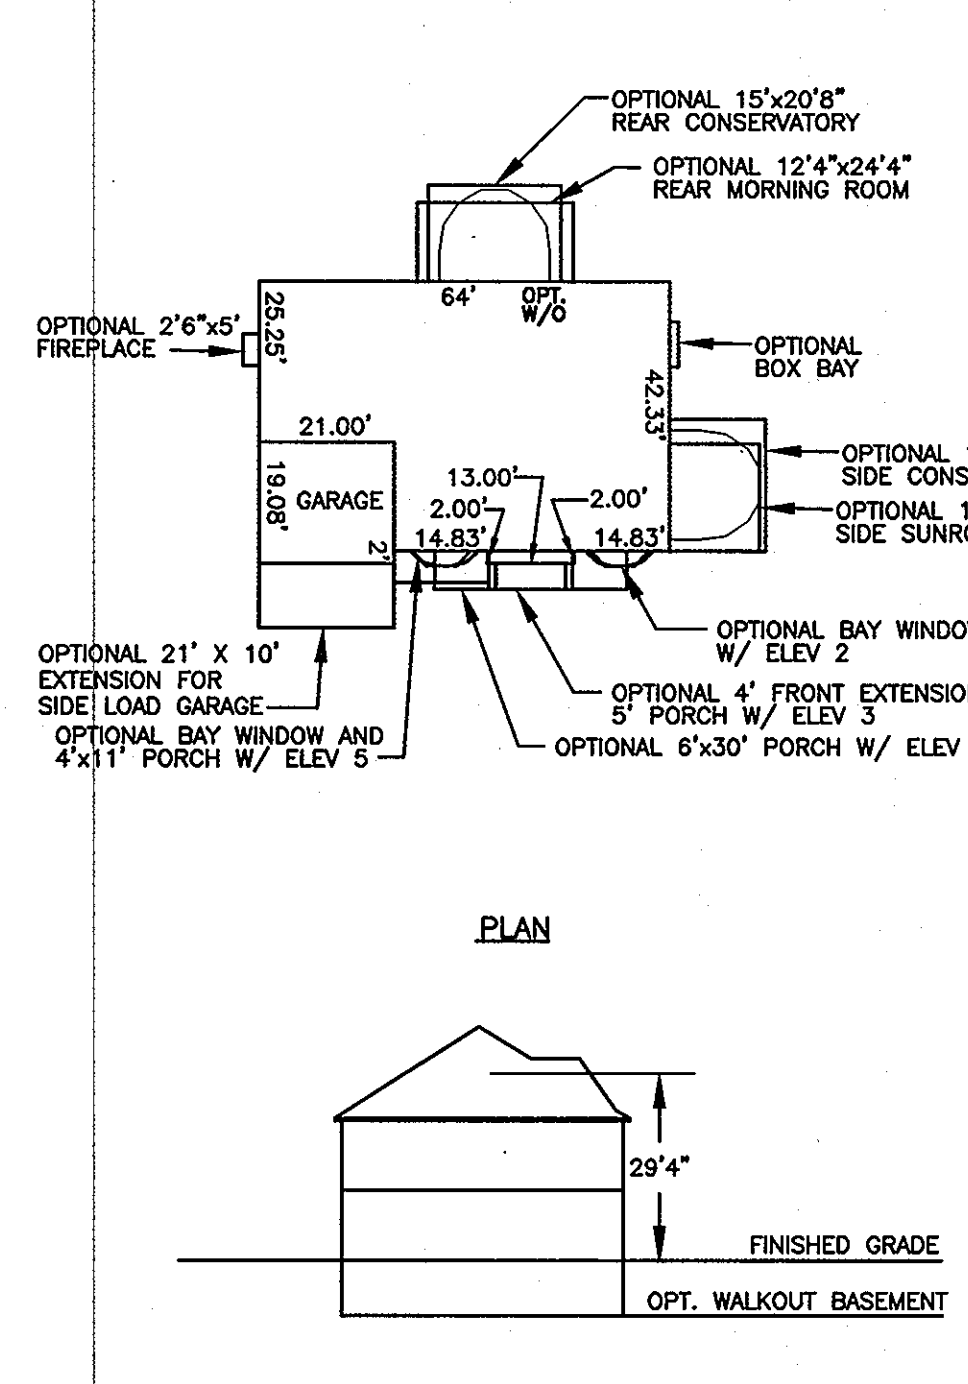


**OAKMONT**

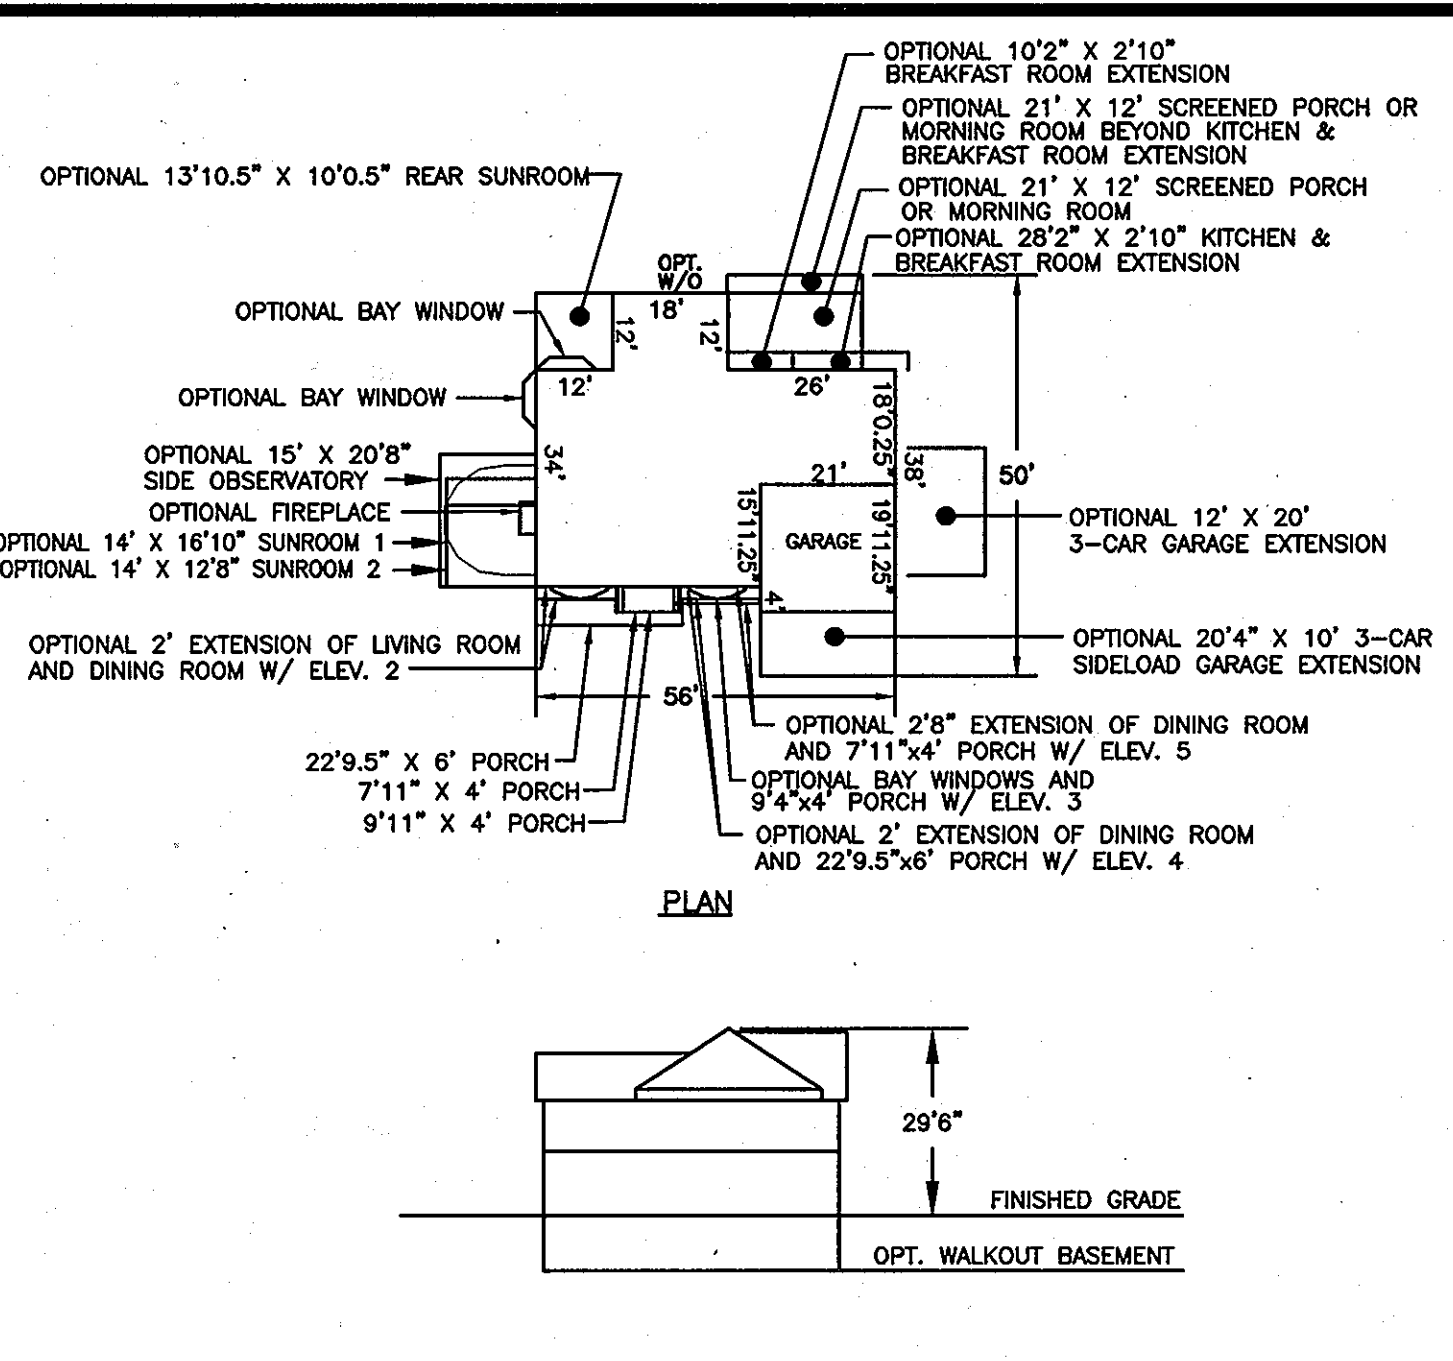


**CLIFTON**

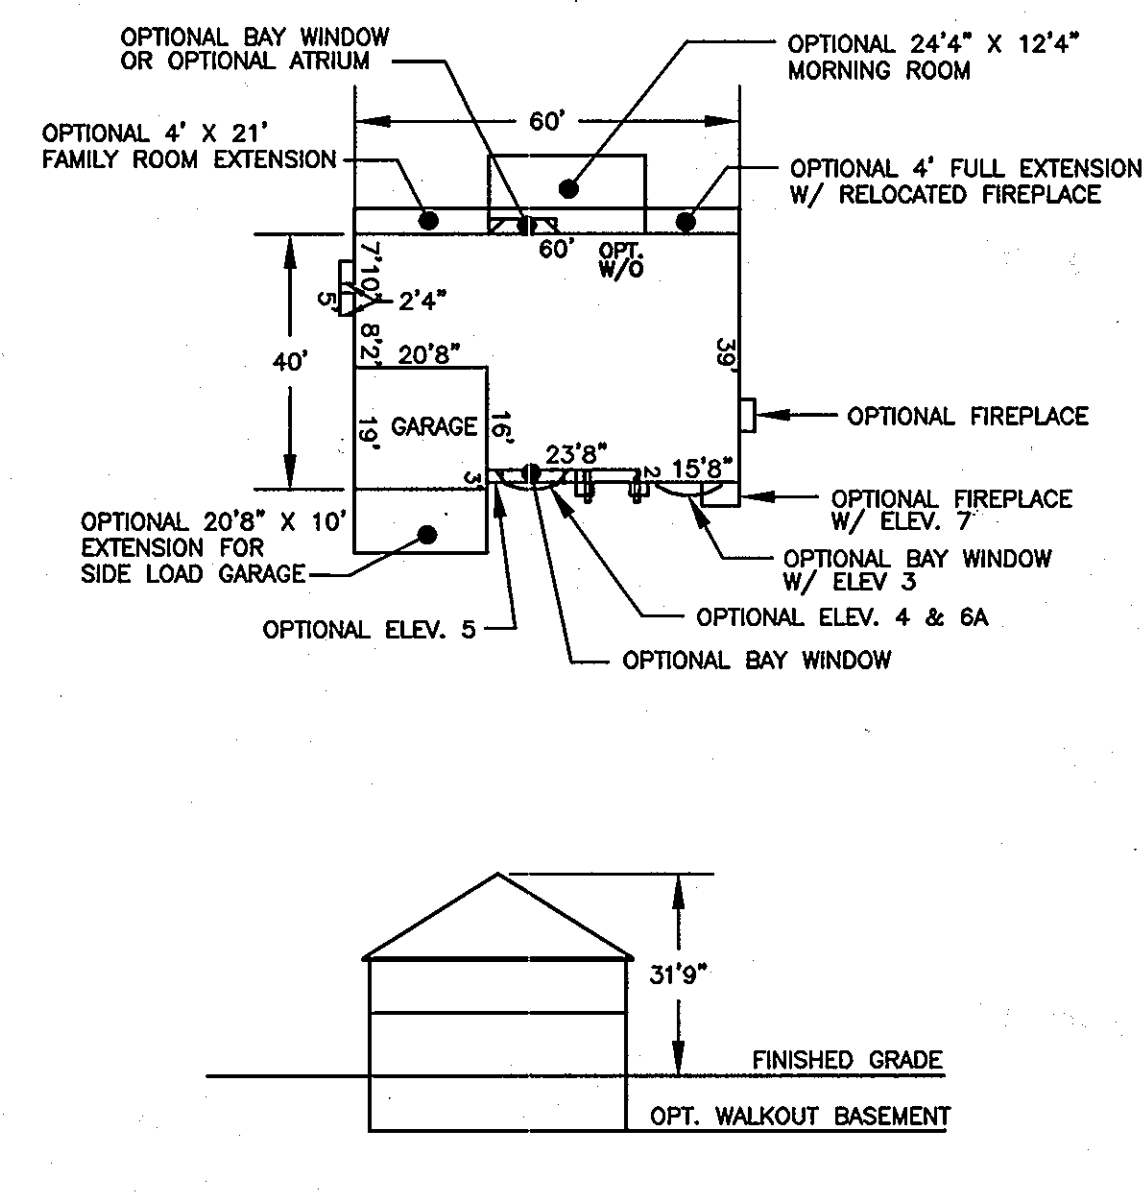

**OAKTON**

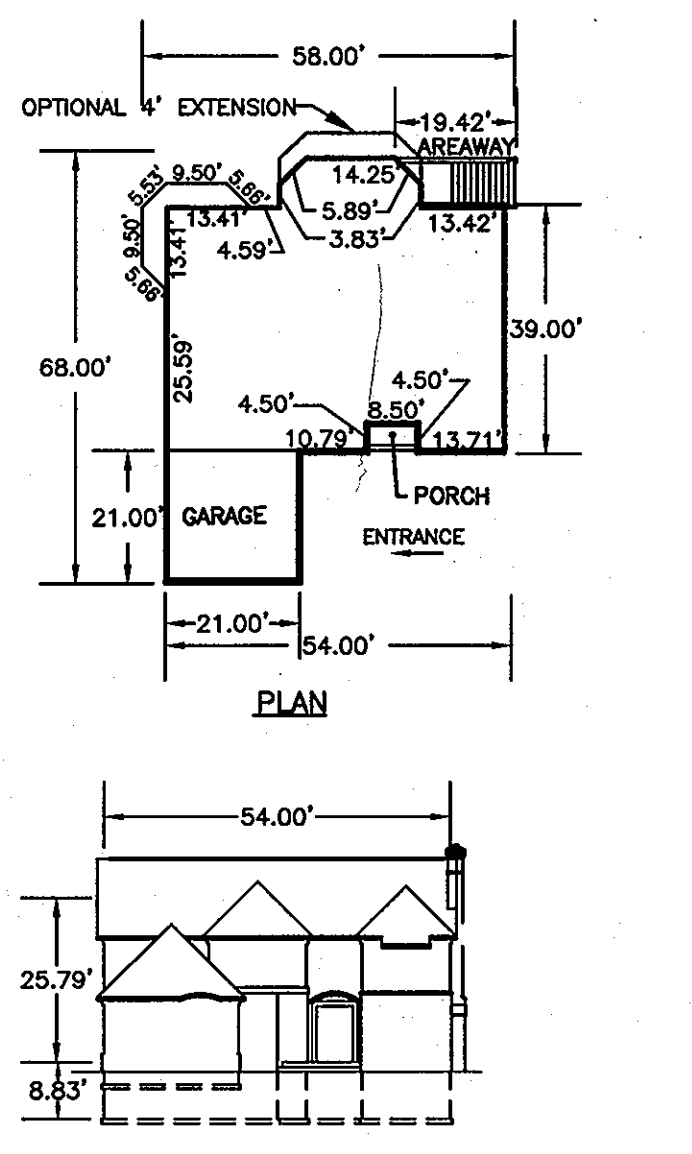


**WESTCHESTER**

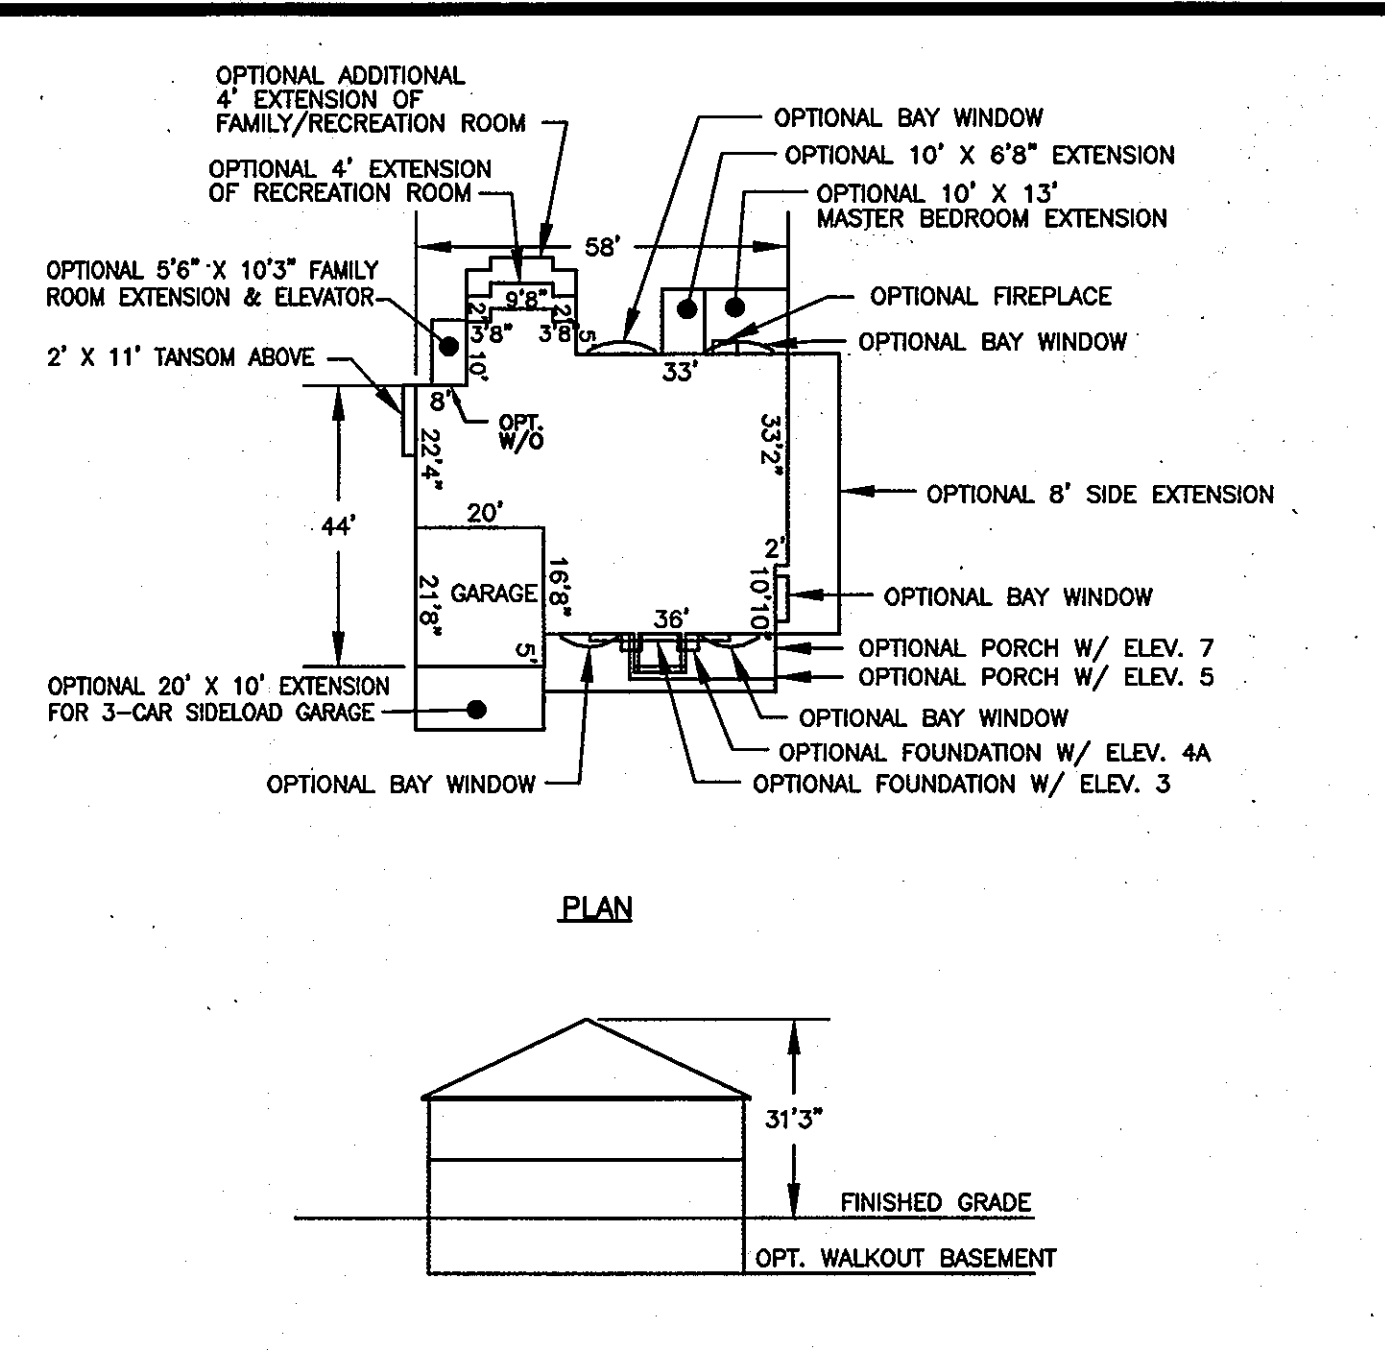

**EDGEMOOR**

GENERIC TYPE	BETHESDA	CHEVY CHASE	CLIFTON	EDGEMOOR	KENWOOD	OAKMONT	OAKTON	WESTCHESTER
A	REVERSE NO 3-CAR FRONTLOAD GARAGE WITH SIDE ROOMS	REVERSE NO 3-CAR FRONTLOAD GARAGE NO SIDE ROOMS	REVERSE NO 3-CAR FRONTLOAD GARAGE NO SIDE ROOMS	NO SIDELOAD GARAGE	DOES NOT FIT	NO SIDELOAD GARAGE NO SIDE ROOMS	NO SIDELOAD GARAGE	REVERSE ALL OPTIONS
B	REVERSE NO 3-CAR FRONTLOAD GARAGE NO SIDE ROOMS NO 3-CAR SIDELOAD GARAGE WITH REAR ROOMS	REVERSE NO 3-CAR FRONTLOAD GARAGE NO SIDE ROOMS NO 3-CAR SIDELOAD GARAGE WITH REAR ROOMS	REVERSE NO 3-CAR FRONTLOAD GARAGE NO SIDE ROOMS NO 3-CAR SIDELOAD GARAGE WITH 21'x12' SCREENED PORCH AND 2'x10' REAR EXTENSIONS	NO 3-CAR SIDELOAD GARAGE NO 8' REAR EXTENSION	DOES NOT FIT	DOES NOT FIT	NO 3-CAR SIDELOAD GARAGE WITH REAR MORNING ROOM	REVERSE ALL OPTIONS
C	REVERSE NO SIDELOAD OR 3-CAR GARAGE WITH SIDE ROOMS	REVERSE NO 3-CAR FRONTLOAD GARAGE WITH SIDE ROOMS	REVERSE NO 3-CAR GARAGE WITH SIDE ROOMS	NO SIDELOAD GARAGE	NO SIDELOAD GARAGE NO SIDE ROOMS	NO SIDELOAD GARAGE NO SIDE ROOMS	NO SIDELOAD GARAGE	REVERSE ALL OPTIONS
D	NO SIDELOAD OR 3-CAR FRONTLOAD GARAGE WITH SIDE SUNROOM NO SIDE OBSERVATORY	NO SIDEROOMS	NO SIDE ROOMS	NO SIDELOAD GARAGE NO 4' OR 8' REAR EXTENSION OR FAMILY ROOM EXTENSION WITH 8' SIDE EXTENSION	DOES NOT FIT	REVERSE NO SIDELOAD GARAGE NO SIDE ROOMS	REVERSE NO SIDELOAD GARAGE	ALL OPTIONS
E	NO 3-CAR SIDELOAD GARAGE WITH REAR ROOMS	NO 3-CAR SIDELOAD GARAGE	NO 3-CAR SIDELOAD GARAGE NO SIDE ROOMS WITH REAR MORNING ROOM	DOES NOT FIT	NO SIDE ROOMS	REVERSE NO 3-CAR GARAGE NO SIDELOAD GARAGE NO SIDE ROOMS NO ELEV. 4	REVERSE NO 3-CAR SIDELOAD GARAGE OR REAR EXTENSION WITH REAR MORNING ROOM	DOES NOT FIT
F	NO SIDELOAD GARAGE NO 3-CAR GARAGE NO SIDE ROOMS	NO SIDELOAD GARAGE NO 3-CAR GARAGE NO SIDE ROOMS	NO SIDELOAD GARAGE NO 3-CAR GARAGE NO SIDE ROOMS	NO SIDELOAD GARAGE NO SIDE ROOMS	DOES NOT FIT	DOES NOT FIT	REVERSE NO SIDELOAD GARAGE	ALL OPTIONS
G	REVERSE NO SIDELOAD GARAGE NO 3-CAR GARAGE NO SIDE ROOMS	REVERSE NO SIDELOAD GARAGE NO 3-CAR GARAGE NO SIDE ROOMS	REVERSE NO SIDELOAD GARAGE NO 3-CAR GARAGE NO SIDE ROOMS	NO SIDELOAD GARAGE NO 8' REAR EXTENSION NO 4' OR 8' REAR EXTENSION	DOES NOT FIT	DOES NOT FIT	NO SIDELOAD GARAGE NO MORNING ROOM WITH REAR EXTENSION NO OPT. FIREPLACE (ELEV. 7)	REVERSE ALL OPTIONS
H	REVERSE NO SIDELOAD GARAGE NO 3-CAR GARAGE NO SIDE ROOMS NO REAR OBSERVATORY WITH 4' REAR EXTENSION	REVERSE NO SIDELOAD GARAGE NO 3-CAR GARAGE NO SIDE ROOMS NO REAR OBSERVATORY WITH 4' REAR EXTENSION	REVERSE NO SIDELOAD GARAGE NO 3-CAR GARAGE NO SIDE ROOMS	REVERSE NO SIDELOAD GARAGE NO 3-CAR GARAGE NO 4' OR 8' REAR EXTENSION NO MASTER BEDROOM EXTENSIONS	DOES NOT FIT	DOES NOT FIT	NO SIDELOAD GARAGE NO MORNING ROOM WITH 4' REAR EXTENSION	REVERSE NO OPTIONAL DEN NO OPTIONAL REAR EXTENSION
I	REVERSE NO 3-CAR GARAGE NO SIDELOAD GARAGE NO SIDE ROOMS	REVERSE NO 3-CAR GARAGE NO SIDELOAD GARAGE NO SIDE ROOMS	REVERSE NO 3-CAR GARAGE NO SIDELOAD GARAGE NO SIDE ROOMS	REVERSE NO SIDELOAD GARAGE NO 8' SIDE EXTENSION NO 4' OR 8' REAR EXTENSION	DOES NOT FIT	DOES NOT FIT	NO SIDELOAD GARAGE NO MORNING ROOM WITH 4' REAR EXTENSION	REVERSE NO OPTIONAL DEN EXT.
J	REVERSE NO 3-CAR GARAGE NO SIDELOAD GARAGE NO SIDE ROOMS	REVERSE NO 3-CAR GARAGE NO SIDELOAD GARAGE NO SIDE ROOMS	REVERSE NO 3-CAR GARAGE NO SIDELOAD GARAGE NO SIDE ROOMS	REVERSE NO SIDELOAD GARAGE NO 8' SIDE EXTENSION	DOES NOT FIT	DOES NOT FIT	NO SIDELOAD GARAGE	REVERSE ALL OPTIONS
K	REVERSE NO 3-CAR GARAGE NO SIDELOAD GARAGE NO SIDE ROOMS	REVERSE NO 3-CAR GARAGE NO SIDELOAD GARAGE NO SIDE ROOMS	REVERSE NO 3-CAR GARAGE NO SIDELOAD GARAGE NO SIDE ROOMS	REVERSE NO SIDELOAD GARAGE NO 8' SIDE EXTENSION	DOES NOT FIT	DOES NOT FIT	DOES NOT FIT	REVERSE ALL OPTIONS

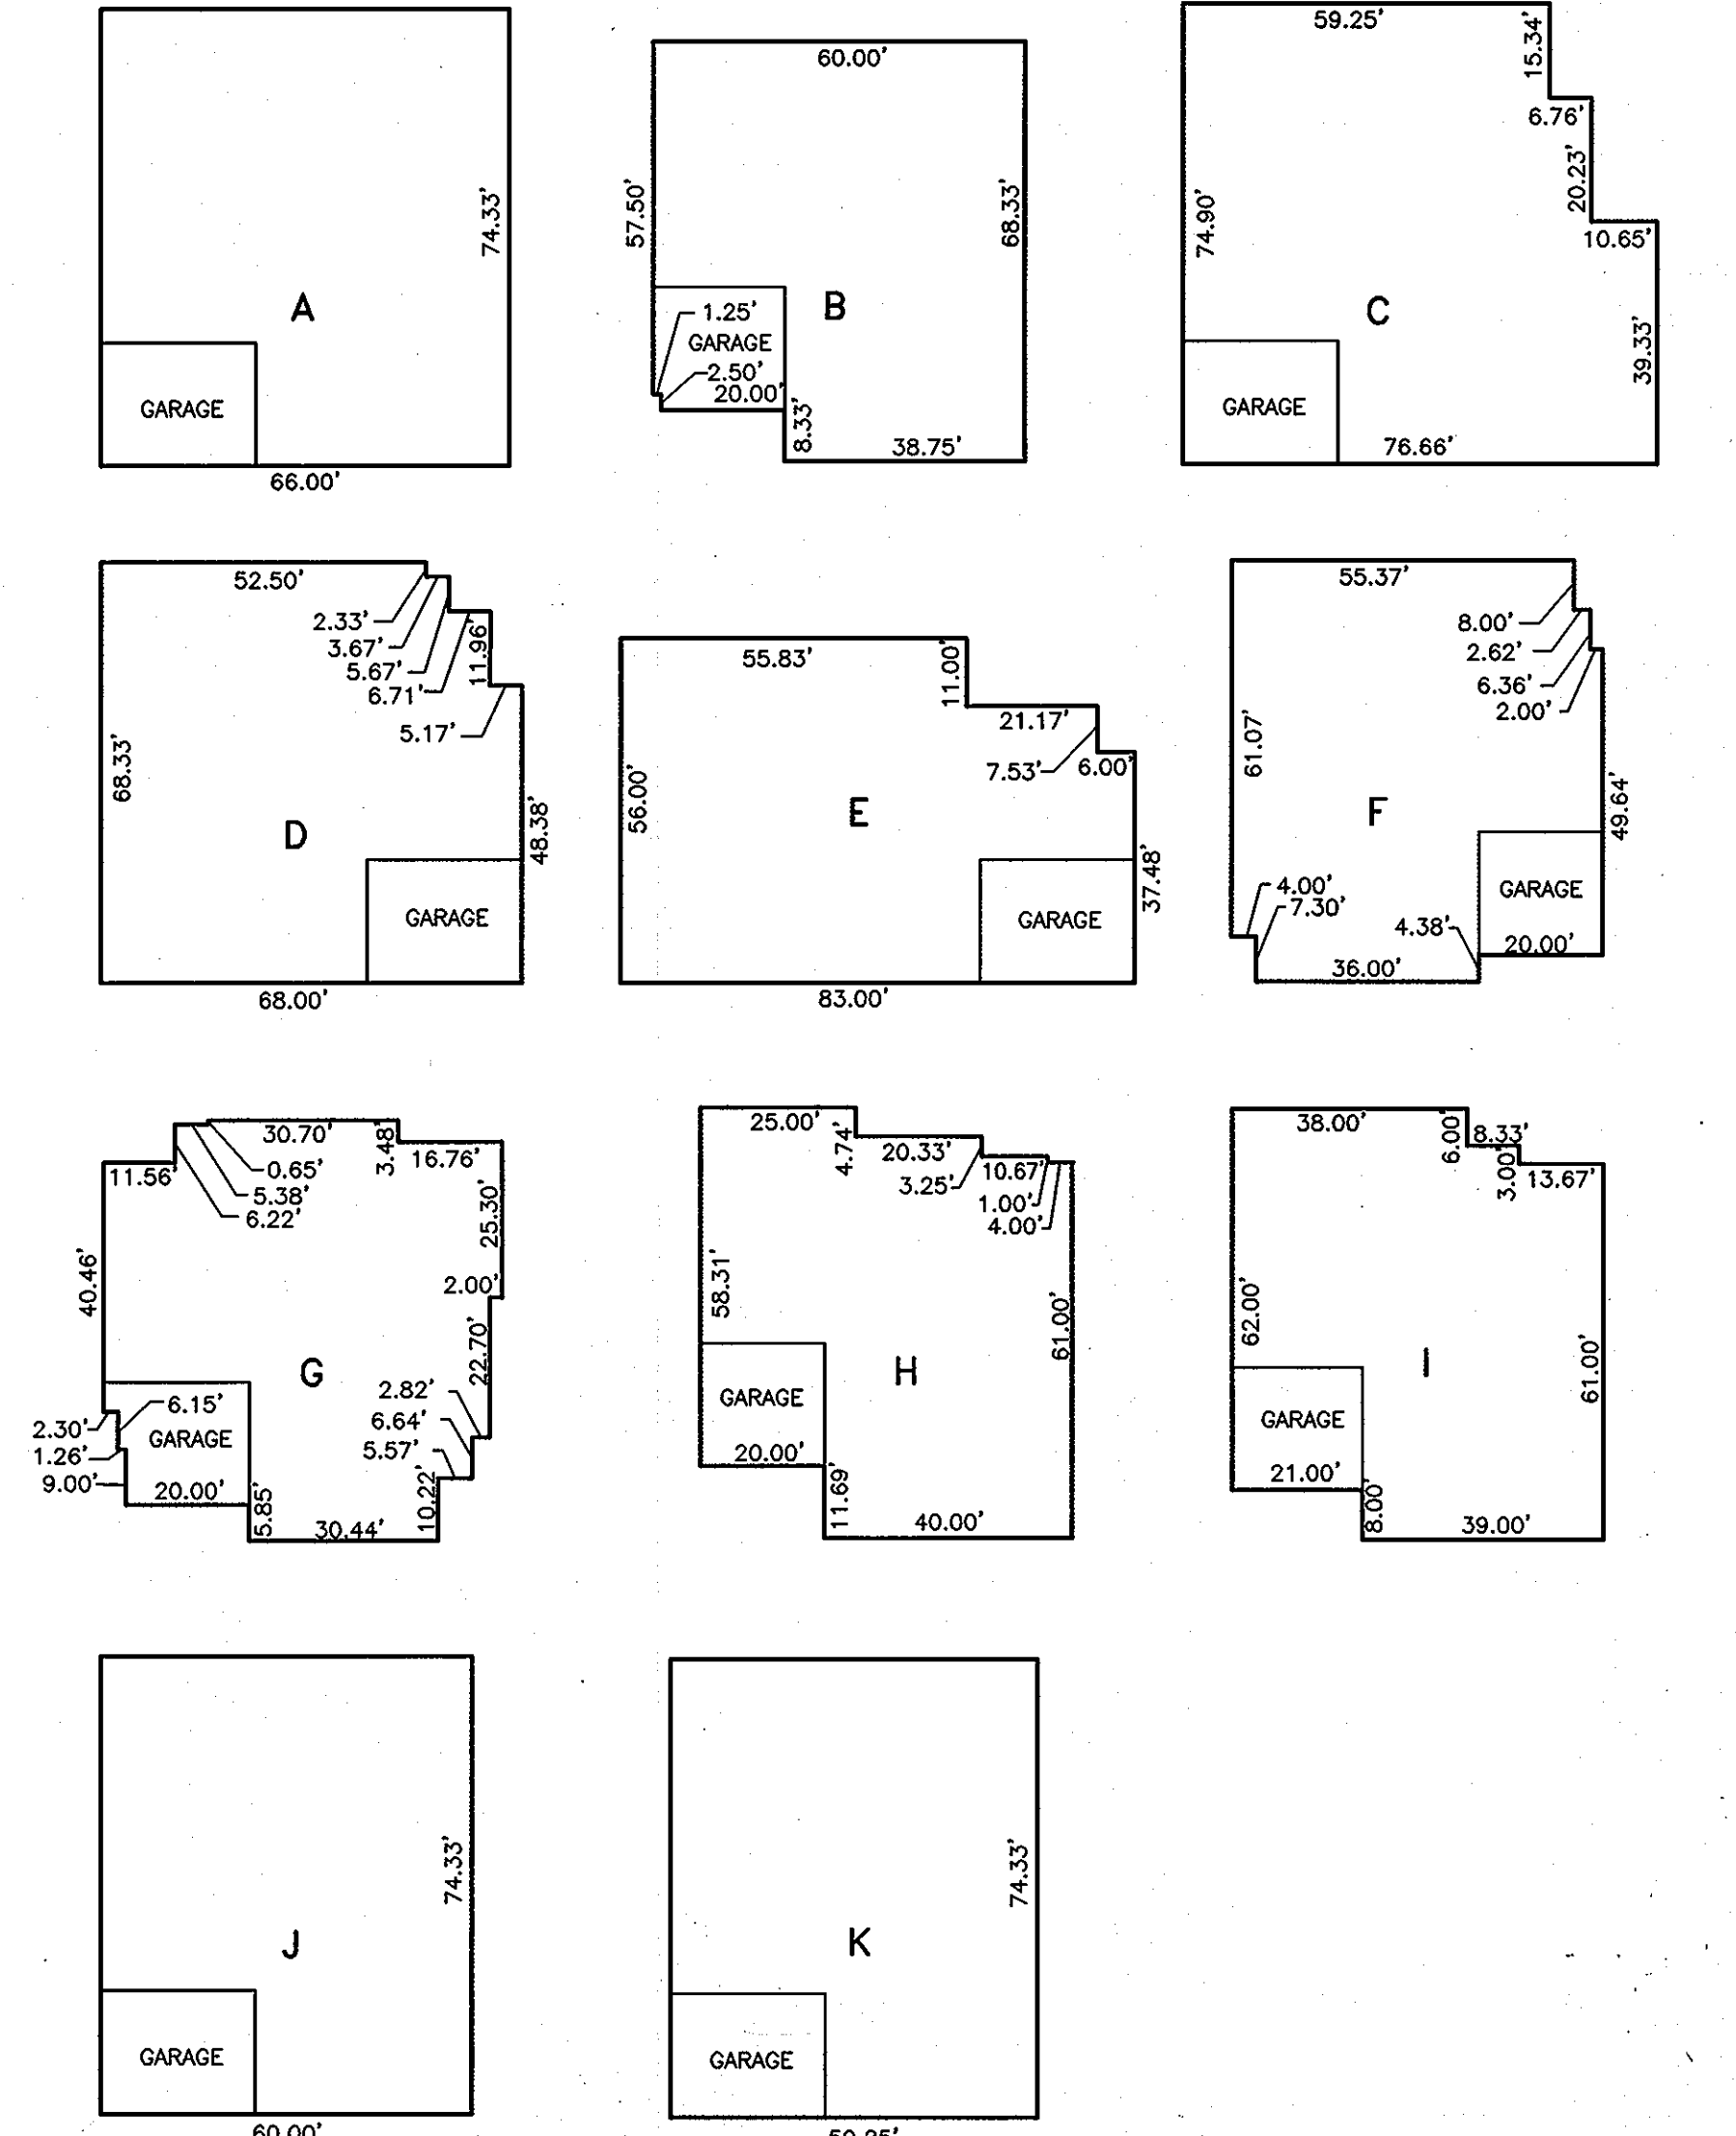

**GENERIC BOXES**  
SCALE: 1"=30'

APPROVED DEPARTMENT OF PLANNING AND ZONING  
 [Signature]  
 CHIEF, DEVELOPMENT ENGINEERING DIVISION  
 [Signature]  
 CHIEF, DIVISION OF LAND DEVELOPMENT  
 [Signature]

**BUILDER/DEVELOPER**  
**CRAFTMARK HOMES**  
 6820 ELM STREET, SUITE 200  
 MCLEAN, VIRGINIA 22101  
 (703)-828-8940  
  
**OWNER**  
**JAMESTOWN LANDING, LC**  
 6820 ELM STREET, SUITE 200  
 MCLEAN, VIRGINIA 22101  
 (703)-734-9730

**HARMS**  
 ENGINEERS - PLANNERS - SURVEYORS  
 41 EAST ALL SAINTS STREET, SUITE 210, FREDERICK, MARYLAND 21701  
 OFFICE: 301/831-2027 FAX: 301/831-2028

NO.	REVISION	BY	DATE
2	REVISE SHEET NUMBER	ST	4/1/07

**JAMESTOWN LANDING, SECTION II,**  
**LOTS 35-37 & 53-64**  
 TAX MAP: 46 - PARCEL: 229 & 352  
 FIFTH ELECTION DISTRICT HOWARD COUNTY, MARYLAND

DESIGNED BY: [Signature]  
 DRAWN BY: [Signature]  
 CHECKED BY: [Signature]  
 DATE: JAN 2007  
 W.O. NO. 08-06-014A

3 OF 5

HOWARD SOIL CONSERVATION DISTRICT

PERMANENT SEEDING NOTES

APPLY TO GRADED OR CLEARED AREAS NOT SUBJECT TO IMMEDIATE FURTHER DISTURBANCE WHERE A PERMANENT LONG-LIVED VEGETATIVE COVER IS NEEDED. SEEDBED PREPARATION: LOOSEN UPPER THREE INCHES OF SOIL BY RAKING, DISKING OR OTHER ACCEPTABLE MEANS BEFORE SEEDING...

TEMPORARY SEEDING NOTES

APPLY TO GRADED OR CLEARED AREAS LIKELY TO BE REDISTURBED WHERE A SHORT-TERM VEGETATIVE COVER IS NEEDED. SEEDBED PREPARATION: LOOSEN UPPER THREE INCHES OF SOIL BY RAKING, DISKING OR OTHER ACCEPTABLE MEANS BEFORE SEEDING...

STANDARD SEDIMENT CONTROL NOTES

- 1) A MINIMUM OF 48 HOURS NOTICE MUST BE GIVEN TO THE HOWARD COUNTY DEPARTMENT OF INSPECTIONS, LICENSES AND PERMITS, SEDIMENT CONTROL DIVISION PRIOR TO THE START OF ANY CONSTRUCTION... 2) ALL VEGETATIVE AND STRUCTURAL PRACTICES ARE TO BE INSTALLED ACCORDING TO THE PROVISIONS OF THIS PLAN AND ARE TO BE IN CONFORMANCE WITH THE MOST CURRENT MARYLAND STANDARDS...

THESE QUANTITIES ARE FOR PERMIT PURPOSES ONLY. CONTRACTOR IS REQUIRED TO PROVIDE HIS OWN QUANTITY MEASUREMENTS.

- 8) ANY SEDIMENT CONTROL PRACTICE WHICH IS DISTURBED BY GRADING ACTIVITY FOR PLACEMENT OF UTILITIES MUST BE REPAIRED ON THE SAME DAY OF DISTURBANCE. 9) ADDITIONAL SEDIMENT CONTROL MUST BE PROVIDED, IF DEEMED NECESSARY BY THE HOWARD COUNTY SEDIMENT CONTROL INSPECTOR.

STANDARD AND SPECIFICATIONS FOR TOPSOIL

DEFINITION: PLACEMENT OF TOPSOIL OVER A PREPARED SUBSOIL PRIOR TO ESTABLISHMENT OF PERMANENT VEGETATION. PURPOSE: TO PROVIDE A SUITABLE SOIL MEDIUM FOR VEGETATIVE GROWTH. SOILS OF CONCERN HAVE LOW MOISTURE CONTENT, LOW NUTRIENT LEVELS, LOW PH, MATERIALS TOXIC TO PLANTS, AND/OR UNACCEPTABLE SOIL GRADATION.

CONSTRUCTION AND MATERIAL SPECIFICATIONS: 1) TOPSOIL SALVAGED FROM THE EXISTING SITE MAY BE USED PROVIDED THAT IT MEETS THE STANDARDS AS SET FORTH IN THESE SPECIFICATIONS. TYPICALLY, THE DEPTH OF TOPSOIL TO BE SALVAGED FOR A GIVEN SOIL TYPE CAN BE FOUND IN THE REPRESENTATIVE SOIL PROFILE SECTION IN THE SOIL SURVEY PUBLISHED BY USDA-SCS...

- i. TOPSOIL SHALL BE A LOAM, SANDY LOAM, CLAY LOAM, SILT LOAM, SANDY CLAY LOAM, LOAMY SAND. OTHER SOILS MAY BE USED IF RECOMMENDED BY AN AGRONOMIST OR SOIL SCIENTIST AND APPROVED BY THE APPROPRIATE APPROVAL AUTHORITY. ii. TOPSOIL MUST BE FREE OF PLANTS OR PLANT PARTS SUCH AS BERMUDA GRASS, QUACKGRASS, JOHNSONSON GRASS, NUTSEDGE, POISON IVY, THISTLE, OR OTHERS AS SPECIFIED.

- V. TOPSOIL APPLICATION: i. WHEN TOPSOILING, MAINTAIN NEEDED EROSION AND SEDIMENT CONTROL PRACTICES SUCH AS DIVERSIONS, GRADE STABILIZATION STRUCTURES, EARTH DIKES, SLOPE SILT FENCE AND SEDIMENT TRAPS AND BASINS. ii. GRADES ON THE AREAS TO BE TOPSOILED, WHICH HAVE BEEN PREVIOUSLY ESTABLISHED, SHALL BE MAINTAINED, ALBEIT 4" - 8" HIGHER IN ELEVATION.

TEMPORARY DUST CONTROL MEASURES

- 1. MULCHES - SEE STANDARDS FOR VEGETATIVE STABILIZATION WITH MULCHES ONLY. MULCH SHOULD BE CRIMPED OR TACKED TO PREVENT BLOWING. 2. VEGETATIVE COVER - SEE STANDARDS FOR TEMPORARY VEGETATIVE COVER. 3. TILLAGE - TO ROUGHEN SURFACE AND BRING CLODS TO THE SURFACE. THIS IS AN EMERGENCY MEASURE WHICH SHOULD BE USED BEFORE SOIL BLOWING STARTS.

SEQUENCE OF CONSTRUCTION

- 1. OBTAIN GRADING PERMIT 2. CONSTRUCT STABILIZED CONSTRUCTION ENTRANCES AT LOCATIONS SHOWN AND CONSTRUCT SILT FENCE IF REQUIRED BY SEDIMENT CONTROL INSPECTOR. (1 DAY) 3. COMPLETE CONSTRUCTION AS SHOWN. (270 DAYS / 9 MONTHS) 4. COMPLETE FINE GRADING OF SITE TO GRADES INDICATED. (1 DAY)

OWNERS/DEVELOPERS CERTIFICATION



I, WE HEREBY CERTIFY THAT ANY CLEARING, GRADING, CONSTRUCTION AND/OR DEVELOPMENT WILL BE DONE PURSUANT TO THIS PLAN AND THAT ANY RESPONSIBILITY FOR THE PROTECTION OF THE ENVIRONMENT WILL BE A CERTIFICATE OF ATTENDANCE AT A DEPARTMENT OF THE ENVIRONMENT APPROVED TRAINING PROGRAM FOR THE CONTROL OF SEDIMENTATION BEFORE BEGINNING OF THE PROJECT...

DESIGN CERTIFICATE


I CERTIFY THAT THIS PLAN FOR EROSION AND SEDIMENT CONTROL REPRESENTS A PRACTICAL AND WORKABLE PLAN BASED ON MY PERSONAL KNOWLEDGE OF THE SITE CONDITIONS AND THAT IT WAS PREPARED IN ACCORDANCE WITH THE REQUIREMENTS OF THE NATURAL RESOURCE CONSERVATION SERVICE.

THESE PLANS HAVE BEEN REVIEWED FOR THE HOWARD SOIL CONSERVATION DISTRICT AND MEETS TECHNICAL REQUIREMENTS.

Signature blocks for Allan Schuber, Stephanie Demchik, Jim Mann, and John Robertson, including dates and titles.

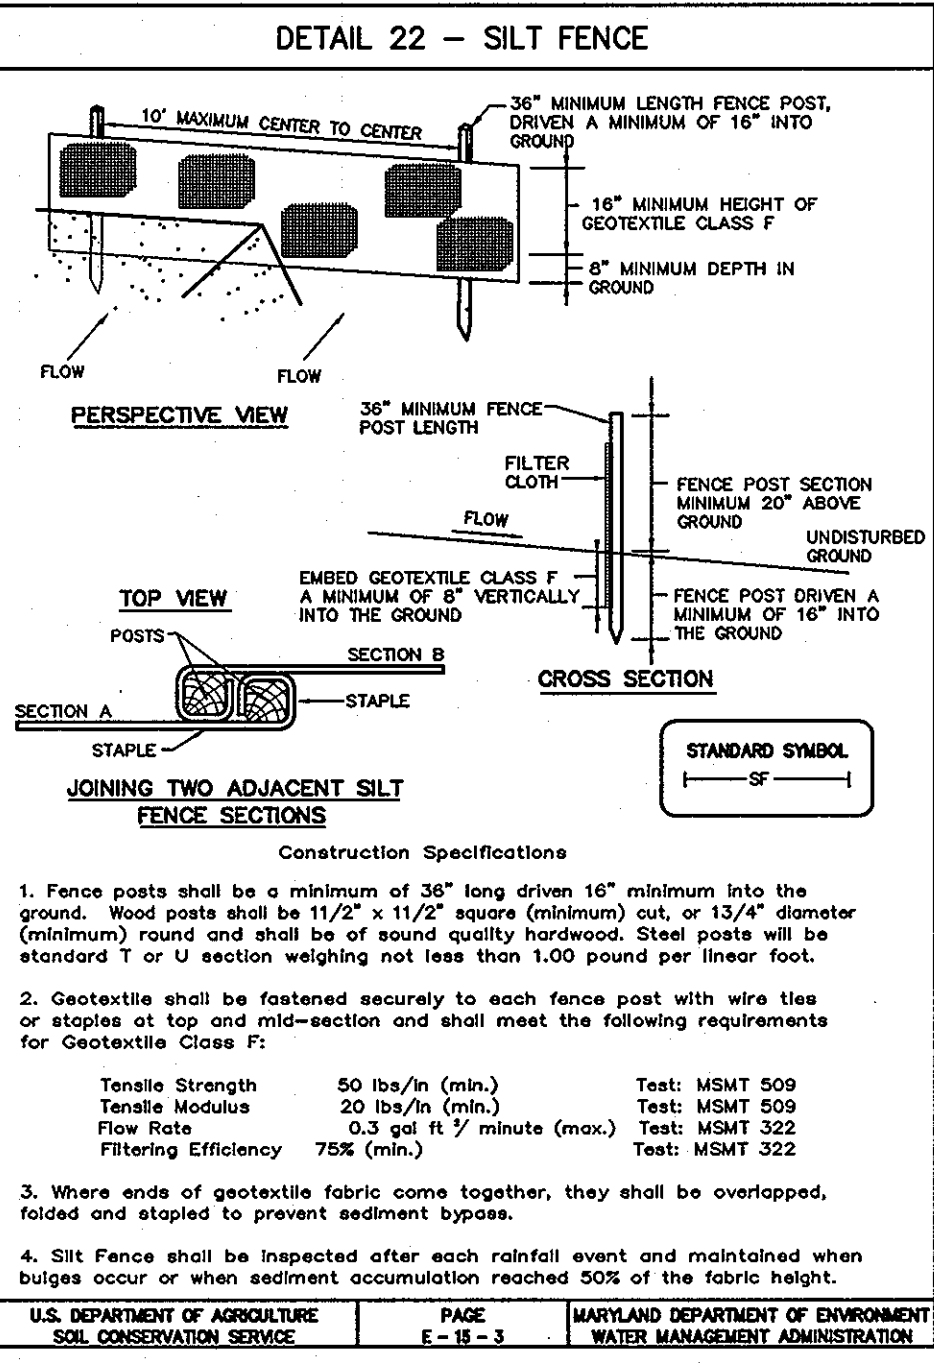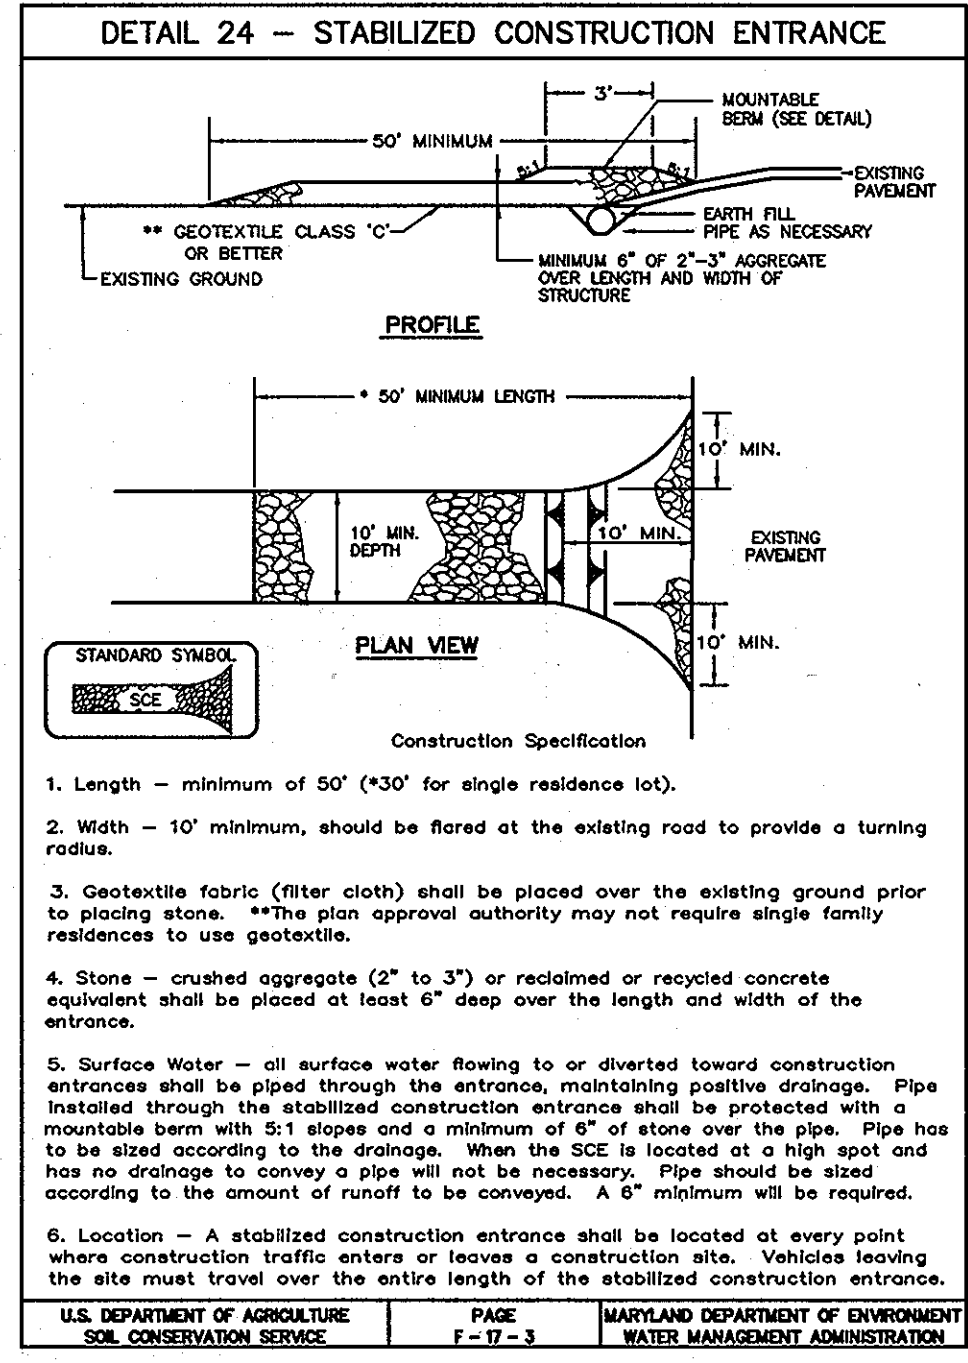

SILT FENCE Silt Fence Design Criteria table with columns for Slope Steepness, Slope Length, and Silt Fence Length. Includes a note on USDA general classification system.

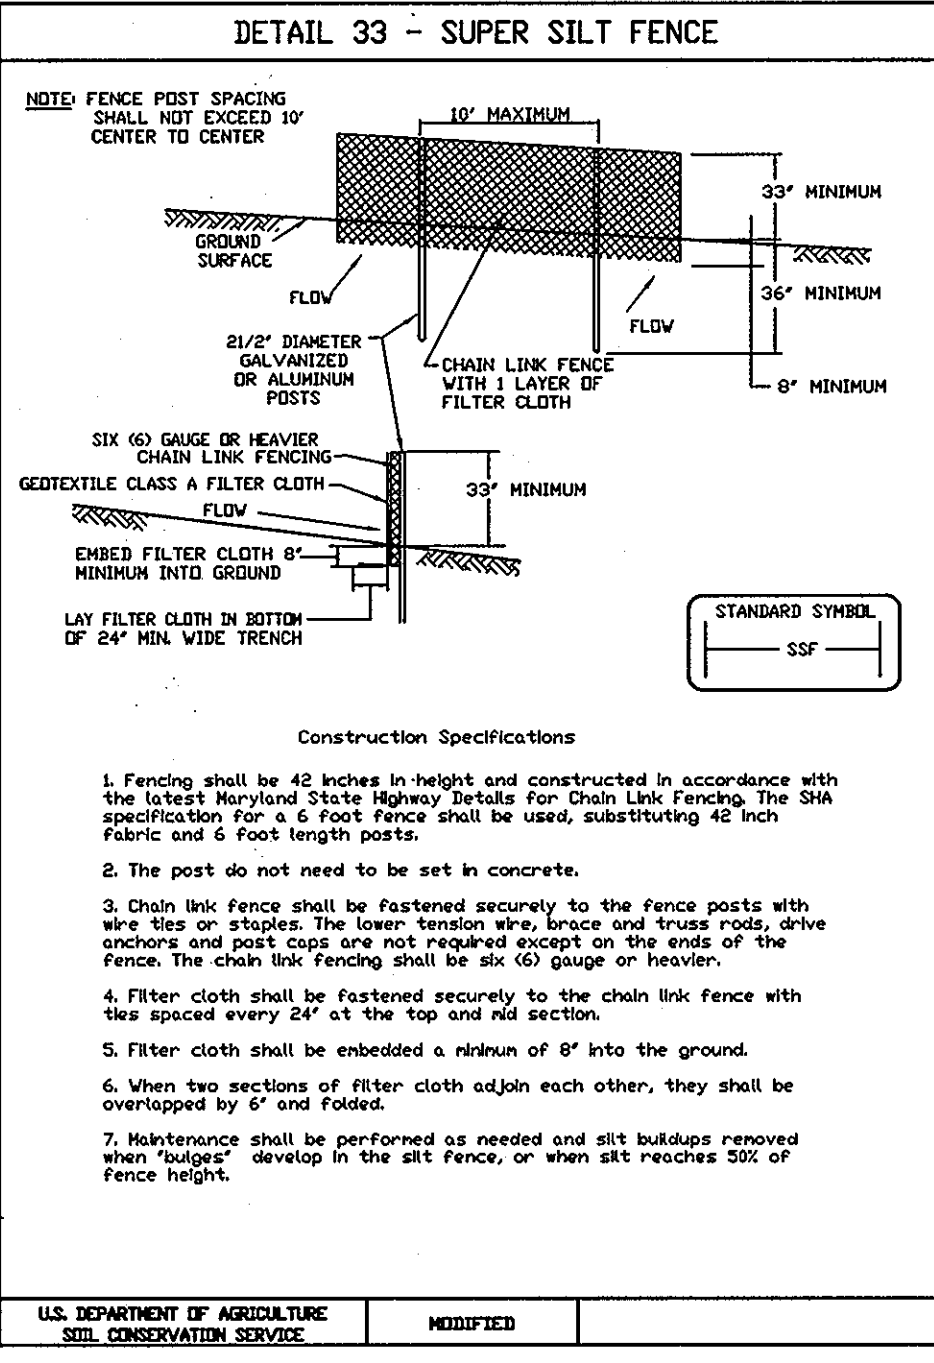

SUPER SILT FENCE Design Criteria table with columns for Slope Steepness, Slope Length, and Silt Fence Length. Includes construction specifications.



HARMS ENGINEERS & PLANNERS - SURVEYORS 41 EAST ALL SAINTS STREET, SUITE 210, FREDERICK, MARYLAND 21701

Table with columns for NO., REVISION, and DATE.

SEDIMENT CONTROL NOTES AND DETAILS JAMESTOWN LANDING, SECTION II, LOTS 35-37 & 53-64 TAX MAP: 46 - PARCEL: 229 & 352 HOWARD COUNTY, MARYLAND

DESIGNED BY: SJL DRAWN BY: SIN CHECKED BY: SJL DATE: JAN 2007 W.D. NO. 08-06-014A

DEVELOPER CRAFTMARK HOMES 6820 ELM STREET, SUITE 102 MCLEAN, VIRGINIA 22101 (703)-929-6940

HOWARD SOIL CONSERVATION DISTRICT

PERMANENT SEEDING NOTES

APPLY TO GRADED OR CLEARED AREAS NOT SUBJECT TO IMMEDIATE FURTHER DISTURBANCE WHERE A PERMANENT LONG-LIVED VEGETATIVE COVER IS NEEDED. SEEDBED PREPARATION: LOOSEN UPPER THREE INCHES OF SOIL BY RAKING, DISKING OR OTHER ACCEPTABLE MEANS BEFORE SEEDING, IF NOT PREVIOUSLY LOOSENED.

TEMPORARY SEEDING NOTES

APPLY TO GRADED OR CLEARED AREAS LIKELY TO BE REDISTURBED WHERE A SHORT-TERM VEGETATIVE COVER IS NEEDED. SEEDBED PREPARATION: LOOSEN UPPER THREE INCHES OF SOIL BY RAKING, DISKING OR OTHER ACCEPTABLE MEANS BEFORE SEEDING, FOR NOT PREVIOUSLY LOOSENED.

STANDARD SEDIMENT CONTROL NOTES

- 1) A MINIMUM OF 48 HOURS NOTICE MUST BE GIVEN TO THE HOWARD COUNTY DEPARTMENT OF INSPECTIONS, LICENSES AND PERMITS, SEDIMENT CONTROL DIVISION PRIOR TO THE START OF ANY CONSTRUCTION, (313-1855).

THESE QUANTITIES ARE FOR PERMIT PURPOSES ONLY. CONTRACTOR IS REQUIRED TO PROVIDE HIS OWN QUANTITY MEASUREMENTS.

- 8) ANY SEDIMENT CONTROL PRACTICE WHICH IS DISTURBED BY GRADING ACTIVITY FOR PLACEMENT OF UTILITIES MUST BE REPAIRED ON THE SAME DAY OF DISTURBANCE.

STANDARD AND SPECIFICATIONS FOR TOPSOIL

DEFINITION: PLACEMENT OF TOPSOIL OVER A PREPARED SUBSOIL PRIOR TO ESTABLISHMENT OF PERMANENT VEGETATION. PURPOSE: TO PROVIDE A SUITABLE SOIL MEDIUM FOR VEGETATIVE GROWTH. SOILS OF CONCERN HAVE LOW MOISTURE CONTENT, LOW NUTRIENT LEVELS, LOW PH, MATERIALS TOXIC TO PLANTS, AND/OR UNACCEPTABLE SOIL GRADATION.

CONDITIONS WHERE PRACTICE APPLIES: I. THIS PRACTICE IS LIMITED TO AREAS HAVING 2:1 OR FLATTER SLOPES WHERE: a. THE TEXTURE OF THE EXPOSED SUBSOIL/PARENT MATERIAL IS NOT ADEQUATE TO PRODUCE VEGETATIVE GROWTH.

CONSTRUCTION AND MATERIAL SPECIFICATIONS: I. TOPSOIL SALVAGED FROM THE EXISTING SITE MAY BE USED PROVIDED THAT IT MEETS THE STANDARDS AS SET FORTH IN THESE SPECIFICATIONS.



- V. TOPSOIL APPLICATION: I. WHEN TOPSOILING, MAINTAIN NEEDED EROSION AND SEDIMENT CONTROL PRACTICES SUCH AS DIVERSIONS, GRADE STABILIZATION STRUCTURES, EARTH DIKES, SLOPE SILT FENCE AND SEDIMENT TRAPS AND BASINS.

TEMPORARY DUST CONTROL MEASURES


- 1. MULCHES - SEE STANDARDS FOR VEGETATIVE STABILIZATION WITH MULCHES ONLY. MULCH SHOULD BE CRIMPED OR TACKED TO PREVENT BLOWING.

SEQUENCE OF CONSTRUCTION

- 1. OBTAIN GRADING PERMIT

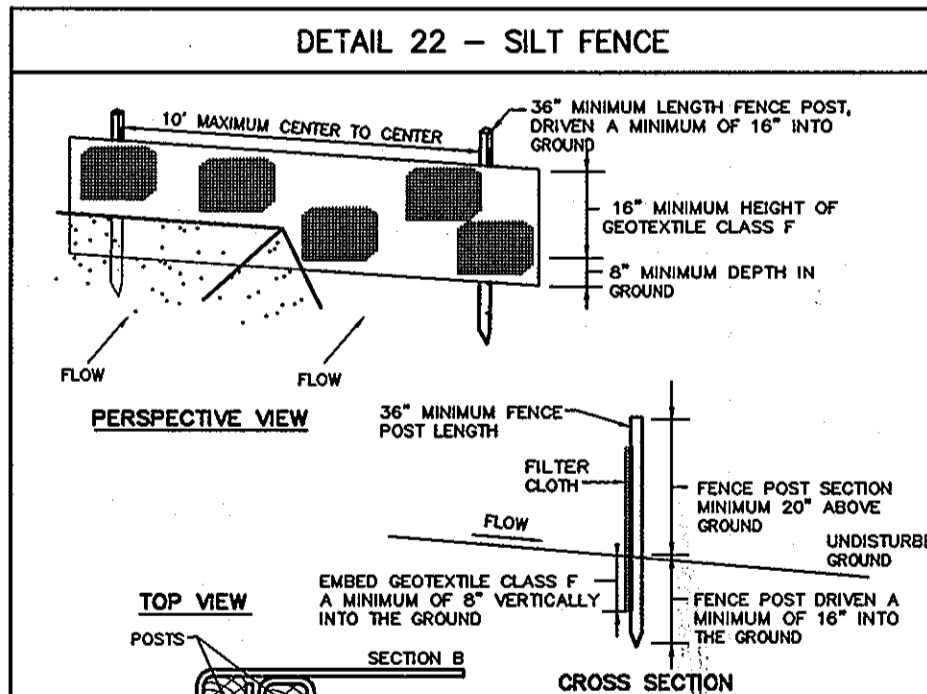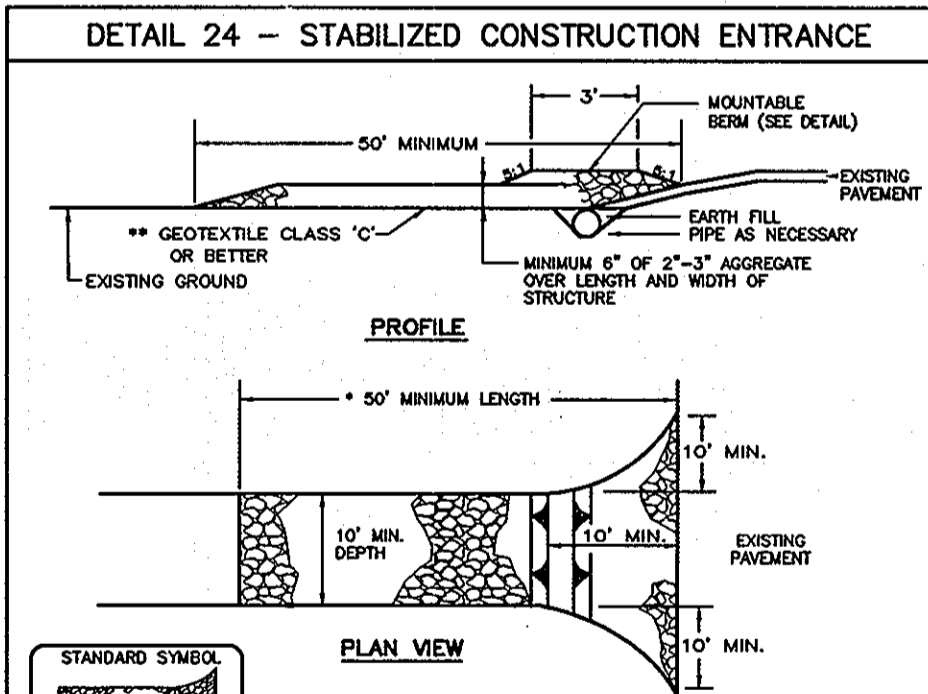

SILT FENCE Silt Fence Design Criteria table with columns for Slope Steepness, Slope Length, and Silt Fence Length.

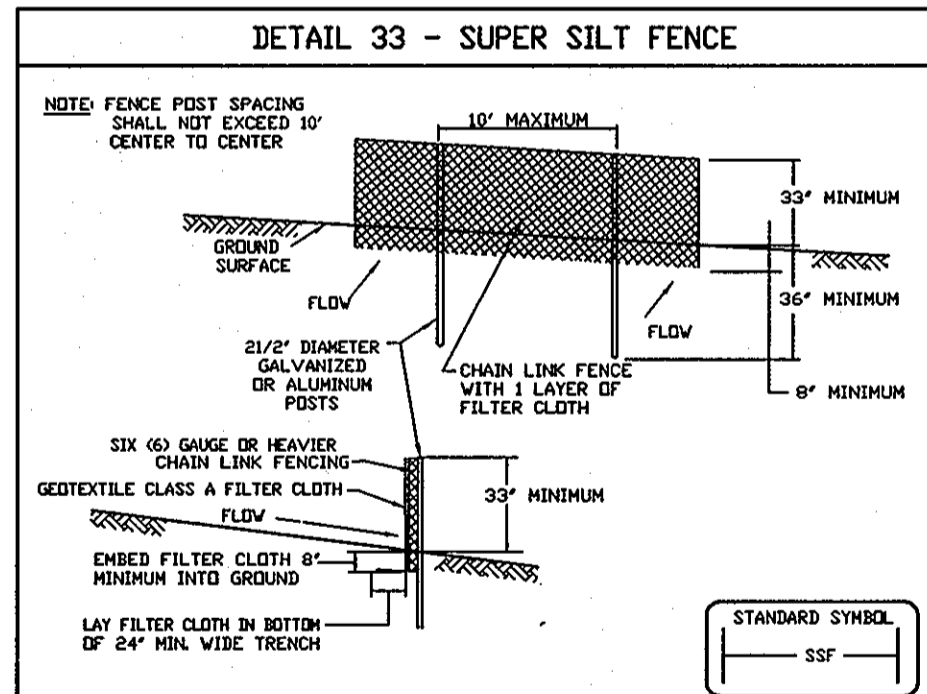

SUPER SILT FENCE Design Criteria table with columns for Slope Steepness, Slope Length, and Silt Fence Length.

OWNERS/DEVELOPERS CERTIFICATION: I/WE HEREBY CERTIFY THAT ANY CLEARING, GRADING, CONSTRUCTION AND/OR DEVELOPMENT WILL BE DONE PURSUANT TO THIS PLAN AND THAT ANY RESPONSIBLE PERSONNEL INVOLVED IN THE CONSTRUCTION PROJECT WILL HAVE A CERTIFICATE OF ATTENDANCE AT A DEPARTMENT OF THE ENVIRONMENT APPROVED TRAINING PROGRAM FOR THE CONTROL OF SEDIMENT AND EROSION BEFORE BEGINNING ANY OF THE PROJECTS DESCRIBED ON THIS SITE INSPECTION BY THE NATURAL RESOURCE CONSERVATION SERVICE.

DESIGN CERTIFICATE: I CERTIFY THAT THIS PLAN FOR EROSION AND SEDIMENT CONTROL REPRESENTS A PRACTICAL AND WORKABLE PLAN BASED ON MY PERSONAL KNOWLEDGE OF THE SITE CONDITIONS AND THAT IT WAS PREPARED IN ACCORDANCE WITH THE REQUIREMENTS OF THE NATURAL RESOURCE CONSERVATION SERVICE.

THESE PLANS HAVE BEEN REVIEWED FOR THE HOWARD SOIL CONSERVATION DISTRICT AND MEETS TECHNICAL REQUIREMENTS.

APPROVED DEPARTMENT OF PLANNING AND ZONING: [Signature]

APPROVED DEPARTMENT OF PLANNING AND ZONING: [Signature]

Construction Specifications: 1. Length - minimum of 50' (+30' for single residence lot).

Construction Specifications: 1. Fence posts shall be a minimum of 36" long driven 16" minimum into the ground.

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Construction Specifications: 1. Fencing shall be 42 inches in height and constructed in accordance with the latest Maryland State Highway Details for Chain Link Fencing.

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Vertical sidebar containing HARM'S logo, contact information for Engineers, Planners & Surveyors, and a table with columns for NO., REVISION, and DATE.

Vertical text on the far left edge of the page.