


ADDRESS CHART	
Lot	Street
1	7403 Jeans Way
2	7407 Jeans Way
3	7454 Jeans Way
Par. 1	4625 Ilchester Road

SHEET INDEX		
DESCRIPTION	SHEET No.	
Site Development & Landscape Plan	1 of 2	
Sediment and Erosion Control Plan and Details	2 of 2	

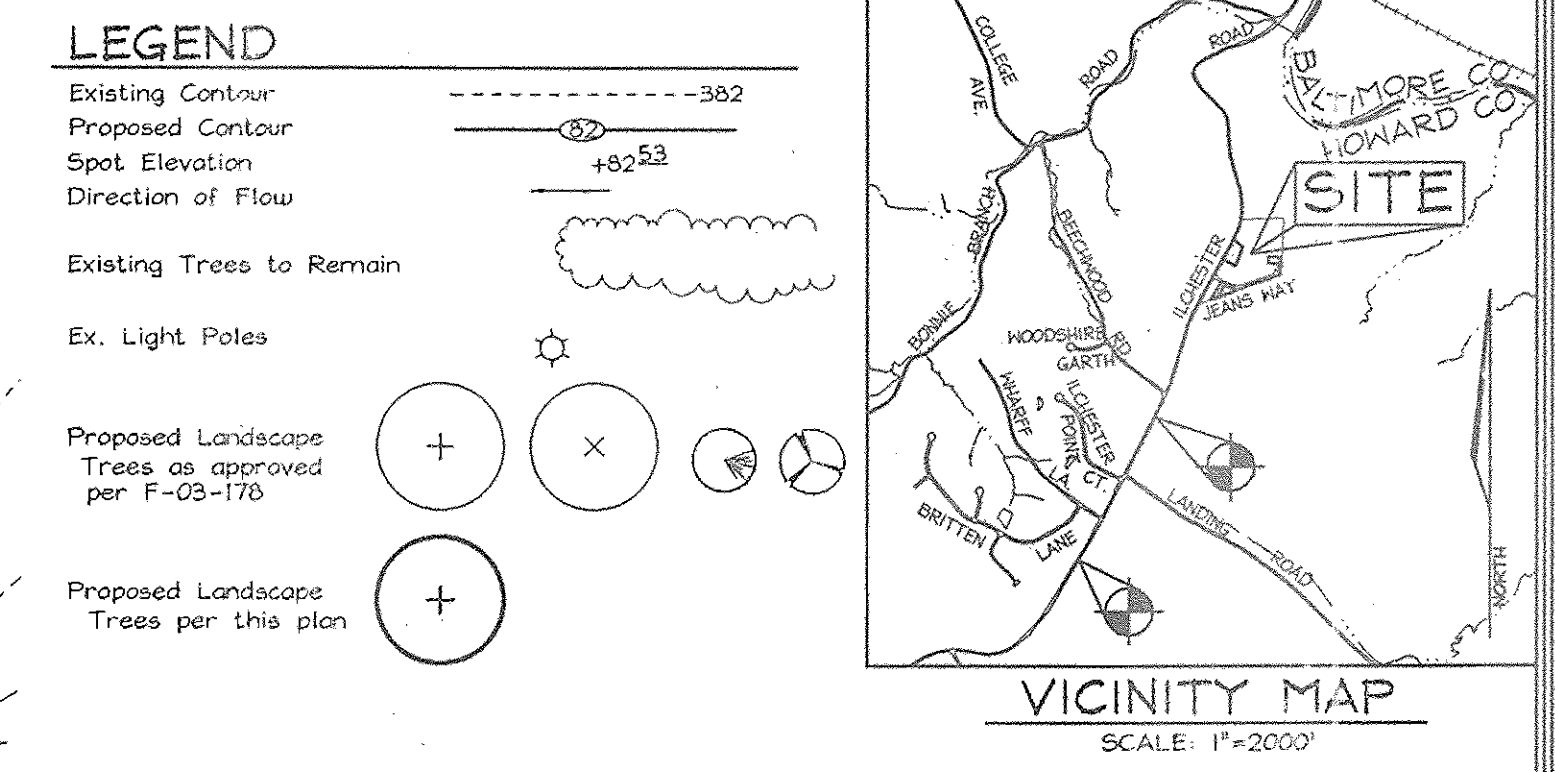


BENCHMARKS			
Sta.	N	E	Elevation (meters)
31E6	N 173,936.1454	E 419,619.1591	El. 147.1455 (meters)
	N 570,852.353	E 1,376,700.524	El. 482.760 (feet)
	5'-SW of edge of road 4' 500'-W of Wharf Lane		
31E7	N 174,468.165	E 419,864.0248	El. 145.8422 (meters)
	N 572,356.322	E 1,377,503.920	El. 478.448 (feet)
	9'-SE of edge of road 4' 250'-W of Beachwood Road		

**GENERAL NOTES**

- The subject property is zoned RE-D per the 02/02/04 Comprehensive Zoning Plan.
- Property is within the Metropolitan District.
- Public water and sewer will be used within this site.
- The Contractor shall notify the following utility companies or agencies at least five (5) working days before starting work shown on these plans:
  - Verizon: 1.800.743.0033/410.214.9210
  - AT&T: 1.800.252.1133
  - State Highway Administration: 410.531.5535
  - BGE (Contractor Services): 410.850.4620
  - BGE (Underground Damage Control): 410.787.9068
  - Miss Utility: 1.800.257.7777
  - Colonial Pipeline Company: 410.745.1340
  - Howard County, Dept. of Public Works, Bureau of Utilities: 410.313.4900
  - Howard County Health Department: 410.313.2640
- The contractor shall notify Miss Utility at 1-800-257-7777 at least 48 hours prior to any excavation work being done.
- The contractor shall notify the Department of Public Works/Bureau of Engineering Construction Inspection Division at (410) 313-1880 at least five (5) working days prior to the start of work.
- The lots shown hereon comply with the minimum ownership, width and lot area as required by the Maryland State Department of the Environment.
- Topography taken from Road Construction Plan F-03-17A.
- Contractor to confirm all dimension, utilities and topography in the field. If any conflicts arise, contact Engineer before beginning any work.
- Howard County Soil Map #20 and #21.
- There are no floodplains and wetlands on site, see F-03-17B.
- The project is in conformance with the latest Howard County Standards unless waivers have been approved.
- The coordinates shown hereon are based upon the Howard County Geodetic Control which is based on the Maryland State Plane Coordinate system. Howard County monument number 31E6 and 31E7 were used for this project.
- In accordance with section 128 of the Howard County Zoning Regulations, bay windows, chimneys, or exterior stairways not more than 16 feet in width may project not more than 4 feet into any setbacks. Porches, or decks, open or enclosed may project not more than 10 feet into the front or rear yard setback. BRL's shown taken from Howard County Zoning Regulation for the Zoning District.
- Driveway(s) shall be provided prior to issuance of a use and occupancy permit for any new dwelling to insure safe access for fire and emergency vehicles per the following (minimum) requirements:
  - Width-12 feet (14' serving more than one residence).
  - Surface-6 inches of compacted crusher run base with 1 1/2" Min. tar on chip coating.
  - Geometry-max. 15% grade, max. 10% grade change, and 45 foot turning radius.
  - Structures (bridges/culverts)-capable of supporting 25 gross tons (425-loading).
  - Drainage elements-capable of safely passing 100 year flood with no more than one foot depth over driveway surface.
  - Structure clearance-minimum 12 feet.
  - Maintenance-sufficient to insure all weather use.
- All Sewer House Connections to be a minimum of 2% and a maximum of 5%. If no slope is shown, 2.0% may be assumed.
- No clearing, grading or construction is permitted within wetland or stream system buffers unless approved by the Department of Planning and Zoning.
- This plan has been prepared in accordance with the Provisions of Section 16124 of the Howard County Code and Landscape Manual. Landscaping for Lots 1, 2, and 3 has been provided for under F-03-17B. Landscaping for Parcel 1 has been provided for under this plan. Financial surety for the required 8 shade trees in the amount of \$2400.00 is part of the builders grading permit application for Parcel 1.
- Forest Conservation for Lots 1, 2, and 3 complies with the requirements of Section 16120 of the Howard County Code for Forest Conservation and has been provided for under F-03-17B. Parcel 1 is exempt from forest conservation requirements because it is a lot less than 40,000 square feet (see section 16120(b)(1)(i) of the subdivision and land development regulations).
- Parcel 1 was not part of F-03-17B, however, it was included and accounted for in the stormwater management calculations prepared under F-03-17B.
- Parcel 1 is developed pursuant to the R-20 district regulations in accordance with Section 07.G.1.a.
- This SDP is in compliance with the Amended Fifth Edition of Howard County Subdivision and Land Development Regulations and the Zoning Regulations adopted 7/2/04.
- Property is subject to PB Code 357 regarding skid patches on Ilchester Hills, per section 107.5 of the Zoning Regulations for 5 single family detached residential lots and 12 single family attached residential lots and open spaces on 9.320 Acres of land, Approved on 1/23/02 subject to the following:
  - Providing fencing along the entry road and Landscape Perimeter 7.
  - Providing additional landscaping along the rear of the townhouse lots.
  - Minimizing the water surface on the future Stormwater Management Pond.

NO	REVISION	DATE
1	Rev. hse type & grd., Parcel 1 and Lot 2 to show existing conditions by Fisher Collins & Carter, Inc.	11-18-05
2	Hse. type rev., Lot 3 by F.C.C., Inc.	12-14-05
3	Rev. grd. lot 1 to show Ex. Cond. by FCC, Inc.	3-14-06
4	Rev. hse. & grd. lot 3 to show Ex. Cond.	11-16-06

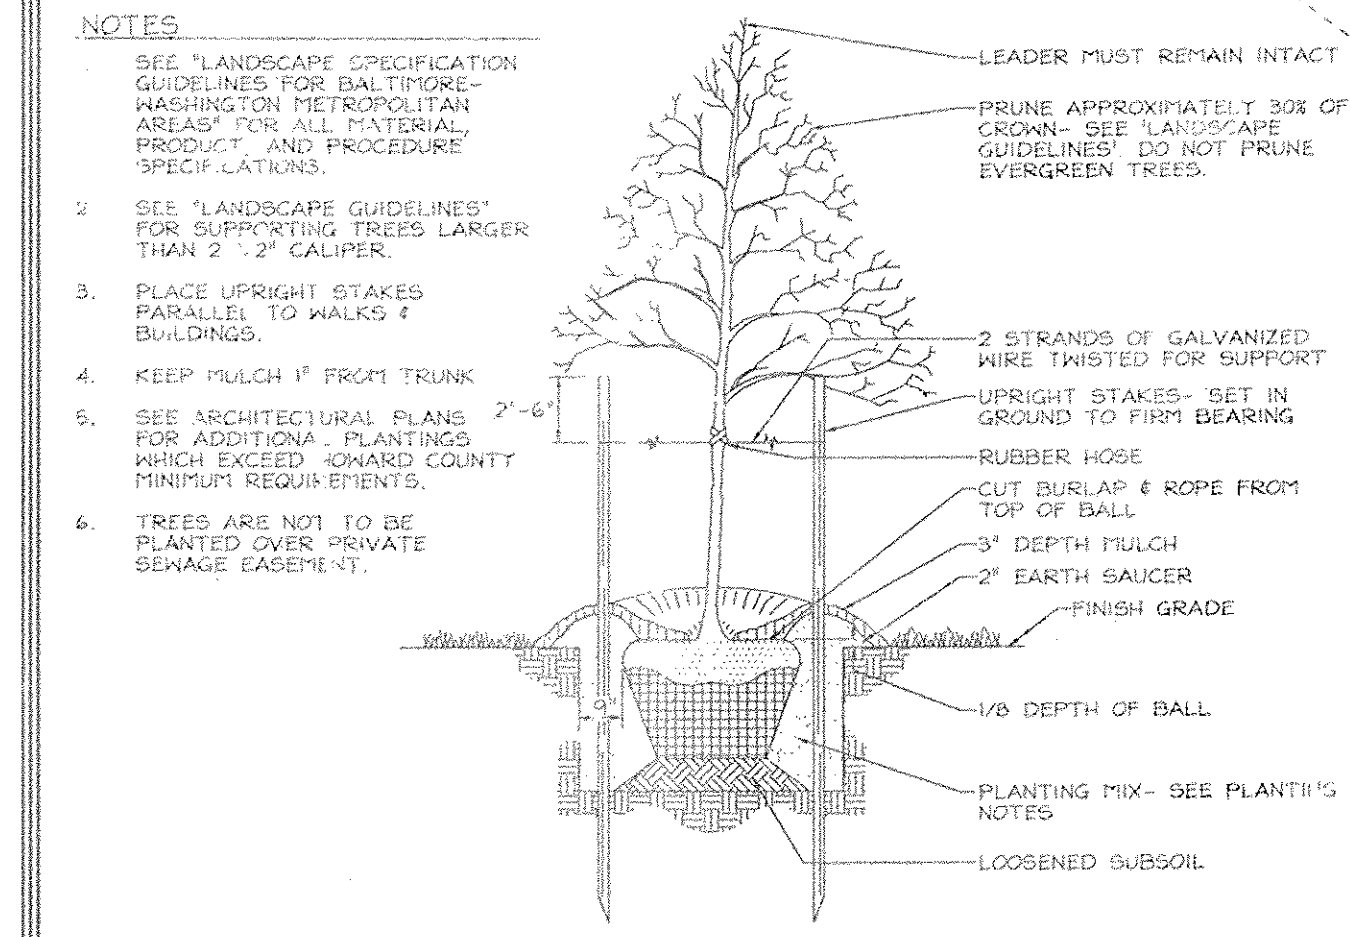

LANDSCAPE SCHEDULE				
KEY	QUAN.	BOTANICAL NAME	SIZE	NOTE
TC	4	Tilia cordata 'Greenspire' 'Greenspire Littleleaf Linden'	2 1/2'-3' Cal.	B & B
QR	4	Quercus rubra (Shade Trees) Red Oak	2 1/2'-3' Cal.	B & B

**NOTES:**

- At the time of installation, all shrubs and other plantings herewith listed and approved for this site, shall be of the proper height requirements in accordance with the Howard County Landscaping Manual. In addition, no substitutions or relocation of required plantings may be made without prior review and approval from the Department of Planning and Zoning. Any deviation from this approved Landscape Plan may result in denial or delay in the release of landscape surety until such time as all required materials are planted and/or revisions are made to applicable plans and certificates.
- Financial surety for the required 8 shade trees in the amount of \$2,400.00 is part of the builders grading permit application for Parcel 1.

SCHEDULE A PERIMETER LANDSCAPE EDGE				
CATEGORY	ADJACENT TO ROADWAYS	ADJACENT TO PERIMETER PROPERTIES		
		1	2	3
Perimeter/Frontage Description		A	A	A
Landscape Type		1	2	3
Linear Feet of Roadway		111	213	42
Credit for Existing Vegetation (Yes, No, Linear Feet)		No	No	No
Remaining Perimeter Length		No	No	No
Credit for Wall, Fence or Berm (Yes, No, Linear Feet)		No	No	No
Remaining Perimeter Length		No	No	No
Number of Plants Required		160	160	160
Shade Trees		-	-	-
Evergreen Trees		-	-	-
Number of Plants Provided		2*	4	2
Shade Trees		-	-	-
Evergreen Trees		-	-	-
Other Trees (2:1 Substitution)		-	-	-
Shrubs (10:1 Substitution)		-	-	-
(Describe Plant Substitution Credits Below if needed)		-	-	-

\* Perimeter 1 trees have been moved to Perimeter 2 since the proposed waterhouse connection and existing 20' Public Drainage and Utility Easement prohibit the planting of trees along this perimeter.

SITE ANALYSIS DATA CHART	
a. Total project area: 1.75 Acres	
b. Limit of disturbance: 0.52 ac	
c. Subject property zoned R-ED per 02/02/04 Comprehensive Zoning Plan.	
d. Proposed uses for site & structures: single family detached	
e. Floor space on each level of building(s) per use: See house templates this sheet	
f. Total number of units allowed: 4	
g. Total number of units proposed: 4	
h. Proposed building coverage of site: 0.18 acres; 13.5% of gross lot area	
i. Howard County file references: S-01-13; S-P-02-12; P-03-04; F-03-17B; Contr. #14-4095-D; Contr. #14-4096-D; Plat #16618-16620	
j. Parcel 1 is not part of F-03-17B.	

**DEVELOPER'S BUILDER'S CERTIFICATE**

I/WE CERTIFY THAT THE LANDSCAPING SHOWN ON THIS PLAN WILL BE DONE ACCORDING TO THE PLAN, SECTION 16124 OF THE HOWARD COUNTY CODE AND THE HOWARD COUNTY LANDSCAPE MANUAL. I/WE FURTHER CERTIFY THAT UPON COMPLETION, A LETTER OF LANDSCAPE INSTALLATION, ACCOMPANIED BY AN EXECUTED ONE (1) YEAR GUARANTEE OF PLANT MATERIALS, WILL BE SUBMITTED TO THE DEPARTMENT OF PLANNING AND ZONING.

*Stephen F. Foney* 6-8-04  
SIGNATURE OF DEVELOPER DATE

PERMIT INFORMATION CHART					
Subdivision Name:	ILCHESTER HILLS	Section/Area:	N/A	Parcel No.:	1
Plat #:	14618-16620	Grid:	5	Zoning:	R-ED
Water Code:	G-04	Tax Map No.:	31	Elect. District:	1st
		Census Tract:	6011		
		Sewer Code:	1251659		

**SITE DEVELOPMENT & LANDSCAPE PLAN**

**ILCHESTER HILLS**

LOTS 1, 2, 3 AND PARCEL 1

SINGLE FAMILY DETACHED DWELLINGS

TAX MAP 31 GRID 5  
1ST ELECTION DISTRICT

PARCEL 419  
HOWARD COUNTY, MARYLAND








**FSH Associates**  
Engineers Planners Surveyors

8318 Fox at Streets  
14107 City, MD 21043  
Tel: 410-750-2255  
Fax: 410-750-7350  
Email: FSH@fsassociates.com

DESIGN BY: PS  
DRAWN BY: KSD  
CHECKED BY: JTF  
SCALE: 1"=30'  
DATE: Jun 28, 2004  
P.L.O. No.: 3185  
SHEET No. 1 of 2

STATE OF MARYLAND  
PROFESSIONAL ENGINEER  
22418



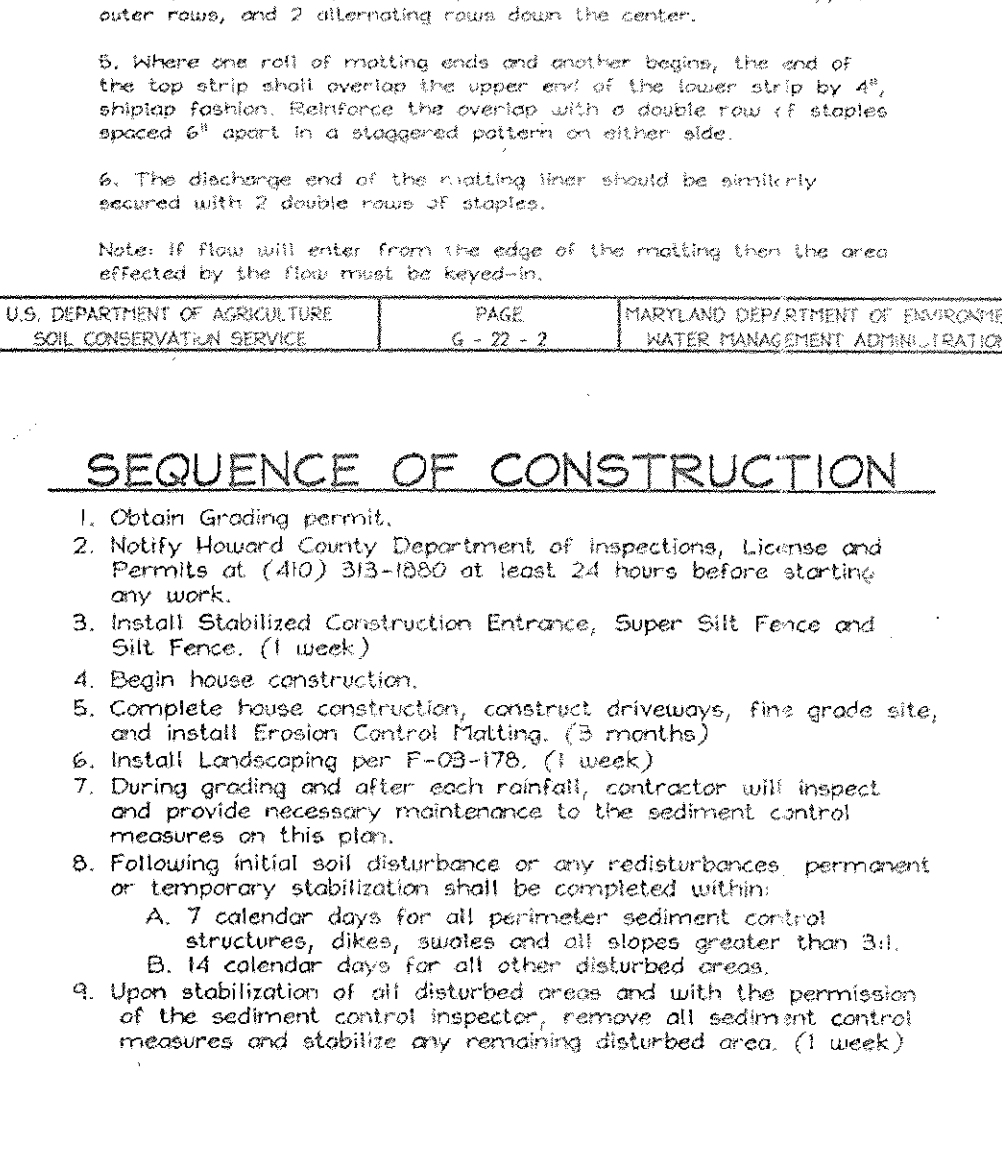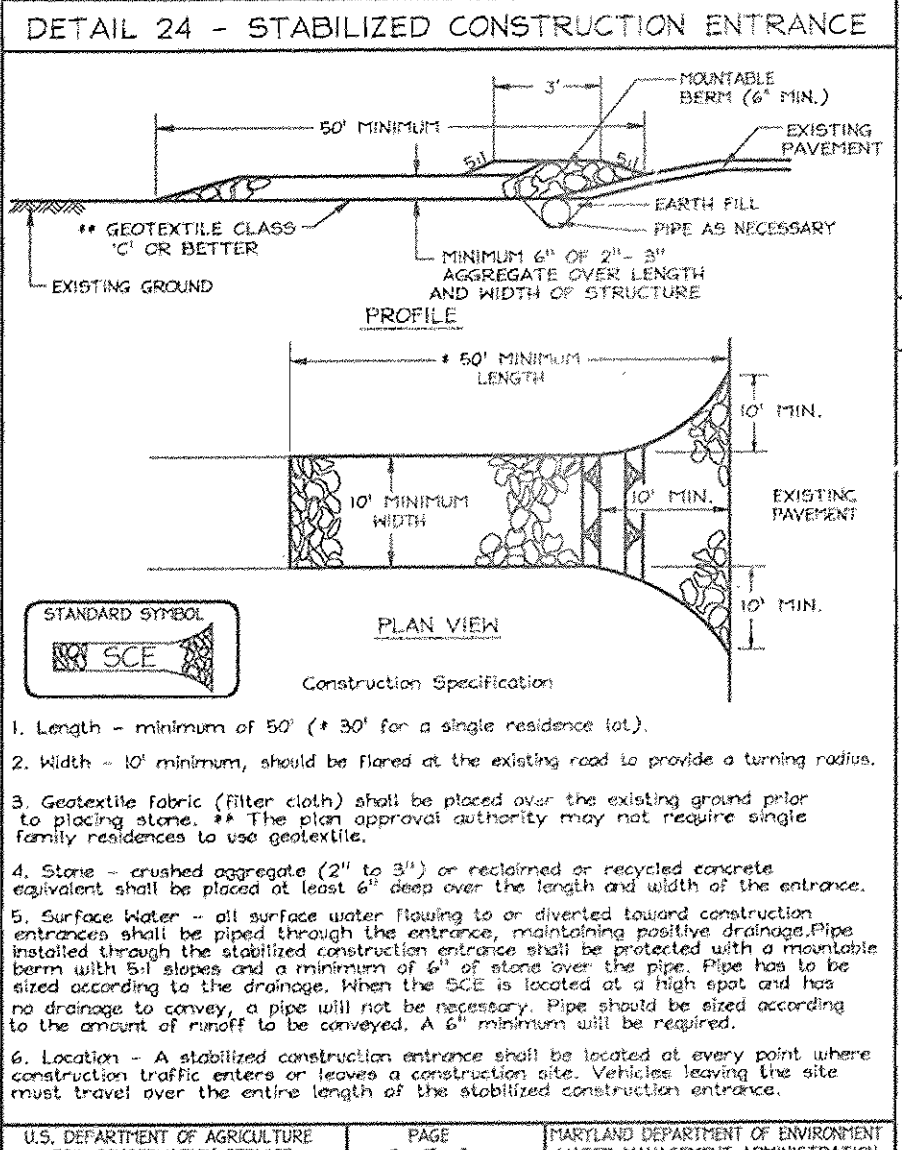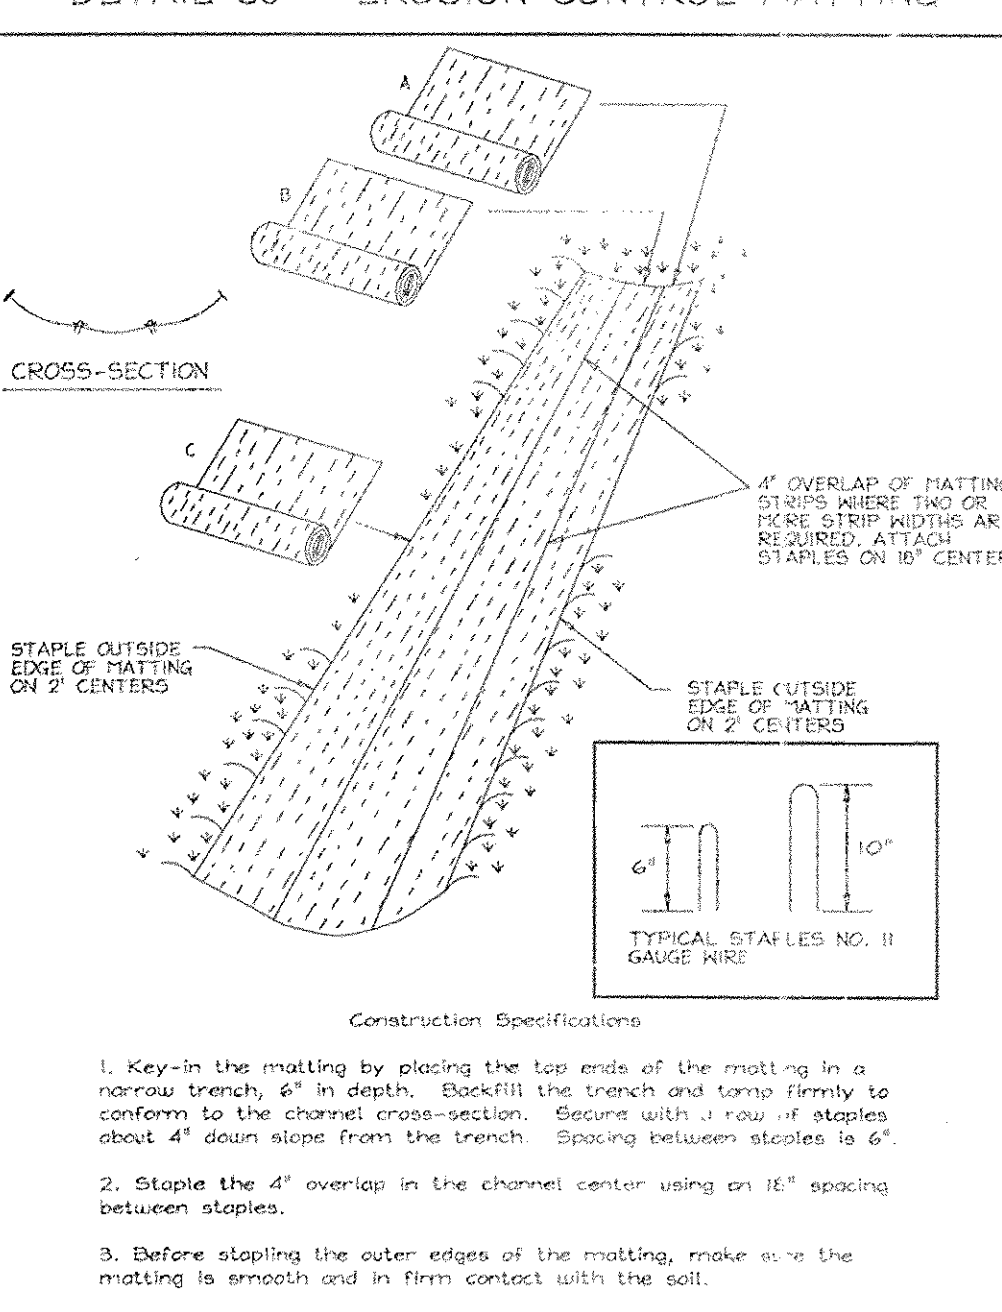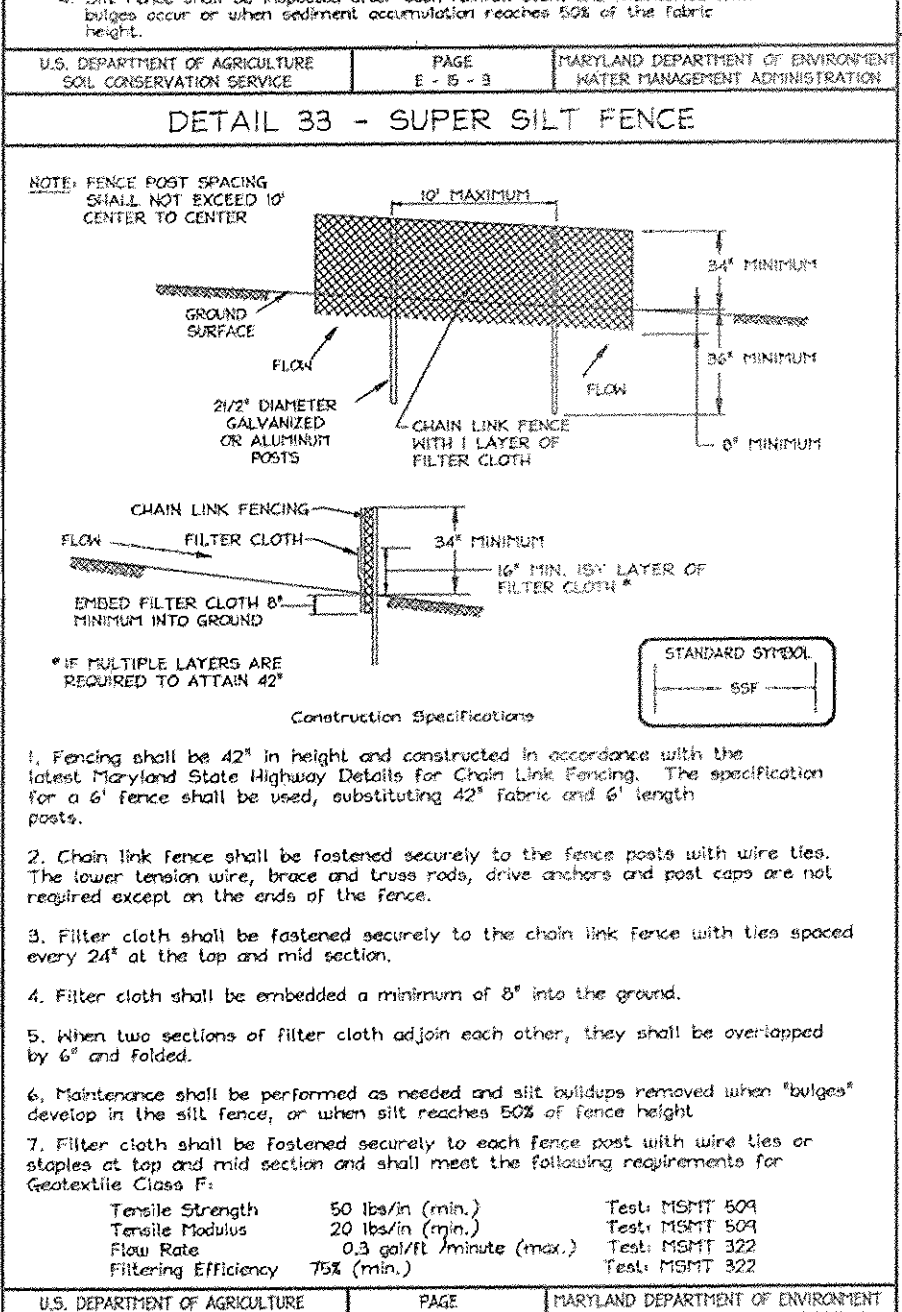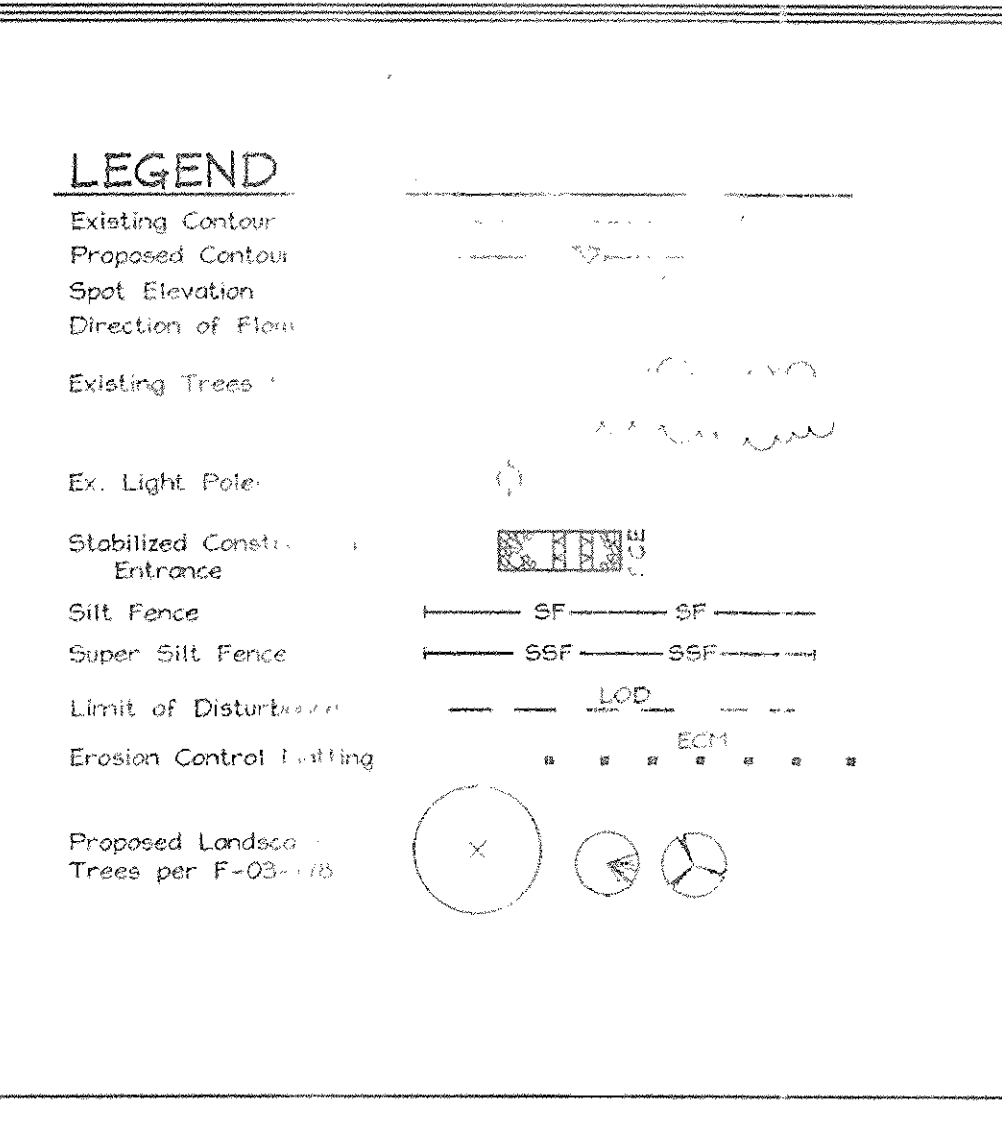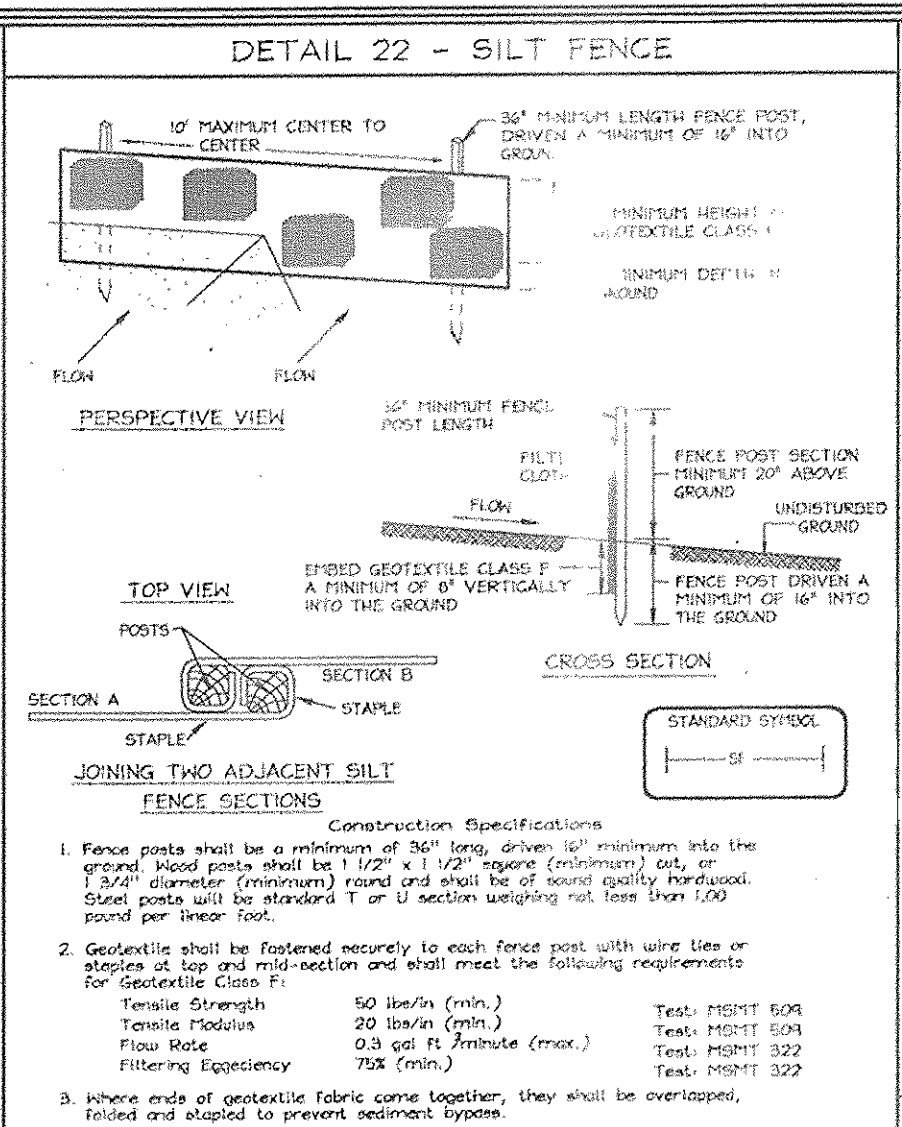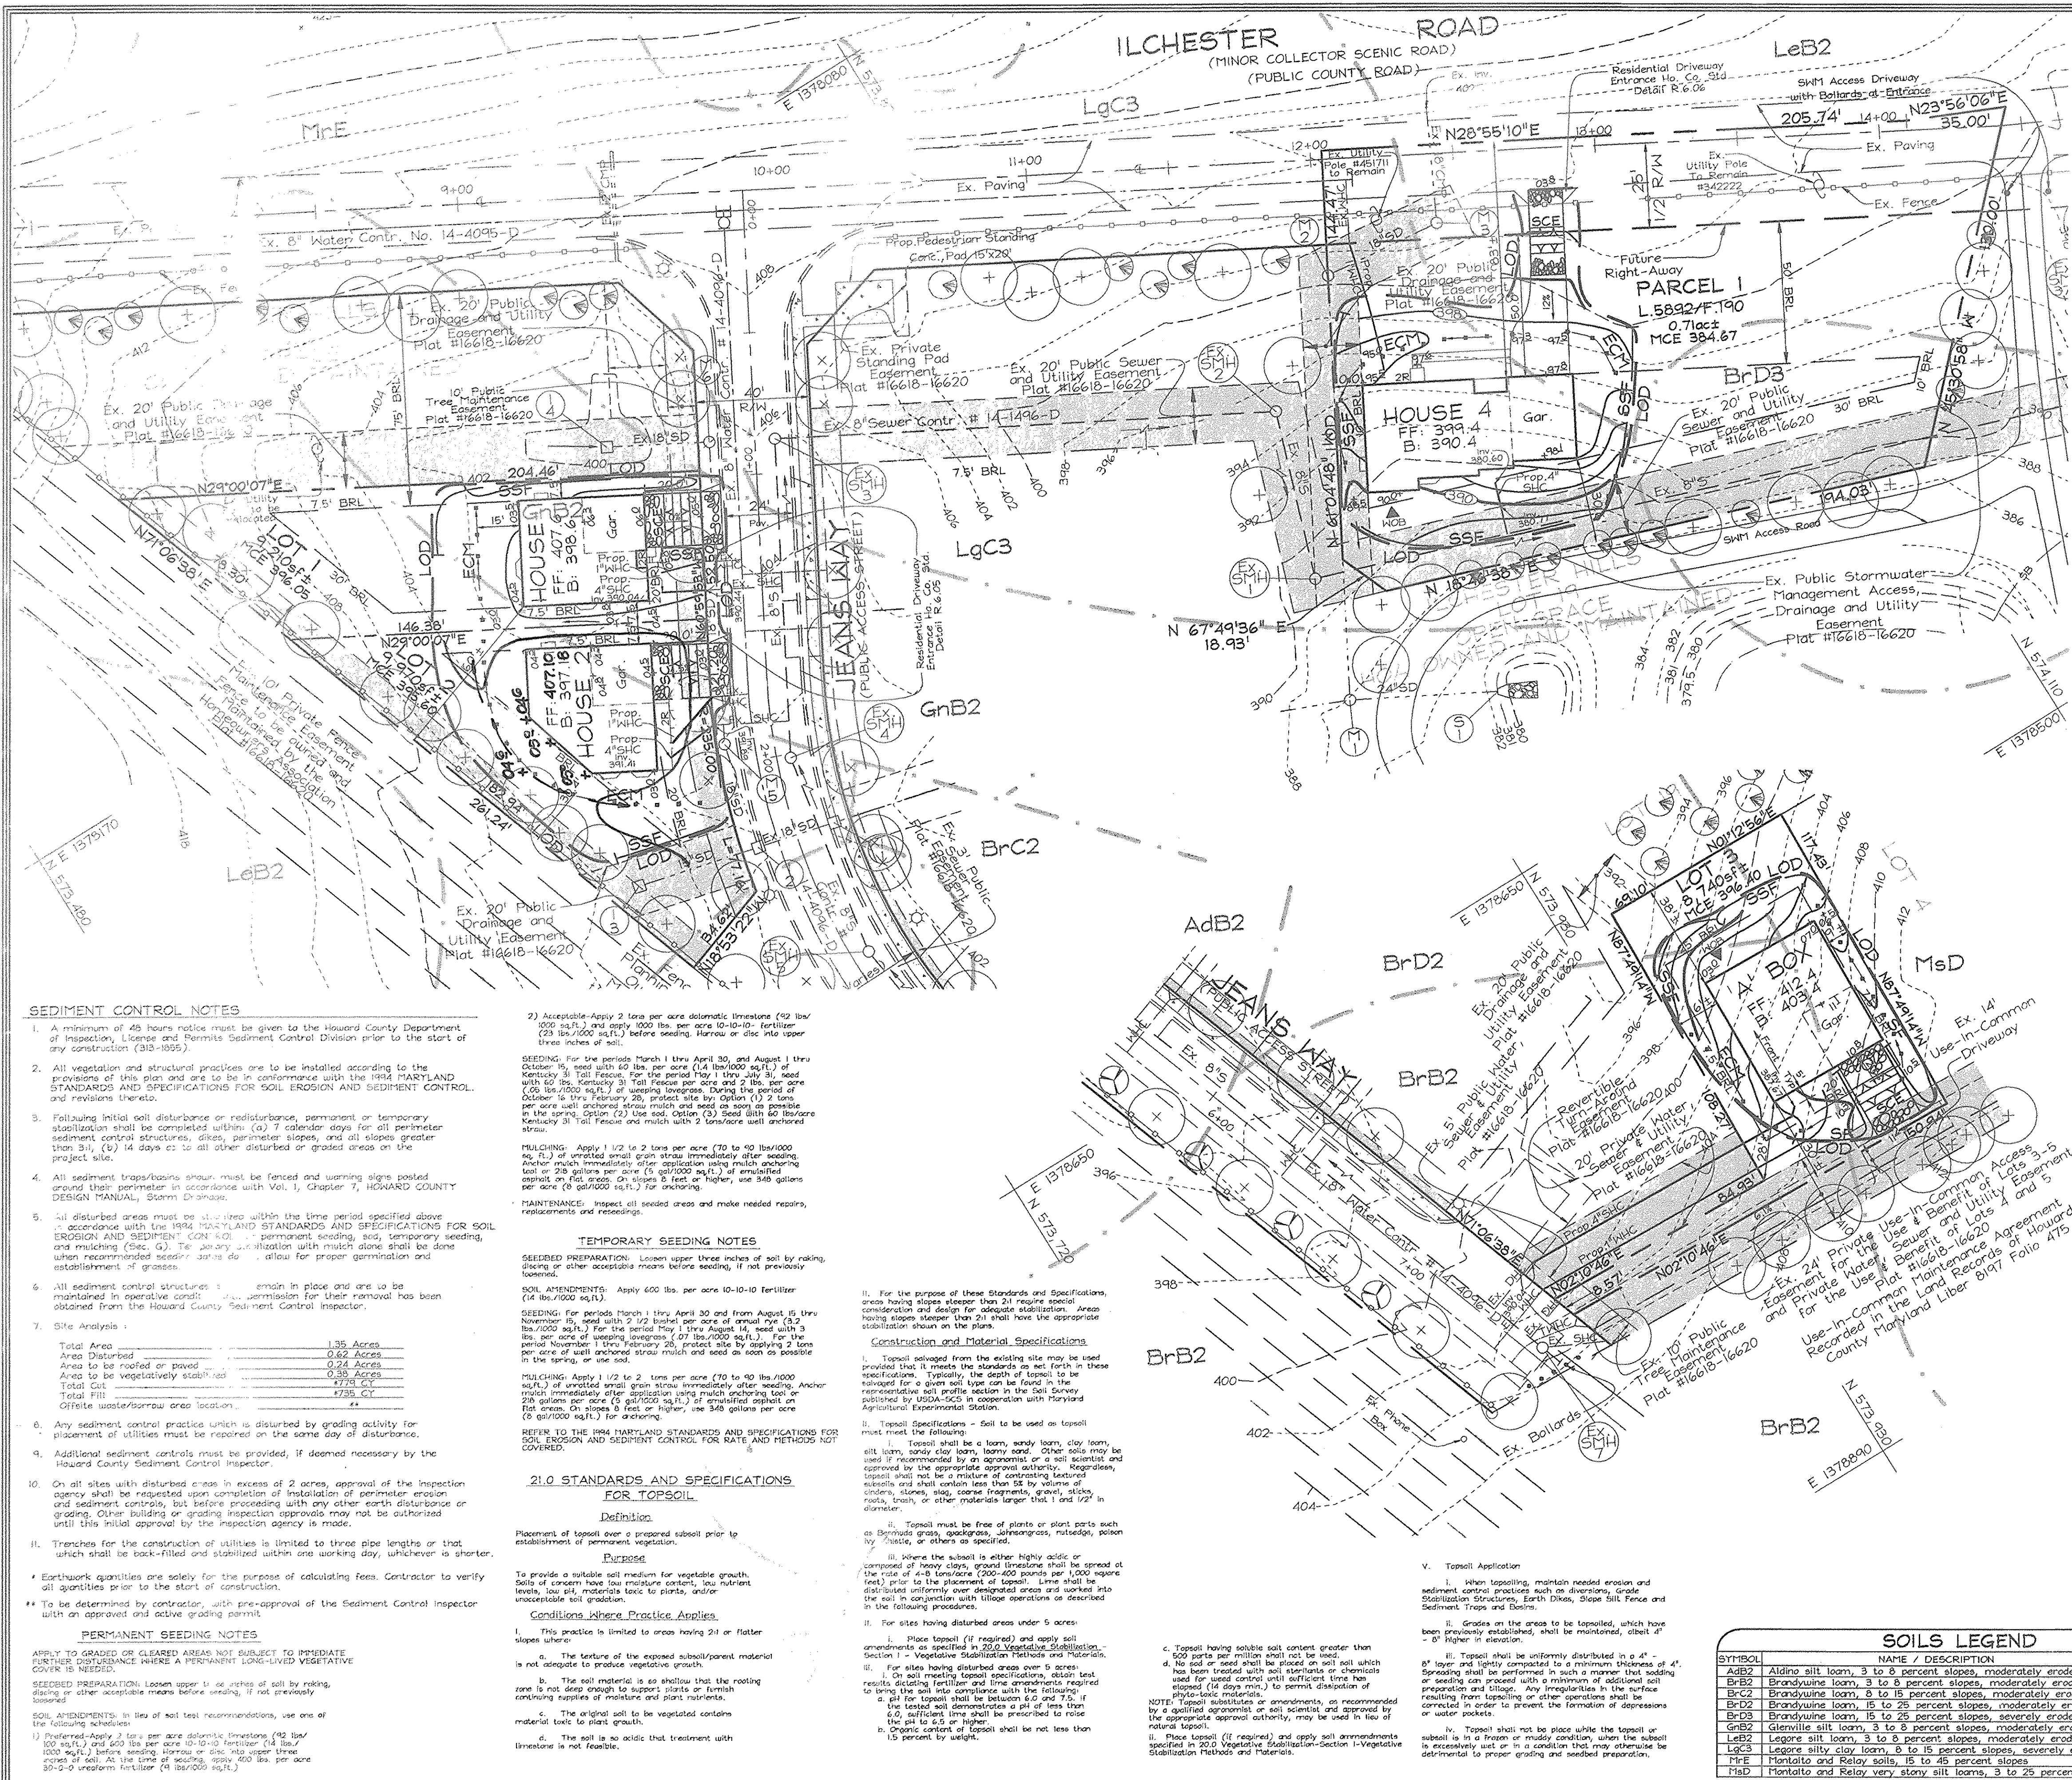

### SEDIMENT CONTROL NOTES

- A minimum of 48 hours notice must be given to the Howard County Department of Inspections, License and Permits Sediment Control Division prior to the start of any construction (913-1055).
- All vegetation and structural practices are to be installed according to the provisions of this plan and are to be in conformance with the 1974 MARYLAND STANDARDS AND SPECIFICATIONS FOR SOIL EROSION AND SEDIMENT CONTROL, and revisions thereto.
- Following initial soil disturbance or redistribution, permanent or temporary stabilization shall be completed within: (a) 7 calendar days for all perimeter sediment control structures, dikes, perimeter slopes, and all slopes greater than 3:1; (b) 14 days for all other disturbed or graded areas on the project site.
- All sediment traps/basins shall be fenced and warning signs posted around their perimeter in accordance with Vol. 1, Chapter 7, HOWARD COUNTY DESIGN MANUAL, Storm Drainage.
- All disturbed areas must be stabilized within the time period specified above or according to the 1974 MARYLAND STANDARDS AND SPECIFICATIONS FOR SOIL EROSION AND SEDIMENT CONTROL, permanent seeding, and temporary seeding, and mulching (Chap. 6). The seeding and mulching with mulch alone shall be done when recommended seeding rates do not allow for proper germination and establishment of grasses.
- All sediment control structures remain in place and are to be maintained in operative condition. No permission for their removal has been obtained from the Howard County Sediment Control Inspector.
- Site Analysis:
 

Total Area	1.35 Acres
Area Disturbed	0.82 Acres
Area to be roofed or paved	0.24 Acres
Area to be vegetatively stabilized	0.38 Acres
Total Call	1.73 ACRES
Total Fill	1738 CY
Offsite stormwater area location	
- Any sediment control practice which is disturbed by grading activity for placement of utilities must be repaired on the same day of disturbance.
- Additional sediment controls must be provided, if deemed necessary by the Howard County Sediment Control Inspector.
- On all sites with disturbed areas in excess of 2 acres, approval of the inspection agency shall be requested upon completion of installation of perimeter erosion and sediment controls, but before proceeding with any other earth disturbance or grading. Other building or grading inspection approvals may not be authorized until this initial approval by the inspection agency is made.
- Trenches for the construction of utilities is limited to three pipe lengths or that which shall be back-filled and stabilized within one working day, whichever is shorter.
- Earthwork quantities are solely for the purpose of calculating fees. Contractor to verify all quantities prior to the start of construction.
- To be determined by contractor, with pre-approval of the Sediment Control Inspector with an approved and active grading permit.

### PERMANENT SEEDING NOTES

APPLY TO GRADED OR CLEARED AREAS NOT SUBJECT TO IMMEDIATE FURTHER DISTURBANCE WHERE A PERMANENT LONG-LIVED VEGETATIVE COVER IS NEEDED.

SEEDING PREPARATION: Loosen upper three inches of soil by raking, disking or other acceptable means before seeding, if not previously loosened.

The soil material is to be as shallow as the rooting zone is not deep enough to support plants or furnish continuing supplies of moisture and plant nutrients.

The original soil to be vegetated contains material toxic to plant growth.

The soil is so acidic that treatment with lime is not feasible.

### TEMPORARY SEEDING NOTES

SEEDING PREPARATION: Loosen upper three inches of soil by raking, disking or other acceptable means before seeding, if not previously loosened.

SOIL AMENDMENTS: Apply 600 lbs. per acre 10-10-10 FERTILIZER (14 lbs./1000 sq.ft.).

SEEDING: For periods March 1 thru April 30 and August 1 thru October 31, seed with 60 lbs. per acre (1.4 lbs./1000 sq.ft.) of Kentucky 31 Tall Fescue. For the period May 1 thru July 31, seed with 60 lbs. Kentucky 31 Tall Fescue per acre and 20 lbs. per acre (0.5 lbs./1000 sq.ft.) of waning legume. During the period of October 1 thru February 29, plant site by Option (1) 2 tons per acre well anchored straw mulch and seed as soon as possible in the spring. Option (2) Use soil, Option (3) Seed with 60 lb/acre Kentucky 31 Tall Fescue and mulch with 2 tons/acre well anchored straw.

MULCHING: Apply 1/2 to 2 tons per acre (70 to 140 lbs./1000 sq. ft.) of untreated straw straw immediately after seeding. Anchor mulch immediately after application using mulch anchoring tool or 20 gallons per acre (2 gal/1000 sq.ft.) of emulsified asphalt on flat areas. On slopes 8 feet or higher, use 348 gallons per acre (0.348 gal/1000 sq.ft.) for anchoring.

MAINTENANCE: Inspect all seeded areas and make needed repairs, restorations and reseedings.

### CONSTRUCTION AND MATERIAL SPECIFICATIONS

Soil to be used on topsoil must meet the following:

- Topsoil shall be a loam, sandy loam, clay loam, silty loam, sandy clay loam, loamy sand. Other soils may be used if recommended by an agronomist or a soil scientist and approved by the appropriate approval authority. Negatives, topsoil shall not be a mixture of contrasting textured materials and shall contain less than 5% by volume of cinders, stones, slag, coarse fragments, gravel, silt, rocks, trash, or other materials larger than 1 and 1/2" in diameter.
- Topsoil must be free of plants or plant parts such as Bermuda grass, quackgrass, wiregrass, nutgrass, or other weeds, or other materials as specified.
- Where the subsoil is either highly acidic or composed of heavy clay, ground limestone shall be spread at the rate of 4-8 tons/acre (200-400 pounds per 1,000 square feet) prior to the placement of topsoil. Lime shall be distributed uniformly over designated areas and worked into the soil in conjunction with tillage operations as described in the following procedures.
- For sites having disturbed areas over 5 acres:
  - Place topsoil (if required) and apply soil amendments as specified in Section 1-Vegetative Stabilization Methods and Materials.
  - For sites having disturbed areas over 5 acres:
    - On soil meeting topsoil specifications, disperse test results, disking fertilizer and lime amendments required to bring the soil into compliance with following:
      - pH for topsoil shall be between 6.0 and 7.0.
      - If the tested soil demonstrates a pH of less than 6.0, sufficient lime shall be prescribed to raise the pH to 6.0 or higher.
      - Organic content of topsoil shall be not less than 1% percent by weight.
- Topsoil having suitable soil content greater than 500 parts per million shall not be used.
- Soil not meeting topsoil specifications, either test results disqualifying fertilizer and lime amendments required to bring the soil into compliance with following:
  - pH for topsoil shall be between 6.0 and 7.0.
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NOTE: Topsoil substitutions or amendments, as recommended by a qualified agronomist or soil scientist and approved by the appropriate approval authority, may be used in lieu of natural topsoil.

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### SOILS LEGEND

SYMBOL	NAME / DESCRIPTION	SOIL GROUP
AD2	Aldo silt loam, 3 to 8 percent slopes, moderately eroded	D
BR2	Brandywine loam, 3 to 8 percent slopes, moderately eroded	C
BR2	Brandywine loam, 8 to 15 percent slopes, moderately eroded	C
BR2	Brandywine loam, 15 to 25 percent slopes, moderately eroded	C
BR2	Brandywine loam, 15 to 25 percent slopes, severely eroded	C
GR2	Glennville silt loam, 3 to 8 percent slopes, moderately eroded	C
LE2	Legare silt loam, 3 to 8 percent slopes, moderately eroded	C
LE2	Legare silt loam, 8 to 15 percent slopes, severely eroded	C
MPE	Mantle and Relay silty, 15 to 45 percent slopes	B
RD	Relay and Relay very stony silt loams, 3 to 25 percent slopes	B

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- Topsoil must be free of plants or plant parts such as Bermuda grass, quackgrass, wiregrass, nutgrass, or other weeds, or other materials as specified.
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APPROVED: HOWARD COUNTY DEPARTMENT OF PLANNING AND ZONING

6/17/04  
 DATE  
 CHIEF, DEVELOPMENT ENGINEERING DIVISION  
 6/25/04  
 DATE  
 CHIEF, DIVISION OF LAND DEVELOPMENT  
 6/25/04  
 DATE  
 DIRECTOR OF ACTIVITIES

REVIEWED FOR HOWARD SCD AND MEETS TECHNICAL REQUIREMENTS

6/17/04  
 DATE  
 USA-NATURAL RESOURCES  
 6/17/04  
 DATE  
 JOHN R. ROBERTSON  
 6/17/04  
 DATE  
 HOWARD SCD

ENGINEERS CERTIFICATE

"I CERTIFY THAT THIS PLAN FOR SEDIMENT AND EROSION CONTROL REPRESENTS A PRACTICAL AND WORKABLE PLAN BASED ON MY PERSONAL KNOWLEDGE OF THE SITE CONDITIONS AND THAT IT WAS PREPARED IN ACCORDANCE WITH THE REQUIREMENTS OF THE HOWARD SOIL CONSERVATION DISTRICT."

6-8-04  
 DATE  
 ZACHARIA Y. FISCH  
 SIGNATURE OF ENGINEER  
 ZACHARIA Y. FISCH

DEVELOPER'S CERTIFICATE

"I CERTIFY THAT ALL DEVELOPMENT AND CONSTRUCTION WILL BE DONE ACCORDING TO THIS PLAN FOR SEDIMENT AND EROSION CONTROL AND THAT ALL RESPONSIBLE PERSONNEL INVOLVED IN THE CONSTRUCTION PROJECT WILL HAVE A CERTIFICATE OF ATTENDANCE AT A DEPARTMENT OF THE ENVIRONMENT APPROVED TRAINING PROGRAM FOR THE CONTROL OF SEDIMENT AND EROSION BEFORE BEGINNING THE PROJECT. I ALSO AUTHORIZE PERIODIC ON-SITE INSPECTION BY THE HOWARD SOIL CONSERVATION DISTRICT."

6-8-04  
 DATE  
 HAMILTON REED, LLC  
 SIGNATURE OF DEVELOPER

OWNER/DEVELOPER

HAMILTON REED, LLC  
 8000 Main Street  
 Ellicott City, MD 21045-6819  
 410.461.6666

SEDIMENT AND EROSION CONTROL PLAN AND DETAILS ILCHESTER HILLS LOTS 1,2,3 AND PARCEL 1 SINGLE FAMILY DETACHED DWELLINGS TAX MAP 31 GRID 5 PARCEL 419 1ST ELECTION DISTRICT HOWARD COUNTY, MARYLAND

DESIGN BY: FS  
 DRAWN BY: K52  
 CHECKED BY: ZYF  
 SCALE: 1"=30'  
 DATE: JUN 08, 2004  
 H.O. No. 3165  
 SHEET No. 3 OF 2

FSH Associates  
 Engineers Planners Surveyors  
 8318 Forest Street, Ellicott City, MD 21043  
 Tel: 410-750-2251 Fax: 410-750-7350  
 E-mail: FSHAssociates.com