

SPRINT PCS


CAPITAL DISTRICT

# SITE NAME: ROY A. ZIMMERMAN SITE NUMBER: WA54XC473C 8282 MURPHY ROAD FULTON, MD 20759

- HOWARD COUNTY GENERAL NOTES

  BE IN ACCORDANCE WITH THE LATEST STANDARDS AND SPECIFICATIONS OF HOWARD COUNTY PLUS MSHA STANDARDS AND SPECIFICATIONS IF APPLICABLE
- THE CONTRACTOR SHALL CONTACT THE CONSTRUCTION INSPECTION DIVISION AT (410) 313-1880 AT LEAST 24 HOURS IN ADVANCE
- THE CONTRACTOR SHALL NOTIFY "MISS UTILITY" AT 1-800-257-7777 AT LEAST 48 HOURS PRIOR TO ANY EXCAVATION WORK BEING
- TRAFFIC CONTROL DEVICES, MARKINGS AND SIGNING SHALL BE IN ACCORDANCE WITH THE LATEST EDITION OF THE MANUAL OF UNIFORM TRAFFIC CONTROL DEVICES (MUTCD). ALL STREET AND REGULATORY SIGNS SHALL BE IN PLACE PRIOR TO THE PLACEMENT
- ALL PLAN DIMENSIONS ARE TO FACE OF CURB UNLESS OTHERWISE NOTEC.
- THE EXISTING TOPOGRAPHY IS TAKEN FROM (FIELD RUN) SURVEY WITH (MAXIMUM ONE FOOT) CONTOUR INTERVALS PREPARED BY
- THE COORDINATES SHOWN HEREON ARE BASED UPON THE HOWARD COUNTY GEODETIC CONTROL WHICH IS BASED UP ON THE MARYLAND STATE PLANE COORDINATE SYSTEM. THE HOWARD COUNTY CONTROLS USED ARE GSC 46EA AND GSC 46EB.
- WATER SERVICE IS NOT REQUIRED FOR THIS PROJECT.
- SEWER SERVICE IS NOT REQUIRED FOR THIS PROJECT.
- O. THIS PROJECT DISTURB 33,340 S.F.
- 1. EXISTING UTILITIES ARE BASED ON FIELD OBSERVATION.
- 2. THERE IS NO FLOODPLAIN ON THIS SITE.
- 3. THE SITE IS LOCATED IN FLOOD ZONE 'C'.
- 4. NO TRAFFIC STUDY IS REQUIRED FOR THIS PROJECT.
- 5. PROJECT BACKGROUND INFORMATION (UNLESS INCLUDED IN TITLE BLOCK): SUBDIVISION NAME: N/A, TAX MAP: 46. SECTION/AREA: B. LOT/PARCEL: 111, ZONING: RRDEO, ZB/BA REFERENCE: N/A, ELECTION DISTRICT: N/A, SITE AREA: 97.68 AC.
- . THIS PLAN HAS BEEN PREPARED IN ACCORDANCE WITH SECTION 16.124 OF THE HOWARD COUNTY CODE AND LANDSCAPE MANUAL, PERIMETER LANDSCAPING SHALL BE PROVIDED FOR THE PROPOSED COMPOUND WITH PLANTINGS OF 6 SHADE TREES AND 12 EVERGREENS. SURETY IN THE AMOUNT OF \$3,600.00 SHALL BE POSTED WITH THE GRADING PERMIT IF A GRADING IS REQUIRED (OR WITH THE DEVELOPERS AGREEMENT, WHICHEVER IS APPLICABLE).
- . THIS PLAN HAS BEEN PREPARED IN ACCORDANCE WITH SECTION 16.1200 OF THE HOWARD COUNTY CODE AND FOREST CONSERVATION MANUAL. THE FOREST CONSERVATION OBLIGATION HAS BEEN FULFILLED BY THE PAYMENT OF A FEE-IN-LIEU IN THE AMOUNT OF \$2,831.40 FOR 0.13 ACRES OF AFFORESTATION.
- B. THE SDP PLAN CONFORMS TO THE AMENDED 5TH EDITION OF THE SUBDIVISION AND LAND DEVELOPMENT REGULATIONS. (COUNCIL BILL NO. 45-2003)
- 9 EACH 5TH YEAR AFTER A FACILITY BECOMES OPERATIONAL, THE FACILITY OPERATOR SHALL CONDUCT A SAFETY INSPECTION IN ACCORDANCE WITH THE ELECTRONICS INDUSTRIES ASSOCIATION STANDARD REFERENCE NUMBER 222E AS REFERENCED IN THE HOWARD COUNTY BUILDING CODE, AND RADIATION LEVEL INSPECTION OF THE FACILITY AND WITHIN 60-DAYS OF THE INSPECTION, FILE A REPORT WITH THE DIRECTOR OF INSPECTIONS, LICENSES AND PERMITS AND THE HEALTH OFFICER.
- 20. BA 01-26C DECISION AND ORDER GRANTING CUP ISSUED JUNE 18, 2002; APPEALED TO HOWARD COUNTY CIRCUIT COURT; FINAL DECISION AFFIRMING CUP ISSUED BY COURT JULY 24, 2003 (CASE NO. 13-C-02-50670). COURT DECISION SUBMITTED WITH PLANS AS SEPERATE DOCUMENTS.

	APPROVA	LS	
APPROVED:	DEPARTMENT OF PLANNING A	ND ZONING	-
CHIEF, DEVELOPMENT EN	CILLULAT GINEERING DIVISION		7/20/04 DATE
CHIEF, DIVISION OF LAND	DEVELOPMENTAL		7/21/04 DATÉ
DIRECTOR	de de gline	. <u></u>	DATE DATE

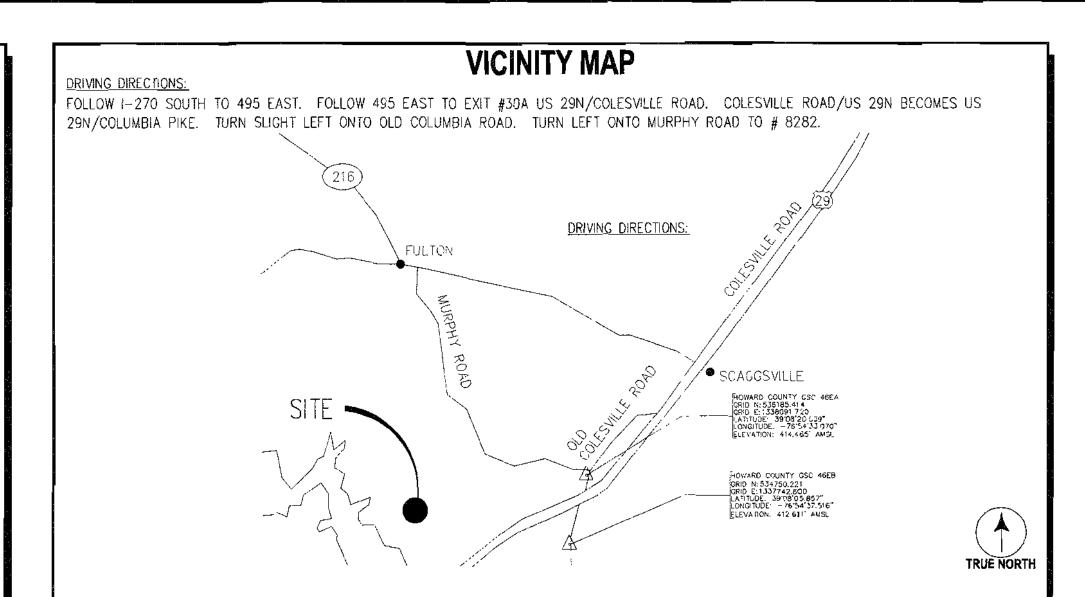

# SITE ANALYSIS DATA CHART

- A. TOTAL PROJECT AREA: 97.68 ACRES/ 4,254,940 SQUARE FEET.
- B. AREA OF PLAN SUBMISSION: 0.85 ACRES/ 37,173 SQUARE FEET.
- C. LIMIT OF DISTURBED AREA = 33,340 S.F.
- n Present zoning designation: RRDEO AGRICULTURAL
- E. PROPOSED USES FOR SITE AND STRUCTURES: CIA (COMMERICIAL) 150 FT TELECOMMUNICATION MONOPOLE, EQUIPMENT CABINETS, 6 FT HIGH CHAIN LINK FENCE AND COMPOUND AREA. EXISTING USE: AGRICULTURE
- F. FLOOR SPACE ON EACH LEVEL OF BUILDING(S) PER USE (RETAIL, OFFICE, WAREHOUSE, ETC.): N/A
- G TOTAL NUMBER OF UNITS ALLOWED FOR PROJECT AS SHOWN ON FINAL PLAT (RESIDENTIAL ONLY): N/A
- H. TOTAL NUMBER OF UNITS PROPOSED ON SUBMISSION (RESIDENTIAL ONLY): N/A
- I. MAXIMUM NUMBER OF EMPLOYEES, TENANTS ON SITE PER USE = 1 FOR EXISTING VACANT USE
- J. NUMBER OF PARKING SPACES REQUIRED BY HOWARD COUNTY ZONING REGULATIONS AND/OR FDP CRITERIA FOR EXISTING VACANT
- K. NUMBER OF PARKING SPACES PROVIDED ON SITE (INCLUDE NUMBER OF HANDICAPPED PARKING SPACES) = 1
- L. OPEN SPACE ON SITE: 97.2 ACRES, 99.5% OF GROSS AREA.
- M. AREA OF RECREATION OPEN SPACE REQUIRED BY SUBDIVISION AND LAND DEVELOPMENT REGULATIONS ACRES REQUIRED: O ACRES PROVIDED: O (RESIDENTIAL ONLY).
- N. BUILDING COVERAGE OF SITE. 0.5 ACRES, 0.5% OF GROSS AREA.
- APPLICABLE DPZ FILE REFERENCES:
- THERE ARE NO KNOWN RECORDED SUBMITTALS, WIAVERS, APPROVED OR DENIED (DPW AND DPZ) CONCERNING THIS TRACT.
- P. ANY OTHER INFORMATION WHICH MAY BE RELEVANT. N/A
- RRDEO = RURAL RESIDENTIAL DENSITY EXCHANGE OPTION

# SHEET INDEX

- TITLE SHEET
  - PROPERTY MAP AND ADJOINERS
- SITE SURVEY
- **ENLARGED SITE PLAN**
- GRADING PLAN ENTRANCE VICINITY
- GRADING PLAN COMPOUND VICINITY
- **CIVIL NOTES**
- CIVIL DETAILS

OWNER:

CONTACT:

WATER CODE:

SITE # BA-01-26C

- C-9 CIVIL DETAILS
- TCP-1 FOREST CONSERVATION PLAN
- LS-1 LANDSCAPING PLAN
- COMPOUND LAYOUT AND MONOPOLE ELEVATION

# PROJECT DESCRIPTION

SCOPE OF WORK: INSTALLATION OF NEW MONOPOLE FOUNDATION, MONOPOLE. PCS COMMUNICATION EQUIPMENT, SITE IMPROVEMENTS,

ELECTRICAL AND TELEPHONE SERVICE.

ENTREX COMMUNICATION SERVICES, INC.

APPLICANT:

APC REALTY AND EQUIPMENT COMPANY, LLC. d/b/a SPRINT PCS

ONE INTERNATIONAL BLVD. STE. 800 MAHWAH, N.J. 07495

LATITUDE: LONGITUDE:

N 39° 08′ 12.502″ W 76° 55′ 18.221″

GROUND ELEVATION: 383.5' AMSL

HOWARD COUNTY

PROPERTY INFO: TAX MAP: 46 GRID: 8 PARCEL.: 111

DEED REFERENCE: LIBER: 1154 FOLIO: 130 CURRENT ZONING: RR-DEO

USE: AGRICULTURAL/ CIA (COMMERCIAL)

SITE DEVELOPMENT PLAN # SDP-04-088

MARC A. MARZULLO, P.E.

(202) 408-0960

ROY A. ZIMMERMAN

8282 MURPHY ROAD

FULTON, MD 20759

# ADDRESS CHART


	ADDIVE OF ALIVIN	<u> </u>
LOT/PARCEL#		STREET ADDRESS
111	8282 MURPH	Y ROAD FULTON, MD 20759
	PERMIT INFORMATION	CHART
SUBDIVISION NAME:	SECTION/AREA:	LOT/PARCEL NO.:
PLAT # OR L/F: GRID #: ZÖNING 1144 / 130 8 RR-	TAX MAP NO: ELEC. DISTR.:  DEO 46	5 CENSUS TRACT: 605102

SEWER CODE:



1575 Eye Street, N.W. Suite 350 WASHINGTON, D.C. 20005 PHONE: (202)408-0960 FAX: (202)408-0961

ı	Βl	_0	CK		
SCI	RIF	10IT	<b>V</b>		RE
TIC	NC	REV	1EW		
TIC	N			•	Ì
LOI	РМ	ENT	PLA	AN	
OM	IME	NTS	<u> </u>		
OM	ME	NTS			2
OM	IME	NTS			
ιTŲ	JRE	SE	T		1
ITS	5				

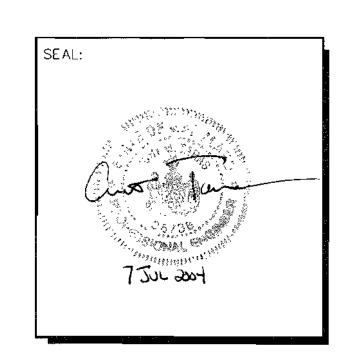



**CAPITAL DISTRICT** 

ROJECT NO: 1015.188 DESIGNER: B.M. ENGINEER: M.M. GRAPHIC SCALE IN INCHES


> ROY A. ZIMMERMAN **WA54XC473C** 8282 MURPHY ROAD **FULTON, MD 20759**

TITLE SHEET

OF 13

SHEET NUMBER:

T-1

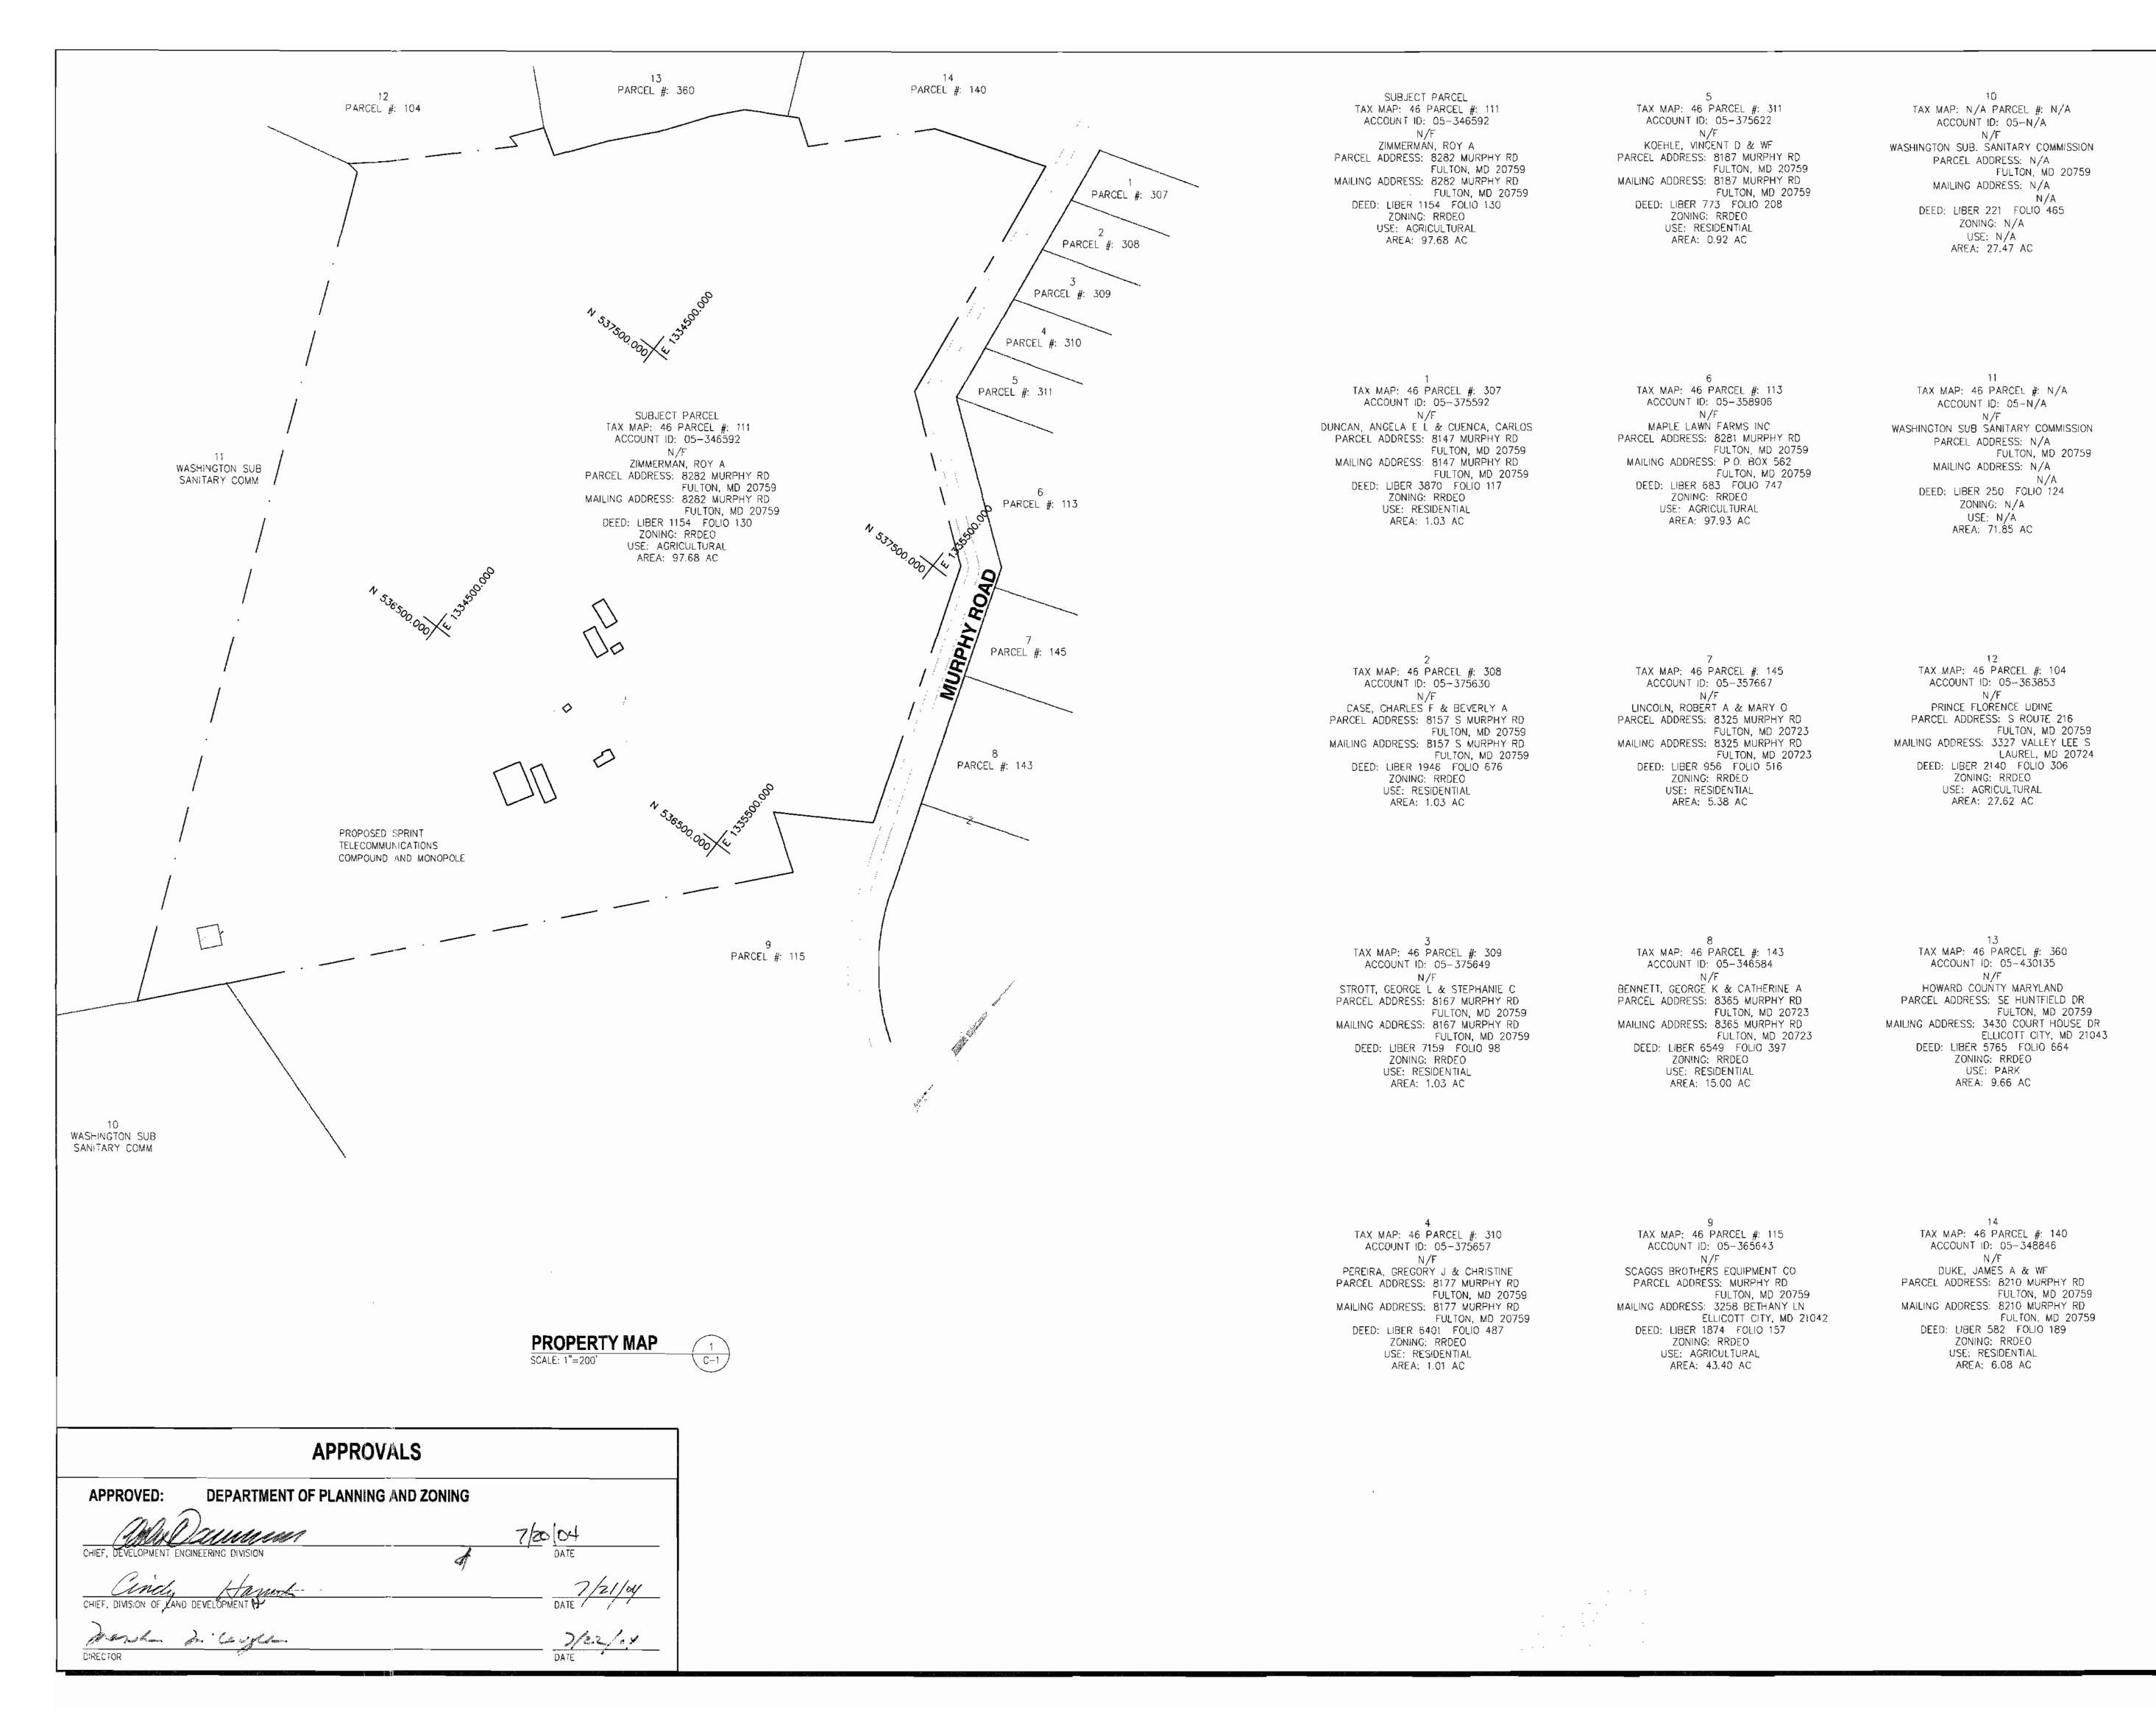



#### **REVISION BLOCK**

DATE DESCRIPTION R

10-29-03 CONSTRUCTION REVIEW

12-02-03 CONSTRUCTION


12-17-03 SITE DEVELOPMENT PLAN

03-17-04 COUNTY COMMENTS

05-11-04 COUNTY COMMENTS

05-26-04 COUNTY COMMENTS

6-16-04 SDP SIGNATURE SET

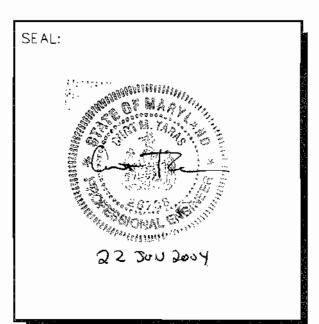



EQUIPMENT CO., LLO
d/b/a
SPRINT PCS
CAPITAL DISTRICT

PROJECT NO: 1015.188

DESIGNER: R.S.

ENGINEER: M.M.

SCALE:

GRAPHIC SCALE IN INCHES

ROY A. ZIMMERMAN WA54XC473C 8282 MURPHY ROAD FULTON, MD 20759


TITLE:

PROPERTY MAP AND ADJOINERS

2 OF 13


SHEET NUMBER:

C-1

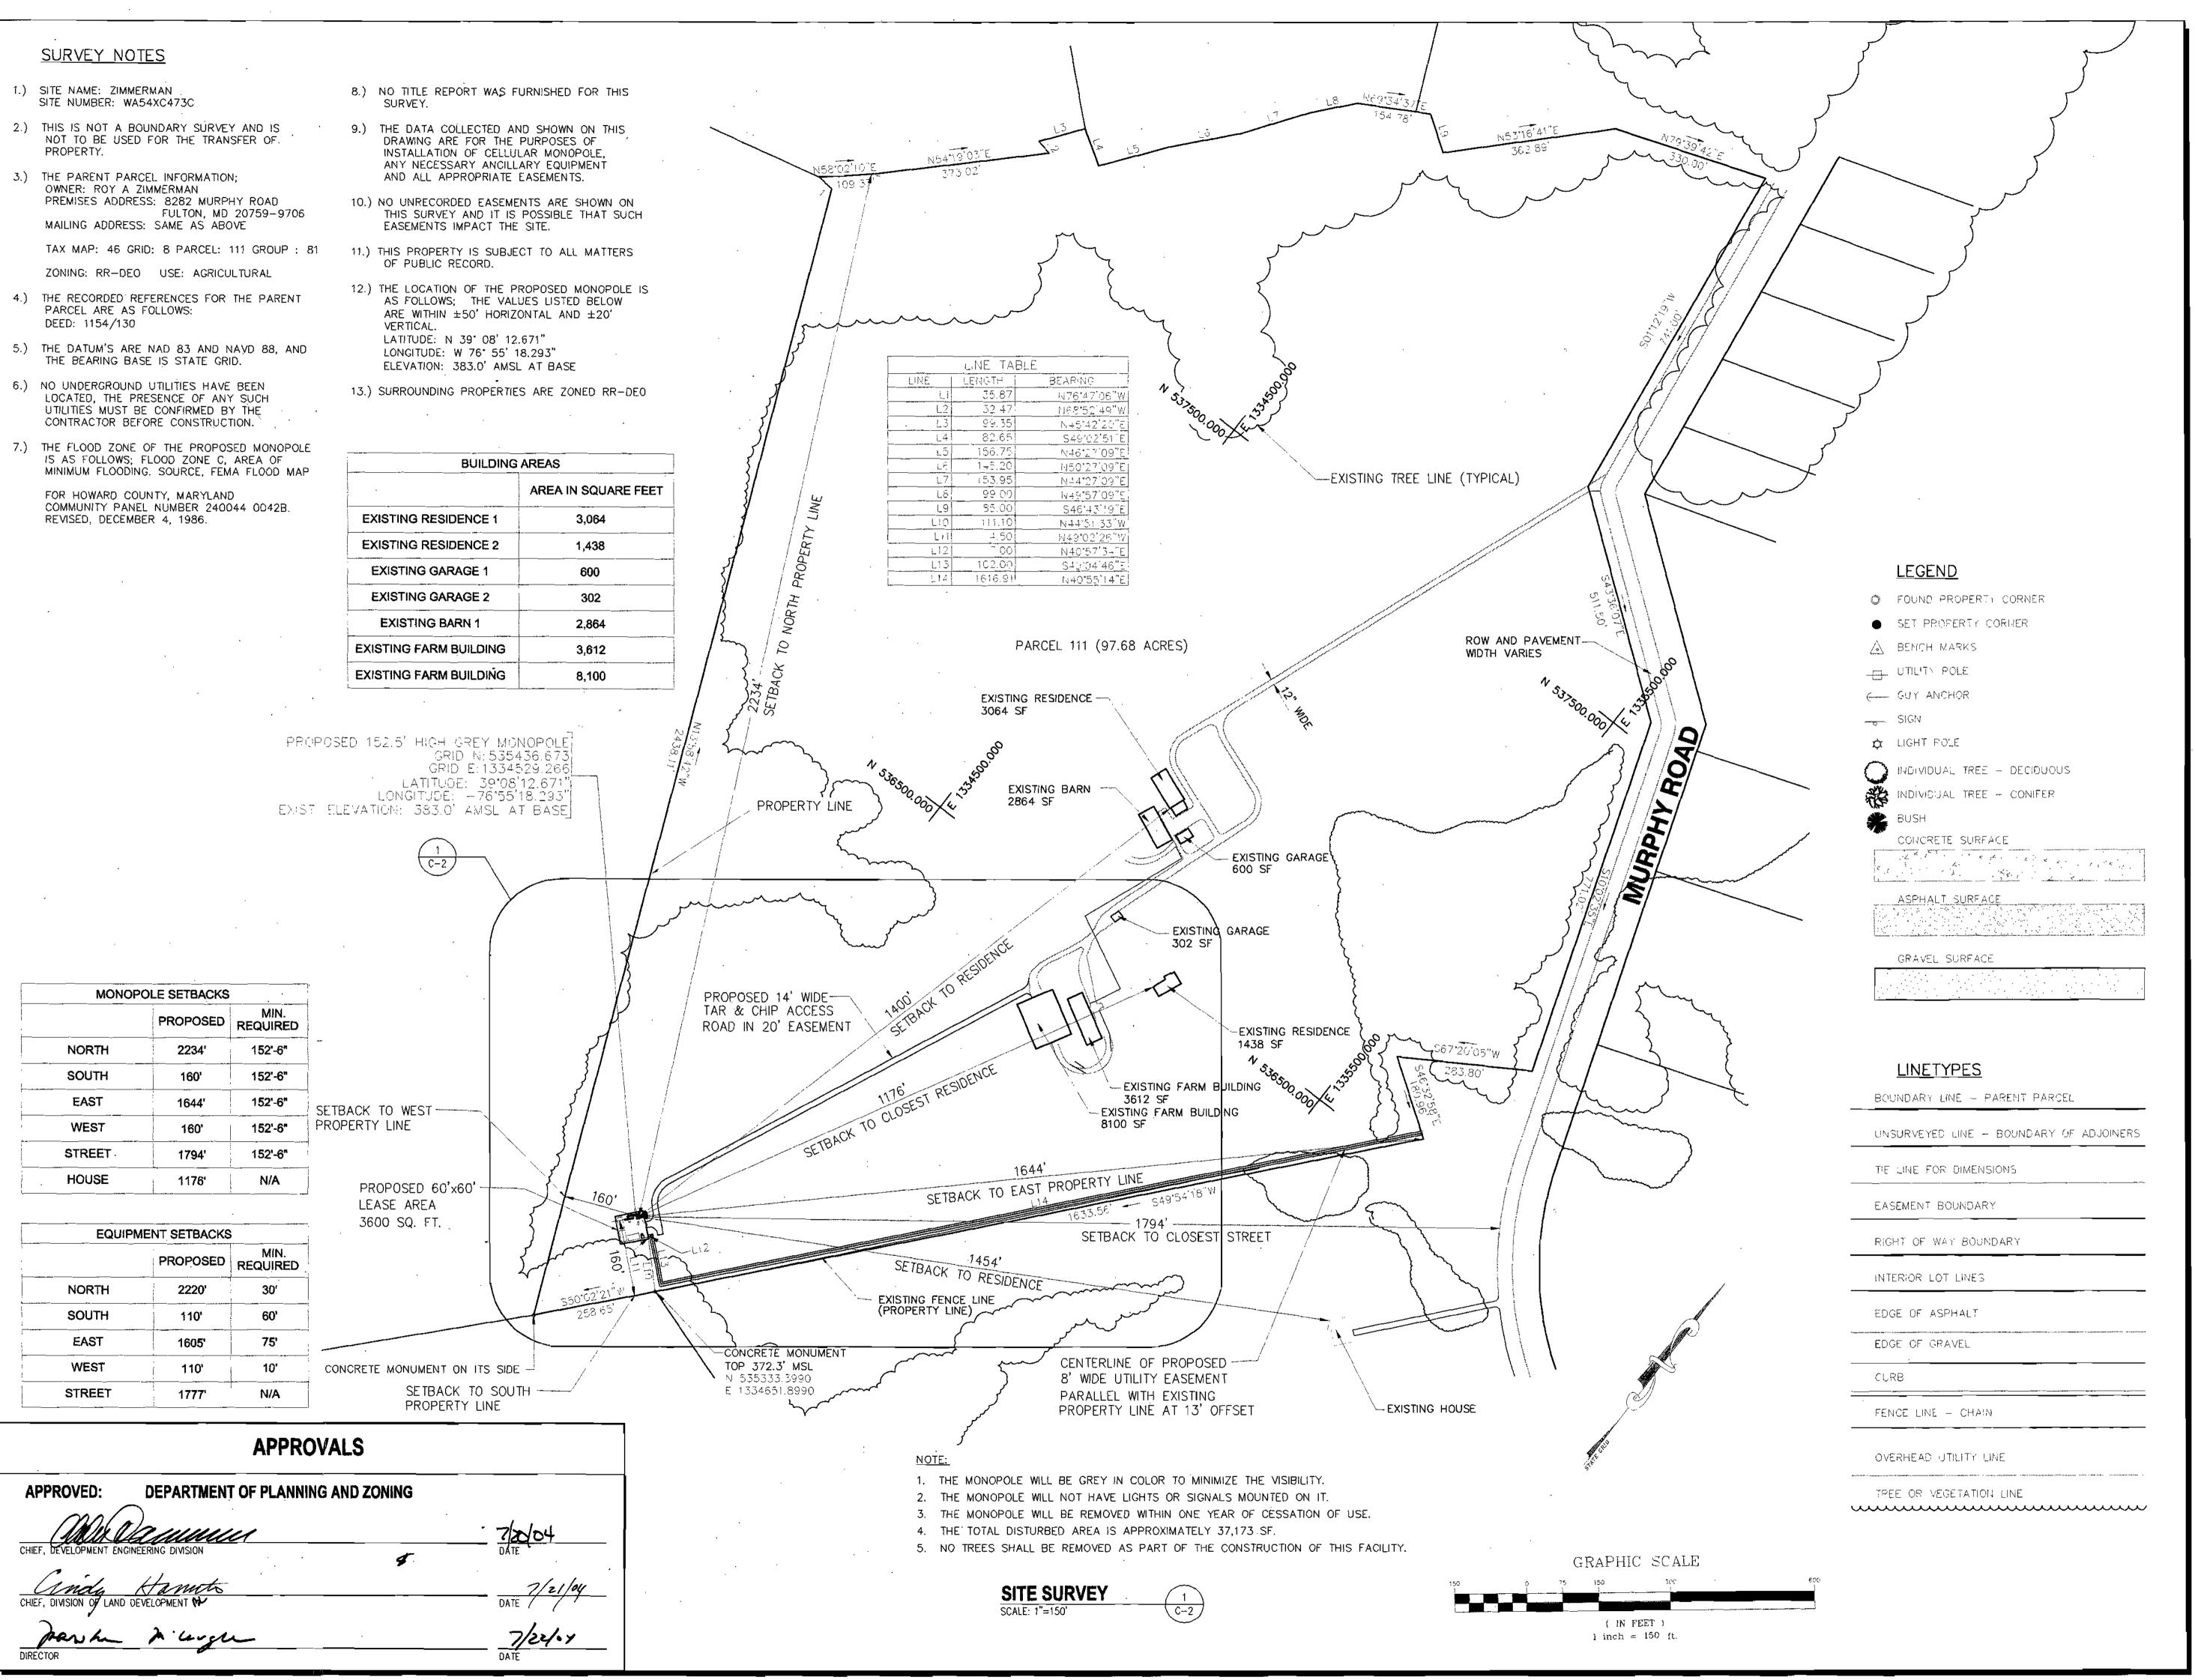



DATE	DESCRIPTION	! REV
10-29-03	CONSTRUCTION REVIEW	
12-02-03	CONSTRUCTION	1
12-17-03	SITE DEVELOPMENT PLAN	
03-17-04	COUNTY COMMENTS	i
05-11-04	COUNTY COMMENTS	2
05-26-04	COUNTY COMMENTS	1
6-16-04	SDP SIGNATURE SET	

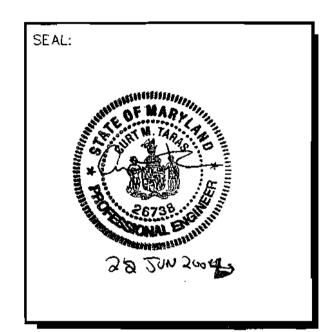



APC REALTY AND EQUIPMENT CO., LLC d/b/a SPRINT PCS CAPITAL DISTRICT

PROJECT NO:	1015.188
DESIGNER:	R.S.
ENGINEER:	M.M.

ROY A. ZIMMERMAN WA54XC473C 8282 MURPHY ROAD FULTON, MD 20759

GRAPHIC SCALE IN INCHES


TITLE:

**SITE SURVEY** 

3 OF 13


SHEET NUMBER:

C-2

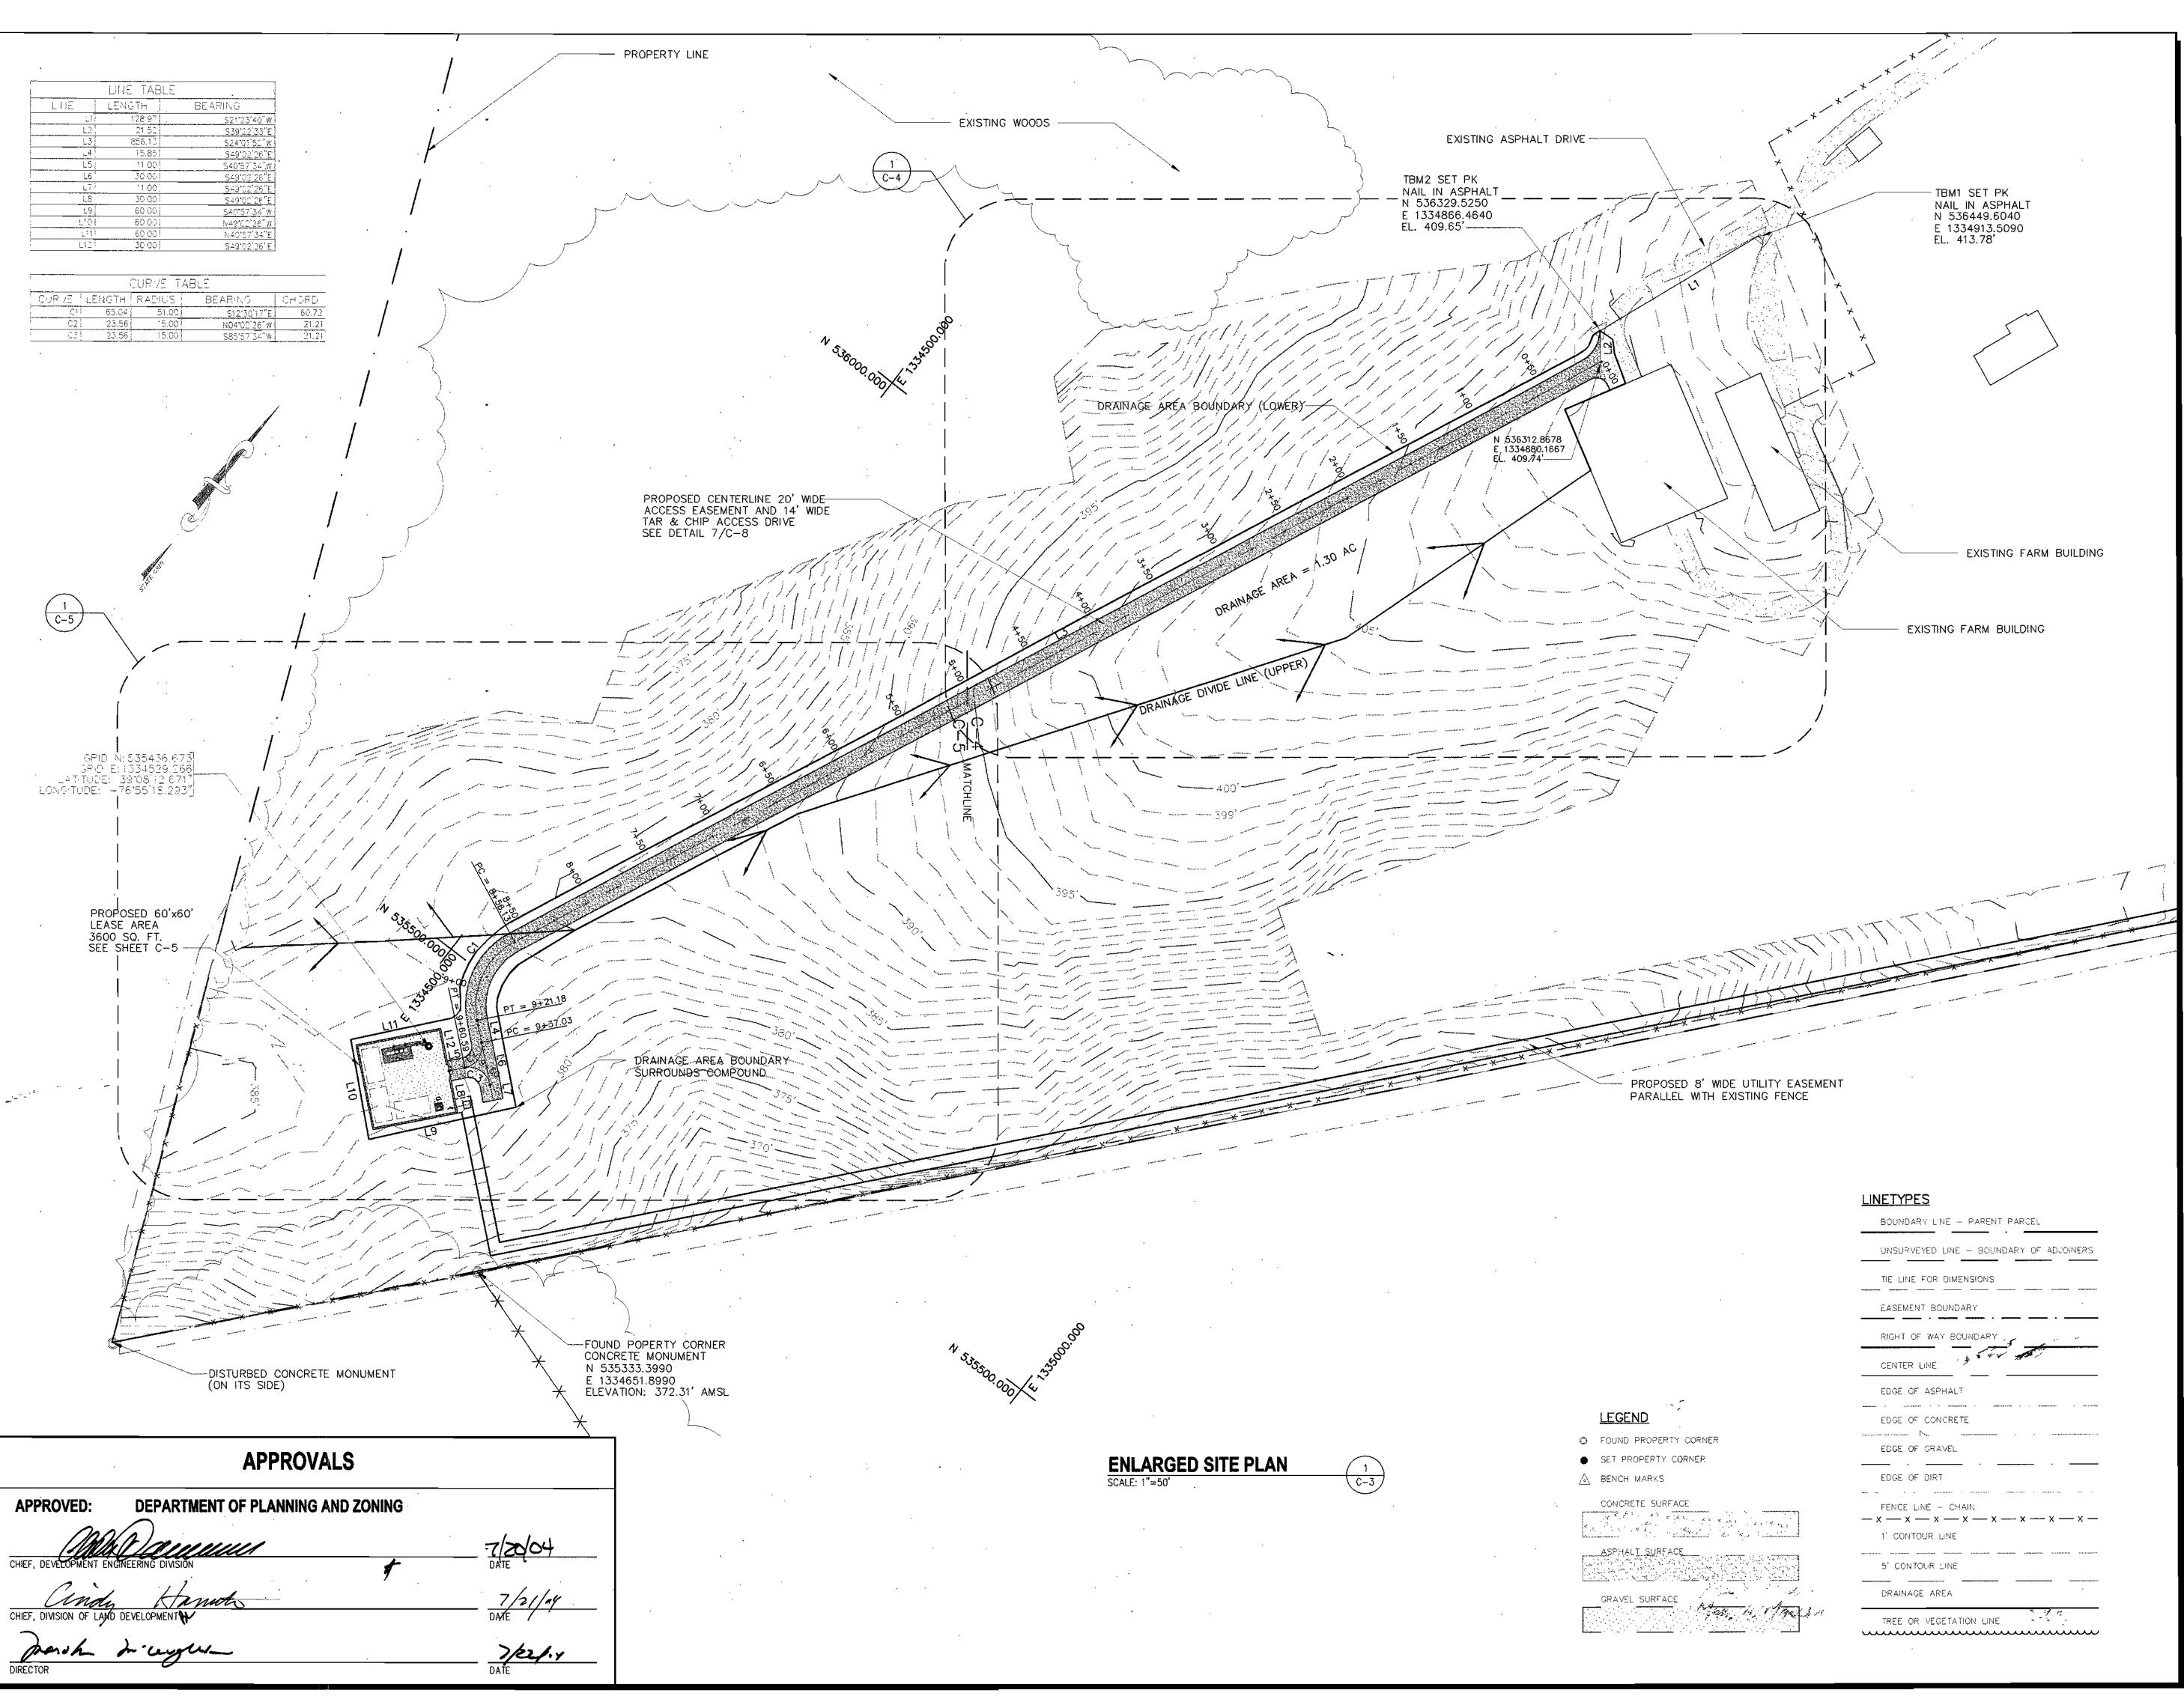



DATE	DESCRIPTION	; REV.
10-29-03	CONSTRUCTION REVIEW	
12-02-03	CONSTRUCTION	
12-17-03	SITE DEVELOPMENT PLAN	
03-17-04	COUNTY COMMENTS	
05-11-04	COUNTY COMMENTS	2
05-26-04	COUNTY COMMENTS	ì
6-16-04	SOP SIGNATURE SET	
~~.	The second of th	Í

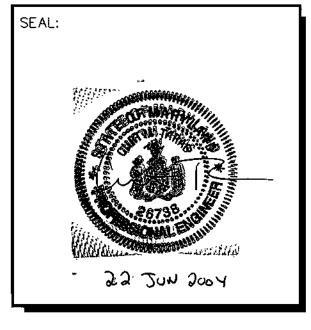



d/b/a SPRINT PCS

CAPITAL DISTRICT

PROJECT NO:	1015.188
DESIGNER:	R.S.
ENGINEER:	M.M.
SCALE:	
0 1/2 GRAPHIC	SCALE IN INCHES

ROY A. ZIMMERMAN WA54XC473C 8282 MURPHY ROAD FULTON, MD 20759


TITLE:

ENLARGED SITE PLAN

4 OF 13

SHEET NUMBER:

**C-3** 

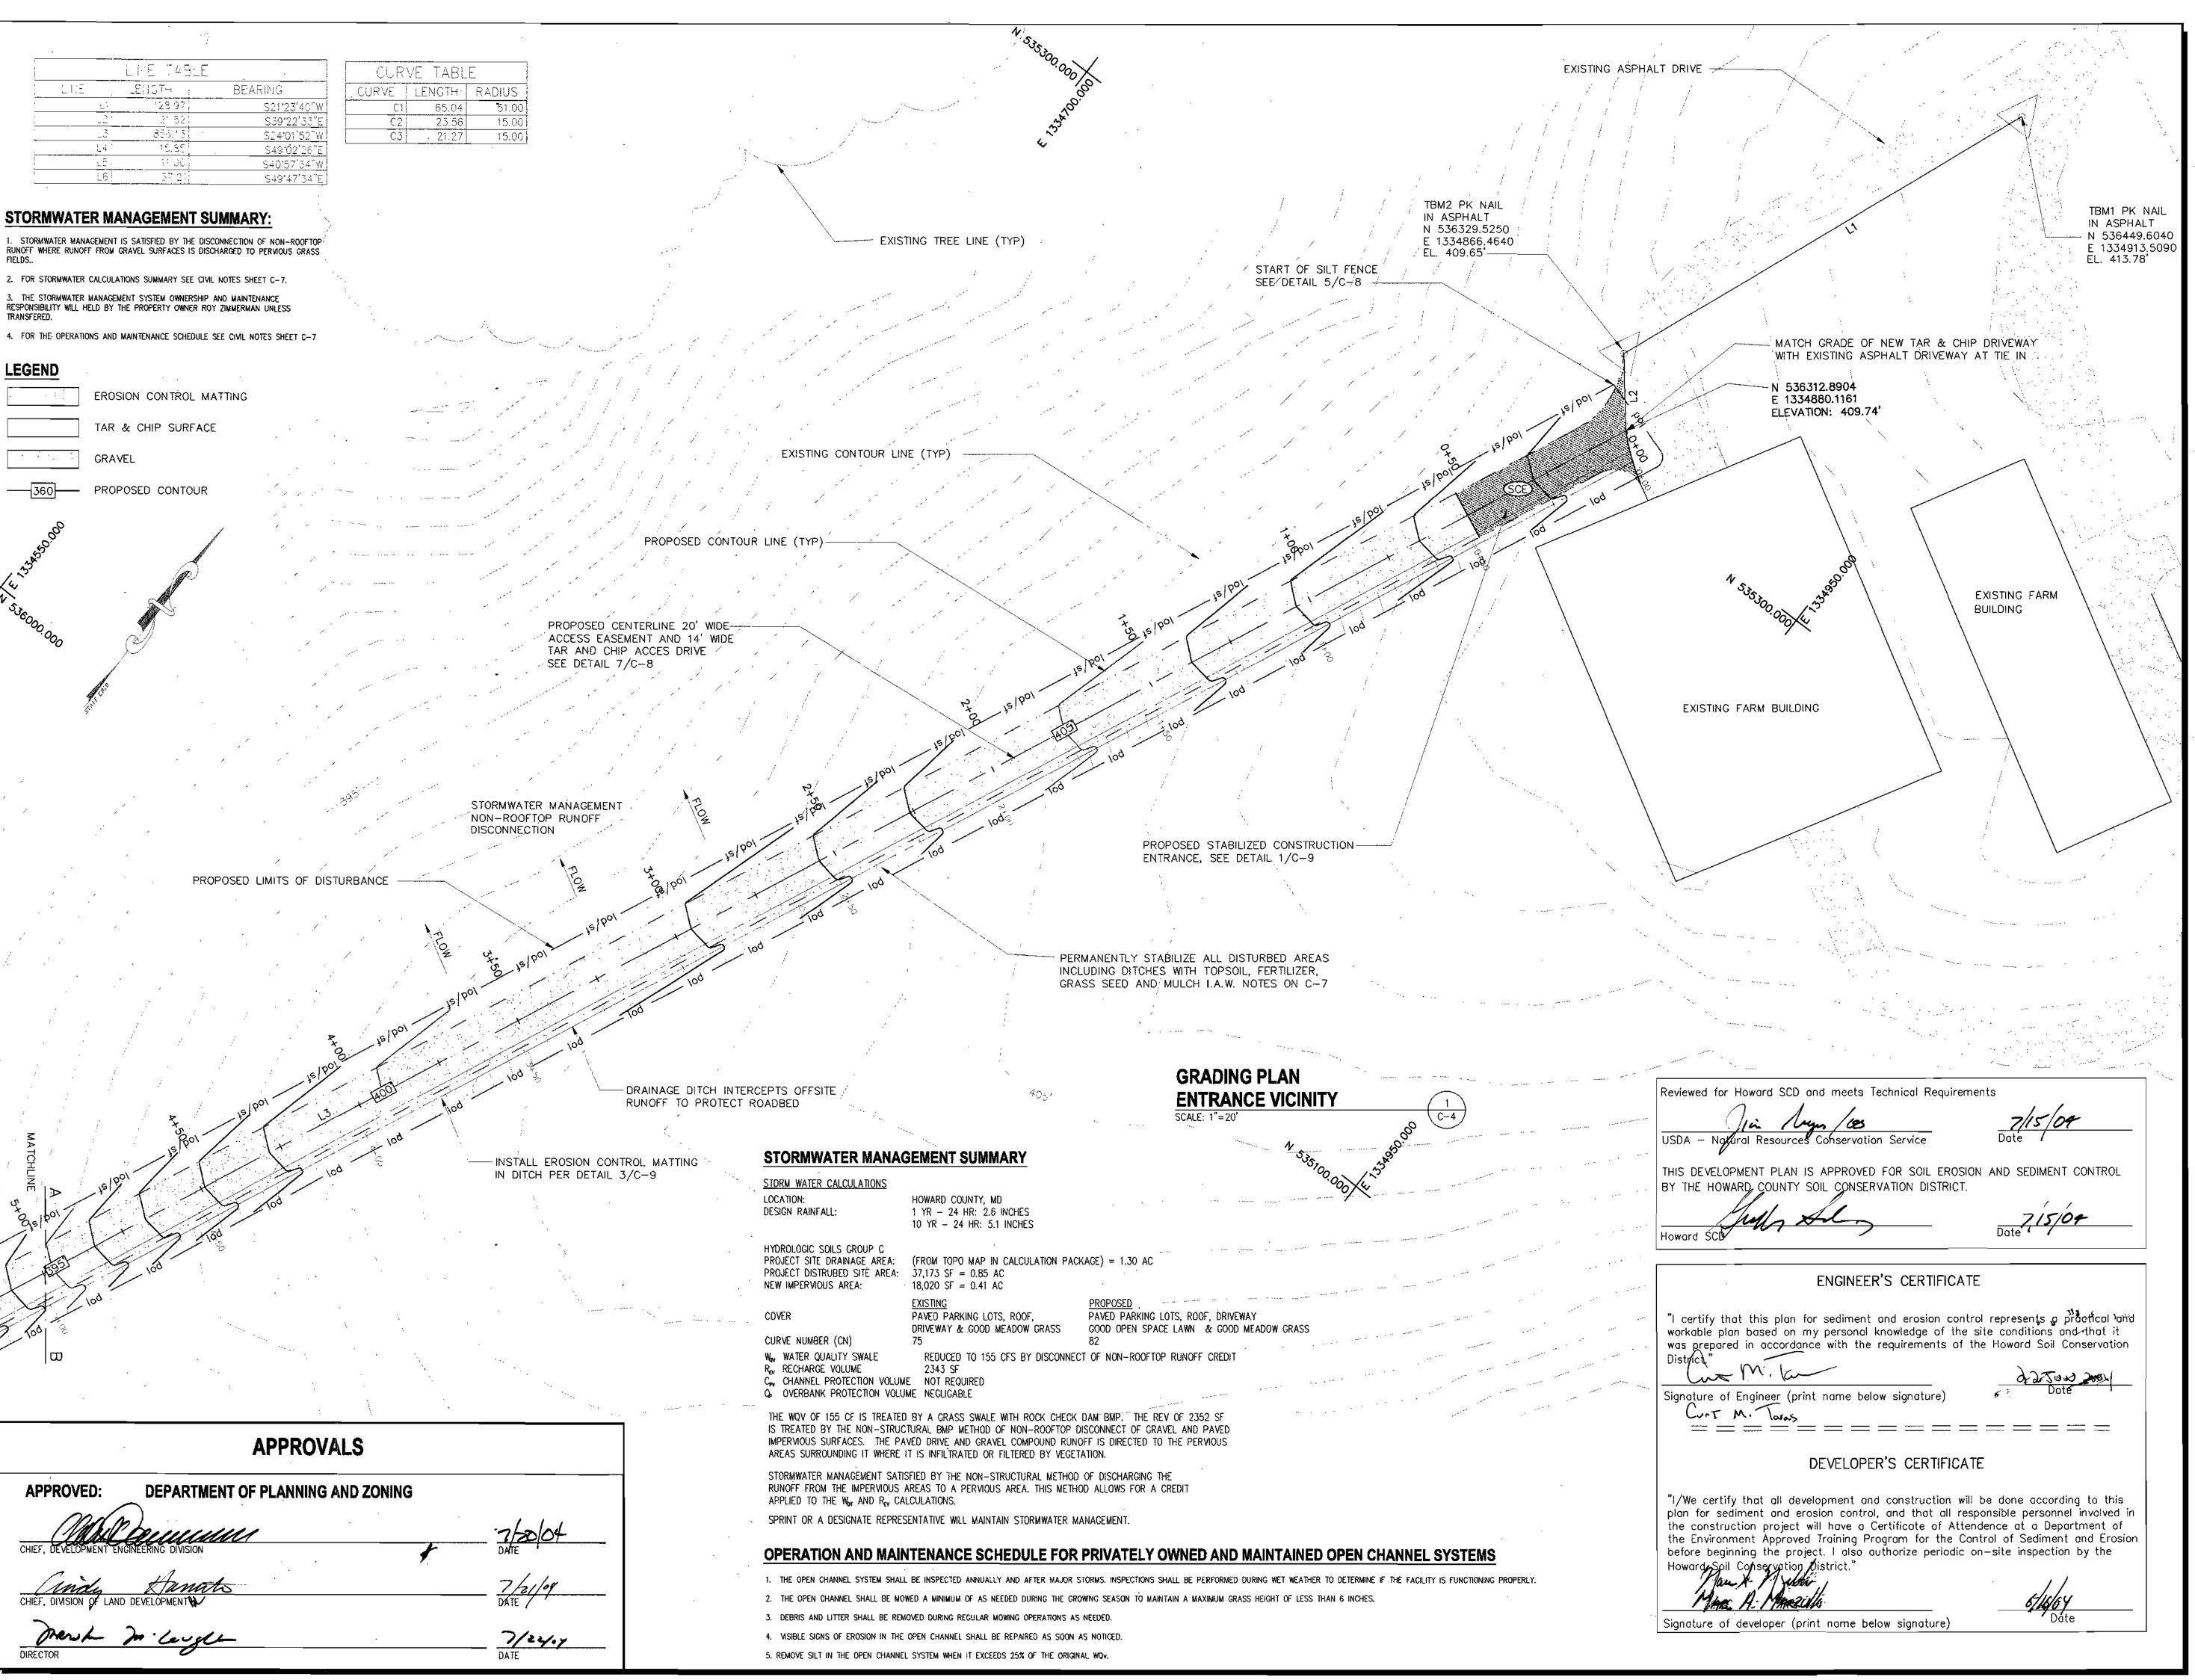



DATE DESCRIPTION REV.  10-29-03 CONSTRUCTION REVIEW  12-02-03 CONSTRUCTION  12-17-03 SITE DEVELOPMENT PLAN  03-17-04 COUNTY COMMENTS  05-11-04 COUNTY COMMENTS  2  05-26-04 COUNTY COMMENTS  6-16-04 SOP SIGNATURE SET	R	EVISION BLOCK	
12-02-03         CONSTRUCTION           12-17-03         SITE DEVELOPMENT PLAN           03-17-04         COUNTY COMMENTS           05-11-04         COUNTY COMMENTS           2         05-26-04           COUNTY COMMENTS	DATE	DESCRIPTION	REV.
12-17-03         SITE DEVELOPMENT PLAN           03-17-04         COUNTY COMMENTS           05-11-04         COUNTY COMMENTS           05-26-04         COUNTY COMMENTS	10-29-03	CONSTRUCTION REVIEW	:
03-17-04         COUNTY COMMENTS           05-11-04         COUNTY COMMENTS         2           05-26-04         COUNTY COMMENTS	12-02-03	CONSTRUCTION	
05-11-04         COUNTY COMMENTS         2           05-26-04         COUNTY COMMENTS	12-17-03	SITE DEVELOPMENT PLAN	Ţ <u>~~</u> `
05-26-04 COUNTY COMMENTS	03-17-04	COUNTY COMMENTS	<u> </u>
	05-11-04	COUNTY COMMENTS	2
6-16-04   SDP SIGNATURE SET	05-26-04	COUNTY COMMENTS	
	6-16-04	SOP SIGNATURE SET	
			,





EQUIPMENT CO., LLC d/b/a SPRINT PCS CAPITAL DISTRICT

PROJECT NO:	1015.188
DESIGNER:	R.S.
ENGINEER:	M.M.
SCALE:	
0 1/2	

ROY A. ZIMMERMAN WA54XC473C 8282 MURPHY ROAD FULTON, MD 20759


TITLE:

GRADING PLAN ENTRANCE VICINITY

5 OF 13

SHEET NUMBER:

C-4

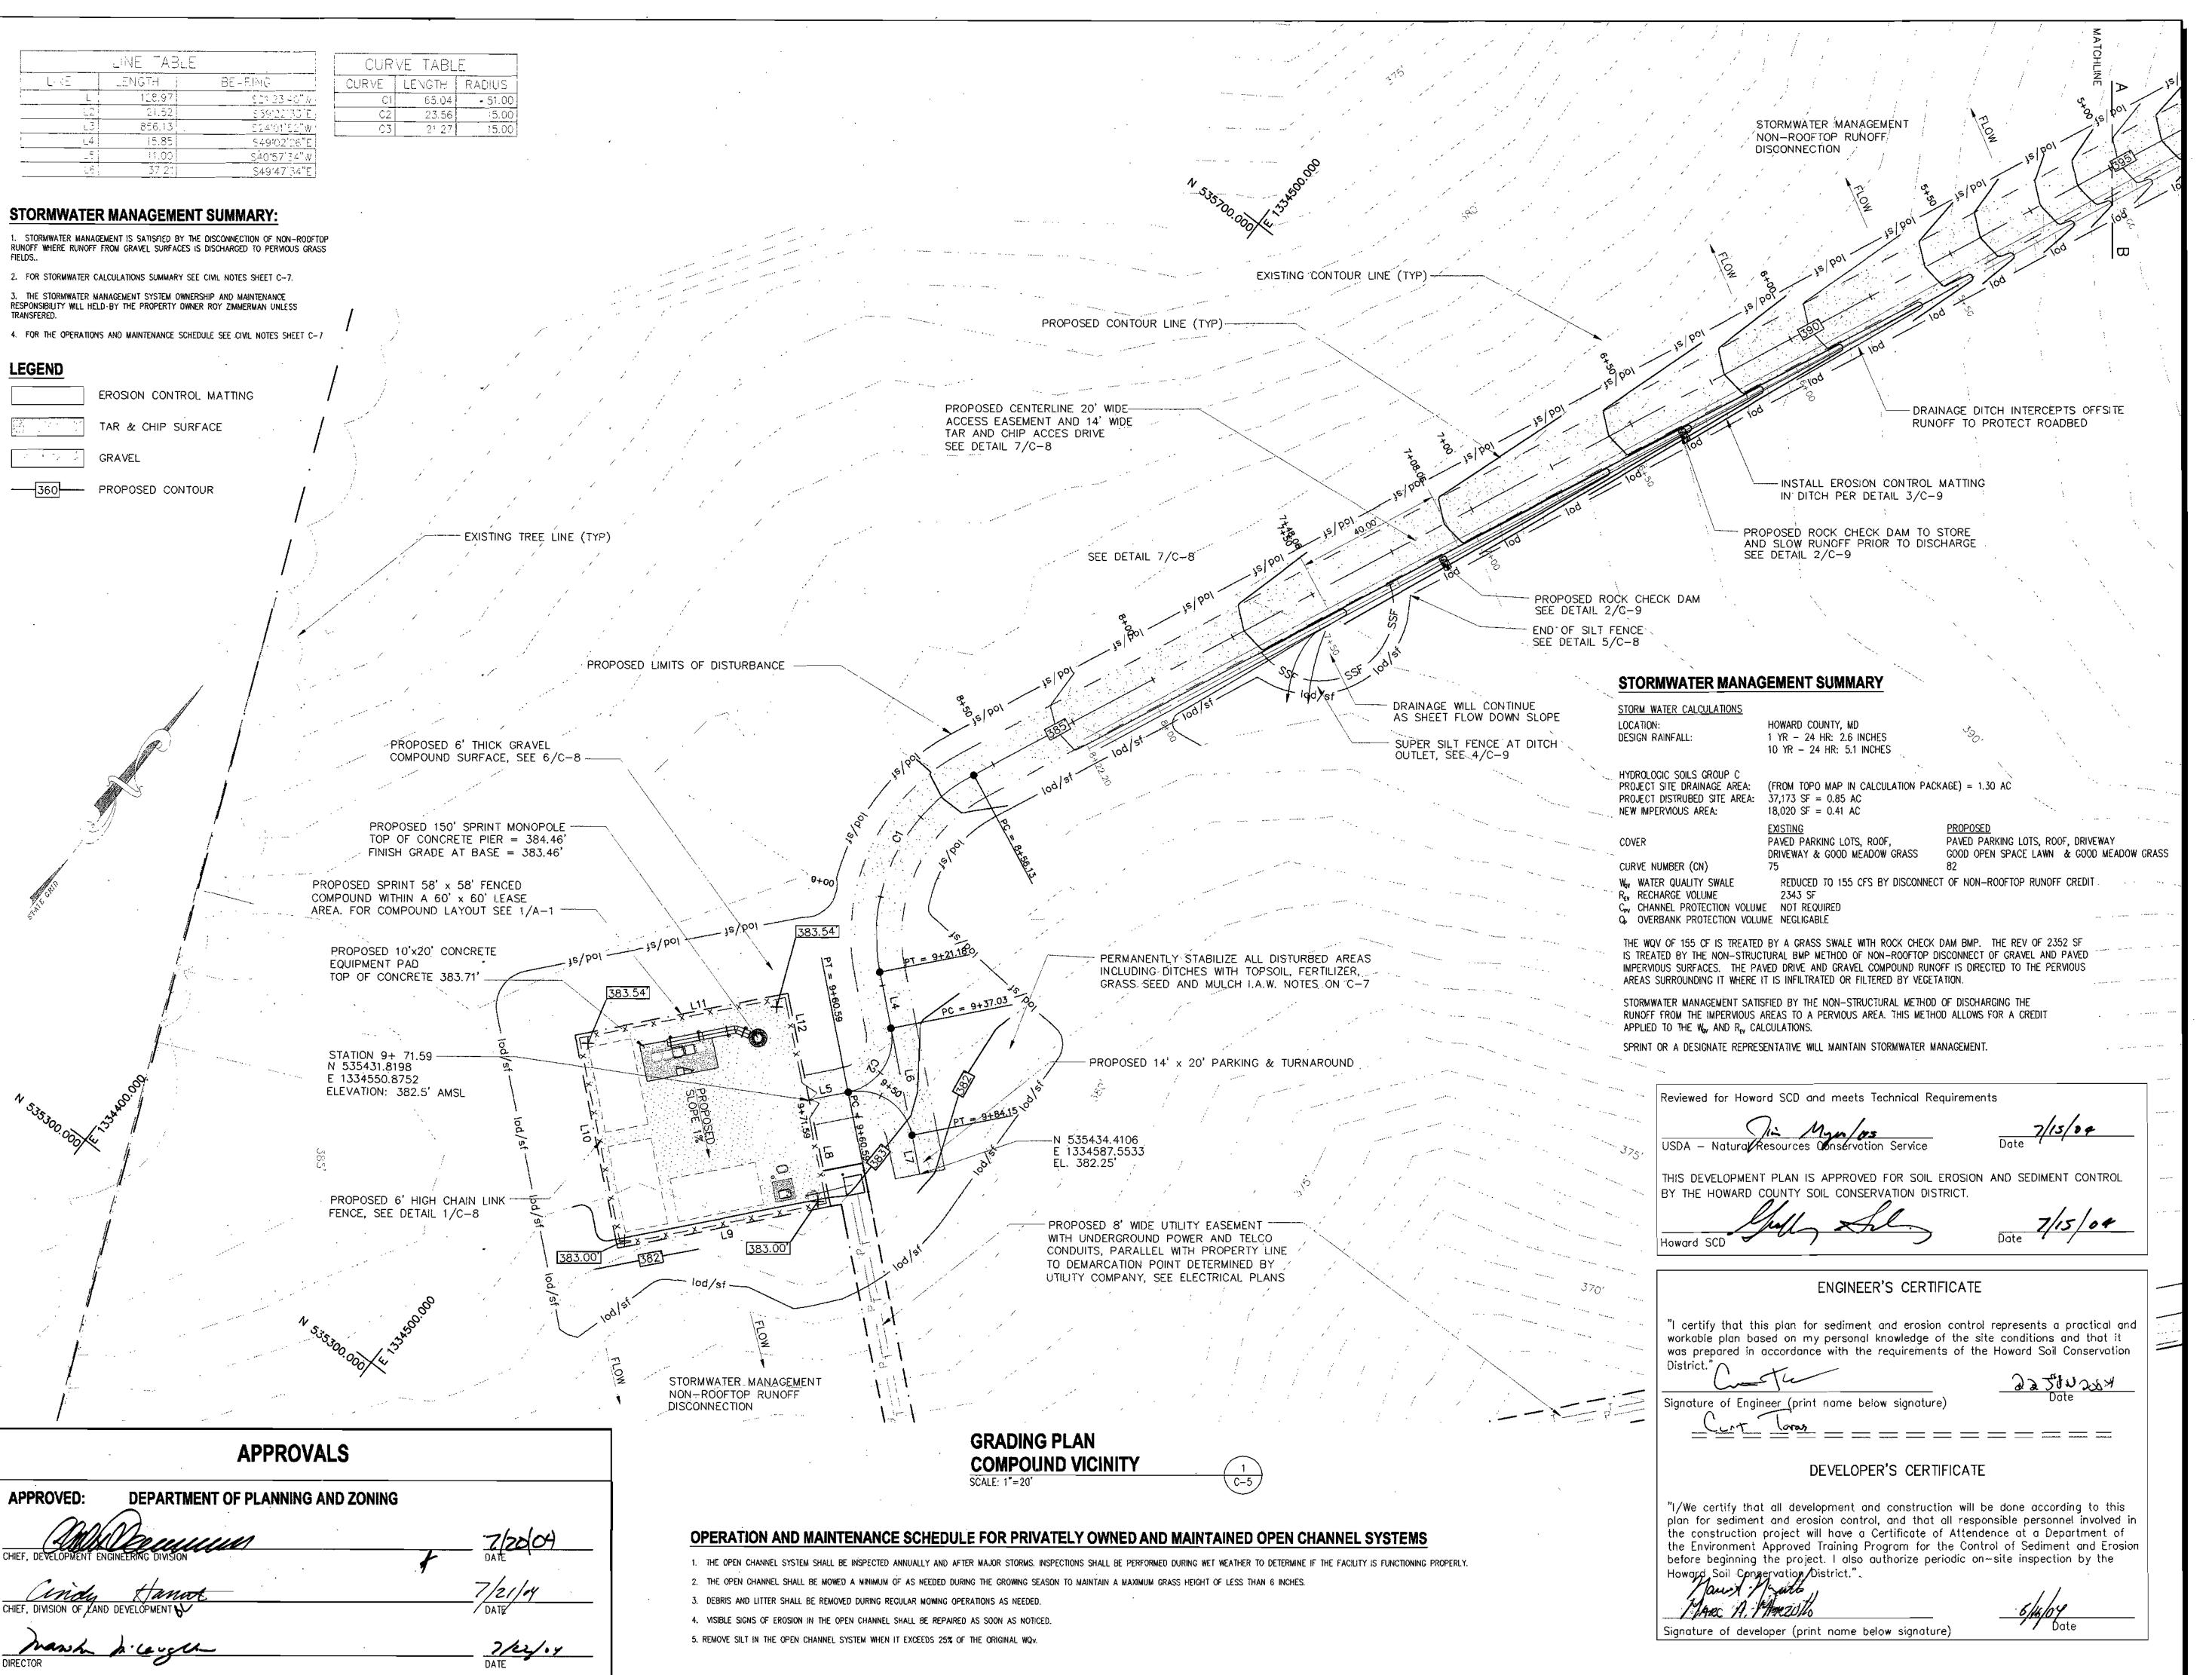



DATE	DESCRIPTION	REV.
10-29-03	CONSTRUCTION REVIEW	î r
12-02-03	CONSTRUCTION	
12-17-03	SITE DEVELOPMENT PLAN	,
03-17-04	COUNTY COMMENTS	
051104	COUNTY COMMENTS	. 2
05-26-04	COUNTY COMMENTS	
6-16-04	SDP SIGNATURE SET	. !





APC REALTY AND EQUIPMENT CO., LLC d/b/a SPRINT PCS

CAPITAL DISTRICT

\_\_\_\_

PROJECT NO: 1015.188

DESIGNER: R.S.

ENGINEER: M.M.

SCALE:

0 1/2 1
GRAPHIC SCALE IN INCHES

ROY A. ZIMMERMAN WA54XC473C 8282 MURPHY ROAD FULTON, MD 20759


TITLE:

GRADING PLAN COMPOUND VICINITY

6 OF 13

SHEET NUMBER:

C-5

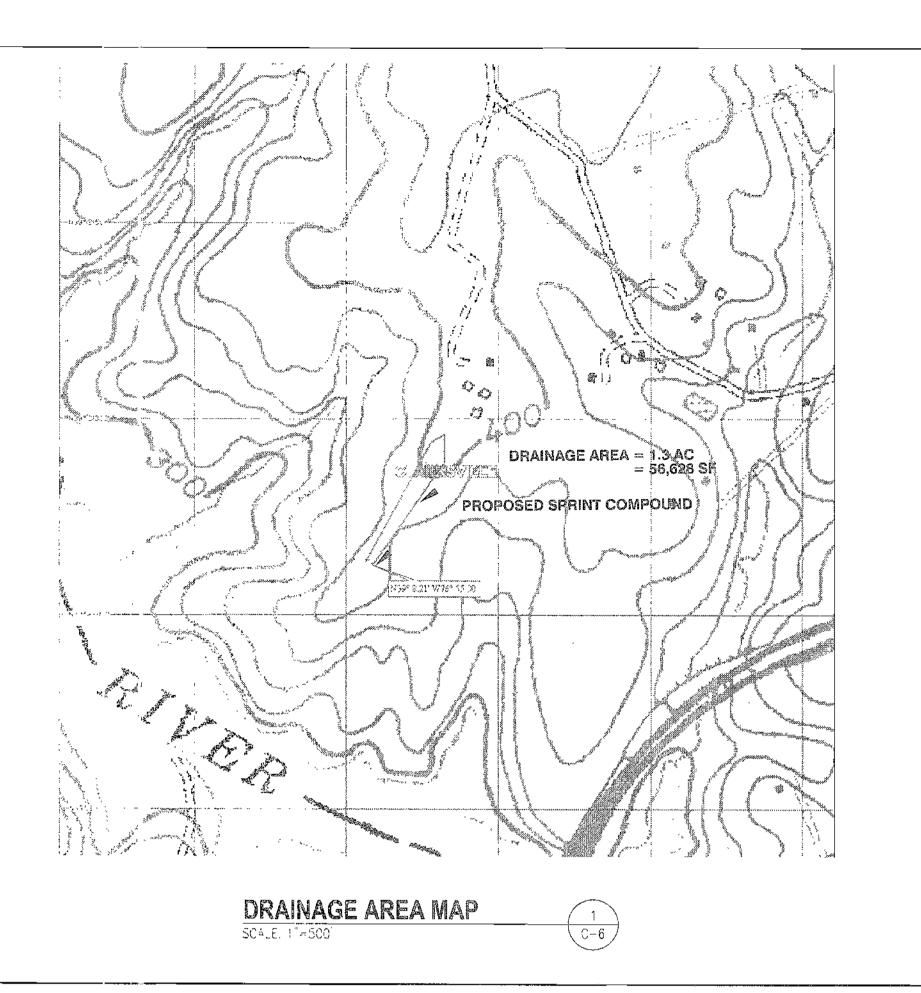



SOILS MAP

SCALE: 1"=500"

 $\begin{pmatrix} 2 \\ C-6 \end{pmatrix}$ 


SOILS NOTE


THE SITE WAS FOUND TO BE LOCATED WITH A SOIL TYPE "CHB2" (CHESTER SILT LOAM)



AERIAL PHOTO
SCALE: 1"=500"

C-6

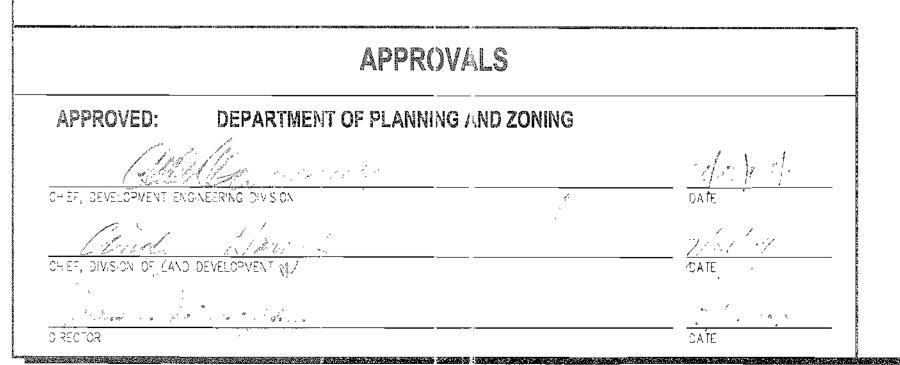

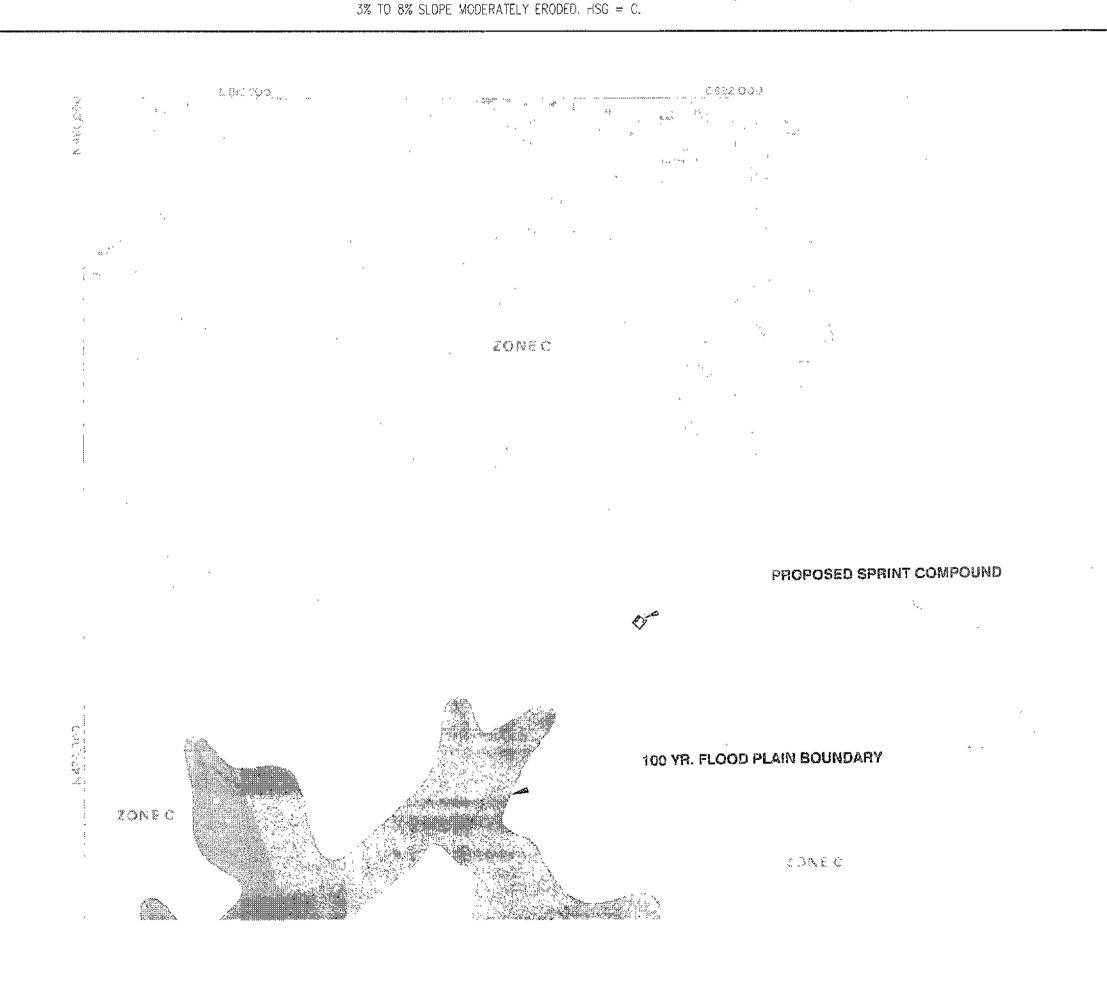

FEMA FLOOD MAP
SCALE: 1"=600'

C-6

©ENES & Communication services, inc

1575 Eye Street, N.W. Suite 350 WASHINGTON, D.C. 20005 PHONE: (202)408-0960 FAX: (202)408-0961

#### revision block

DATE DESCRIPTION

10-29-03 CONSTRUCTION REVIEW


12-02-03 CONSTRUCTION REVIEW

12-17-03 SITE DEVELOPMENT RUM

03-17-04 COUNTY COMMENTS

05-25-04 COUNTY COMMENTS

6 16 04 SUP SIGNATURE SET

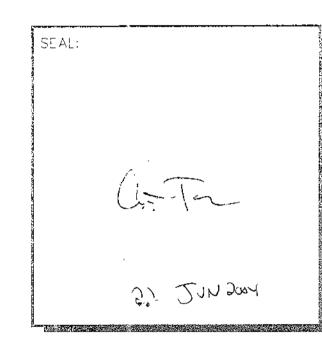



APC REALTY AND
EQUIPMENT CO., LLC
d/b/a
SPRINT PCS
CAPITAL DISTRICT

PROJECT NO: 1015.188

DESIGNER: B.M.

ENGINEER: M.M.

SUALE:

0 1/2 1 GRAPH C SCALE IN INCHES

ROY A. ZIMMERMAN WA54XC473C 8282 MURPHY ROAD FULTON, MD 20759

CIVIL MAPS

7 **OF 13** SHEET NUMBER:

C = 0

#### GENERAL EROSION AND SEDIMENT CONTROL NOTES

1. UNLESS OTHERWISE INDICATED, ALL VEGETATIVE AND STRUCTURAL EROSION AND SEDIMENT CONTROL PRACTICES WILL BE CONSTRUCTED AND MAINTAINED ACCORDING TO LATEST MDE STANDARDS AND SPECIFICATIONS FOR SEDIMENT AND EROSION CONTROL.

2 THE CONTRACTOR SHALL APPLY PERMANENT OR TEMPORARY SOIL STABILIZATION TO ALL CENUDED OR DISTURBED AREAS WITHIN 7 DAYS AFTER FINAL GRADE IS REACHED ON ANY PORTION OF THE SITE. SOIL STABILIZATION MUST ALSO BE APPLIED TO DENUDED OR DISTURBED AREAS WHICH MAY NOT BE AT FINAL GRADE BUT WHICH WILL REMAIN UNDISTURBED FOR LONGER THAT 30 DAYS, SOIL STABILIZATION MEASURES INCLUDE VEGETATIVE ESTABLISHMENT, MULCHING, AND THE EARLY APPLICATION OF GRAVEL BASE MATERIAL ON AREAS TO BE PAVED.

3. ALL SEDIMENT AND CONTROL MEASURES ARE TO BE PLACED PRIOR TO OR AS THE FIRST STEP IN LAND DISTURBANCE.

4. THE CONTRACTOR SHALL INSPECT ALL EROSION CONTROL MEASURES PERIODICALLY AND AFTER EACH RUNOFF PRODUCING RAINFALL EVENT. ANY NECESSARY REPAIRS TO MAINTAIN THE EFFECTIVENESS OF THE EROSION CONTROL DEVICES AND CLEANUP OF THE SEDIMENTATION ARE THE RESPONSIBILITY OF THE CONTRACTOR AND SHALL BE MADE IMMEDIATELY.

5. THE CONTRACTOR SHALL LIMIT SITE ACCESS BY CONSTRUCTION VEHICLES TO ENTRANCES PROTECTED BY A STONE CONSTRUCTION ENTRANCE OR AND APPROVED COMPARABLE CONTROL MEASURE, SEDIMENT SHALL BE REMOVED FROM PAVED ALEAS ON A DAILY BASIS.

6. STOCKPILES OF SOIL AND OTHER ERODIBLE MATERIALS SHALL BE STABILIZED IR PROTECTED WITH SEDIMENT TRAPPING MEASURES. THE CONTRACTOR IS RESPONSIBLE FOR THE TEMPORARY PROTECTION AND PERMANENT STABILIZATION FOR STOCKPILES ON SITE AS WELL AS FOR MATERIALS TRANSPORTED FROM THE PROJECT SITE.

7. THE CONTRACTOR SHALL MONITOR AND TAKE PRECAUTIONS TO CONTROL DUST. INCLUDING (BUT NOT LIMITED TO) USE OF WATER, MULCH, OR CHEWICAL DUST ADHESIVES AND CONTROL OF CONSTRUCTION SITE TRAFFIC

8. EFFLUENT FROM DEWATERING OPERATIONS SHALL BE FILTERED OR PASSED THROUGH AN APPROVED SEDIMENT TRAPPING DEVICE, OR BOTH, AND DISCHARGED IN A MANNER THAT DOES NOT ADVERSELY AFFECT ADJACENT PROPERTIES, WETLANDS, WATERWAYS OR THE STORM DRAINAGE SYSTEM

9. THE CONTRACTOR IS RESPONSIBLE FOR INSTALLATION AND MAINTENANCE OF ANY ADDITIONAL CONTROL MEASURES NECESSARY TO PREVENT FROSION AND SEDIMENTATION AS DEFERMINED NECESSARY BY THE PLAN APPROVING AUTHORITY

10 TEMPORARY EROSION AND SEDIMENT CONTROL MEASURES ARE NOT TO BE REMOVED UNTIL ALL DISTRUBED AREAS ARE STABILIZED. AFTER STABILIZATION IS COMPLETE, ALL MEASURES SHALL BE REMOVED WITHIN 30 DAYS. TRAPPED SEDIMENT SHALL BE SPREAD AND SEEDED.

#### SEQUENCE OF CONSTRUCTION

TASK DESCRIPTION

OBTAIN GRADING PERWIT (3 DAYS)

CONSTRUCT STABILIZED CONSTRUCTION ENTRANCE (2 DAYS)

CONSTRUCT SILT FENCE (3 DAYS)

CONSTRUCT MONOPOLE (30 DAYS)

FINISH GRADE WITHIN THE SITE (20 DAYS)

INSTALL EQUIPMENT (20 DAYS)

CONSTRUCT FENCE (10 DAYS)

STABILIZE WITH TOPSOIL, FERTILIZER AND SEED (10 DAYS) INSTALL EROSION CONTROL MATTING AS SHOWN IN CIVIL DETAILS

REMOVE SEDIMENT CONTROL PRACTICES ONLY WITH PERMISSION FROM SEDIMENT CONTROL INSPECTOR (5 DAYS)

#### SYMBOLS

— SF — SF — SF = SILT FENCE

TPF = TREE PROTECTION FENCE

LOD = LIMITS OF DISTURBANCE

\_\_\_\_ T 

TELEPHONE

**AREA TABLE** 

IMPERMOUS AREA . 15,960 SF

DISTURBED AREA GRAVEL 63 CY

CALL "MISS UTILITY" AT 1-800-257-7777, 48 HOURS PRIOR TO THE START OF WORK. THE EXCAVATOR MUST NOTIFY ALL PUBLIC UTILITY COMPANIES WITH UNDER GROUND FACILITIES IN THE AREA OF PROPOSED EXCAVATION AND HAVE THOSE FACILITIES LOCATED BY THE UTILITY COMPANIES PRIOR TO COMMENCING EXCAVATION.

#### EARTH EXCAVATION NOTES

EXCAVATED MATERIAL SHALL BE USED AS BACKFILL WHEREVER POSSIBLE, BACKFILL MATERIAL SHALL BE OF A QUALITY SUITABLE TO THE ENGINEER AND FREE OF EXCESS ORGANIC MATTER AND

2. BACKFILL SLOPES SHALL BE STEPPED OR SERRATED AND PROCEED IN SIX (6) INCH LIFTS. 3 EACH LAYER SHALL BE COMPACTED BY MECHANICAL TAMPERS OF OTHER APPROVED MEANS TO NINETY-FIVE (95) PERCENT OF MAXIMUM DENSITY AS MEASURED BY A.A.S.H.O. 1-99.

4 COMPACTION TESTING SHALL BE MADE BY AN OWNER APPROVED MATERIALS TESTING FIRM AND THE RESULTS SHALL BE SUBMITTED BY THE CONTRACTOR TO THE DESIGN ENGINEER FOR APPROVAL. TESTS SHALL BE CONDUCTED AT THE RATE OF ONE TEST PER 50 CY OF FILL OR 2000 SF OF SURFACE AREA WHICHEVER IS GREATER. A MINIMUM OF 2 TESTS PER COMPACTED AREA ARE

5. THE BACKFILL SHALL BE PROPERLY CRADED TO BLEND WITH THE EXISTING GROUND AND DRAIN

6 MAXIMUM CUT OR FILL SLOPE

3 1 FOR SEED OR SOD LAWN AREAS 2 1 FOR STABILIZED LOW MAINTENANCE AREAS

#### HOWARD COUNTY DRIVEWAY NOTES

1. DRIVEWAY(S) SHALL BE PROVIDED PRIOR TO RESIDENTIAL OCCUPANCY TO INSURE SAFE ACCESS FOR FIRE AND EMERGENCY VEHICLES PER THE FOLLOWING MINIMUM REQUIREMENTS:

A. WIDTH - 12' (14' SERVING MORE THAN ONE RESIDENCE); B. SURFACE - 6" OF COMPACTED CRUSHER RUN BASE W/TAR AND CHIP COATING (1-1/2" MIN.);

C. GEOMETRY - MAX. 15 % GRADE, MAX 10% GRADE CHANGE AND MIN. 45' TURNING RADIUS;

E. DRAINAGE ELEMENTS - CAPABLE OF SAFELY PASSING 100-YEAR FLOOD WITH NO MORE THAN 1 FOOT DEPTH OVER DRIVEWAY SURFACE;

D STRUCTURES (CULVERTS/BRIDGES) - CAPABLE OF SUPPORTING 25 GROSS TONS (H25 LOADING);

F. STRUCTURAL CLEARANCE - MINIMUM 12 FEFT:

G. MAINTENANCE - SUFFICIENT TO INSURE ALL WEATHER USE.

#### HOWARD COUNTY CHECKLIST ITEMS

1. APFO ROAD TESTS ARE NOT APPLICABLE TO THIS PROJECT.

2. APFO MITIGATION PLANS ARE NOT APPLICABLE TO THIS PROJECT.

3. A TRAFFIC STUDY IS NOT REQUIRED FOR THIS PROJECT. THE PROJECT WILL REQUIRE ONE MAN TRIP TO

4. A SIGHT DISTANCE ANALYSIS IS NOT REQUIRED FOR THIS PROJECT. THE SITE ACCESSED THROUGH PRIVATE

5. THERE ARE NO BURIAL GROUNDS OR CEMETERY SITES ON THIS PROPERTY.

6. THERE ARE NO SCENIC ROADS ADJACENT TO, OR WITHIN 200 FT OF THE PROPERTY

#### **HOWARD COUNTY ZONING NOTES & REGULATIONS**

1 IN ACCORDANCE WITH SECTION 128.E.2.A. OF THE ZONING REGULATIONS. THE MONOPOLE SHALL BE SETBACK A MINIMUM DISTANCE FROM PUBLIC STREET RIGHT-OF-WAY AND OTHER RESIDENTIALLY-ZONED LOTS EQUAL TO THE TOWER HEIGHT (INCLUDING ANTENNAS) MEASURED FROM GROUND LEVEL AND A MINIMUM DISTANCE FROM NON-RESIDENTIALLY-ZONED LOTS EQUAL TO 50 FEET OR ONE-THIRD OF THE TOWER HEICHT (INCLUDING ANTENNAS) MEASURED FROM GROUND LEVEL, WHICHEVER IS GREATER.

2. COMMUNICATION TOWERS SHALL BE GRAY OR A SIMILAR COLOR THAT MINIMIZES VISIBILITY, UNLESS A DIFFERENT COLOR IS REQUIRED BY THE FEDERAL COMMUNICATIONS COMMISSION OR THE FEDERAL AVIATION

3. NO SIGNALS OR LIGHTS SHALL BE PERMITTED ON TOWERS UNLESS REQUIRED BY THE FEDERAL COMMUNICATIONS COMMISSION OR THE FEDERAL AVIATION ADMINISTRATION.

4. A COMMUNICATION TOWER THAT IS NO LONGER USED SHALL BE REMOVED FROM THE SITE WITHIN ONE-YEAR OF THE DATE THAT THE USE CEASES

#### HOWARD COUNTY SOIL CONSERVATION DISTRICT NOTES

1. ALL VECETATIVE AND STRUCTURAL PRACTICES ARE TO BE INSTALLED ACCORDING TO THE PROVISIONS OF THIS PLAN AND ARE TO BE IN CONFORMANCE WITH THE MOST CURRENT MARYLAND STANDARDS AND SPECIFICATIONS FOR SOIL EROSION AND SEDIMENT CONTROL AND REVISIONS THERETO.

2 THE DEVELOPER IS RESPONSIBLE FOR THE ACQUISITION OF ALL EASEMENTS, RIGHTS AND/OR RIGHTS OF WAY THAT MAY BE REQUIRED FOR GRADING AND/OR WORK ON ADJACENT PROPERTIES AFFECTED BY THIS

#### TOPSOIL SPECIFICATIONS:

FOR SITES HAVING DISTURBED AREAS UNDER 5 ACRES SOIL TO BE USED AS TOPSOIL MUST MEET THE FOLLOWING:

1. TOPSOIL SHALL BE A LOAM, SANDY LOAM, CLAY LOAM, SILT LOAM, SANDY CLAY LOAM, LOAMY SAND. OTHER SOILS MAY BE USED IF RECOMMENDED BY AN AGRONOMIST OR SOIL SCIENTIST AND APPROVED BY THE APPROPRIATE APPROVAL AUTHORITY. REGARDLESS, TOPSOIL SHALL NOT BE A MIXTURE OF CONTRASTING TEXTURED SUBSCILS AND SHALL CONTAIN LESS THAN 5% BY VOLUME OF CINDERS, STONES, SLAG, COARSE FRAGMENTS, GRAVEL STICKS, ROOTS, TRASH, OR OTHER MATERIALS LARGER THAN 1 1/2" IN DIAMETER.

2. TOPSOIL MUST 9E FREE OF PLANTS OR PLANT PARTS SUCH AS BERMUDA GRASS, QUACKGRASS, JOHNSONGRASS, NUTSEDGE, POISON IVY, THISTLE, OR OTHERS AS SPECIFIED.

4. FERTILIZERS SHALL BE UNIFORM IN COMPOSITION, FREE FLOWING AND SUITABLE FOR ACCURATE

3. WHERE THE SUBSOIL IS EITHER HIGHLY ACIDIC OR COMPOSED OF HEAVY CLAYS, GROUND LIMESTONE SHALL BE SPREAD AT THE RATE OF 4-8 TONS/ACRE (200-400 POUNDS PER 1,000 SQUARE FEET) PRIOR TO THE PLACEMENT OF TOPSOIL. LIME SHALL BE DISTRIBUTED UNIFORMLY OVER DESIGNATED AREAS AND WORKED INTO THE SOIL IN CONJUNCTION WITH TILLAGE OPERATIONS AS DESCRIBED IN THE FOLLOWING PROCEDURES

APPLICATION BY APPROVED EQUIPMENT. MANURE MAY BE SUBSTITUTED FOR FERTILIZER WITH PRIOR APPROVAL FROM THE APPROPRIATE APPROVAL AUTHORITY. FERTILIZERS SHALL ALL BE DELIVERED TO THE SITE FULLY LABELED ACCORDING TO THE APPLICABLE STATE FERTILIZER LAWS AND SHALL BEAR THE NAME, TRADE NAME OR TRADEMARK AND WARRANTEE OF THE PRODUCT.

5. LIME MATERIALS SHALL BE GROUND LIMESTONE (HYDRATED OR BURNT LIME MAY BE SUBSTITUTED) WHICH CONTAINS AT LEAST 50% TOTAL OXIDES (CALCIUM OXIDE PLUS MAGNESIUM OXIDE). LIMESTONE SHALL BE GROUND TO SUCH FINENESS THAT AT LEAST 50% WILL PASS THROUGH A #100 MESH SIEVE AND 98-100% WILL PASS THROUGH A #20 MESH SIEVE.

6. INCORPORATE LIME AND FERTILIZER INTO THE TOP 3-5" OF SOIL BY DISKING OR OTHER SUITABLE MEANS.

#### SECTION II: TEMPORARY SEEDING

SEEDING, IF NOT PREVIOUSLY LOOSENED.

VEGETATION - ANNUAL GRASS OF GRAIN USED TO PROVIDE COVER ON DISTURBED AREAS FOR UP TO 12 MONTHS, FOR LONGER DURATION OF VEGETATIVE COVER, PERMANENT SEEDING IS REQUIRED.

APPLY TO GRADED OR CLEARED AREAS LIKELY TO BE RE-DISTURBED WHERE A SHORT-TERM VEGETATIVE COVER IS NEEDED. SEEDBED PREPARATION: -- LOOSEN UPPER THREE INCHES OF SOIL BY RAKING, DISKING OR OTHER ACCEPTABLE MEANS BEFORE

SOIL AMENDMENTS: -- APPLY 600 IBS/ACRE 10-10-10 FERTILIZER (14 IBS/1000 SQ. FT.).

SEEDING: -- FOR PERIODS MARCH 1 -- APRIL 30 AND FROM AUGUST 15 -- OCTOBER 15. SEED WITH 2-1/2 BUSHEL PER ACRE OF ANNUAL RYE (3.2 IBS/1000 SQ. FT.) FOR THE PERIOD MAY 1 -- AUGUST 14, SEED WITH 3 IBS/ACRE OF WEEPING LOVEGRASS

IBS/1000 SQ. FT.), FO~ THE PERIOD NOVEMBER 16 -- FEBRUARY 28, PROTECT SITE BY APPLYING 2 TONS/ACRE OF WELL STRAW MULCH AND SEED AS SOON AS POSSIBLE IN THE SPRING, OR USE SOD.

MULCHING: -- APPLY L-1/2 TO 2 TONS/ACRE (70 TO 90 IBS/1000 SQ. FI) OF UNROTTED WEED-FREE, SMALL GRAIN STRAW HMMEDIATELY AFTER SEEDING, ANCHOR MULCH IMMEDIATELY AFTER APPLICATION USING MULCH ANCHORING TOOL OR 218 GAL. PER ACRE (5 GAL/1000 SQ. FT.) OF EMULSIFIED ASPHALT ON FLAT AREAS. ON SLOPE 8 FT. OR HIGHER, USE 348 GAL, PER ACRE (8

REFER TO THE 1994 MAR4AND STANDARDS AND SPECIFICATIONS FOR SOL EROSION AND SEDIMENT

CONTROL FOR ADDITIONAL RATES AND METHODS NOT COVERED. A. SEED MIXTURES - TEMPORARY SEEDING

#### TEMPORARY SEEDING SUMMARY

	SEED MIXTURE (FOR HARDINES	5 ZUNE 6D) (FROM TABLE 2	26)		FERTILIZER RATE	LIME
NO.	SPECIES	APPLICATION RATE (LB/1000SF)	SEEDING DATES	SEEDING DEPTHS	(10 - 10 - 10)	RATE
	RYE	3 22	2/1 TO 4/30 8/15 TO 11/30	1 - 2	600 LB/AC (15 LB/1000 SF)	2 TONS/AC (100 LB/1000 SF)
	WEEPING LOVEGRASS	0.09	5/1 - 8/14	1/4 - 1/2		

#### SECTION III: PERMANENT SEEDING

SEEDING GRASS AND LEGUMES TO ESTABLISH GROUND COVER FOR A MINIMUM PERIOD OF ONE YEAR ON DISTURBED AREAS GENERALLY RECEIVING LOW MAINTENANCE

APPLY TO GRADED OR CLEARED AREAS NOT SUBJECT TO IMMEDIATE FURTHER DISTURBANCE WHERE A PERMANENT LONG-LIVED VEGETATIVE COVER IS NEEDED

SEEDBED PREPARATION: LOOSEN UPPER THREE INCHES OF SOIL BY RAKING, DISKING OR OTHER ACCEPTABLE MEANS BEFORE SEEDING, IF NOT PREVIOUSLY LOOSENED.

SOIL AMENDMENTS: IN LIEU OF SOIL TEST RECOMMENDATIONS, USE ONE OF THE FOLLOWING SCHEDULES:

1. PREFERRED -- APPLY 2 TONS/ACRE DOLOMITIC LIMESTONE (92 IBS/1000 SQ. FT.) AND 600 IBS/ACRE 10-10-10 FERTILIZER (14 IBS/1000 SQ. FT.) BEFORE SEEDING, HARROW OR DISK INTO UPPER THREE INCHES OF SOIL, AT TIME OF SEEDING, APPLY 400 IBS/ACRE 30-0-0 UREAFORM FERTILIZER (9 IBS/1000 SQ. FT.)

2. ACCEPTABLE -- APPLY 2 TONS/ACRE DOLOMITIC LIMESTONE (92 IBS/1000 SQ. FT.) AND 1000 IBS/ACRE 10-10-10 FERTILIZER (23 IBS/1000 SQ. FT.) BEFORE SEEDING, HARROW OR DISK INTO UPPER THREE INCHES OF SOIL.

SEEDING -- FOR THE PERIODS MARCH 1 -- APRIL 30, AND AUGUST 1 -- DCTOBER 15, SEED WITH 60 IBS/ACRE (1.4 IBS/1000 SO, FT.) OF KENTUCKY 31 TALL FESCUE FOR THE PERIOD MAY 1 -- JULY 31, SEED WITH 60 IBS KENTUCKY 31 TALL FESCUE PER ACRE AND 2 IBS/ACRE (.05 IBS/100() SQ. FT.) OF WEEPING LOVEGRASS. DURING THE PERIOD OF OCTOBER 16 --FEBRUARY 28, PROTECT SITE BY:

OPTION 1 -- TWO TONS PER ACRE OF WELL ANCHORED STRAW MULCH AND SEED AS SOON AS POSSIBLE IN THE SPRING. OPTION 2 -- USE SOD. OPTION 3 --- SEER: WITH 60 IBS/ACRE KENTUCKY 30 TALL FESCUE AND MULCH WITH 2 TONS/ACRE WELL ANCHORED STRAW.

MULCHING -- APPLY 1-1/2 TO 2 TONS PER ACRE (70 TO 90 IBS/1000 SQ. FT.) OF UNROTTED SMALL GRAIN STRAW IMMEDIATELY AFTER SEEDING, ANCHOR MULCH IMMEDIATELY AFTER APPLICATION USING MULCH ANCHORING TOOL OR 218 GALLONS PER ACRE (5 GAL/1000 SQ. FT.) OF EMULSIFIED ASPHALT ON FLAT AREAS. ON SLOPE 8 FEET OR HIGHER, USE 348 GALLONS PER ACRE (8 GAL/1000 SQ. FT.) FOR ANCHORING.

MAINTENANCE -- INSPECT ALL SEEDING AREAS AND MAKE NEEDED REPAIRS, REPLACEMENTS AND RESEEDINGS.

A. SEED MIXTURES - PERMANENT SEEDING

III. FOR AREAS RECEIVING LOW MAINTENANCE, APPLY UREAFORM FERTILIZER (46-0-0) AT 3 1/2 LBS/1000 SQ.FT. (150 IBS/AC), IN ADDITION TO THE ABOVE SOIL AMENOMENTS SHOWN IN THE TABLE BELOW, TO BE PERFORMED AT THE TIME OF SEEDING.

#### PERMANENT SEEDING SUMMARY

	SEED MIXTURE (FOR HARDINESS	ZONE 6b) (FROM TABLE 2	:5)			ERTILIZER RA 10 - 20 - 3		LIME
NO	SPECIES	APPLICATION RATE (LB/1000SF)	SEEDING DATES	SEEDING DEPTHS	N	P205	K20	RATE
1	TALL FESCUE (83%) WEEPING LOVEGRASS (2%) PLUS SERECIA LESPEDEZA (15%)	2.5 0.07 0.46	3/1 TO 5/15 5/16 TO 8/14 8/15 TO 10/15	1/4 - 1/2	90 LB/AC (2 L8/ 1000 SF)	175 LB/AC (4 LB/ 1000 SF)	175 LB/AC (4 LB/ 1000 SF)	2 TONS/AC (100 LB/ 1000 SF)

# **SEDIMENT CONTROL NOTES:**

1. A MINIMUM OF 48 HOURS NOTICE MUST BE GIVEN TO THE HOWARD COUNTY DEPARTMENT OF INSPECTIONS, LICENSES AND PERMITS, SEDIMENT CONTROL DIVISION PRIOR TO THE START OF ANY CONSTRUCTION (313-1855).

2. ALL VEGETATIVE AND STRUCTURAL PRACTICES ARE TO BE INSTALLED ACCORDING TO THE PROVISIONS OF THIS PLAN AND ARE TO BE IN CONFORMANCE WITH THE MOST CURRENT MARYLAND STANDARDS AND SPECIFICATIONS FOR SOIL EROSION AND SEDIMENT CONTROL AND REVISIONS THERETO.

3. FOLLOWING INITIAL SOIL DISTURBANCE OR RE-DISTURBANCE, PERMANENT OR TEMPORARY STABILIZATION SHALL BE COMPLETED WITHIN: A) 7 CALENDAR DAYS FOR ALL PERIMETER SEDIMENT CONTROL STRUCTURES, DIKES, PERIMETER SLOPES AND ALL SLOPES CREATER THAN 3:1, B) 14 DAYS AS TO ALL OTHER DISTURBED OR GRADED AREAS ON THE

4 ALL SEDIMENT TRAPS/BASINS SHOWN MUST BE FENCED AND WARNING SIGNS POSTED AROUND THEIR PERIMETER IN ACCORDANCE WITH VOL 1, CHAPTER 12 OF THE HOWARD COUNTY DESIGN MANUAL, STORM DRAINAGE.

5. ALL DISTURBED AREAS MUST BE STABILIZED WITHIN THE TIME PERIOD SPECIFIED ABOVE IN ACCORDANCE WITH THE 1994 MARYLAND STANDARDS AND SPECIFICATIONS FOR SOIL EROSION AND SEDIMENT CONTROL FOR PERMANENT SEEDING (SEC. 51), SOD (SEC. 54), TEMPORARY SEEDING (SEC. 50) AND MULCHING (SEC. 52) TEMPORARY STABILIZATION WITH MULCH ALONE CAN ONLY BE DONE WHEN RECOMMENDED SEEDING DATES DO NOT ALLOW FOR PROPER GERMINATION AND ESTABLISHMENT OF GRASSES.

6. ALL SEDIMENT CONTROL STRUCTURES ARE TO REMAIN IN PLACE AND ARE TO BE MAINTAINED IN OPERATIVE CONDITION UNTIL PERMISSION FOR THEIR REMOVAL HAS BEEN OBTAINED FROM THE HOWARD COUNTY SEDIMENT CONTROL INSPECTOR.

TOTAL AREA OF SITE AREA DISTURBED AREA TO BE ROOFED OR PAVED AREA TO BE VEGETATIVELY STABILIZED TOTAL CUT TOTAL FILE

\_\_\_0 85\_\_\_ACRES \_0.41\_\_\_ACRES \_\_\_0.44\_\_\_ACRES \_\_\_\_355\_\_\_CU. YOS. \_\_355\_\_ CU. YDS. OFFSITE WASTE/BORROW AREA LOCATION. GRAVEL SUPPLY QUARRY

8. ANY SEDIMENT CONTROL PRACTICE WHICH IS DISTURBED BY GRADING ACTIVITY FOR PLACEMENT OF UTILITIES MUST BE REPAIRED ON THE SAME DAY OF DISTURBANCE.

9. ADDITIONAL SEDIMENT CONTROL MUST BE PROVIDED, IF DEEMED NECESSARY BY THE HOWARD COUNTY SEDIMENT CONTROL INSPECTOR.

10. ON ALL SITES WITH DISTURBED AREAS IN EXCESS OF 2 ACRES, APPROVAL OF THE INSPECTION AGENCY SHALL BE REQUESTED UPON COMPLETION OF INSTALLATION OF PERIMETER EROSION AND SEDIMENT CONTROLS, BUT BEFORE PROCEEDING WITH ANY OTHER EARTH DISTURBANCE OR GRADING. OTHER BUILDING OR GRADING INSPECTION APPROVALS MAY NOT BE AUTHORIZED UNTIL THIS INITIAL APPROVAL BY THE INSPECTION AGENCY IS MADE.

1. TRENCHES FOR THE CONSTRUCTION OF UTILITIES IS LIMITED TO THREE PIPE LENGTHS OR THAT WHICH SHALL BE BACK-FILLED AND STABILIZED BY THE END OF EACH WORK DAY, WHICHEVER IS SHORTER.



1575 Eye Street, N.W. Suite 350 WASHINGTON, D.C. 20005 PHONE: (202)408-0960 FAX: (202)408-0961


#### **REVISION BLOCK**

DESCRIPTION DATE 10-29-03 CONSTRUCTION REVIEW 12-02-03 CONSTRUCTION

12-17-03 SITE DEVELOPMENT PLAN 03-17-04 COUNTY COMMENTS

05-11-04 COUNTY COMMENTS 05-26-04 COUNTY COMMENTS

6-16-04 SDP SIGNATURE SET

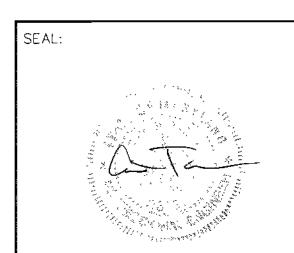



APC REALTY AND

**EQUIPMENT CO., LLC** 

22 Jun sooy

**SPRINT PCS** 

CAPITAL DISTRICT

PROJECT NO: 1015.188 В.М. DESIGNER:

Reviewed for Howard SCD and meets Technical Requirements

THIS DEVELOPMENT PLAN IS APPROVED FOR SOIL EROSION AND SEDIMENT CONTROL

ENGINEER'S CERTIFICATE

I certify that this plan for sediment and erosion control represents a practical and workable plan

based on my personal knowledge of the site conditions and that it was prepared in accordance with

DEVELOPER'S CERTIFICATE

"I/We certify that all development and construction will be done according to this plan for sediment and erosion control, and that all responsible personnel involved in the construction project will have a

Certificate of Attendence at a Department of the Environment Approved Training Program for the Control of Sediment and Erosion before beginning the project. I also outhorize periodic on—site

(e/22/2004)

Matural Resources Conservation Service

BY THE HOWARD COUNTY SOIL CONSERVATION DISTRICT.

the requirements of the Howard Soil Conservation District."

Signature of Engineer (print name below signature)

inspection by the Howard Spil Conservation District."

Signature of developer (print name below signature)

NGINEER:


GRAPHIC SCALE IN INCHES


M.M.

ROY A. ZIMMERMAN **WA54XC473C** 8282 MURPHY ROAD

**CIVIL NOTES** 

8 OF 13 SHEET NUMBER:

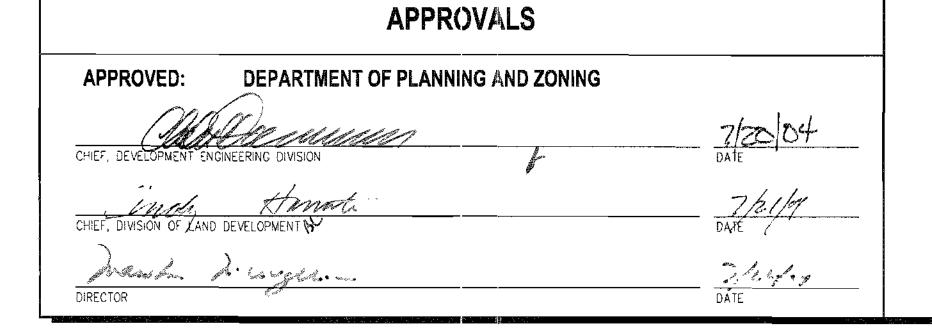

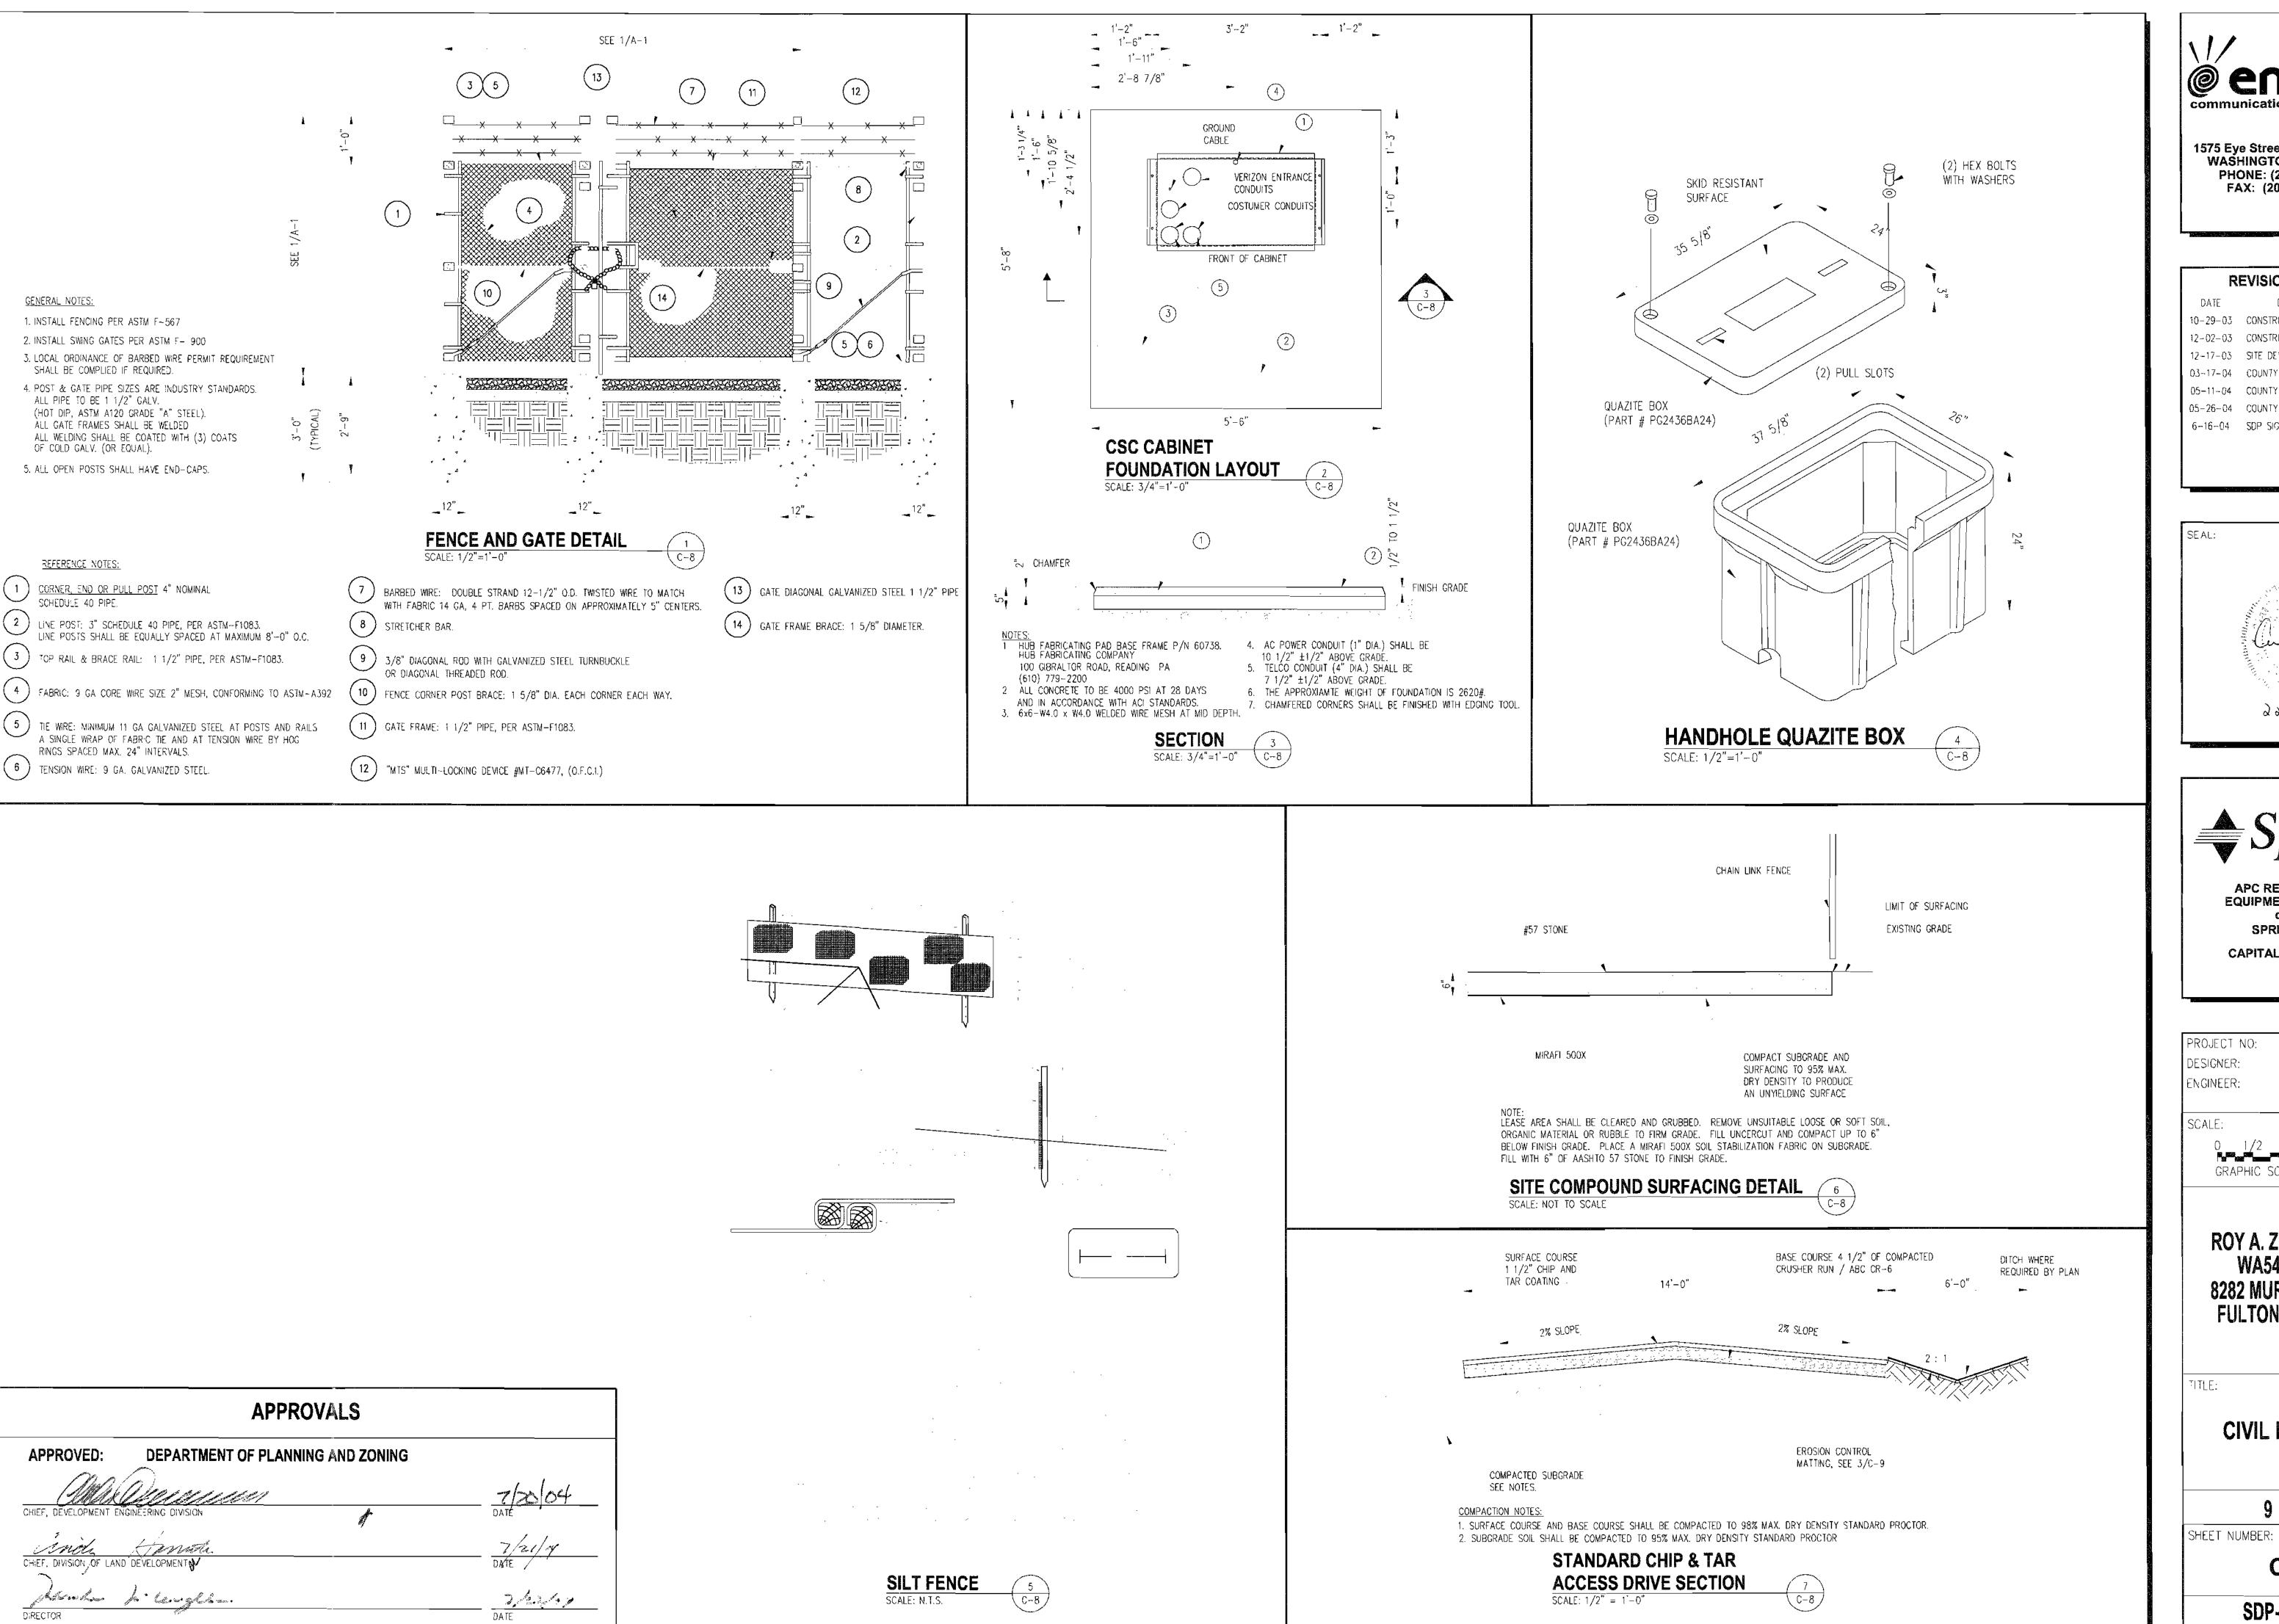



#### **REVISION BLOCK**

DESCRIPTION 10-29-03 CONSTRUCTION REVIEW 12-02-03 CONSTRUCTION 12-17-03 SITE DEVELOPMENT PLAN 03-17-04 COUNTY COMMENTS 05-11-04 COUNTY COMMENTS 05-26-04 COUNTY COMMENTS 6-16-04 SDP SIGNATURE SET





**EQUIPMENT CO., LLC** SPRINT PCS **CAPITAL DISTRICT** 

APC REALTY AND

PROJECT NO: 1015.188 DESIGNER: В.М. ENGINEER:


GRAPHIC SCALE IN INCHES

**ROY A. ZIMMERMAN WA54XC473C** 8282 MURPHY ROAD **FULTON, MD 20759** 

**CIVIL DETAILS** 

9 OF 13


C-8

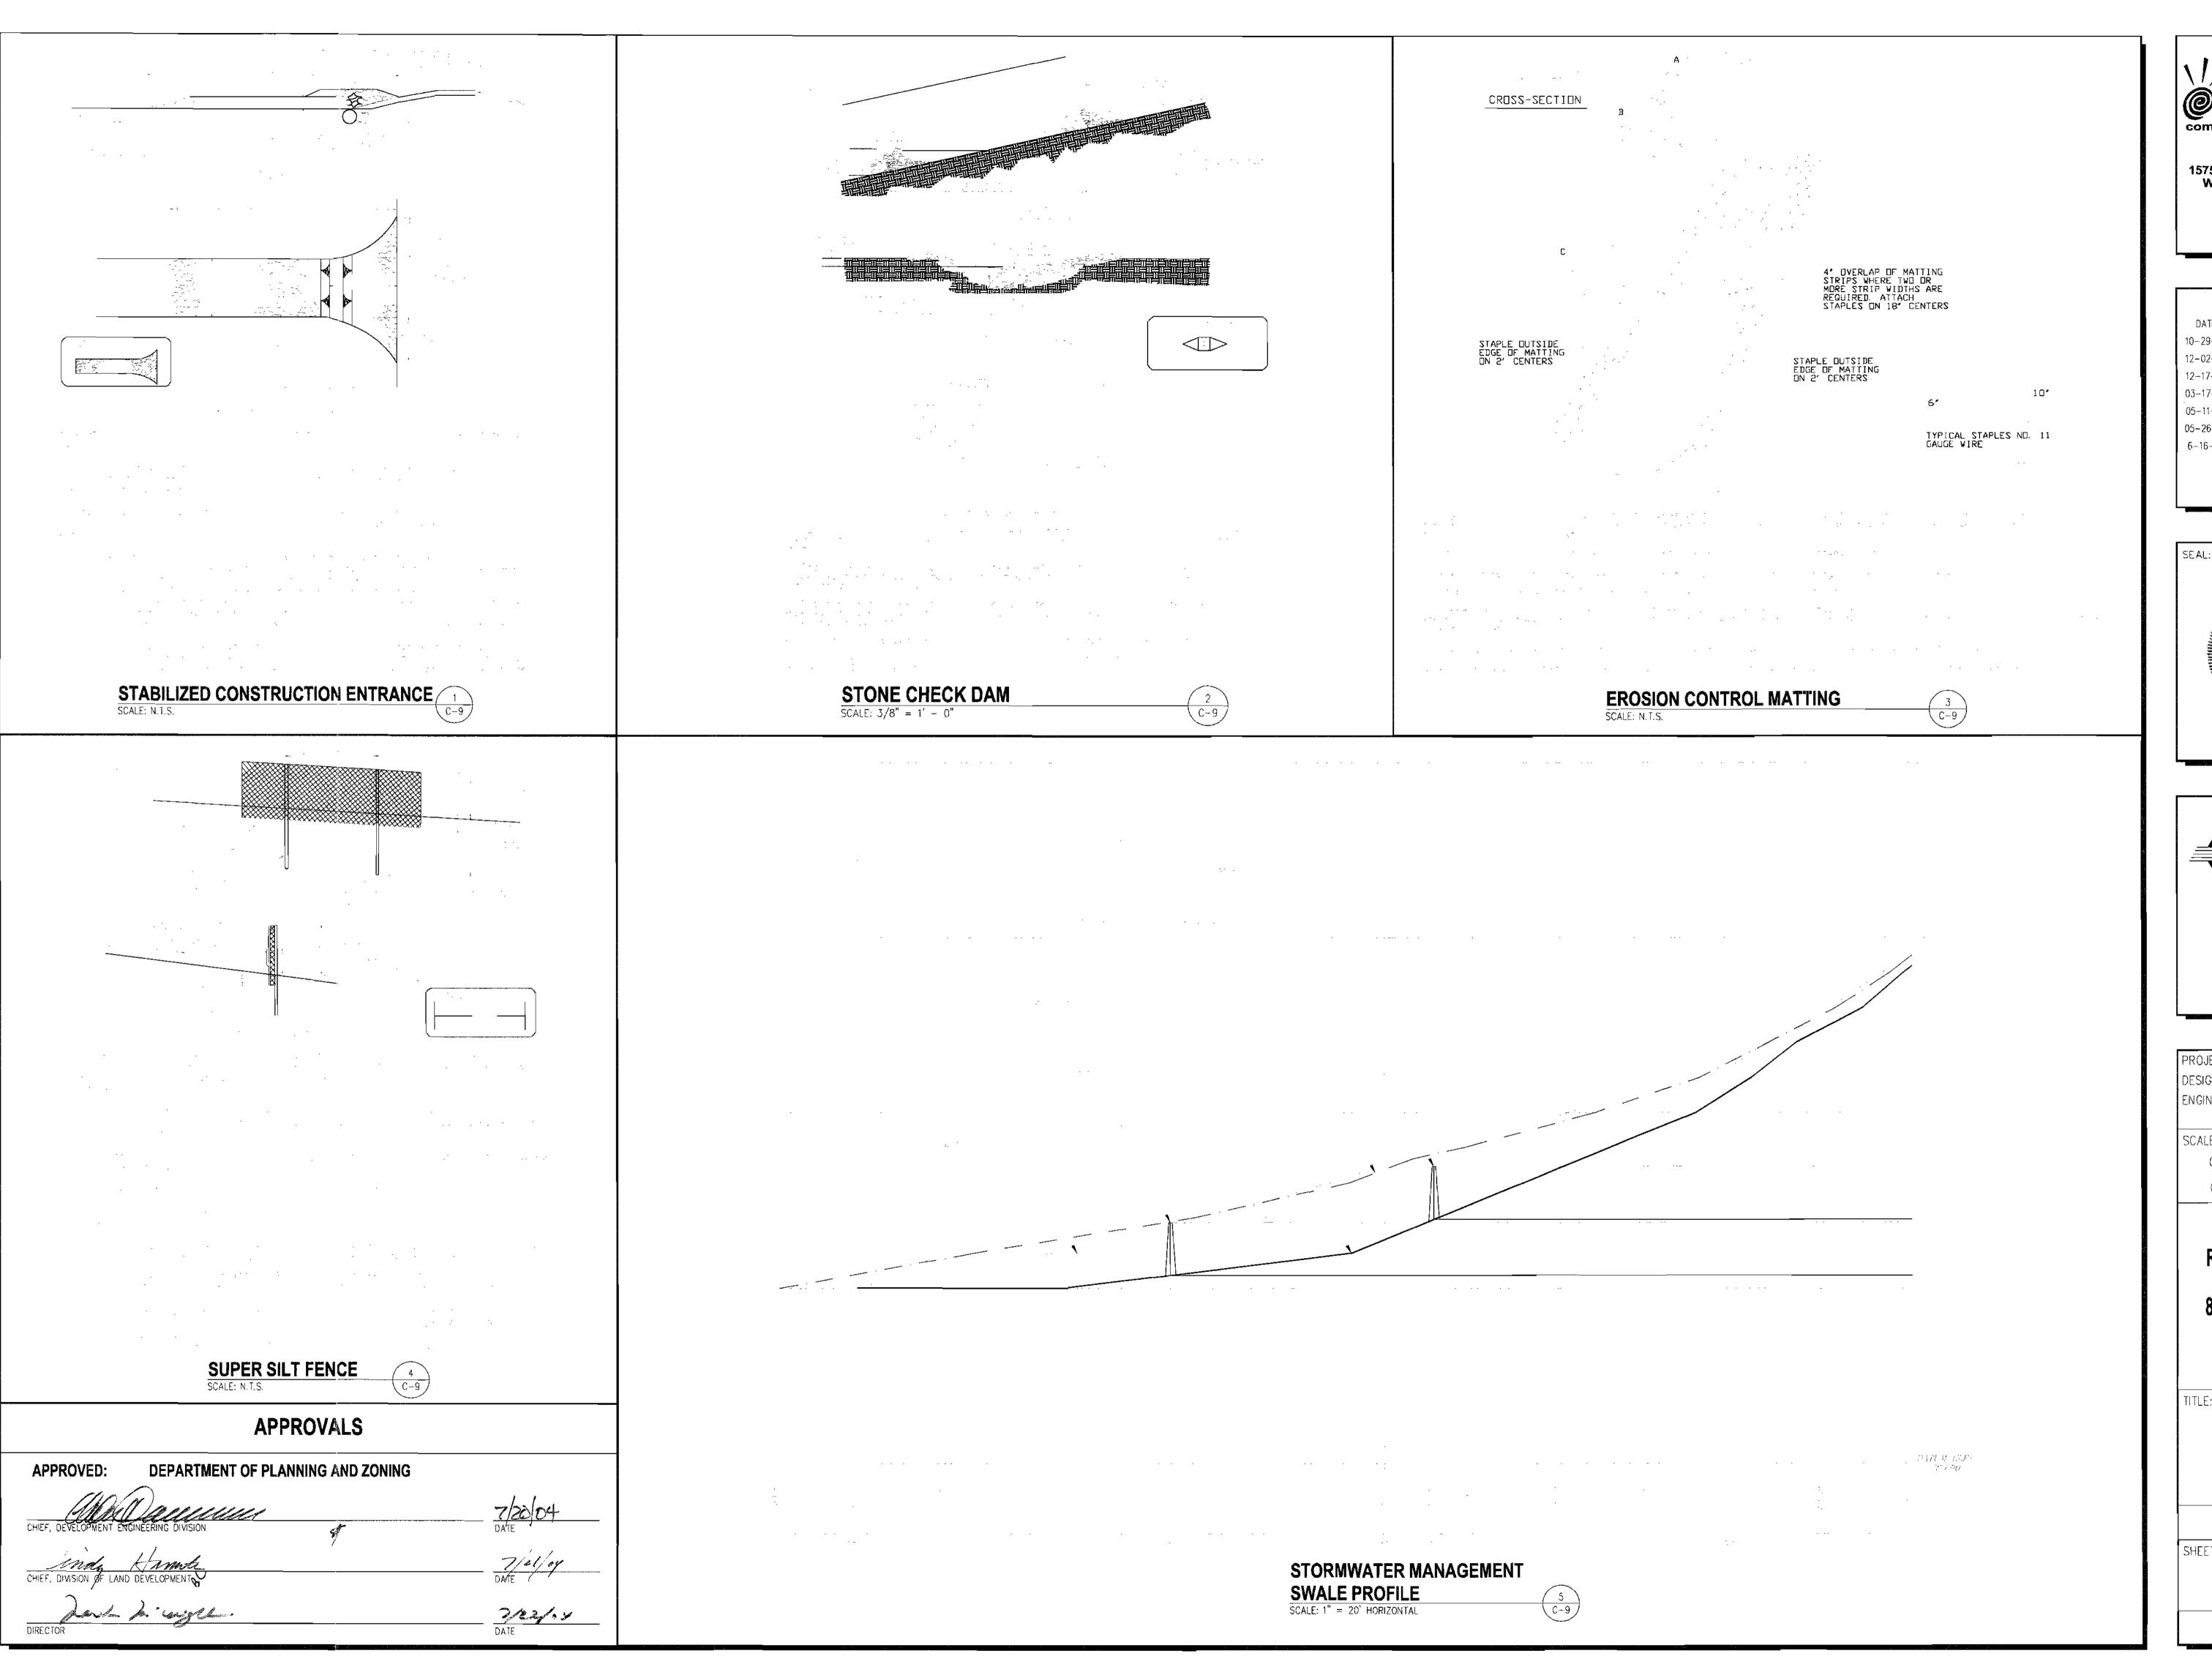



## **REVISION BLOCK**

DATE DESCRIPTION 10-29-03 CONSTRUCTION REVIEW 12-02-03 CONSTRUCTION 12-17-03 SITE DEVELOPMENT PLAN 03-17-04 COUNTY COMMENTS 05-11-04 COUNTY COMMENTS 05-26-04 COUNTY COMMENTS 6-16-04 SDP SIGNATURE SET

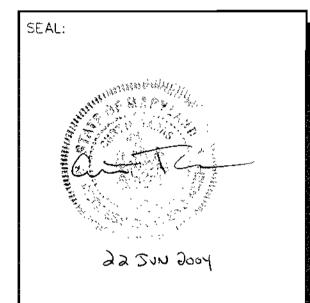



**EQUIPMENT CO., LLC** SPRINT PCS CAPITAL DISTRICT

APC REALTY AND

1015.188 ENGINEER:

ROY A. ZIMMERMAN **WA54XC473C** 8282 MURPHY ROAD **FULTON, MD 20759** 

**CIVIL DETAILS** 

10 OF 13

SHEET NUMBER:

C-9

# FOREST CONSERVATION CALCULATIONS

BASIC SITE DATA	ACRES (1/10)
GROSS SITE AREA	97.68
AREA WITHIN 100 YEAR FLOODPLAIN	0.00
AREA TO REMAIN IN AGRICULTURAL USE	96.83
NET TRACT AREA	0.85
LAND USE CATEGORY	CIA C∐MMERCIAL

#### INFORMATION FOR CALCULATIONS

A. NET TRACT AREA B. REFORESTATION THRESHOLD (15% × A) C. AFFORESTATION MINIMUM (15% × A) D. EXISTING FOREST ON NET TRACT AREA E. FOREST AREAS TO BE CLEARED F. FOREST AREAS TO BE RETAINED	0.85 0.13 0.13 0.00 0.00
AFFORESTATION CALCULATIONS	6.00
A. NET TRACT AREA	n 85

#### D. FOREST AREAS TO BE CLEARED E. FOREST AREAS TO BE RETAINED

NO CLEARING BELOW THE MINIMUM

B. AFFORESTATION THRESHOLD (15% x A)

EXISTING FOREST ON NET TRACT AREA

IF EXISTING FOREST AREAS ARE LESS THAN THE AFFORESTATION MINIMUM (IF C IS LESS THAN B) AND NO CLEARING IS PROPOSED, THE FOLLOWING CALCULATIONS APPLY:

#### TOTAL AFFORESTATION REQUIRED 0.13 AFFORESTATION PROVIDED ON-SITE 0.00 FEE-IN-LIEU PROVIDED FOR


#### GOALS AND OBJECTIVES

THE GOALS AND OBJECTIVES OF THIS FOREST CONSERVATION PLAN ARE TO CONFIRM THAT NO FOREST RESOURCES ARE LOCATED ON THE AREA OF DEVELOPMENT, WHICH IS DESCRIBED AS THE AREA WITHIN THE LIMIT OF DISTURBANCE. NO FOREST CLEARING OR RETENTION IS PROPOSED, AND AN AFFORESTATION REQUIREMENT OF 0.13 ACRES IS REQUIRED. THIS OBLIGATION WILL BE SATISFIED BY A FEE-IN-LIEU PAYMENT OF \$2,831.40.

#### DEVELOPERS/BUILDERS CERTIFICATE

I/WE CERTIFY THAT THE LANDSCAPING SHOWN ON THIS PLAN WILL BE DONE ACCORDING TO THE PLAN, SECTION 16.124 OF THE HOWARD COUNTY CODE AND THE HOWARD COUNTY LANDSCAPE MANUAL I/WE FURTHER CERTIFY THAT UPON COMPLATION A CERTIFICATION OF LANDSCAPE INSTALLATION, ACCOMPANIED BY AN EXECUTED ONE YEAR GUARANTEE OF PLANT MATERIALS, WILL BE SUBMITTED TO THE DEPARTMENT OF PLANNING AND ZONING.



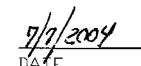

0.13

0.00

0.00

0.00

# OPTION 1 FEE-IN-LIEU

FILE NUMBER: SDP-04-088 PROJECT/SUBDIVISION NAME: SPRINT PCS @ ZIMMERMAN PROPERTY

FEE-IN-LIEU AMOUNT: \$2,831.40 NET TRACT AREA: 0.85 AC AREA OF DISTURBANCE: 0.77 AC


CASH RECEIPT NO.\*:

WATERSHED: 2-13-11-07

COMMENT: FEE-IN-LIEU FOR \_\_013\_\_ ACRES OF AFFORESTATION (SPECIFY WHICH IS APPICABLE)


\*TO BE COMPLETED BY DPZ STAFF

APPROVALS		
APPROVED: DEPARTMENT OF PLANNING AND ZONING		
CHIEF, DEVELOPMENT ENGINEERING DIVISION		7/20/04 DATE
CHIEF, DIVISION OF LAND DEVELOPMENT		7/21/mg DATE (
DIRECTOR		DATE

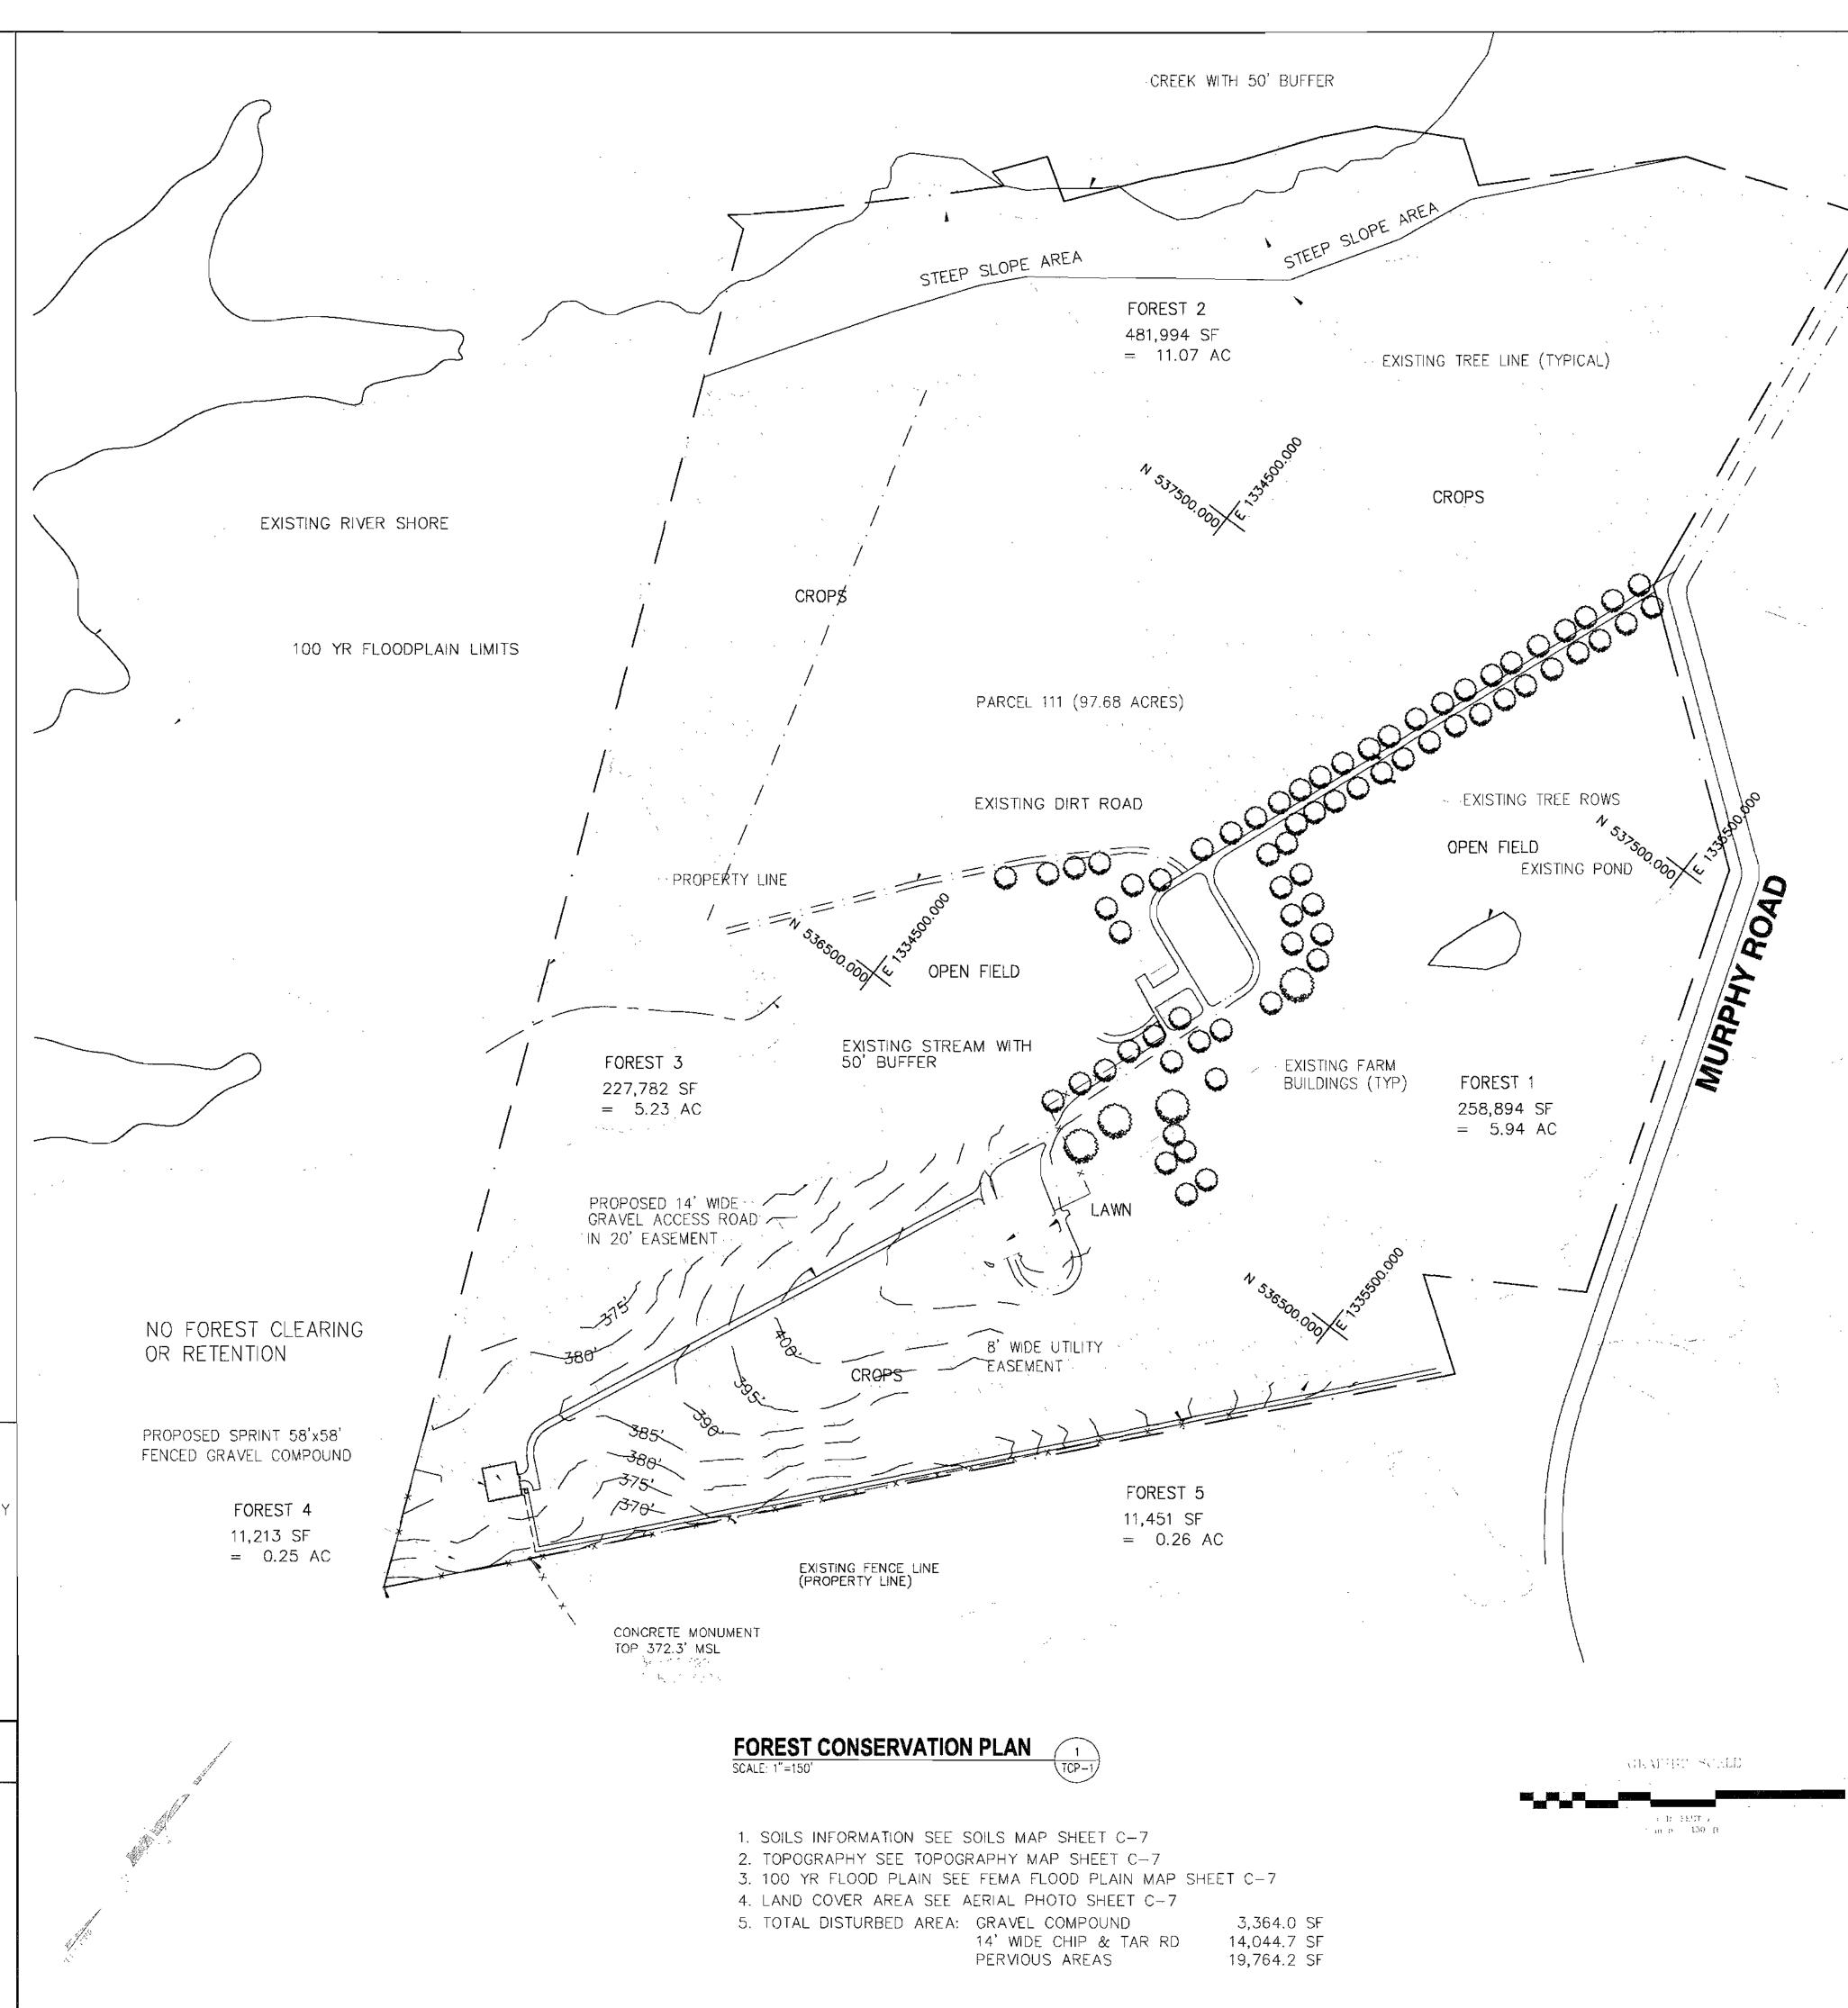




1575 Eye Street, N.W. Suite 350 WASHINGTON, D.C. 20005 PHONE: (202)408-0960 FAX: (202)408-0961

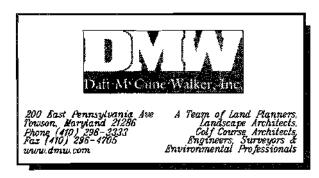

SUBMITTALS

DESCRIPTION 12-17-03 SITE DEVELOPMENT PLAN 03-17-04 COUNTY COMMENTS 07-01-04 MYLAR EDITS

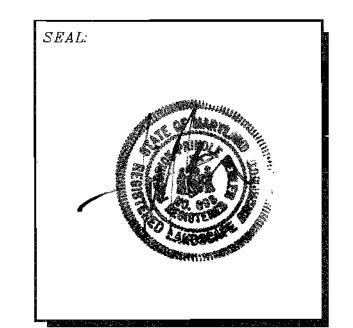



APC REALTY AND **EQUIPMENT COMPANY, LLC** SPRINT PCS

**CAPITAL DISTRICT** 

PROJECT NO: 1015.188 DESIGNER: R.S.

ENGINEER: M.M.

SCALE:

GRAPHIC SCALE IN INCHES

**ROY A. ZIMMERMAN WA54XC473C** 8282 MURPHY ROAD **FULTON, MD 20759** 

TITLE:

**FOREST** CONSERVATION PLAN

11 OF 13

SHEET NUMBER:

TCP-1

# PERIMETER LANDSCAPING REQUIREMENTS

LANDSCAPING IS REQUIRED FOR THE PROPOSED COMPOUND PERIMETER CNLY PER THE HOWARD COUNTY LANDSCAPE MANUAL, CHAPTER II TITLED "GENERAL INFORMATION". THIS SECTION STATES THAT AN EXPANSION THAT INCREASES THE NON-RESIDENTIAL BUILDING SPACE BY LESS THAN 50% SHALL BE REQUIRED TO PROVIDE LANSCAPING FOR THE ADDITIONAL DEVELOPMENT ONLY

PARCEL ZONING: RR-DEO EXISTING USE: AGRICULTURAL

PROPOSED USE: AGRICULTURAL WITH SPECIAL EXCEPTION FOR

TELECOMMUNICATIONS COMPOUND AND MONOPOLE.

PERIMETER OF COMPOUND: PROPOSED LANDSCAPE EDGE TYPE: C (HEAVY BUFFER)

PLANTING REQUIREMENTS: 1 SHADE TREE PER 40 FT = 6 SHADE TREES 1 EVERGREEN TREE PER 20 FT = 12 EVERGREEN TREES

## **GENERAL PLANTING NOTES**

- 1. ALL PLANTS MUST BE HEALTHY, VIGOROUS MATERIAL, FREE OF PESTS AND DISEASE.
- 2. ALL PLANTS MUST BE CONTAINER-GROWN OR BALLED AND BURLAPPED AS SPECIFIED.
- 3. ALL TREES MUST BE STRAIGHT TRUNKED, FULL HEADED AND MEET ALL REQUIREMENTS SPECIFIED.
- 4. ALL PLANTS ARE SUBJECT TO THE APPROVAL OF SPECTRASITE CONSTRUCTION MANAGER BEFORE, DURING AND AFTER INSTALLATION.
- 5. ALL TREES MUST BE GUYED OR STAKED AS SHOWN.
- 6. ALL PLANTS AND PLANTING AREAS MUST BE COMPLETELY MULCHED AS SPECIFIED.
- 7. PRIOR TO CONSTRUCTION, THE CONTRACTOR SHALL BE RESPONSIBLE FOR LOCATING ALL UNDERGROUND UTILITIES AND SHALL AVOID DAMAGE TO ALL UTILITIES DURING COURSE OF THE
- 8. THE CONTRACTOR IS RESPONSIBLE FOR VERIFYING ALL QUANTITIES SHOWN ON THESE PLANS BEFORE PRICING THE WORK.
- 9. THE CONTRACTOR IS RESPONSIBLE FOR FULLY MAINTAINING ALL PLANTING (INCLUDING, BUT NOT LIMITED TO: WATERING, SPRAYING, MULCHING, FERTILIZATION, ETC.) OF PLANTING AREAS AND LAWNS UNTIL THE WORK IS ACCEPTED IN TOTAL BY SPRINT'S REPRESENTATIVE.
- 10. THE CONTRACTOR SHALL COMPLETELY GUARANTEE ALL PLANT MATERIAL FOR A PERIOD OF ONE (1) YEAR BEGINNING AT THE DATE OF THE TOTAL ACCEPTANCE. THE CONTRACTOR SHALL PROMPTLY MAKE ALL REPLACEMENTS BEFORE OR AT THE END OF THE GUARANTEE PERIOD.

WORK. THE CONTRACTOR IS RESPONSIBLE FOR REPAIRING ALL DAMAGE TO UTILITIES, STRUCTURES, SITE APPURTENANCES, ETC. WHICH OCCURS AS A RESULT OF THE LANDSCAPE CONSTRUCTION.

- 11. THE OWNER AGREES TO PERFORM ALL LANDSCAPE MAINTENANCE (INCLUDING WATERING) THROUGHOUT THE ONE-YEAR GUARANTEE PERIOD UNLESS OTHERWISE DETERMINED.
- 12. SPECTRASITE'S REPRESENTATIVE WILL APPROVE THE STAKED LOCATION OF ALL PLANT MATERIAL PRIOR TO INSTALLATION.


AS ALL REQUIRED MATERIALS ARE PLANTED AND/OR REVISIONS ARE MADE TO APPLICABLE PLANS AND CERTIFICATES.

- 13. AFTER BEING DUG AT THE NURSERY SOURCE, ALL TREES IN LEAF SHALL BE ACCLIMATED FOR TWO (2) WEEKS UNDER A MIST SYSTEM PRIOR TO INSTALLATION.
- 14. ANY PLANT MATERIAL THAT DIES, TURNS BROWN OR DEFOLIATES (PRIOR TO TOTAL ACCEPTANCE OF THE WORK) SHALL BE PROMPTLY REMOVED FROM THE SITE AND REPLACED MATERIAL OF WITH THE SAME SPECIES, QUANTITY, SIZE AND MEETING ALL SPECIFICATIONS.
- 15. STANDARDS SET FORTH IN "AMERICAN STANDARD FOR NURSERY STOCK" REPRESENT GUIDELINE SPECIFICATIONS ONLY AND SHALL CONSTITUTE MINIMUM QUALITY REQUIREMENTS FOR PLANT MATERIAL


#### 16. AMENDED AREAS TO CONSIST OF 40% COMPOST AND 60% EXISTING SOIL AND 1/3 AMOUNT OF FERTILIZER APPLICATION RATE RECOMMENDED OF PLANTING. IN A 1:3:2 RATIO FERTILIZER AT TIME IN NOV./DEC. OF THE FOLLOWING YEAR, APPLY FULL PRIMARY AMOUNT OF FERTILIZER.

# **COUNTY LANDSCAPING NOTES**

- 1. THIS PLAN HAS BEEN PREPARED IN ACCORDANCE WITH THE PROVISIONS OF SECTION 16.124 OF THE HOWARD COUNTY CODE AND LANDSCAPE MANUAL.
- 2. SURETY IN THE AMOUNT OF SHADE FOR & SHADE TREES SHALL BE POSTED WITH THE GRADING PERMIT IF A GRADING PERMIT IS REQUIRED FOR THIS SITE.
- 3. AT THE TIME OF INSTALLMENT, ALL SHRUBS AND OTHER PLANTINGS HEREWITH LISTED AND APPROVED FOR THIS SITE, SHALL BE OF THE PROPER HEIGHT REQUIREMENTS IN ACCORDANCE WITH THE HOWARD COUNTY LANDSCAPE MANUAL. IN ADDITION, NO SUBSTITUTIONS OR RELOCATION OF REQUIRED PLANTING MAY BE MADE WITHOUT PRIOR REVIEW AND APPROVAL FROM THE DEPARTMENT OF PLANNING AND ZONING. ANY DEVIATION FROM THIS APPROVED LANDSCAPE PLAN MAY RESULT IN DENIAL OR RELEASE OF LANDSCAPE SURETY UNTIL SUCH TIME

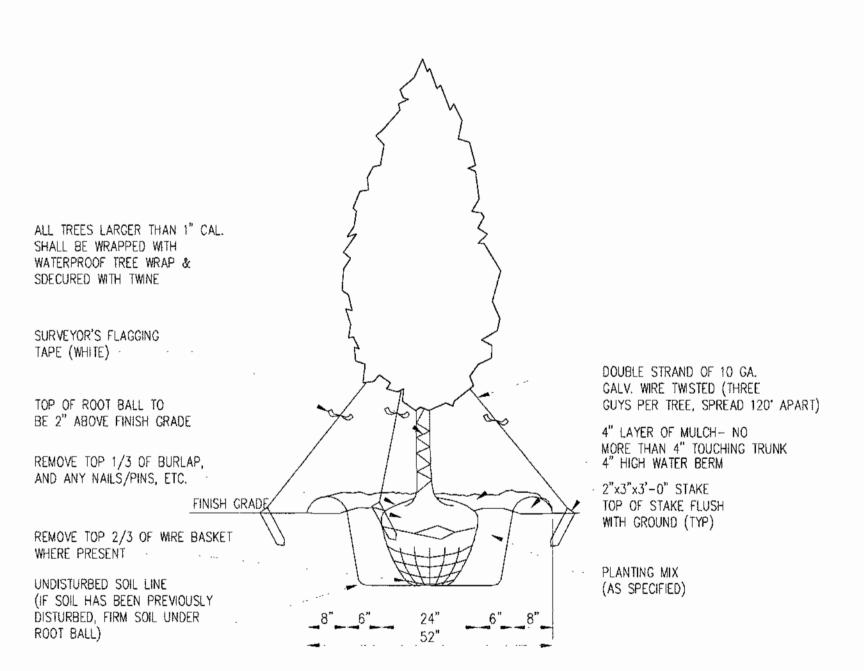



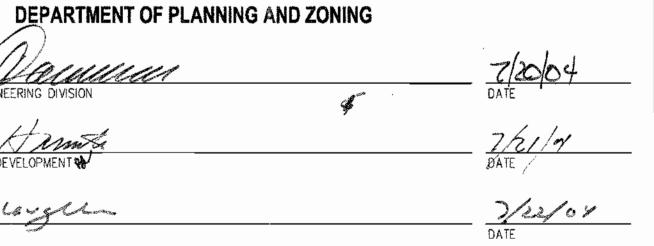


**APPROVALS** 

# **PLANT LIST**

			<b>T</b>	
SYMBOL	NAME	SIZE	QUANTITY	COMMENTS
	RED OAK QUERCUS RUBRA	MIN 2 1/2' CALIPER	6	SEE PLAN
談	LEYLAND CYPRESS	4'-6" TALL (MIN.)	12	PLANT 15'-0" O.C.

# HOWARD COUNTY LANDSCAPE SCHEDULE "A"

CATEGORY	ADJACENT TO ROADWAYS	ADJACENT TO PERIMETER PROPERTIES
LANDSCAPE TYPE	N/A	С
LINEAR FEET OF ROADWAY FRONTAGE/PERIMETER	N/A	240 FT.
CREDITS FOR EXITING VEGETATION (YES, NO, LINEAR FEET)	N/A	NO
CREDITS FOR WALL, FENCE OR BERM (YES, NO, LINEAR FEET)	N/A	NO
NUMBER OF PLANTS REQUIRED SHADE TREES EVERGREEN TREES SHRUBS		6 SHADE 12 EVERGREEN
NUMBER OF PLANTS PROVIDED SHADE TREES EVERGREEN TREES OTHER TREES (2:1 SUBSTITUTION) SHRUBS (10:1 SUBSTITUTION)		6 SHADE 12 EVERGREEN

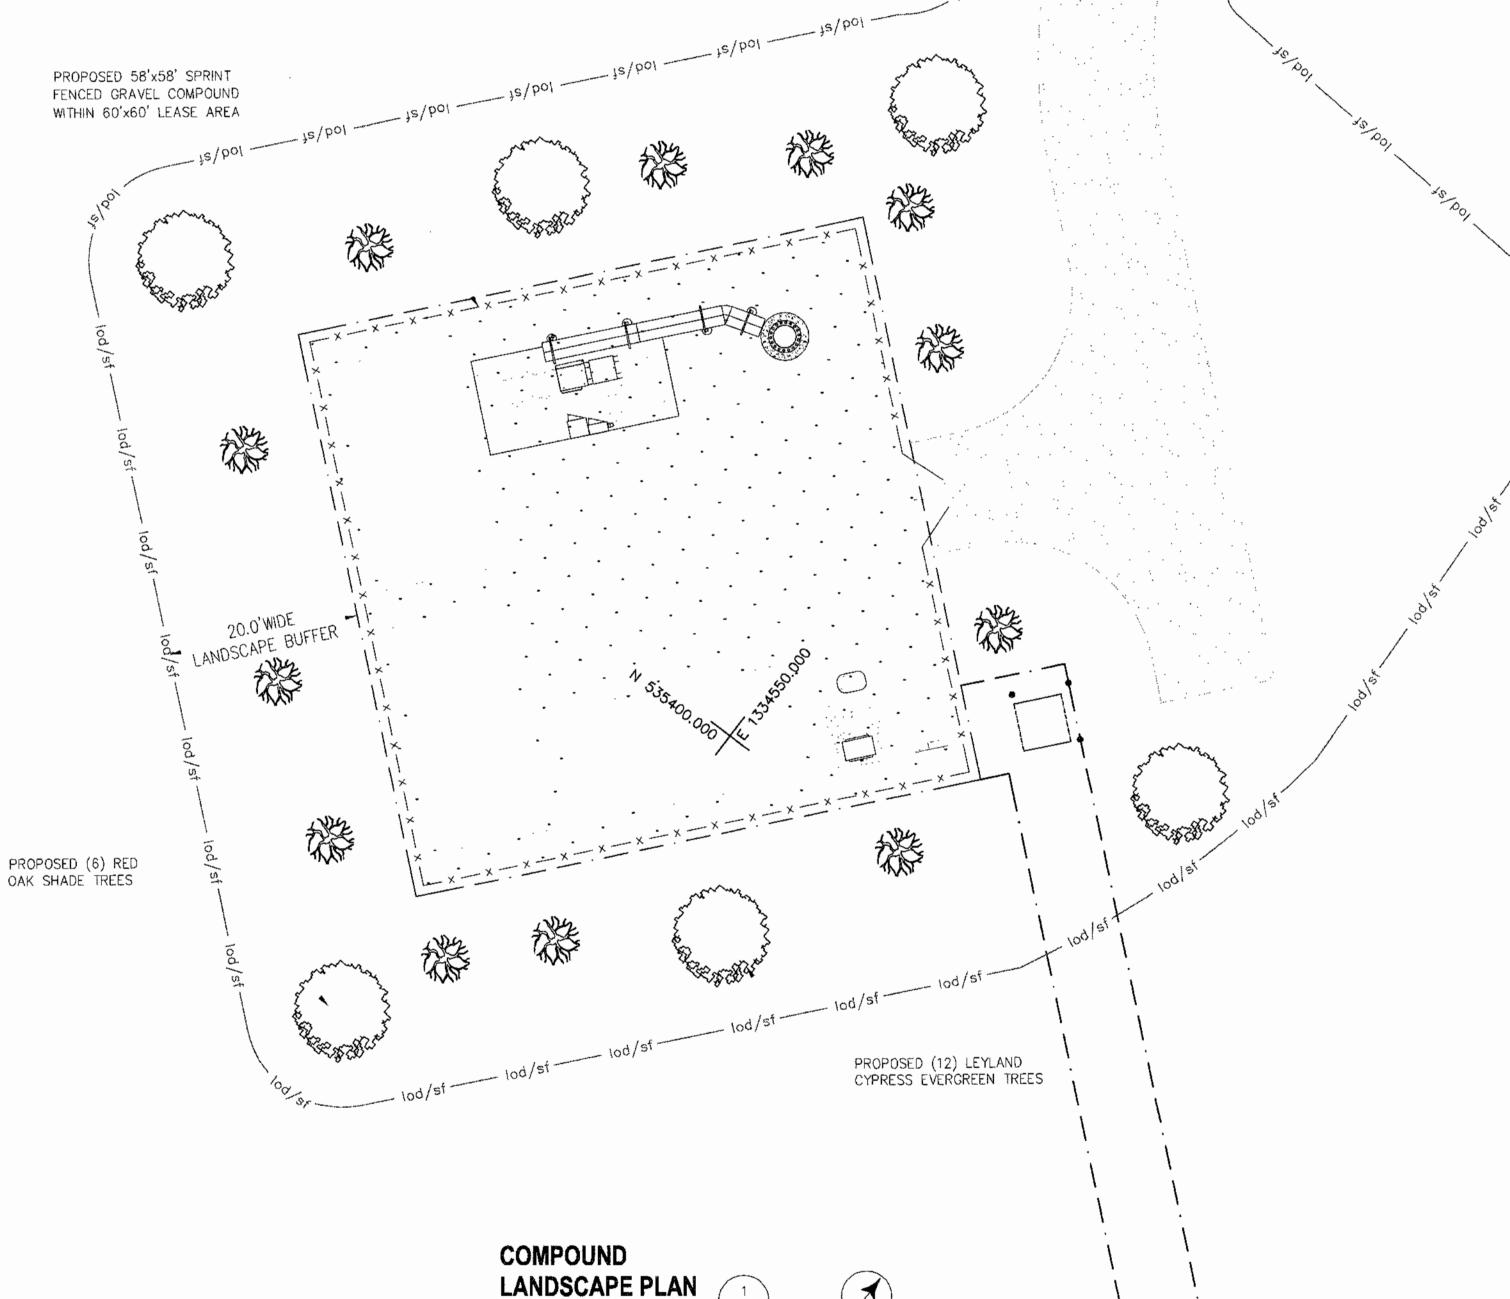

# DEVELOPERS/BUILDERS CERTIFICATE

I/WE CERTIFY THAT THE LANDSCAPING SHOWN ON THIS PLAN WILL BE DONE ACCORDING TO THE PLAN, SECTION 16.124 OF THE HOWARD COUNTY CODE AND THE HOWARD COUNTY LANDSCAPE MANUAL I/WE FURTHER CERTIFY THAT UPON COMPLATION A CERTIFICATION OF LANDSCAPE INSTALLATION, ACCOMPANIED BY AN EXECUTED ONE YEAR GUARANTEE OF PLANT MATERIALS, WILL BE SUBMITTED TO THE DEPARTMENT OF PLANNING AND ZONING.

DATE




1575 Eye Street, N.W. Suite 350 WASHINGTON, D.C. 20005 PHONE: (202)408-0960 FAX: (202)408-0961

#### **REVISION BLOCK**

DESCRIPTION 10-29-03 CONSTRUCTION REVIEW 12-02-03 CONSTRUCTION 12-17-03 SITE DEVELOPMENT PLAN 03-17-04 COUNTY COMMENTS 05-11-04 COUNTY COMMENTS 05-26-04 COUNTY COMMENTS

6-16-04 SDP SIGNATURE SET

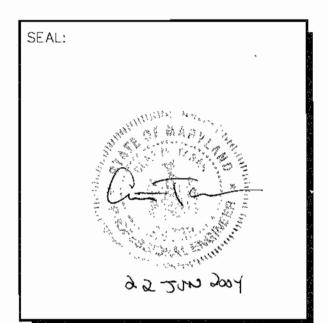



**EQUIPMENT CO., LLC** SPRINT PCS

CAPITAL DISTRICT

APC REALTY AND

PROJECT NO: 1015.188 DESIGNER:

NGINEER:

GRAPHIC SCALE IN INCHES

 $\mathsf{M}.\mathsf{M}.$ 


ROY A. ZIMMERMAN **WA54XC473C** 8282 MURPHY ROAD **FULTON, MD 20759** 


LANDSCAPING **PLAN** 

12 OF 13

SHEET NUMBER:

LS-1

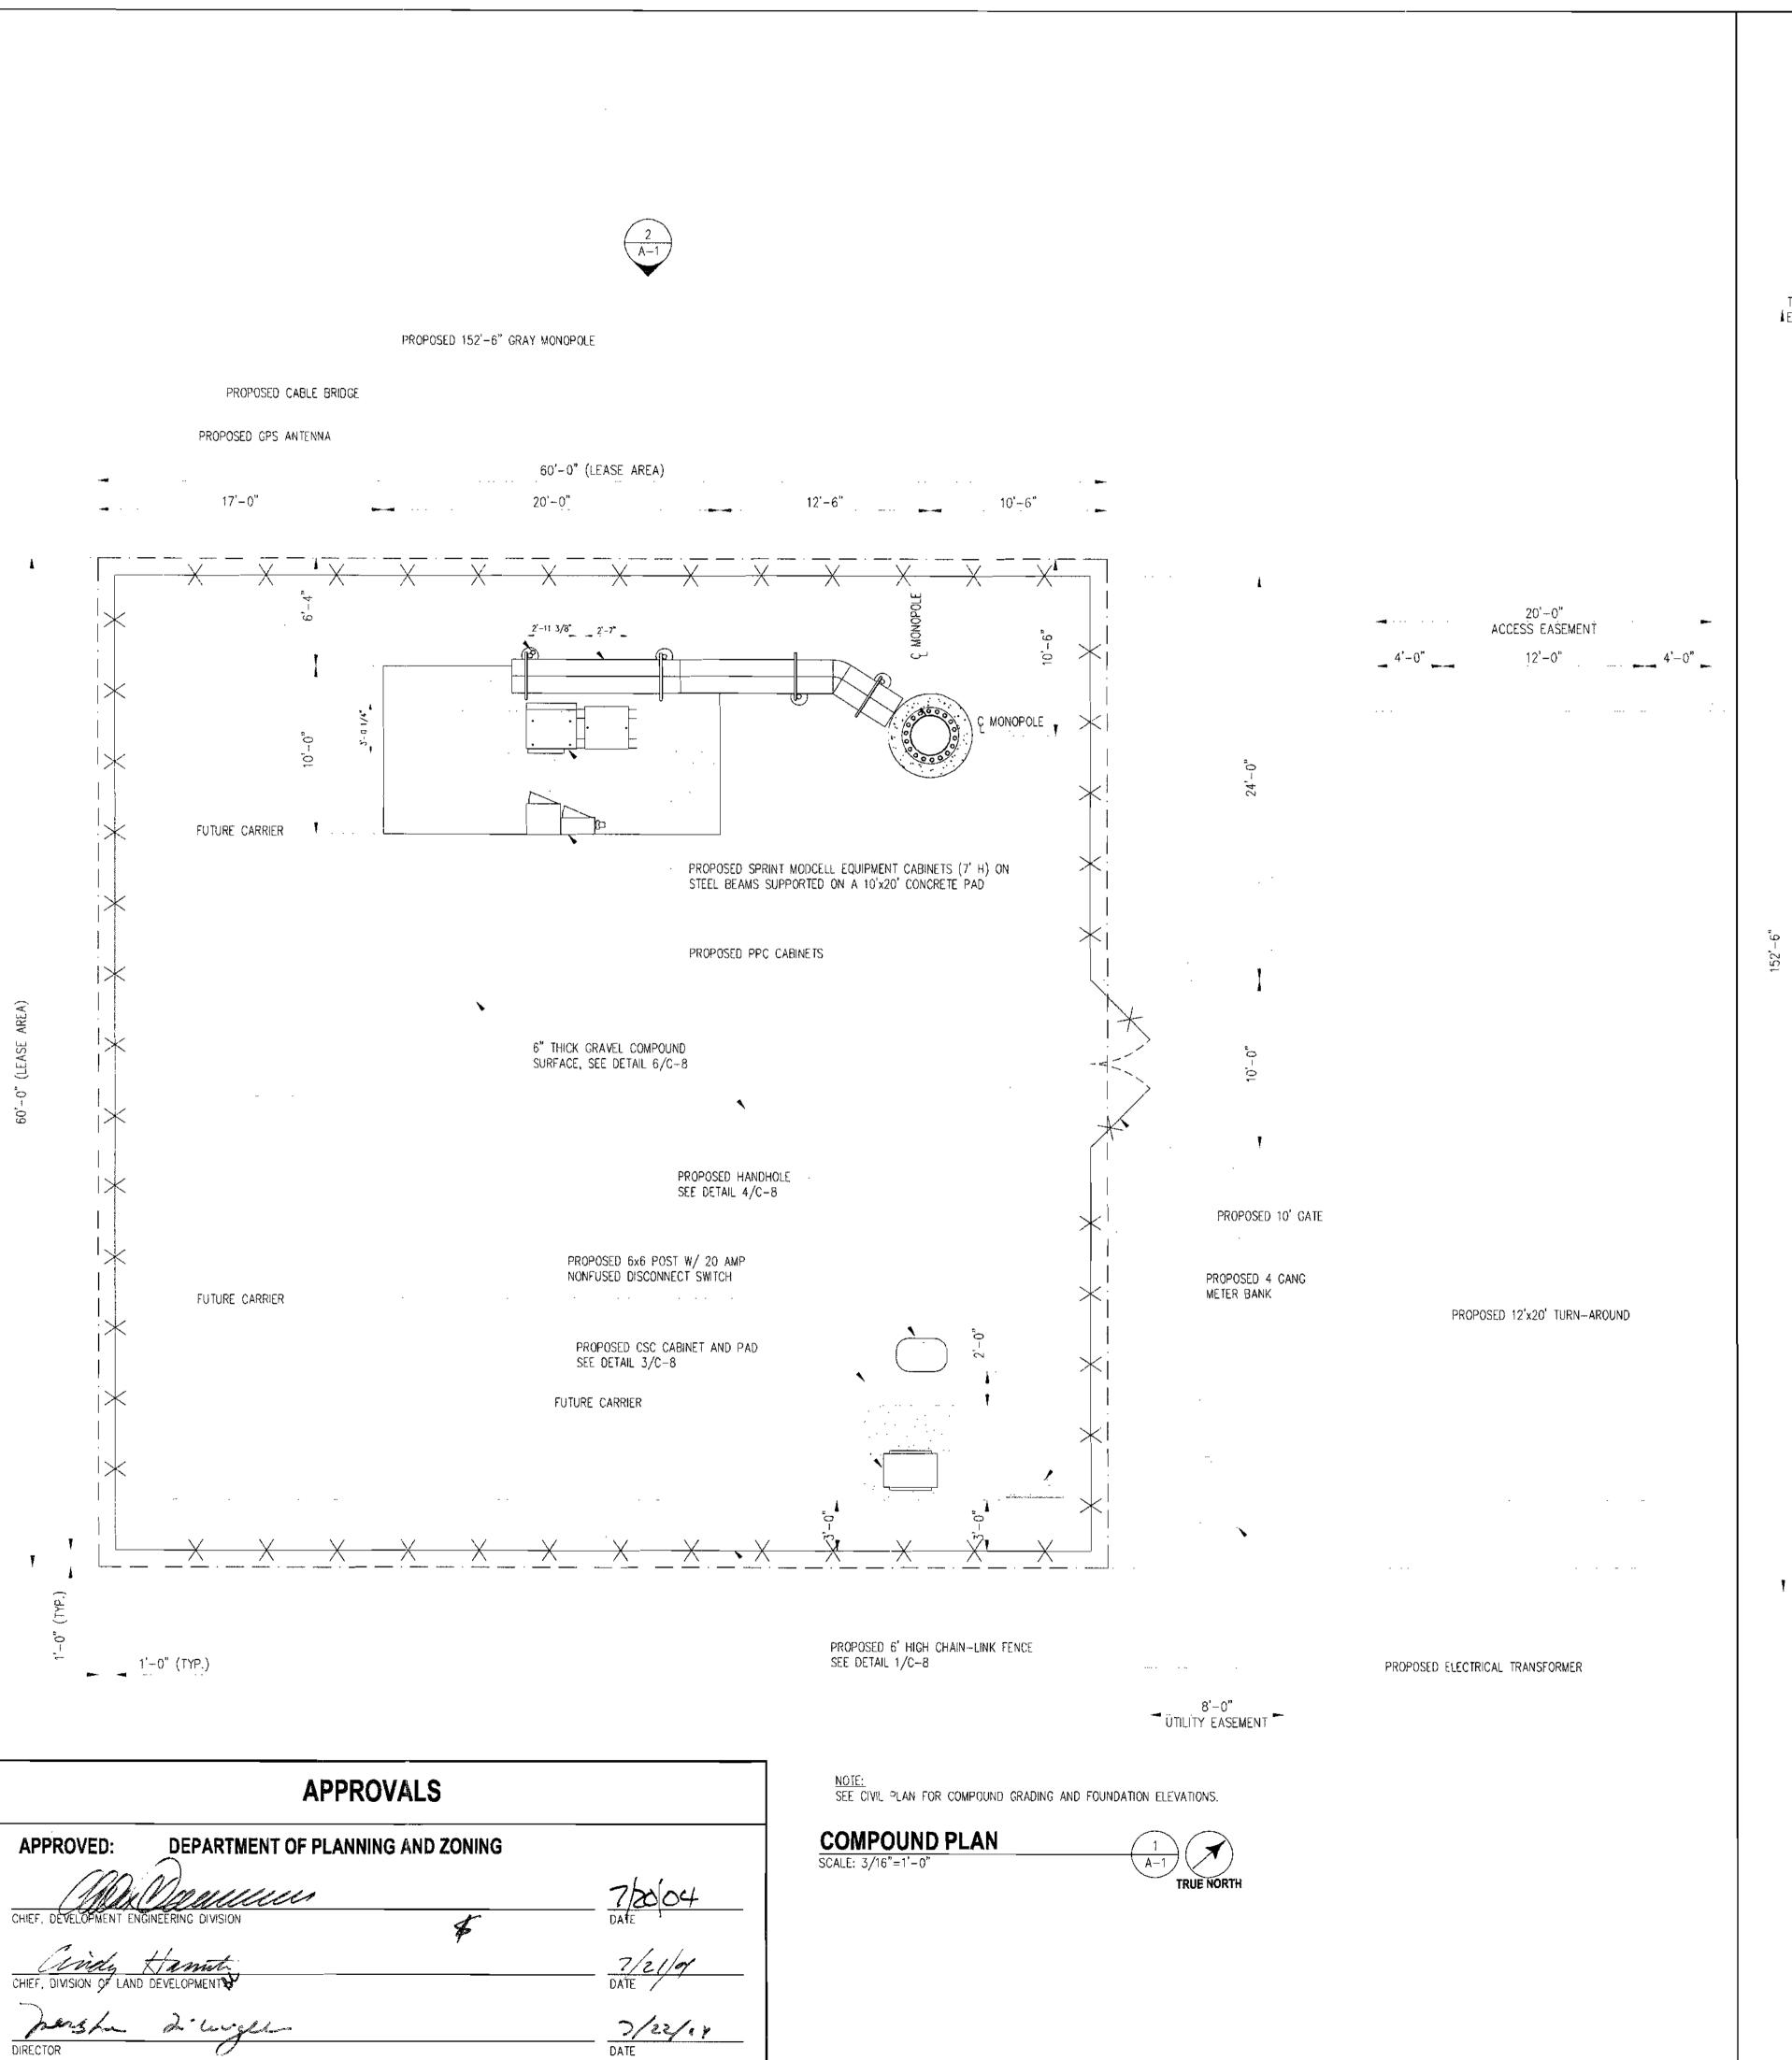

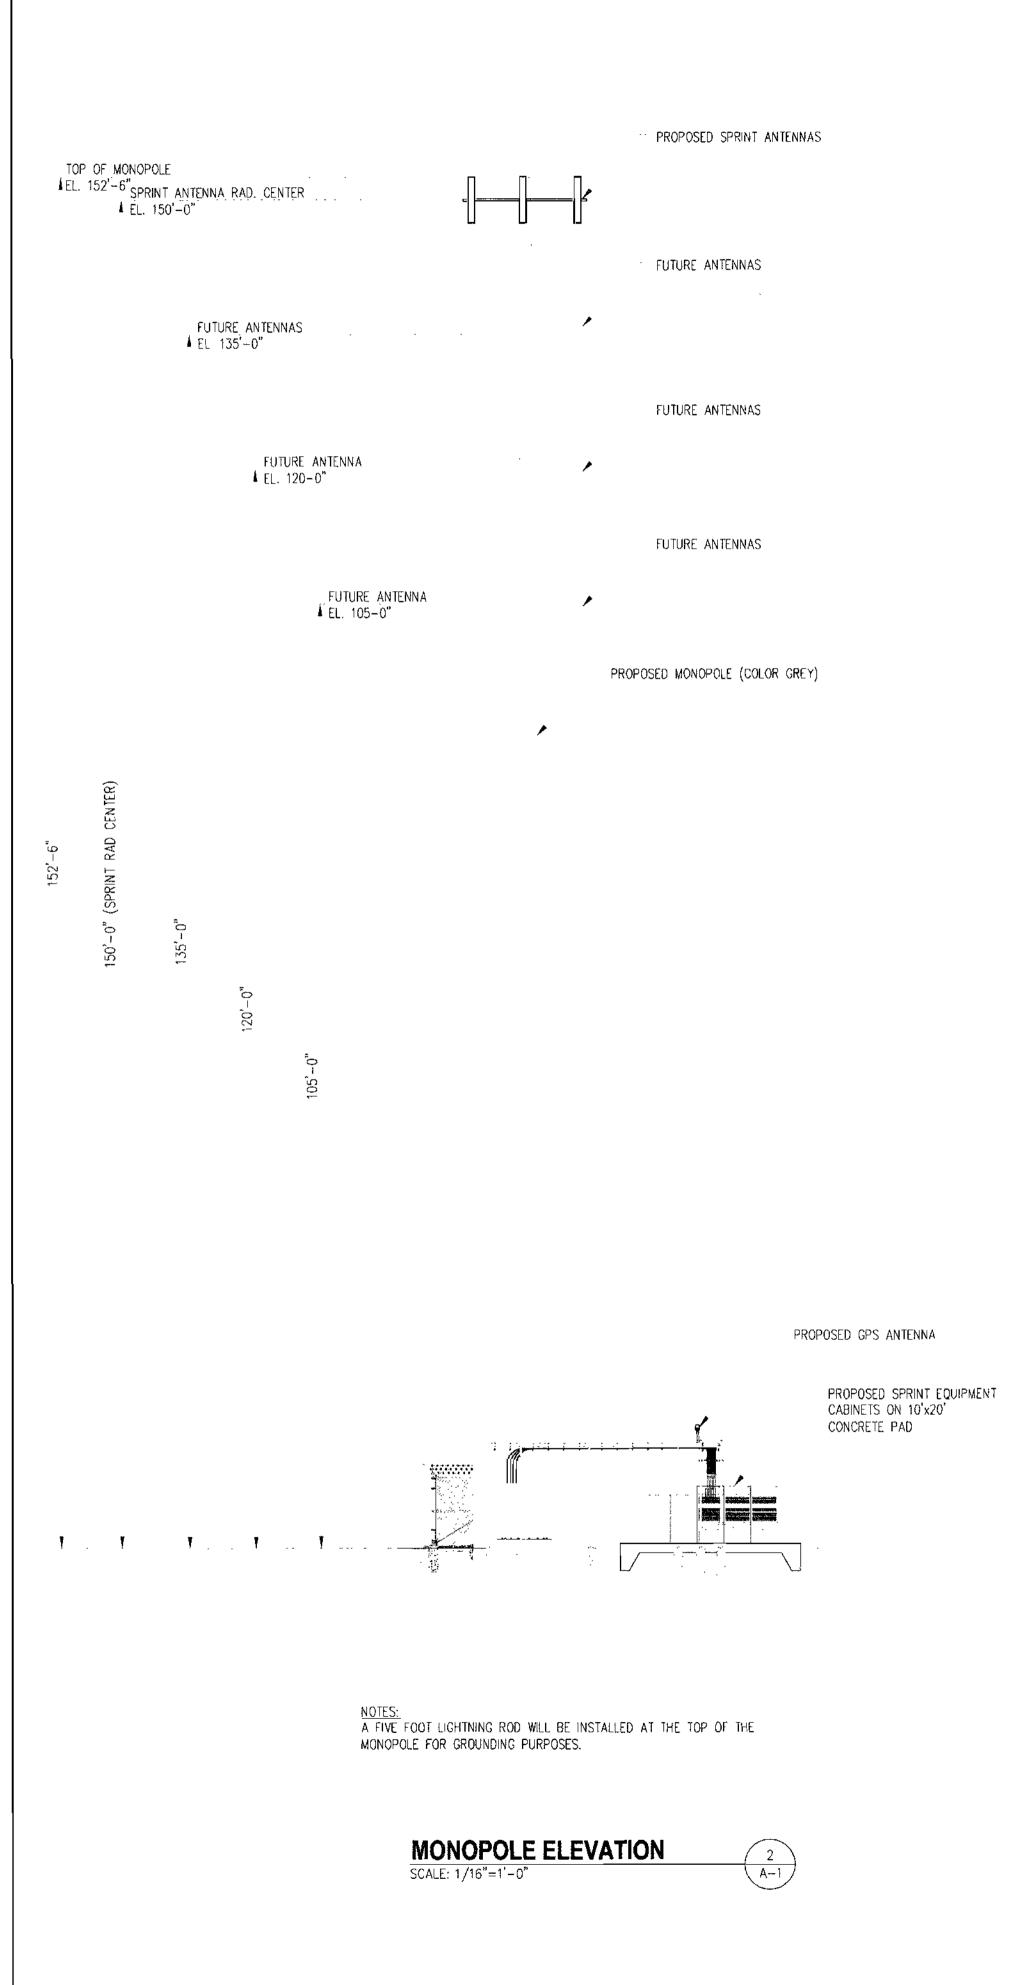



## REVISION BLOCK

DATE DESCRIPTION REVIEW

10-29-03 CONSTRUCTION REVIEW

12-02-03 CONSTRUCTION

12-17-03 SITE DEVELOPMENT PLAN


03-17-04 COUNTY COMMENTS

05-11-04 COUNTY COMMENTS

2

05-26-04 COUNTY COMMENTS

6-16-04 SDP SIGNATURE SET

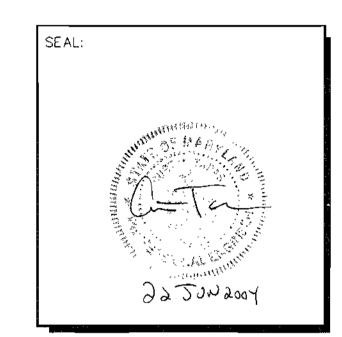



EQUIPMENT CO., LLC d/b/a
SPRINT PCS

CAPITAL DISTRICT

PROJECT NO: 1015.188

DESIGNER: M.M.

ENGINEER:

SCALE:

GRAPHIC SCALE IN INCHES

ROY A. ZIMMERMAN WA54XC473C 8282 MURPHY ROAD FULTON, MD 20759

TITLE

COMPOUND PLAN AND MONOPOLE ELEVATION

13 OF 13

SHEET NUMBER:

**A-1**