

SPRINT PCS CAPITAL DISTRICT

SEARCH NAME: PINE ORCHARD SITE NAME: GLENN MULLINIX SITE NUMBER: WA54XC459B 10256 BALTIMORE NATIONAL PIKE ELLICOTT CITY, MD 21042

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C-1 SITE SURVEY

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LS-1 FOREST STAND DELINEATION PLAN


C-2 SITE PLAN



1575 Eye Street, N.W. Suite 350 WASHINGTON, D.C. 20005 PHONE: (202)408-0960 FAX: (202)408-0961

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APC REALTY AND EQUIPMENT CO., LLC d/b/a
SPRINT PCS

1015.184
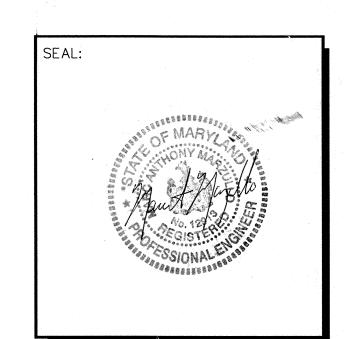
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M.M.

GRAPHIC SCALE IN INCHES

PINE ORCHARD

GLENN MULLINIX

WA54XC459B

10256 BALTIMORE

NATIONAL PIKE

ELLICOTT CITY, MD 21042

TITLE SHEET

T-1

SDP-03-125

SHEET NUMBER:

OF 13

SPRINT PCS
CAPITAL DISTRICT

PROJECT NO:

DESIGNER:

ENGINEER:

SCALE:

PROJECT DESCRIPTION

SHEET INDEX

SCOPE OF WORK: INSTALLATION OF NEW MONOPOLE FOUNDATION, MONOPOLE, PCS COMMUNICATION EQUIPMENT, SITE IMPROVEMENTS,

ELECTRICAL AND TELEPHONE SERVICE.

PROPERTY OWNER: MULLINIX, GLENN A
10226 BALTIMORE NATIONAL PIKE
ELLICOTT CITY, MD 21042-3667

(202) 408-0960

ENTREX COMMUNICATION SERVICES, INC. MARC A. MARZULLO, P.E.

POLE, APPLICANT:

d/b/a SPRINT PCS ONE INTERNATIONAL BLVD. STE. 300 MAHWAH, N.J. 07495

APC REALTY AND EQUIPMENT COMPANY, LLC.

LATITUDE: N 39' 16' 53.830" LONGITUDE: W 76' 51' 58.536"

ELECTION DISTRICT: 02

GROUND ELEVATION: 429'

JURISDICTION: HOWARD COUNTY

PROPERTY INFO: TAX MAP: 24 GRID: 1 PARCEL: 491 GROUP: 80

DEED REFERENCE: LIBER: 354 FOLIO: 83
CURRENT ZONING: B1


SITE DEVELOPMENT PLAN # SDP 03-125

			AD	DRES	S CHAR	T		
LOT/PARCEL#			STREET ADDRESS					
491			10256 BALTIMORE NATIONAL PIKE, ELLICOTT CITY, MD					
					-			
		F	PERMIT I	NFOR	MATION	CHAR	RT	
SUBDIVISION NAME	: N/A		SECTION/AREA:	¥	N/A		LOT/PARCEL NO.:	491
PLAT # OR L/F: 354/83	GRID #:	ZONING: B1	TAX MAP NO:	24	ELEC. DISTR.:	02	CENSUS TRACT:	6022
WATER CODE:	N/A		SEWER CODE:		N/A			

HOWARD COUNTY GENERAL NOTES


- 1. ALL CONSTRUCTION SHALL BE IN ACCORDANCE WITH THE LATEST STANDARDS AND SPECIFICATIONS OF HOWARD COUNTY PLUS MSH STANDARDS AND SPECIFICATIONS IF APPLICABLE.
- 2. THE CONTRACTOR SHALL CONTACT THE CONSTRUCTION INSPECTION DIVISION AT (410) 313-1880 AT LEAST 24 HOURS IN ADVAN OF COMMENCEMENT OF WORK.
- 3. THE CONTRACTOR SHALL NOTIFY "MISS UTILITY" AT 1-800-257-7777 AT LEAST 48 HOURS PRIOR TO ANY EXCAVATION WORK BEING
- 4. TRAFFIC CONTROL DEVICES, MARKINGS AND SIGNING SHALL BE IN ACCORDANCE WITH THE LATEST EDITION OF THE MANUAL OF UNIFORM TRAFFIC CONTROL DEVICES (MUTCD). ALL STREET AND REGULATORY SIGNS SHALL BE IN PLACE PRIOR TO THE PLACEME OF ANY ASPHALT.
- 5 ALL PLAN DIMENSIONS ARE TO FACE OF CURB LINESS OTHERWISE NOTE
- 6. THE EXISTING TOPOGRAPHY IS TAKEN FROM (FIELD RUN) SURVEY WITH (MAXIMUM ONE FOOT) CONTOUR INTERVALS PREPARED BY ENTREX COMMUNICATION SERVICES.
- 7. THE COORDINATES SHOWN HEREON ARE BASED UPON THE HOWARD COUNTY GEODETIC CONTROL WHICH IS BASED UP ON THE MARYLAND STATE PLANE COORDINATE SYSTEM.
- 8. WATER SERVICE IS NOT REQUIRED FOR THIS PROJECT.
- 9. SEWER SERVICE IS NOT REQUIRED FOR THIS PROJECT.
- 10. THIS PROJECT DISTURBES LESS THAN 5,000 S.F. AND IS EXEMPT FROM MD STORMWATER MANAGEMENT REQUIREMENTS.
- 11. EXISTING UTILITIES ARE BASED ON FIELD OBSERVATION.
- 12. THERE IS NO FLOODPLAIN ON THIS SITE.
- 13. THERE ARE NO WETLANDS ON THIS SITE. THE SITE IS LOCATED IN FLOOD ZONE 'C'.
- 14. NO TRAFFIC STUDY IS REQUIRED FOR THIS PROJECT.
- 15. PROJECT BACKGROUND INFORMATION (UNLESS INCLUDED IN TITLE BLOCK):
 SUBDIVISION NAME: N/A, TAX MAP: 24, SECTION/AREA: N/A, LOT/PARCEL: 491, ZONING: B1, ZB/BA REFERENCE: N/A, ELECTION DISTRICT: 02, SITE AREA: 1.6 AC.
- 16. IN ACCORDANCE WITH SECTION 16.124 OF THE HOWARD COUNTY CODE AND LANDSCAPE MANUAL, PERIMETER LANDSCAPING SHALL BE PROVIDED BY CREDIT FOR EXISTING VEGETATION AND PLANTINGS OF 7 SHADE TREES. SURETY IN THE AMOUNT OF \$2,100.00 SHALL BE POSTED WITH THE GRADING PERMIT (IF A GRADING IS REQUIRED). (OR WATH THE DEVELOPERS AGREEMENT, WHISHENERS ARPLICABLE).
- 17. IN ACCORDANCE WITH SECTION 16.1200 OF THE HOWARD COUNTY CODE AND FOREST CONSERVATION MANUAL, THE FOREST OBLIGATIONS FOR THIS SITE SHALL BE MET BY PAYMENT OF A FEE—IN—LIEU TO THE FOREST CONSERVATION FUND IN THE AMOUNT OF \$5,227.20 (WHICHENER IS APPLICABLE), FOR 0.24 ACRES OF AFFORESTATION FEED TO INCIDENTAL OF DISTURBANCE SHOWN ON THIS SITE PLAN TO UPGRADE THE EXISTING DRIVEWAY IS EXEMPT FROM THE ACREAGE USED IN CALCULATION OF FOREST CONSERVATION OBLIGATIONS SINCE THE AREA OF DISTURBANCE IS NOT BEYOND THE PREVIOUSLY GRADED AREA AT THE INITIAL STAGE OF THE DRIVEWAY CONSTRUCTION.
- 18. THIS PLAN CONFORMS TO THE 5TH EDITION OF THE SUBDIVISION AND LAND DEVELOPMENT REGULATIONS.
- 19. A USE-IN-COMMON 30' WIDE ACCESS EASEMENT AGREEMENT THROUGH PARCELS 7 & 490 TO PARCEL 491 HAS BEEN RECORDED IN THE LAND RECORDS OF HOWARD COUNTY, MD, AS LIBER NO. 661 FOLIO NO. 24 ON APRIL 17, 1973.
- 20. A TEMPORARY CONSTRUCTION EASEMENT HAS BEEN RECORDED IN THE LAND RECORDS OFFICE OF HOWARD COUNTY, MD AS LIBER No. 07552 FOLIO No. 000504 ON AUGUST 19TH, 2003, FOR THE PURPOSE OF CONSTRUCTING THE RETAINING WALL ALONG THE PROPERTY LINE AND LANDSCAPING ALONG THE COMPOUND FACE LINE.

APPROVED: DEPARTMENT OF PLANNING AND ZONING CHIEF, DEVELOPMENT ENGINEERING DIVISION CHIEF, DIVISION OF LAND DEVELOPMENT DIRECTOR DIPLOMBRIT DEVELOPMENT DIPLOMBRIT DIVISION DATE

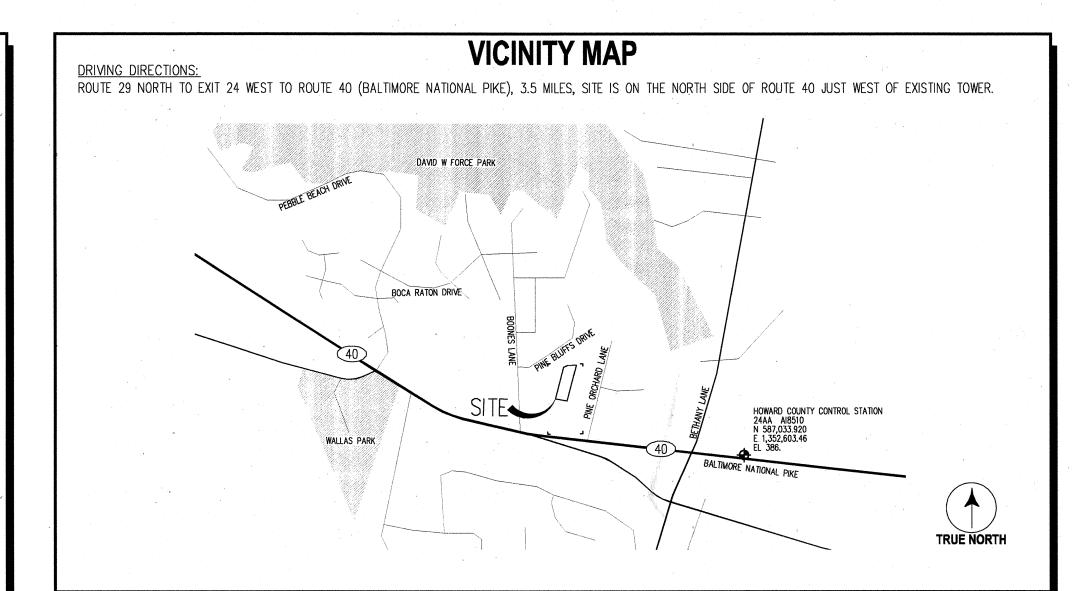

SITE ANALYSIS DATA CHART

- A. TOTAL PROJECT AREA: 1.6 ACRES/ 69,700 SQUARE FEET.
- B. AREA OF PLAN SUBMISSION: 0.111 ACRES / 4,835 SQUARE FEET.
- C. LIMIT OF DISTURBED AREA = 4,950 S.F.
- D. PRESENT ZONING DESIGNATION: B1 COMMERICIAL
- E. PROPOSED USES FOR SITE AND STRUCTURES: 150 FT TELECOMMUNICATION MONOPOLE, EQUIPMENT CABINETS, RETAINING WALLS, 8 FT HIGH CHAIN LINK FENCE AND COMPOUND AREA EXISTING USE: VACANT COMMERCIAL BUILDING
- F. FLOOR SPACE ON EACH LEVEL OF BUILDING(S) PER USE (RETAIL, OFFICE, WAREHOUSE, ETC.): N/A
- G. TOTAL NUMBER OF UNITS ALLOWED FOR PROJECT AS SHOWN ON FINAL PLAT (RESIDENTIAL ONLY): N/A
- H. TOTAL NUMBER OF UNITS PROPOSED ON SUBMISSION (RESIDENTIAL ONLY): N/A
- I. MAXIMUM NUMBER OF EMPLOYEES, TENANTS ON SITE PER USE = 1 FOR EXISTING VACANT USE
- J. NUMBER OF PARKING SPACES REQUIRED BY HOWARD COUNTY ZONING REGULATIONS AND XON FOR EXISTING VACANT COMMERCIAL BUILDING = 1
- K. NUMBER OF PARKING SPACES PROVIDED ON SITE (INCLUDE NUMBER OF HANDICAPPED PARKING SPACES) = 4
- L. OPEN SPACE ON SITE: NOT APPLICABLE TO THIS PROJECT.
- M. AREA OF RECREATION OPEN SPACE REQUIRED BY SUBDIVISION AND LAND DEVELOPMENT REGULATIONS ACRES REQUIRED: 0 ACRES PROVIDED: 0 (RESIDENTIAL ONLY).
- N. BUILDING COVERAGE OF SITE: NOT APPLICABLE TO THIS PROJECT.
- O. APPLICABLE DPZ FILE REFERENCES:
 - THERE ARE NO KNOWN RECORDED SUBMITTALS, WAVERS, APPROVED OR DENIED (DPW AND DPZ) CONCERNING THIS TRACT.
- P. ANY OTHER INFORMATION WHICH MAY BE RELEVANT. N/A

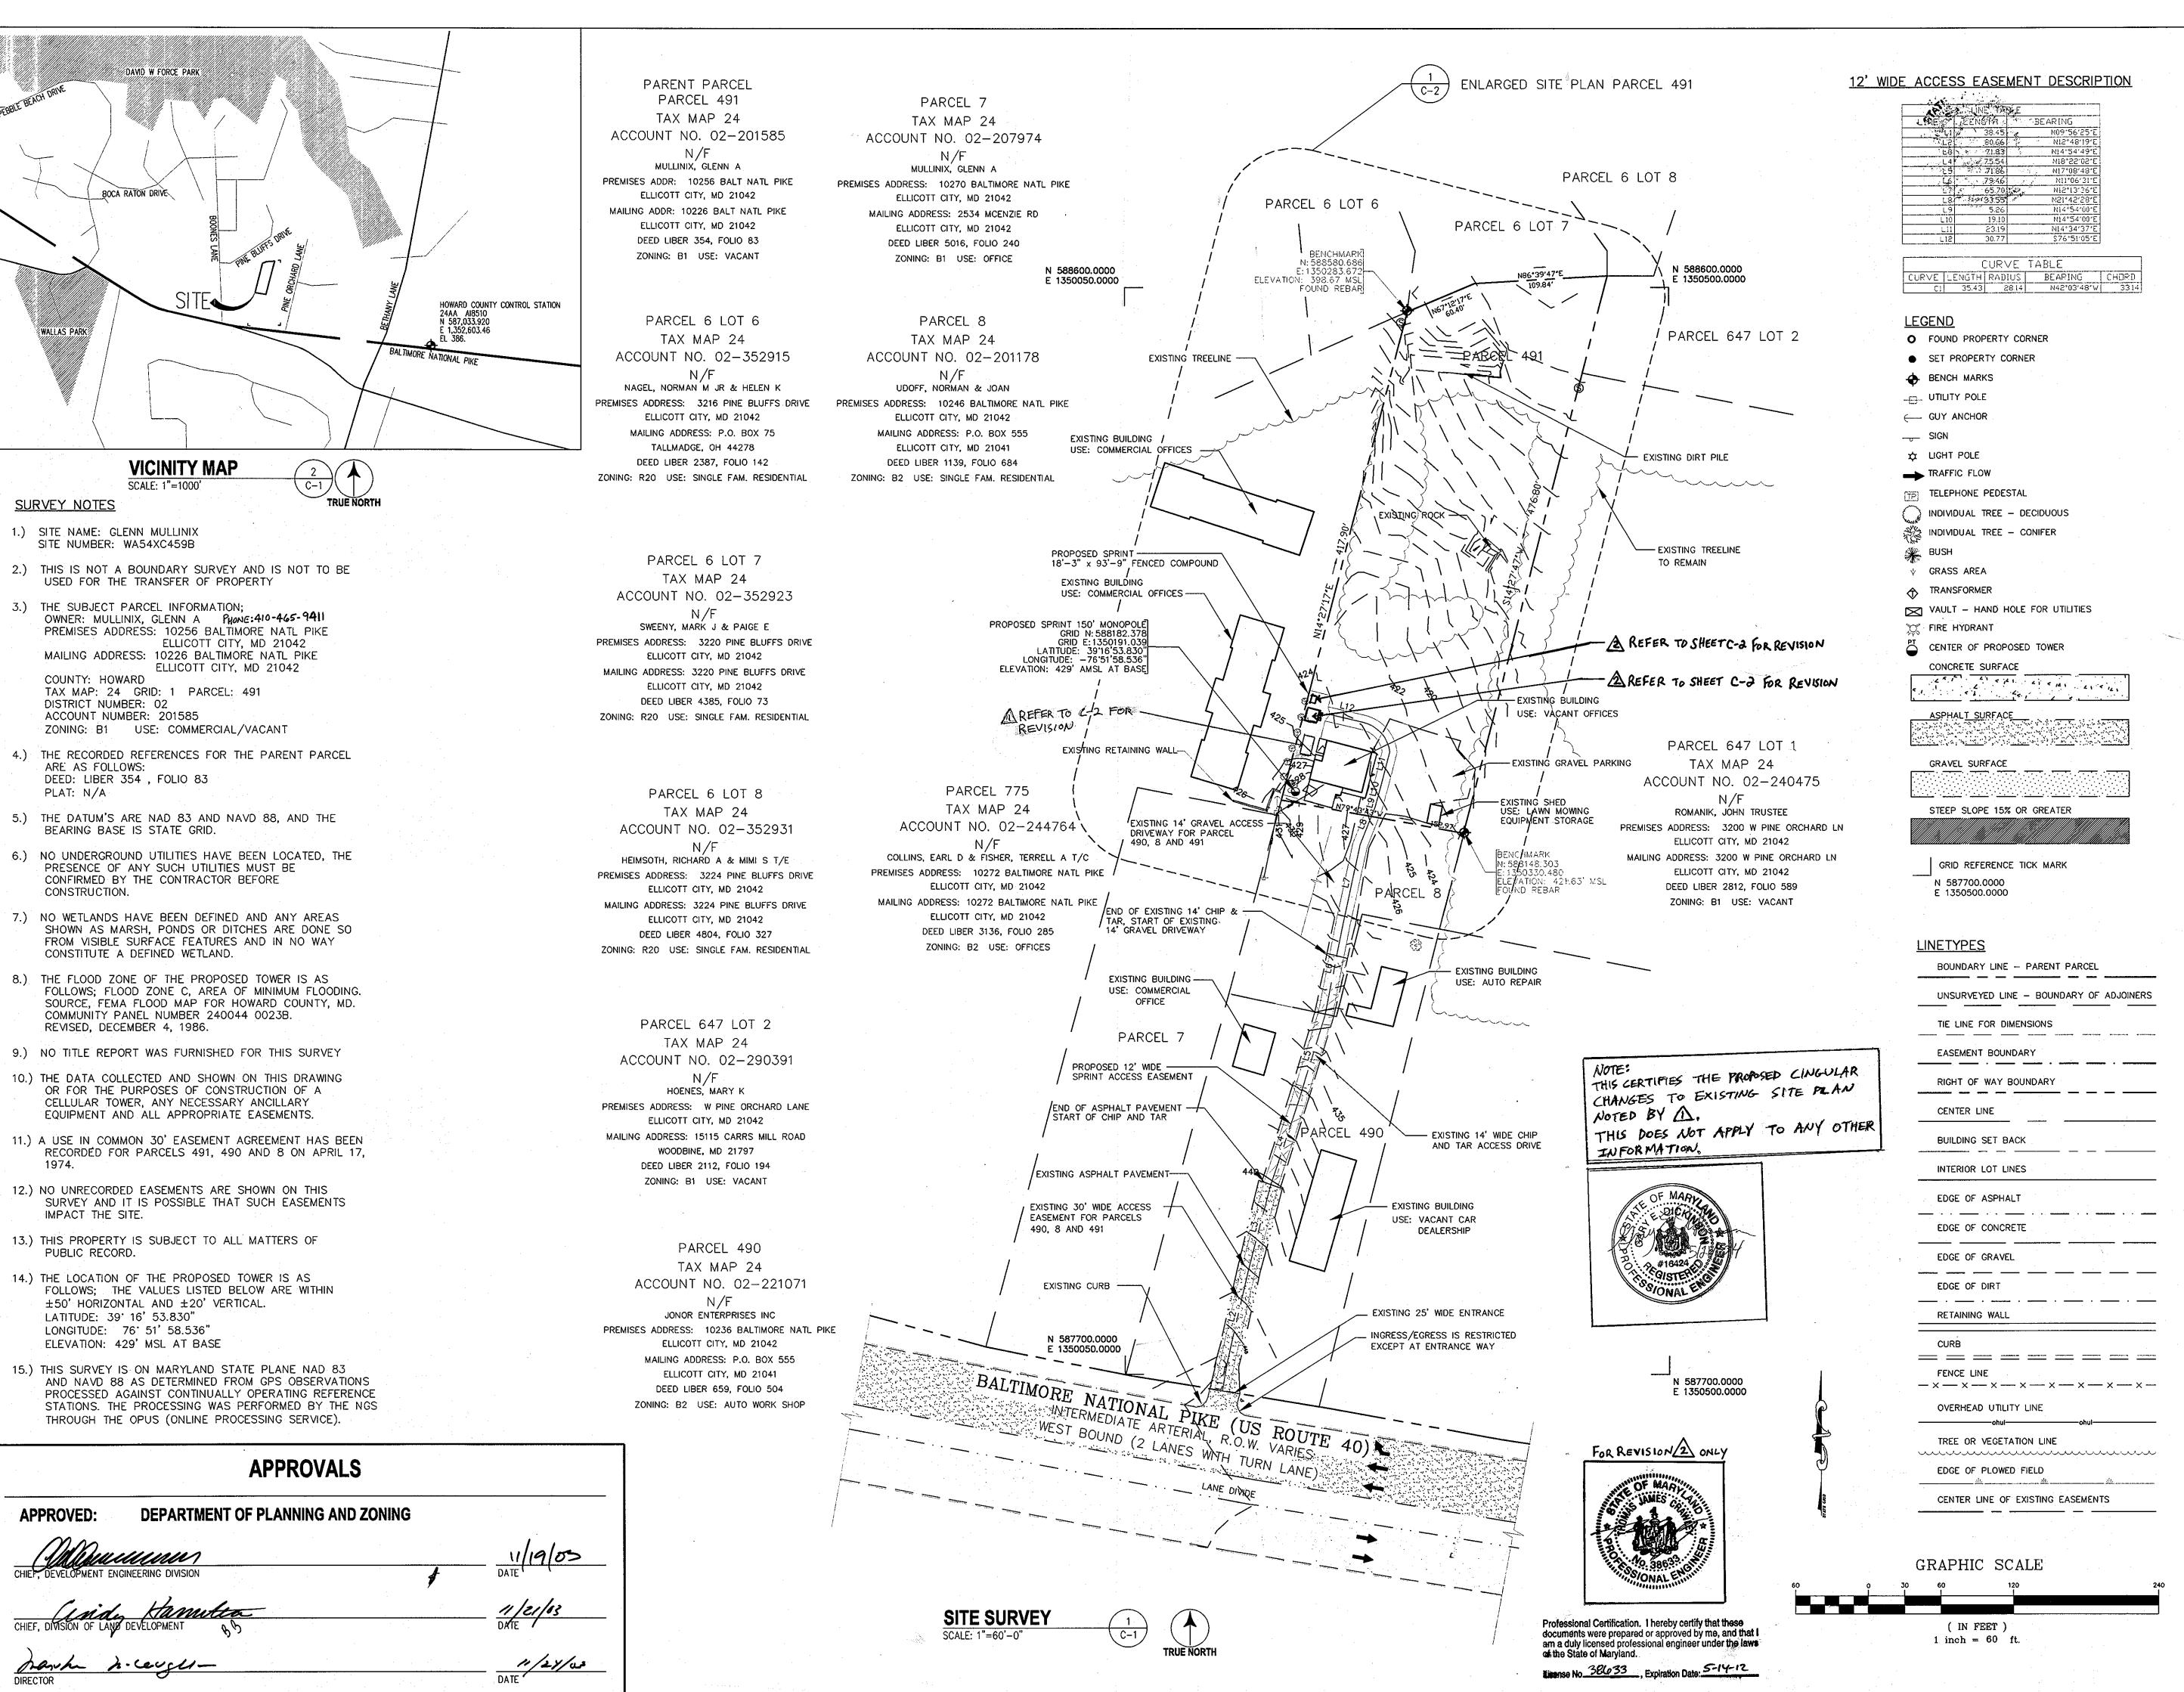



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APC REALTY AND EQUIPMENT CO., LLC d/b/a SPRINT PCS CAPITAL DISTRICT

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ENGINEER:	C.T.	
DESIGNER:	R.S.	
PROJECT NO:	1015.184	
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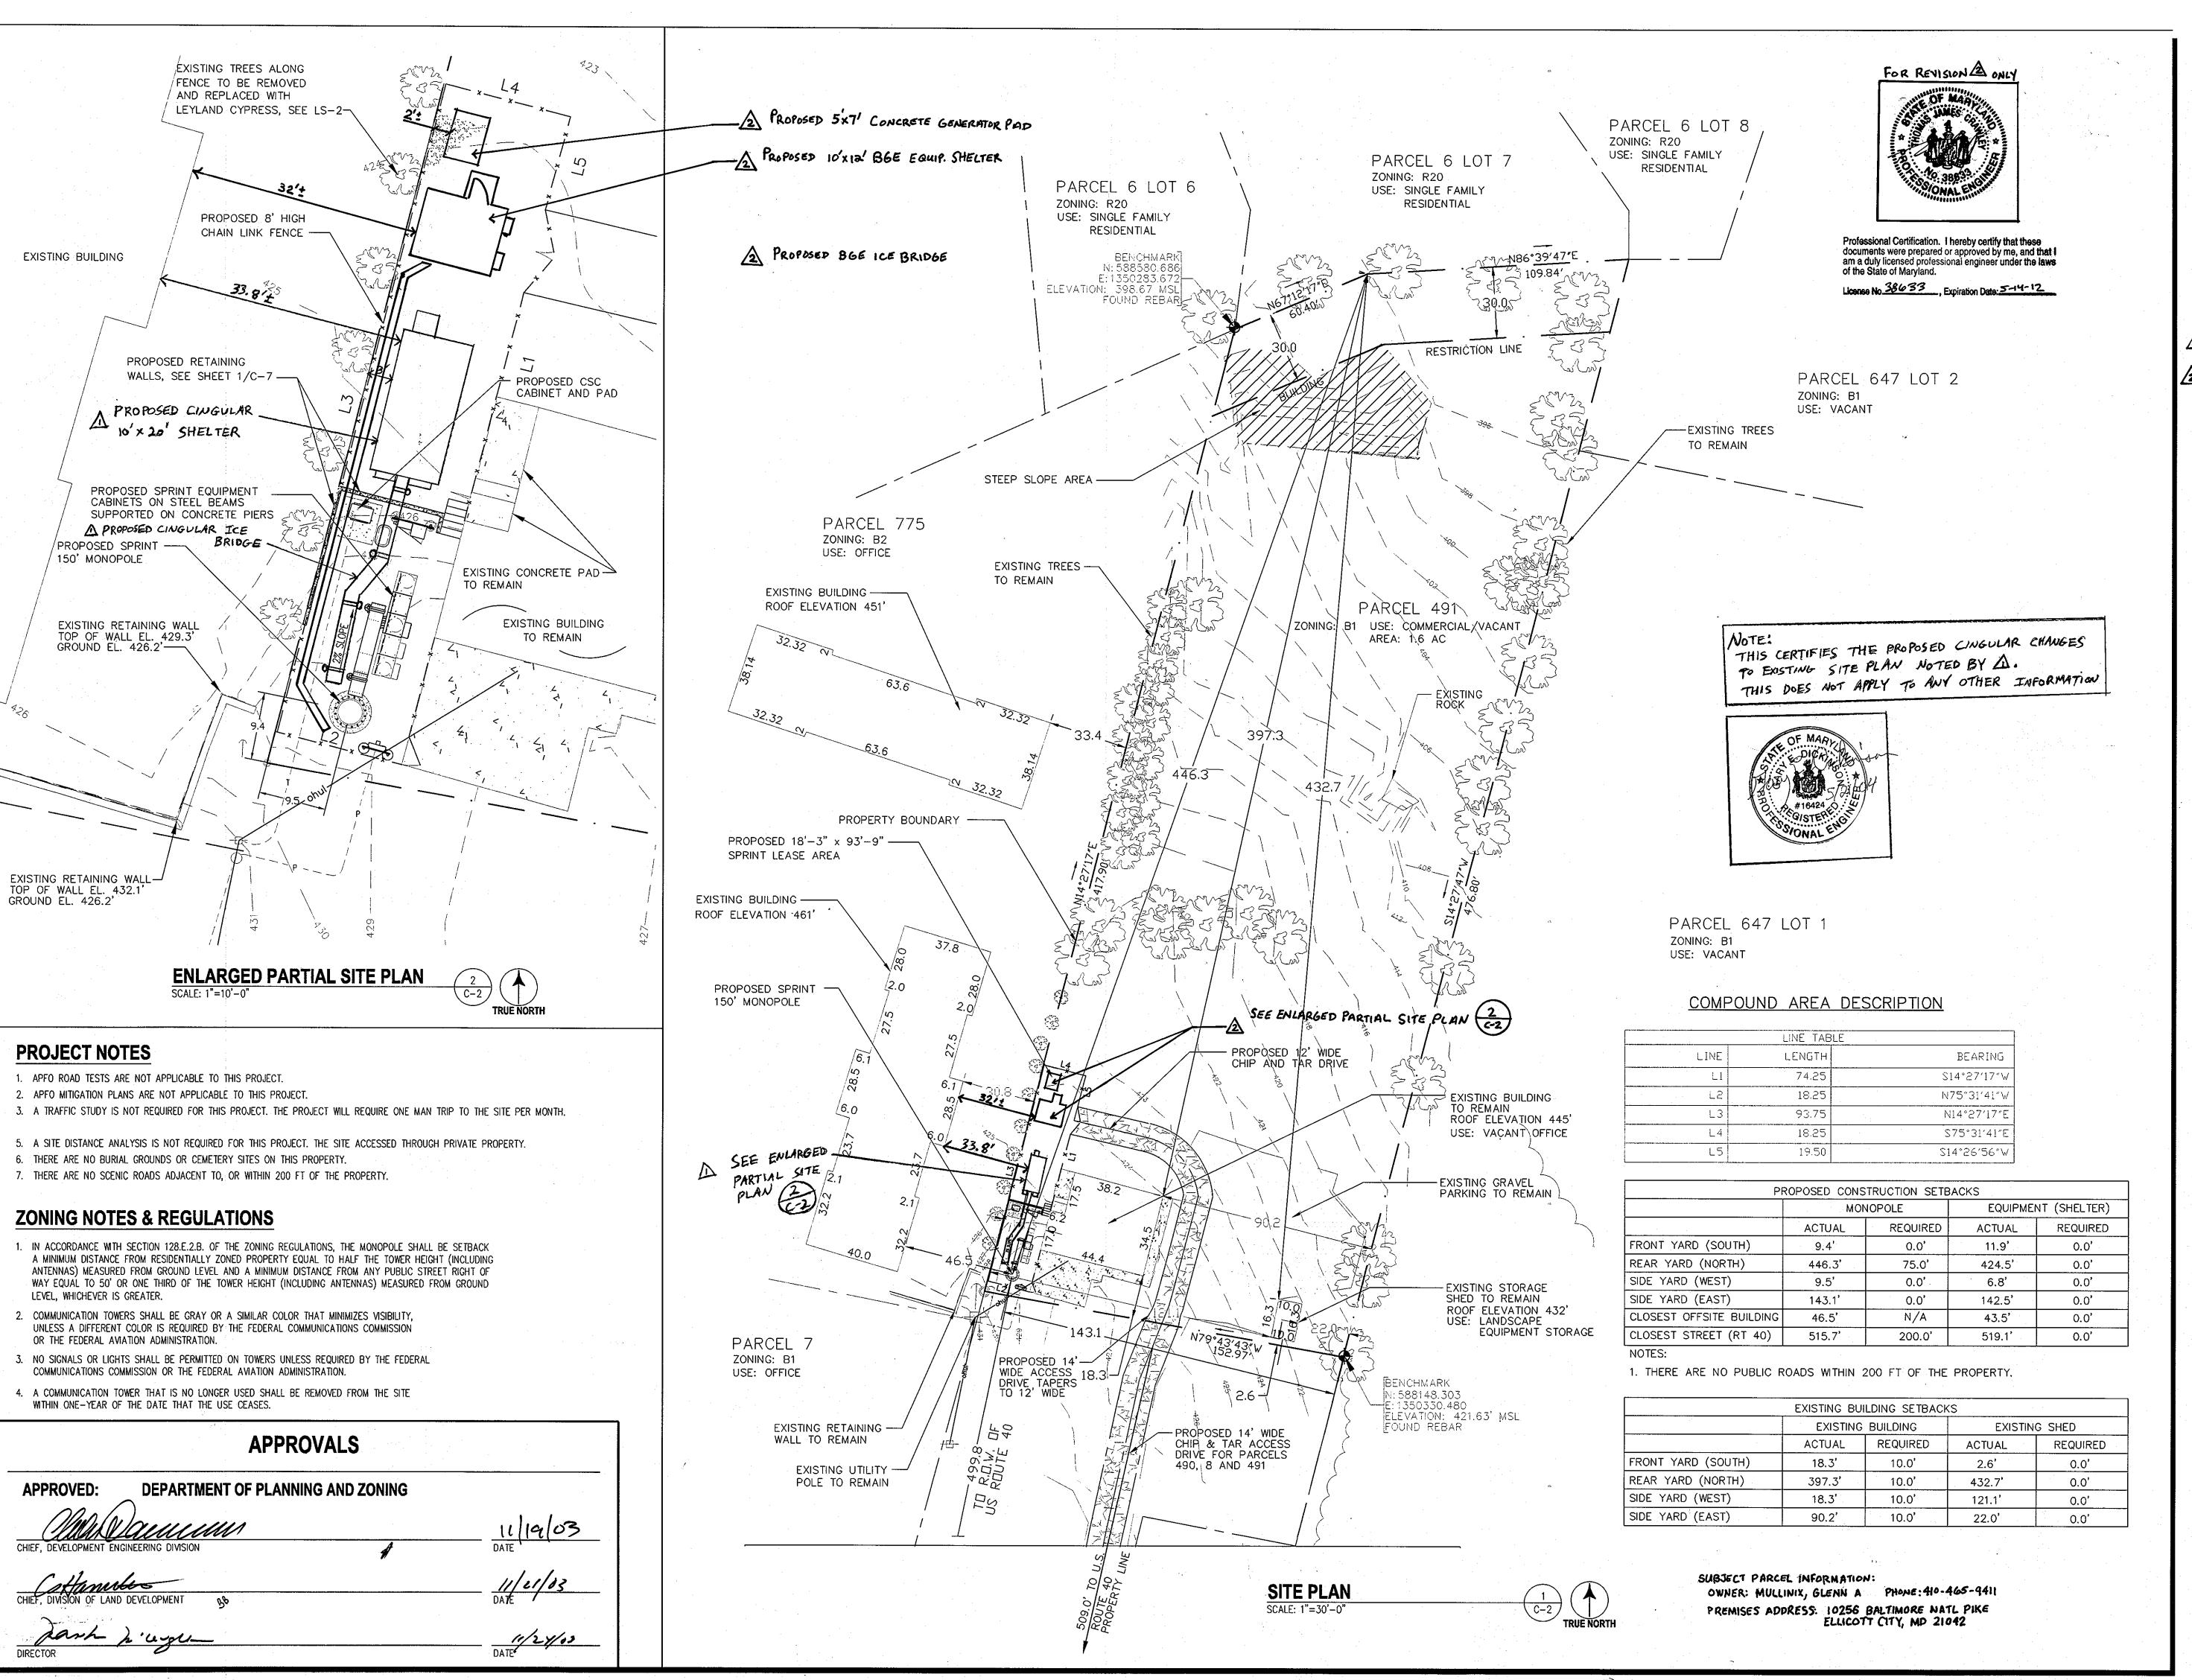
TITLE:

SITE SURVEY

2 OF 13

SHEET NUMBER:


C-1





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APC REALTY AND EQUIPMENT CO., LLC d/b/a SPRINT PCS

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ENGINEER:	C.T.
SCALE	
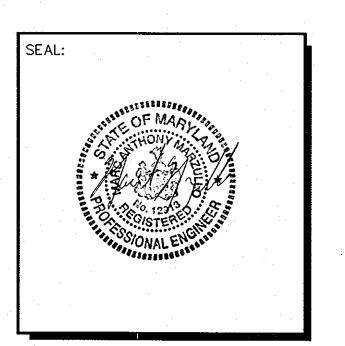
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GRAPHIC SCALE IN INCHES

PINE ORCHARD
GLENN MULLINIX
WA54XC459B
10256 BALTIMORE
NATIONAL PIKE
ELLICOTT CITY, MD 21042

TITLE:

SITE PLAN

3 OF 13

SHEET NUMBER:

C-2

GENERAL NOTES

SEE SHEET C-4 FOR SYMBOLS

STORMWATER MANAGEMENT EXEMPTION

THE DISTURBED AREA OF 4,950 S.F. IS LESS THAN 5,000 S.F. THEREFOR THE PROJECT IS EXEMPT FROM MD STORMWATER MANAGEMENT REQUIREMENTS.

EARTH EXCAVATION NOTES

- 1. EXCAVATED MATERIAL SHALL BE USED AS BACKFILL WHEREVER POSSIBLE. BACKFILL MATERIAL SHALL BE OF A QUALITY SUITABLE TO THE ENGINEER AND FREE OF EXCESS ORGANIC MATTER AND BOULDERS.
- 2. BACKFILL SLOPES SHALL BE STEPPED OR SERRATED AND PROCEED IN SIX (6) INCHLIFTS.
- 3. EACH LAYER SHALL BE COMPACTED BY MECHANICAL TAMPERS OR OTHER APPROVED MEANS TO NINETY-FIVE (95) PERCENT OF MAXIMUM DENSITY AS MEASURED BY A.A.S.H.O. T-99.
- 4. COMPACTION TESTING SHALL BE MADE BY AN OWNER APPROVED MATERIALS TESTING FIRM AND THE RESULTS SHALL BE SUBMITTED BY THE CONTRACTOR TO THE DESIGN ENGINEER FOR APPROVAL. TESTS SHALL BE CONDUCTED AT THE RATE OF ONE TEST PER 50 CY OF FILL OR 2000 SF OF SURFACE AREA WHICHEVER IS GREATER. A MINIMUM OF 2 TESTS PER COMPACTED AREA ARE REQUIRED.
- 5. THE BACKFILL SHALL BE PROPERLY GRADED TO BLEND WITH THE EXISTING GROUND AND DRAIN PROPERLY.
- 6. MAXIMUM CUT OR FILL SLOPE
 3:1 FOR SEED OR SOD LAWN AREAS
 2:1 FOR STABILIZED LOW MAINTENANCE AREAS


AREA TABLE

IMPERVIOUS AREA : 4,848 SF


DISTURBED AREA : 4,950 SF


HOWARD COUNTY NOTES

- 1. DRIVEWAYS SHALL BE PROVIDED PRIOR TO ISSUANCE OF A USE AND OCCUPANCY PERMIT FOR ANY NEW DWELLINGS TO INSURE SAFE ACCESS FOR FIRE AND EMERGENCY VEHICLES PER THE FOLLOWING MINIMUM REQUIREMENTS:
 - A. WIDTH 12' (14' SERVING MORE THAN ONE RESIDENCE); B. SURFACE - 6" OF COMPACTED CRUSHER RUN BASE W/TAR
 - AND CHIP COATING (1-1/2" MIN.); C. GEOMETRY – MAX. 15 % GRADE, MAX. 10% GRADE CHANGE AND
 - MIN. 45' TURNING RADIUS;
 - D. STRUCTURES (CULVERTS/BRIDGES) CAPABLE OF SUPPORTING 25 GROSS TONS (H25 LOADING);
 - E. DRAINAGE ELEMENTS CAPABLE OF SAFELY PASSING 100— YEAR FLOOD WITH NO MORE THAN 1 FOOT DEPTH OVER DRIVEWAY SURFACE;
 - F. MAINTENANCE SUFFICIENT TO INSURE ALL WEATHER USE.

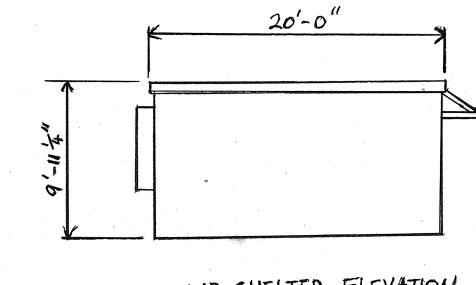

A PROPOSED CINGULAR SHELTER ELEVATION

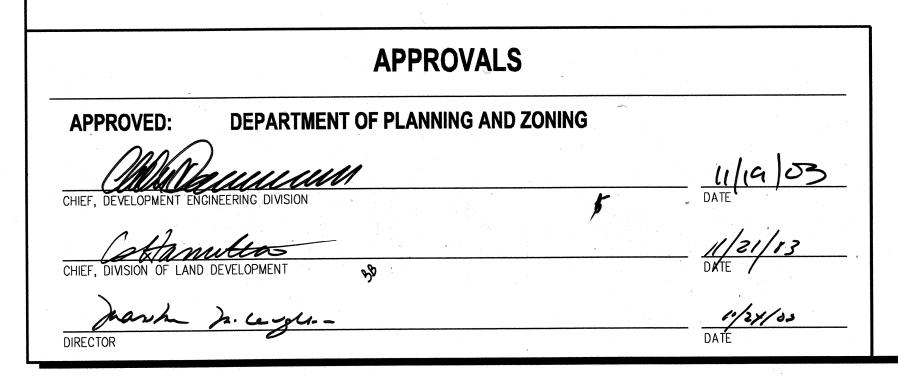


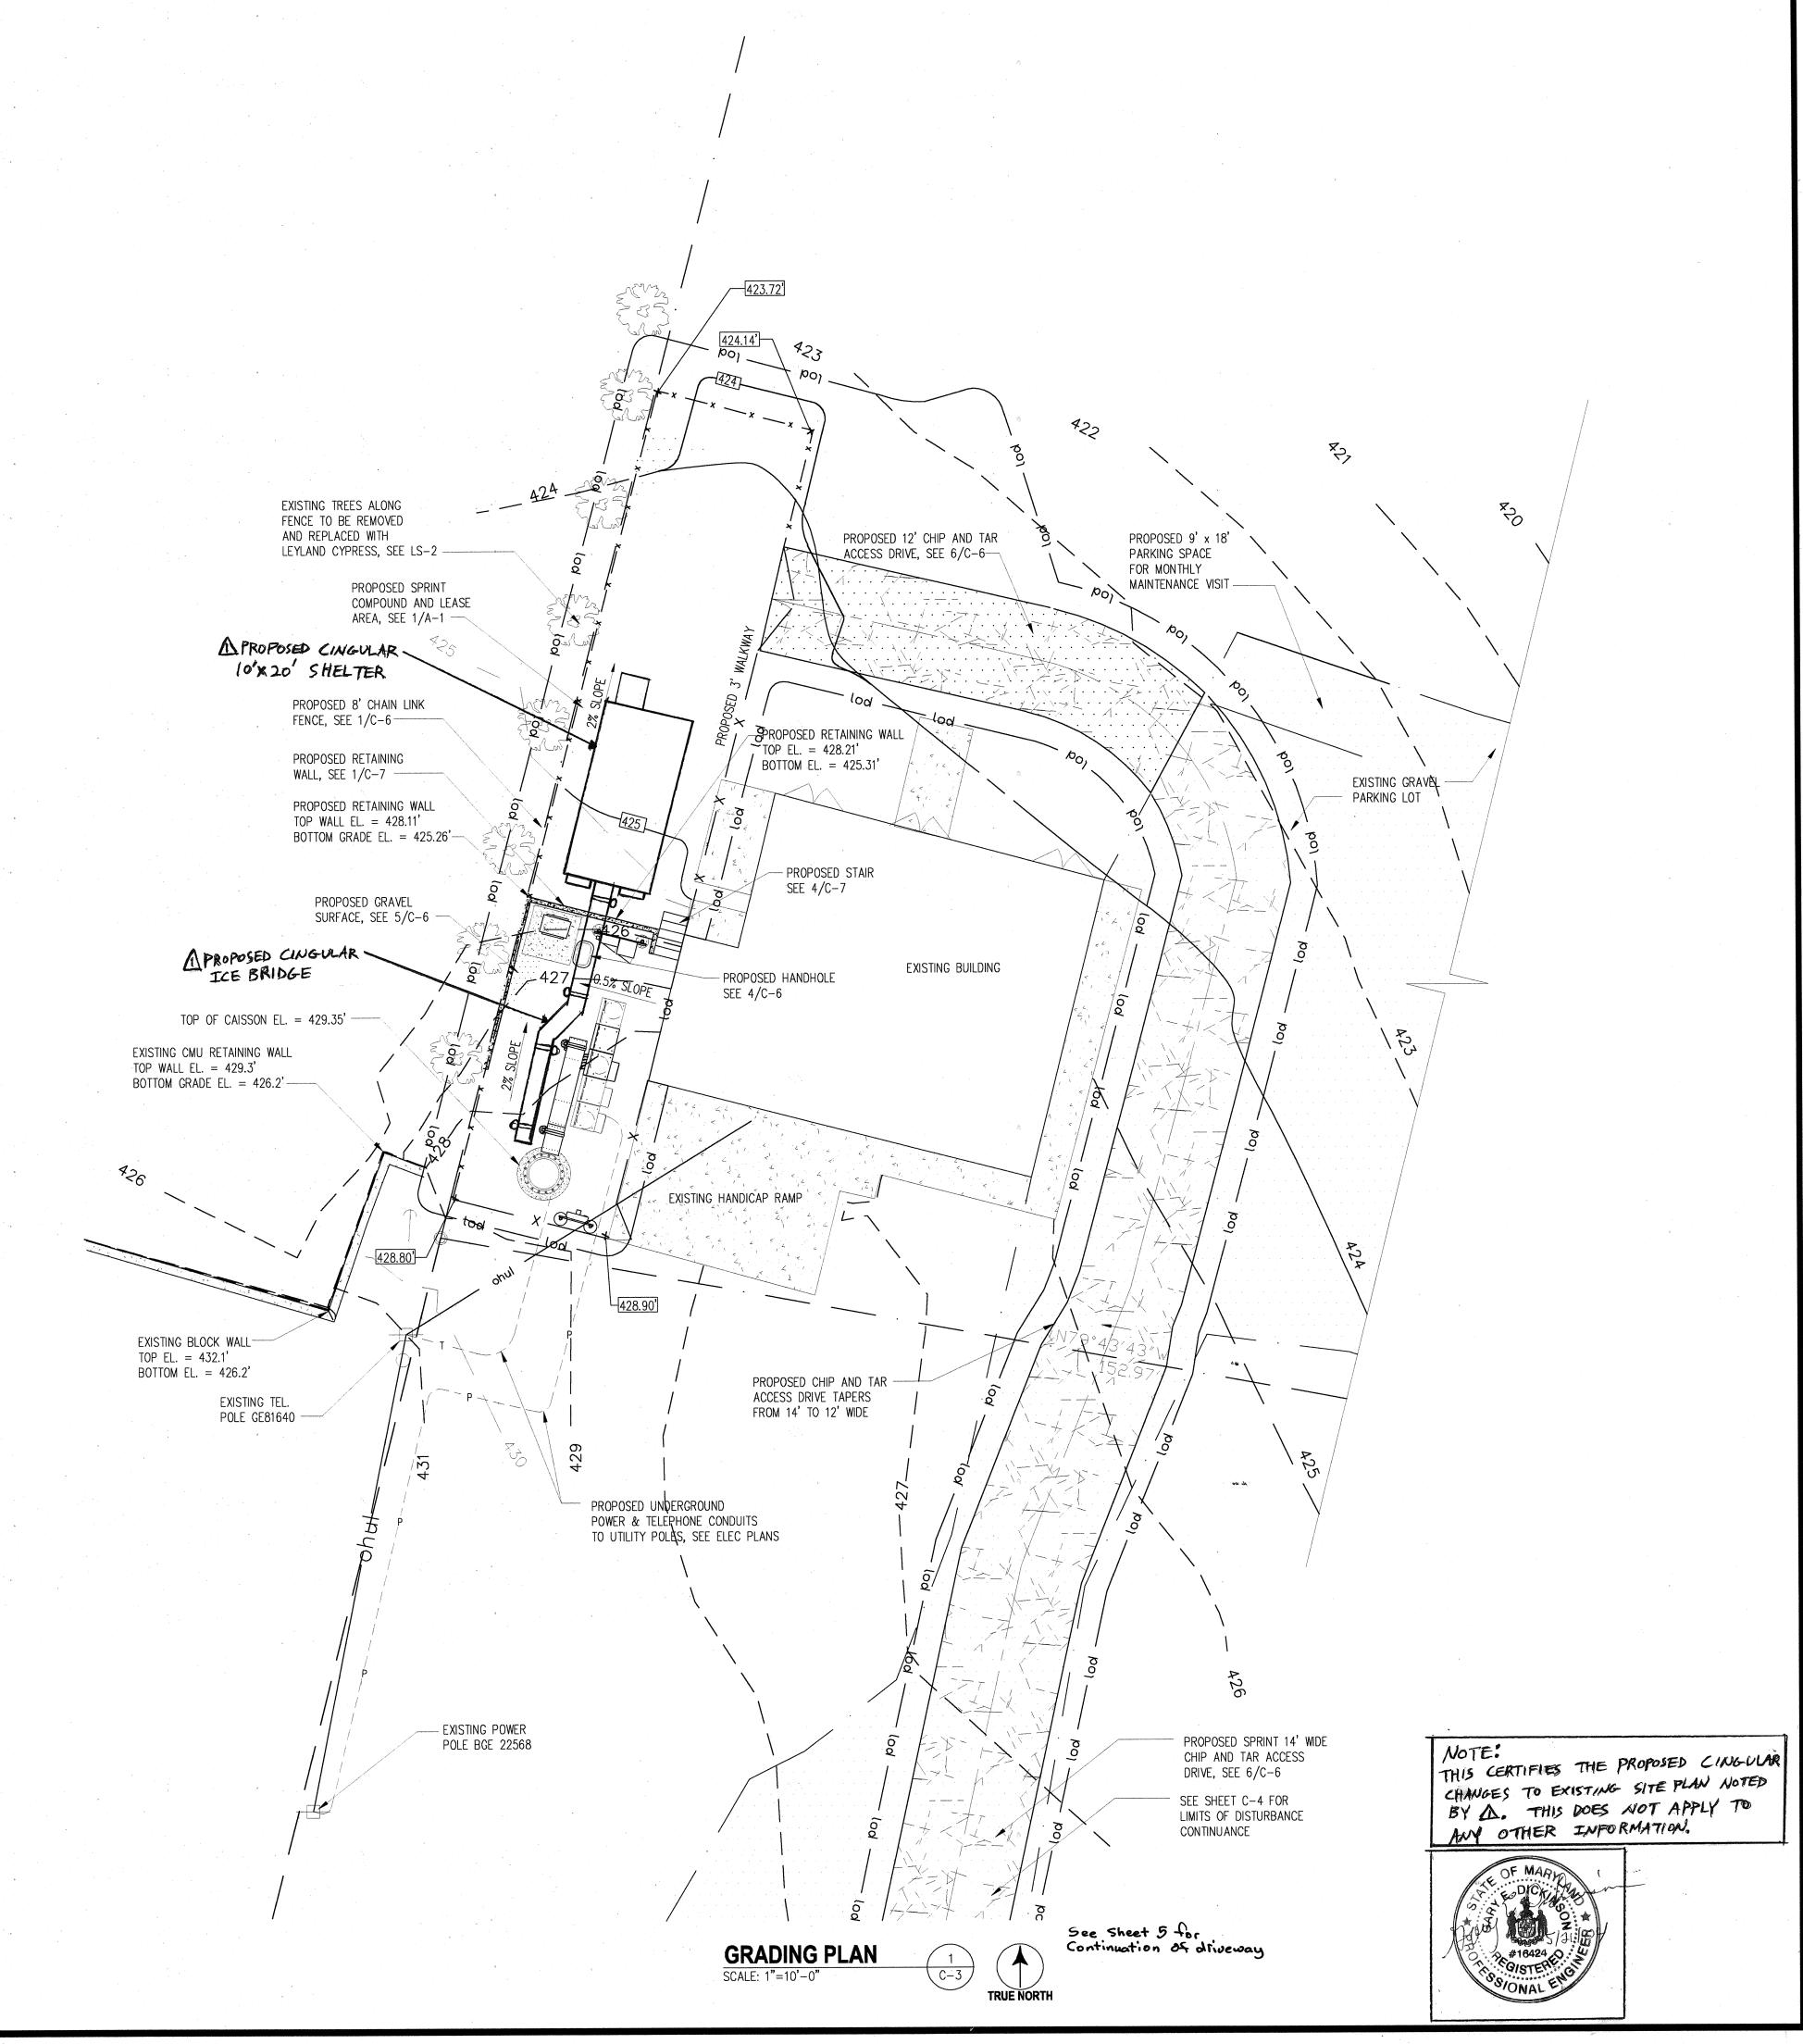




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SCALE: 0 1/2 1 GRAPHIC SCALE IN INCHES
PINE ORCHARD GLENN MULLINIX WA54XC459B
10256 BALTIMORE NATIONAL PIKE ELLICOTT CITY, MD 21042

1015.184

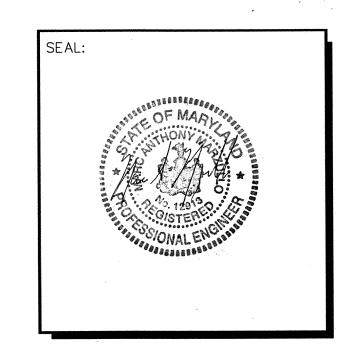TMF

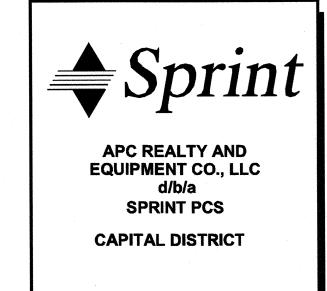C.T.

PROJECT NO:

ESIGNER:

ENGINEER:

TITLE:

GRADING PLAN

4 OF 13

SHEET NUMBER:

C-3

ENGINEER'S CERTIFICATE GENERAL EROSION AND SEDIMENT CONTROL NOTES I CERTIFY THAT THIS PLAN FOR SEDIMENT AND EROSION CONTROL REPRESENTS A PRACTICAL . UNLESS OTHERWISE INDICATED, ALL VEGETATIVE AND STRUCTURAL EROSION AND AND WORKABLE PLAN BASED ON MY PERSONAL KNOWLEDGE OF THE SITE CONDITIONS AND THAT SEDIMENT CONTROL PRACTICES WILL BE CONSTRUCTED AND MAINTAINED ACCORDING IT WAS PREPARED IN ACCORDANCE WITH THE REQUIREMENTS OF THE HOWARD SOIL TO LATEST MDE STANDARDS AND SPECIFICATIONS FOR SEDIMENT AND EROSION CONSERVATION DISTRICT." 2. THE CONTRACTOR SHALL APPLY PERMANENT OR TEMPORARY SQIL STABILIZATION TO ALL DENUDED OR DISTURBED AREAS WITHIN 7 DAYS AFTER FINAL GRADE IS REACHED ON ANY PORTION OF THE SITE. SOIL STABILIZATION MUST ALSO BE APPLIED TO DENUDED OR DISTURBED AREAS WHICH MAY NOT BE AT FINAL GRADE BUT WHICH WILL END OF TREE REMAIN UNDISTURBED FOR LONGER THAT 30 DAYS. SOIL STABILIZATION MEASURES PROTECTION FENCE-INCLUDE VEGETATIVE ESTABLISHMENT, MULCHING, AND THE EARLY APPLICATION OF SEE 3/C-5 GNATURE OF ENGINEER (PRINT NAME BELOW SIGNATURE). GRAVEL BASE MATERIAL ON AREAS TO BE PAVED. 3. ALL SEDIMENT AND CONTROL MEASURES ARE TO BE PLACED PRIOR TO OR AS THE PERMANENTLY STABILIZE DISTURBED FIRST STEP IN LAND DISTURBANCE. AREAS WITH TOPSOIL, FERTILIZER AND **DEVELOPER'S CERTIFICATE** SEED IN ACCORDANCE WITH SPECIFICATIONS . THE CONTRACTOR SHALL INSPECT ALL EROSION CONTROL MEASURES PERIODICALLY SEE SHEET C-5 AND AFTER EACH RUNOFF PRODUCING RAINFALL EVENT. ANY NECESSARY REPAIRS TO MAINTAIN THE EFFECTIVENESS OF THE EROSION CONTROL DEVICES AND CLEANUP "I/WE CERTIFY THAT ALL DEVELOPMENT AND CONSTRUCTION WILL BE DONE ACCORDING TO THIS OF THE SEDIMENTATION ARE THE RESPONSIBILITY OF THE CONTRACTOR AND SHALL PLAN FOR SEDIMENT AND EROSION CONTROL, AND THAT ALL RESPONSIBLE PERSONNEL INVOLVED BE MADE IMMEDIATELY. IN THE CONSTRUCTION PROJECT WILL HAVE A CERTIFICATE OF ATTENDANCE AT A DEPARTMENT OF THE ENVIRONMENT APPROVED TRAINING PROGRAM FOR THE CONTROL OF SEDIMENT AND 5. THE CONTRACTOR SHALL LIMIT SITE ACCESS BY CONSTRUCTION VEHICLES TO EROSION BEFORE BEGINNING THE PROJECT. I ALSO AUTHORIZE PERIODIC ON-SITE INSPECTION ENTRANCES PROTECTED BY A STONE CONSTRUCTION ENTRANCE OR AND APPROVED BY THE HOWARD SOIL CONSERVATION DISTRICT." COMPARABLE CONTROL MEASURE. SEDIMENT SHALL BE REMOVED FROM PAVED AREAS ON A DAILY BASIS. 6. STOCKPILES OF SOIL AND OTHER ERODIBLE MATERIALS SHALL BE STABILIZED OR PROTECTED WITH SEDIMENT TRAPPING MEASURES. THE CONTRACTOR IS RESPONSIBLE 1/05/03 FOR THE TEMPORARY PROTECTION AND PERMANENT STABILIZATION FOR STOCKPILES PROPOSED STABILIZED CONSTRUCTION ON SITE AS WELL AS FOR MATERIALS TRANSPORTED FROM THE PROJECT SITE. SIGNATURE OF ENGINEER (PRINT NAME BELOW SIGNATURE) ENTRANCE, SEE 4/C-5 THE CONTRACTOR SHALL MONITOR AND TAKE PRECAUTIONS TO CONTROL DUST, MARC A. MARZULO END OF SILT FENCE **TEMPORARY** INCLUDING (BUT NOT LIMITED TO) USE OF WATER, MULCH, OR CHEMICAL DUST EXISTING TREES (7) ALONG SOIL STOCKPILE ADHESIVES AND CONTROL OF CONSTRUCTION SITE TRAFFIC. FENCE TO BE REMOVED B. EFFLUENT FROM DEWATERING OPERATIONS SHALL BE FILTERED OR PASSED THROUGH AND REPLACED BY HOWARD COUNTY SOIL CONSERVATION DISTRICT NOTES AN APPROVED SEDIMENT TRAPPING DEVICE, OR BOTH, AND DISCHARGED IN A MANNER LEYLAND CYPRESS, SEE LS-2 ----THAT DOES NOT ADVERSELY AFFECT ADJACENT PROPERTIES, WETLANDS, WATERWAYS OR THE STORM DRAINAGE SYSTEM. SEAL: 1. ALL VEGETATIVE AND STRUCTURAL PRACTICES ARE TO BE INSTALLED ACCORDING TO THE PROPOSED SILT FENCE 9. THE CONTRACTOR IS RESPONSIBLE FOR INSTALLATION AND MAINTENANCE OF ANY SEE DETAIL 2/C-5 PROVISIONS OF THIS PLAN AND ARE TO BE IN CONFORMANCE WITH THE MOST CURRENT ADDITIONAL CONTROL MEASURES NECESSARY TO PREVENT EROSION AND PROPOSED 12' CHIP AND A PROPOSED CINGULAR MARYLAND STANDARDS AND SPECIFICATIONS FOR SOIL EROSION AND SEDIMENT CONTROL AND SEDIMENTATION AS DETERMINED NECESSARY BY THE PLAN APPROVING AUTHORITY. TAR ACCESS DRIVE REVISIONS THERETO. 10'x20' SHELTER TEMPORARY EROSION AND SEDIMENT CONTROL MEASURES ARE NOT TO BE REMOVED UNTIL ALL DISTRUBED AREAS ARE STABILIZED. AFTER STABILIZATION IS COMPLETE, 2. THE DEVELOPER IS RESPONSIBLE FOR THE ACQUISITION OF ALL EASEMENTS, RIGHTS AND/OR ALL MEASURES SHALL BE REMOVED WITHIN 30 DAYS. TRAPPED SEDIMENT SHALL BE PROPOSED 8' CHAIN SPREAD AND SEEDED. RIGHTS OF WAY THAT MAY BE REQUIRED FOR GRADING AND/OR WORK ON ADJACENT LINK FENCE, SEE 1/C-6-PROPERTIES AFFECTED BY THIS PLAN. **SEQUENCE OF CONSTRUCTION** PROPOSED RETAINING WALL TASK <u>DESCRIPTION</u> * See Note 20 of General Notes, Sheet 1 OBTAIN GRADING PERMIT CONSTRUCT STABILIZED CONSTRUCTION ENTRANCE CONSTRUCT SILT FENCE -EXISTING CONCRETE SLAB START OF SILT FENCE -CONSTRUCT RETAINING WALL AND MONOPOLE A PROPOSED CINGULAR. FINISH GRADE WITHIN THE SITE ICE BRIDGE EXISTING BUILDING INSTALL EQUIPMENT EXISTING CMU -CONSTRUCT FENCE RETAINING WALL MATCHLINE A STABILIZE WITH TOPSOIL, FERTILIZER AND SEED REMOVE SEDIMENT CONTROL PRACTICES ONLY WITH PERMISSION FROM SEDIMENT CONTROL INSPECTOR EXISTING CMU RETAINING WALL-TOP WALL EL. = 432.1' BOTTOM GRADE EL. = 426.2' **SYMBOLS** SF = SILT FENCE EXISTING HANDICAP RAME — TPF — TPF — TPF = TREE PROTECTION FENCE — lod —— lod — LOD = LIMITS OF DISTURBANCE DA1 = DRAINAGE AREA 1DA2 = DRAINAGE AREA 2— P —— P —— POWER TELEPHONE EXISTING TEL. POLE GE81640 **CUT & FILL TABLE** 40 CY PROPOSED UNDERGROUND - END OF EXISTING TAR & CHIP POWER & TELEPHONE CONDUITS DRIVEWAY, SEE C-1 GRAVEL: 32 CY TO UTILITY POLAS CALL "MISS UTILITY" AT 1-800-257-7777, 48 HOURS PRIOR TO THE START OF WORK. THE EXCAVATOR MUST NOTIFY ALL PUBLIC UTILITY COMPANIES WITH UNDER GROUND FACILITIES IN THE AREA OF PROPOSED EXCAVATION AND HAVE THOSE FACILITIES LOCATED BY THE UTILITY COMPANIES PRIOR TO COMMENCING EXCAVATION. NOTE: **APPROVALS** THIS CERTIFIES THE PROPOSED CINGULAR CHANGES TO EXISTING - EXISTING POWER - PROPOSED 14' CHIP AND SITE PLAN NOTED BY A. **DEPARTMENT OF PLANNING AND ZONING** TAR ACCESS DRIVE POLE BGE 22568 THIS DOES NOT APPLY TO ANY OTHER INFORMATION. MATCHLINE A SHEET NUMBER: **EROSION CONTROL PLAN** 11/24/07



1575 Eye Street, N.W. Suite 350 **WASHINGTON, D.C. 20005** PHONE: (202)408-0960 FAX: (202)408-0961

R	EVISION BLOCK	
DATE	DESCRIPTION	REV.
5/14/04	ADD CINGULAR ANTENNA AND EQUIP. SHELTER	51
	AND EQUIP. SHELTER	



APC REALTY AND EQUIPMENT CO., LLC SPRINT PCS

CAPITAL DISTRICT

1015.184 ROJECT NO: **ESIGNER** TMF ENGINEER: C.T. GRAPHIC SCALE IN INCHES

> PINE ORCHARD **GLENN MULLINIX WA54XC459B 10256 BALTIMORE**

NATIONAL PIKE ELLICOTT CITY, MD 21042

EROSION CONTROL PLAN

5 OF 13

C-4

PERMANENT SEEDING SPECIFICATIONS SITE SPECIFIC SEEDING MIXTURES


MINIMUM CARE LAWN	TOTAL LBS. PER ACRE
COMMERCIAL OR RESIDENTIAL	175-200 LBS.
KENTUCKY 31 OR TURF-TYPE TALL FESCUE	95-100%
IMPROVED PERENNIAL RYEGRASS	0-5%
KENTUCKY BLUEGRASS	0-5%
HIGH MAINTENANCE LAWN	
	200-250 LBS.
KENTUCKY 31 OR TURF-TYPE TALL FESCUE	100%
GENERAL SLOPE (3:1 OR LESS)	TOTAL LBS. PER ACRE
KENTUCKY 31 TALL FESCUE	128 LBS.
REDTOP GRASS	2 LBS.
SEASONAL NURSE CROP *	20 LBS.
	150 LBS.
LOW MAINTENANCE SLOPE (STEEPER THAN 3:1)	TOTAL LBS. PER ACRE
KENTUCKY 31 TALL FESCUE	108 LBS.
RED TOP GRASS	2 LBS.
SEASONAL NURSE CROPE *	20 LBS.
CROWNVETCH **	20 LBS.
	150 LBS.

TOPSOIL SPECIFICATIONS:

FOR SITES HAVING DISTURBED AREAS UNDER 5 ACRES SOIL TO BE USED AS TOPSOIL MUST MEET THE FOLLOWING:

1. TOPSOIL SHALL BE A LOAM, SANDY LOAM, CLAY LOAM, SILT LOAM, SANDY CLAY LOAM, LOAMY SAND. OTHER SOILS MAY BE USED IF RECOMMENDED BY AN AGRONOMIST OR SOIL SCIENTIST AND APPROVED BY THE APPROPRIATE APPROVAL AUTHORITY. REGARDLESS, TOPSOIL SHALL NOT BE A MIXTURE OF CONTRASTING TEXTURED SUBSOILS AND SHALL CONTAIN LESS THAN 5% BY VOLUME OF CINDERS, STONES, SLAG, COARSE FRAGMENTS, GRAVEL STICKS, ROOTS, TRASH, OR OTHER MATERIALS LARGER THAN 1 1/2" IN DIAMETER.

- 2. TOPSOIL MUST BE FREE OF PLANTS OR PLANT PARTS SUCH AS BERMUDA GRASS, QUACKGRASS, JOHNSONGRASS, NUTSEDGE, POISON IVY, THISTLE, OR OTHERS AS SPECIFIED.
- 3. WHERE THE SUBSOIL IS EITHER HIGHLY ACIDIC OR COMPOSED OF HEAVY CLAYS, GROUND LIMESTONE SHALL BE SPREAD AT THE RATE OF 4-8 TONS/ACRE (200-400 POUNDS PER 1,000 SQUARE FEET) PRIOR TO THE PLACEMENT OF TOPSOIL. LIME SHALL BE DISTRIBUTED UNIFORMLY OVER DÉSIGNATED AREAS AND WORKED INTO THE SOIL IN CONJUNCTION WITH TILLAGE OPERATIONS AS DESCRIBED IN THE FOLLOWING PROCEDURES.
- 4. FERTILIZERS SHALL BE UNIFORM IN COMPOSITION, FREE FLOWING AND SUITABLE FOR ACCURATE APPLICATION BY APPROVED EQUIPMENT. MANURE MAY BE SUBSTITUTED FOR FERTILIZER WITH PRIOR APPROVAL FROM THE APPROPRIATE APPROVAL AUTHORITY. FERTILIZERS SHALL ALL BE DELIVERED TO THE SITE FULLY LABELED ACCORDING TO THE APPLICABLE STATE FERTILIZER LAWS AND SHALL BEAR THE NAME, TRADE NAME OR TRADEMARK AND WARRANTEE OF THE PRODUCT.
- 5. LIME MATERIALS SHALL BE GROUND LIMESTONE (HYDRATED OR BURNT LIME MAY BE SUBSTITUTED) WHICH CONTAINS AT LEAST 50% TOTAL OXIDES (CALCIUM OXIDE PLUS MAGNESIUM ÓXIDE). LIMESTONE SHALL BE GROUND TO SUCH FINENESS THAT AT LEAST 50% WILL PASS THROUGH A #100 MESH SIEVE AND 98-100% WILL PASS THROUGH A #20 MESH
- 6. INCORPORATE LIME AND FERTILIZER INTO THE TOP 3-5" OF SOIL BY DISKING OR OTHER SUITABLE MEANS.

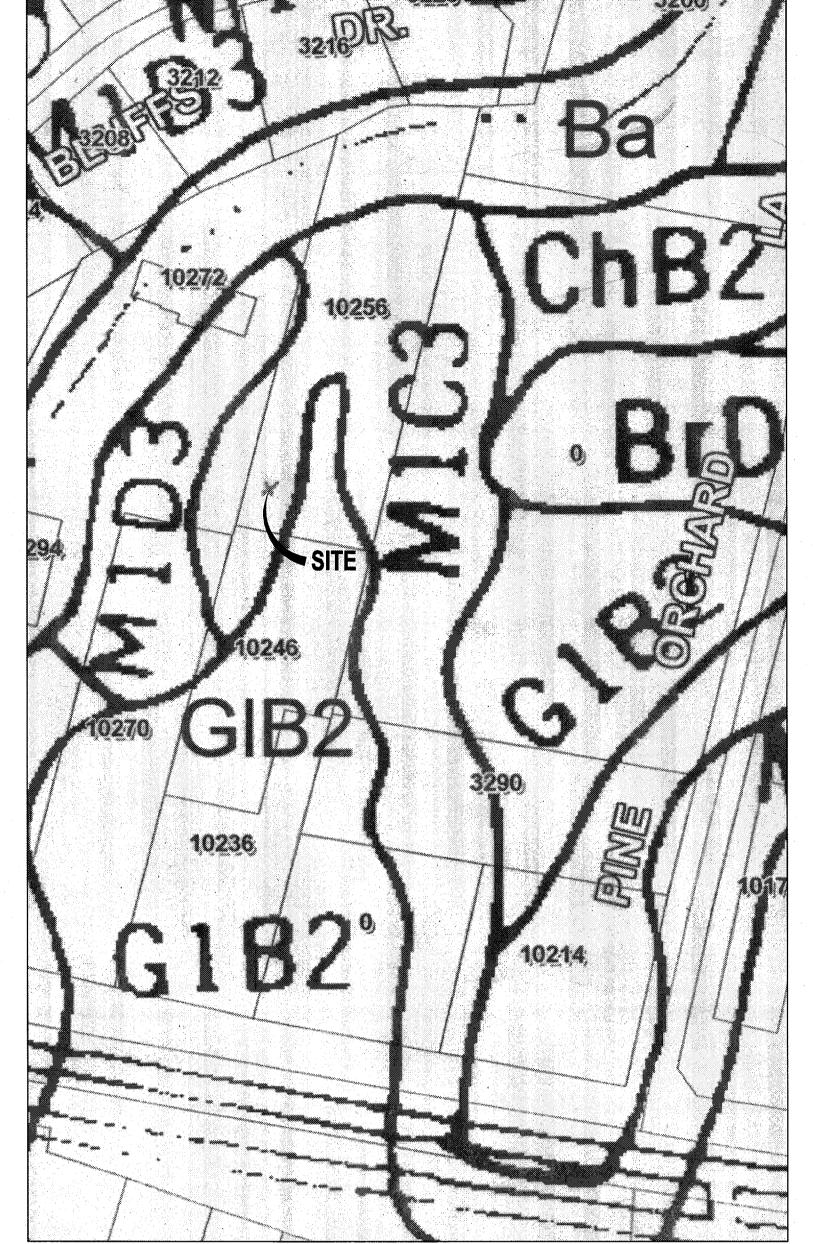


PROJECT SITE SOILS TYPE: M1C3 MANOR LOAM

SOILS MAP


SCALE: N.T.S.


LAYER OF FILTER FABRIC -JOINING FENCE SECTIONS

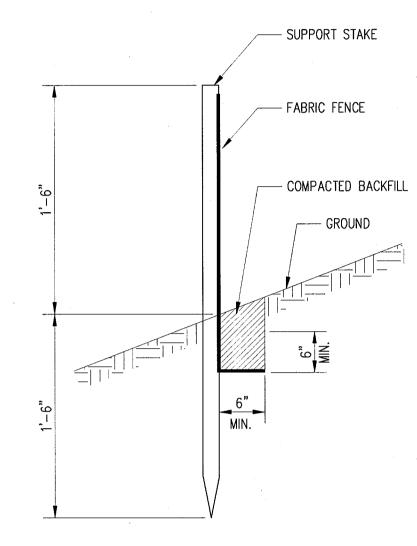


- 1. STAKES SPACED @ 8' MAXIMUM. USE 2"x2" WOOD OR EQUIVALENT STEEL
- 2. FILTER FABRIC FENCE MUST BE PLACED AT LEVEL EXISTING GRADE. BOTH ENDS OF THE BARRIER MUST BE EXTENDED AT LEAST 8 FEET UP SLOPE AT 45 DEGREES TO THE MAIN BARRIER ALIGNMENT. HEIGHT OF THE FENCE.
- 3. ANY SECTION OF FILTER FABRIC FENCE WHICH HAS BEE UNDERMINDED OR TOPPED MUST BE IMMEDIATELY REPLACED WITH A ROCK FILTER OUTLET.


SILT FENCE DETAIL SCALE: 1-1/2"=1'-0"

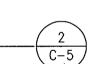


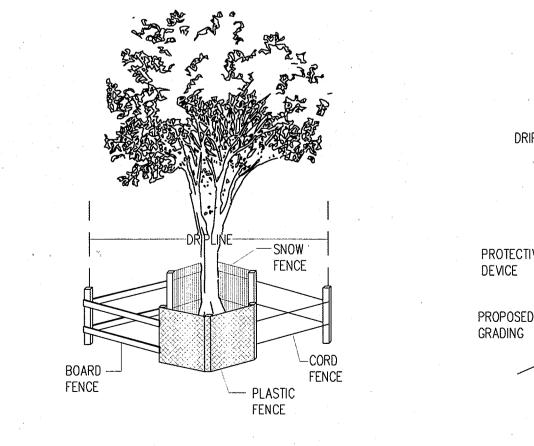

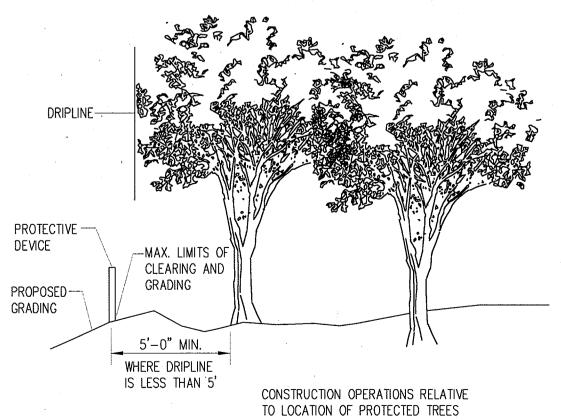

TREE PROTECTION BARRIER

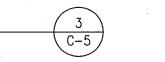

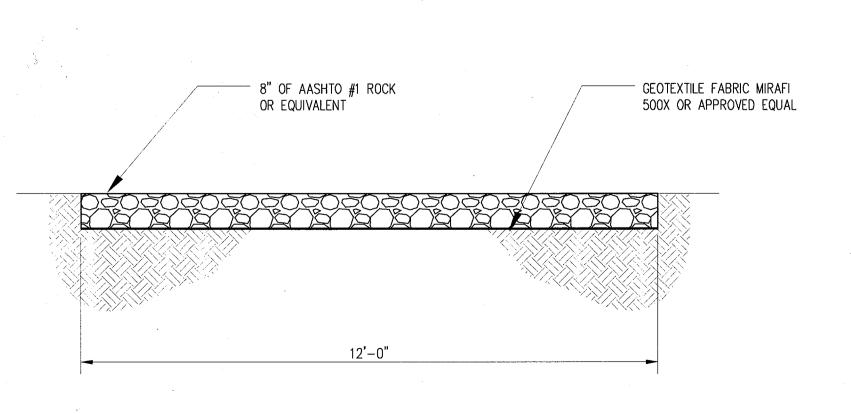


STABILIZED CONSTRUCTION ENTRANCE SCALE: 1/2"=1'-0"



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APC REALTY AND EQUIPMENT CO., LLC SPRINT PCS **CAPITAL DISTRICT**


PROJECT NO:	1015.184
DESIGNER:	J.D.S.
ENGINEER:	C.T.
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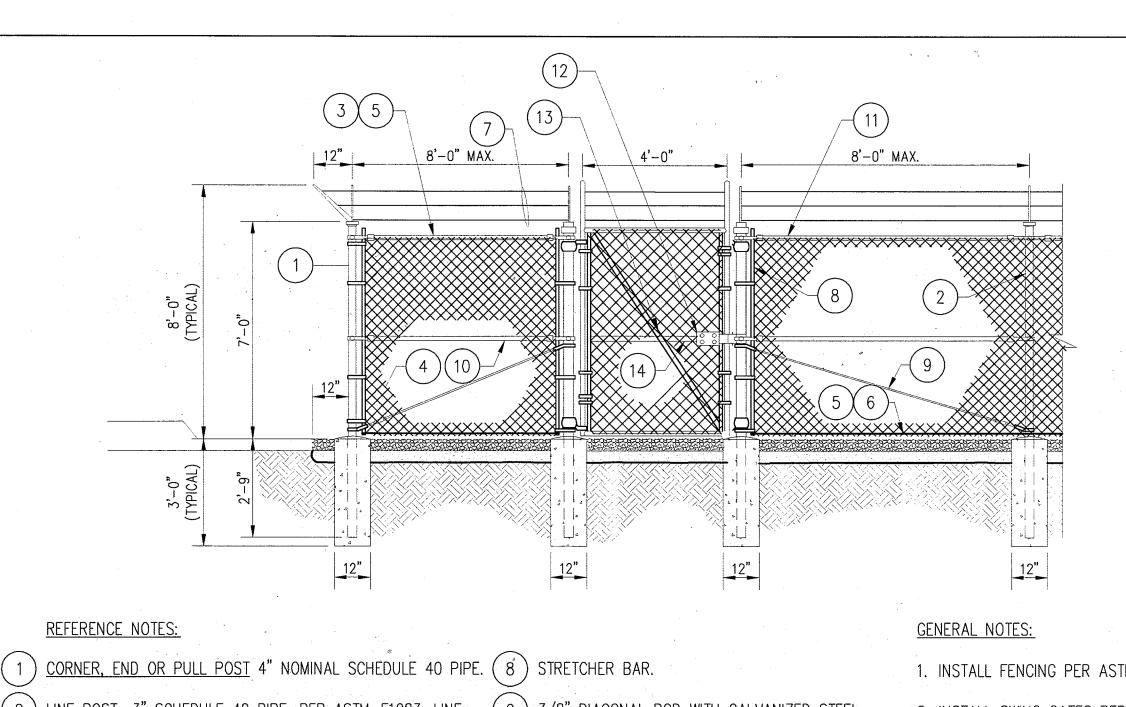
PINE ORCHARD **GLENN MULLINIX WA54XC459B** 10256 BALTIMORE **NATIONAL PIKE** ELLICOTT CITY, MD 21042

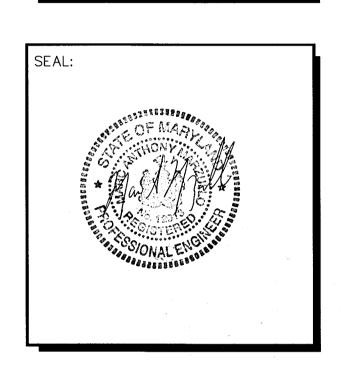CIVIL NOTES, MAPS **AND DETAILS**

6 OF 13 SHEET NUMBER:

C-5



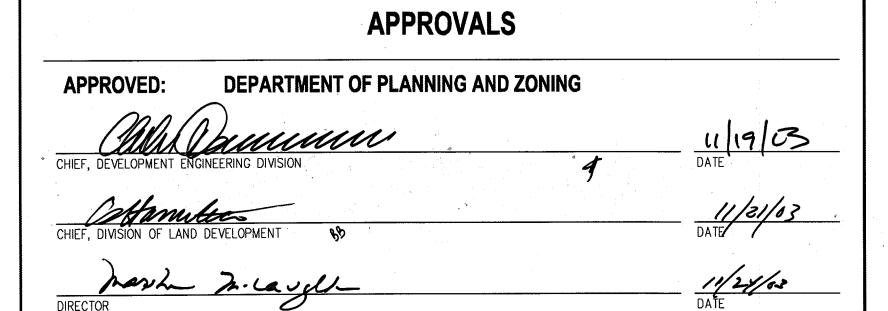



- 2 LINE POST: 3" SCHEDULE 40 PIPE, PER ASTM-F1083. LINE POSTS SHALL BE EQUALLY SPACED AT MAXIMUM 8'-0" O.C.
- (3) TOP RAIL & BRACE RAIL: 1 1/2" PIPE, PER ASTM-F1083.
- (4) FABRIC: 9 GA CORE WIRE SIZE 2" MESH, CONFORMING TO ASTM-A392.
- (5) TIE WIRE: MINIMUM 11 GA GALVANIZED STEEL AT POSTS AND RAILS A SINGLE WRAP OF FABRIC TIE AND AT TENSION WIRE BY HOG RINGS SPACED MAX. 24" INTERVALS.
- (6) TENSION WIRE: 9 GA. GALVANIZED STEEL.
- (7) BARBED WIRE: DOUBLE STRAND 12-1/2" O.D. TWISTED WIRE TO MATCH WITH FABRIC 14 GA, 4 PT. BARBS SPACED ON APPROXIMATELY 5" CENTERS.

- (9) 3/8" DIAGONAL ROD WITH GALVAŅIZED STEEL TURNBUCKLE OR DIAGONAL THREADED ROD.
- (10) FENCE CORNER POST BRACE: 1 5/8" DIA.
- EACH CORNER EACH WAY.
- (11) GATE FRAME: 1 1/2" PIPE, PER ASTM-F1083. (12) "MTS" MULTI-LOCKING DEVICE #MT-C6477, (O.F.C.I.)
- (13) GATE DIAGONAL GALVANIZED STEEL 1 1/2" PIPE.
- (14) GATE FRAME BRACE: 1 5/8" DIAMETER.

FENCE AND GATE DETAIL

- 1. INSTALL FENCING PER ASTM F-567
- 2. INSTALL SWING GATES PER ASTM F- 900
- 3. LOCAL ORDINANCE OF BARBED WIRE PERMIT REQUIREMENT SHALL BE COMPLIED IF REQUIRED.
- 4. POST & GATE PIPE SIZES ARE INDUSTRY STANDARDS. ALL PIPE TO BE 1 1/2" GALV. (HOT DIP, ASTM A120 GRADE "A" STEEL). ALL GATE FRAMES SHALL BE WELDED. ALL WELDING SHALL BE COATED WITH (3) COATS OF COLD GALV. (OR EQUAL).
- 5. ALL OPEN POSTS SHALL HAVE END-CAPS.

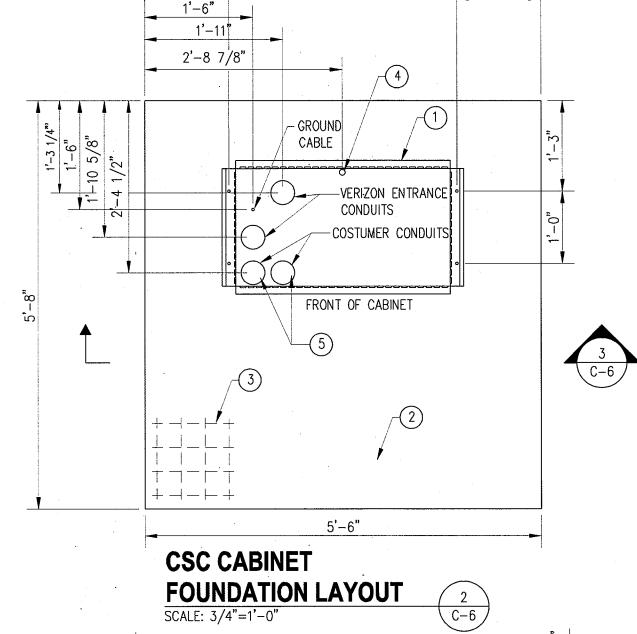


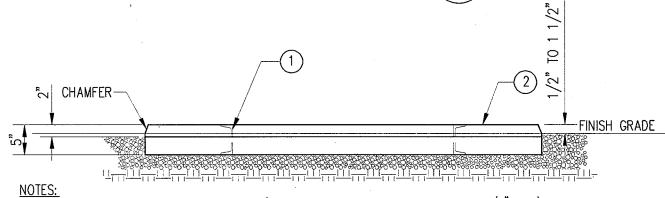

SECTION


SCALE: 3/4"=1'-0" C-6

- I. HUB FABRICATING PAD BASE FRAME P/N 60738.
 HUB FABRICATING COMPANY 100 GIBRALTOR ROAD, READING PA
- (610) 779-2200 2. ALL CONCRETE TO BE 4000 PSI AT 28 DAYS AND IN ACCORDANCE WITH ACI STANDARDS. 3. 6x6-W4.0 x W4.0 WELDED WIRE MESH AT MID DEPTH.
- . AC POWER CONDUIT (1" DIA.) SHALL BE 10 1/2" ±1/2" ABOVE GRADE.
 . TELCO CONDUIT (4" DIA.) SHALL BE
 - 7 1/2" ±1/2" ABOVE GRADE. 6. THE APPROXIAMTE WEIGHT OF FOUNDATION IS 2620#. 7. CHAMFERED CORNERS SHALL BE FINISHED WITH EDGING TOOL.

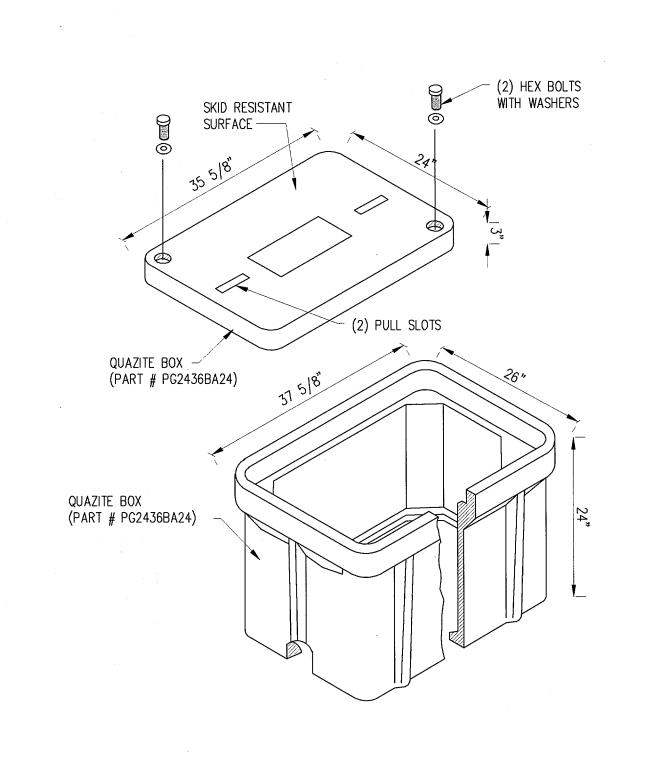

HANDHOLE QUAZITE BOX SCALE: 3/4"=1'-0"

 $\begin{pmatrix} 4 \\ C-6 \end{pmatrix}$

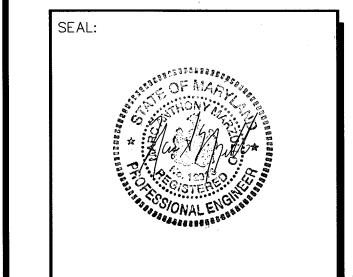

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REVISION BLOCK

DESCRIPTION



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APC REALTY AND

EQUIPMENT CO., LLC

CAPITAL DISTRICT

PROJECT NO: 1015.184 DESIGNER: TMF ENGINEER: M.M. SCALE:

GRAPHIC SCALE IN INCHES

PINE ORCHARD **GLENN MULLINIX WA54XC459B 10256 BALTIMORE** NATIONAL PIKE ELLICOTT CITY, MD 21042

CIVIL DETAILS

7 OF 13 SHEET NUMBER:

C-6

SDP-03-125

CHAIN LINK FENCE -- LIMIT OF SURFACING - EXISTING GRADE #57 STONE --COMPACT SUBGRADE AND SURFACING TO 95% MAX. DRY DENSITY TO PRODUCE AN UNYIELDING SURFACE


> NOTE: LEASE AREA SHALL BE CLEARED AND GRUBBED. REMOVE UNSUITABLE LOOSE OR SOFT SOIL, ORGANIC MATERIAL OR RUBBLE TO FIRM GRADE. FILL UNCERCUT AND COMPACT UP TO 6" BELOW FINISH GRADE. PLACE A MIRAFI 500X SOIL STABILIZATION FABRIC ON SUBGRADE. FILL WITH 6" OF AASHTO 57 STONE TO FINISH GRADE.


SITE COMPOUND SURFACING DETAIL SCALE: NOT TO SCALE





APPROVALS


DEPARTMENT OF PLANNING AND ZONING APPROVED:

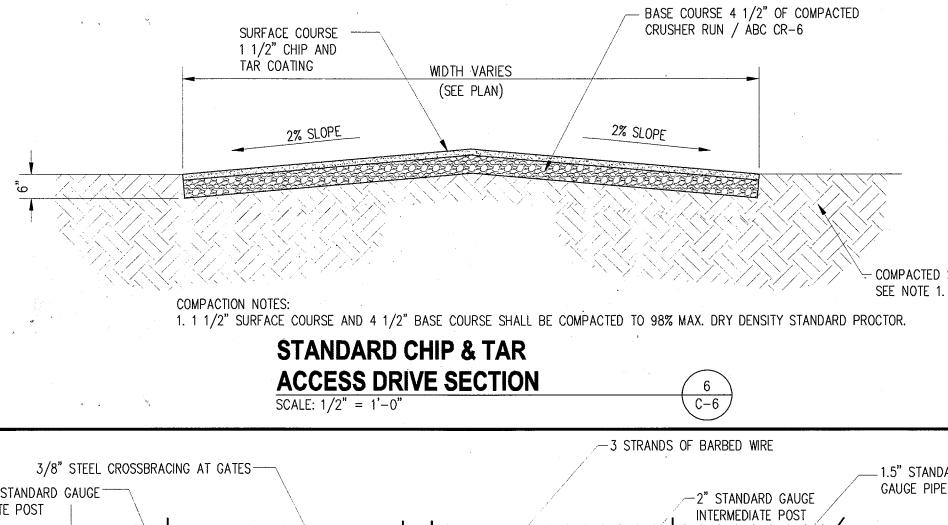

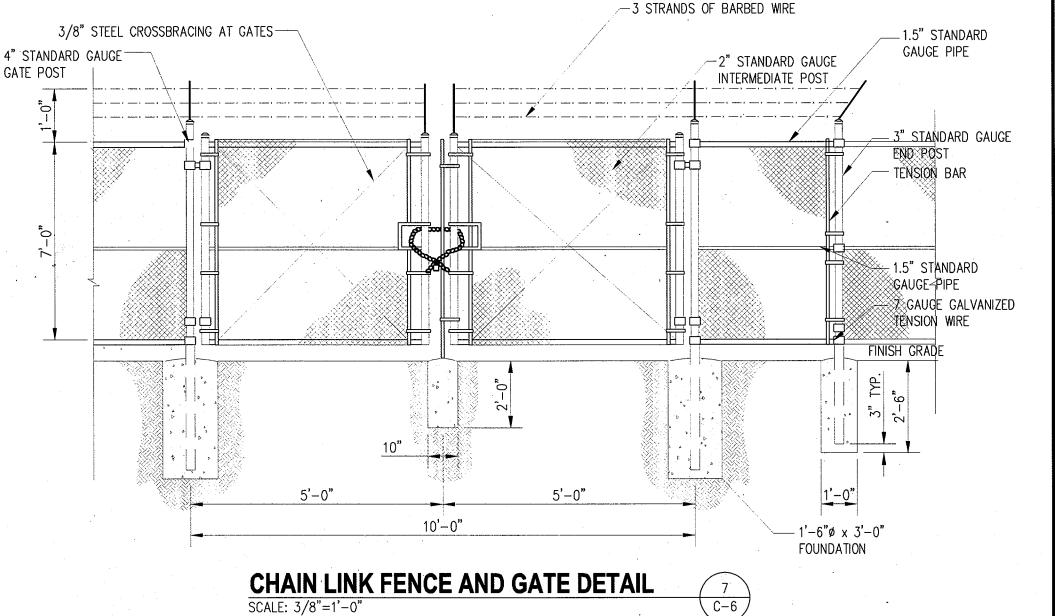

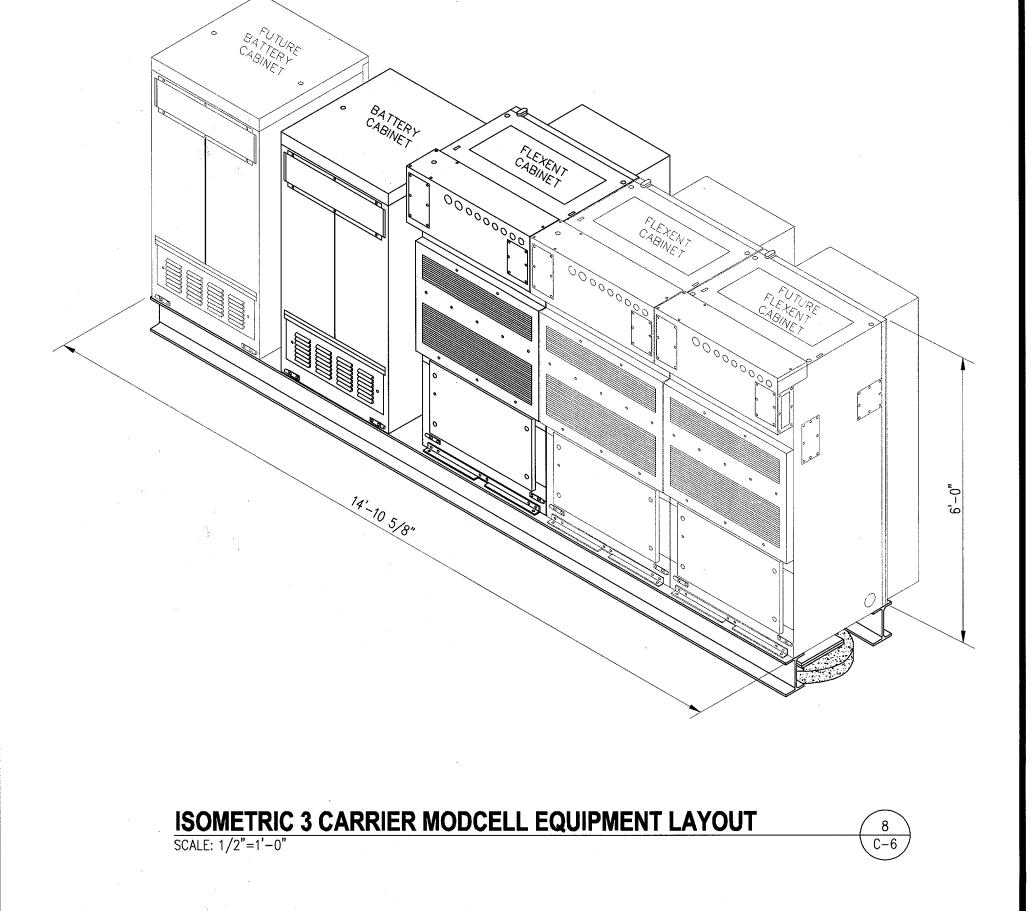

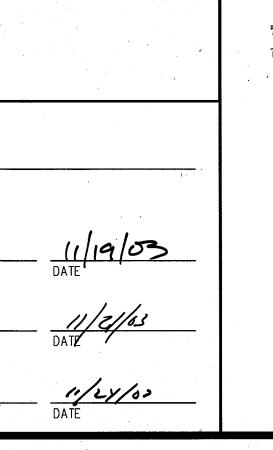

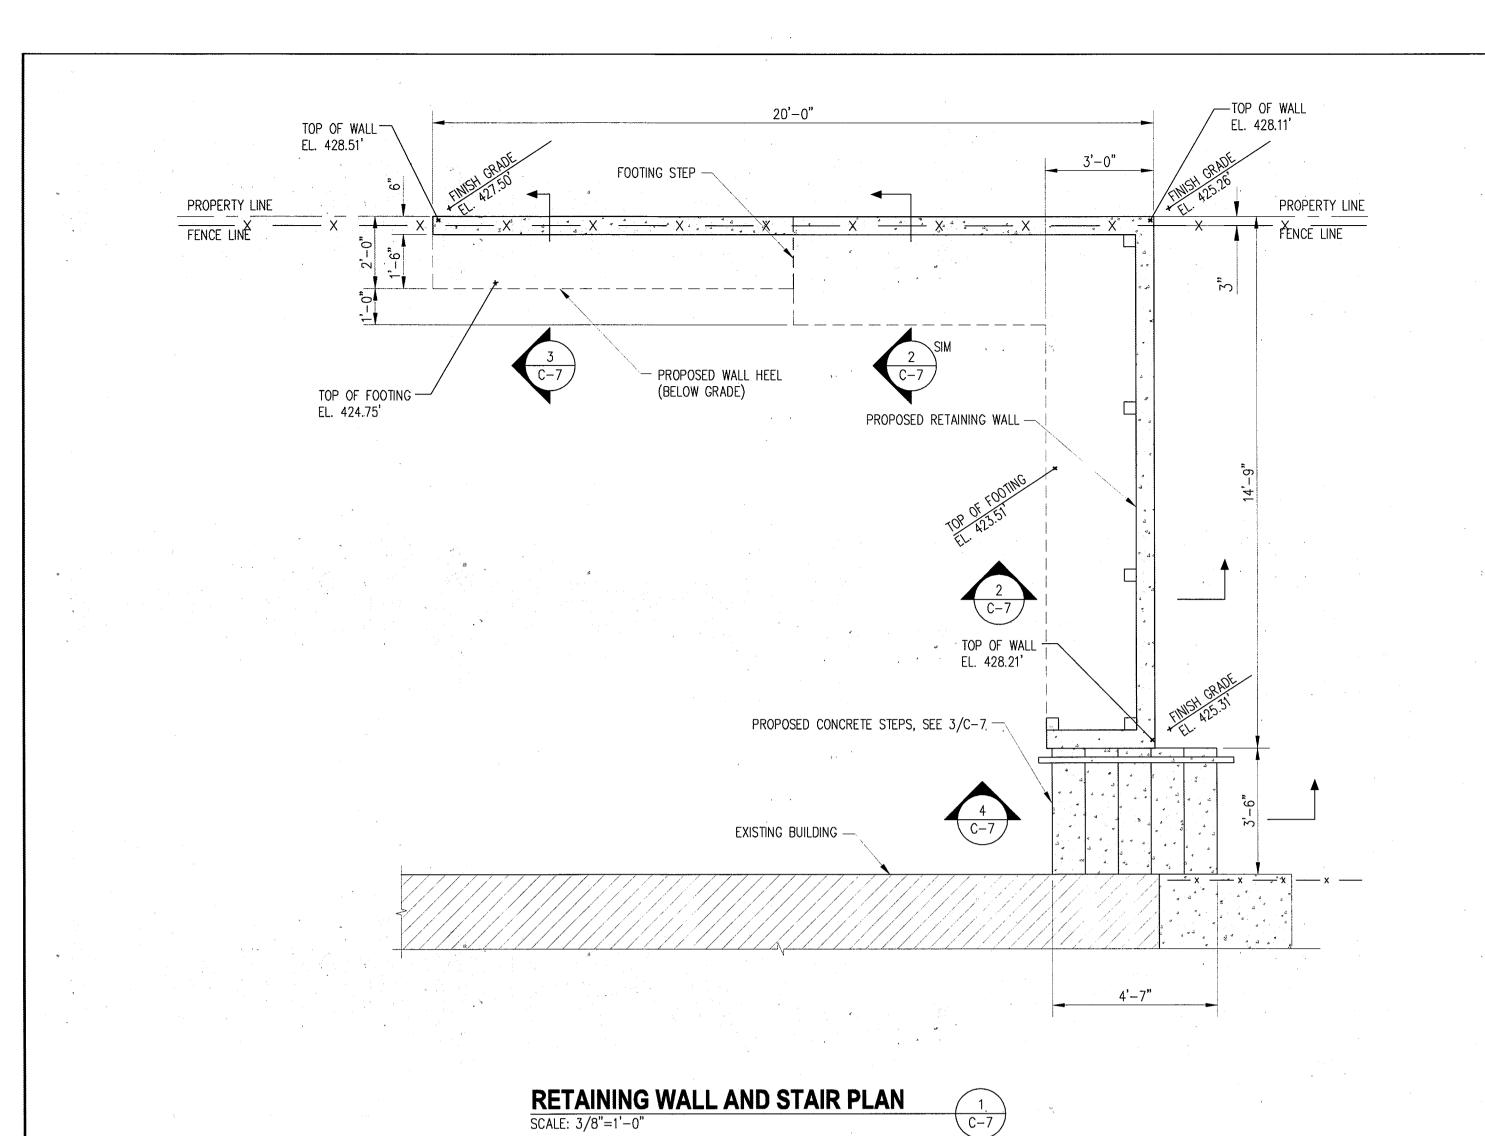


-- 4"x4" POST - SAND OR GRAVEL BACKFILL - #4 @ 16" O.C. VERTICAL - #4 @ 18" O.C. HORIZONTAL --- 2-1/2"ø PVC DRAIN TO FILTER SCREEN FOR DRAIN —— DAYLIGHT @ 48" O.C. #4 DOWELS @ 16" O.C. -LAP 2'-6" KEY 2" WIDE, 1" DEEP #4 @ 12" O.C. —

RETAINING WALL DETAIL



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APC REALTY AND EQUIPMENT CO., LLC d/b/a SPRINT PCS

CAPITAL DISTRICT

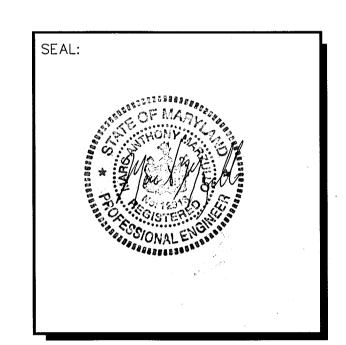PROJECT NO:	1015.184
DESIGNER:	TMF
ENGINEER:	M.M.
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PINE ORCHARD **GLENN MULLINIX** WA54XC459B **10256 BALTIMORE NATIONAL PIKE** ELLICOTT CITY, MD 21042


CIVIL DETAILS

8 OF 13


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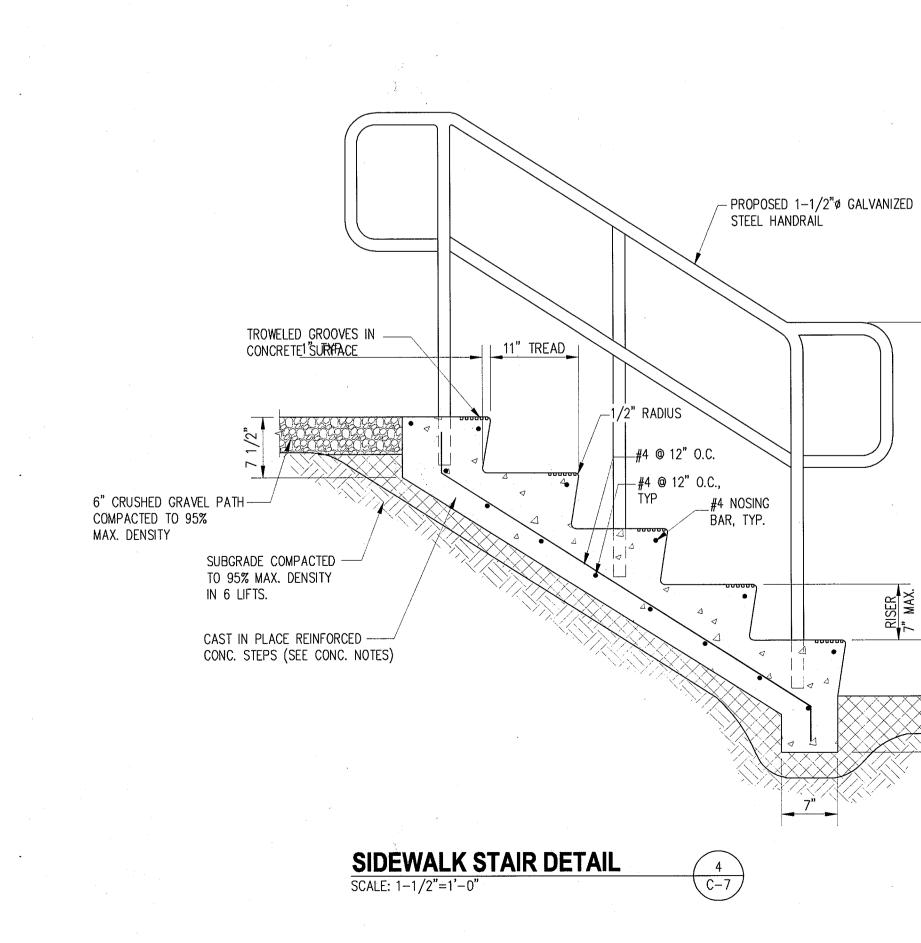
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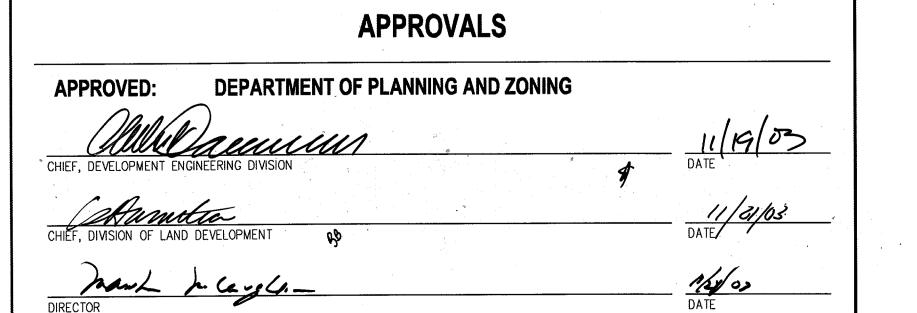
SDP-03-125



SAND OR GRAVEL BACKFILL — #4 @ 18" O.C. HORIZONTAL -2-1/2"ø PVC DRAIN TO DAYLIGHT @ 48" O.C. FILTER SCREEN -FOR DRAIN #4 DOWELS @ 16" O.C. —— LAP 2'-6" KEY 2" WIDE, 1" DEEP -#4 @ 12" O.C. — **RETAINING WALL DETAIL**

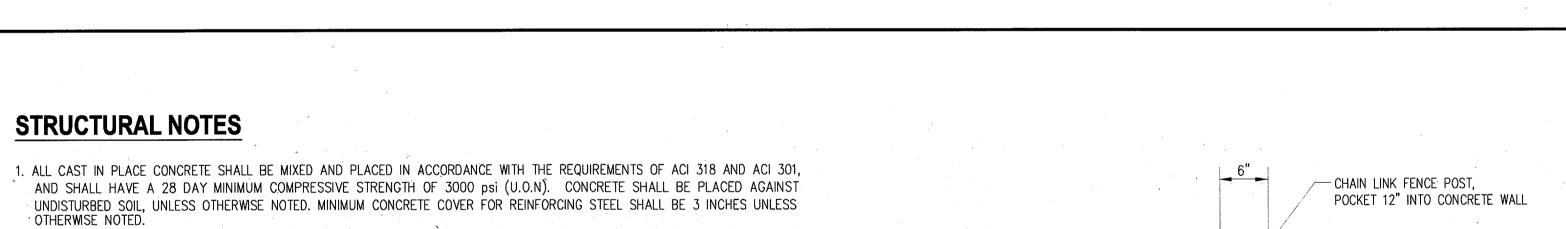



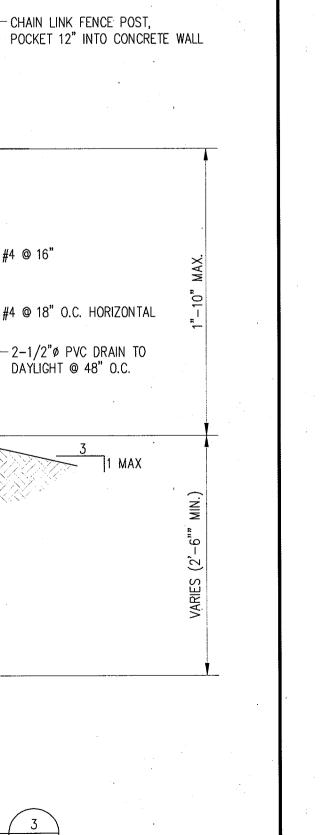


2. CONCRETE SHALL BE 4 TO 6 % AIR ENTRAINED.

SITE DEVELOPMENT PLAN.

3. ALL REINFORCING STEEL SHALL CONFORM TO ASTM 615 GRADE 60. DEFORMED BILLET STEEL BARS.

4. ASSUMED SOIL BEARING CAPACITY 2.0 KSF. A GEOTECHNICAL INVESTIGATION WILL BE PERFORMED AFTER APPROVAL OF THE

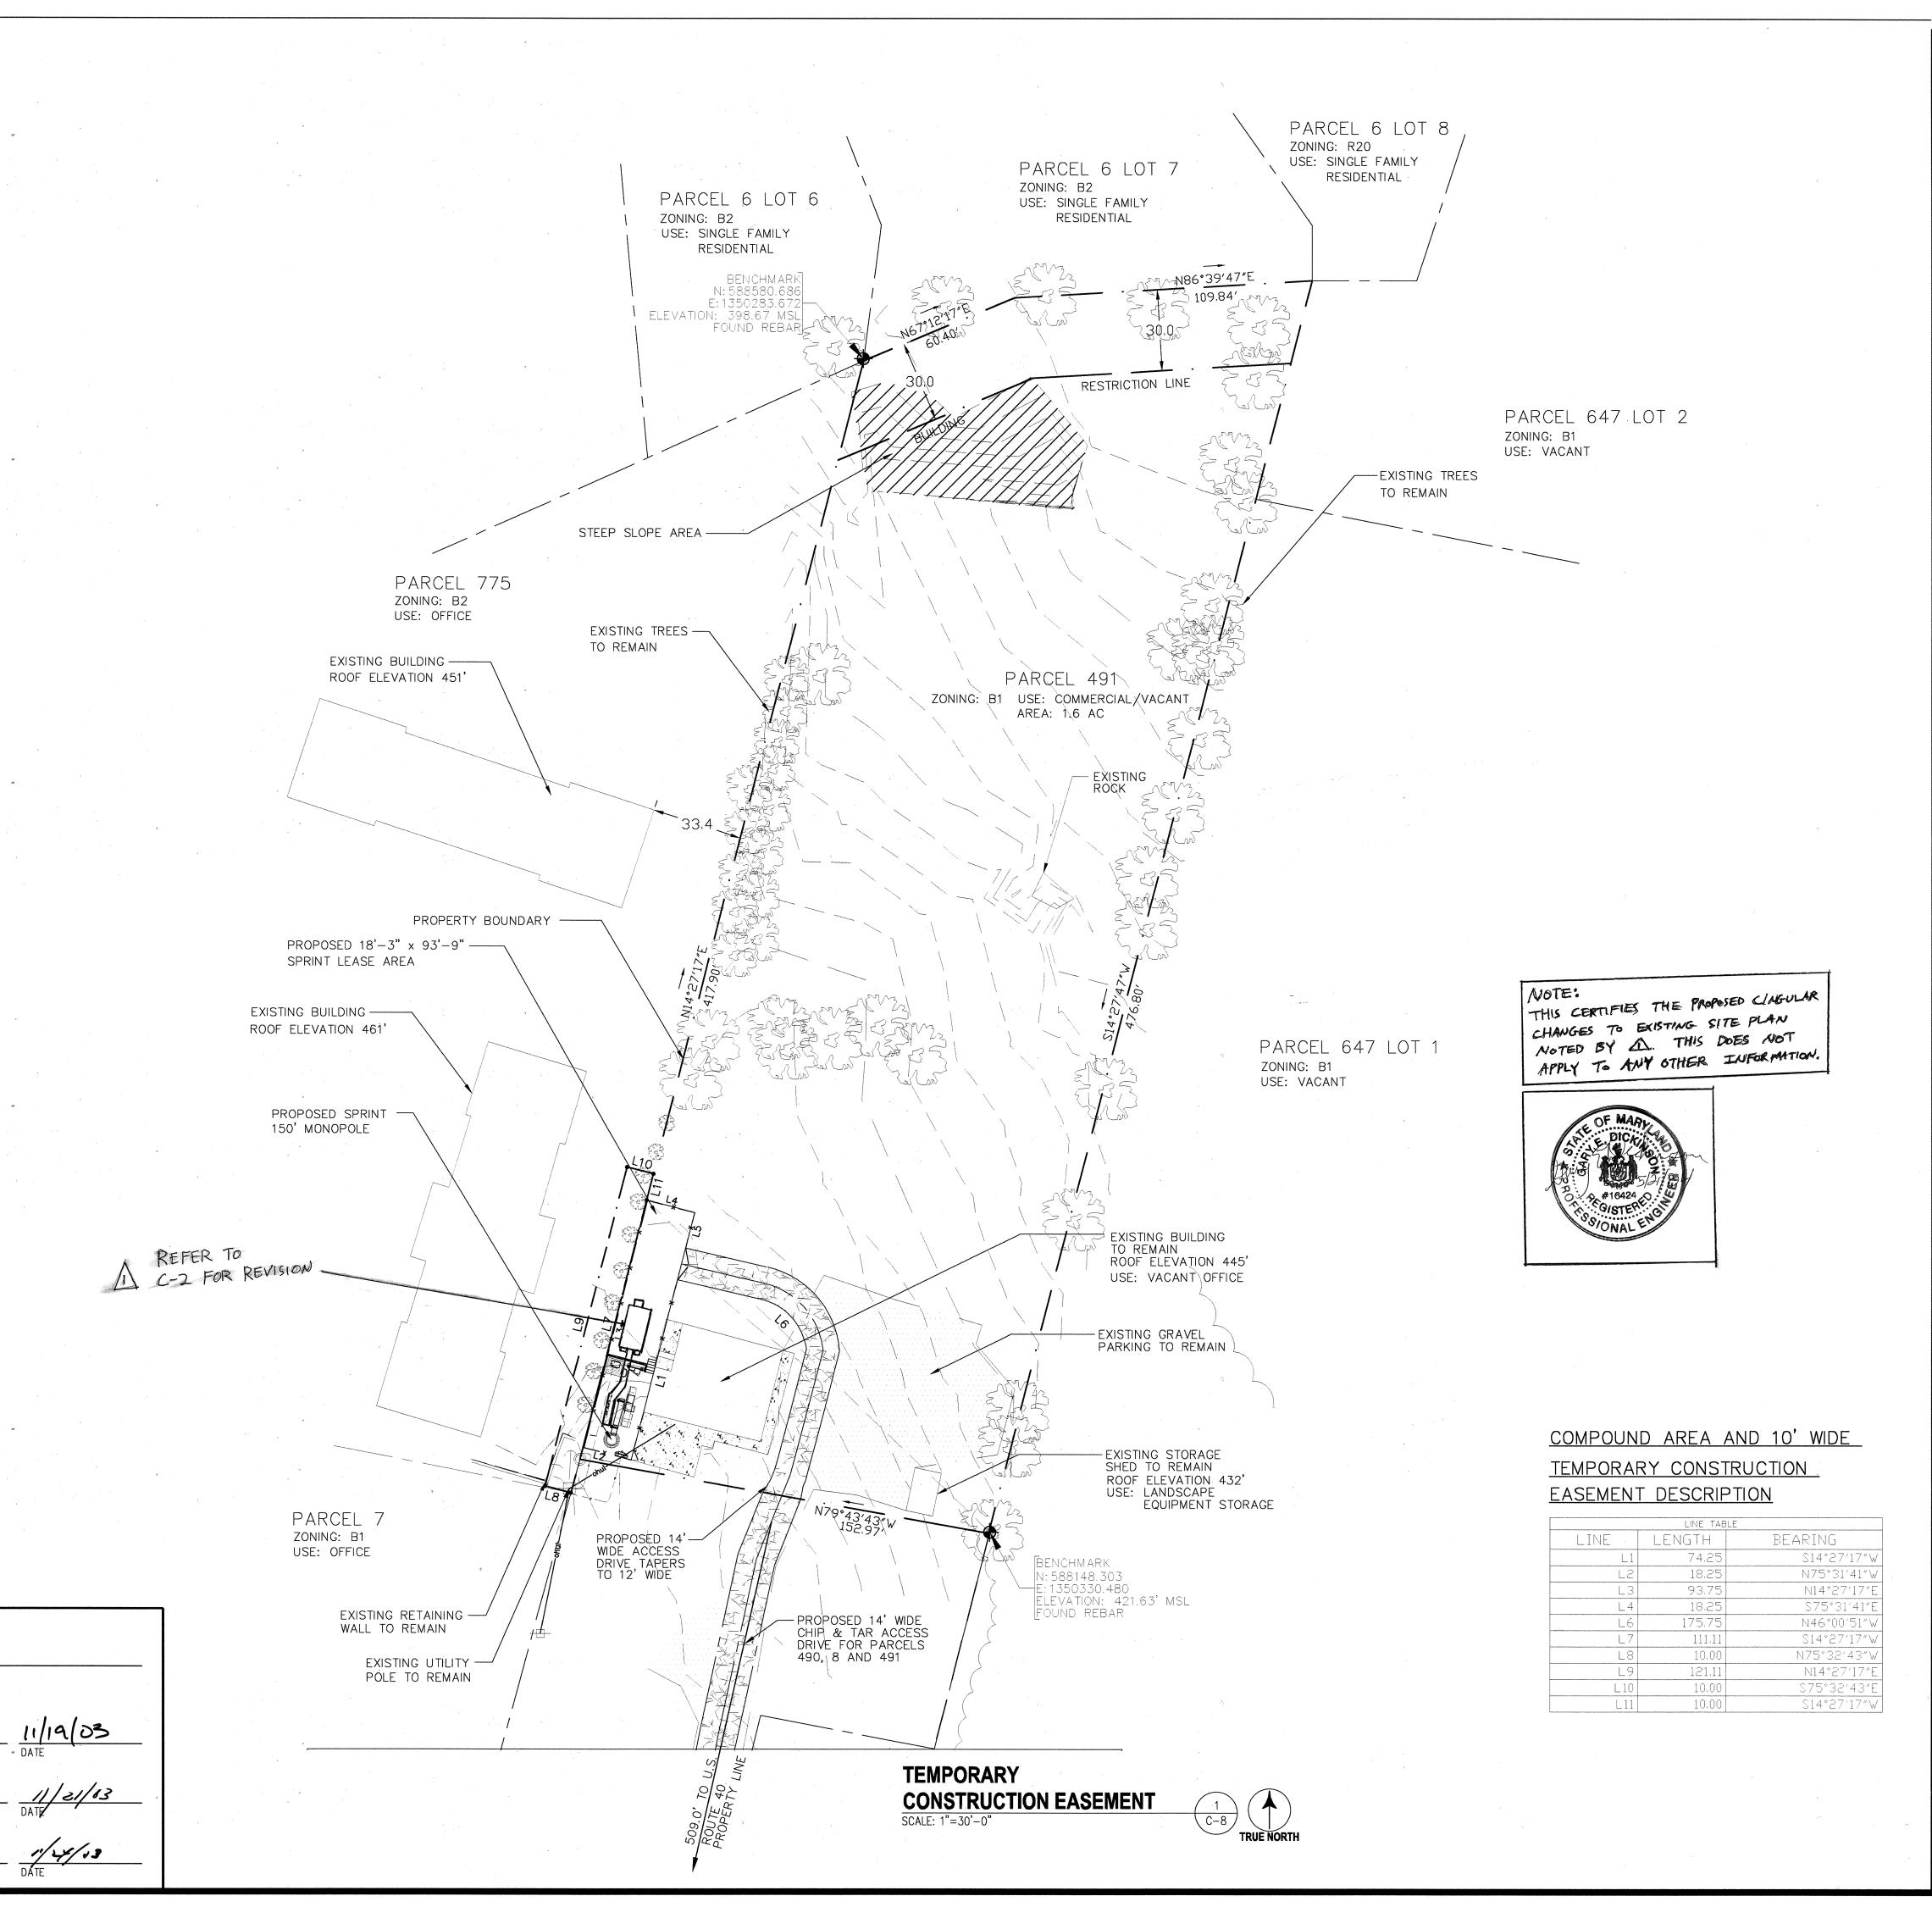

LEGAL DESCRIPTION FOR 10' WIDE TEMPORARY

FOLIO 83 CURRENTLY OWNED BY GLENN A.
MULLINIX, AND THE COMMON MOST WESTERLY
PROPERTY LINE OF PARCEL 647 LOT 1, AS
RECORDED IN DEED FOUND IN LIBER 2812, FOLIO

589 CURRENTLY OWNED BY JOHN ROMANIK

TRUSTEE; THENCE NORTH 46' 00' 51" WEST, A DISTANCE OF 175.75' TO A POINT ON THE MOST

WESTERLY PROPERTY LINE OF PARCEL 491, AND

AS RECORDED IN DEED FOUND IN LIBER 3136.

THE COMMON MOST EASTERLY LINE OF PARCEL 775,

FOLIO 285 CURRENTLY OWNED BY EARL D. COLLINS

& TERRELL A. FISHER, SAID POINT BEING THE TRUE

POINT OF BEGINNING OF A 10' WIDE TEMPORARY

THENCE SOUTH 14' 27' 17" WEST, A DISTANCE OF

SOUTHWESTERN CORNER OF PARCEL 775, AND THE COMMON NORTHWESTERN CORNER OF PARCEL 7, AS

THENCE NORTH 75' 32' 43" WEST, A DISTANCE OF 10.00' TO A POINT ON THE MOST NORTHERLY LINE

RECORDED IN DEED FOUND IN LIBER 5016, FOLIO

240 CURRENTLY OWNED BY GLENN A. MULLINIX;

OF PARCEL 7, AND COMMON SOUTHWESTERLY

THENCE, DEPARTING SAID PROPERTY LINE NORTH

14' 27" 17" EAST, A DISTANCE OF 121.11' TO A

THENCE SOUTH 75° 32' 43" EAST, A DISTANCE OF

THENCE, ALONG SAID LINE SOUTH 14' 27' 17" WEST, A DISTANCE OF 10.00' TO A POINT BEING THE TRUE

1,211.06 SQUARE FEET OR 0.0278 ACRES MORE OR

CELLULAR TOWER AND IS SUBJECT TO ALL MATTERS

OF PUBLIC RECORD. THE BEARINGS ARE STATE GRID

APPROVALS

DEPARTMENT OF PLANNING AND ZONING

LESS, IS DEDICATED TO THE CONSTRUCTION OF A

10.00' TO A POINT ON THE MOST EASTERLY PROPERTY LINE OF PARCEL 647 LOT 1, AND THE COMMON MOST WESTERLY PROPERTY LINE OF

THE ABOVE DESCRIBED PARCEL, CONTAINING

AND ALL DISTANCES ARE GROUND.

PROPERTY LINE OF PARCEL 775;

POINT;

PARCEL 491;

CHIEF, DIVISION OF LAND DEVELOPMENT

POINT OF BEGINNING;

111.11' TO A POINT, SAID POINT BEING THE

BEGINNING AT A POINT BEING A FOUND REBAR SAID POINT BEING THE SOUTHEAST CORNER OF PARCEL 491, AS RECORDED IN DEED FOUND IN LIBER 354,


CONSTRUCTION EASEMENT

CONSTRUCTION EASEMENT;



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APC REALTY AND

EQUIPMENT CO., LLC

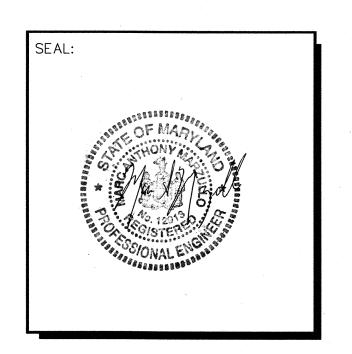CAPITAL DISTRICT

PROJECT NO:	1015.184
DESIGNER:	R.S.
ENGINEER:	C.T.
SCALE:	
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GRAPHIC	SCALE IN INCHES

PINE ORCHARD GLENN MULLINIX WA54XC459B 10256 BALTIMORE NATIONAL PIKE ELLICOTT CITY, MD 21042


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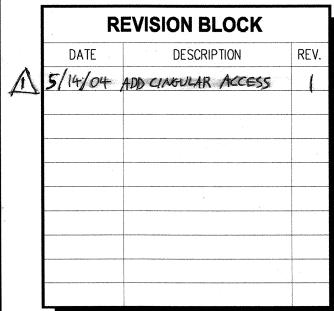
9 OF 13

C-8





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APC REALTY AND EQUIPMENT CO., LLC SPRINT PCS

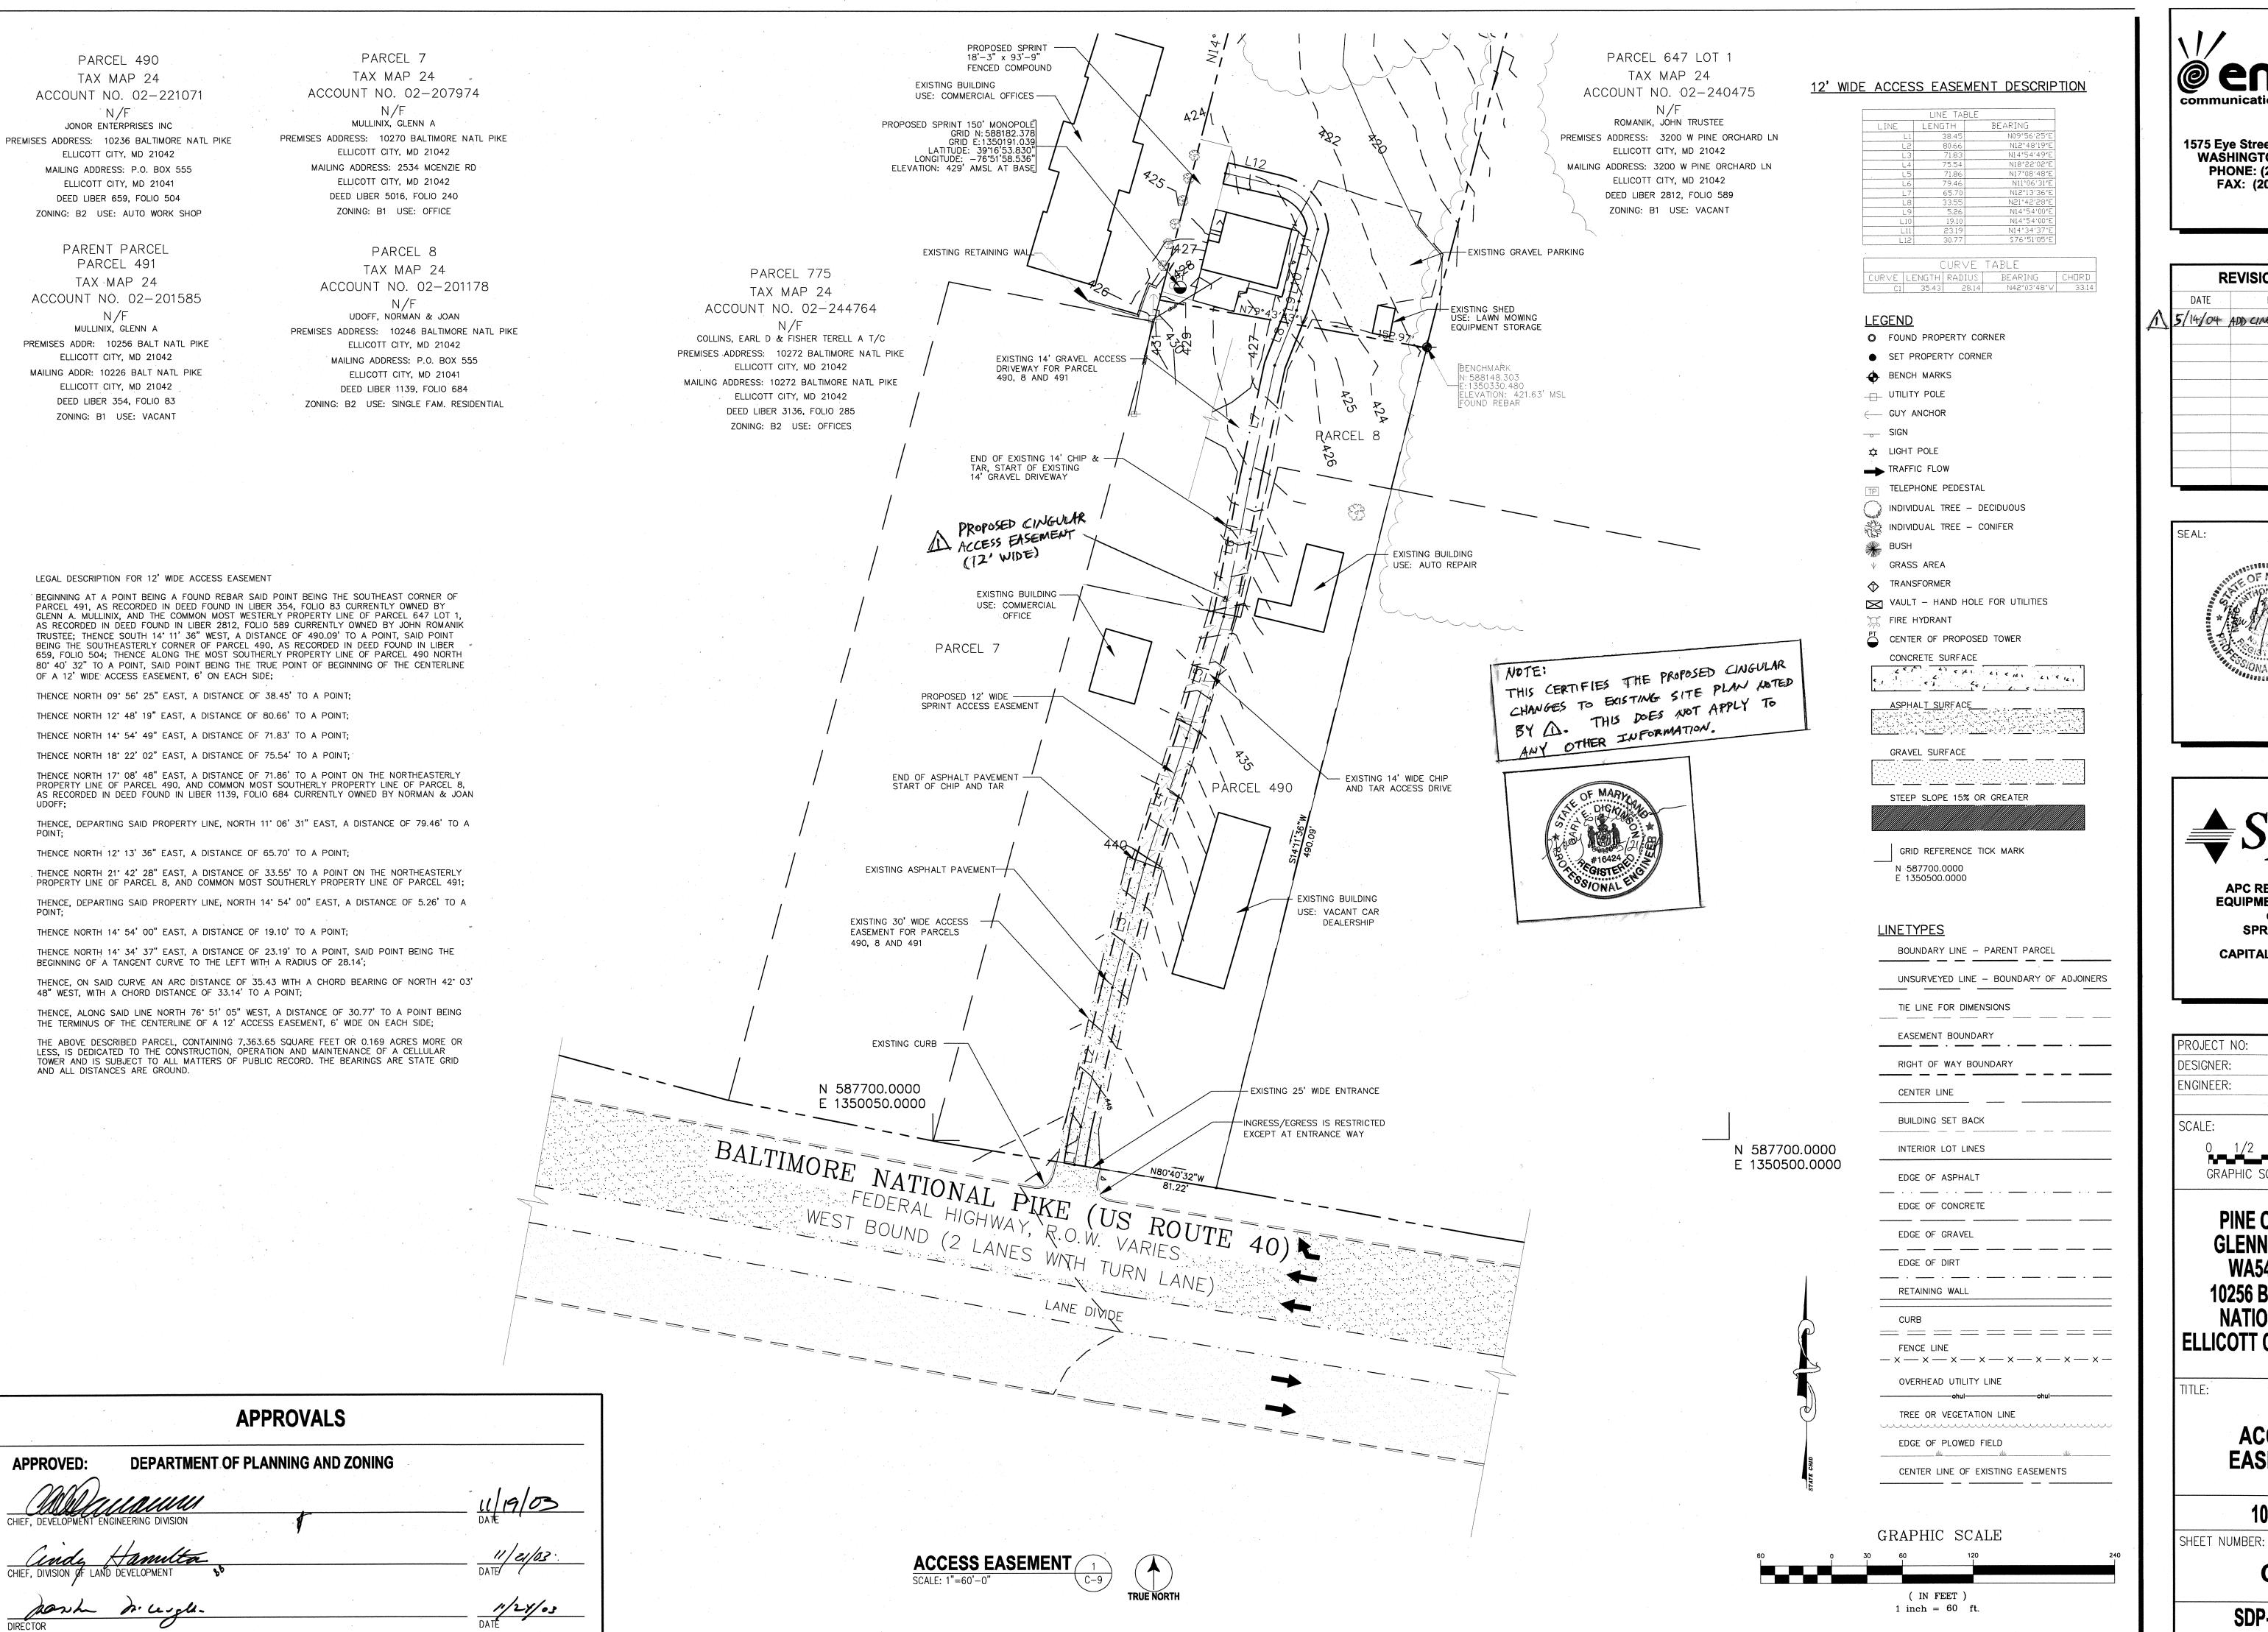CAPITAL DISTRICT

ROJECT NO: 1015.184 ESIGNER: R.S. ENGINEER: C.T. GRAPHIC SCALE IN INCHES PINE ORCHARD

GLENN MULLINIX WA54XC459B **10256 BALTIMORE** NATIONAL PIKE ELLICOTT CITY, MD 21042

TITLE:

ACCESS EASEMENT

10 OF 13

C-9

TREE INDEX LIST

TREE #	DIAMETER	COMMON NAME	SCIENTIFIC NAME	REMARKS
T1	2 1/2"	EASTERN WHITE PINE	PINUS STROBUS	TO BE REMOVED AND REPLACED BY HEDGE, SEE LS-2
T2	2 1/2"	EASTERN WHITE PINE	PINUS STROBUS	TO BE REMOVED AND REPLACED BY HEDGE, SEE LS-2
Т3	2 1/2"	EASTERN WHITE PINE	PINUS STROBUS	TO BE REMOVED AND REPLACED BY HEDGE, SEE LS-2
T4	2 1/2"	EASTERN WHITE PINE	PINUS STROBUS	TO BE REMOVED AND REPLACED BY HEDGE, SEE LS-2
T5	2 1/2"	EASTERN WHITE PINE	PINUS STROBUS	TO BE REMOVED AND REPLACED BY HEDGE, SEE LS-2
T6	2 1/2"	EASTERN WHITE PINE	PINUS STROBUS	TO BE REMOVED AND REPLACED BY HEDGE, SEE LS-2
T7	2 1/2"	EASTERN WHITE PINE	PINUS STROBUS	TO BE REMOVED AND REPLACED BY HEDGE, SEE LS-2
T8	2 1/2"	EASTERN WHITE PINE	PINUS STROBUS	10'-11" TALL, ON ABUTTING PROPERTY
T9	2 1/2"	EASTERN WHITE PINE	PINUS STROBUS	10'-11" TALL, ON ABUTTING PROPERTY
T10	2 1/2"	EASTERN WHITE PINE	PINUS STROBUS	10'-11" TALL, ON ABUTTING PROPERTY
T11	11"	TREE OF HEAVEN	AILANTHUS ALTISSIMA	FAIR CONDITION
T12	15"	FIRE CHERRY	PRUNIS PENNSYLVANICA	POOR CONDITION
T13	20"	RED MAPLE	ACER RUBRUM	GOOD CONDITION
T14	20"	EASTERN WHITE PINE	PINUS STROBUS	GOOD CONDITION
T15	20"	EASTERN WHITE PINE	PINUS STROBUS	GOOD CONDITION
T16	20"	EASTERN WHITE PINE	PINUS STROBUS	GOOD CONDITION
T17	27"(DOUBLE TRUNK)	RED MAPLE	ACER RUBRUM	FAIRL/POOR CONDITION
T18	22 1/2"	GREEN ASH	FRAXINUS PENNSYLVANICA	POOR CONDITION
T19	19"	GREEN ASH	FRAXINUS PENNSYLVANICA	FAIR CONDITION
T20	25 1/2"	GREEN ASH	FRAXINUS PENNSYLVANICA	FAIR CONDITION
T21	15 1/2"	GREEN ASH	FRAXINUS PENNSYLVANICA	FAIR CONDITION
T22	14"	TULIP POPULAR	LIRIODENDRON TULIPIFERA	GOOD CONDITION
T23	22 1/2"	BLACK WALNUT	JUGLANS NIGRA	FAIR/POOR CONDITION
T24	14 1/2"	BLACK WALNUT	JUGLANS NIGRA	GOOD CONDITION
T25	16"	BLACK WALNUT	JUGLANS NIGRA	FAIR CONDITION
T26	29 1/2"	TULIP POPULAR	LIRIODENDRON TULIPIFERA	POOR CONDITION
T27	14 1/2"	BLACK WALNUT	JUGLANS NIGRA	FAIR CONDITION
T28	26"	TULIP POPULAR	LIRIODENDRON TULIPIFERA	FAIR/GOOD CONDITION
T29	27 1/2"	TULIP POPULAR	LIRIODENDRON TULIPIFERA	FAIR/GOOD CONDITION
T30	29"(MULTI TRUNK)	SILVER MAPLE	ACER SACCHARUM	FAIR/POOR CONDITION
T31	19"	TULIP POPULAR	LIRIODENDRON TULIPIFERA	FAIR CONDITION
T32 *	33"	TULIP POPULAR	LIRIODENDRON TULIPIFERA	FAIR/POOR CONDITION
T33	23 1/2" (DOUBLE TRUNK)	RED MAPLE	ACER RUBRUM	POOR CONDITION
T34	19"(DOUBLE TRUNK)	RED MAPLE	ACER RUBRUM	POOR CONDITION
T35 *	33 1/2"	TULIP POPULAR	LIRIODENDRON TULIPIFERA	GOOD CONDITION
T36	18"	RED MAPLE	ACER RUBRUM	GOOD CONDITION
T37	8"	NORWAY SPRUCE JUNIPER	PICIA ABIES	POOR CONDITION
T38	HEDGE ROW 2" - 10"	TREE OF HEAVEN	AILANTHUS ALTISSIMA	FAIR CONDITION

NOTES: 1. TREES NOTED WITH AN ASTERISK (*) ARE SPECIMEN TREES

FOREST CONSERVATION WORKSHEET

TOTAL AFFORESTATION REQUIRED B-C

	ACRES (1/10 ACR
BASIC SITE DATA	
GROSS SITE AREA	1.6
AREA WITHIN 100 YEAR FLOODPLAIN	0
AREA WITHIN AGRICULTURAL USE OR PRESERVATION PARCEL (IF APPLICABLE)	0
NET TRACT AREA	1.6
LAND USE CATEGORY (R-RLD, R-RMD, R-S, C/I/O, I	C
INFORMATION FOR CALCULATIONS	
A. NET TRACT AREA	1.6
B. REFORESTATION THRESHOLD (15% x A)	0.24
C. AFFORESTATION MINIMUM (15% x A)	0.24
D. EXISTING FOREST ON NET TRACT AREA	0
E. FOREST AREAS TO BE CLEARED	0
F. FOREST AREAS TO BE RETAINED	0
AFFORESTATION CALCULATIONS	
A. NET TRACT AREA	1.6
B. AFFORESTATION MINIMUM (15% x A)	0.24
C. EXISTING FOREST ON NET TRACT AREA	0
D. FOREST AREAS TO BE CLEARED	0
E. FOREST AREAS TO BE RETAINED	0


	APPROVALS		
APPROVED:	DEPARTMENT OF PLANNING AND ZONING		
CHIEF, DEVELOPMENT EN	IGINEERING DIVISION	11 (19 (03) DATE	
CHIEF, DIVISION OF LAN	Hanulta D DEVELOPMENT 80	11/8//03 DATE	
Dark	a. Ceveli-	1/24/13	

CRE)

0.24 FEE IN LIEU REQUESTED FOR 0.24 AC OF AFFORESTATION

FEE IN LIEU REQUEST


ALL FOREST CONSERVATION PLAN OBLIGATIONS HAVE BEEN MET BY THE APPROPRIATE PAYMENT AND THE SITE CARRIES NO ADDITIONAL RESTRICTIONS RELATED TO SPECIFIC FOREST CONSERVATION REQUIREMENTS.

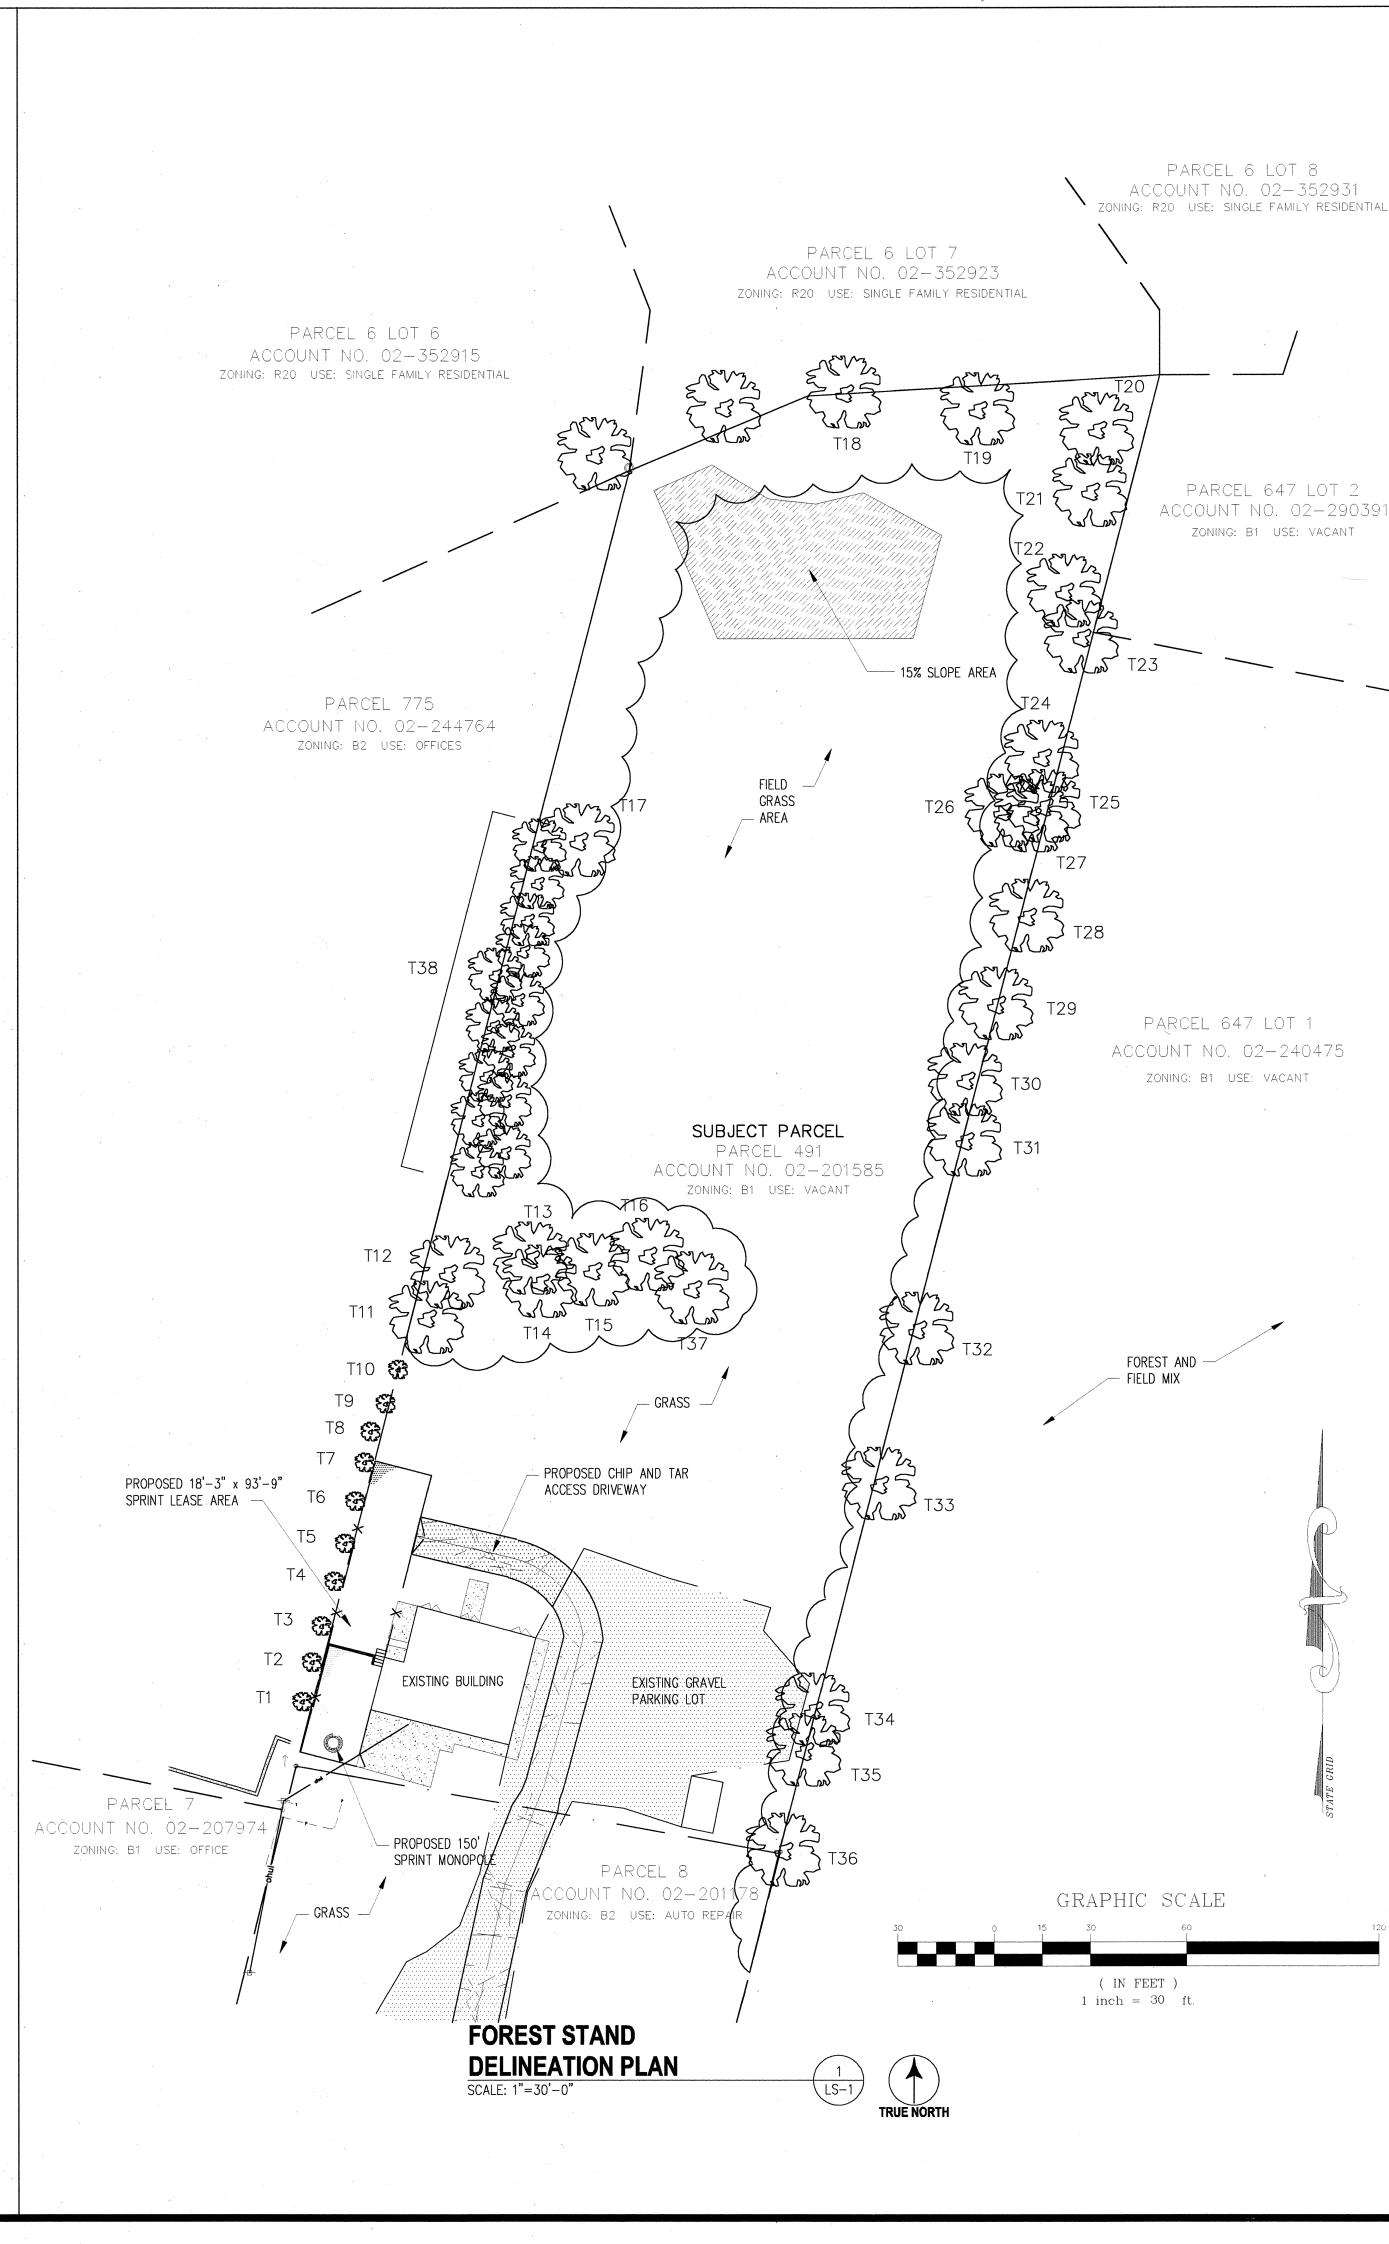




1575 Eye Street, N.W. Suite 350 WASHINGTON, D.C. 20005 PHONE: (202)408-0960 FAX: (202)408-0961

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GLEN WAS	ORCHARD N MULLINIX 54XC459B BALTIMORE
0 1/2 GRAPHIC	SCALE IN INCHES
SCALE:	:
ENGINEER:	C.T.
DESIGNER:	R.S.
PROJECT NO:	1015.184

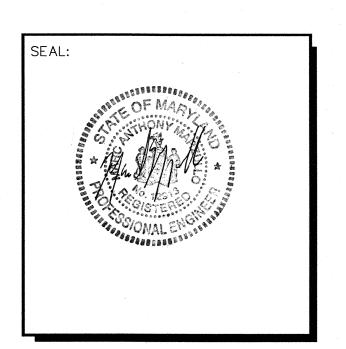
FOREST STAND **DELINEATION PLAN**

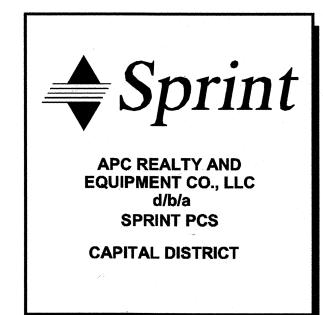ELLICOTT CITY, MD 21042

11 OF 13

SHEET NUMBER:


LS-1

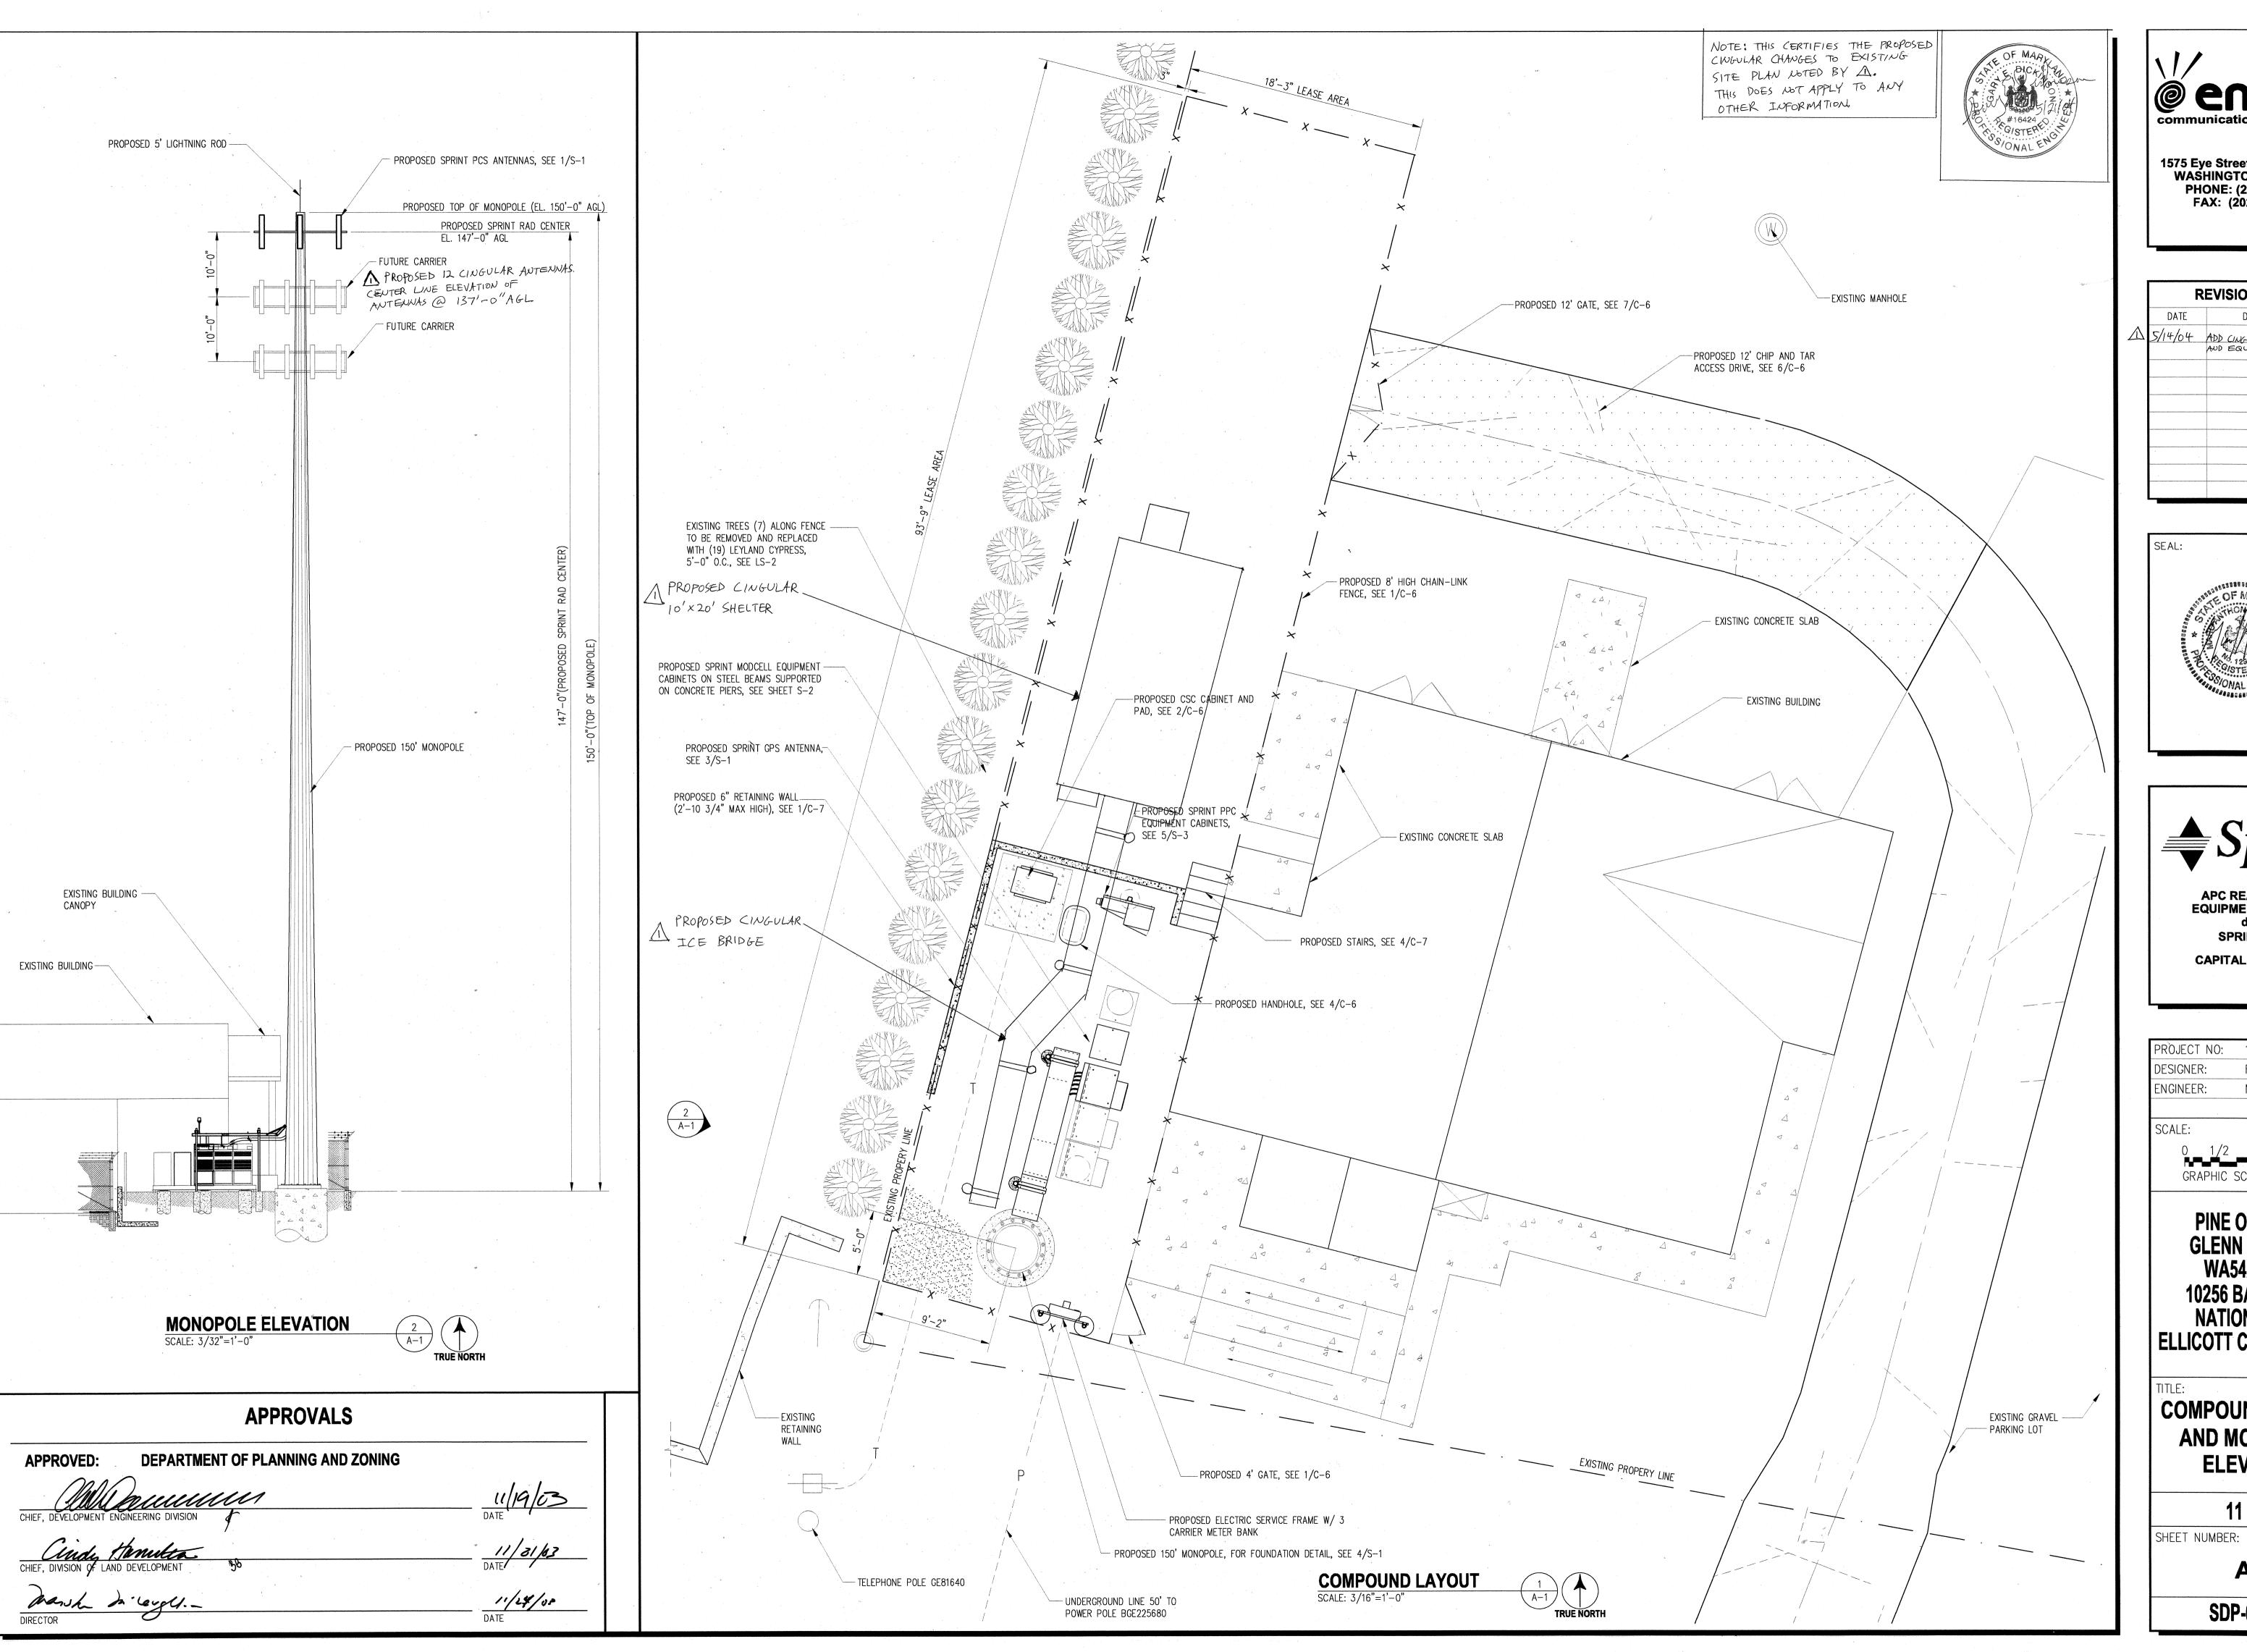



1575 Eye Street, N.W. Suite 350 WASHINGTON, D.C. 20005 PHONE: (202)408-0960 FAX: (202)408-0961

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Δ	5/14/04	ADD CINGULAR ANTENNAS AND EQUIP, SHELTER		
		1		

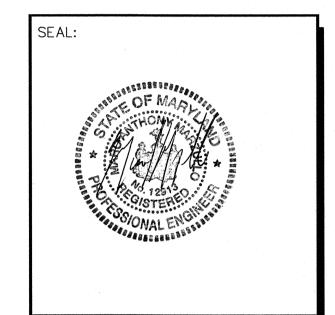



APC REALTY AND EQUIPMENT CO., LLC d/b/a SPRINT PCS

CAPITAL DISTRICT

PROJECT NO:	1015.184
DESIGNER:	F.Y.
ENGINEER:	M.M.

PINE ORCHARD GLENN MULLINIX WA54XC459B **10256 BALTIMORE NATIONAL PIKE** ELLICOTT CITY, MD 21042

COMPOUND LAYOUT AND MONOPOLE **ELEVATION**

11 OF 13

A-1

LANDSCAPING EDGES ADJACENT TO PERIMETER PROPERTIES

ADJACENT LAND USE: COMMERCIAL LANDSCAPE TYPE: A (LIGHT BUFFER) LENGTH ALONG PROPERTY LINE: 418FT PLANTING REQUIREMENT: 1 SHADE TREE/60FT x 418 = 7 SHADE TREES CREDIT IS TAKEN FOR 7 EXISTING SHADE TREES TO REMAIN.

PERIMETER NO. 2: ADJACENT LAND USE: RESIDENTIAL LANDSCAPE TYPE: C (HEAVY BUFFER) LENGTH ALONG PROPERTY LINE: 170FT

PLANTING REQUIREMENT: 1 SHADE TREE/40FT x 170 = 5 SHADE TREES 1 EVERGREEN TREE/20FT = 9 TREES

CREDIT IS TAKEN FOR ONE EXISTING SHADE TREE TO REMAIN AND SUBSTITUTION OF 19 EXISTING SHADE TREES FOR 9 REQUIRED EVERGREENS, 4 SHADE TREES WILL BE PLANTED AROUND THE PROPOSED COMPOUND.

ADJACENT LAND USE: COMMERCIAL LANDSCAPE TYPE: A (LIGHT BUFFER) LENGTH ALONG PROPERTY LINE: 477FT PLANTING REQUIREMENT: 1 SHADE TREE/60FT x 477 = 8 SHADE TREES CREDIT IS TAKEN FOR 8 EXISTING SHADE TREES TO REMAIN.


ADJACENT LAND USE: COMMERCIAL LANDSCAPE TYPE: A (LIGHT BUFFER) LENGTH ALONG PROPERTY LINE: 153FT PLANTING REQUIREMENT: 1 SHADE TREE/60FT x 153 = 3 SHADE TREES SEE PROPOSED LANDSCAPING PLAN, 3 SHADE TREES TO BE PLANTED.

GENERAL PLANTING NOTES

- 1. ALL PLANTS MUST BE HEALTHY, VIGOROUS MATERIAL, FREE OF PESTS AND DISEASE.
- 2. ALL PLANTS MUST BE CONTAINER-GROWN OR BALLED AND BURLAPPED AS SPECIFIED.
- 3. ALL TREES MUST BE STRAIGHT TRUNKED, FULL HEADED AND MEET ALL REQUIREMENTS SPECIFIED.
- 4. ALL PLANTS ARE SUBJECT TO THE APPROVAL OF SPECTRASITE CONSTRUCTION MANAGER BEFORE, DURING AND AFTER INSTALLATION.
- 5. ALL TREES MUST BE GUYED OR STAKED AS SHOWN.
- 6. ALL PLANTS AND PLANTING AREAS MUST BE COMPLETELY MULCHED AS SPECIFIED.
- 7. PRIOR TO CONSTRUCTION, THE CONTRACTOR SHALL BE RESPONSIBLE FOR LOCATING ALL UNDERGROUND UTILITIES AND SHALL AVOID DAMAGE TO ALL UTILITIES DURING COURSE OF THE WORK. THE CONTRACTOR IS RESPONSIBLE FOR REPAIRING ALL DAMAGE TO UTILITIES, STRUCTURES, SITE APPURTENANCES, ETC. WHICH OCCURS AS A RESULT OF THE LANDSCAPE CONSTRUCTION.
- 8. THE CONTRACTOR IS RESPONSIBLE FOR VERIFYING ALL QUANTITIES SHOWN ON THESE PLANS BEFORE PRICING THE WORK.
- 9. THE CONTRACTOR IS RESPONSIBLE FOR FULLY MAINTAINING ALL PLANTING (INCLUDING, BUT NOT LIMITED TO: WATERING, SPRAYING, MULCHING, FERTILIZATION, ETC.) OF PLANTING AREAS AND LAWNS UNTIL THE WORK IS ACCEPTED IN TOTAL BY SPRINT'S REPRESENTATIVE.
- 10. THE CONTRACTOR SHALL COMPLETELY GUARANTEE ALL PLANT MATERIAL FOR A PERIOD OF ONE (1) YEAR BEGINNING AT THE DATE OF THE TOTAL ACCEPTANCE. THE CONTRACTOR SHALL PROMPTLY MAKE ALL REPLACEMENTS BEFORE OR AT THE END OF THE GUARANTEE PERIOD.
- 11. THE OWNER AGREES TO PERFORM ALL LANDSCAPE MAINTENANCE (INCLUDING WATERING) THROUGHOUT THE ONE-YEAR GUARANTEE PERIOD UNLESS OTHERWISE DETERMINED.
- 12. SPECTRASITE'S REPRESENTATIVE WILL APPROVE THE STAKED LOCATION OF ALL PLANT MATERIAL PRIOR TO INSTALLATION.
- 13. AFTER BEING DUG AT THE NURSERY SOURCE, ALL TREES IN LEAF SHALL BE ACCLIMATED FOR TWO (2) WEEKS UNDER A MIST SYSTEM PRIOR TO INSTALLATION.
- 14. ANY PLANT MATERIAL THAT DIES, TURNS BROWN OR DEFOLIATES (PRIOR TO TOTAL ACCEPTANCE OF THE WORK) SHALL BE PROMPTLY REMOVED FROM THE SITE AND REPLACED MATERIAL OF WITH THE SAME SPECIES, QUANTITY, SIZE AND MEETING ALL SPECIFICATIONS.
- 15. STANDARDS SET FORTH IN "AMERICAN STANDARD FOR NURSERY STOCK" REPRESENT GUIDELINE SPECIFICATIONS ONLY AND SHALL CONSTITUTE MINIMUM QUALITY REQUIREMENTS FOR PLANT MATERIAL.
- 16. AMENDED AREAS TO CONSIST OF 40% COMPOST AND 60% EXISTING SOIL AND 1/3 AMOUNT OF FERTILIZER APPLICATION RATE RECOMMENDED OF PLANTING. IN A 1:3:2 RATIO FERTILIZER AT TIME IN NOV./DEC. OF THE FOLLOWING YEAR, APPLY FULL PRIMARY AMOUNT OF FERTILIZER.

COUNTY LANDSCAPING NOTES


- 1. THIS PLAN HAS BEEN PREPARED IN ACCORDANCE WITH THE PROVISIONS OF SECTION 16.124 OF THE HOWARD COUNTY CODE AND LANDSCAPE MANUAL.
- 2. SURETY IN THE AMOUNT OF \$2,100.00 FOR 7 SHADE TREES SHALL BE POSTED WITH THE GRADING PERMIT IF A GRADING PERMIT IS REQUIRED FOR THIS SITE.

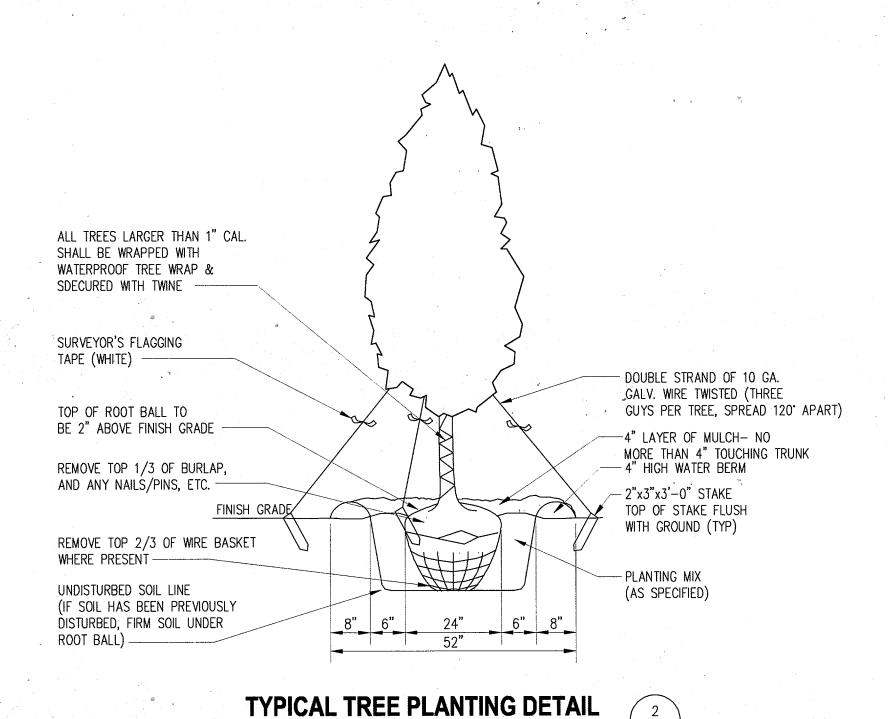

APPROVALS DEPARTMENT OF PLANNING AND ZONING

PLANT LIST

SYMBOL	NAME	SIZE	QUANTITY	COMMENTS
8	RED DAK QUERCUS RUBRA	MIN 2 1/2' CALIPER	7 ·	SEE 1/LS-2
	LEYLAND CYPRESS	4'-6" TALL (MIN.)	19	PLANT 5'-0" O.C.
E SE	EXISTING TREE TO REMAIN	VARIDUS	SEE TABLE LS-1	SEE LS-1

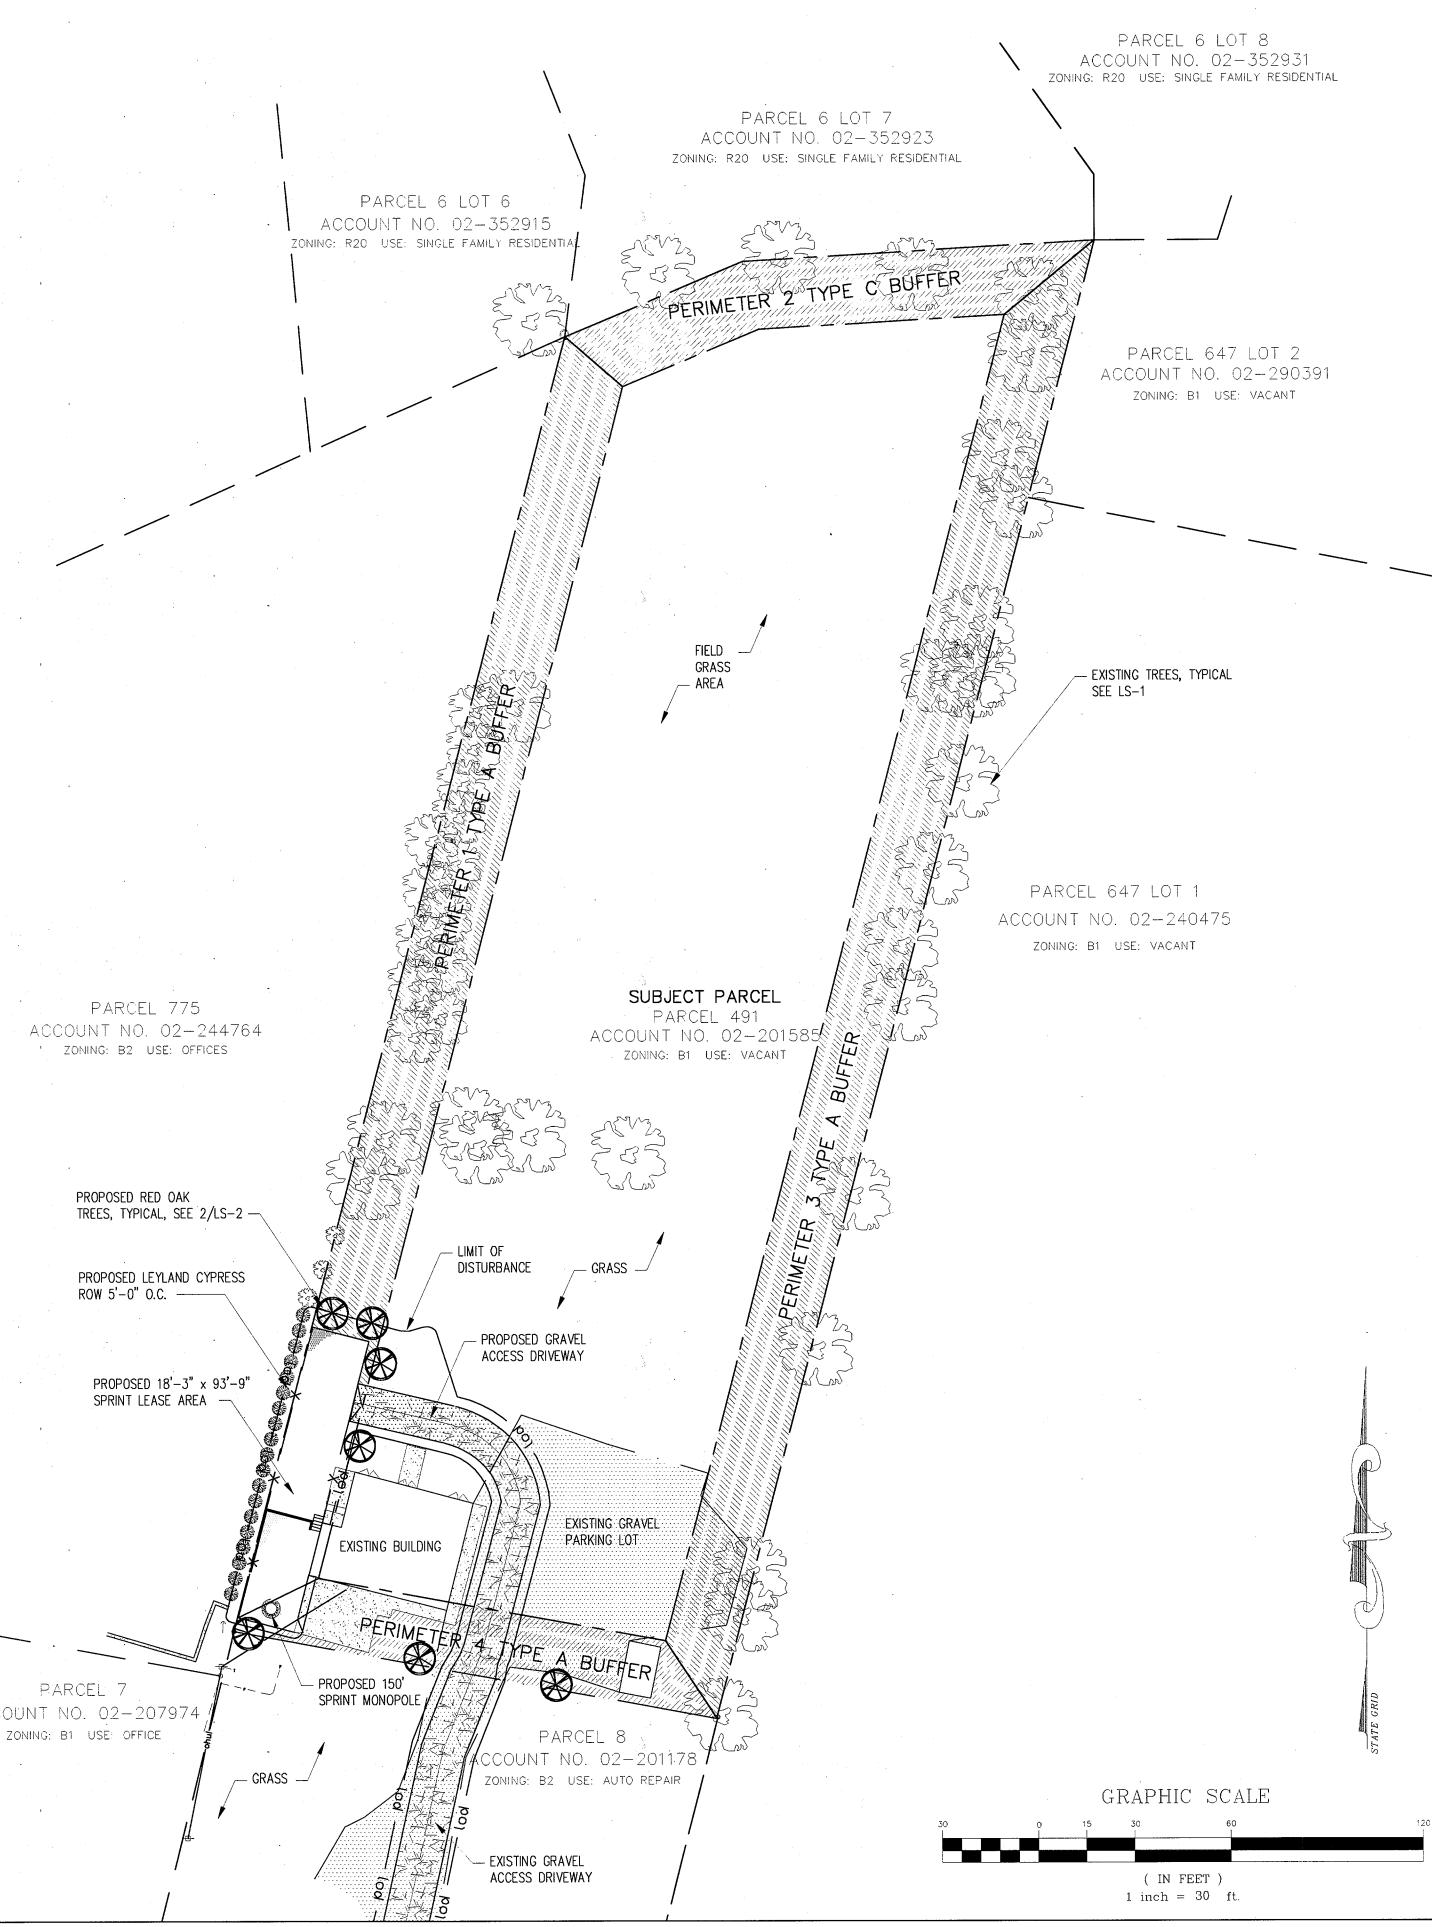


LANDSCAPING PLAN

SCALE: 1"=30'-0"



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PROJECT NO: 1015.184 DESIGNER: R.S. ENGINEER: C.T.
ENGINEER: C.T.
SCALE: 0 1/2 1 GRAPHIC SCALE IN INCHES

10256 BALTIMORE NATIONAL PIKE ELLICOTT CITY, MD 21042

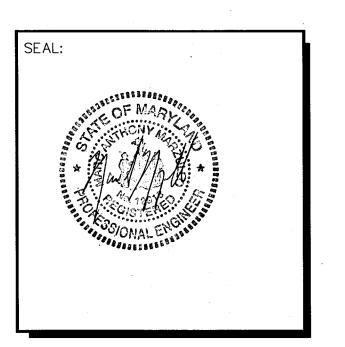LANDSCAPING PLAN

12 OF 13

SHEET NUMBER:

LS-2

