GENERAL NOTES

- 1. Public water and sewer will be used within this site.
- 2. Stormwater Management Quantity and quality is provided by regional facility on F-02-47. Recharge is provided on site in a grass swale.
- 3. The Contractor shall notify the following utility companies or agencies at least five (5) working days before starting work shown on these plans: State Highway Administration

BGE(Contractor Services) BGE (Underground Damage Control) 410.850.4620 410.787,9068 1.800.257,777 410,795,1390

Miss Utility Colonial Pipeline Company Howard County, Dept. of Public Works, Bureau of Utilities 410.313.4900 Howard County Health Department 410,313,2640

- 4. The contractor shall notify Miss Utility at 1-800-257-7777 at least 48 hours prior to any excavation work being done.
- 5. The contractor shall notify the Department of Public Works/Bureau of Engineering Construction Inspection Division at (410) 313-1880 at least five (5) working days prior
- 6. The existing topography is taken from F-02-47.
- 7. Existing utilities are based on F-02-47.
- 8. There are no floodplains, steep slopes, historic structures or cemeteries within
- 9. The project is in conformance with the latest Howard County Standards unless waivers have been approved.
- 10. The coordinates shown hereon are based upon the Howard County Geodetic Control which is based on the Maryland State Plane Coordinate system. Howard County
- monument numbers 304005R and 3044004R were used for this project. II. No clearing, grading or construction is permitted within wetlands, streams or their required buffers, forest conservation retention easements, and forest conservation reforestation easements after they have been planted.
- 12. Financial Surety for the required landscaping shall be posted as part of the Grading Permit in the amount of \$42,600.00 (64 shade trees @ \$300.00 each, 28 ornamental
- trees @ \$300.00 each, 96 evergreen trees @ \$150.00 each and 20 shrubs @ \$30.00 each). 13. All curb and gutter to be Howard County Standard R-3.01 Modified Curb and Gutter unless
- otherwise noted. 14. All proposed spot elevations along curb and gutter are to the flowline unless otherwise
- 15. Any damage to the County's Right-of-Way shall be corrected at the developer's expense. 16. SHC elevations shown are at 2.0%. See Water/Sewer Contract #14-4034-D for additional information. 17. For driveway entrance details refer to Howard County Design Manual, Volume IV,
- Standard Détail R-6-05 (use 201 wide driveway). 18. Section 128.A.1.c of the Howard County Zoning Regulations allows porches or decks, open or enclosed to project not more than 10 feet into the required front or rear setback area or into a required setback from a project boundary or different zoning districts. Exterior
- stairways or ramps, above or below ground level, may extend not more than 10 feet into a front setback area or a setback from a project boundary or different zoning district, and not more than 16 feet into a rear setback area. 19. All HDPE pipe specification and installation shall meet AASHTO M-252 Type S, M-294
- Type S and ASTM D2321, respectively. 20. All pathways and sidewalks to conform to Howard County Standard Detail R.3.05.
- 21. Soil compaction specifications, requirements, methods and materials are to be in accordance with the recommendations of the project Geotechnical Engineer, Geotechnical Engineer to confirm acceptability of proposed paving section, based on soil test, prior to construction.
- 22. All traffic control devices, markings and signing shall be in accordance with the latest edition of the Manual on Uniform Traffic Control Devices (MUTCD). 23. Contractor is responsible to construct all handicap ramps and handicap access in accordance
- with current ADA requirements. Handicap Ramps to conform to Howard County Standard 24. APFO Traffic Study not required for this project. Proposed site is greater than I mile to closest major collector intersection. The developer is proposing housing for elderly
- subdivisions of Village Crest and their guests. 25. All storm drain located outside of the public Right-of-Way shall be privately owned and maintained by the Home Owners Association.

center only open to the members that must be residents and/or homeowners in the

26. Units I thru 15 will have private trash collection. Units 16 thru 51 will have public trash collection. 27. Forest Conservation obligations are identified and provided under F-02-47. For bearings and distances of Forest Conservation Easements and see Record Plat #16/04 - 16/09

for Village Crest Subdivision. The site development of proposed private community recreation

(F-02-47) recorded in the Land Records of Howard County. 28. Convenants regarding age restrictions are recorded among the land records of Howard County in Liber 7916 Folio 335 - 338

ADDRESS CHART STREET 8268 Academy Road 8266 Academy Road 8264 Academy Road 8262 Academy Road 8260 Academy Road 8258 Academy Road 8256 Academy Road 8254 Academy Road 8252 Academy Road 8248 Academy Road 8246 Academy Road 8244 Academy Road 8242 Academy Road 8240 Academy Road 8238 Academy Road 8234 Academy Road 8232 Academy Road 8230 Academy Road 8228 Academy Road 8226 Academy Road 8224 Academy Road 8220 Academy Road 8218 Academy Road 8216 Academy Road 8214 Academy Road 8212 Academy Road 8210 Academy Road 8211 Academy Road 8213 Academy Road 8215 Academy Road 8217 Academy Road 8221 Academy Road 8223 Academy Road 8225 Academy Road 8227 Academy Road 823! Academy Road 8233 Academy Road 8235 Academy Road 8237 Academy Road 8239 Academy Road 8241 Academy Road 8245 Academy Road 8247 Academy Road

8249 Academy Road

8251 Academy Road

8257 Academy Road

8259 Academy Road


8261 Academy Road

8263 Academy Road


8265 Academy Road


SITE DEVELOPMENT PLAN VILLAGE CREST


UNITS 1 THRU 51 HOWARD COUNTY, MARYLAND

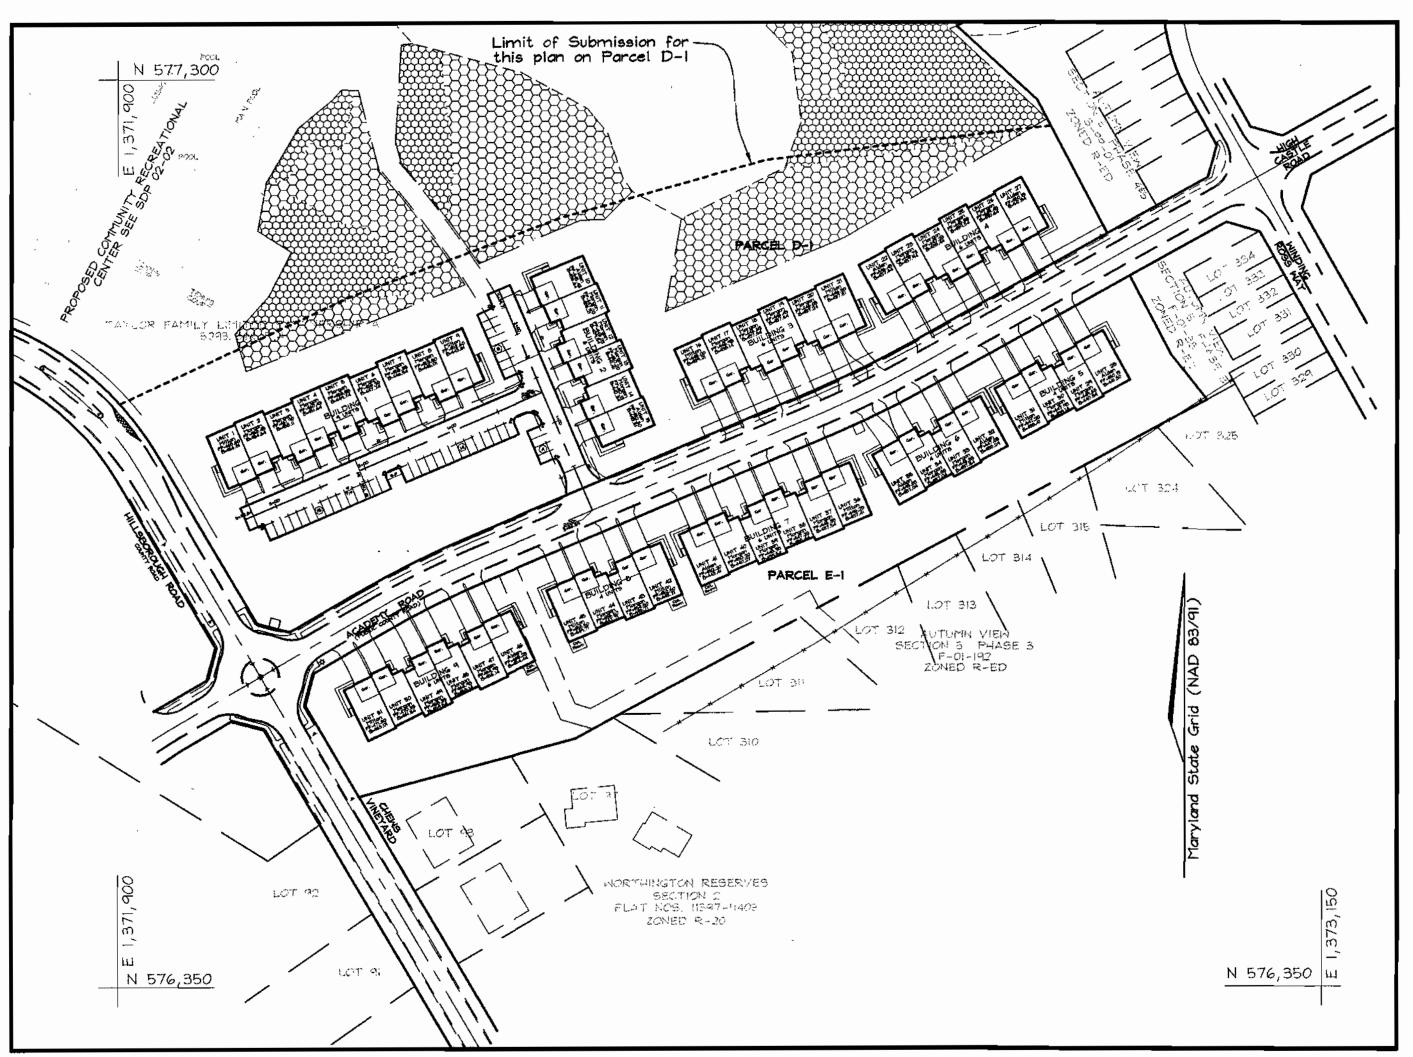


LOCATION MAP SCALE: 1"=100"

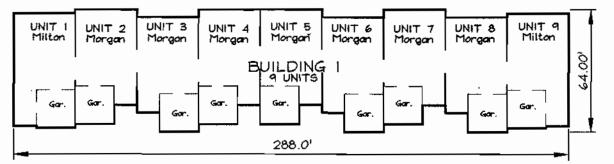

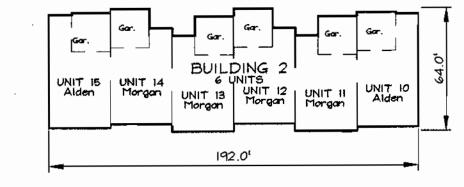

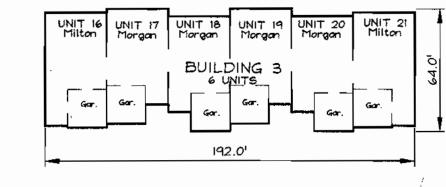

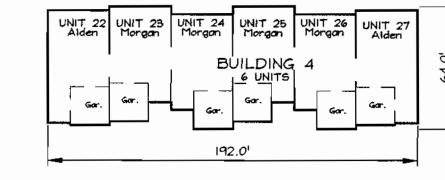

Existing Spot Elevation +82⁵³ Proposed Spot Elevation Direction of Flow ~~~~~~ Existing Trees to Remain Forest Conservation Easemen (Reforestation) Forest Conservation Easemen (Retention) Tree Protection Fence Tree Protection Signage SHEET INDEX DESCRIPTION SHEET No. 1 of 9 Cover Sheet 2 of 9 Site Development and Grading Plan 3 of 9 Site Development and Grading Plan 4 of 9 Sediment and Erosion Control Plan Sediment and Erosion Control Plan 5 of 9 Sediment and Erosion Control Notes and Details 6 of 9 Storm Drain Profiles and Site Details 7 of 9

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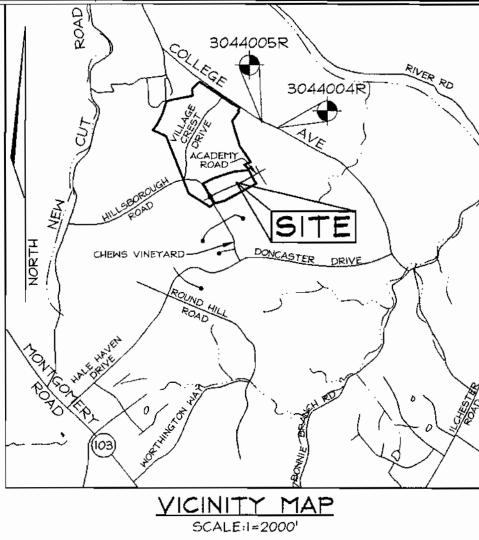
LEGEND

Existing Contour

Storm Drain Drainage Area Map

Landscape Plan and Details

Proposed Contour



BENCHMARKS

Sta. 3044005R N 578,233.92 E 1,373,142.33 Elev. 374.389 Sta. 3044004R N 578,128.03 E 1,373,460.71 Elev. 362.575


SITE ANALYSIS DATA CHART

- a. Limit of submission acreage on Parcel D-I for this plan =5.53 Ac.± (Total of D-I: 38.49 Ac.±) b. Total area of Parcel E-I for this subdivision =3.58 Ac.±
- c. Area of plan submission: 9.11 Ac.± d. Limit of disturbed area: 8.39 Ac.±

8 of 9

9 of 9

- e. Present zoning: "POR" per 02/02/04 Comprehensive Zoning Plan.
- f. Proposed uses for site \$ structures: Age Restricted Adult Housing g. Floor space on each level of building(s) per use: See building templates
- h. Total number of units proposed: 51
- i. Number of parking spaces required: 102 (2 per unit)
- i. Total number of parking spaces provided: 143(2.8 parking spaces provided per unit) Number of parking spaces provided with two-car garage units: 102
- Number of common parking area head-in parking spaces provided: 41
- In accordance with Zoning Sections 115.D.2.b(2), 133.C.1.a \$ b, and 133.D.2.b.(1), the two parking spaces in the garages in Units 16-51 must be used for parking only, as parking, a use, is not permitted within the shown "30' Structure and Use Setback."
- k. Open Space/Area required: 0 ac. (Per Plat under F-02-47)
- 1. Total Building coverage of site: 93,803.16 sf = 2.15 Ac. = 23.7% Building coverage on Parcel D-1 for this subdivision: 49497.66 sf = 1.14 Ac. = 20.6%
- Building coverage on Parcel E-I for this subdivision: 44,305.50 sf = 1.01 Ac. = 28.4%
- m. A recreational center is proposed on another part of Parcel D-I Per SDP-02-02.
- n. DPZ file references: S-98-18, S-00-05, P-00-07, P-01-20, F-02-112, F-02-47, SDP-02-94 F-01-60, WS Contract #14-4034-D; F-04-077.
- Recreational Open Space Required Recreational Open Space: 175'67/UNIT (SDP-02-94)
 267 Units (SDP-02-94): 46725 SF (1.07Ac)
- Required Recreational Open Space: 400 SF/UNIT (SOP-03-35)
- 51 Units (this plan): 20400 SF (0.468 Ac)
- Provided Recreational Open Space (SDP-04-25) < Fenced Pool: 17744.995F, Community Recreational
 Provided Recreational Open Space (SDP-04-25) < Fenced Pool: 17744.995F, & Building (SDP-04-25): 2611.005F
 Per Community Recreational/Commercial Comptex (SOP-04-25): 36971.195F (0.85Ac)
 Elderly Housing 267 Units (SDP-02-94): 35 140. 62 SF (0.81Ac)
 TOTAL RECREATIONAL OPEN / Tenanglation TOTAL RECREATIONAL OPEN (501-02-94) SPACE PROVIDED: 72111. 815F (1.66 AC)

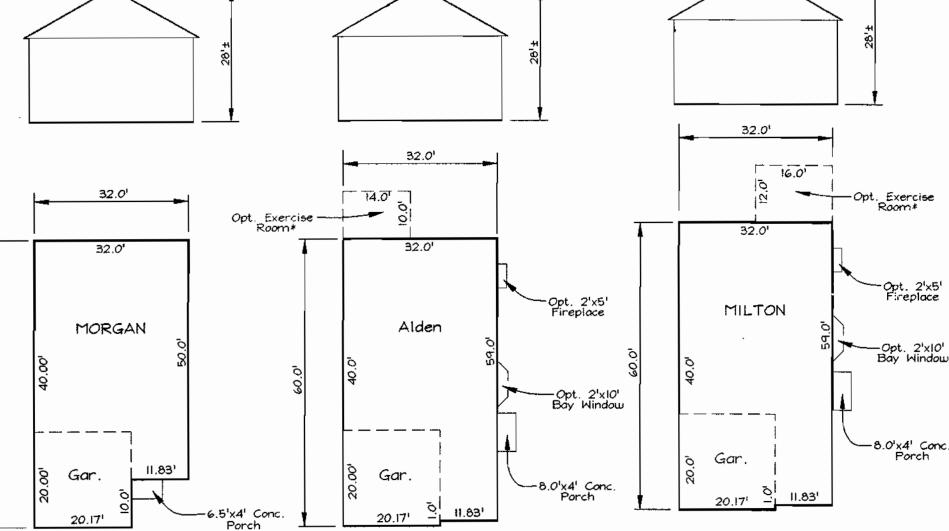

*The optional Exercise Room is not permitted to be located within any shown Structure and Use Setback.

HOUSE TEMPLATES SCALE:1=201

OWNER

Taylor Family Limited Partnership A C/o Land Design & Development, Inc. 8000 Main Street Ellicott City, MD 21043 Attn.: Mr. Donald R. Revwer Phone: (410) 480-9105

DEVELOPER Pulte Homes 1501 S. Edgewood Street Suite K Baltimore, Maryland 21227 410-644-5603

Parcel E-1 and

P/O Parcel D-I

VILLAGE CREST


UNITS 1 THRU 51

TAX MAP 31, 20, GRID 3, 25

PARCEL E-1 & P/O D-1

COVER SHEET

2ND ELECTION DISTRICT

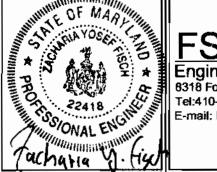

<u>FSH_Associates</u> 8318 Forrest Street Ellicott City, MD 21043 Tel:410-750-2251 Fax: 410-750-7350 E-mail: FSHAssociates@cs.com

DESIGN BY: KO DRAWN BY: KO CHECKED BY: ZYF SCALE: As Shown DATE: <u>June 18, 2003</u> W.O. No.: ____3092__ SHEET No.: 1 OF 9

HOWARD COUNTY, MARYLAND

APPROVED: HOWARD COUNTY DEPARTMENT OF PLANNING AND ZONING

For unit dimensions see house templates this sheet

BUILDING TEMPLATES SCALE:1=50'

UNIT 40 UNIT 39 UNIT 38 Morgan Morgan Morgan


PRIVATE STREET LIGHT 100 watt HPS vapor pendant mount; post topi colonial 14' branze fiberglass N 576,831.5427 E 1,372,049.4933 100 watt HPS vapor pendant mount; post topi colonial 14' branze fiberglass ornamental N 576,889.6196 E 1,372,185.2708 100 watt HPS vapor pendant 14" bronze fiberglass N 577,061.8820 E 1,372,285.5395

Note: Light pole location given at center of base


Subdivision Name: Lot/Parcel No Village Crest Tax Map No. Elect. District Census Tract 16421-16422 POR 6104-16109 Sewer Code Water Code 1253100 *4-0*5


PERMIT INFORMATION CHART

M.\Village Crest Pulte 3092\dwg\SDP\3092_5f_s1.dwg, 6/18/2003 12:48:45 PM, andyb

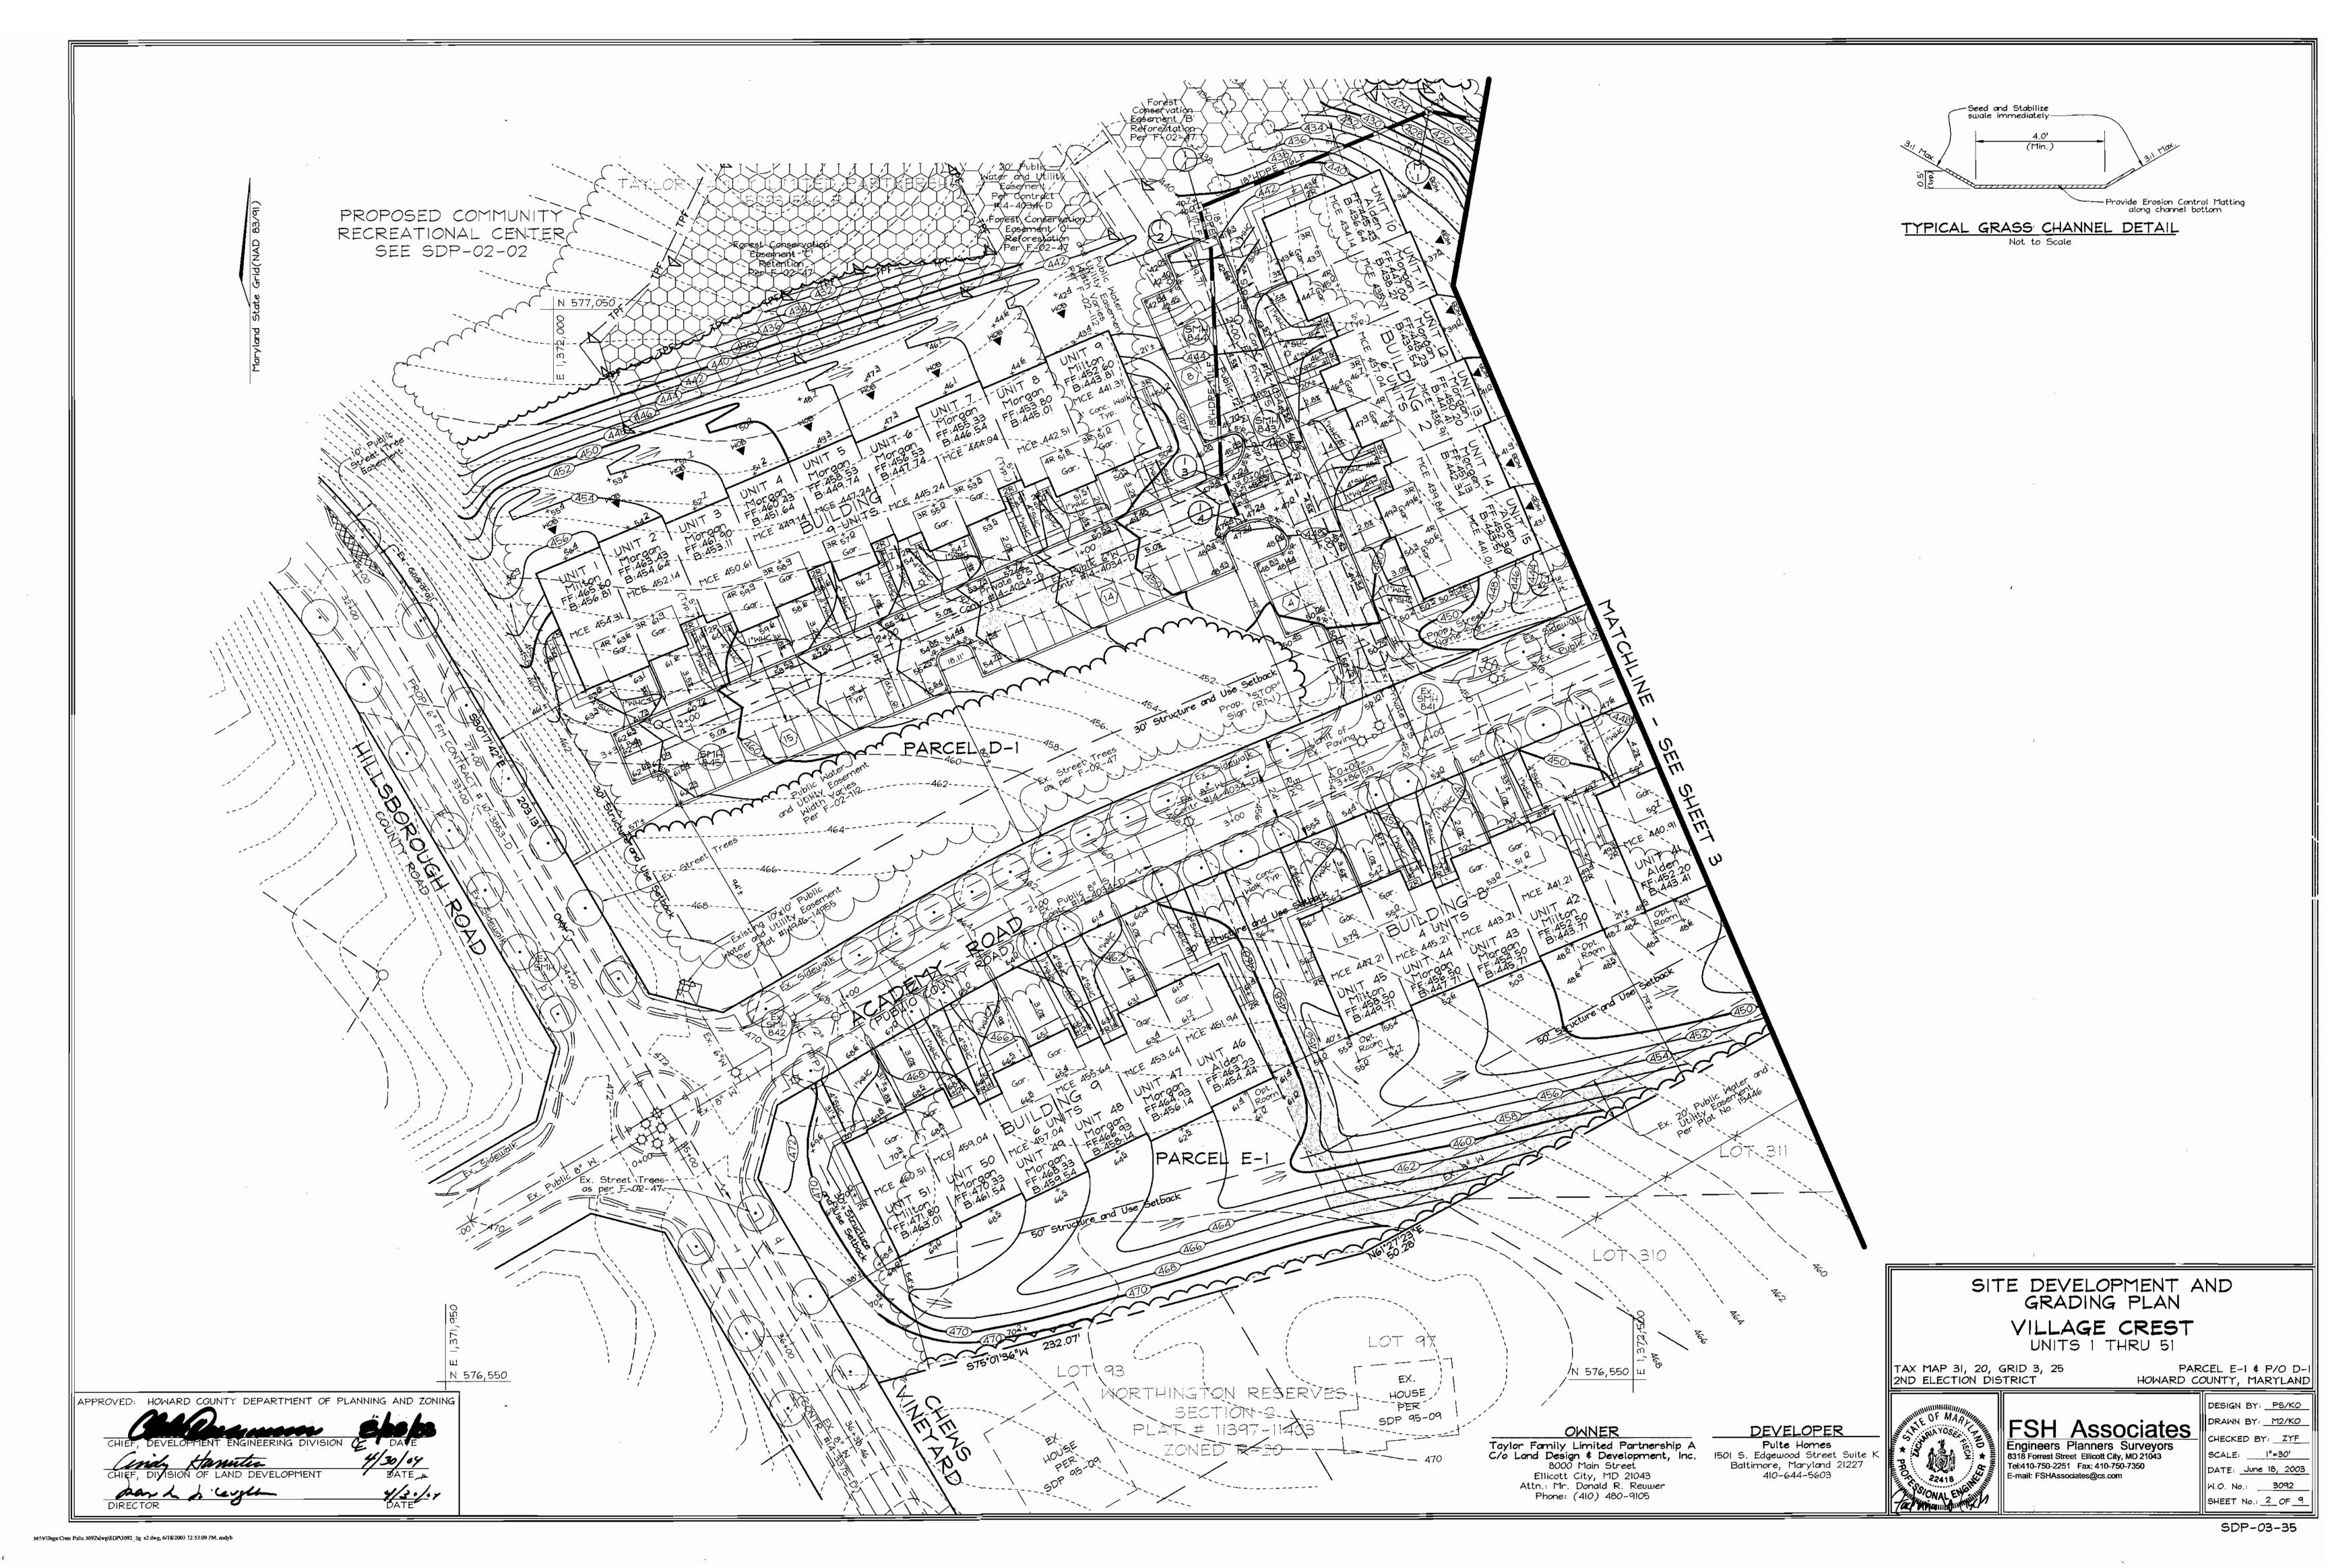





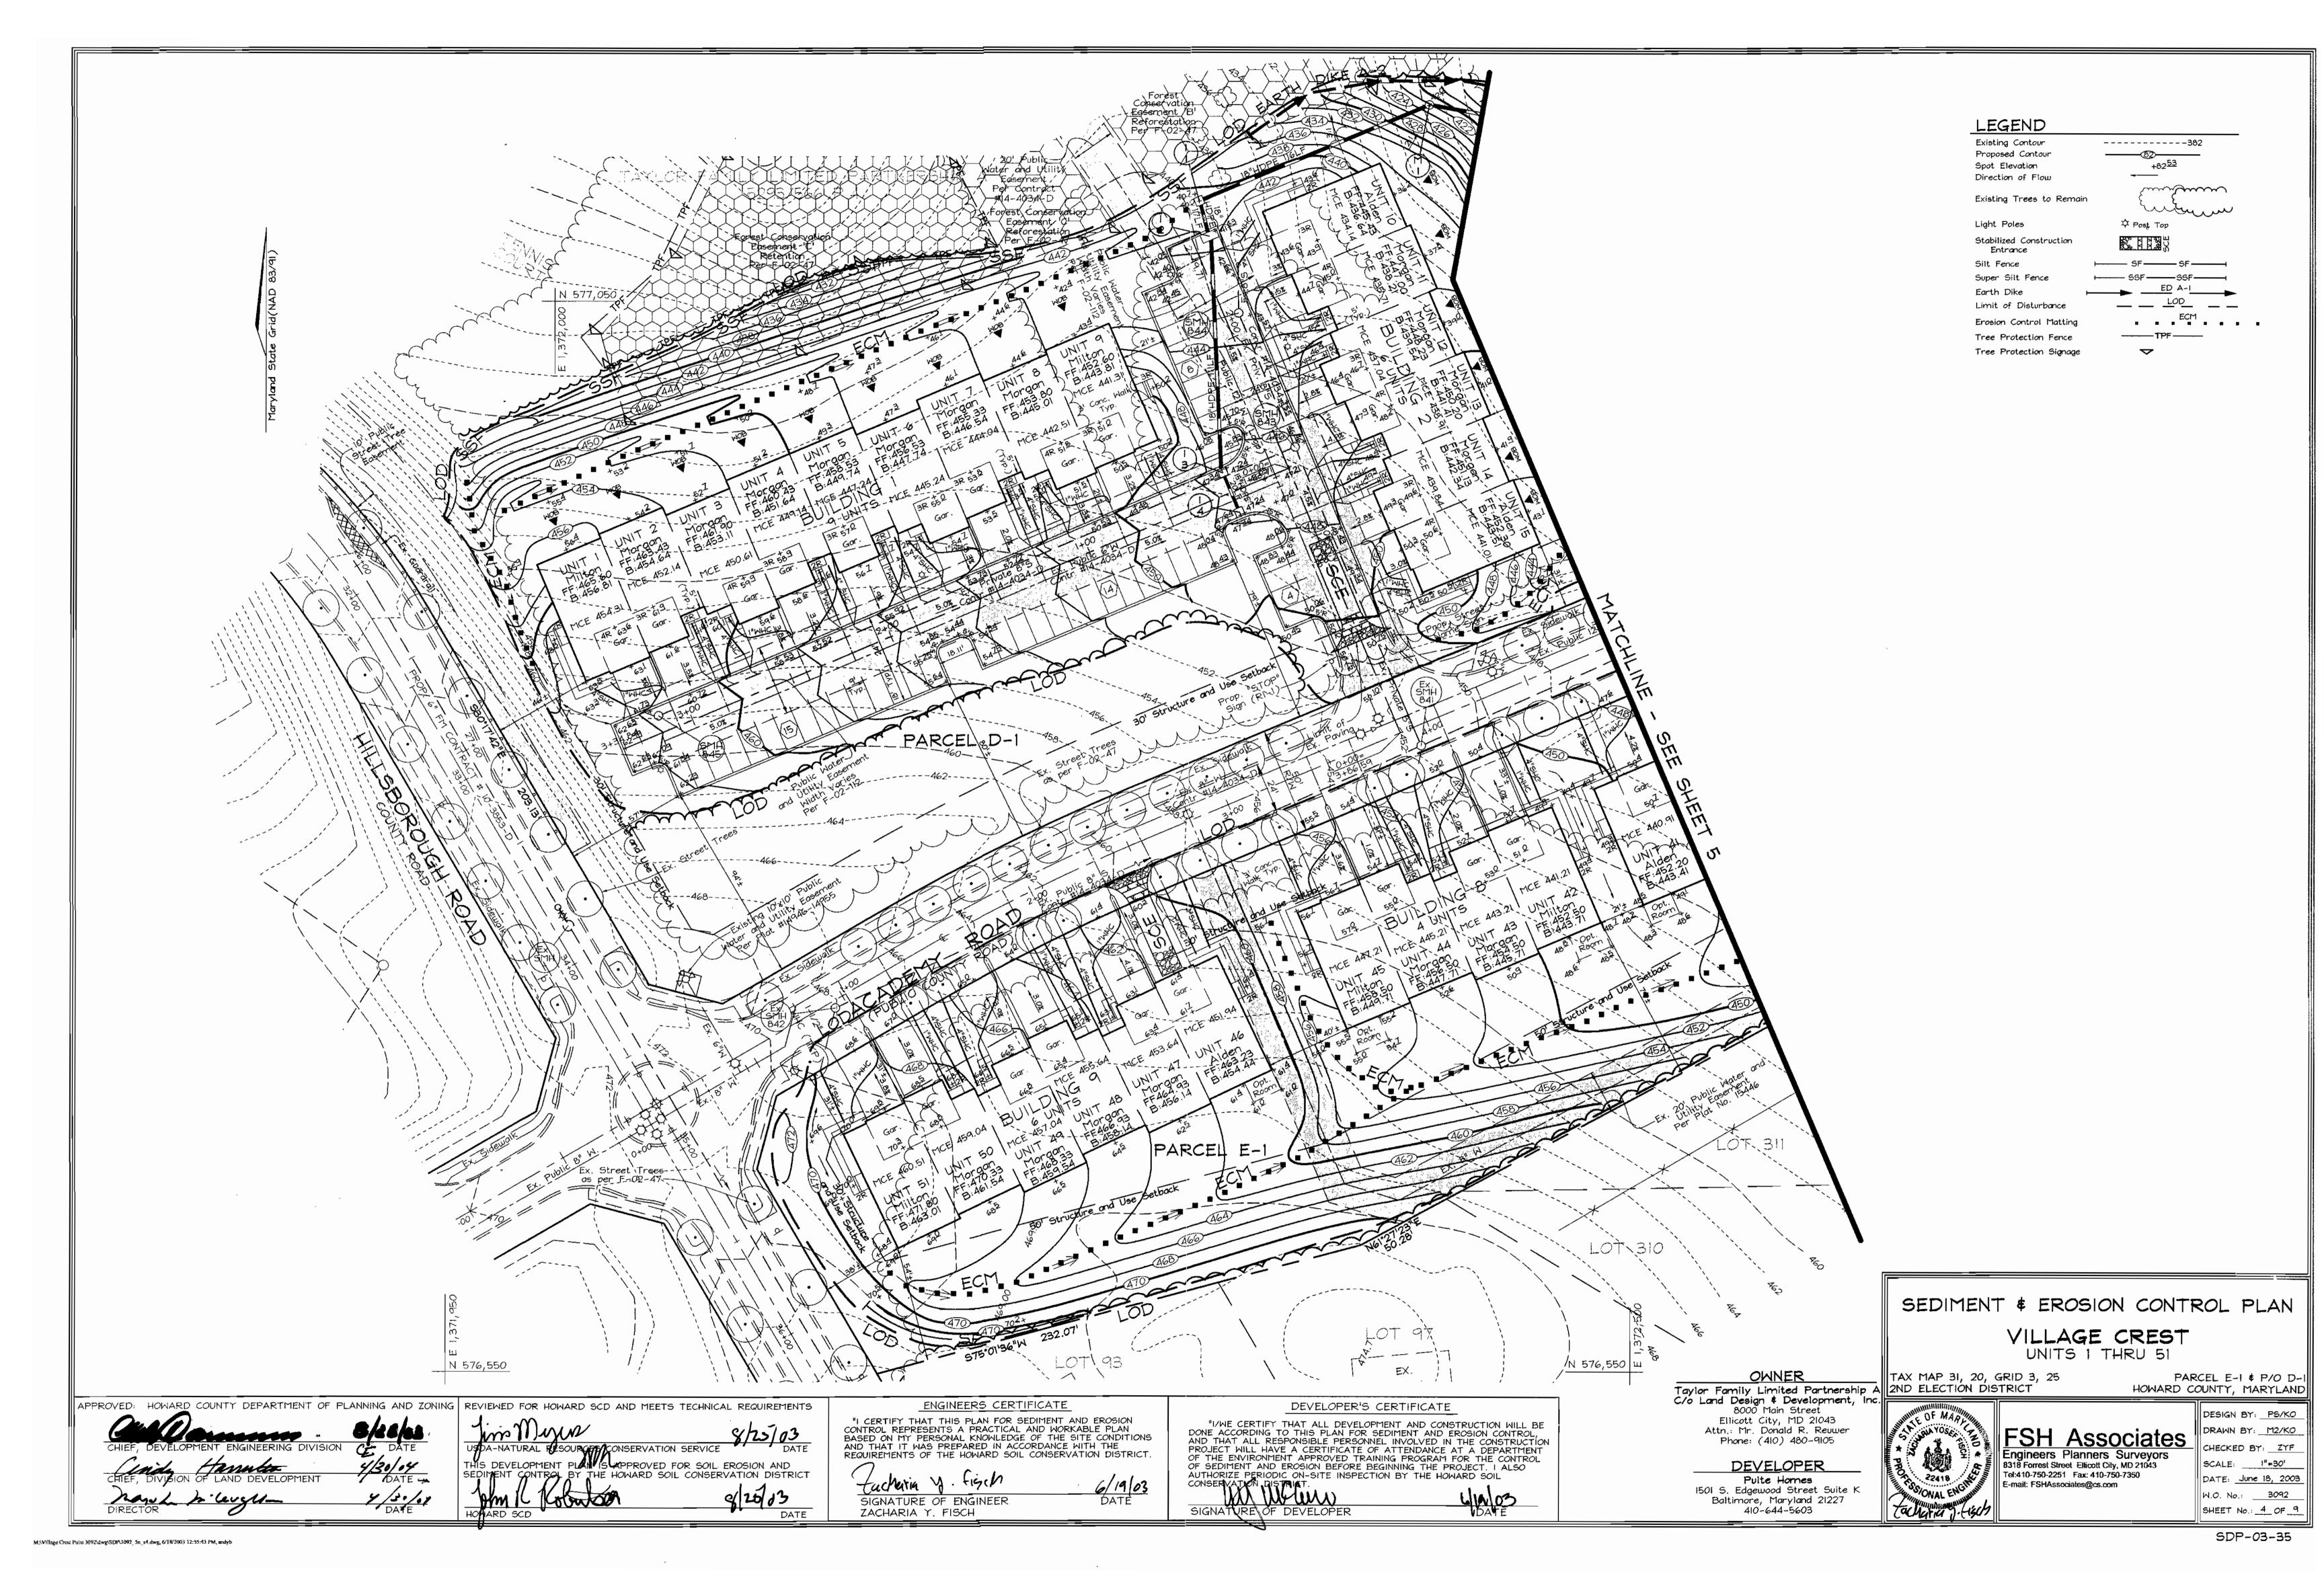

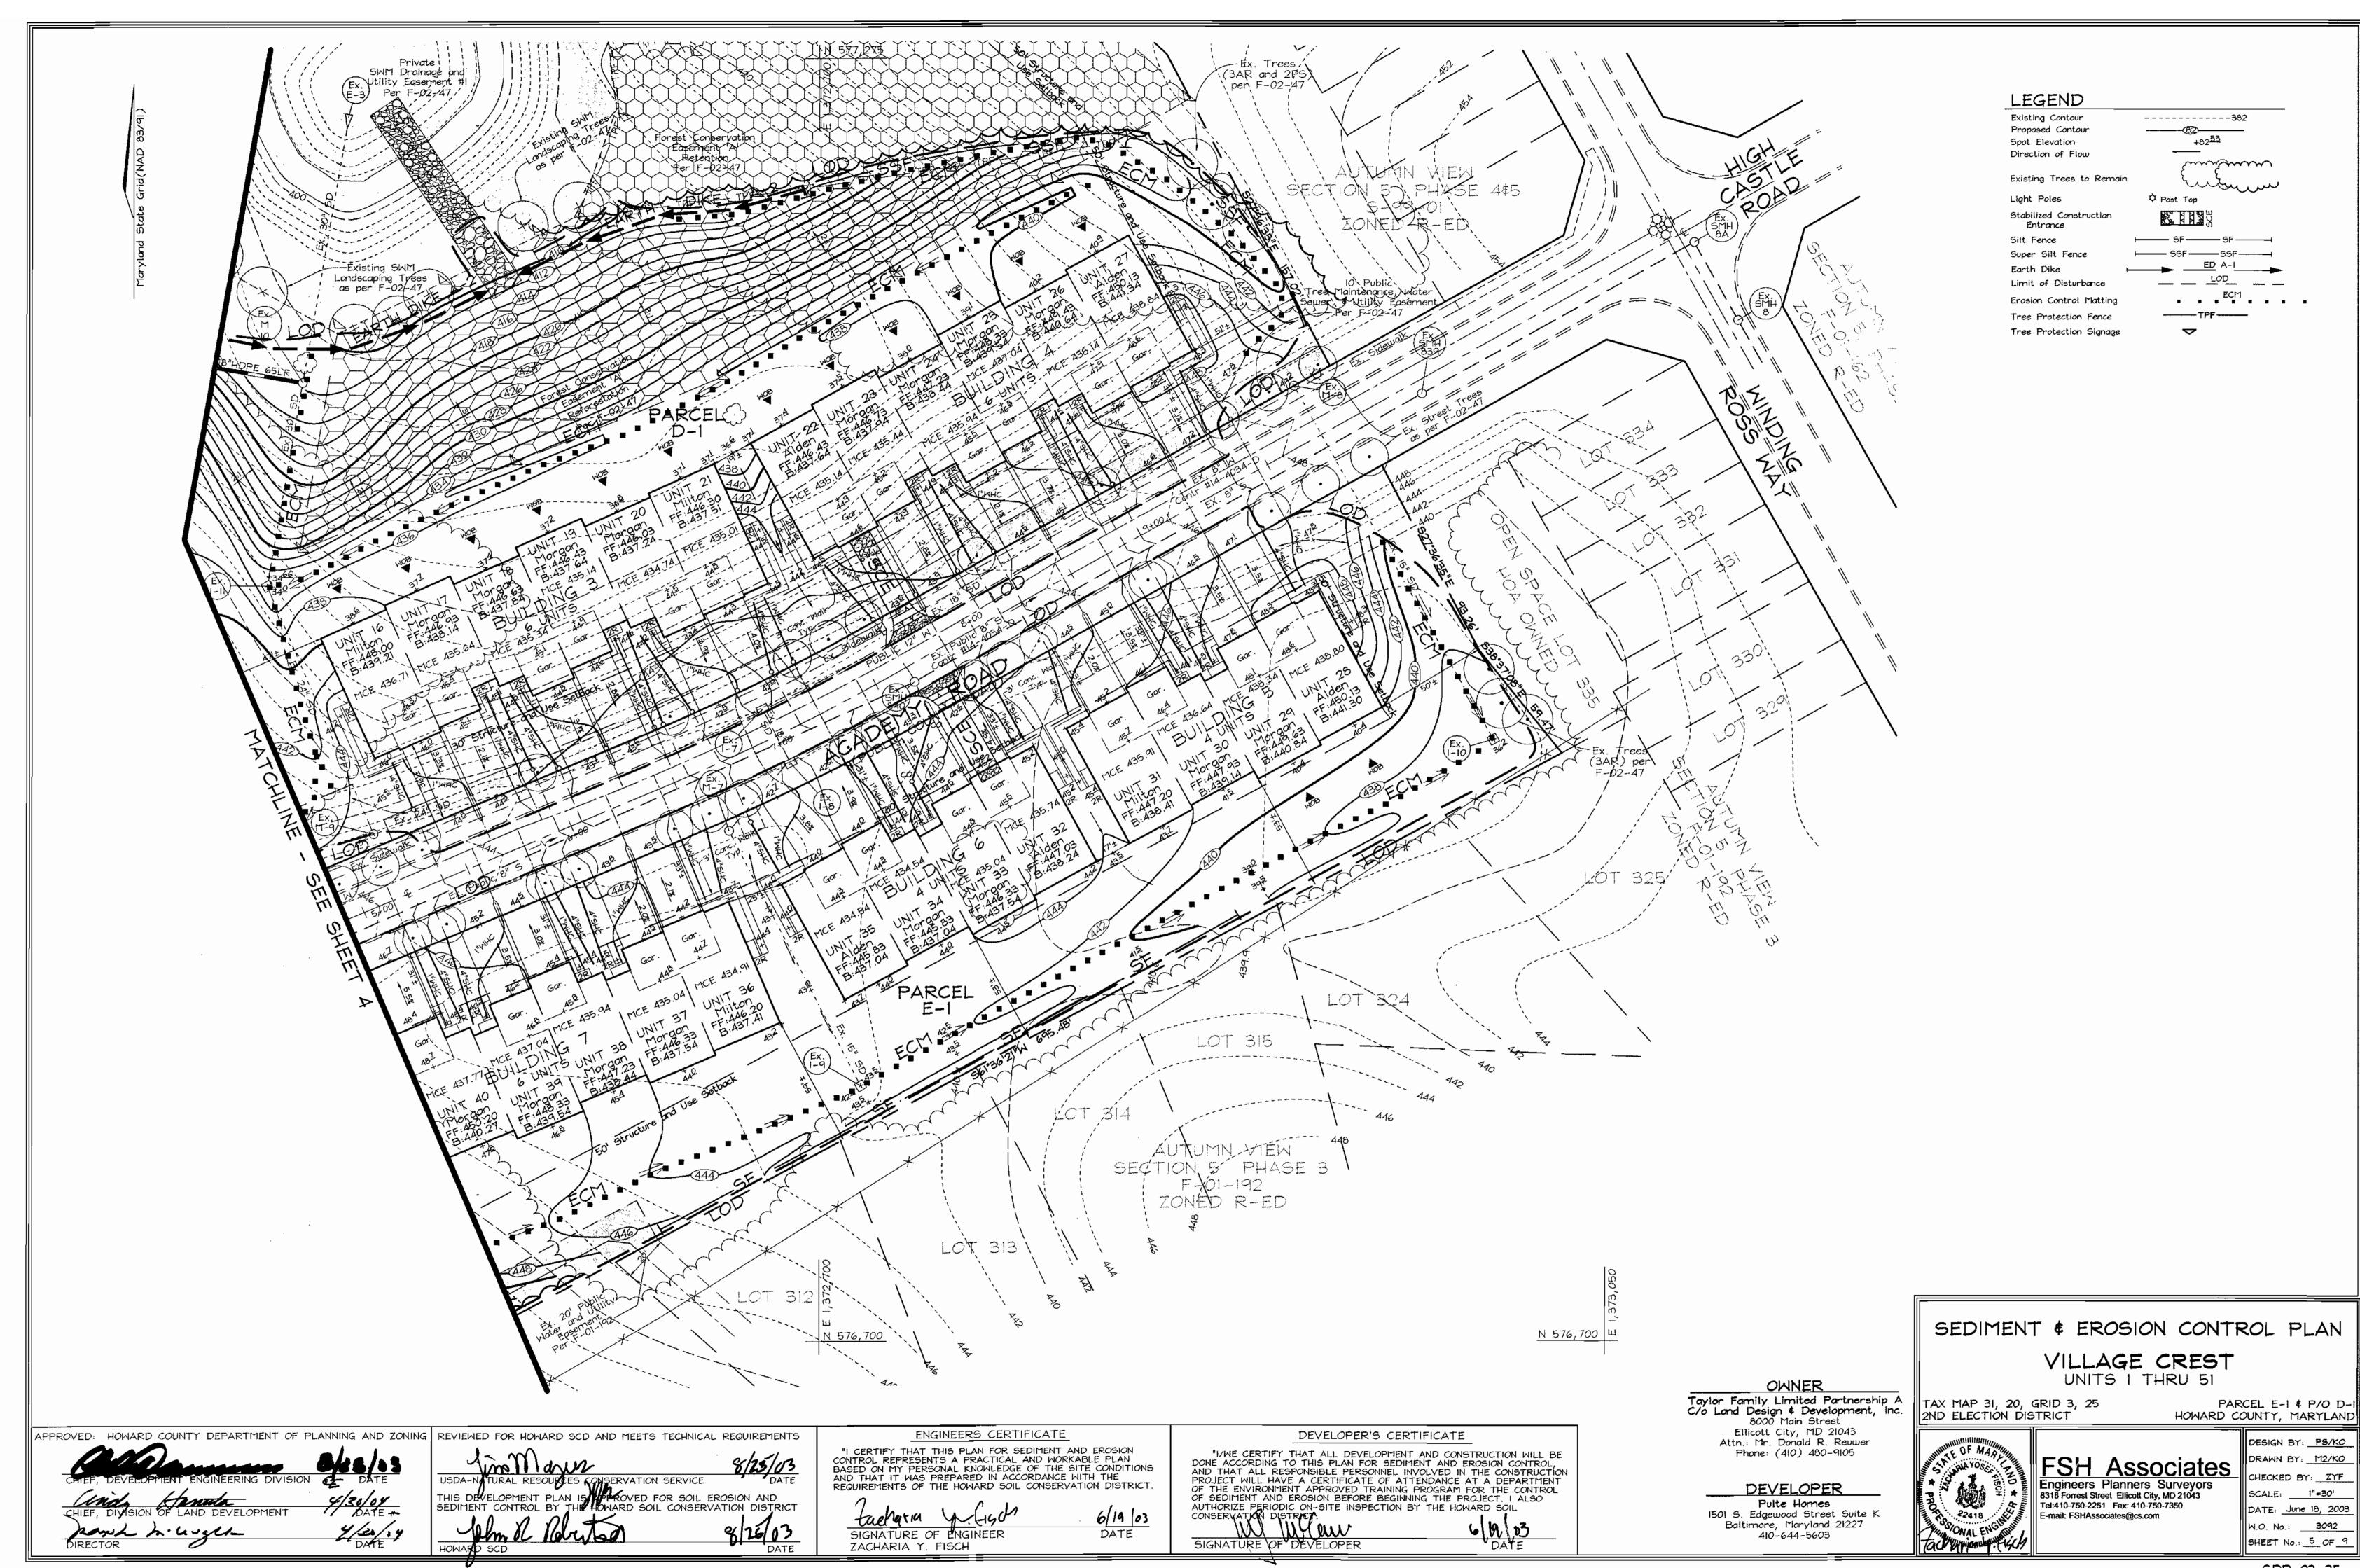

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3. Before stopling the outer edges of the matting, make sure the matting is emouth and in firm contact with the soil.

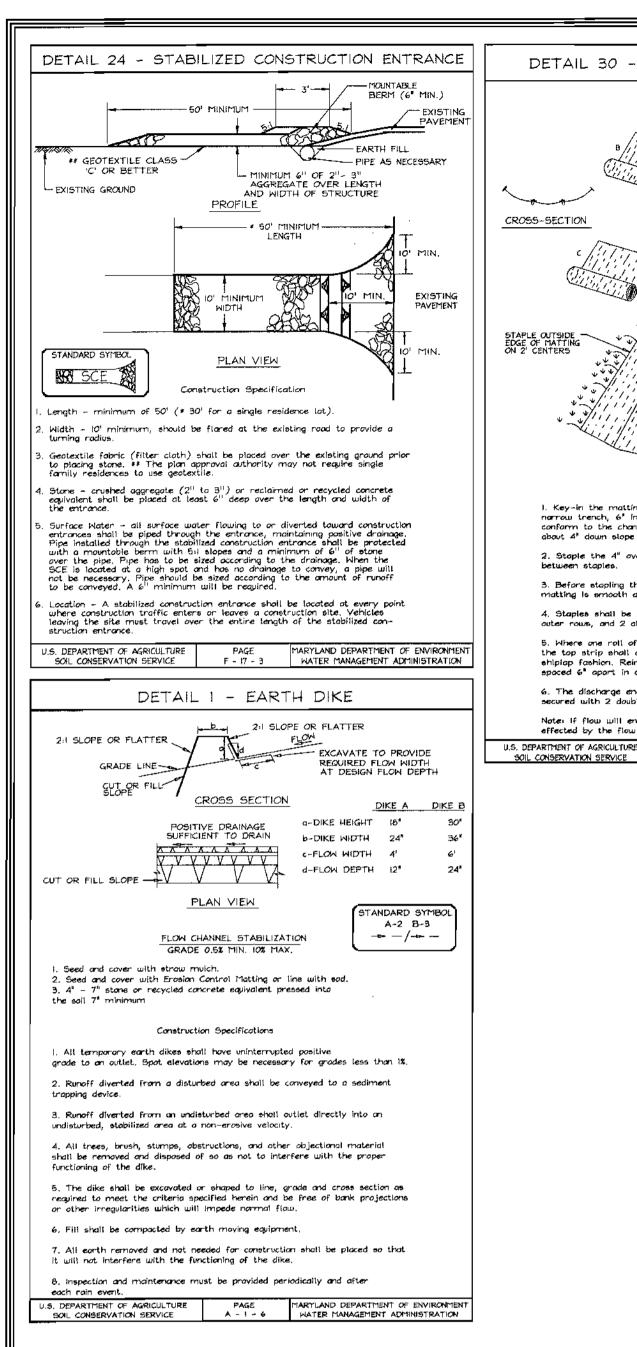4. Staples shall be placed 2' aport with 4 rows for each strip, 2

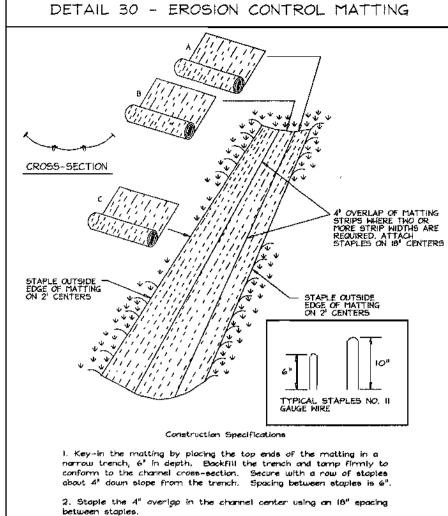5. Where one roll of matting ends and another begins, the end of

6. The discharge end of the matting liner should be similarly

the top strip shall overlap the upper end of the lower strip by 4°, shiplap fashion. Reinforce the overlap with a double row of staples

Note: If flow will enter from the edge of the matting then the area

outer rows, and 2 alternating rows down the center.

spaced 6° apart in a staggered pattern on either side.

effected by the flow must be keyed-in.

EMBED GEOTEXTILE CLASS F
A MINIMUM OF 8" VERTICALLY
INTO THE GROUND - FENCE POST DRIVEN TOP VIEW THE GROUND CROSS SECTION STANDARD SYMBOL ----- SF ------JOINING TWO ADJACENT SILT FENCE SECTIONS Construction Specifications Fence posts shall be a minimum of 36" long, driven 16" minimum into the ground, blood posts shall be I I/2" x I I/2" square (minimum) cut, or 1 3/4" diameter (minimum) round and shall be of sound apality handwood. Steel posts will be standard T or U section weighing not less than 1.00 2. Geotextile shall be fastened securely to each fence post with wire ties or stoples at top and mid-section and shall meet the following requirements for Geotextile Class F: 50 lbs/in (min.) Tensile Strength 20 lbs/in (min.) 0,3 gal ft /minute (max.) Test: MSMT 509 Test: MSMT 322 Filtering Eggeclency Where ends of geotextile fabric come tagether, they shall be overlapped, folded and stapled to prevent sediment bypass. Silt Fence shall be inspected after each rainfall event and maintained when bulges occur or when sediment accumulation reaches 50% of the fabric PAGE MARYLAND DEPARTMENT OF ENVIRONMENT E - 15 - 3 WATER MANAGEMENT ADMINISTRATION

DETAIL 22 - SILT FENCE

36" MINIMUM FENCE

FILTER CLOTH—

DRIVEN A MINIMUM OF 16" INTO

FENCE POST SECTION

- MINIMUM 20" ABOVE
GROUND

101 MAXIMUM CENTER TO

PERSPECTIVE VIEW

DETAIL 33 - SUPER SILT FENCE 10' MAXIMUM SHALL NOT EXCEED 10' CENTER TO CENTER Definition Placement of topsoil over a prepared subsoil prior to establishment of permanent vegetation.

36° MINIMUM FLOW 21/2" DIAMETER E BE MINIMUM

STANDARD SYMBO

slopes where:

CHAIN LINK FENCING ----FILTER CLOTH-34" MINIMUM - 16" MIN IST LAYER OF FILTER CLOTH *

* IF MULTIPLE LAYERS ARE REQUIRED TO ATTAIN 42 — SSF Construction Specifications . Fencing shall be 42" in height and constructed in accordance with the latest Maryland State Highway Details for Chain Link Fencing. The specification for a 6' fence shall be used, substituting 42" fabric and 6' length

2. Chain link fence shall be fastened securely to the fence posts with wire ties. The lower tension wire, brace and trues rods, drive anchors and post caps are not required except on the ends of the fence. 3. Filter cloth shall be fostened securely to the chain link fence with ties spaced

4. Filter clath shall be embedded a minimum of 8° into the around.

5. When two sections of filter cloth adjoin each other, they shall be overlapped

6. Maintenance shall be performed as needed and silt buildups removed when "bulges" develop in the slit fence, or when slit reaches 50% of fence helpht 7. Filter cloth shall be fostened securely to each fence post with wire ties or staples at top and mid section and shall meet the following requirements for Geotextile Class Fe Tensile Strength 50 lbs/in (mln.)

20 Ibe/in (min.)

0.3 gal/ft /minute (max.)

(min.)

Test: MSMT 322
Test: MSMT 322 Flow Rate PAGE H - 26 - 3 WATER MANAGEMENT ADMINISTRATION SOIL CONSERVATION SERVICE

21.0 STANDARDS AND SPECIFICATIONS FOR TOPSOIL

To provide a suitable soil medium for vegetable growth. Soils of concern have low moisture content, low nutrient levels, low pH, materials toxic to plants, and/or unacceptable soil aradation.

Conditions Where Practice Applies 1. This practice is limited to areas having 2:1 or flatter

a. The texture of the exposed subsoil/parent material is not adequate to produce vegetative growth.

The soil material is so shallow that the rooting zone is not deep enough to support plants or furnish continuing supplies of moisture and plant nutrients.

c. The original soil to be vegetated contains material toxic to plant growth.

d. The soil is so acidic that treatment with limestone is not feasible.

areas having slopes steeper than 2:1 require special consideration and design for adequate stabilization. Areas having slopes steeper than 2:1 shall have the appropriate stabilization shown on the plans.

II. For the purpose of these Standards and Specifications,

Construction and Material Specifications

1. Topsoil salvaged from the existing site may be used provided that it meets the standards as set forth in these specifications. Typically, the depth of topsoil to be salvaged for a given soil type can be found in the representative soil profile section in the Soil Survey published by USDA-SCS in cooperation with Maryland Agricultural Experimental Station.

II. Topsoil Specifications - Soil to be used as topsoil must meet the following:

i. Topsoil shall be a loam, sandy loam, clay loam, silt loam, sandy clay loam, loamy sand. Other soils may be used if recommended by an agronomist or a soil scientist and approved by the appropriate approval authority. Regardless, topsoil shall not be a mixture of contrasting textured subsoils and shall contain less than 5% by volume of cinders, stones, siag, coarse fragments, gravel, sticks, roots, trash, or other materials larger that I and 1/2" in

ii. Topsoil must be free of plants or plant parts such as Bermuda arass, quackgrass, Johnsongrass, nutsedge, poison ivy, thistle, or others as specified.

iii. Where the subsoil is either highly acidic or composed of heavy clays, ground limestone shall be spread at the rate of 4-8 tons/acre (200-400 pounds per 1,000 square feet) prior to the placement of topsoil. Lime shall be distributed uniformly over designated areas and worked into the soil in conjunction with tillage operations as described in the following procedures.

11. For sites having disturbed areas under 5 acres:

iii. For sites having disturbed areas over 5 acres:

i. Place topsoil (if required) and apply soil amendments as specified in 20.0 Vegetative Stabilization Section | - Vegetative Stabilization Methods and Materials.

i. On soil meeting topsoil specifications, obtain test results dictating fertilizer and lime amendments required to bring the soil into compliance with the following: a, pH for topsoil shall be between 6.0 and 7.5. If the tested soil demonstrates a pH of less than 6.0, sufficient lime shall be prescribed to raise b. Organic content of topsoil shall be not less than 1.5 percent by weight. c. Topsoil having soluble salt content greater than
500 parts per million shall not be used.
d. No sod or seed shall be placed on soil soil which has been treated with soil sterilants or chemicals used for weed control until sufficient time has elapsed (14 days min.) to permit dissipation of

phyto-toxic materials. NOTE: Topsoil substitutes or amendments, as recommended by a qualified agronomist or soil scientist and approved by the appropriate approval authority, may be used in lieu of natural tapsoil.

ii. Place topsoil (if required) and apply soil ammendments specified in 20.0 Vegetative Stabilization-Section I-Vegetative Stabilization Methods and Materials.

V. Topsoil Application

i. When topsoiling, maintain needed erosion and sediment control practices such as diversions, Grade Stabilization Structures, Earth Dikes, Slope Silt Fence and Sediment Traps and Basins.

ii. Grades on the areas to be topsoiled, which have been previously established, shall be maintained, albeit 4" - 8" higher in elevation.

iii. Topsoil shall be uniformly distributed in a 4" -8" layer and lightly compacted to a minimum thickness of 4". Spreading shall be performed in such a manner that sodding or seeding can proceed with a minimum of additional soil preparation and tillage. Any irregularities in the surface resulting from topsoiling or other operations shall be corrected in order to prevent the formation of depressions or water packets.

iv. Topsoil shall not be place while the topsoil or subsoil is in a frozen or muddy condition, when the subsoil is excessively wet or in a condition that may otherwise be detrimental to proper grading and seedbed preparation.

PERMANENT SEEDING NOTES

APPLY TO GRADED OR CLEARED AREAS NOT SUBJECT TO IMMEDIATE FURTHER DISTURBANCE WHERE A PERMANENT LONG-LIVED VEGETATIVE COVER IS NEEDED

SEEDBED PREPARATION: Loosen upper three inches of soil by raking, discing or other acceptable means before seeding, if not previously

SOIL AMENDMENTS: In lieu of soil test recommendations, use one of the following schedules:

1) Preferred-Apply 2 tons per acre dolomitic limestone (92 lbs/100 sq.ft.) and 600 lbs per acre 10-10-10 fertilizer (14 lbs./ 1000 sq.ft.) before seeding. Harrow or disc into upper three inches of soil. At the time of seeding, apply 400 lbs. per acre 30-0-0 ureaform fertilizer (9 lbs/1000 sq.ft.) 2) Acceptable-Apply 2 tons per acre dolomatic limestone (92 lbs/ 1000 sq.ft.) and apply 1000 lbs, per acre 10-10-10- fertilizer (23 lbs./1000 sq.ft.) before seeding. Harrow or disc into upper

three inches of soil.

SEEDING: For the periods March I thru April 30, and August I thru October 15, seed with 60 lbs. per acre (1.4 lbs/1000 sq.ft.) of Turf Type Tall Fescue. For the period May 1 thru July 31, seed with 60 lbs. Turf Type Tall Fescue per acre and 2 lbs. per acre (.05 lbs./1000 sq.ft.) of weeping lovegrass. During the period of October 16 thru February 28, protect site by: Option (1) 2 tons per acre well anchored straw mulch and seed as soon as possible in the spring. Option (2) Use sod. Option (3) Seed with 60 lbs/acre Kentucky 31 Tall Fescue and mulch with 2 tons/acre well anchored

MULCHING: Apply 1 1/2 to 2 tons per acre (70 to 90 lbs/1000 sq. ft.) of unrotted small grain straw immediately after seeding. Anchor mulch immediately after application using mulch anchoring tool or 218 gallons per acre (5 gal/1000 sq.ft.) of emulsified asphalt on flat areas. On slopes 8 feet or higher, use 348 gallons per acre (8 gal/1000 sq.ft.) for anchoring.

MAINTENANCE: Inspect all seeded areas and make needed repairs, replacements and reseedings.

TEMPORARY SEEDING NOTES

SEEDBED PREPARATION: Loosen upper three inches of soil by raking, discing or other acceptable means before seeding, if not

SOIL AMENDMENTS: Apply 600 lbs. per acre 10-10-10 fertilizer (14 lbs./1000 sq.ft).

SEEDING: For periods March 1 thru April 30 and from August 15 thru November 15, seed with 2 1/2 bushel per acre of annual rye (3.2 1bs./1000 sq.ft.) For the period May I thru August 14, seed with 3 lbs. per acre of weeping lavegrass (.07 lbs./1000 sq.ft.). For the period November I thru February 28, protect site by applying 2 tons per acre of well anchored straw mulch and seed as soon as possible in the spring, or use sod.

MULCHING: Apply 1 1/2 to 2 tons per acre (70 to 90 ibs./1000 sq.ft.) of unrotted small grain straw immediately after seeding. Anchor mulch immediately after application using mulch anchoring tool or 218 gallons per acre (5 gal/1000 sa.ft.) of emulsified asphalt on flat areas. On slopes 8 feet or higher, use 348 gallons per acre (8 gai/1000 sq.ft.) for anchoring.

REFER TO THE 1994 MARYLAND STANDARDS AND SPECIFICATIONS FOR SOIL EROSION AND SEDIMENT CONTROL FOR RATE AND METHODS NOT COVERED.

SEDIMENT CONTROL NOTES

- !, A minimum of 48 hours notice must be given to the Howard County Department of Inspection. License and Permits Sediment Control Division prior to the start of any construction (313-1855)
- All vegetation and structural practices are to be installed according to the provisions of this plan and are to be in conformance with the 1994 MARYLAND STANDARDS AND SPECIFICATIONS FOR SOIL EROSION AND SEDIMENT CONTROL and revisions thereto.
- 3. Following initial soil disturbance or redisturbance, permanent or temporary stabilization shall be completed within: (a) 7 calendar days for all perimeter sediment control structures, dikes, perimeter slopes, and all slopes areater than 3:1, (b) 14 days as to all other disturbed or graded areas on the
- All sediment traps/basins shown must be fenced and warning signs posted around their perimeter in accordance with Vol. 1, Chapter 7, HOWARD COUNTY DESIGN MANUAL, Storm Drainage.
- 5. All disturbed areas must be stabilized within the time period specified above in accordance with the 1994 MARYLAND STANDARDS AND SPECIFICATIONS FOR SOIL EROSION AND SEDIMENT CONTROL for permanent seeding, sod, temporary seeding, and mulching (Sec. G). Temporary stabilization with mulch alone shall be done when recommended seeding dates do not allow for proper germination and establishment of arasses.
- All sediment control structures are to remain in place and are to be maintained in operative condition until permission for their removal has been obtained from the Howard County Sediment Control Inspector.
- 7. Site Analysis

Total Area	9.81 Acres
Area Disturbed	8.39 Acres
Area to be roofed or paved	3.64 Acres
Area to be vegetatively stabilized	4.75 Acres
Total Cut	*15,7 <u>97 CY</u>
Total Fill	<u>*65,388 CY</u>
Offsite waste/borrow area location	**

- 8. Any sediment control practice which is disturbed by grading activity for placement of utilities must be repaired on the same day of disturbance.
- 9. Additional sediment controls must be provided, if deemed necessary by the

Howard County Sediment Control Inspector.

- 10. On all sites with disturbed areas in excess of 2 acres, approval of the inspection agency shall be requested upon completion of installation of perimeter erosion and sediment controls, but before proceeding with any other earth disturbance or grading. Other building or grading inspection approvals may not be authorized until this initial approval by the inspection agency is made.
- Trenches for the construction of utilities is limited to three pipe lengths or that which shall be back-filled and stabilized within one working day, whichever is shorter.
- * Earthwork quantities are solely for the purpose of calculating fees. Contractor to verify all quantities prior to the start of construction.
- ** To be determined by contractor, with pre-approval of the Sediment Control Inspector with an approved and active grading permit

SEQUENCE OF CONSTRUCTION

- I. Obtain Grading permit. 2. Notify Howard County Department of Inspections, License and Permits at (410) 313-1880 at least
- 24 hours before starting any work.
- 3. Install stablized construction entrances, silt fence, super silt fence, earth dikes, and temporary pipe. (1 week)
- 4. Clear, grub, and rough grade site. (3 weeks)
- 5. Construct storm drain, water and sewer. (3 weeks)
- 6. Construct private roads and begin building construction. (1 month)
- 7. Complete building construction, fine grade site and install Erosion Control Matting. (4 months)
- 8. Install landscaping and afforestation plantings. (1 week)
- 9. Flush storm drain system. (I day) 10. During grading and after each rainfall, contractor will
- inspect and provide necessary maintenance to the
- sediment control measures on this plan. 11. Following initial soil disturbance or any redisturbances, permanent or temporary stabilization shall be completed
 - A. 7 calender days for all perimeter
 - sediment control structures, dikes,
 - swales and all slopes greater than 3:1 B. 14 calender days for all other disturbed areas.
- 12. Upon stabilization of all disturbed areas and with the permission of the sediment control inspector, remove all sediment control measures and stabilize any remaining disturbed area. (I week)

SEDIMENT AND EROSION CONTROL NOTES AND DETAILS VILLAGE CREST

UNITS 1 THRU 51

TAX MAP 31, 20, GRID 3, 25 2ND ELECTION DISTRICT Taylor Family Limited Partnership A

PARCEL E-I # P/O D-I HOWARD COUNTY, MARYLAND



FSH Associates Engineers Planners Surveyors 8318 Forrest Street Ellicott City, MD 21043 Tel:410-750-2251 Fax: 410-750-7350 E-mail: FSHAssociates@cs.com

DESIGN BY: PS/KO DRAWN BY: M2/KO CHECKED BY: ZYF SCALE: As Shown DATE: June 18, 2003 W.O, No.: <u>3092</u> SHEET No.: 6 OF 9

APPROVED: HOWARD COUNTY DEPARTMENT OF PLANNING AND ZONING REVIEWED FOR HOWARD SCD AND MEETS TECHNICAL REQUIREMENTS

(120 03 m Mum USDA-NATURAL RESPURCES AND SERVICE THIS DEVELOPMENT PLANTS APPROVED FOR SOIL EROSION AND SEDIMENT CONTROL BY THE HOWARD SOIL CONSERVATION DISTRICT

ENGINEERS CERTIFICATE "I CERTIFY THAT THIS PLAN FOR SEDIMENT AND EROSION CONTROL REPRESENTS A PRACTICAL AND WORKABLE PLAN BASED ON MY PERSONAL KNOWLEDGE OF THE SITE CONDITIONS AND THAT IT WAS PREPARED IN ACCORDANCE WITH THE REQUIREMENTS OF THE HOWARD SOIL CONSERVATION DISTRICT.

tachatia DATE SIGNATURE OF ENGINEER ZACHARIA Y. FISCH

"I/WE CERTIFY THAT ALL DEVELOPMENT AND CONSTRUCTION WILL BE DONE ACCORDING TO THIS PLAN FOR SEDIMENT AND EROSION CONTROL, AND THAT ALL RESPONSIBLE PERSONNEL INVOLVED IN THE CONSTRUCTION PROJECT WILL HAVE A CERTIFICATE OF ATTENDANCE AT A DEPARTMENT OF THE ENVIRONMENT APPROVED TRAINING PROGRAM FOR THE CONTROL OF SEDIMENT AND EROSION BEFORE BEGINNING THE PROJECT. I ALSO AUTHORIZE PERIODIC ON-SITE INSPECTION BY THE HOWARD SOIL CONSERVATION DISTRICT.

DEVELOPER'S CERTIFICATE

W week SIGNATURE OF DEVELOPER

DEVELOPER Pulte Homes 1501 S. Edgewood Street Suite K Baltimore, Maryland 21227 410-644-5603

OWNER


C/o Land Design # Development, Inc.

8000 Main Street

Ellicott City, MD 21043

Attn.: Mr. Donald R. Revwer

Phone: (410) 480-9105

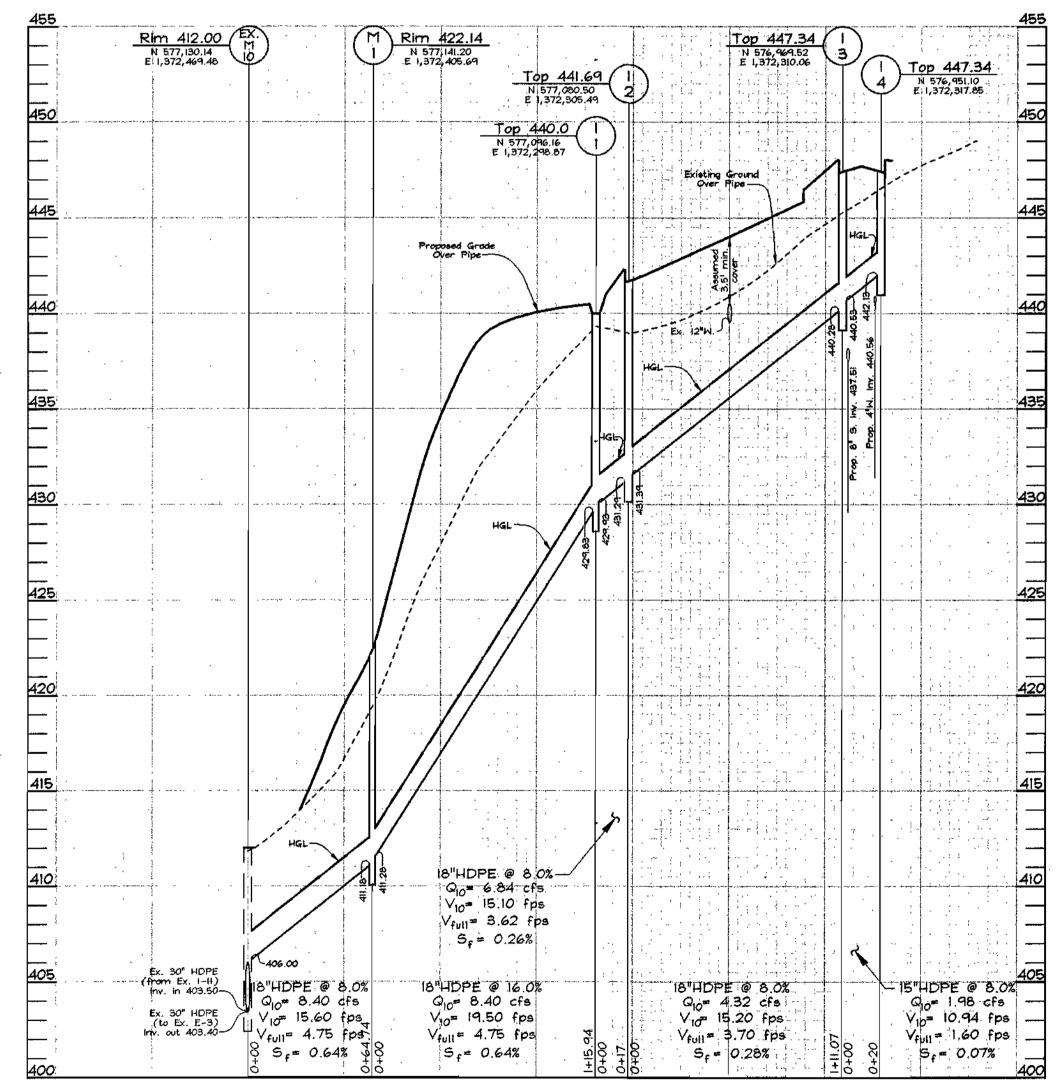


STORM	DRAIN	PROFILE				
SCALE: HOR.: 1"=50' VERT.: 1"=5'						

APPROVED:	HOWARD CO	UNTY DEPAR	TMENT OF F	PLANNING AI	ND ZONING	
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CHIĒF,	DIVISION OF	LAND DEVEL	OPMENT	7/3	0/07	
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M:\Village Crest Pulte 3092\dwg\SDP\3092 5Q_s7.dwg, 6/18/2003 12:59:12 PM, andyb

STRUCTURE SCHEDULE						
NO.	TYPE	LOCATION	TOP ELEV.	INV. IN	INV. OUT	REMARKS
11	Single 'S'	N 577,096.16 E 1,372,298.8	7 440.0	429.93	429.83	SD 4.22
I-2	Double 'S'	N 577,079.72 E 1,372,303.	441.69	431.39	431.29	SD 4.23
1-3	Single '5'	N 576,969.52 E 1,372,310.0	6 447.34	440.53	440.28	SD 4.22
1-4	Single 'S'	N 576,951.10 E 1,372,317.8	5 447.34	1	442.13	SD 4.22
M-1	Precast Manhole (4')	N 577,141.20 E 1,372,405.6	9 422.14	411.28	411.18	G 5.12

	PIPE SCHEDULE	
SIZE	TYPE	LENGTH
15"	HDPE	20 LF
18"	HDPE	309 LF
	-	

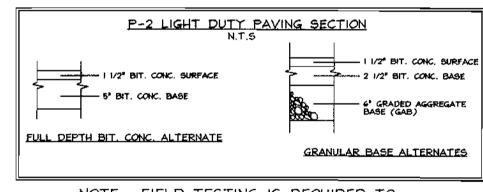

NOTE: FIELD TESTING IS REQUIRED TO VERIFY ADEQUATE DEPTH OF PROPOSED PAVING SECTION.

STORM DRAIN PROFILES AND SITE DETAILS VILLAGE CREST UNITS 1 THRU 51

TAX MAP 31, 20, GRID 3, 25 2ND ELECTION DISTRICT

PARCEL E-I \$ P/O D-I HOWARD COUNTY, MARYLAND

DEVELOPER

DESIGN BY: KO FSH Associates


Engineers Planners Surveyors
8318 Forrest Street Ellicott City, MD 21043
Tel:410-750-2251 Fax: 410-750-7350
E-mail: FSHAssociates@cs.com DRAWN BY: KO


CHECKED BY: ZYF SCALE: As Shown DATE: June 18, 2003 W.O. No.: 3092 SHEET No.: 7 OF 9

OWNER

Taylor Family Limited Partnership A
C/o Land Design & Development, Inc.
8000 Main Street
Ellicott City, MD 21043

Pulte Homes
1501 S. Edgewood Street Suite K
Baltimore, Maryland 21227
410-644-5603 Ellicott City, MD 21043 Attn.: Mr. Donald R. Reuwer Phone: (410) 480-9105

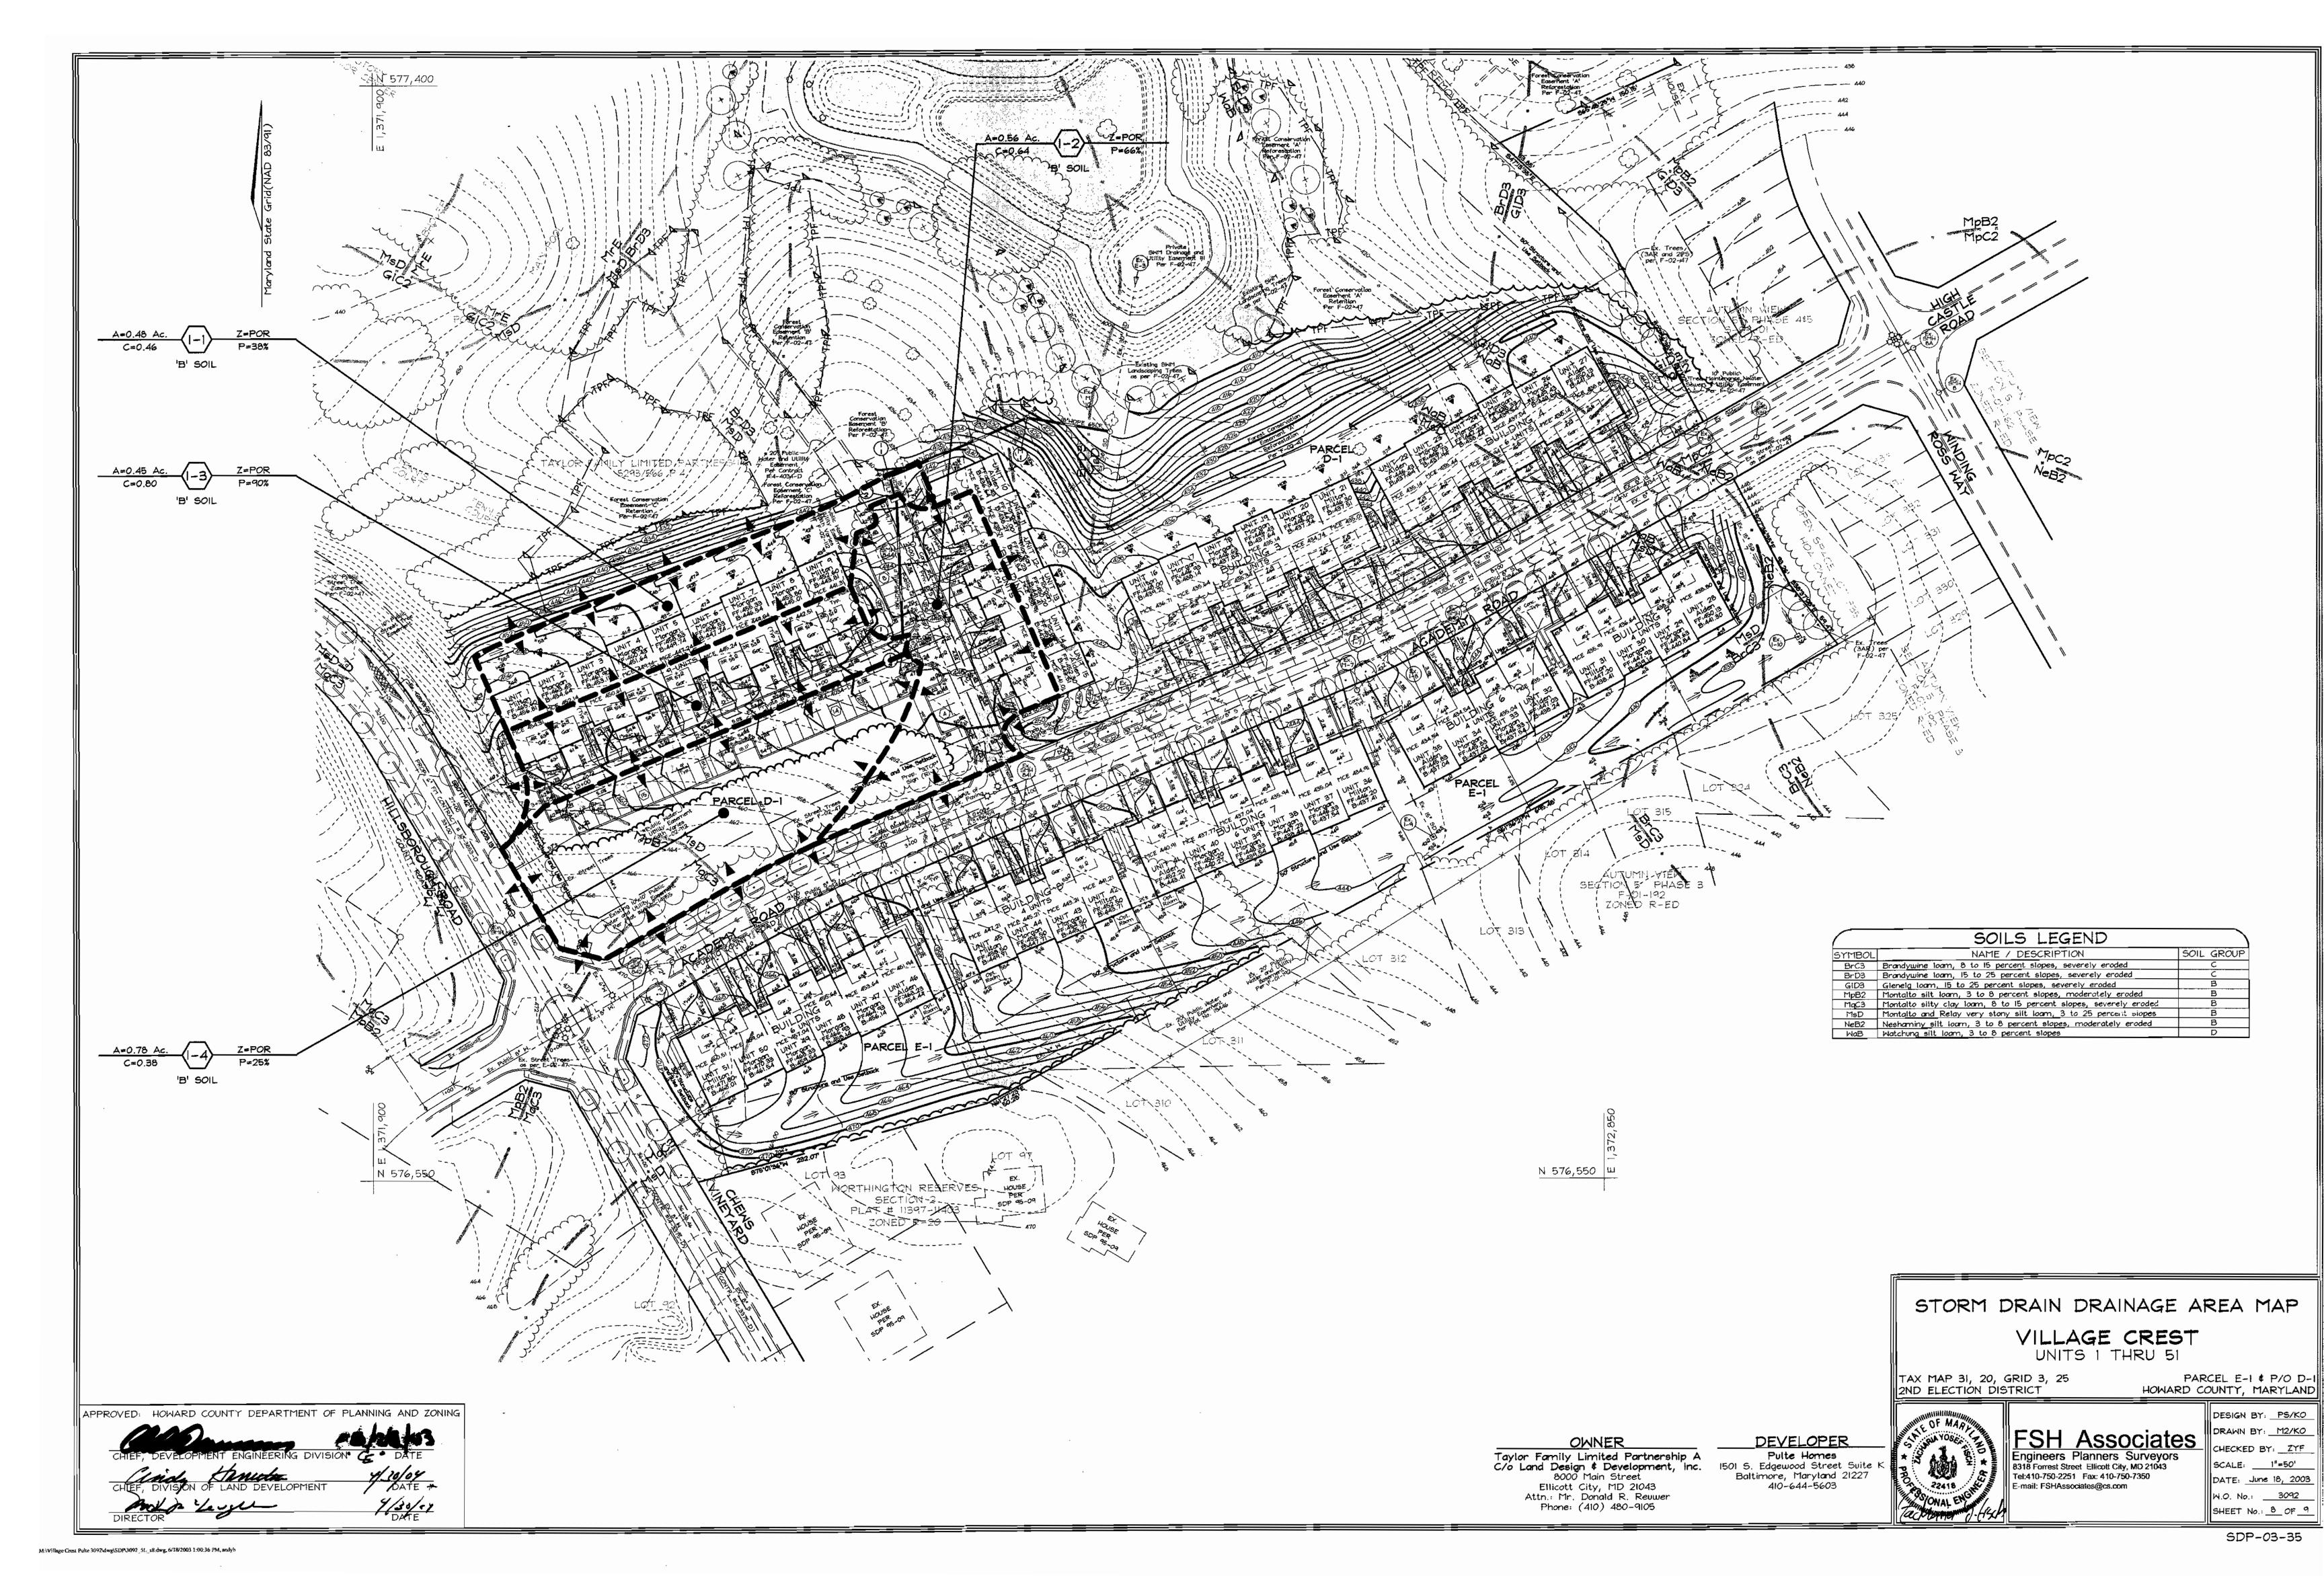

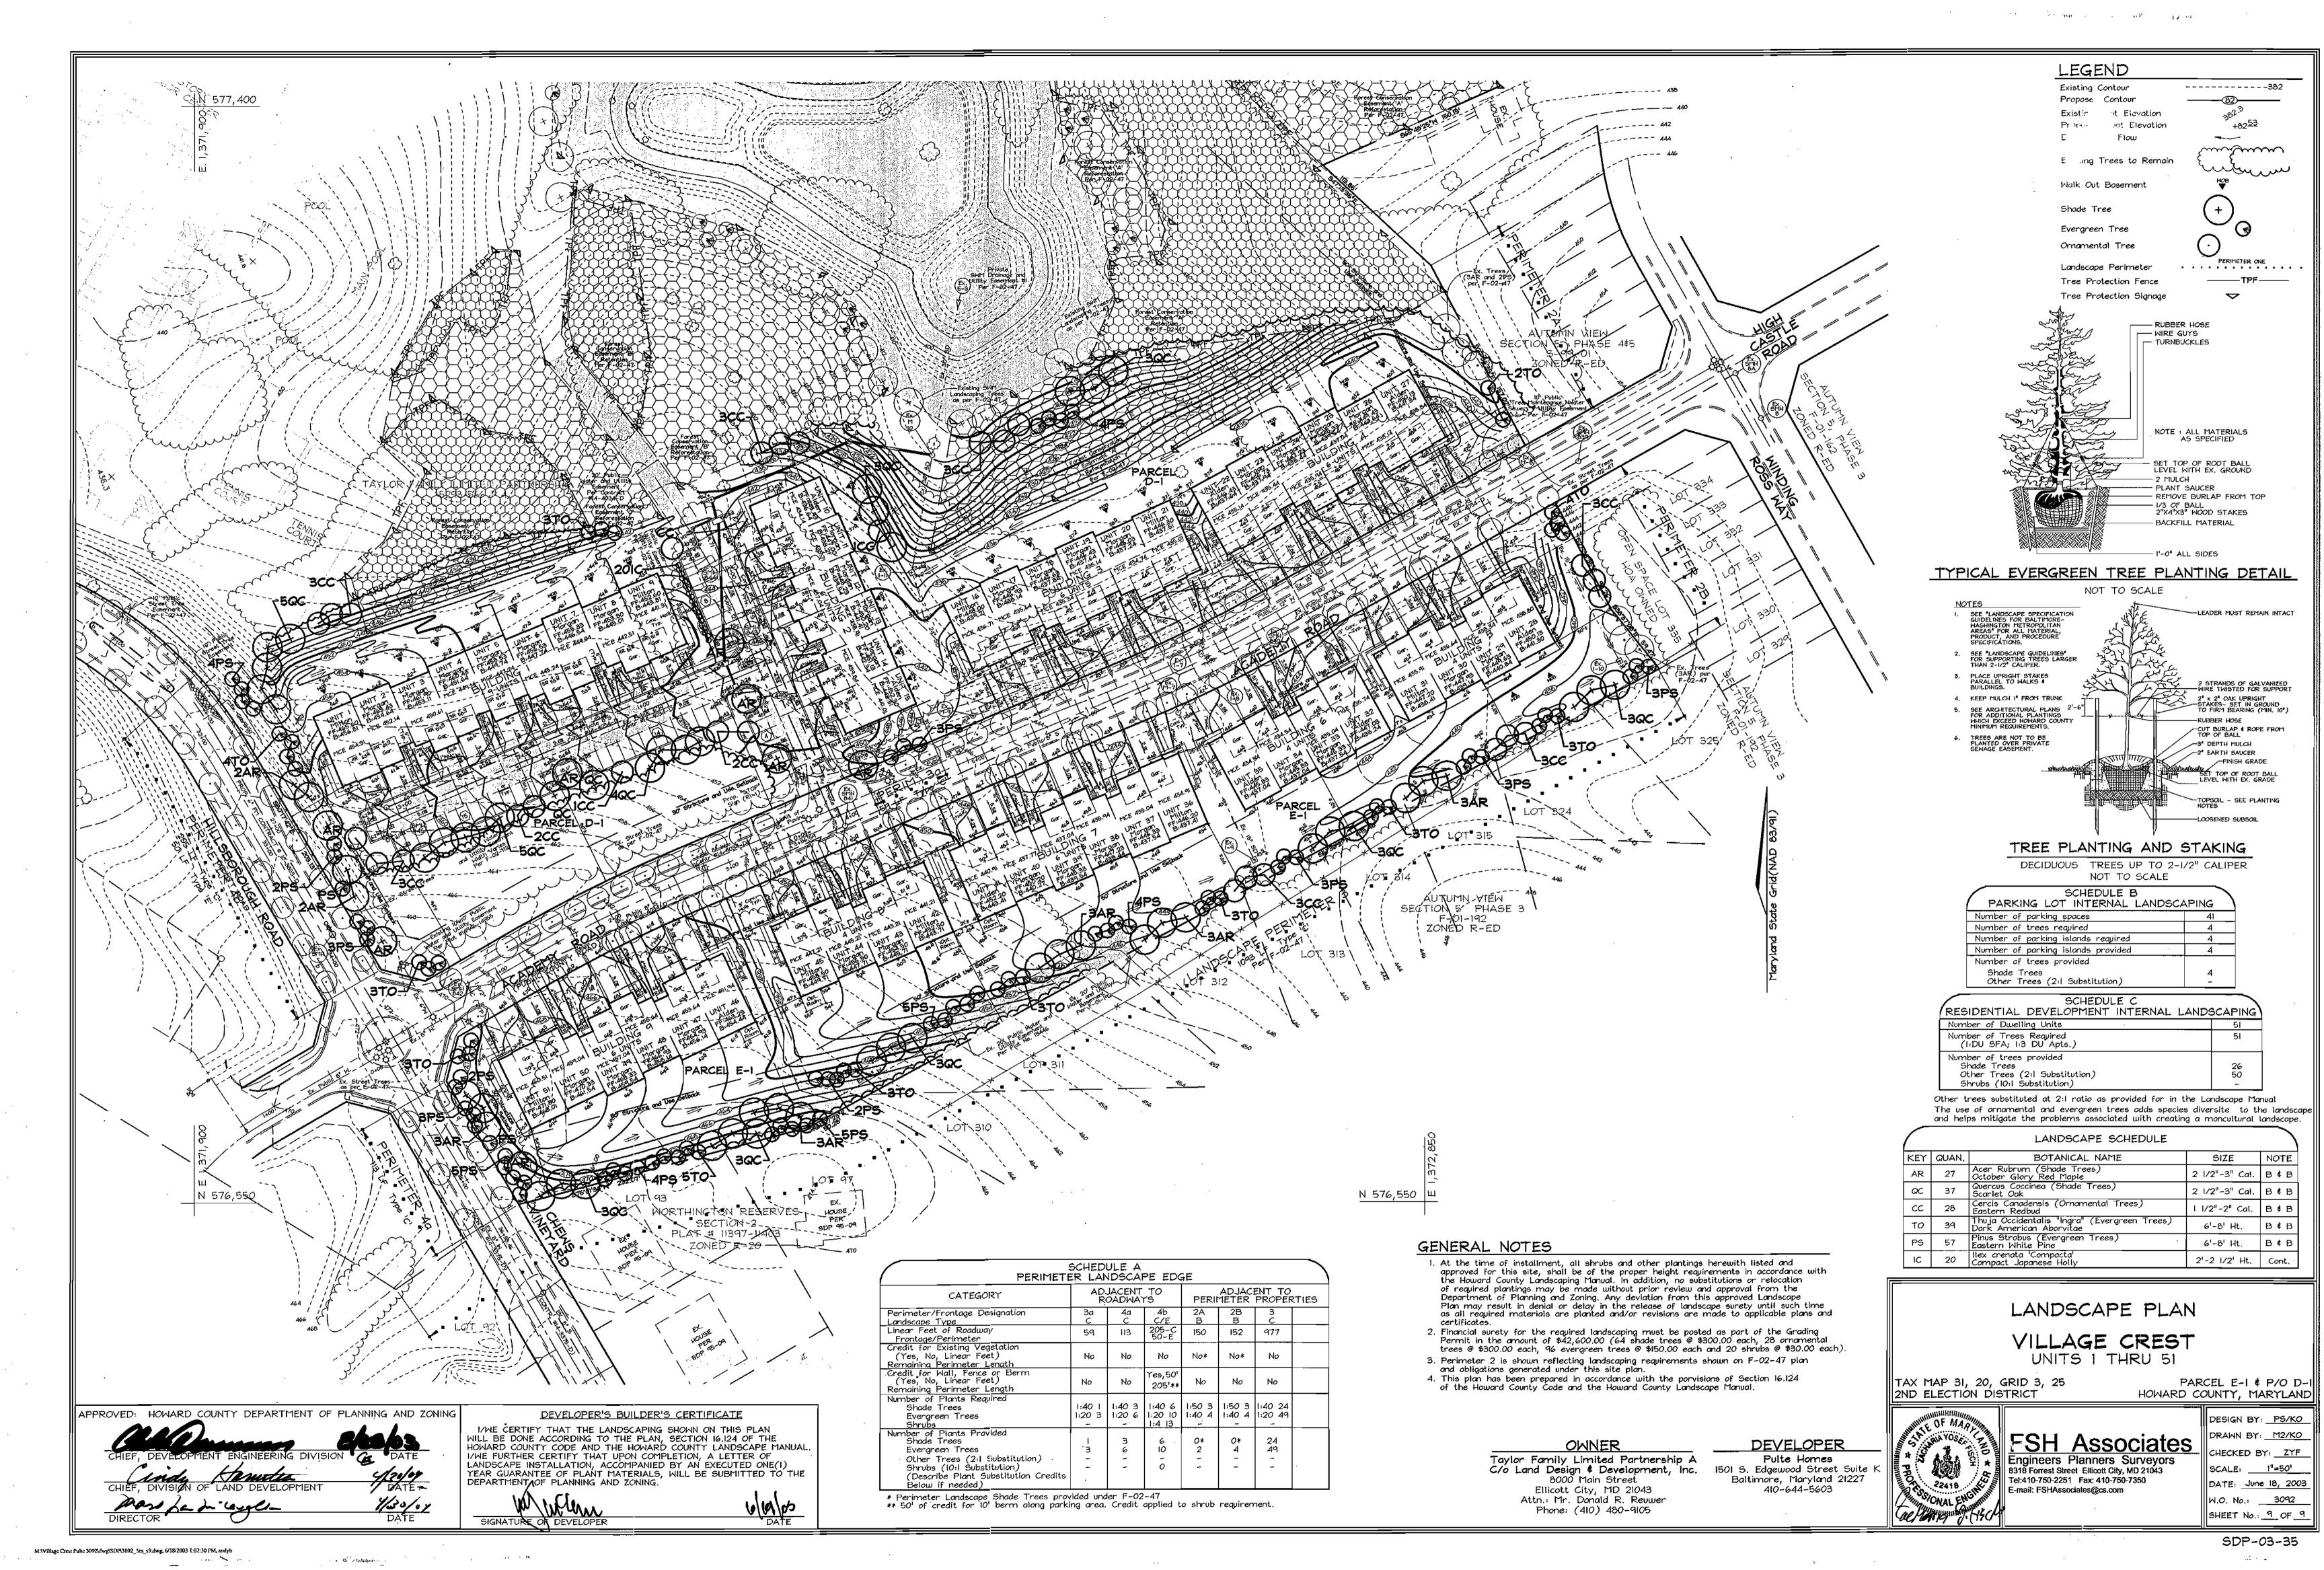

Control of the Contro GENERAL NOTES

- . Public water and sewer will be used within this site. 2. Stormwater Management Quantity and quality is provided by regional facility on F-02-47.
- Recharge is provided on site in a grass swale. 3. The Contractor shall notify the following utility companies or agencies at least five(5) working days before starting work shown on these plans:

State Highway Administration BGE(Contractor Services) BGE (Underground Damage

410.850.4620 410.787.9063 Miss Utility Colonial Pipeline Company 1.800.257.7777 410 795 1390 Howard County, Dept. of Public Works, Bureau of Utilities 410.313.4900

Howard County Health Department 410.313.2640 4. The contractor shall notify Miss Utility at 1-800-257-7777 at least 48 hours prior to any excavation work being done

5. The contractor shall notify the Department of Public Works/Bureau of Engineering Construction Inspection Division at (410) 313-1880 at least five (5) working days prior

6. The existing topography is taken from F-02-47. . Existing utilities are based on F-02-47.

8. There are no floodplains, steep slopes, historic structures or cemeteries within Limits of Disturbance.

9. The project is in conformance with the latest Howard County Standards unless waivers have been approved.

10. The coordinates shown hereon are based upon the Howard County Geodetic Control which is based on the Maryland State Plane Coordinate system. Howard County monument numbers 304005R and 3044004R were used for this project.

II. No clearing, grading or construction is permitted within wetlands, streams or their required buffers, forest conservation retention easements, and forest conservation reforestation easements after they have been planted. 12. Financial Surety for the required landscaping shall be posted as part of the Grading

Permit in the amount of \$42,600.00 (64 shade trees @ \$300.00 each, 28 ornamental trees @ \$300.00 each, 96 evergreen trees @ \$150.00 each and 20 shrubs @ \$30.00 each). 13. All curb and gutter to be Howard County Standard R-3.01 Modified Curb and Gutter unless otherwise noted.

15. Any damage to the County's Right-of-Way shall be corrected at the developer's expense.

14. All proposed spot elevations along curb and gutter are to the flowline unless otherwise

16. SHC elevations shown are at 2.0%. See Water/Sewer Contract #14-4034-D for additional information. 17. For driveway entrance details refer to Howard County Design Manual, Volume IV, Standard Détail R-6-05 (use 20' wide driveway).

18. Section 128.A.I.c of the Howard County Zoning Regulations allows porches or decks, open or enclosed to project not more than 10 feet into the required front or rear setback area or into a required setback from a project boundary or different zoning districts. Exterior stairways or ramps, above or below ground level, may extend not more than 10 feet into a front setback area or a setback from a project boundary or different zoning district, and not more than 16 feet into a rear setback area.

19. All HDPE pipe specification and installation shall meet AASHTO M-252 Type S, M-294 Type S and ASTM D2321, respectively.

20. All pathways and sidewalks to conform to Howard County Standard Detail R.3.05. 21. Soil compaction specifications, requirements, methods and materials are to be in accordance with the recommendations of the project Geotechnical Engineer. Geotechnical Engineer to

22. All traffic control devices, markings and signing shall be in accordance with the latest edition of the Manual on Uniform Traffic Control Devices (MUTCD). 23. Contractor is responsible to construct all handicap ramps and handicap access in accordance

confirm acceptability of proposed paving section, based on soil test, prior to construction.

with current ADA requirements. Handicap Ramps to conform to Howard County Standard 24. APFO Traffic Study not required for this project. Proposed site is greater than I mile

to closest major collector intersection. The developer is proposing housing for elderly for Village Crest Subdivision. The site development of proposed private community recreation center only open to the members that must be residents and/or homeowners in the subdivisions of Village Crest and their guests.


25. All storm drain located outside of the public Right-of-Way shall be privately owned and maintained by the Home Owners Association. 26. Units I thru 15 will have private trash collection. Units 16 thru 51 will have public trash collection.

27. Forest Conservation obligations are identified and provided under F-02-47. For bearings and distances of Forest Conservation Easements and see Record Plat #16104-16109 (F-02-47) recorded in the Land Records of Howard County.

28. Convenants regarding age restrictions are recorded among the land records of Howard County in Liber 7916 Folio 335-338.

8268 Academy Road 8266 Academy Road 8264 Academy Road 8262 Academy Road 8260 Academy Road 8258 Academy Road 8256 Academy Road 8254 Academy Road 8252 Academy Road 8248 Academy Road 8246 Academy Road 8244 Academy Road 8242 Academy Road 8240 Academy Road 8238 Academy Road 8234 Academy Road 8232 Academy Roac 8230 Academy Roac 8228 Academy Road 8226 Academy Road 8224 Academy Road 8220 Academy Road 8214 Academy Road 8212 Academy Road 8210 Academy Road 8211 Academy Road 8213 Academy Road 8215 Academy Road 8217 Academy Road 8221 Academy Road 8223 Academy Road 8225 Academy Road 8227 Academy Road 8231 Academy Road 8233 Academy Road 8235 Academy Road 8237 Academy Road 8239 Academy Road 8241 Academy Road 8245 Academy Road 8247 Academy Road 8249 Academy Road 8251 Academy Road 8255 Academy Road


ADDRESS CHART

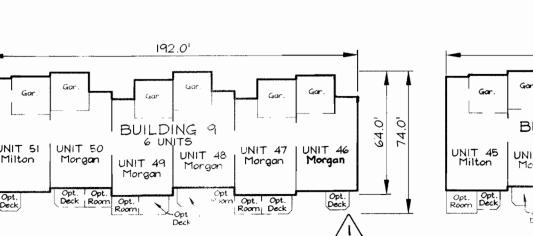

Revised Unit 46 from Alden to Morgan


DESCRIPTION

REVISIONS

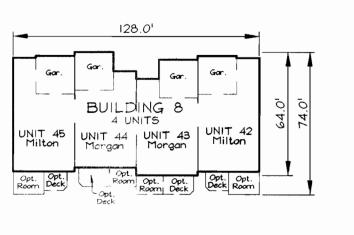

For unit dimensions see

house templates this sheet

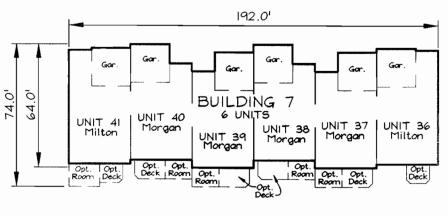

BUILDING TEMPLATES

SCALE:1=50'

LOCATION MAP

SCALE: 1"=100'

SITE DEVELOPMENT PLAN


VILLAGE CREST

UNITS 1 THRU 51

HOWARD COUNTY, MARYLAND


Limit of Submission for -

this plan on Parcel D-1

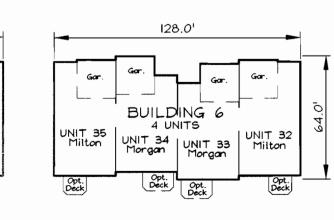


0 watt HPS vapor pendant | 14' bronze fiberglass

Note: Light pole location given at center of base

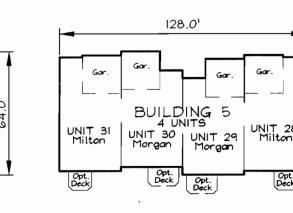

N 576,889.6196 E 1,372,185.2708

№ 576,350 Ш

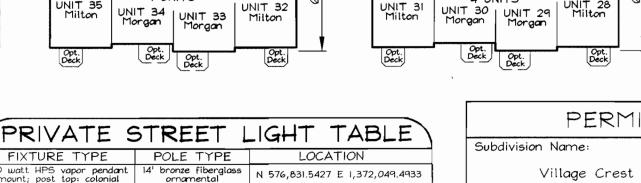


PERMIT INFORMATION CHART								
Subdivision Nam	ne:		Section/A	rea			Lot/Parcel No.	
Villaç	ge Crest		N/A		Parcel E-1 an P/O Parcel D			
Plat #	Grid	Zoning	Tax Map	No.	Elect.	District	Census Tract	
16104-16109 16421-16422	<i>0</i> 3 25	POR	31 20		2nd		6027.00	
Water Code			Sewer Co	de				

LEGEND Existing Contour -----382 Proposed Contour Existing Spot Elevation Proposed Spot Elevation $\sim\sim\sim$ Existing Trees to Remain Forest Conservation Easement (Reforestation)

Forest Conservation Easement (Retention) Tree Protection Fence Tree Protection Signage

SHEET INDEX DESCRIPTION SHEET No. Revised Cover Sheet 1 of 9 Revised Site Development and Grading Plan 2 of 9 Revised Site Development and Grading Plan 3 of 9 Revised Sediment and Erosion Control Plan 4 of 9 Revised Sediment and Erosion Control Plan 5 of 9 Sediment and Erosion Control Notes and Details 6 of 9 Storm Drain Profiles and Site Details 7 of 9 Revised Storm Drain Drainage Area Map 8 of 9 Revised Landscape Plan and Details 9 of 9

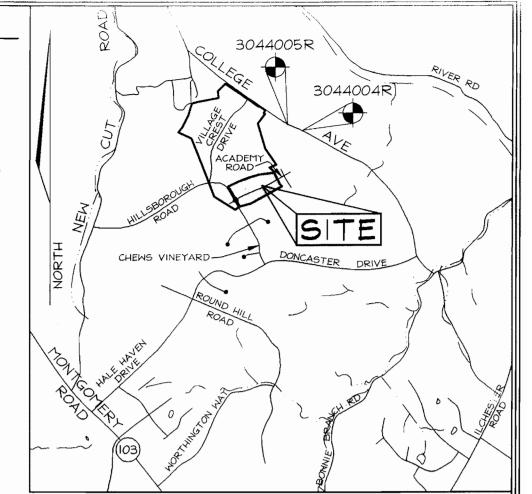

VICINITY MAP

BENCHMARKS

Sta. 3044005R N 578,233.92 E 1,373,142.33 Elev. 374.389 Sta. 3044004R N 578,128.03 E 1,373,460.71 Elev. 362.575

SITE ANALYSIS DATA CHART


- a. Limit of submission acreage on Parcel D-1 for this plan =5.53 Ac. \pm (Total of D-1: 38.49 Ac. \pm) b. Total area of Parcel E-1 for this subdivision =3.58 Ac. ±
- c. Area of plan submission: 9.11 Ac.±

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- d. Limit of disturbed area: 8.39 Ac.±
- e. Present zoning: "POR" per 02/02/04 Comprehensive Zoning Plan. f. Proposed uses for site \$ structures: Age Restricted Adult Housing
- g. Floor space on each level of building(s) per use: See building templates
- h. Total number of units proposed: 51
- i. Number of parking spaces required: 102 (2 per unit) j. Total number of parking spaces provided: 143(2.8 parking spaces provided per unit) Number of parking spaces provided with two-car garage units: 102
- Number of common parking area head-in parking spaces provided: 41 In accordance with Zoning Sections 115.D.2.b(2), 133.C.1.a \$ b, and 133.D.2.b.(1), the two
- parking spaces in the garages in Units 16-51 must be used for parking only, as parking, a use, is not permitted within the shown "30' Structure and Use Setback." k. Open Space/Area required: 0 ac. (Per Plat under F-02-47)
- 1. Total Building coverage of site: 93,803.16 sf = 2.15 Ac. = 23.7% Building coverage on Parcel D-1 for this subdivision: 49497.66 sf = 1.14 Ac. = 20.6%
- Building coverage on Parcel E-I for this subdivision: 44,305.50 sf = 1.01 Ac. = 28.4%
- m. A recreational center is proposed on another part of Parcel D-I Per SDP-02-02. n. DPZ file references: S-98-18, S-00-05, P-00-07, P-01-20, F-02-112, F-02-47, SDP-02-94
- F-01-60, WS Contract #14-4034-D;F-04-077.
- o. <u>Recreational Open Space</u>

Required Recreational Open Space: 175 SF/UNIT (SDP-02-94)
267 Units (SDP-02-94): 46725 SF (1.07 Ac)
Required Recreational Open Space: 400 SF/UNIT (SDP-03-35)
51 Units (SDP-03-35): 20400 SF (0.468 Ac)
TOTAL RECREATIONAL OPEN SPACE REQ.: 67125 SF (1.54 Ac)

Provided Recreational Open Space (SDP-04-25) -Fenced Pool: 17744.99SF; & Community Recreation -Tennis Court: 16615.20 SF; Building (SDP-04-25): 2611.00 SF Per Community Recreational/Commercial Complex (SDF)-04-25): 36971.19 SF (0.85 Ac)

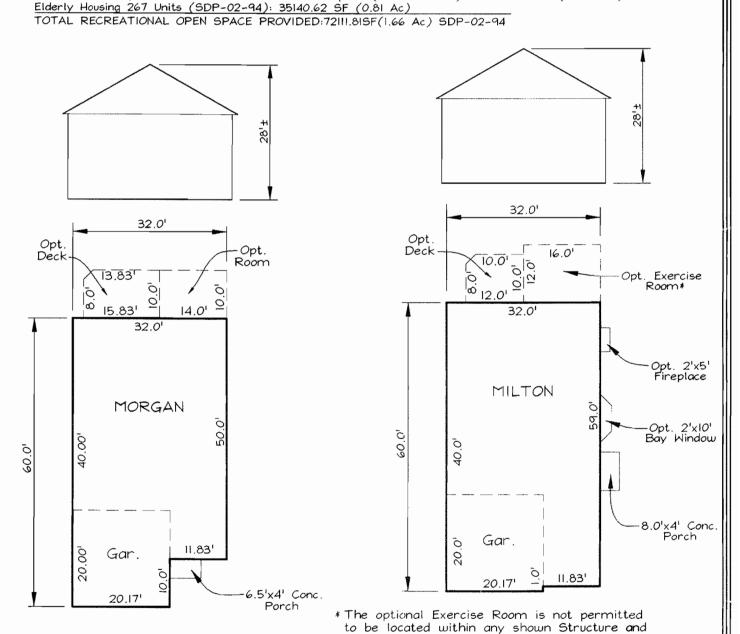

Purpose Note: The purpose of this plan is to revise House Template Grading around all units

REPLACEMENT SHEET OI 05

OWNER/DEVELOPER

Pulte Homes 1501 S. Edgewood Street Suite K Baltimore, Maryland 21227 410-644-5603

REVISED COVER SHEET

VILLAGE CREST UNITS 1 THRU 51

TAX MAP 31, 20, GRID 3, 25 2ND ELECTION DISTRICT

HOWARD COUNTY, MARYLAND

DESIGN BY: KO FSH Associates



HOUSE TEMPLATES

DRAWN BY: KO CHECKED BY: ZYF SCALE: As Shown DATE: Dec. 23, 2004 W.O. No.: ____3092 SHEET No .: 1 OF 9

SDP-03-35

PARCEL E-1 & P/O D-

8257 Academy Road

8261 Academy Road

8263 Academy Road

8265 Academy Road

APPROVED: HOWARD COUNTY DEPARTMENT OF PLANNING AND ZONING

