CROSSROADS CHURCH OF THE NAZARENE

GENERAL NOTES

- 1. ALL CONSTRUCTION SHALL BE IN ACCORDANCE WITH THE LATEST STANDARDS AND SPECIFICATIONS OF HOWARD COUNTY PLUS MSHA STANDARD AND SPECIFICATIONS IF APPLICABLE.
- 2. THE CONTRACTOR SHALL NOTIFY THE DEPARTMENT OF PUBLIC WORKS/CONSTRUCTION INSPECTION DIVISION AT (410) 313-1880 AT LEAST FIVE (5) WORKING DAYS PRIOR TO THE START OF WORK.
- 3. THE CONTRACTOR SHALL NOTIFY "MISS UTILITY" AT 1-800-257-7777 AT LEAST 48 HOURS PRIOR TO ANY EXCAVATION WORK.
- 4. THE CONTRACTOR SHALL NOTIFY THE HOWARD COUNTY DEPARTMENT OF PUBLIC WORKS, BUREAU OF UTILITIES AT (410) 313-4900 AT LEAST FIVE WORKING DAYS PRIOR TO STARTING ANY EXCAVATION WORK.
- 5. SITE AREA: 10.35 Ac. ±
- 6. TRAFFIC CONTROL DEVICES, MARKINGS, AND SIGNING SHALL BE IN ACCORDANCE WITH THE LATEST EDITION OF THE MANUAL ON UNIFORM TRAFFIC CONTROL DEVICES (MUTCD). ALL STREET AND REGULATORY SIGNISHALL BE IN PLACE PRIOR TO THE PLACEMENT OF ANY
- 7. ALL PLAN DIMENSIONS ARE TO FACE OF CURB UNLESS OTHERWISE NOTED.
- 8. EXISTING TOPOGRAPHY REFLECTS FIELD SURVEY BY CENTURY ENGINEERING EXCEPT IN VICINITY OF MOMOPOLE ANTENNA AREA
- 9. COORDINATES AND BEARING ARE BASED UPON THE MD STATE PLAN SYSTEM (NAD '83).
- 10. EXISTING WATER AND SEWER SHOWN IS PUBLIC.
- 11. STORMWATER MANAGEMENT: QUANITY AND QUALITY MANAGEMENT IS PROVIDED BY ON-SITE FACILITIES. THE FACILITIES CONSIST OF POCKET AND SURFACE SAND FILTERS FOR WATER QUALITY AND UNDERGROUND STONE STORAGE FOR THE CPV VOLUME.
- 12. ALL EXISTING WATER AND SEWER IS PER CONTRACT #S: 70-W & 10-3707
- 13. NO EXISTING PUBLIC STORM DRAIN ON SITE.
- 14. ALL CURB RADII IS 5' UNLESS NOTED OTHERWISE.
- 15. UTILITY INFORMATION TAKEN FROM APPROVED FINAL CONSTRUCTION PLANS FOR DEVELOPMENT.
- 16. ALL SIDEWALKS SHALL BE 4' WIDE EXCEPT WHERE DIMENSIONED OTHERWISE, PROVIDE 3' RADIUS ROUNDING AT ALL ANGLE BREAKS
- 17. CONTRACTOR SHALL UTILIZE PVC FOR ALL SEWER HOUSE CONNECTIONS. CONTRACTOR SHALL UTILIZE D.I.P. (CL. 51) FOR WATER SERVICE CONNECTION. (FIRE & DOMESTIC)
- 18. USE HOWARD COUNTY TRENCH BEDDING CLASS "C" FOR STORM DRAINS.
- 19. PAVED AREAS INDICATED ARE PRIVATE EXCEPT AS NOTED.
- 20. PROJECT BACKGROUND: SEE DEPT. OF PLANNING & ZONING FILE NUMBERS: SPD 73-89, BA-94-26E & BA01-30C, 6tp.95.87
- 21. ALL PROPOSED RAMPS SHALL BE IN ACCORDANCE WITH CURRENT A.D.A. STANDARDS. MAXIMUM SIDEWALK CROSS SLOPE SHALL BE TWO PERCENT. PROVIDE A FIVE-FOOT BY FIVE-FOOT LEVEL (2 PERCENT MAX.) LANDING AT THE TOP AND BOTTOM OF ALL RAMPS AND BUILDING
- 22. ALL PROPOSED SITE UTILITIES ARE TO TERMINATE 5' FROM THE BUILDING. THE BUILDING PLUMBER SHALL CONNECT TO AND EXTEND THESE UTILITIES TO THE INSIDE OF THE BUILDING.
- 23. FOR GAS. TELEPHONE AND ELECTRIC ROUTING, SEE SEPARATE PLAN.
- 24. ALL EXISTING UTILITIES WITNIN THE PERIMETER OF PROP. BLDG. TO BE RELOCATED PER DRAWING AS REQUIRED.
- 25. ALL POTHOLES AND DEPRESSION IN EXISTING PAVED AREAS TO BE REPAIRED. ALL EXISTING PAVED AREAS WHICH ARE TO REMAIN SHALL BE SEALED AND RESTRIPED.
- 26. NO CLEARING, GRADING OR CONSTRUCTION IS PERMITTED WITHIN THE REQUIRED WETLANDS, STREAM(S) OR THEIR BUFFERS AND FOREST CONSERVATION EASEMENT AREAS EXCEPT TO INSTALL THE PROPOSED 24" OUTFALL, ENDWALL AND RIP-RAP AT EXISTING 36" OUTFALL. THE DISTURBANCE IS NECCESSARY TO CONSTRUCT THE PROPOSED OUTFALL TO PROVIDE A SINGLE DISCHARGE POINT AT THE EXISTING OUTFALL LOCATION AND SHALL BE CONSTRUCTED IN A MANNER SO AS TO DISTURB ONLY THE AREA REQUIRED TO INSTALL THE PROPOSED STORM DRAIN OUTFALL. THE DEPARTMENT OF PLANNING AND ZONING HAS DETERMINED THE THE INTRUSION INTO THE STREAM BUFFER FOR CONSTRUCTION OF THE RIPRAP OUTFALL ONLY TO BE ESSENTIAL PER SECTION 16.116(C) OF THE SUBDIVISION AND LAND DEVELOPMENT
- 27. TOPOGRAPHY OBTAINED BY CENTURY ENGINEERING ON 1-31-01
- 28. FOREST CONSERVATION REQUIREMENT TO BE PROVIDED IN AN EASEMENT CONTAINING 2.6 ACRES AS PER THE FOREST CONSERVATION RETENTION OBLIGATION, THE SURETY AMOUNT IS \$22,651.00 (\$0.20 PER S.F.), PLAN SHOWN ON SHEET 14 OF 14 1
- 29. THE LANDSCAPE OBLIGATION IS INCLUDED IN THE DEVELOPERS AGREEMENT. THE SURETY IS IN THE AMOUNT OF \$15,2+0.00
- 30. THIS PROJECT IS EXEMPT FROM APPO BECAUSE THE IMPROVEMENTS DO NOT GENERATE ADDITIONAL TRAFFIC DURING THE DESIGN STUDY HOURS.
- 31. SEE CAPITAL PROJECT NUMBER T-7076 FOR IMPROVEMENTS TO THE INTERSECTION OF ROGERS AVE. AND FREDERICK ROAD
- 32. THE PRESSURE SEWER WAIVER WAS OBTAINED ON JULY 26, 2002 FOR THE EXISTING MANHOLE AT THE INTERSECTION OF ROGERS AVE. AND FREDERICK ROAD.
- 33. THE PROPOSED WATER MAIN EXTENSION WILL BE CONSTRUCTED UNDER
- AN ADVANCED DEPOSIT ORDER.
- 34. THE EXISTING 36" PIPE WAS PLACED IN 1982 ALONG WITH THE PERMIT TO CONSTRUCT THE EXISTING GARAGE. THIS WAS DONE UNDER HOWARD
- 35. AN ALTERNATIVE COMPLIANCE TO THE 2000 MARYLAND STORMWATER DESIGN MANUAL VOLUMES I &II HAS BEEN APPROVED BY LETTER DATED 10/21/02. AN ADDITIONAL 0.78 ACRES OF EXISTING IMPERVIOUS AREA NOT REQUIRED TO BE TREATED IS TREATED BY THE DESIGN TO OFFSET THE 0.12 ACRES OF PROPOSED IMPERVIOUS WHICH WILL NOT BE MANAGED,
- 36. LIGHTING FIXTURE DETAILS SHOWN ON SHEET 3 OF 14.

SITE ANALYSIS CONTO

- 18. THE LIMIT OF DISTURBANCE (LOD) FOR REVISION #2
 15 1600 SF. AT SUCH TIME AS THE ACCUMULATED LOD
 FOR THIS REVISION AND PUTURE REVISIONS EXCEED 5,000SF,
- 19. REFERENCE BA 15-005 APPROVED JUNE 15, 2015, HEARING EXAMINER GRANTED THE PETITION OF CROSSROADS CHURCH OF THE NAZARENE TO ENLARGE AN EXISTING RELIGIOUS FACILITY WITH TWO BUILDING ADDITIONS IN AN R-20 (RESIDENTIAL: SINGLE) ZONING.



VICINITY MAP SCALE: 1"=600'

BENCH MARK

NO. 17FA-CONC. MON @ SURFACE 24.7' N. OF CLOLD FREDERICK RD RT. 99 (ROGERS AVE) W. OF OLD FREDERICK RD. ELEV.= 477.482'

NO. 17F7-CONC. MON. @ SURF. 20' N. OF @ RD. 66' E. OF CHAPEL AVENUE. ELEV.= 470.162'



ROBERT H. VOGEL PE. NO 16193 2 does Core

FOR PENISION #3 ONLY

PARCEL NO.

3 REMOVE EXISTING 6'COVERED WALKWAY REVISION

4/24/17 AND REPLACE WITH AN ENCLOSED LOBBY 4-25-03 ADDRESS CHART STREET ADDRESS 2750 ROGERS AVE. PARCELA 6055 18 R.20 2

SITE ANALYSIS

- 1. TOTAL SITE AREA: 10.35 AC. +/- = 450,846 S.F
- 2. TOTAL NUMBER OF PARCELS: 2
- 3. DEED REFERENCE: 4799/230 & 541/721 4. PRESENT ZONING: R-20
- 5. TAX MAP: 17 GRID: 18 PARCELX: 186 2 97
- **ELECTION DISTRICT: 2** 6. PARKING TABULATION: A. REQUIRED:
 - RELIGIOUS ACTIVITIES STRUCTURE
 1 SPACE / 3 SEATS X 325 EX. SEATS = 109 SPACES
- 201 SPACES (INCLUDING 7 HANDICAP SPACES) 7. SITE AREA TABULATION:
 - 10.35 Ac. (PARCEL 86-1.00 Ac. PARCEL 87-9.35 Ac.) A. PARCEL AREA 1.55 Ac. 15% COVERAGE B. BUILDING AREA
- 8. OWNER & PETITIONER: CROSSROADS CHURCH OF THE NAZERENE
 - 2750 ROGERS AVE. ELLICOTT CITY, MD. 21043
- TEL. 410-465-1103 9. EXISTING AND PROPOSED USE IS RELIGIOUS ACTIVITIES STRUCTURES (CLASSROOMS, KITCHEN AND SOCIAL HALL/GYM) THIS ADDITION IS NOT FOR CHILD DAY CARE
- 10. THE STORMWATER MANAGEMENT FACILITY FOR PHASE 1 IS TO BE GRASS SWALE FOR PRETREATMENT, SAND FILTER FOR WATER QUALITY UNDERGROUND STOREAGE FOR CHANNEL PROTECTION AND RECHARGE VOLUME. STORMWATER MANAGEMENT FOR THE IMPROVEMENTS SHOWN ON THIS PLAN ARE BASED ON MEASURED IMPERVIOUS AREAS USING
- REDEVELOPMENT CRITERIA ANY ADDITIONAL CONSTRUCTION ON THIS SITE SHALL REQUIRE FURTHER EVALUATION OF THE STORMWATER MANAGEMENT PROVISIONS. SURFACE SAND FILTER AND COV ENLARGEMENT (REVISION I).
- 11. TOTAL DISTURBED AREA = 122,345 S.F. = 2.81 Ac±
- 12. PROPOSED BUILDING ADDITION: UPPER LEVEL=4,277 SF
- LOWER LEVEL=|445| SF/31 13. ZONING PETITION BA01-30C, FOR A CONDITONAL USE FOR A NONCONFORMING EXISTING RELIGIOUS FACILITY AND FOR AN
- ENLARGEMENT TO THAT FACILITY IN AN R-20 (RESIDENTIAL: SINGLE) ZONING DISTRICT WAS GRANTED ON 11-29-01 SUBJECT TO THE THE FOLLOWING CONDITIONS. 1. THE CONDITIONAL USE SHALL APPLY ONLY TO THE EXISTING AND PROPOSED RELIGIOUS FACILITY AS DESCRIBED IN THE PETITION, AND AS DEPICTED ON THE CONDITIONAL USE PLAN FOR BALTIMORE FIRST CHURCH OF THE NAZERENE SUBMITTED ON MAY 15, 2001, AND NOT
- TO ANY OTHER ACTIVITIES, USES OR STRUCTURES ON THE PROPERTY. 2. THE PETITIONER SHALL INSTALL A TYPE D (SCREEN) LANDSCAPE EDGE ALONG THE WEST SIDE OF THE NEW PARKING LOT ON PARCEL 86 TO SCREEN THE PARKING LOT FROM THE ABUTTING PROPERTY TO THE WEST.

 3. THE PHASING PLAN FOR THE CONSTRUCTION OF THE IMPROVEMENTS IS APPROVED AS FOLLOWS: (a) PHASE I, THE CONSTRUCTION OF THE FAMILY LIFE CENTER, SHALL COMMENCE WITHIN THREE YEARS OF THE DATE HEREOF; (b) PHASE II, THE SANCTUARY EXPANSION, WITHIN FIVE YEARS OF THE DATE HEREOF:
- (c)PHASEIII. THE CONSTRUCTION OF A SEPERATE BUILDING TO BE USED FOR THE CHURCH OFFICES, SHALL COMMENCE WITHIN SEVEN YEARS OF THE DATE HEREOF. 4. THE PETIONER SHALL COMPLY WITH ALL APPLICABLE FEDERAL, STATE AND COUNTY LAWS AND REGULATIONS.
- 14. PREVIOUSLY APPROVED SITE DEVELOPMENT PLANS SDP 73-89, SDP 95-87 & BA-94-26E MONOPOLE PLAN. CONDITIONAL USE SHALL APPLY ONLY TO EXISTING AND PROPOSED RELIGIOUS FACILITY AS DEPICTED ON CONDITIONAL USE PLAN DATED 5-15-01. THERE ARE THREE
- PHASES FOR THE PROPOSED IMPROVEMENTS AS FOLLOWS: A. PHASE I-LIFE CENTER (WITHIN THREE YEARS OF 11-29-01) PHASE II-SANCTUARY EXPANSION (WITHIN FIVE YEARS OF 11-29-01) A PHASE III-CHURCH OFFICE BUILDING (WITHIN SEVEN YEARS
- OF 11-29-01) REVISION I MEETS THE PHASE II REQUIREMENT. TYPE D (SCREEN) LANDSCAPE EDGE ALONG WEST SIDE PARCEL 86.
- 15. BUILDING HEIGHT IS 29'-3" < 34' MAX. ALLOWED PER ZONING, SECTION 131.N.38(b). HEIGHT CALCULATED AS PER ZONING DEFINITION SECTION
- 16. SEE RECORDED PLAT SHOWING THE MERGER OF PARCELS 86 & 87 AND THE FOREST CONSERVATION EASEMENT, F.03.158, 4055
- 17. THERE ARE NO WETLANDS/WETLANDS BUFFERS WITHIN THE LIMIT OF DISTURBANCE SHOWN FOR DEVELOPMENT ON THIS SITE PLAN.

2/23/04	12/17/03		REVISED DWGS. PER DED COMMENTS
Pereloper's Agreement	10/7/03	\triangle	REVISED PLANS FOR PARKING LOT AND BORROW AREAS, ADDED SHEET II AND
executed on May 12, 2003		A. Sangar	RENUMBERED SHEETS II THROUGH 13.
	Date	No	Revision Description

DEPARTMENT OF PLANNING AND ZONIN

AMERICA WAS A

SHEET	INDEX	APPROVED:
SHEET NUMBER	DRAWING TITLE	
1	COVER SHEET	CHEF-DEVE
2	SITE GRADING PLAN	
3	SITE UTILITY PLAN	CHIEF-BIVIS
4	SITE DETAILS	ma
5	PIPE PROFILES	DIRECTOR APPROVED:
6	SEDIMENT & EROSION CONTROL PLAN	
7	SEDIMENT & EROSION CONTROL NOTES & DETAILS	Rem
8	SEDIMENT & EROSION CONTROL NOTES	0
9	SWM DETAILS & D.A. MAPS	PH/
10	SWM DETAILS & SPECIFICATIONS	0.5
11	PARKING LOT ADDITION PLAN AND DETAILS DRAINAGE AREA MAP	Ch
12 13	LANDSCAPE PLAN	(
14	FOREST CONSERVATION PLAN	

IASE I -FAMILY LIFE CENTER ROSSROADS CHURCH THE NAZARENE BUILDING ADDITION

FOR PUBLIC WATER AND PUBLIC SEWERAGE SYSTEMS

2750 ROGERS AVE. ELECTION DISTRICT NO. 2 HOWARD CO. MARYLAND

CENTURY ENGINEERING, INC.


CONSULTING ENGINEERS, PLANNERS, SURVEYORS


32 WEST ROAD TOWSON, MARYLAND 21204 (410) (301) 823-8070


COVER SHEET


NWOHR &A Proj No 21010.00 Drn By 🔞 Date NOVEMBER, 2002 DRAWING NO OF 14


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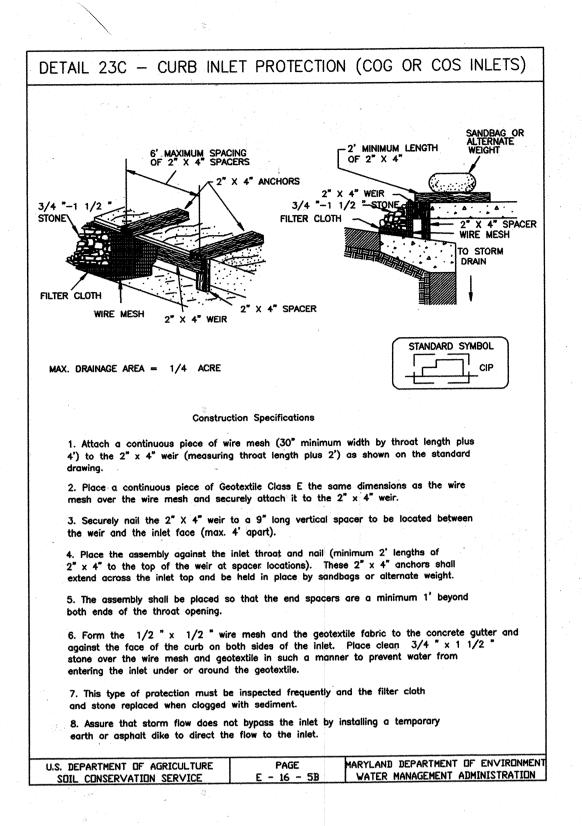


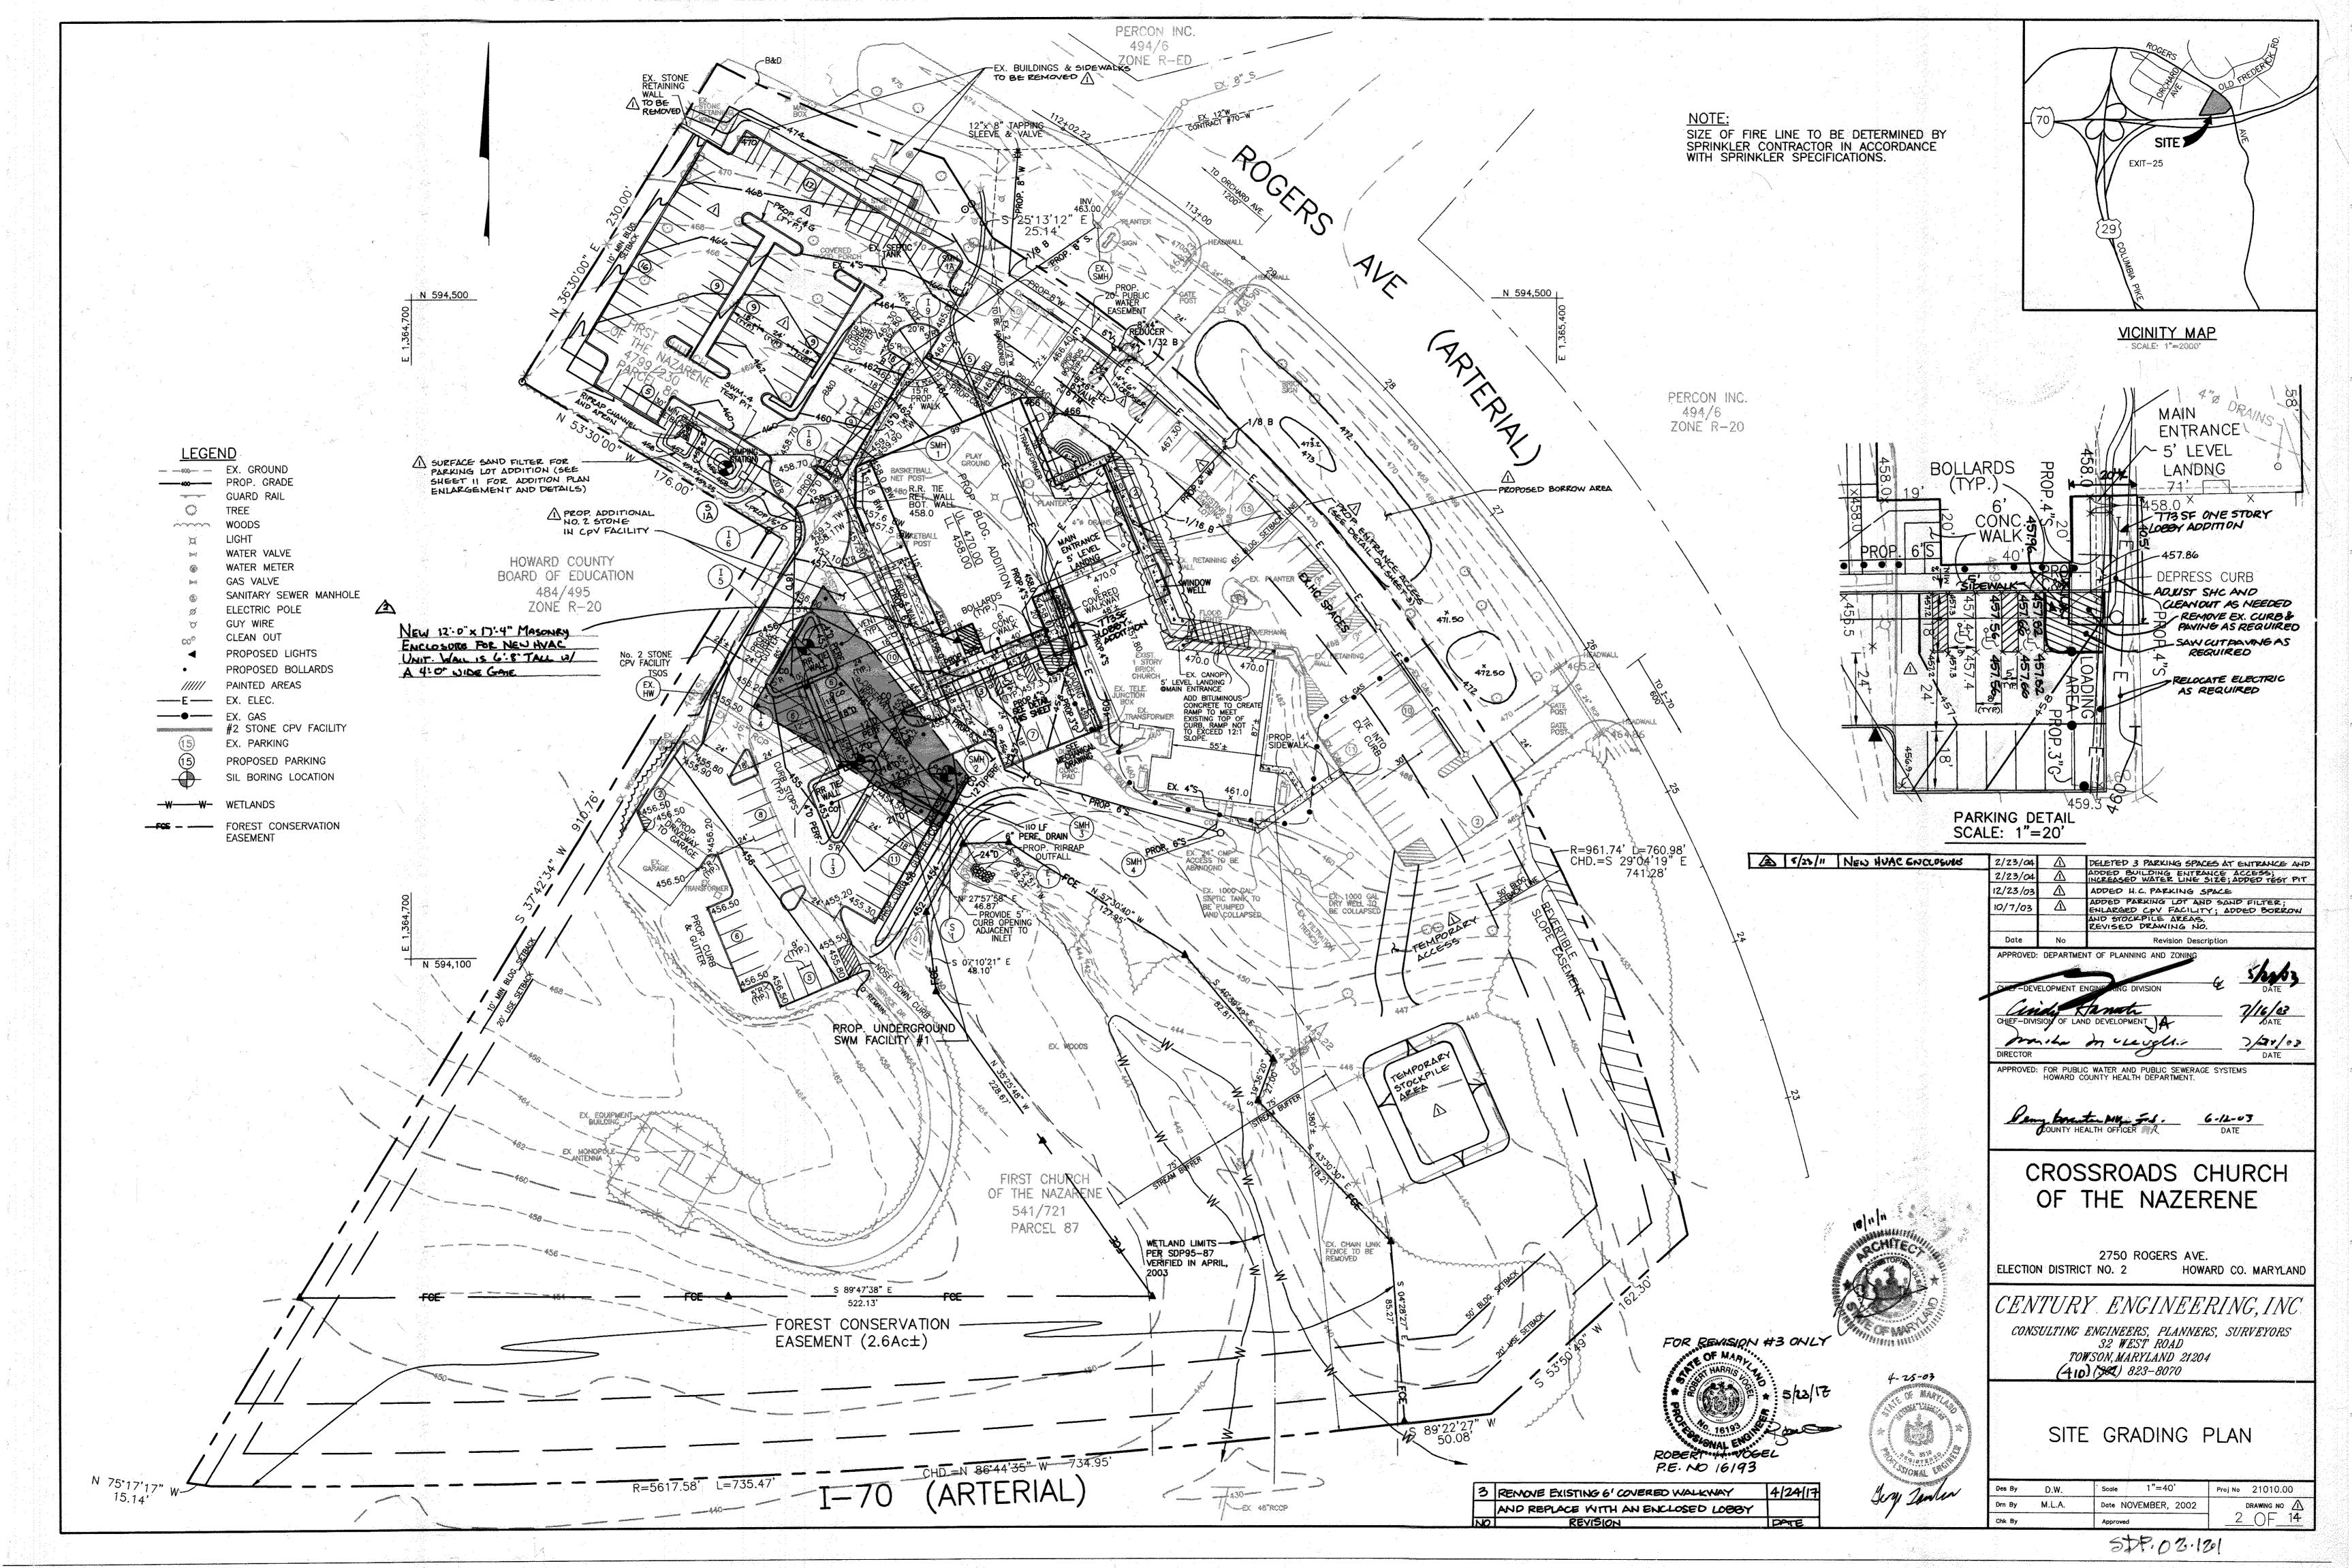


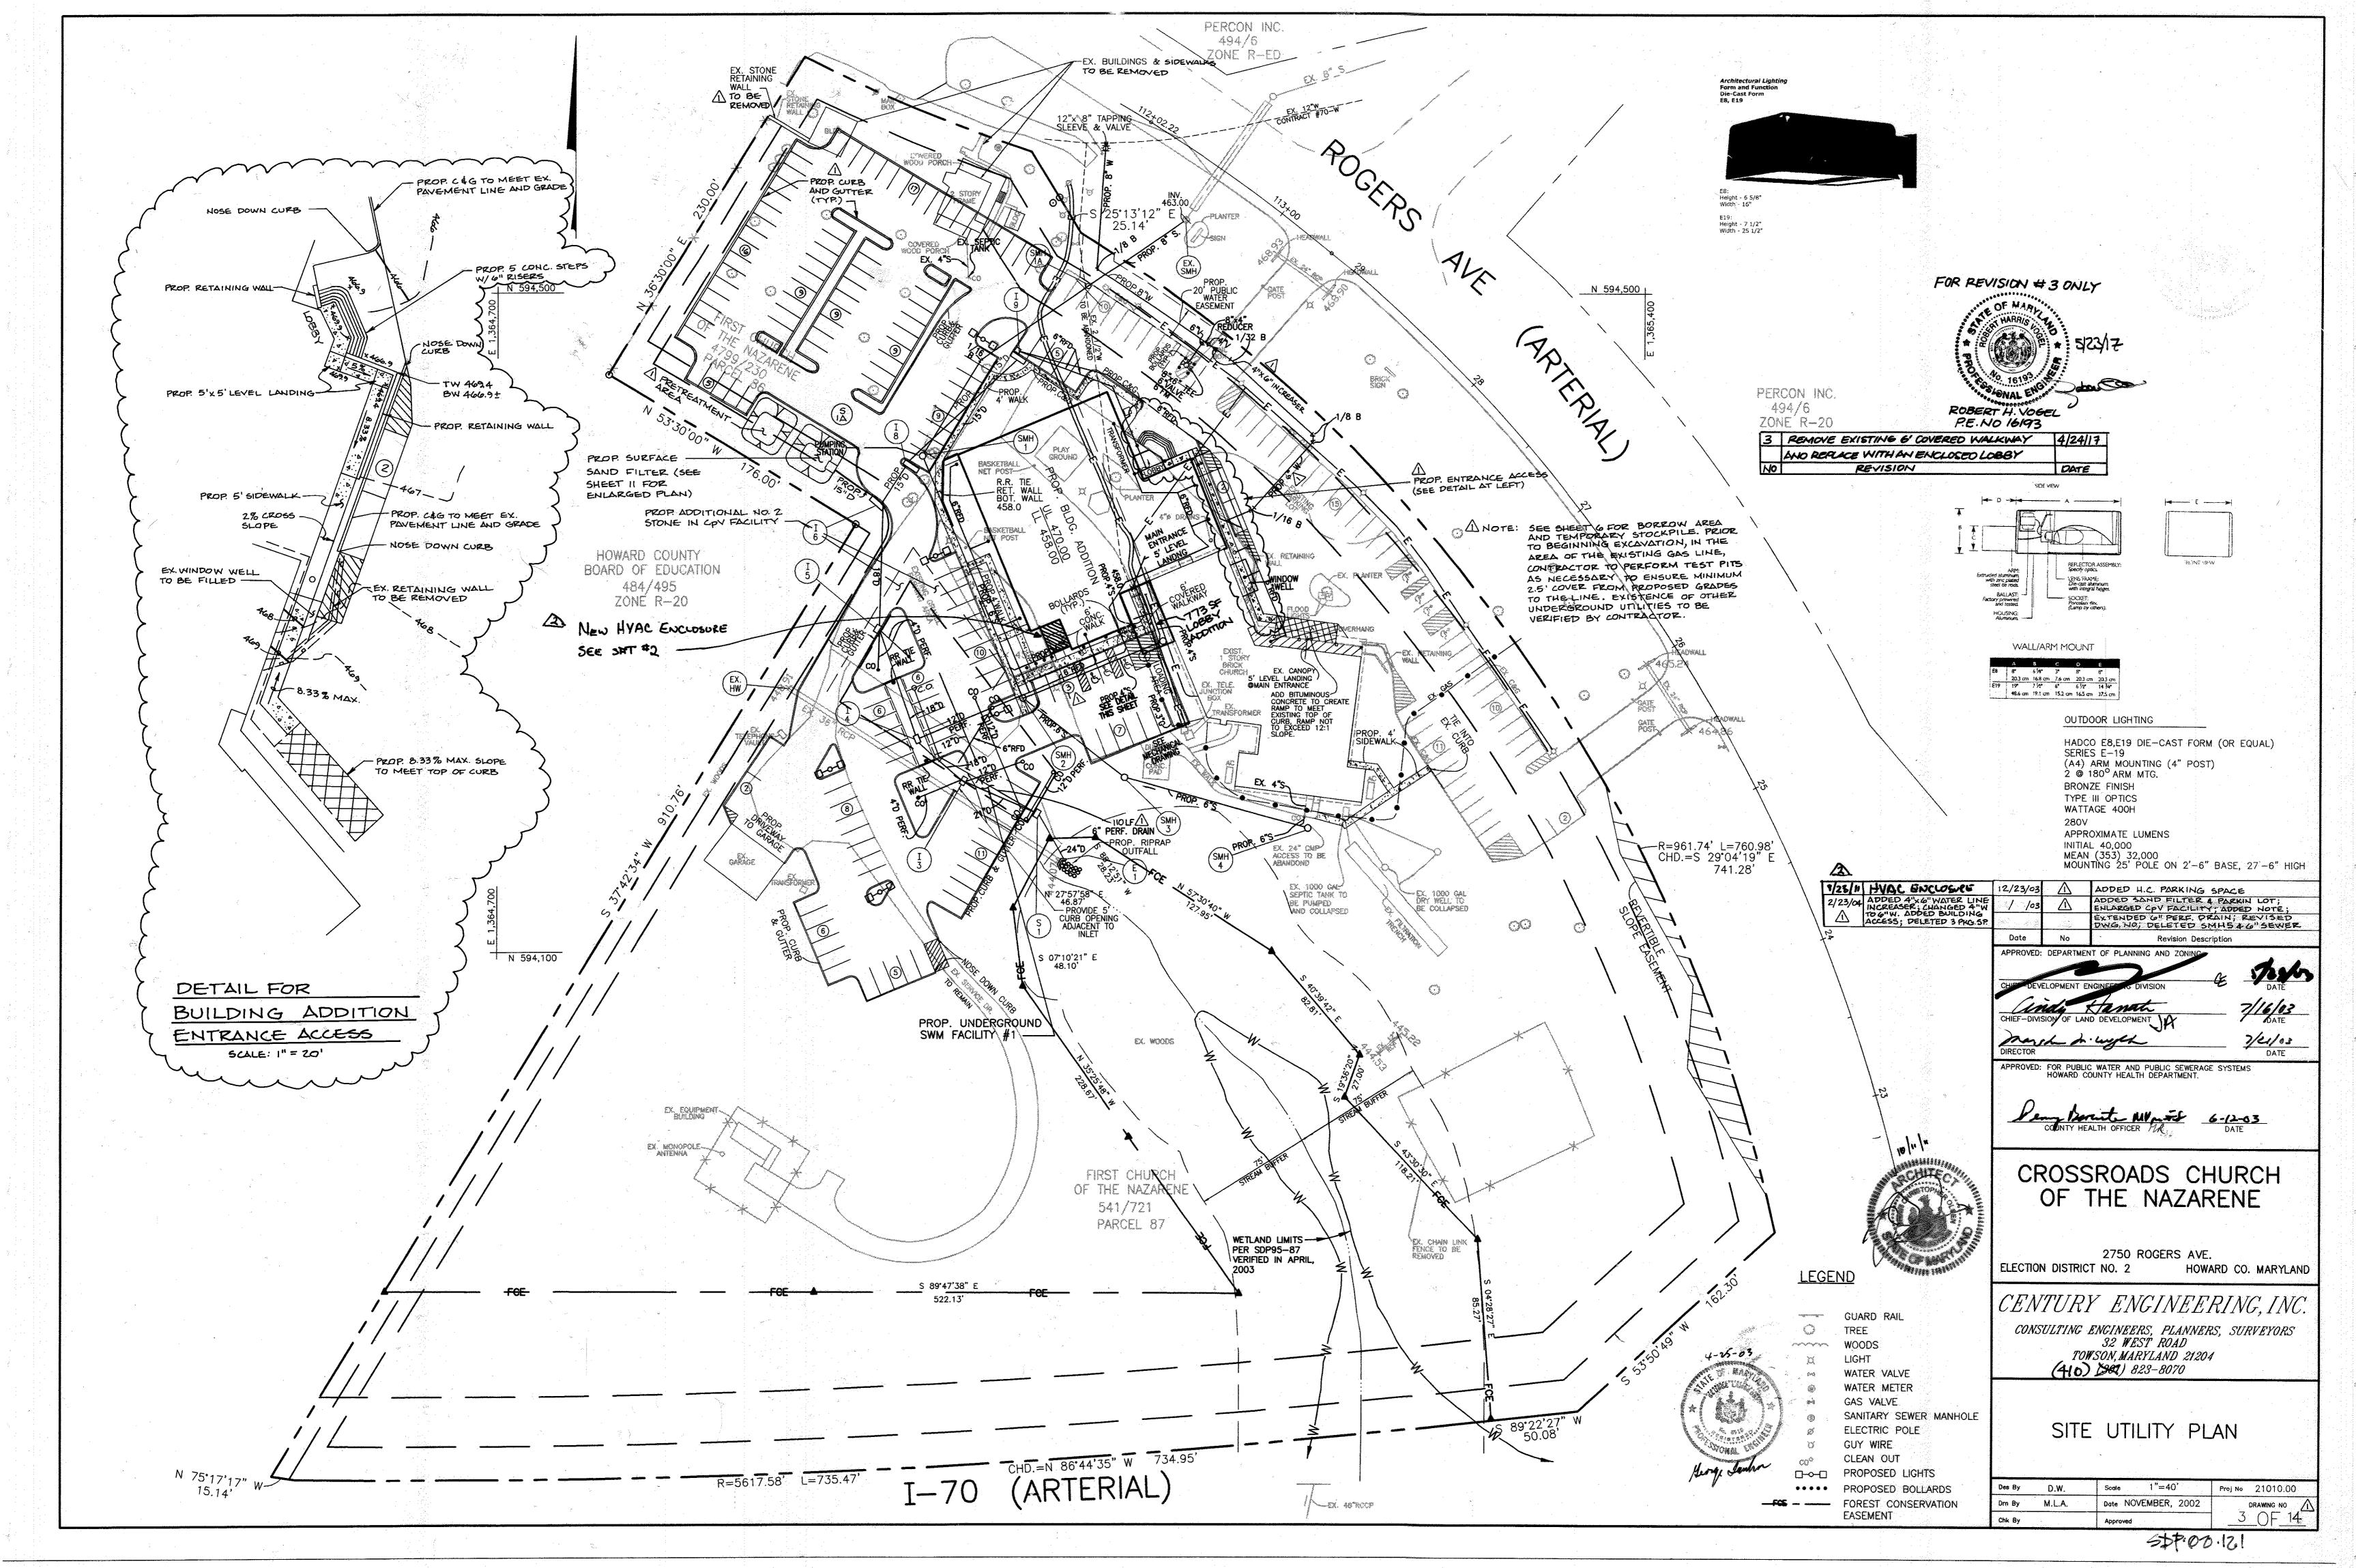

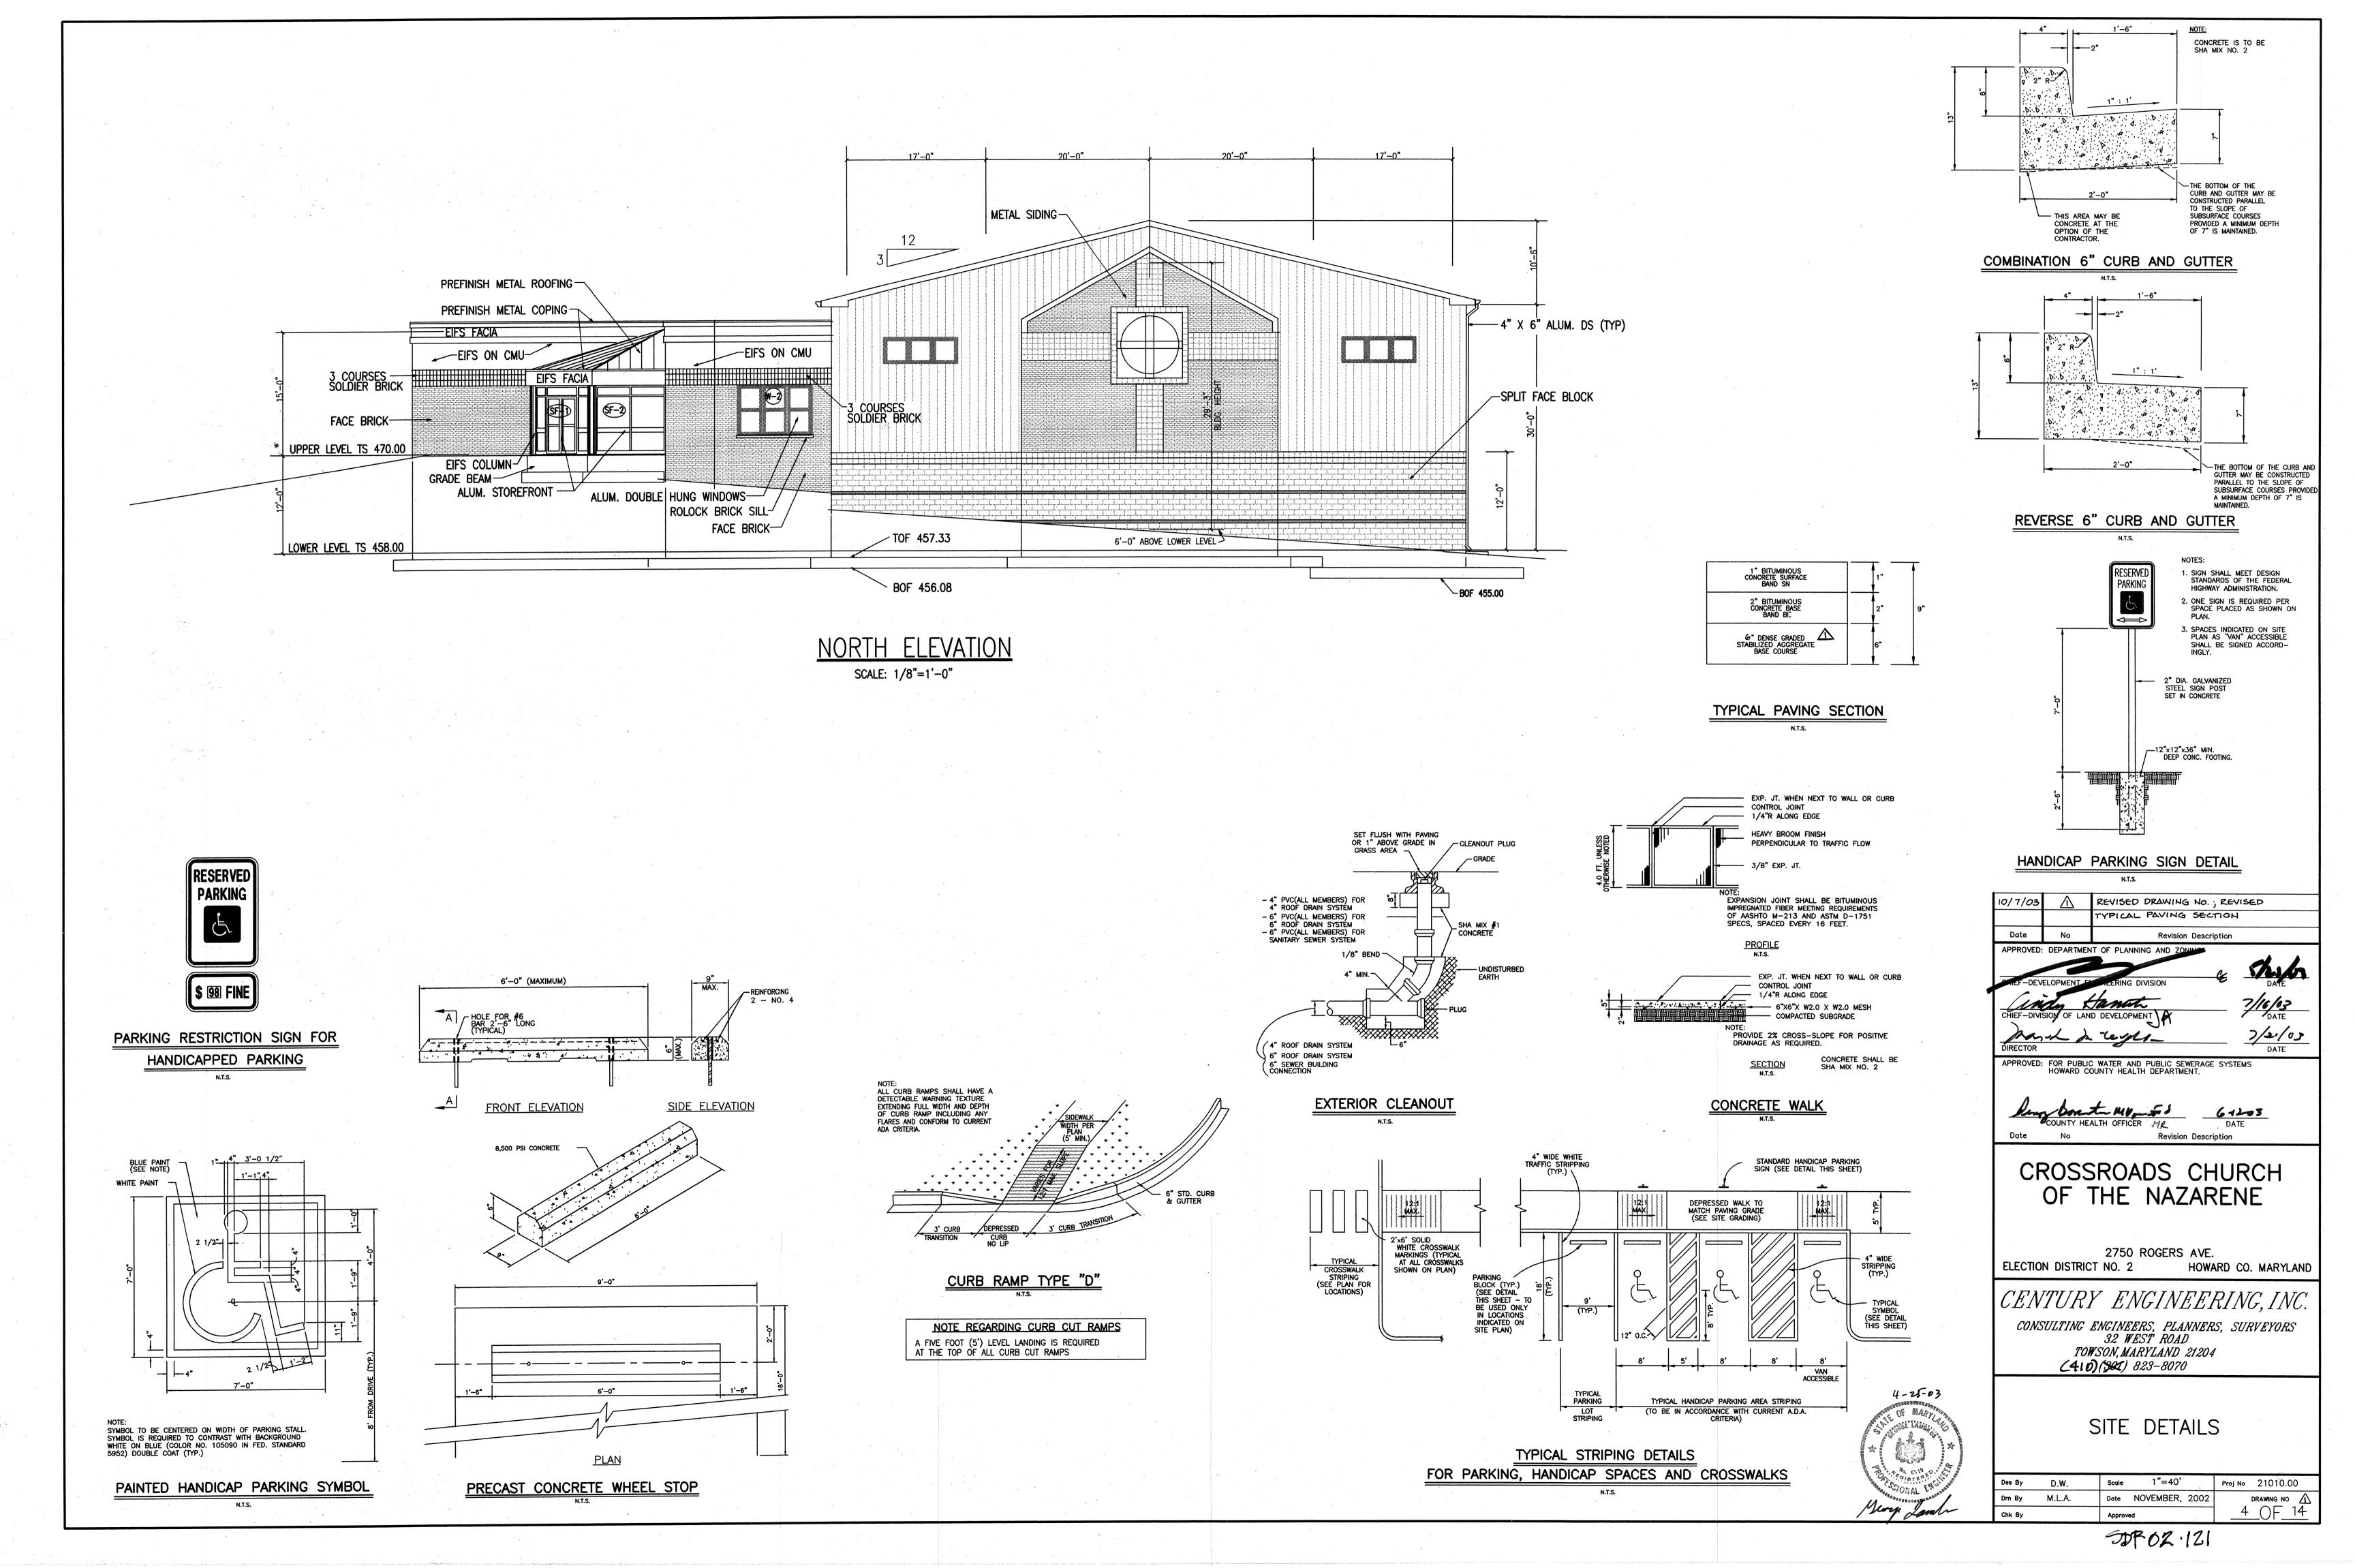


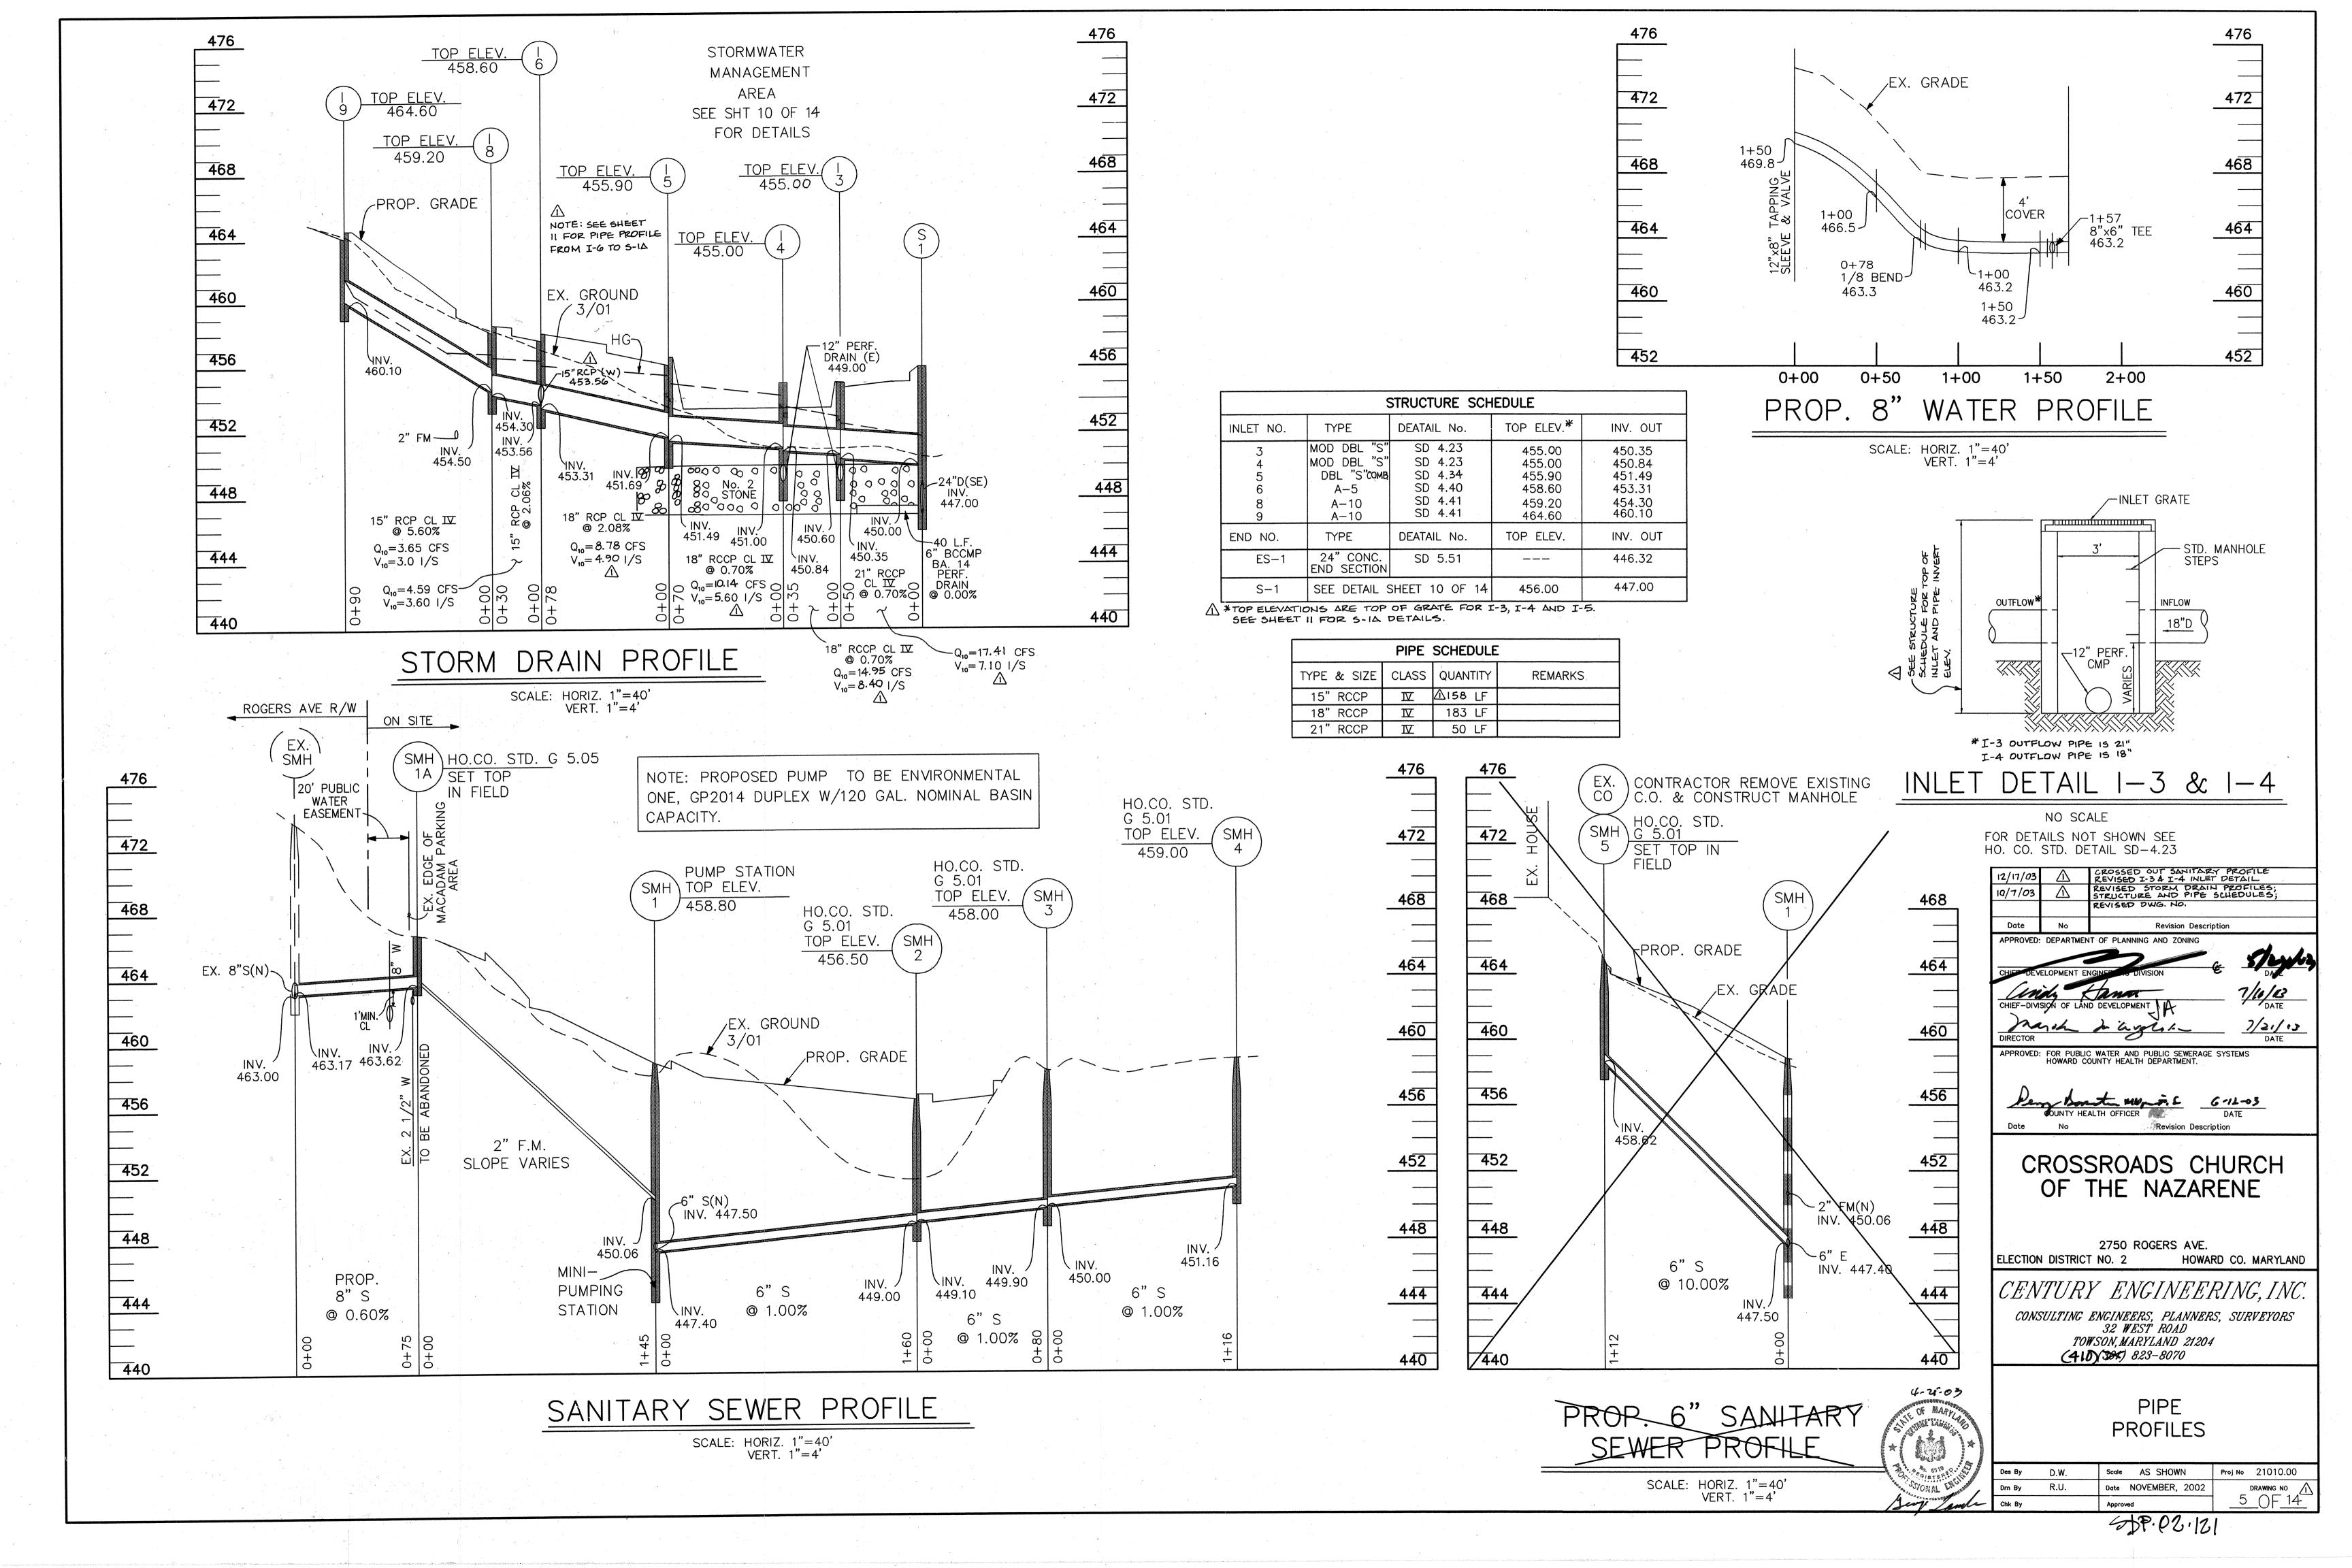


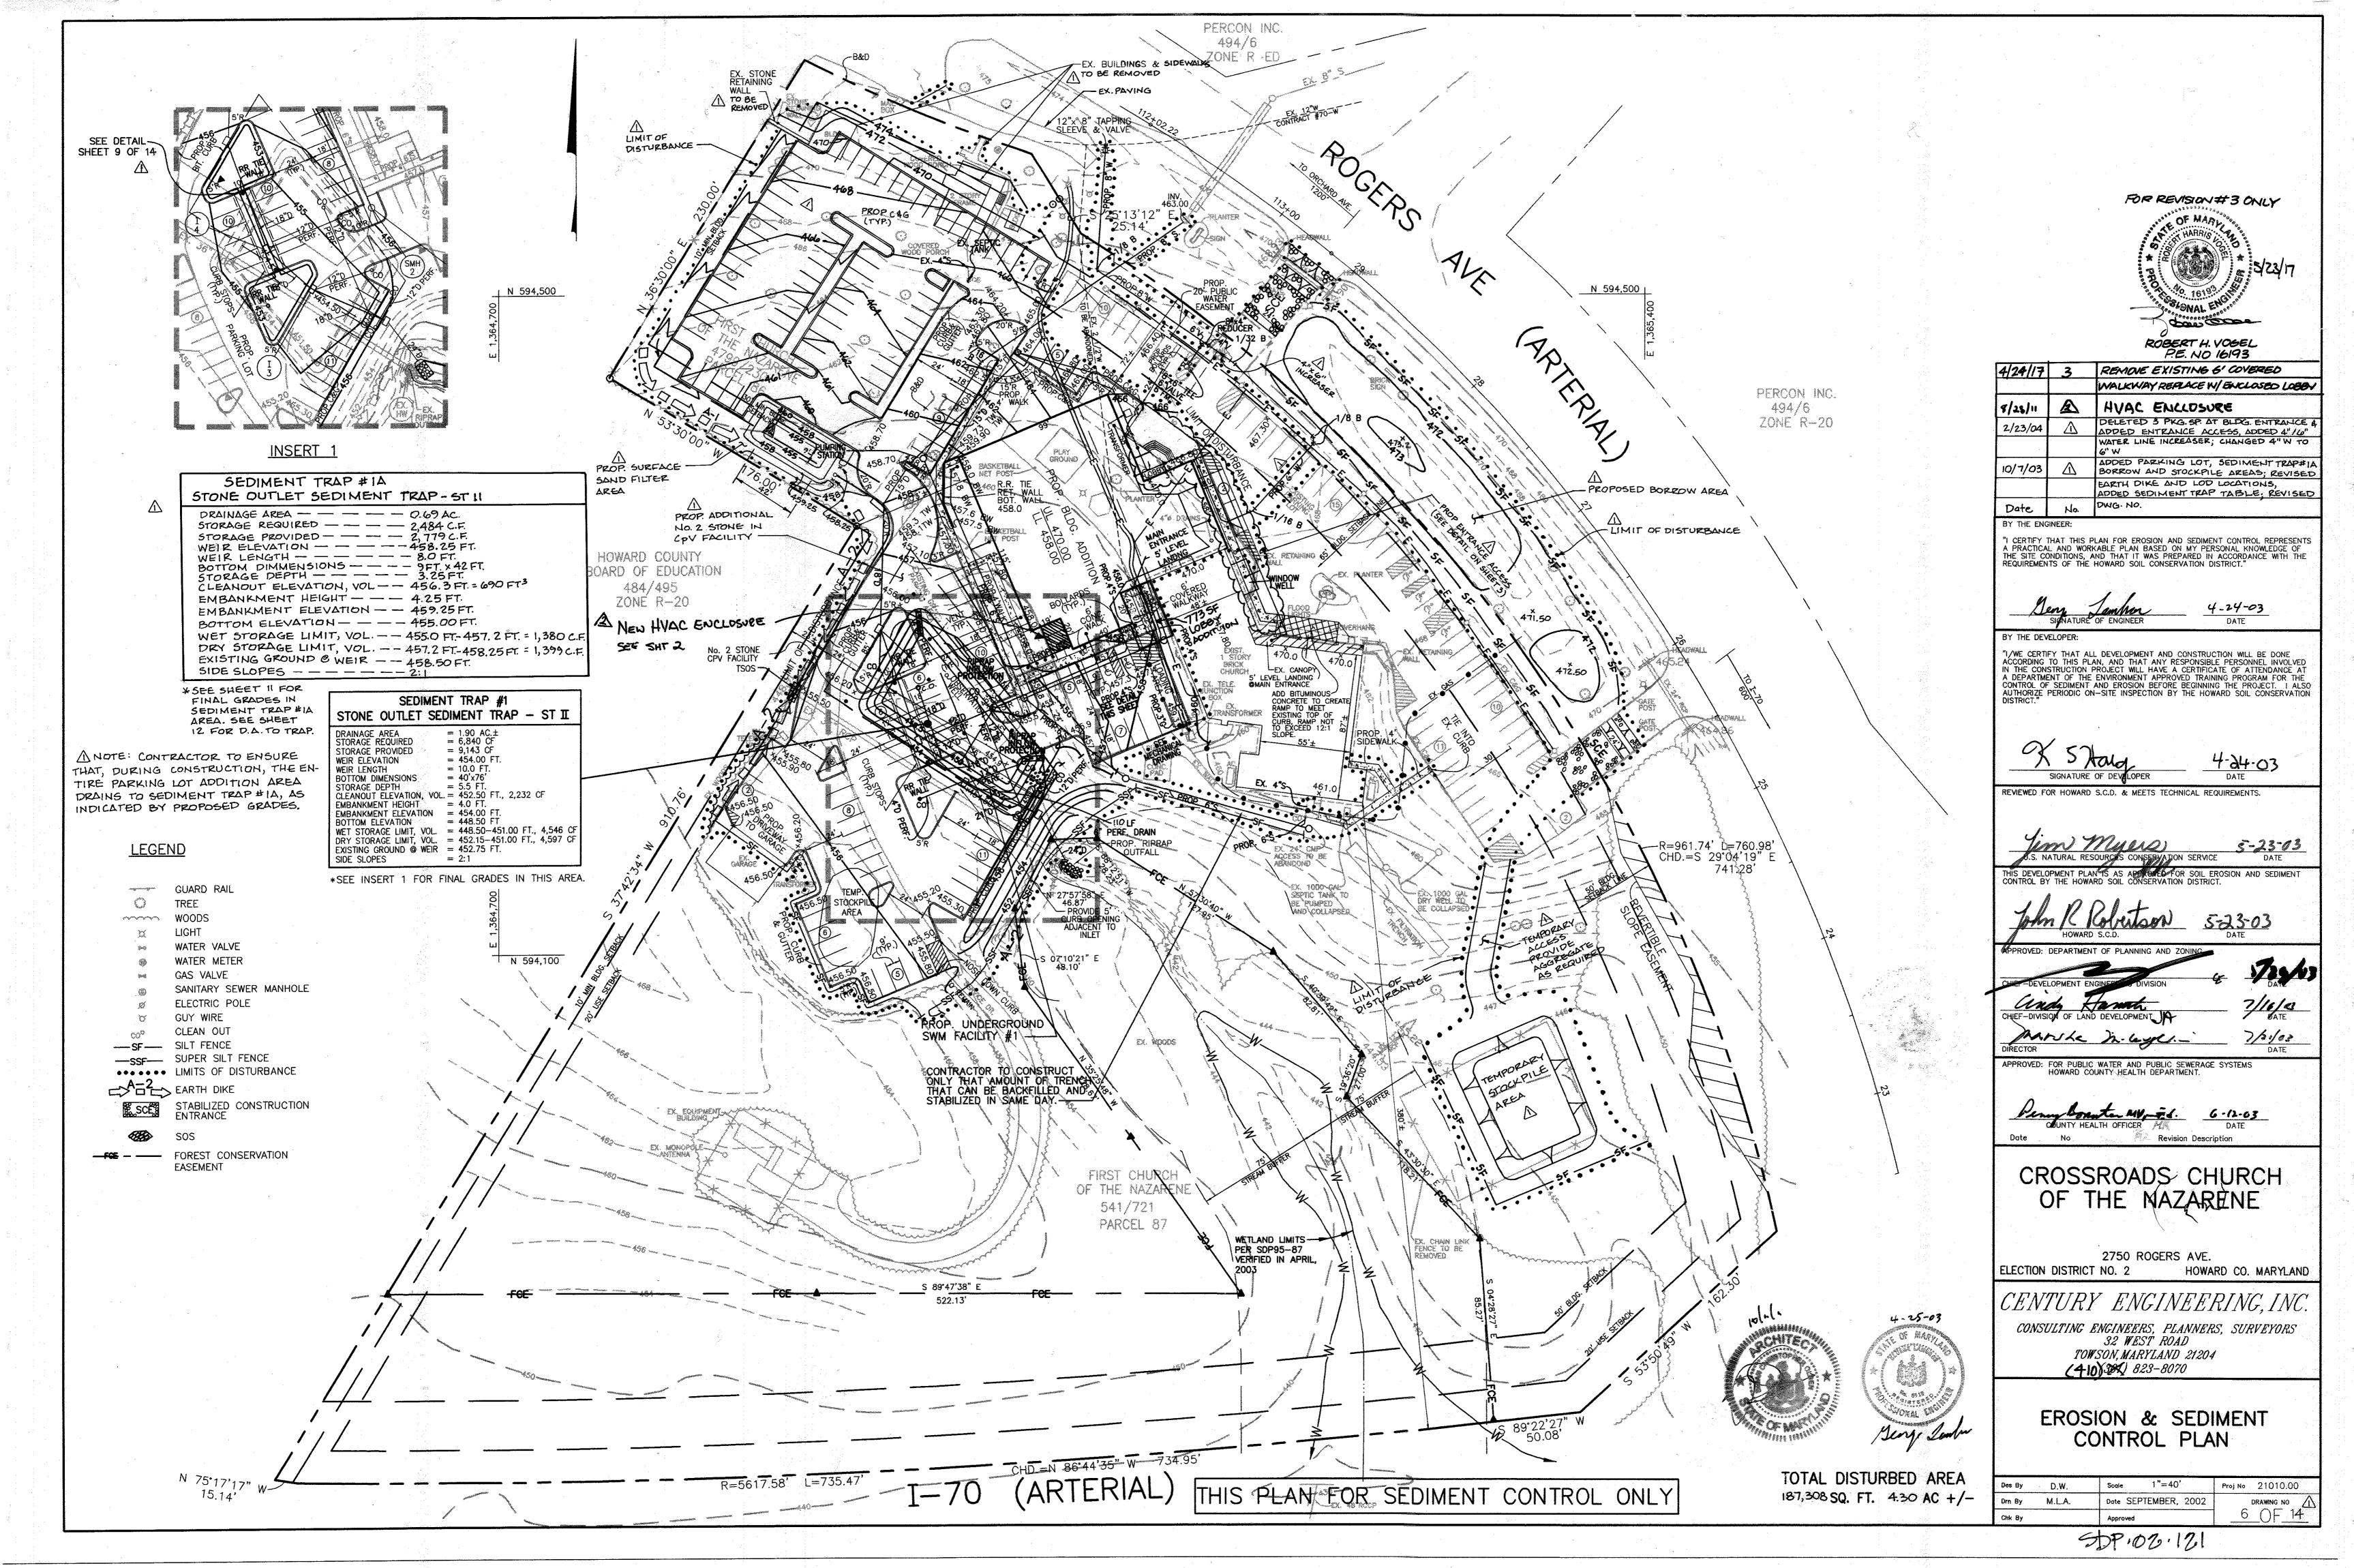

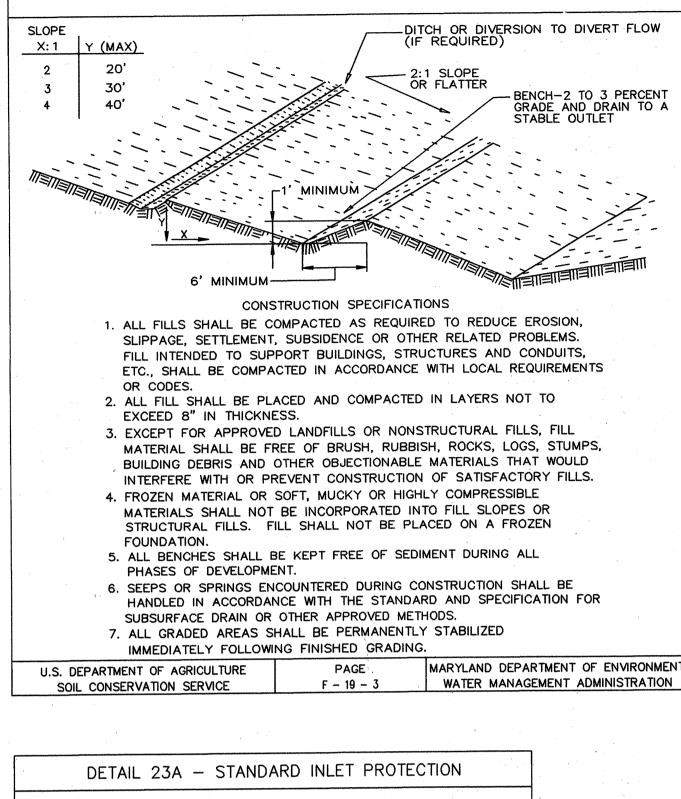

DETAIL 28 - BENCHED SLOPES

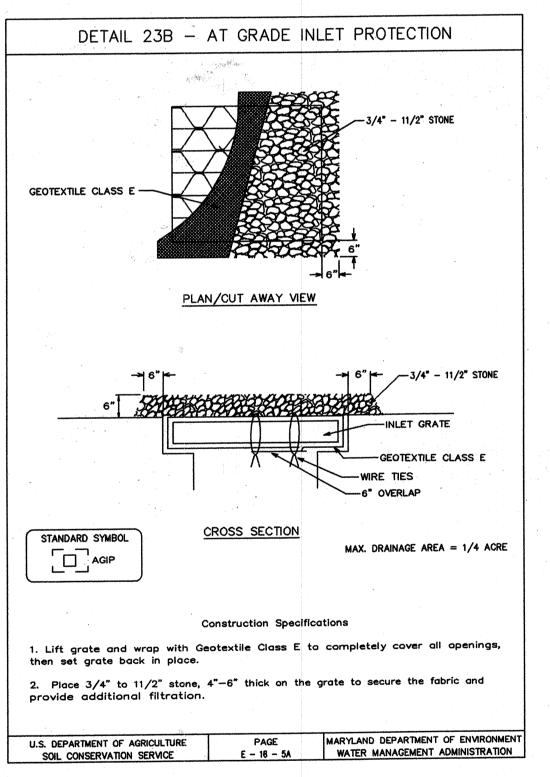

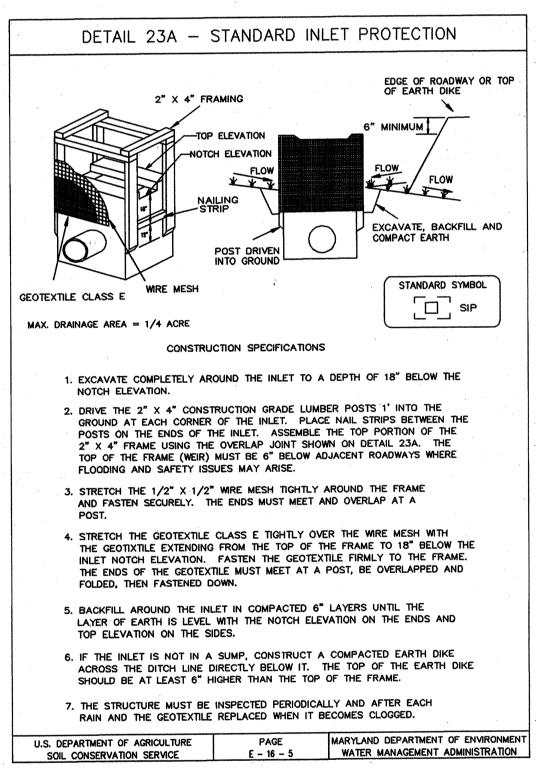

HOWARD SOIL CONSERVATION DISTRICT

STANDARD SEDIMENT CONTROL NOTES

- 1. A MINIMUM OF 48 HOURS NOTICE MUST BE GIVEN TO THE HOWARD COUNTY DEPARTMENT OF INSPECTIONS, LICENSES AND PERMITS, SEDIMENT CONTROL DIVISION PRIOR TO THE START OF ANY
- 2. ALL VEGETATIVE AND STRUCTURAL PRACTICES ARE TO BE INSTALLED ACCORDING TO THE PROVISIONS OF THIS PLAN AND ARE TO BE IN CONFORMANCE WITH THE 1994 MARYLAND STANDARDS AND SPECIFICATIONS FOR SOIL EROSION AND SEDIMENT CONTROL AND REVISIONS
- 3. FOLLOWING INITIAL SOIL DISTURBANCE OR RE-DISTURBANCE, PERMANENT OR TEMPORARY STABILIZATION SHALL BE COMPLETED WITHIN: A) 7 CALENDAR DAYS FOR ALL PERIMETER SEDIMENT CONTROL STRUCTURES, DIKES, PERIMETER SLOPES AND ALL SLOPES STEEPER THAN 3:1, B) 14 DAYS AS TO ALL
- 4. ALL SEDIMENT TRAPS/BASINS SHOWN MUST BE FENCED AND WARNING SIGNS POSTED AROUND THEIR PERIMETER IN ACCORDANCE WITH VOL. 1, CHAPTER 7 OF THE HOWARD COUNTY DESIGN
- 5. ALL DISTURBED AREAS MUST BE STABILIZED WITHIN THE TIME PERIOD SPECIFIED ABOVE IN ACCORDANCE WITH THE 1994 MARYLAND STANDARDS AND SPECIFICATIONS FOR SOIL EROSION AND SEDIMENT CONTROL FOR PERMANENT SEEDING, SOD, TEMPORARY SEEDING AND MULCHING (SEC. G). TEMPORARY STABILIZATION WITH MULCH ALONE SHALL ONLY BE DONE WHEN RECOMMENDED SEEDING DATES DO NOT ALLOW FOR PROPER GERMINATION AND
- 6. ALL SEDIMENT CONTROL STRUCTURES ARE IN PLACE AND ARE TO BE MAINTAINED IN OPERATIVE CONDITION UNTIL PERMISSION FOR THEIR REMOVAL HAS BEEN OBTAINED FROM THE HOWARD COUNTY SEDIMENT CONTROL INSPECTOR.
- 7. SITE ANALYSIS:

TOTAL AREA OF SITE AREA DISTURBED AREA TO BE ROOFED OR PAVED AREA TO BE VEGETATIVELY STABILIZED TOTAL CUT

- 8. ANY SEDIMENT CONTROL PRACTICE WHICH IS DISTURBED BY GRADING ACTIVITY FOR PLACEMENT OF UTILITIES MUST BE REPAIRED ON THE SAME DAY OF DISTURBANCE.
- 9. ADDITIONAL SEDIMENT CONTROL MUST BE PROVIDED, IF DEEMED NECESSARY, BY THE HOWARD COUNTY SEDIMENT CONTROL INSPECTOR.
- 10. ON ALL SITES WITH DISTURBED AREAS IN EXCESS OF 2 ACRES, APPROVAL OF THE INSPECTION AGENCY SHALL BE REQUESTED UPON COMPLETION OF INSTALLATION OF PERIMETER EROSION AND SEDIMENT CONTROLS, BUT BEFORE PROCEEDING WITH ANY OTHER EARTH DISTURBANCE OR GRADING. OTHER BUILDING OR GRADING INSPECTION APPROVALS MAY NOT BE AUTHORIZED UNTIL THIS INITIAL APPROVAL.
- 11. TRENCHES FOR THE CONSTRUCTION OF UTILITIES IS LIMITED TO THREE PIPE LENGTHS OR THAT WHICH SHALL BE BACKFILLED AND STABILIZED WITHIN ONE WORKING DAY, WHICHEVER IS SHORTER.

HOWARD SOIL CONSERVATION DISTRICT

PERMANENT SEEDING NOTES

APPLY TO GRADED OR CLEARED AREAS NOT SUBJECT TO IMMEDIATE FURTHER DISTURBANCE WHERE A PERMANENT LONG-LIVED VEGETATIVE COVER IS NEEDED.

SEEDBED PREPARATION: LOOSEN UPPER THREE INCHES OF SOIL BY RAKING, DISKING OR OTHER ACCEPTABLE MEANS BEFORE SEEDING, IF NOT PREVIOUSLY LOOSENED.

SOIL AMENDMENTS: IN LIEU OF SOIL TEST RECOMMENDATIONS, USE ONE OF THE FOLLOWING SCHEDULES:

- PREFERRED APPLY 2 TONS/ACRE DOLOMITIC LIMESTONE (92,000 LBS/1000 SQ. FT) AND 600 LBS/ACRE 10-10-10 FERTILIZER (14 LBS/1000 SQ. FT) BEFORE SEEDING. HARROW OR DISK INTO UPPER THREE INCHES OF SOIL. AT TIME OF SEEDING, APPLY 400 LBS/ACRE 30-0-0 UREAFORM FERTILIZER (9 LBS/1000 SQ. FT.).
- 2. ACCEPTABLE APPLY 2 TONS/ACRE DOLOMITIC LIMESTONE (92 LBS/1000 SQ. FT.) AND 1000 LBS/ACRE 10-10-10 FERTILIZER (23 LBS/1000 SQ. FT.) BEFORE SEEDING. HARROW OR DISK INTÓ UPPER THREE INCHES OF SOÌL.

seeding — for the periods march 1 — april 30 and august 1 — october 15, seed with 60 lbs/acre (1.4 LBS/1000 SQ. FT.) OF KENTUCKY 31 TALL FESCUE. FOR THE PERIOD MAY - JULY 31, SEED WITH 60 LBS. KENTUCKY 31 TALL FESCUE PER ACRE AND 2 LBS/ACRE (.05 LBS/1000 SQ. FT.) OF WEEPING LOVEGRASS. DURING THE PERIOD OF OCTOBER 16 - FEBRUARY 28, PROTECT SITE BY: OPTION 1 - TWO TONS PER ACRE OF WELL ANCHORED STRAW MULCH AND SEED AS SOON AS POSSIBLE IN THE SPRING. OPTION 2 - USE SOD. OPTION 3 - SEED WITH 60 LBS/ACRE KENTUCKY 30 TALL FESCUE AND MULCH WITH 2 TONS/ACRE WELL

MULCHING - APPLY 1 1/2 TO 2 TONS PER ACRE (70 TO 90 LBS/1000 SQ. FT.) OF UNROTTED SMALL GRAIN STRAW IMMEDIATELY AFTER SEEDING. ANCHOR MULCH IMMEDIATELY AFTER APPLICATION USING MULCH ANCHORING TOOL OR 218 GALLONS PER ANCHOR OF SEED ANCHOR SEED ASPHALT ON FLAT AREAS. ON SLOPE 8 FEET OR HIGHER, USE 348 GALLONS PER ACRE (8 GAL/1000 SQ. FT.) FOR ANCHORING.

MAINTENANCE: INSPECT ALL SEEDING AREAS AND MAKE NEEDED REPAIRS, REPLACEMENTS AND RESEEDINGS. TEMPORARY SEEDING NOTES

APPLY TO GRADED OR CLEARED AREAS LIKELY TO BE RE-DISTURBED WHERE A SHORT-TERM VEGETATIVE COVER IS

SEEDBED PREPARATION - LOOSEN UPPER THREE INCHES OF SOIL BY RAKING, DISKING OR OTHER MEANS BEFORE SEEDING, IF NOT PREVIOUSLY LOOSENED.

SOIL AMENDMENTS - APPLY 600 LBS/ACRE 10-10-10 FERTILIZER (14 LBS/1000 SQ. FT.).

SEEDING — FOR PERIOD MARCH 1 — APRIL 30 FROM AUGUST 15 — OCTOBER 15, SEED WITH 2 1/2 BUSHEL PER ACRE OF ANNUAL RYE (3.2 LBS/1000 SQ. FT.). FOR THE PERIOD MAY 1 — AUGUST 14, SEED WITH 3 LBS/ACRE OF WEEPING LOVEGRASS (.07 LBS/1000 SQ. FT.). FOR THE PERIOD NOVEMBER 16 — FEBRUARY 28, PROTECT SITE BY APPLYING 2 TONS/ACRE OF WELL ANCHORED STRAW MULCH AND SEED AS SOON AS POSSIBLE IN THE

MULCHING - APPLY 1 1/2 TONS/ACRE (70 TO 90 LBS/1000 SQ. FT.) OF UNROTTED WEED-FREE, SMALL GRAIN STRAW IMMEDIATELY AFTER SEEDING. ANCHOR MULCH IMMEDIATELY AFTER APPLICATION USING MULCH ANCHORING TOOL OR 218 GAL. PER ACRE (5 GAL/1000 SQ. FT.) OF EMULSIFIED ASPHALT ON FLAT AREAS. ON SLOPE 8 FT. OR HIGHER, USE 348 GAL. PER ACRE (8 GAL/1000 SQ. FT.) FOR ANCHORING.

REFER TO THE 1994 MARYLAND STANDARDS AND SPECIFICATIONS FOR SOIL EROSION AND SEDIMENT CONTROL FOR ADDITIONAL RATES AND METHODS NOT COVERED.


1. OBTAIN GRADING PERMIT.	
2. NOTIFY HOWARD COUNTY DEPARTMENTS OF PERMITS & LICENSES, GRADING AND SEDIMENT CONTROL INSPECTIONS © 313-1855 AT LEAST 48 HOURS PRIOR TO BEGINNING WORK.	1 DAY
3. CLEAR AND GRUB FOR SEDIMENT AND EROSION CONTROL MEASURES.	3 DAYS
4. INSTALL ALL SEDIMENT & EROSION CONTROL MEASURES OR DEVICES ONLY.*	10 DAYS
5. NOTIFY HOWARD COUNTY DEPARTMENT OF PERMITS & LICENSES, GRADING AND SEDIMENT CONTROL INSPETIONS • 414-313-1855 UPON COMPLETION OF SAID INSTALLATION.	1 DAY
6. WITH THE APPROVAL OF THE SEDIMENT CONTROL INSPECTOR, CLEAR AND GRUB REMAINDER OF THE SITE AS REQUIRED.	5 DAYS
7. ROUGH GRADE SITE AS REQUIRED.	10 DAYS
8. BEGIN BUILDING CONSTRUCTION.	90 DAYS
9. INSTALL UTILITIES AND MAINTAIN POSITIVE DRAINAGE TO SEDIMENT TRAPS AS NECESSARY.**	30 DAYS
10. INSTALL PAVING SUBBASE AND MAINTAIN POSITIVE DRAINAGE TO SEDIMENT TRAPS AS NECESSARY.	15 DAYS
11. COMPLETE BUILDING CONSTRUCTION, PAVE PARKING AREAS NORTH OF BUILDING AND	10 DAYS
PERMANENTLY STABILIZE LAWN AREAS. 12. WITH THE PERMISSION OF SEDIMENT CONTROL INSPECTOR, CLEAN AND REMOVE SEDIMENT TRAPS.	5 DAYS
13. CONVERT TRAPS TO STORMWATER MANAGEMENT FACILITIES.**	* 15 DAYS
14. COMPLETE STORM DRAIN CONSTRUCTION.	5 DAYS
COMPLETE FINAL GRADING FOR REMAINING PARKING AREA, INSTALL SUBBASE AND PAVE.	5 DAYS
16. STABILIZE ALL REMAINING AREAS.	2 DAYS
17. WITH THE PERMISSION OF THE SEDIMENT CONTROL INSPECTOR, REMOVE ALL SEDIMENT & EROSIONS CONTROLS MEASURES. STABILIZE ANY AREAS DISTURBED BY THIS PROCESS.	3 DAYS
18. INSTALL LANDSCAPE MATERIALS.	5 DAYS

TIMETABLE

SEQUENCE OF CONSTRUCTION

*NOTE: THE DIVERSION IS TO BE REMOVED/REPLACED OR RELOCATED AT THE DISCRETION OF THE SEDIMENT CONTROL INSPECTOR WITH SILT FENCE DIVERSION. **NOTE: REPLACE OR REPAIR ANY SEDIMENT CONTROL MEASURE DISTURBED BY UTILITY INSTALLATION . STORMDRAINS THAT ARE SHOWN IN THE SEDIMENT TRAP TO BE INSTALLED AFTER THE SEDIMENT CONTROL INSPECTOR HAS


AUTHORIZED REMOVAL OF THE TRAP (SEE 12 & 14). 1 *** NOTE: IT IS THE CONTRACTOR'S RESPONSIBILITY TO ENSURE THAT PRIOR TO PLACING STONE IN THE CPV FACILITY, OR MATERIAL IN SAND FILTER AREAS, THAT UPSTREAM DRAINAGE AREAS ARE STABILIZED, AND MATERIAL IS PLACED IN A MANNER THAT PREVENTS CONTAMINATION. CONTAMINATED MATERIAL SHALL BE REPLACED AT THE CONTRACTOR'S EXPENSE.

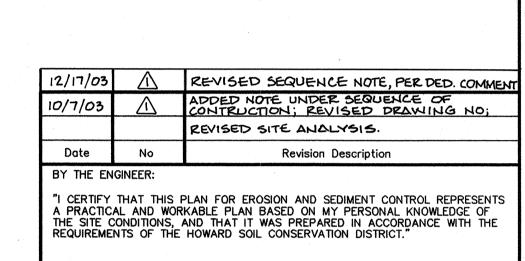

BY THE DEVELOPER:

"I/WE CERTIFY THAT ALL DEVELOPMENT AND CONSTRUCTION WILL BE DONE ACCORDING TO THIS PLAN, AND THAT ANY RESPONSIBLE PERSONNEL INVOLVED IN THE CONSTRUCTION PROJECT WILL HAVE A CERTIFICATE OF ATTENDANCE AT A DEPARTMENT OF THE ENVIRONMENT APPROVED TRAINING PROGRAM FOR THE CONTROL OF SEDIMENT AND EROSION BEFORE BEGINNING THE PROJECT. I ALSO AUTHORIZE PERIODIC ON-SITE INSPECTION BY THE HOWARD SOIL CONSERVATION

REVIEWED FOR HOWARD S.C.D. & MEETS TECHNICAL REQUIREMENTS.

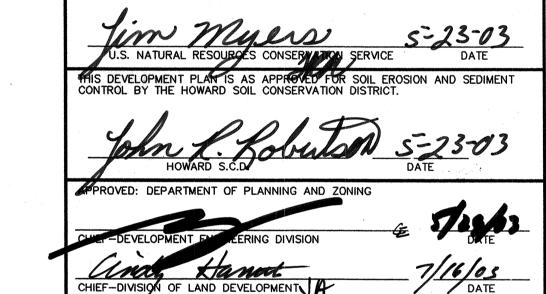

APPROVED: FOR PUBLIC WATER AND PUBLIC SEWERAGE SYSTEMS

1/21/03

Revision Description

CROSSROADS CHURCH OF THE NAZARENE

2750 ROGERS AVE.

ELECTION DISTRICT NO. 2 HOWARD CO. MARYLAND

CENTURY ENGINEERING, INC.

CONSULTING ENGINEERS, PLANNERS, SURVEYORS 32 WEST ROAD TOWSON, MARYLAND 21204 (410) (361) 823-8070

> SEDIMENT & **EROSION CONTROL** NOTES AND DETAILS

AS SHOWN Proj No 21010.00 Des By D.W. Date NOVEMBER, 2002 Dm By R.U. DRAWING NO 7 OF 14


INLET PROTECTION NOTE:

THE CONTRACTOR IS REQUIRED TO INSTALL INLET PROTECTION ON ALL STORM DRAIN INLETS WITH THE EXCEPTION OF THE FOLLOWING:

- 1. ANY INLET OUTFALLING DIRECTLY INTO A SEDIMENT TRAPPING DEVICE.
- 2. INLETS ON PRIVATE OR PUBLIC PAVED ROADWAYS OPEN TO THE PUBLIC.
- ALL INLET PROTECTION WILL BE INSTALLED AS DIRECTED BY THE INSPECTOR IN ACCORDANCE WITH THE 1994 MARYLAND STANDARDS AND SPECIFICATIONS FOR SOIL EROSION AND SEDIMENT CONTROL, PAGE E-16-1 (OR AS MAY BE AMENDED). THE REMOVAL OF ANY INLET PROTECTION DEVICES WILL REQUIRE APPROVAL FROM THE INSPECTOR.
- *STORM DRAINS TO BE FLUSHED PRIOR TO TRAPPING DEVICE REMOVAL

UTILITY NOTE:

- A) CONTRACTOR SHOULD OPEN ONLY THAT SECTION OF TRENCH THAT CAN BE BACKFILLED AND STABILIZED EACH DAY. IF TRENCH MUST REMAIN OPEN LONGER THAN ONE DAY, SILT FENCE SHALL BE PLACED BELOW (DOWNSLOPE) THE TRENCH.
- B) PLACE ALL EXCAVATED MATERIAL ON UPHILL SIDE OF TRENCH.
- C) ANY SEDIMENT CONTROLS DISTURBED BY UTILITY CONSTRUCTION ARE TO BE REPAIRED IMMEDIATELY.

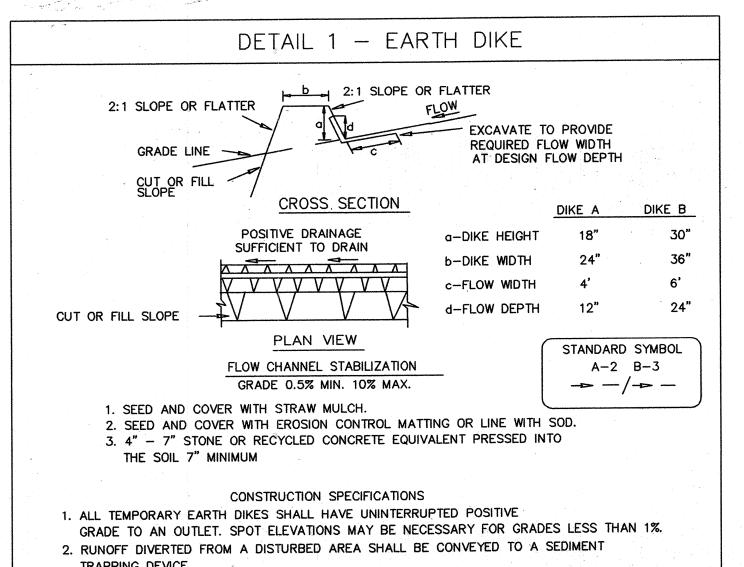

3. RUNOFF DIVERTED FROM AN UNDISTURBED AREA SHALL OUTLET DIRECTLY INTO AN UNDISTURBED, STABILIZED AREA AT A NON-EROSIVE VELOCITY.

4. ALL TREES, BRUSH, STUMPS, OBSTRUCTIONS, AND OTHER OBJECTIONAL MATERIAL SHALL BE REMOVED AND DISPOSED OF SO AS NOT TO INTERFERE WITH THE PROPER FUNCTIONING OF THE DIKE.


5. THE DIKE SHALL BE EXCAVATED OR SHAPED TO LINE, GRADE AND CROSS SECTION AS REQUIRED TO MEET THE CRITERIA SPECIFIED HEREIN AND BE FREE OF BANK PROJECTIONS OR OTHER IRREGULARITIES WHICH WILL IMPEDE NORMAL FLOW.

6. FILL SHALL BE COMPACTED BY EARTH MOVING EQUIPMENT.

7. ALL EARTH REMOVED AND NOT NEEDED FOR CONSTRUCTION SHALL BE PLACED SO THAT IT WILL NOT INTERFERE WITH THE FUNCTIONING OF THE DIKE.

8. INSPECTION AND MAINTENANCE MUST BE PROVIDED PERIODICALLY AND AFTER EACH RAIN EVENT.

MARYLAND DEPARTMENT OF ENVIRONMENT U.S. DEPARTMENT OF AGRICULTURE WATER MANAGEMENT ADMINISTRATION SOIL CONSERVATION SERVICE A - 1 - 6

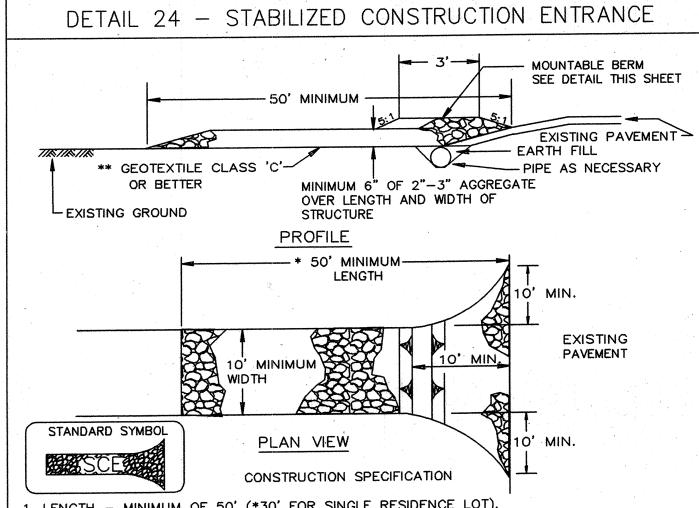

. LENGTH - MINIMUM OF 50' (*30' FOR SINGLE RESIDENCE LOT).

2. WIDTH - 10' MINIMUM, SHOULD BE FLARED AT THE EXISTING ROAD TO PROVIDE A TURNING

3. GEOTEXTILE FABRIC (FILTER CLOTH) SHALL BE PLACED OVER THE EXISTING GROUND PRIOR TO PLACING STONE. **THE PLAN APPROVAL AUTHORITY MAY NOT REQUIRE SINGLE FAMILY RESIDENCES TO USE GEOTEXTILE.

4. STONE - CRUSHED AGGREGATE (2" TO 3") OR RECLAIMED OR RECYCLED CONCRETE EQUIVALENT SHALL BE PLACED AT LEAST 6" DEEP OVER THE LENGTH AND WIDTH OF THE ENTRANCE.


5. SURFACE WATER - ALL SURFACE WATER FLOWING TO OR DIVERTED TOWARD CONSTRUCTION ENTRANCES SHALL BE PIPED THROUGH THE ENTRANCE, MAINTAINING POSITIVE DRAINAGE. PIPE INSTALLED THROUGH THE STABILIZED CONSTRUCTION ENTRANCE SHALL BE PROTECTED WITH A MOUNTABLE BERM WITH 5:1 SLOPES AND A MINIMUM OF 6" OF STONE OVER THE PIPE. PIPE HAS TO BE SIZED ACCORDING TO THE DRAINAGE. WHEN THE SCE IS LOCATED AT A HIGH SPOT AND HAS NO DRAINAGE TO CONVEY A PIPE WILL NOT BE NECESSARY. PIPE SHOULD BE SIZED ACCORDING TO THE AMOUNT OF RUNOFF TO BE CONVEYED. A 6" MINIMUM WILL BE REQUIRED.


6. LOCATION - A STABILIZED CONSTRUCTION ENTRANCE SHALL BE LOCATED AT EVERY POINT WHERE CONSTRUCTION TRAFFIC ENTERS OR LEAVES A CONSTRUCTION SITE. VEHICLES LEAVING THE SITE MUST TRAVEL OVER THE ENTIRE LENGTH OF THE STABILIZED CONSTRUCTION ENTRANCE.


U.S. DEPARTMENT OF AGRICULTURE SOIL CONSERVATION SERVICE

F - 17 - 3


MARYLAND DEPARTMENT OF ENVIRONMENT WATER MANAGEMENT ADMINISTRATION

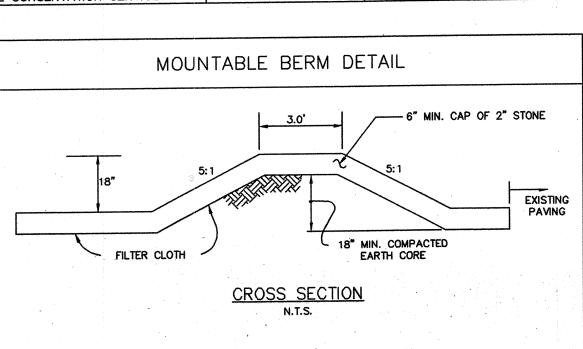

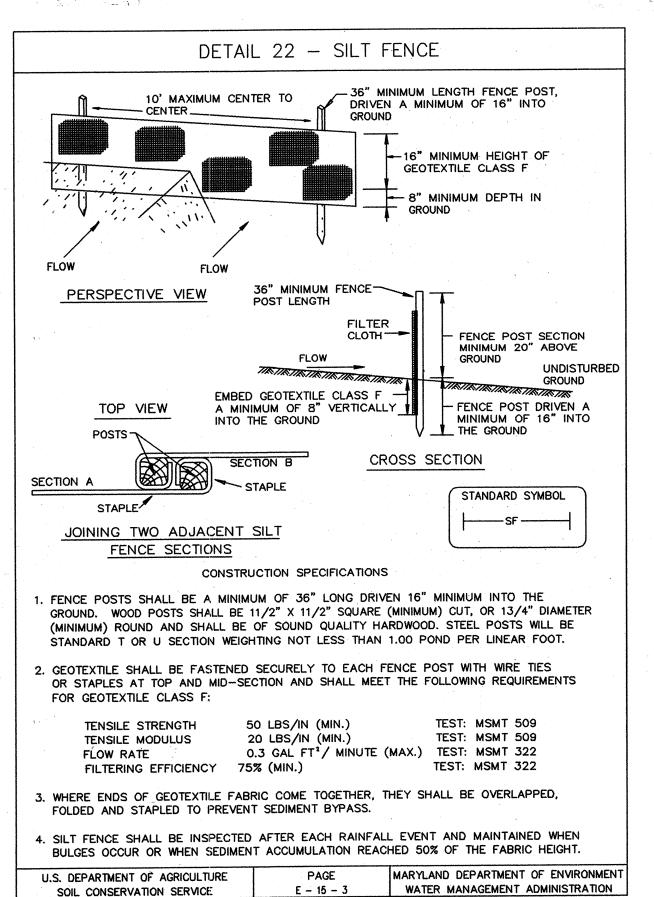

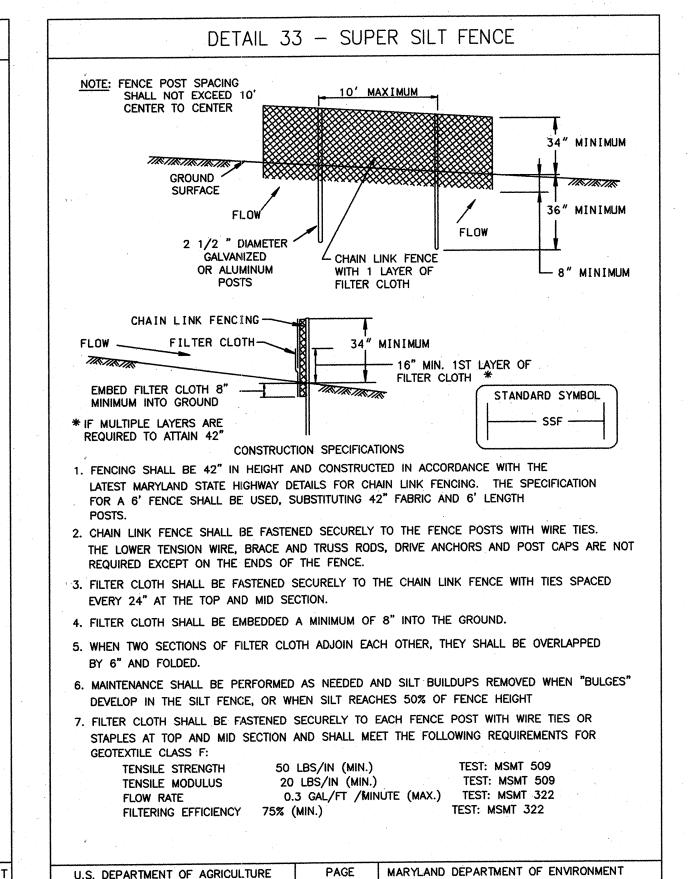

H - 26 - 3 WATER MANAGEMENT ADMINISTRATION

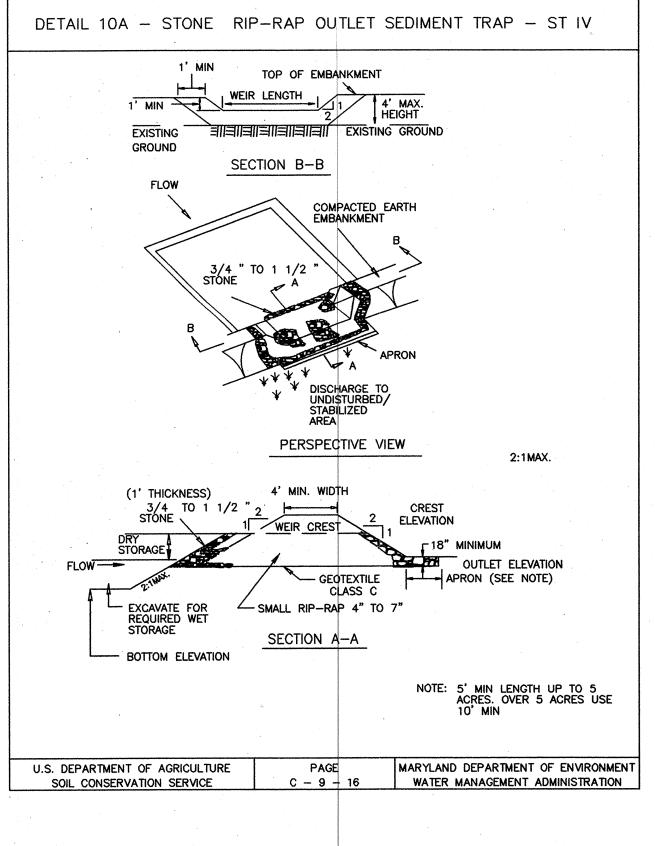



CONSTUCTION SPECIFICATIONS

1. THE AREA UNDER EMBANKMENT SHALL BE CLEARED, GRUBBED AND STRIPPED OF ANY VEGETATION AND ROOT MAT. THE POOL AREA \$HALL BE CLEARED.

2. THE FILL MATERIAL FOR THE EMBANKMENT SHALL BE FREE OF ROOTS OR OTHER WOODY VEGETATION AS WELL AS OVER-SIZED STONES, ROCKS, ORGANIC MATERIAL OR OTHER OBJECTIONABLE MATERIAL. THE EMBANKMENT SHALL BE COMPACTED BY TRAVERSING WITH FOUIPMENT WHILE IT IS BEING CONSTRUCTED. MAXIMUM HEIGHT OF EMBANKMENT SHALL BE 4'. MEASURED AT CENTERLINE OF EMBANKMENT.

3. ALL CUT AND FILL SLOPES SHALL BE 2:1 OR FLATTER.

EXCEED THE HEIGHT OF TRAP EMBANKMENT.

4. ELEVATION OF THE TOP OF ANY DIKE DIRECTING WATER INTO TRAP MUST EQUAL OR

5. STORAGE AREA PROVIDED SHALL BE FIGURED BY COMPUTING THE VOLUME MEASURED FROM TOP OF EXCAVATION. (FOR STORAGE REQUIREMENTS SEE TABLE 9).

6. GEOTEXTILE CLASS C SHALL BE PLACED OVER THE BOTTOM AND SIDES OF THE OUTLET CHANNELPRIOR TO PLACEMENT OF STONE. SECTION OF FABRIC MUST OVERLAP AT LEAST 1' WITH SECTION NEAREST THE ENTRANCE PLACED ON TOP. FABRIC SHALL BE EMBEDDED AT LEAST 6" INTO EXISTING GROUND AT ENTRANCE OF OUTLET CHANNEL.

7. 4" - 7" STONE SHALL BE USED TO CONSTRUCT THE WEIR AND 4" - 12" OR CLASS I RIP-RAP SHALL BE USED TO CONSTRUCT THE DUTLET CHANNEL.

8. OUTLET - AN OUTLET SHALL INCLUDE A MEANS OF CONVEYING THE DISCHARGE IN AN EROSION FREE MANNER TO AN EXISTING STABLE CHANNEL. PROTECTION AGAINST SCOUR AT

THE DISCHARGE POINT SHALL BE PROVIDED AS NECESSARY. 9. OUTLET CHANNEL MUST HAVE POSITIVE DRAINAGE FROM THE TRAP.


10. SEDIMENT SHALL BE REMOVED AND TRAP RESTORED TO ITS ORIGINAL DIMENSIONS WHEN THE SEDIMENT HAS ACCUMULATED TO 1/2 OF THE WET STORAGE DEPTH OF THE TRAP (900 CF/AC). REMOVED SEDIMENT SHALL BE DEPOSITED IN A SUITABLE AREA AND IN SUCH A MANNER THAT IT WILL NOT ERODE.

11. THE STRUCTURE SHALL BE INSPECTED PERIODICALLY AFTER EACH RAIN AND REPAIRED

AS NEEDED. 12. CONSTRUCTION OF TRAPS SHALL BE CARRIED OUT IN SUCH A MANNER THAT SEDIMENT POLLUTION IS ABATED. ONCE CONSTRUCTED, THE TOP AND OUTSIDE FACE OF THE EMBANKMENT SHALL BE STABILIZED WITH SEED AND MULCH. POINTS OF CONCENTRATED INFLOW SHALL BE PROTECTED IN ACCORDANCE WITH GRADE STABILIZATION STRUCTURE CRITERIA. THE REMAINDER OF THE INTERIOR SLOPES SHOULD BE STABILIZED (ONE TIME) WITH SEED AND MULCH UPON TRAP COMPLETION AND MONITORED AND MAINTAINED EROSION FREE DURING THE LIFE OF THE TRAP.

13. THE STRUCTURE SHALL BE DEWATERED BY APPROVED METHODS, REMOVED AND THE AREA STABILIZED WHEN THE DRAINAGE AREA HAS BEEN PROPERLY STABILIZED.

MARYLAND DEPARTMENT OF ENVIRONMENT U.S. DEPARTMENT OF AGRICULTURE WATER MANAGEMENT ADMINISTRATION SOIL CONSERVATION SERVICE C - 9 - 16A

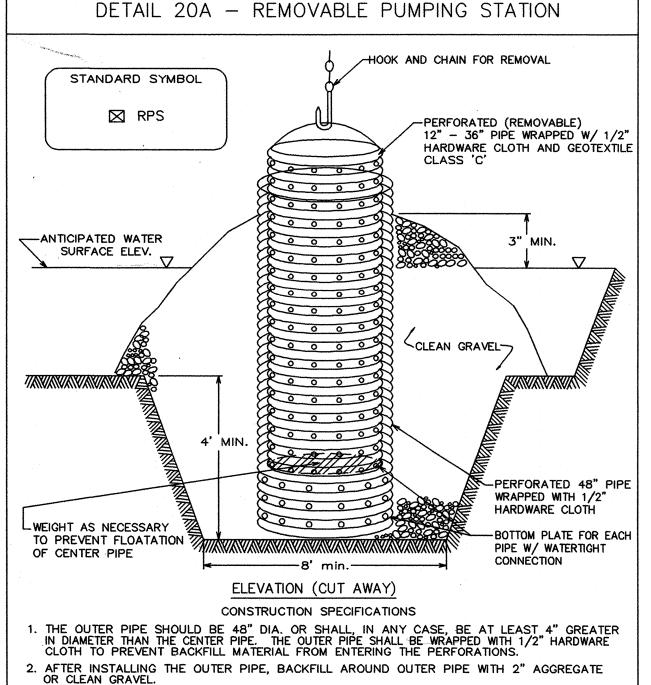

THE INSIDE STAND PIPE (CENTER PIPE) SHOULD BE CONSTRUCTED BY PERFORATING A CORRUGATED OR PVC PIPE BETWEEN 12" AND 36" IN DIAMETER. THE PERFORATIONS SHALL BE 1/2" X 6" SLITS OR 1" DIAMETER HOLES 6" ON CENTER. THE CENTER PIPE SHALL BE WRAPPED WITH 1/2" HARDWARE CLOTH FIRST, THEN WRAPPED AGAIN WITH GEOTEXTILE CLASS C.

THE CENTER PIPE SHOULD EXTEND 12" TO 18" ABOVE THE ANTICIPATED WATER SURFACE ELEVATION OR RISER CREST ELEVATION WHEN DEWATERING A BASIN.


MARYLAND DEPARTMENT OF ENVIRONMENT

CROSS SECTION

4-16-03

SOIL CONSERVATION SERVICE WATER MANAGEMENT ADMINISTRATION D - 12 - 4

U.S. DEPARTMENT OF AGRICULTURE

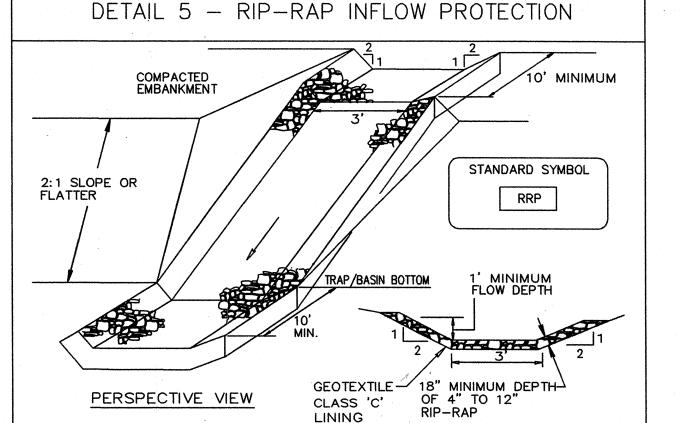

CONSTRUCTION SPECIFICATIONS . RIP-RAP LINED INFLOW CHANNELS SHALL BE 1' IN DEPTH, HAVE A TRAPEZOIDAL CROSS SECTION WITH 2:1 OR FLATTER SIDE SLOPES AND 3' (MIN.) BOTTOM WIDTH. THE CHANNEL SHALL BE LINED WITH 4" TO 12" RIP- RAP TO A DEPTH OF 18".

2. FILTER CLOTH SHALL BE INSTALLED UNDER ALL RIP-RAP. FILTER CLOTH SHALL BE GEOTEXTILE CLASS C.

3. ENTRANCE AND EXIT SECTIONS SHALL BE INSTALLED AS SHOWN ON THE DETAIL SECTION.


RIP-RAP USED FOR THE LINING MAY BE RECYCLED FOR PERMANENT OUTLET PROTECTION IF THE BASIN IS TO BE CONVERTED TO A STORMWATER MANAGEMENT

5. GABION INFLOW PROTECTION MAY BE USED IN LIEU OF RIP-RAP INFLOW PROTECTION.

6. RIP-RAP SHOULD BLEND INTO EXISTING GROUND.

RIP-RAP INFLOW PROTECTION SHALL BE USED WHERE THE SLOPE IS BETWEEN 4:1 AND 10:1, FOR SLOPES FLATTER THAN 10:1 USE EARTH DIKE OR TEMPORARY SWALE LINING CRITERIA.


MARYLAND DEPARTMENT OF ENVIRONMENT U.S. DEPARTMENT OF AGRICULTURE PAGE SOIL CONSERVATION SERVICE WATER MANAGEMENT ADMINISTRATION B - 6 - 2

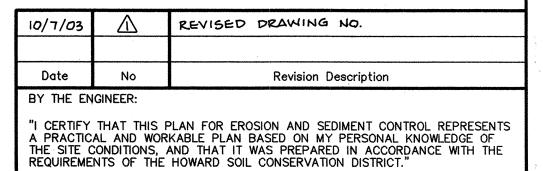


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BY THE DEVELOPER:

I/WE CERTIFY THAT ALL DEVELOPMENT AND CONSTRUCTION WILL BE DONE ACCORDING TO THIS PLAN, AND THAT ANY RESPONSIBLE PERSONNEL INVOLVED IN THE CONSTRUCTION PROJECT WILL HAVE A CERTIFICATE OF ATTENDANCE AT A DEPARTMENT OF THE ENVIRONMENT APPROVED TRAINING PROGRAM FOR THE CONTROL OF SEDIMENT AND EROSION BEFORE BEGINNING THE PROJECT. I ALSO AUTHORIZE PERIODIC ON-SITE INSPECTION BY THE HOWARD SOIL CONSERVATION

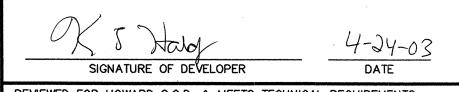


REVIEWED FOR HOWARD S.C.D. & MEETS TECHNICAL REQUIREMENTS.

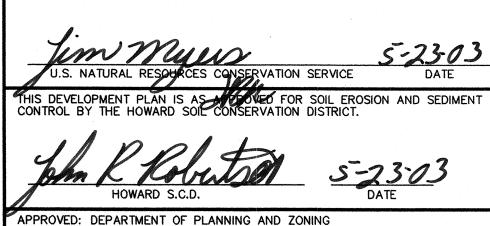

CHIEF-DIVISION OF LAND DEVELOPMENT \ 7/21/03

APPROVED: FOR PUBLIC WATER AND PUBLIC SEWERAGE SYSTEMS

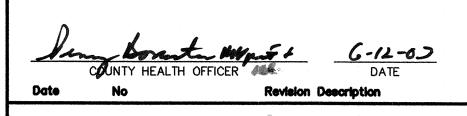

CROSSROADS CHURCH OF THE NAZARENE


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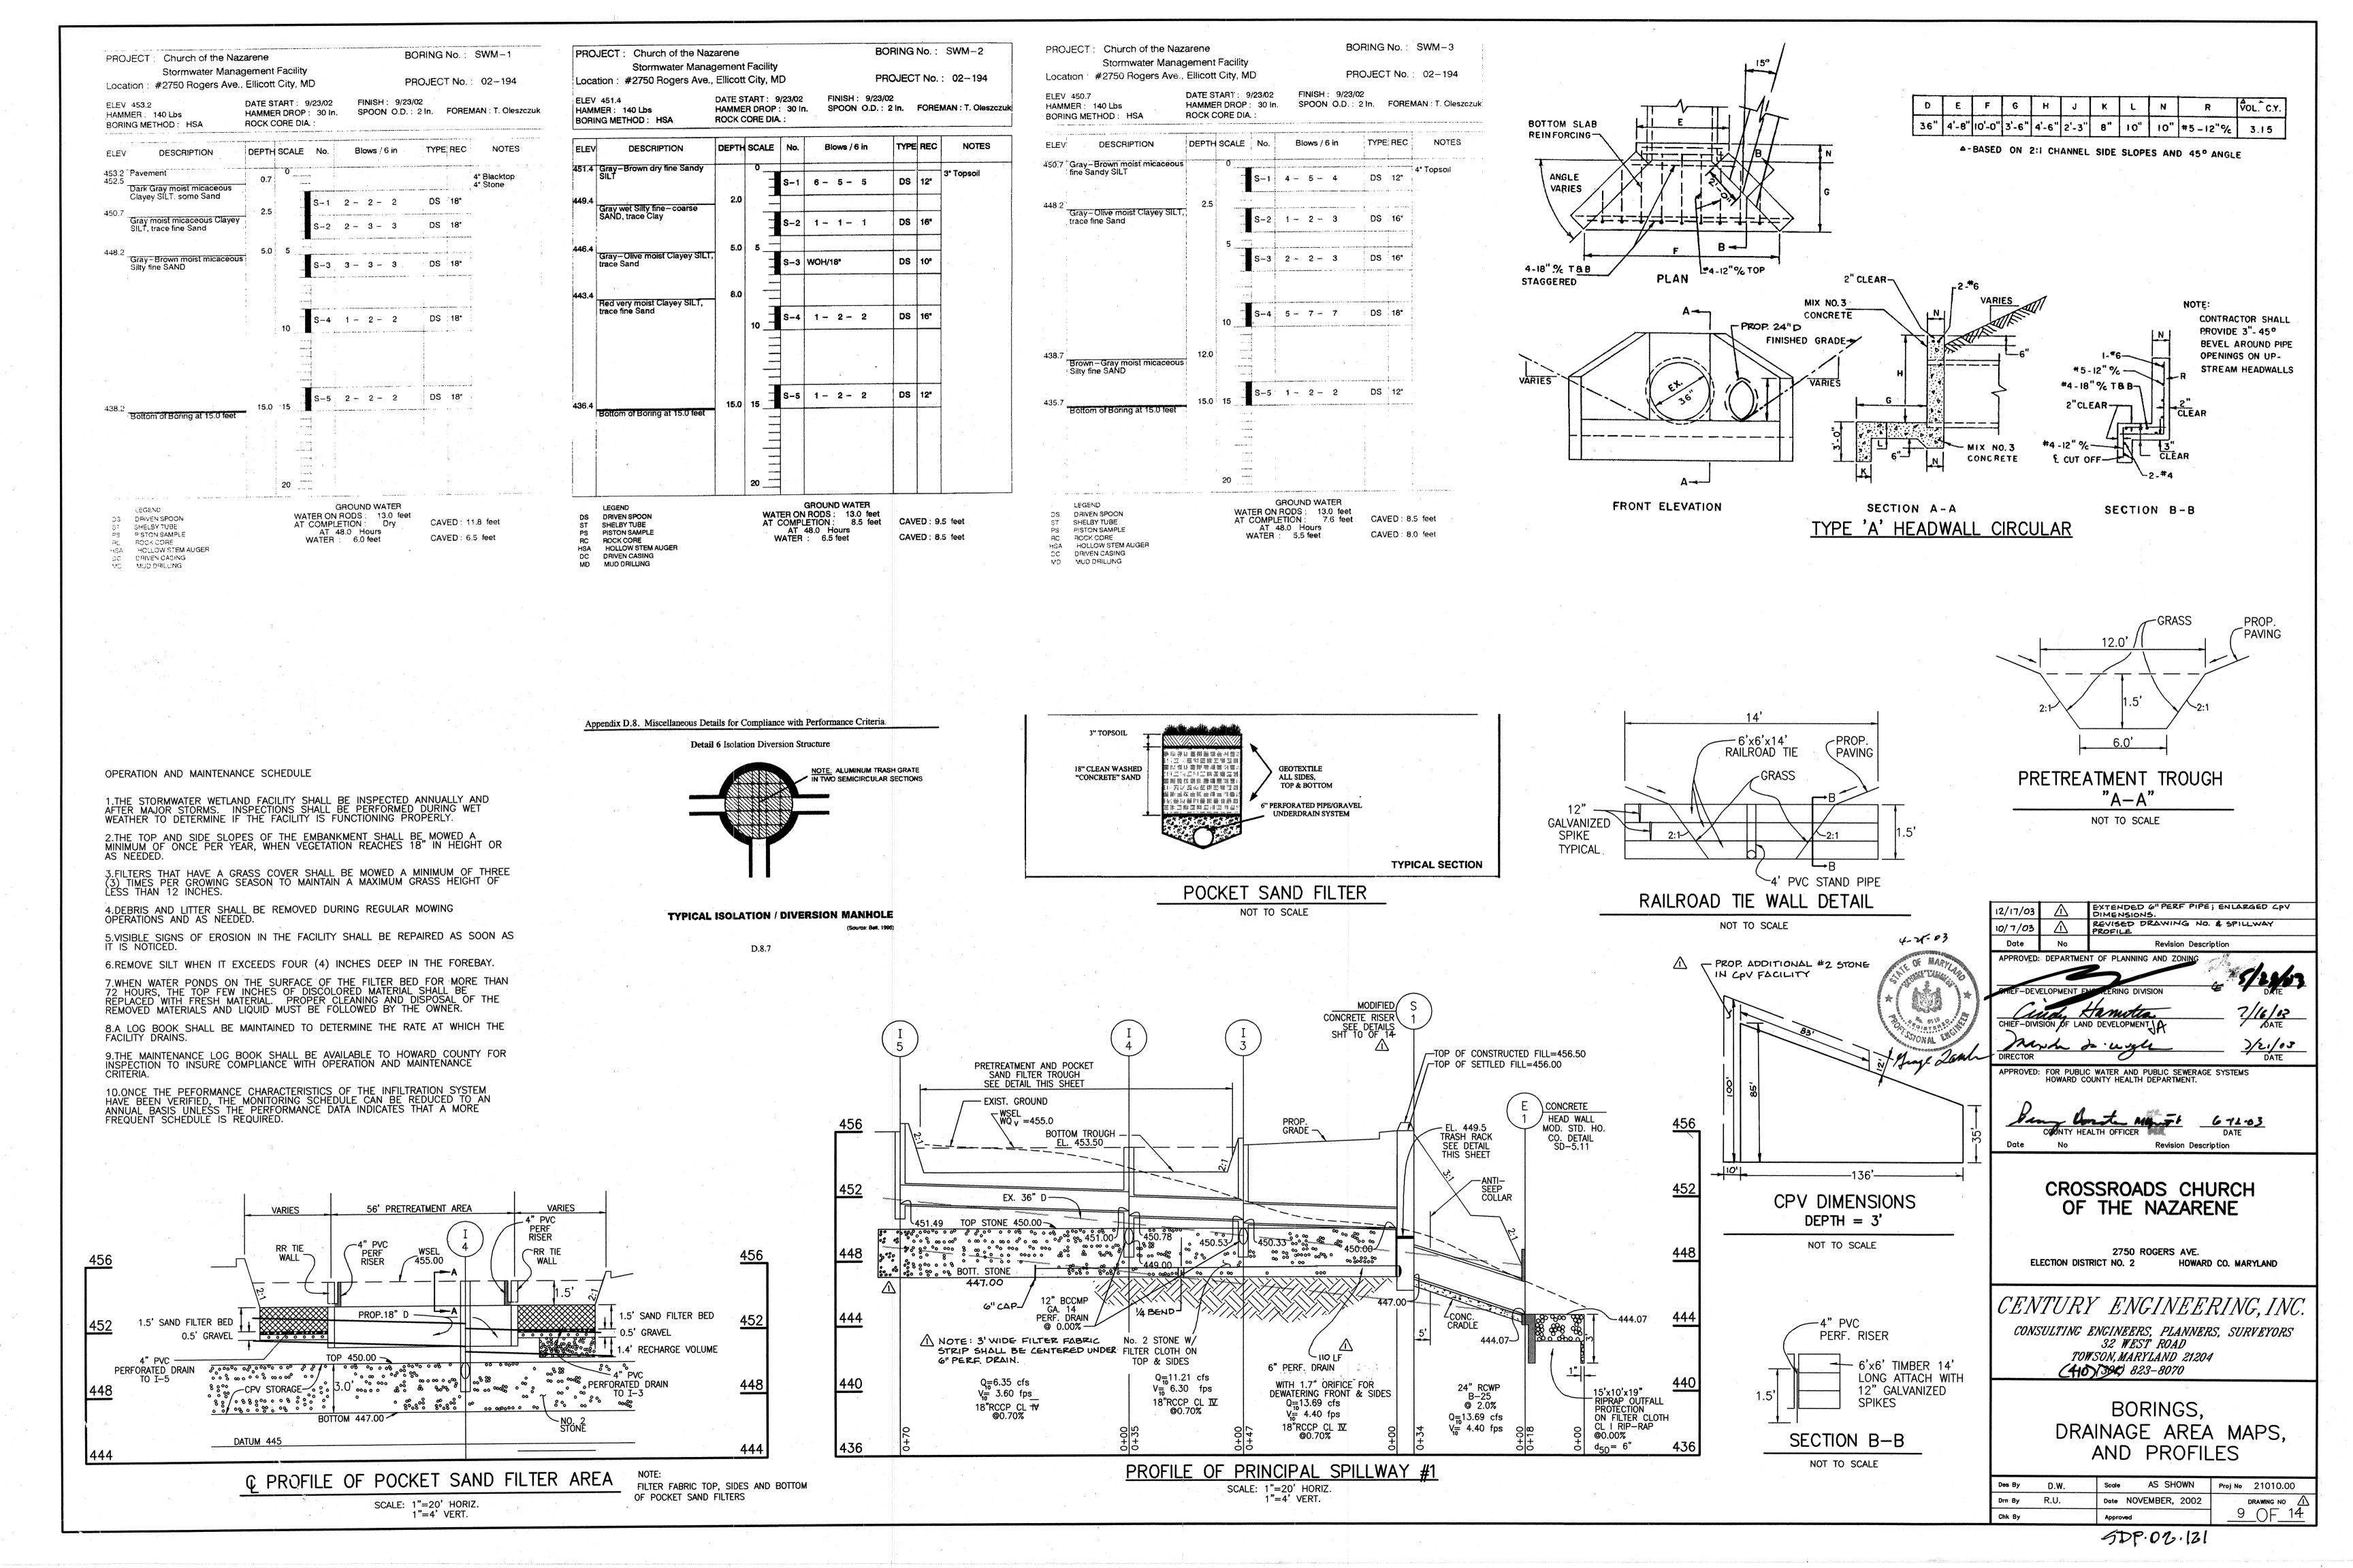
CENTURY ENGINEERING, INC.

CONSULTING ENGINEERS, PLANNERS, SURVEYORS 32 WEST ROAD TOWSON, MARYLAND 21204 (410) (821) 823-8070

> SEDIMENT & **EROSION CONTROL** NOTES AND DETAILS

AS SHOWN Proj No 21010.00 D.W. Date NOVEMBER, 2002 Dm By R.U. DRAWING NO : /1



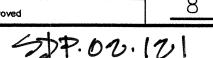

STORMWATER MANAGEMENT FACILITIES CONSTRUCTION SPECIFICATIONS

SPECIFICATIONS AND DETAILS:

STORMWATER MANAGEMENT FACILITIES SHALL BE CONSTRUCTED IN ACCORDANCE WITH THE BALTIMORE COUNTY DEPARTMENT OF PUBLIC WORKS STANDARD SPECIFICATIONS AND DETAILS FOR CONSTRUCTION UNLESS OTHERWISE INDICATED.

INSPECTION BY DESIGNATED ENGINEER:

THE CONSTRUCTION OF ALL STORMWATER MANAGEMENT FACILITIES SHALL BE UNDER THE SUPERVISION OF A REGISTERED PROFESSIONAL ENGINEER. THE ENGINEER MUST CERTIFY THAT THE FACILITIES HAVE BEEN BUILT IN ACCORDANCE WITH THE PLANS AND SUBMIT WRITTEN CERTIFICATION IMMEDIATELY FOLLOWING THE COMPLETION OF THE PROJECT.

TIMING:

RUNOFF SHALL NOT BE DISCHARGED TO UNDERGROUND SWM FACILITIES UNTIL ALL UPSTREAM DRAINAGE AREAS HAVE BEEN STABILIZED. DISCHARGE PIPES FROM THE CONTROL STRUCTURE TO THE STONE STORAGE BED SHALL BE PLUGGED UNTIL ALL AREAS ARE STABILIZED.

EROSION CONTROL FACILITIES: ALL DISTURBED AREAS SHALL BE CONTROLLED BY

EROSION AND SEDIMENT CONTROL DEVICES IN ACCORDANCE WITH A PLAN APPROVED BY BCSCD.

CARE OF WATER DURING CONSTRUCTION ALL WORK SHALL BE CARRIED OUT IN AREAS FREE FROM WATER. THE CONTRACTOR SHALL CONSTRUCT AND MAINTAIN ALL TEMPORARY DIKES, BERMS AND DRAINAGE STRUCTURES NECESSARY TO PROTECT THE WORK AREAS, AND SHALL FURNISH, OPERATE AND MAINTAIN ALL NECESSARY PUMPING AND OTHER EQUIPMENT REQUIRED FOR REMOVAL OF WATER FROM VARIOUS PARTS OF THE WORK. AFTER HAVING SERVED THEIR PURPOSE, ALL TEMPORARY FACILITIES AND EQUIPMENT SHALL BE

REMOVED. **MATERIALS:**

CONCRETE: CONCRETE SHALL BE MIX No. 3 CONCRETE ART, 20.07 REINFORCING STEEL SHALL BE ASTM A-615 GRADE 60.

CORRUGATED STEEL PIPE: PIPE SHALL BE FULLY GALVANIZED AND FULLY BITUMINOUS COATED AND SHALL CONFORM TO AASHTO M-190, TYPE A. THE CLEAR AREA OF EACH PERFORATION IN PERFORATED PIPE AFTER THE APPLICATION OF THE BITUMINOUS COATING SHALL BE AT LEAST 75 PERCENT OF THE CLEAR AREA BEFORE COATING. PIPE SHALL BE SUPPLIED WITH WATERTIGHT CONNECTING BANDS.

STONE FILL: STONE SHALL BE MSHA SIZE #2. BACKFILL MATERIAL: FILL SHALL BE FREE OF ROOTS STUMPS, WOOD, RUBBISH, OVERSIZE STONES, FROZEN OR OTHER OBJECTIONABLE MATERIALS, AND SHALL MEET THE REQUIREMENTS FOR SUBGRADE MATERIALS.

STABILIZATION: ALL BORROW AREAS SHALL BE GRADED TO PROVIDE PROPER DRAINAGE AND LEFT IN A SIGHTLY CONDITION. ALL EXPOSED SURFACES OF THE EMBANKMENT, SPILLWAY, SPOIL AND BORROW AREAS, AND BERMS SHALL BE STABILIZED BY SEEDING, LIMING, FERTILIZING AND MULCHING (IF REQUIRED) IN ACCORDANCE WITH THE VEGETATIVE TREATMENT SPÉCIFICATIONS OR AS SHOWN ON THE ACCOMPANYING DRAWINGS.

INSTALLATION:

EXCAVATION: PREPARE EXCAVATIONS TO DESIGN DIMENSIONS. EXCAVATED MATERIALS SHALL BE PLACED AWAY FROM THE EXCAVATED SIDES TO ENHANCE WALL STABILITY. LARGE TREE ROOTS SHALL BE TRIMMED FLUSH WITH THE SIDES TO PREVENT FABRIC TEARING OF PUNCTURING DURING SUBSEQUENT INSTALLATION PROCEDURES. THE SIDE WALLS OF EXCAVATIONS WHICH HAVE BEEN SHEARED AND SEALED BY EXCAVATING EQUIPMENT SHALL BE ROUGHENED BEFORE FABRIC IS PLACED.

FABRIC LAYDOWN: THE FILTER FABRIC ROLL SHALL BE CUT TO THE PROPER WIDTH PRIOR TO INSTALLATION. FABRIC SHALL BE PLACED TO COMPLETELY LINE THE TRENCH AND TO CONFORM TO ANY IRREGULARITIES IN THE EXCAVATION. FABRIC SHALL BE ANCHORED WITH METAL STAPLES OR OTHER APPROVED METHODS. WHERE OVERLAPS BETWEEN TWO ROLLS ARE REQUIRED, THE UPSTREAM ROLL SHALL LAP A MINIMUM OF 2 FEET OVER THE DOWNSTREAM ROLL IN ORDER TO PROVIDE A SHINGLE EFFECT. OVERLAPS ON THE TOP OF TRENCHES AND BEDS SHALL BE A MINIMUM OF 6 INCHES.

STONE PLACEMENT: STONE SHALL BE PLACED WITH CARE TO AVOID TEARING OR DISPLACING FILTER FABRIC. STONE FILL SHALL BE PLACED IN LIFTS AND COMPACTED USING PLATE COMPACTORS OR OTHER APPROVED EQUIPMENT. MAXIMUM LOOSE LIFT THICKNESS SHALL BE 12 INCHES.

CONTAMINATION: CARE SHALL BE EXERCISED TO PREVENT NATURAL OR FILL SOILS FROM INTERMIXING WITH THE STONE FILL. ALL CONTAMINATED STONE FILL SHALL BE REMOVED AND REPLACED WITH UNCONTAMIN-ATED STONE.

BACKFILL: AFTER STONE FILL HAS BEEN PLACED, THE TOP OF THE STONE STORAGE BED SHALL BE COVERED WITH FILTER CLOTH. BACKFILL SHALL BE PLACED IN LIFTS WITH A MAXIMUM THICKNESS OF 6 INCHES AND THOROUGHLY COMPACTED USING HAND OPERATED VIBRATORY TAMPERS OR OTHER APPROVED EQUIPMENT TO 95 PERCENT OF AASHTO T-99 MAXIMUM DENSITY. BACKFILL MATERIALS SHALL MEET THE SPECIFICATIONS FOR PAVEMENT SUBGRADE.

OBSERVATION WELL: AN OBSERVATION WELL SHALL BE CONSTRUCTED FOR EACH FACILITY WHERE INDICATED ON THE DRAWINGS. THE DEPTH OF THE WELL AT THE TIME OF INSTALLATION SHALL BE MARKED ON THE CAP. FILTER CLOTH: FILTER CLOTH AS APPROVED BY COUNTY MATERIALS LAB: MIRAFI 140S, SUPAC 5P, DUPONT TYPAR #3341 OR #3401 OR EQUIVALENT. COMPACTION: SUBGRADE SHALL BE COMPACTED TO NOT LESS THAN 95% OF MAX. DENSITY AS A REQUIRE-

MENT OF AASHTO T180 METHOD C.

PIPE CONDUITS

ALL PIPES SHALL BE CIRCULAR IN CROSS SECTION. REINFORCED CONCRETE PIPE: ALL OF THE FOLLOWING CRITERIA SHALL APPLY FOR REINFORCED CONCRETE PIPE.

1. MATERIALS:

RFINFORCED CONCRETE PIPE SHALL HAVE BELL AND SPIGOT JOINTS WITH RUBBER GASKETS AND SHALL EQUAL OR EXCEED ASTM DESIGNATION C-361.

2. **BEDDING:**

ALL REINFORCED CONCRETE PIPE CONDUITS SHALL BE LAID IN A CONCRETE BEDDING FOR THEIR ENTIRE LENGTH. THIS BEDDING SHALL CONSIST OF HIGH SLUMP CONCRETE PLACED UNDER THE PIPE AND UP THE SIDES OF THE PIPE AT LEAST 10% OF ITS OUTSIDE DIAMETER WITH A MINIMUM THICKNESS OF 3 INCHES, OR AS SHOWN ON THE DRAWINGS.

LAYING PIPE:

BELL AND SPIGOT PIPE SHALL BE PLACED WITH THE BELL END UPSTREAM. JOINTS SHALL BE MADE IN ACCORDANCE WITH RECOMMENDATIONS OF THE MANUFACTURER OF THE MATERIAL. AFTER THE JOINTS ARE SEALED FOR THE ENTIRE LINE, THE BEDDING SHALL BE PLACED SO THAT ALL SPACES UNDER THE PIPE ARE FILLED. CARE SHALL BE EXERCISED TO PREVENT ANY DEVIATION FROM THE ORIGINAL LINE AND GRADE OF THE PIPE. THE FIRST JOINT MUST BE LOCATED WITHIN 2 FEET FROM THE RISER.

BACKFILLING SHALL CONFORM TO "STRUCTURE BACKFILL." OTHER DETAILS (ANTI-SEEP COLLARS, VALVES, ETC.) SHALL BE AS SHOWN ON THE DRAWINGS.

POLYVINYL CHLORIDE (PVC): ALL OF THE FOLLOWING CRITERIA SHALL APPLY FOR POLYVINYL CHLORIDE (PVC) PIPE.

PVC PIPE SHALL BE PVC-1120 OR PVC-1220 CONFORMING TO ASTM D-1785 OF ASTM D-2241.

JOINTS AND CONNECTIONS TO ANTI-SEEP COLLARS SHALL BE COMPLETELY WATERTIGHT.

BEDDING

THE PIPE SHALL BE FIRMLY AND UNIFORMLY BEDDED THROUGHOUT ITS ENTIRE LENGTH. WHERE ROCK OR SOFT, SPONGY OR OTHER UNSTABLE SOIL IS ENCOUNTERED ALL SUCH MATERIAL SHALL BE REMOVED AND REPLACED WITH SUITABLE EARTH COMPACTED TO PROVIDE ADEQUATE

- BACKFILLING SHALL CONFORM TO "STRUCTURE BACKFILL
- OTHER DETAILS (ANTI-SEEP COLLARS, VALVES, ETC.) SHALL BE AS SHOWN ON THE DRAWINGS.

STRUCTURE BACKFILL

BACKFILL ADJACENT TO PIPES OR STRUCTURES SHALL BE OF THE TYPE AND QUALITY CONFORMING TO THAT SPECIFIED PLACED IN HORIZONTAL LAYERS NOT TO EXCEED 4 INCHES IN THICKNESS AND COMPACTED BY HAND TAMPERS OR OTHER OF 24 INCHES OR GREATER OVER THE STRUCTURE OR PIPE.

AREAS DESIGNATED FOR BORROW AREAS, EMBANKMENT, AND STRUCTURAL WORKS SHALL BE CLEARED, GRUBBED AND STRIPPED OF TOPSOIL. ALL TREES, VEGETATION, ROOTS AND OTHER OBJECTIONABLE MATERIAL SHALL BE REMOVED. CHANNEL BANKS AND SHARP BREAKS SHALL BE SLOPED NO STEEPER THAN 1:1.

OF ALL TREES, BRUSH, LOGS, FENCES, RUBBISH AND OTHER OBJECTIONABLE MATERIAL UNLESS OTHERWISE DESIGNATED ON THE PLANS. TREES. BRUSH AND STUMPS SHALL BE CUT APPROXIMATELY LEVEL WITH THE GROUND SURFACE. FOR DRY STORMWATER MANAGEMENT PONDS, A MINIMUM OF A 50 FOOT RADIUS AROUND THE INLET STRUCTURE SHALL BE CLEARED. ALL CLEARED AND GRUBBED MATERIAL SHALL BE DISPOSED OF OUTSIDE AND BELOW THE LIMITS OF THE DAM AND RESERVOIR AS DIRECTED BY THE OWNER OR HIS REPRESENTATIVE. WHEN SPECIFIED, A SUFFICIENT QUANTITY OF TOPSOIL WILL BE STOCKPILED IN A SUITABLE LOCATION FOR USE ON THE

SEQUENCE OF OPERATIONS FOR SWM FACILITY #1

- 2. CLEAR AND GRUB FOR SEDIMENT & EROSION CONTROL
- AND DEVICES.

- BEGIN MASS GRADING.
- AFTER GRADING, BEGIN INSTALLATION OF UTILITIES. BEGIN PLACING SUB-BASE AND INSTALLING CURB AND
- PAVING. 10. CONSTRUCT UNDERGROUND STORMWATER MANAGEMENT
- 11. FINISH GRADING AND STABILIZE DISTURBED AREA ACCORDING TO PERMANENT SEEDING SPECIFICATIONS.
- 12. FINISH PAVING.
- 13. AFTER OBTAINING PERMISSION FROM SEDIMENT CONTROL
- 14. STABILIZE ANY AREAS DISTURBED BY THIS PROCESS.

SIDES AND SHOULD BE AVOIDED. REMOVING BOULDERS OR OTHER OBSTACLES FROM THE TRENCH WALLS IS ONE SOURCE OF SUCH VOIDS. NATURAL SOILS SHOULD BE PLACED IN THESE VOIDS AT THE MOST CONVENIENT TIME DURING CONSTRUC-TION TO ENSURE FABRIC CONFORMITY TO THE EXCAVATION SIDES. SOIL PIPING, FABRIC CLOGGING, AND POSSIBLE SURFACE SUBSIDENCE WILL BE AVOIDED BY THIS REMEDIAL PROCESS AS-BUILT PLANS AND CERTIFICATION ARE REQUIRED FOR THIS STORMWATER MANAGEMENT FACILITY. THESE MUST BE PREPARED AND SEALED BY A <u>REGISTERED PROFESSIONAL ENGINEER</u> BALTIMORE COUNTY WILL NOT PERFORM THE INSPECTION OR PREPARE THE AS-BUILT PLANS OF CERTIFICATION. THE STORMWATER MANAGEMENT PERMIT SECURITY WILL NOT BE RELEASED UNTIL THE AS-BUILT PLANS AND CERTIFICATION ARE APPROVED BY BALTIMORE COUNTY.

GENERAL NOTES

- UTILITIES AND TOPOGRAPHICAL FEATURES SHOWN ON THESE PLANS ARE ONLY FOR THE CONVENIENCE OF THE USER AND THERE IS NO WARRANTY OR GUARANTEE OF THE CORRECTNESS OF THE COMPLETENESS OF THE INFORMATION GIVEN. THE USER OF THESE DRAWINGS MUST VERIFY ALL SUCH INFORMATION TO HIS. OWN SATISFATION.

FOR THE ADJOINING FILL MATERIAL. THE FILL SHALL BE MANUALLY DIRECTED COMPACTION EQUIPMENT. THE MATERIAL NEEDS TO FILL COMPLETELY ALL SPACES UNDER AND ADJACENT TO THE PIPE. AT NO TIME DURING THE BACKFILLING OPERATION SHALL DRIVEN EQUIPMENT BE ALLOWED TO OPERATE CLOSER THAN FOUR FEET. MEASURED HORIZONTALLY, TO ANY PART OF A STRUCTURE. UNDER NO CIRCUMSTANCES SHALL EQUIPMENT BE DRIVEN OVER ANY PART OF A CONCRETE STRUCTURE OR PIPE UNLESS THERE IS A COMPACTED FILL

SITE PREPARATION

AREAS TO BE COVERED BY THE RESERVOIR WILL BE CLEARED EMBANKMENT AND OTHER DESIGNATED AREAS.

- NOTIFY HOWARD COUNTY DEPARTMENT OF ENVIRON-MENTAL PROTECTION AND RESOURCE MANAGEMENT, SEDIMENT CONTROL DIVISION (410)887-3226 AT LEAST 48 HOURS PRIOR TO BEGINNING WORK.
- MEASURES OR DEVICES ONLY.
- INSTALL ALL SEDIMENT & EROSION CONTROL MEASURES
- NOTIFY HOWARD COUNTY DEPARTMENT OF ENVIRON-MENTAL PROTECTION AND RESOURCE MANAGEMENT, SEDIMENT CONTROL DIVISION, UPON COMPLETION OF SAID INSTALLATION.
- WITH THE APPROVAL OF HOWARD COUNTY DEPARTMENT OF ENVIRONMENTAL PROTECTION AND RESOURCE MANAGEMENT AND THE SEDIMENT CONTROL INSPECTOR, CLEAR AND GRUB REMAINDER OF SITE.
- REMOVE EXISTING PAVING WHERE REQUIRED.

- INSPECTOR, REMOVE SEDIMENT CONTROL MEASURES.

VOIDS BEHIND FABRIC


VOIDS CAN BE CREATED BETWEEN THE FABRIC AND EXCAVATION

- AS-BUILT PLANS AND CERTIFICATION ARE REQUIRED FOR THIS STORMWATER MANAGEMENT FACILITY. THESE MUST BE PREPARED AND SEALED BY A REGISTERED PROFESSIONAL ENGINEER. HOWARD COUNTY WILL NOT PERFORM THE INSPECTION OR PREPARE THE AS-BUILT PLANS OR CERTIFICATION. THE STORMWATER MANAGEMENT PERMIT SECURITY WILL NOT BE RELEASED UNTIL THE AS-BUILT PLANS AND CERTIFICATION ARE APPROVED BY HOWARD COUNTY.
- IN ORDER TO PREPARE THE REQUIRED AS-BUILT PLANS AND CERTIFICATION, THIS STORMWATER MANAGEMENT FACILITY MUST BE INSPECTED BY THE ENGINEER AT SPECIFIC STAGES DURING CONSTRUCTION AS REQUIRED BY THE CURRENT BALTIMORE COUNTY STORMWATER MANAGEMENT POLICY AND DESIGN MANUAL. THE CONTRACTOR SHALL NOTIFY THE ENGINEER AT LEAST FIVE (5) WORKING DAYS PRIOR TO STARTING ANY WORK SHOWN ON THESE PLANS.
- UNLESS OTHERWISE NOTED, ALL CONSTRUCTION AND WORKMANSHIP SHALL BE IN ACCORDANCE WITH: HOWARD COUNTY DEPARTMENT OF PUBLIC WORKS STANDARD SPECIFICATIONS AND DETAILS FOR CONSTRUCTION 1976, ERRATA AND ADDENDA.

SOIL CONSERVATION SERVICE MARYLAND STANDARDS AND SPECIFICATIONS POND CODE 378 NOVEMBER, 1992 MARYLAND DEPARTMENT OF TRANSPORTATION STATE HIGHWAY ADMINISTRATION, JANUARY, 1982, STANDARD SPECIFICATIONS FOR CONSTRUCTION AND MATERIAL.

4" DIA. PIPE BCCMP 4" DIA. PIPE BCCMP ∠—6"x4 TEE **F** 1000 6" PERF. **END** BCCMP GA. 14 X

SECTION X-X CLEANOUT DETAIL (N.T.S.) (N.T.S.)

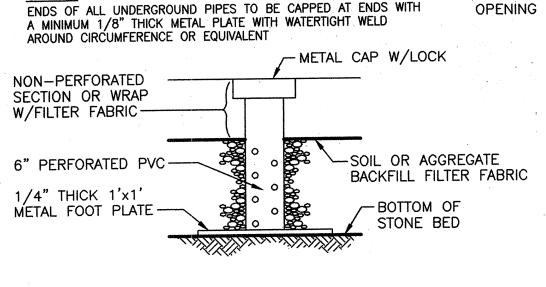

OBSERVATION WELL (N.T.S.) - FINISH GRADE NON-PERFORATED SECTION OR WRAP W/FILTER FABRIC MIX NO. 3 CONCRETE-SOIL OR AGGREGATE 2"x4" KEY (TYP.) BACKFILL FILTER FABRIC 1 1/2" PERFORATED PVC-6" PERF. CMP. -BOTTOM OF STONE BED

1 1/2" DIAMETER PIPES SHALL BE MAINTAINED IN AN OPEN AND CLEAR CONDITION AT ALL TIMES. SUBSEQUENT PARKING LOT REPAVING WILL REQUIRE EXTENSION, REPAIR


AND/OR REPLACEMENT OF VENTS AS REQUIRED TO

MAINTAIN THEIR FUNCTION. PLUG VENTS DURING ALL

PAVING OPERATIONS. APPLICABLE INFILTRATION MANUAL

SPECS.:

VENT PIPE (N.T.S.)

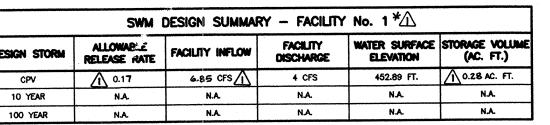

DRAINAGE AREA ROUTED = 3.52 Ac. \pm *WATERSHED AREA: \$\alpha\$ 3.52 AC. \pm\$ IMPERVIOUS AREA = 1.26 Ac. WATER QUALITY: TO ELEV. 454.50 3010 CF LEVEL OF MANAGEMENT PROVIDED BY FACILITIES: CPV QUANTITY MANAGEMENT BIORETENTION SWALE FOR WQV VOLUME PROVIDED

1 4 CPV FACILITY ADJUSTED FOR PARKING LOT ADDITION STREAM CLASS:

THESE FACILITIES ARE PRIVATE

A 21"D-1

FLOW

21"D-

4" SLAB W/ SIDEWALK

FRAME & COVER ----

MANHOLE STEPS © 12" o.c.

TOP STONE EL. 450.00

6" PERF. CMP W∕3" ø —

OPENING FOR DEWATERING

447.00

MAINTENANCE TO BE PROVIDED BY OWNER TYPE OF FACILITY: UNDERGROUND SAND/STONE STORAGE -

4'-0"

RISER STRUCTURE PLAN S-1

4'-0"

6" PERF. CMF

6'-4"

(NOT TO SCALE)

5'-4"

4'-0"

7'-4"

SECTION B - B

SCREEN PROTECTION DETAIL

NO SCALE

PROVIDE CAP CONSISTING OF SQUARE GAV. WIRE MESH

CENTERED OVER INLET ENDS

WALLS WITH CLIPS.

HARDWARE FABRIC)

OF PIPES AND ANCHORED INTO

1/2" SQ. OPENNINGS) TO BE

(NOT TO SCALE)

SECTION A - A

MAINTENANCE

INFILTRATION TRENCHES SHALL BE DESIGNED TO MINIMIZE MAINTENANCE. HOWEVER, IT IS RECOGNIZED THAT ALL INFILTRATION FACILITIES ARE SUBJECT TO CLOGGING BE SEDIMENT, OIL, GREASE, GRIT AND OTHER DEBRIS. IN ADDITION, THE PERFORMANCE AND LONGEVITY OF THESE STRUCTURES IS NOT WELL DOCUMENTED. CONSEQUENTLY, A MONITORING OBSERVATION WELL IS REQUIRED FOR ALL INFILTRATION STRUCTURES.

THE OBSERVATION WELL SHALL BE MONITORED PERIODICALLY. FOR THE FIRST YEAR AFTER COMPLETION OF CONSTRUCTION, THE WELL SHOULD BE MONITORED ON A QUARTERLY BASIS AND AFTER EVERY LARGE STORM. IT IS RECOMMENDED THAT A LOG BOOK BE MAINTAINED INDICATING THE RATE AT WHICH THE FACILITY DEWATERS AFTER LARGE STORMS AND THE DEPTH OF THE WELL FOR EACH OBSERVATION. ONCE THE PERFORMANCE CHARACTERISTICS OF THE STRUCTURE HAVE BEEN VERIFIED, THE MONITORING SCHEDULE CAN BE REDUCED TO AN ANNUAL BASIS, UNLESS THE PERFORMANCE DATA INDICATE THAT A MORE FREQUENT SCHEDULE IS REQUIRED.

SEDIMENT BUILD-UP IN THE TOP FOOT OF STONE AGGREGATES OR THE SURFACE INLET SHOULD BE MONITORED ON THE SAME SCHEDULE AS THE OBSERVATION WELL. A MONITORING WELL IN THE TOP FOOT OF STONE AGGREGATE WILL BE REQUIRED WHEN THE TRENCH HAS A STONE SURFACE. SEDIMENT DEPOSITED SHALL NOT BE ALLOWED TO BUILD UP TO THE POINT WHERE IT WILL REDUCE THE RATE OF INFILTRATION INTO THE

-24" RCWP

ASTM C-361

B - 25

EL. 454.50

PROVIDE JOINT

2' FROM RISER

-24" RCWP B-25

EL. 447.00

#4 @ 12" E.W.

TOP AND

BOTTOM


<u>. 454.50</u>

#4 @ 12" o.c. E.W.

EL. 447.00

6" PERF. CMP.

TOP AND BOTTOM

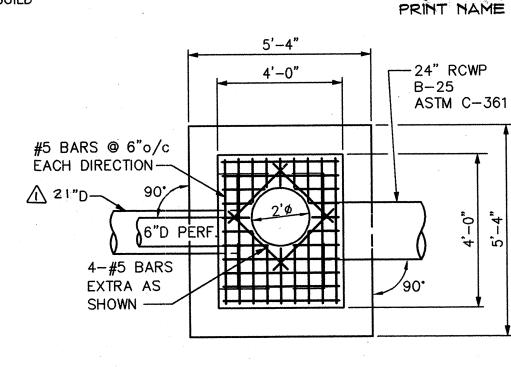

RISER STRUCTURE TOP

SLAB REINFORCING PLAN

SCALE: 3/8" = 1'-0

RIVER

VERT. BAR 3" CLEAR \ , MINIMUM MORTAR AROUND PIPE AND ANTI-SEEP COLLAR WITH NON-SHRINK GROUT (TYP.) R.C.W.P 2' MINIMUM CONC. CRADLE-PROTECTION

> ANTI-SEEP COLLAR (NOT TO SCALE)

> > CHANGED 18" PIPE TO 21" PIPE

DESIGN SUMMARY TABLE

REVISED DRAWING NO. AND SWM

Revision Description

7/16/03 DATE

)/21/03 DATE

6519

4-24-03


P.E. NO.

DATE

P.E. NO.

DATE

DATE

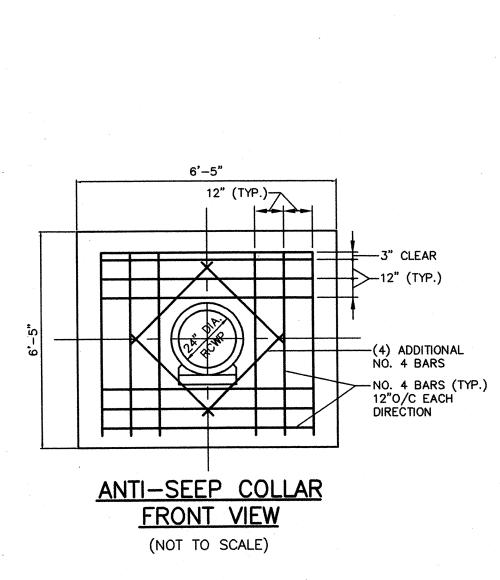

RISER NOTES:

CONCRETE CRADLE

(NOT TO SCALE)

ALL CONSTRUCTION AND MATERIALS SHALL BE IN ACCORDANCE WITH THE SWM POND/SEDIMENT BASIN CONSTRUCTION SPECIFICATIONS AND THE MSHA STANDARD SPECIFICATIONS FOR CONSTRUCTION AND MATERIALS SECTIONS 414 AND 416.


CONCRETE

2. ALL CONCRETE SHALL BE MIX NO. 3 (fc=3500 psi) 3. ALL REINFORCING STEEL SHALL CONFORM TO ASTM DESIGNATION A615, GRADE 60. ALL REINFORCING STEEL SHALL BE #4 BARS SPACED AT 12". CONCRETE COVER OVER THE REINFORCING STEEL SHALL BE A MINIMUM OF 2" MEASURED FROM THE INSIDE FACE OF WALLS AND FROM THE TOP SURFACE OF THE REINFORCING STEEL IN THE BOTTOM AND SIDES OF THE FOOTING. CUT REINFORCING STEEL AT PIPES AND

CONSTRUCTION JOINTS BETWEEN WALLS AND FOOTING SHALL BE ROUGH FLOATED SUFFICIENTLY TO THOROUGHLY CONSOLIDATE THE SURFACE AND SHALL BE INTENTIONALLY LEFT IN A ROUGENED

6. ORIFICE PLATE TO BE SHOP FABRICATED AND HOT DIPPED GALVANIZED PRIOR TO FIELD ASSEMBLY.

5. PROVIDE 1 1/4" CHAMFER FOR ALL CORNERS ABOVE GRADE.

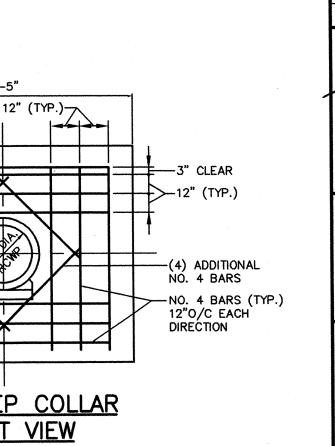

4-25-03

ENGINEER'S CERTIFICATION:

GEORGE LAMBROS

AS-BUILT CERTIFICATION

AND SPECIFICATIONS.

PRINT NAME

SIGNATURE

PRINT NAME

ENGINEER.

X+5

SIGNATURE

Kenn

I HEREBY CERTIFY THAT THIS PLAN HAS BEEN PREPARED BY ME OR UNDER

MY SUPERVISION AND MEETS THE MINIMUM STANDARDS OF THE HOWARD

COUNTY DEPARTMENT OF ENVIRONMENTAL PROTECTION AND RESOURCE

MANAGEMENT AND THE HOWARD COUNTY SOIL CONSERVATION DISTRICT

I HEREBY CERTIFY THAT THE FACILITY SHOWN ON THIS PLAN WAS CONSTRUCTED

AS SHOWN ON THE "AS-BUILT" PLANS AND MEETS THE APPROVED PLANS

I/WE HEREBY CERTIFY THAT ALL WORK SHOWN ON THESE CONSTRUCTION

DRAWINGS WILL BE ACCOMPLISHED PURSUANT TO THESE PLANS. I/WE ALSO

UNDERSTAND THAT IT IS MY/OUR RESPONSIBILITY TO HAVE THE CONSTRUCTION

SUPERVISED AND CERTIFIED, INCLUDING THE SUBMITTAL OF "AS-BUILT" PLANS

WITHIN THIRTY (30) DAYS OF COMPLETION, BY A REGISTERED PROFESSIONAL

10/7/03

Date

APPROVED: DEPARTMENT OF PLANNING AND

CHIEF-DIVISION OF LAND DEVELOPMENT

Hamilia

LANDOWNER'S/DEVELOPER'S CERTIFICATION

but uniss. 6-12-03 Revision Description CROSSROADS CHURCH OF THE NAZARENE

APPROVED: FOR PUBLIC WATER AND PUBLIC SEWERAGE SYSTEMS HOWARD COUNTY HEALTH DEPARTMENT.

2750 ROGERS AVE. HOWARD CO. MARYLAND **ELECTION DISTRICT NO. 2**


CENTURY ENGINEERING, INC. CONSULTING ENGINEERS, PLANNERS, SURVEYORS

32 WEST ROAD OKSON, MARYLAND 21204 (410) (301) 823-8070

STORM WATER MANAGEMENT NOTES AND DETAILS FACILITY #1

AS SHOWN | Proj No 21010.00 Des By D.W. Drn By R.U. Date NOVEMBER, 2002 DRAWING NO 10 OF 14

SP.02.121

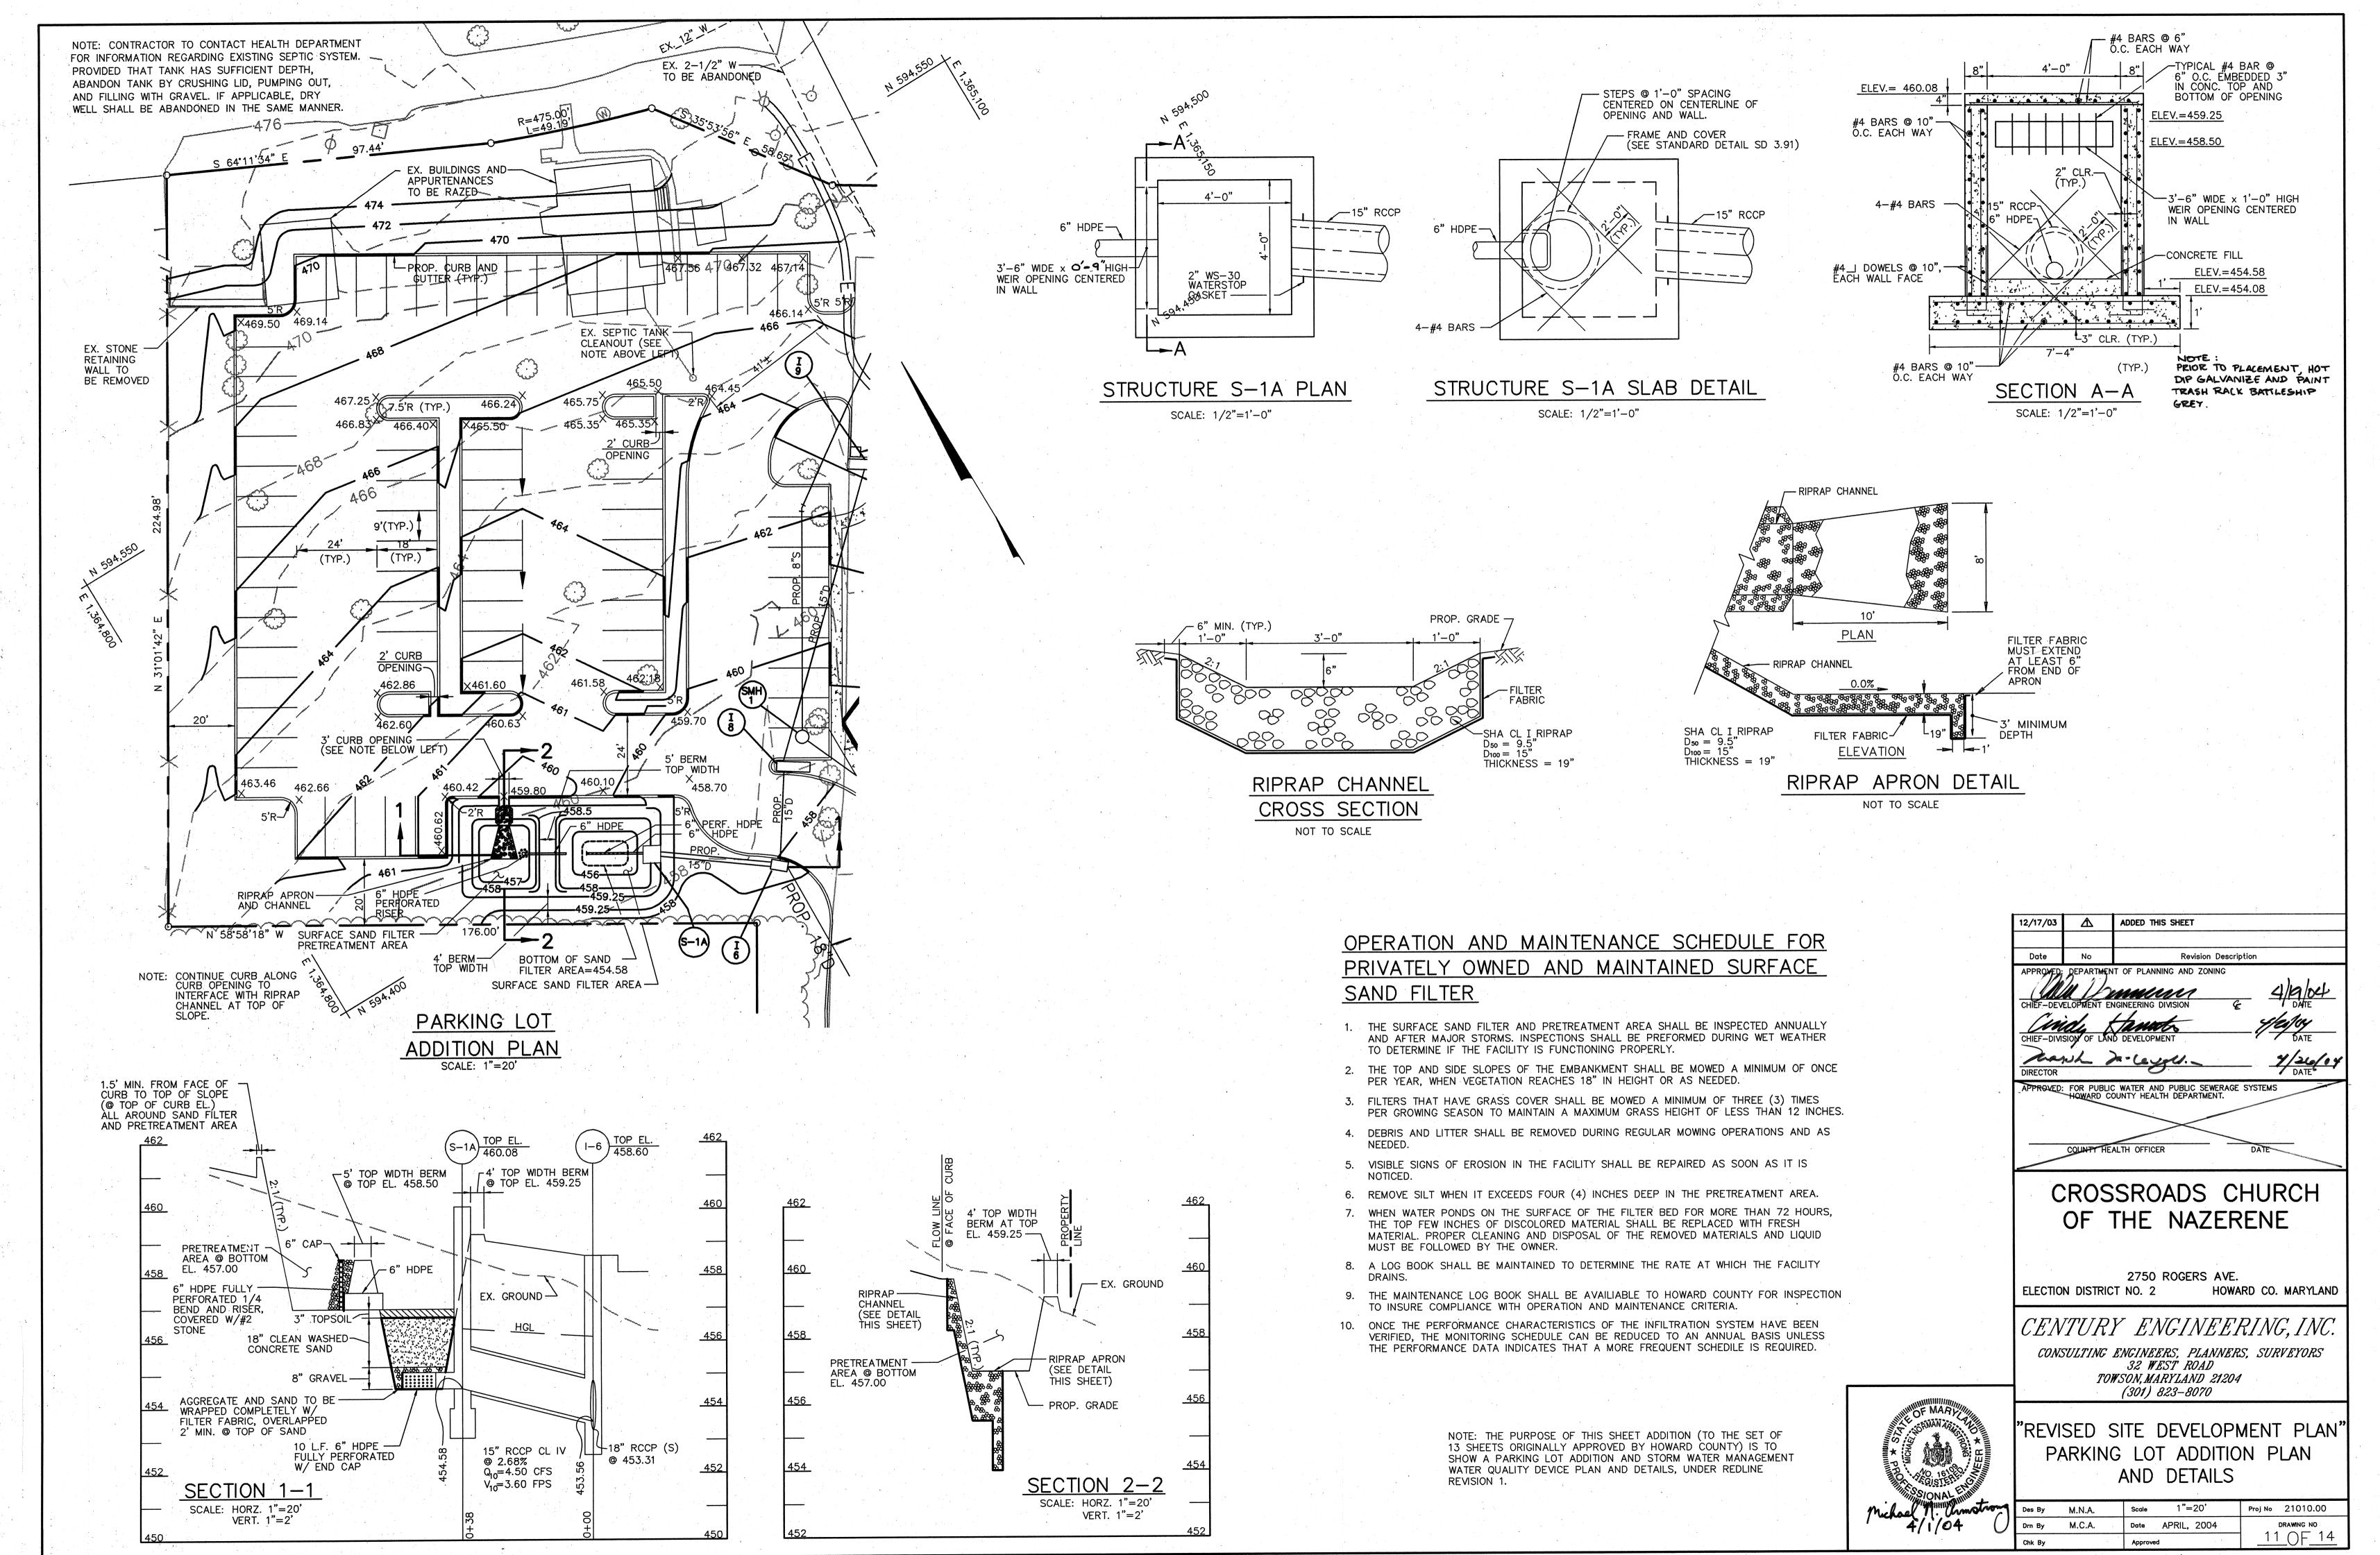

5DP.OZ.121

