#### GENERAL NOTES

- All construction shall be in accordance with the latest standards and specifications of Howard County plus MSHA standard and specifications if applicable.
- 2. The contractor shall notify the Department of Public Works/Construction Inspection Division at (410) 313-1880 at least five (5) working days prior to the start of work.
- 3. The contractor shall notify "Miss Utility" at 1-800-257-7777 at least 48 hours prior to any excavation work.
- 4. The contractor shall notify the Howard County Department of Public Works, Bureau of Utilities at (410) 313—4900 at least five working days prior to starting any excavation work.
- 5. Site area: 26.35 ACRES
- 6. Traffic control devices, markings, and signing shall be in accordance with the latest edition of the manual on uniform traffic control devices (MUTCD). All street and regulatory signs shall be in place prior to the placement of any
- 7. All plan dimensions are to face of curb unless otherwise
- 8. Existing topography reflects field survey by Century Engineering, March, 2000.
- 9. Coordinates and bearing are based upon the MD State plan system (NAD '83).
- 10. Existing water and sewer shown is public.
- 11. Stormwater Management will be addressed using a stone trench at the base of the existing slope. This design will provide water quality for the new impervious
- 12. All existing water and sewer is per Contract #s: 10-1214, 208-W
- 13. All curb radii is 5' unless noted otherwise.
- 14. Exisiting Utility information taken from approved final construction plans for development. Contract numbers Sewer 10—1215 and Water 208—W.
- 15. All sidewalks shall be 6' wide except where dimensioned otherwise. Provide 3' radius rounding at all angle breaks and intersections.
- 16. Contractor shall utilize PVC for all sewer house connections. Contractor shall utilize D.I.P. (CL. 51) for 6" water house connection.
- 17. For all storm drain connections at existing stubs, the contractor shall remove the existing blocking and maintain.
- 18. Use Howard County trench bedding class "C" for storm drains.
- 19. Payed areas indicated are private except as noted.
- 20. Recording reference: Plat No. 274/939
- 21. All proposed ramps shall be in accordance with current A.D.A. standards. Maximum sidewalk cross slope shall be two percent. Provide a five-foot by five-foot level (2 percent max.) landing at the top and bottom of all ramps and building entrances and exits.
- 23. All proposed site utilities are to terminate 5' from the building. The building plumber shall connect to and extend these utilities to the inside of the building.
- 24. For Gas, Telephone and Electric routing, see separate plan.
- 25. This project is exempt from the requirements of Section16.1200 of the Howard County Code for Forest Conservation because all propsed improvements are contained within the previously approved Limit of Disturbance as shown on SDP-84-294 and SDP-93-14. (16.1202(b)(1)(iii)
- 26. No clearing, grading or construction is permitted within the required wetlands, stream(s) or their buffers and forest conservation easement areas.
- 27. Previous site plan references S.D.P. 84-294 and S.D.P. 93-14 and BA CASE 83-39E, WP 91-28. BA CASE 90-24E, BA 01-51c
- 28. There are no burial grounds on subject property. 29. Lighting fixture details shown on Sheet 4 of 11.
- 30. The subject property is zoned R-ED per the October 18, 1993 Comprehensive Zoning Plan.
- 31. All on-site structures are to be retained. The approximate age of the on-site structures are as follows: School-45 years Church-17 years

Rectory—24 years Religious Education—24 years


32. Landscape surety in the amount of \$7,450.00 shall be provided by the developer/builder. as part of the Developer's Agreement (see sheet 10 of 10)


COUNTY MEALTH OFFICER HOWARD COUNTY HEALTH DEPARTMENT

APPROVED FOR PUBLIC WATER AND PUBLIC SEVERAGE SYSTEMS

APPROVED: HOWARD COUNTY DEPARTMENT OF PLANNING & ZONING

# SITE DEVELOPMENT PLAN OUR LADY OF PERPETUAL HELP MULTIPURPOSE BUILDING

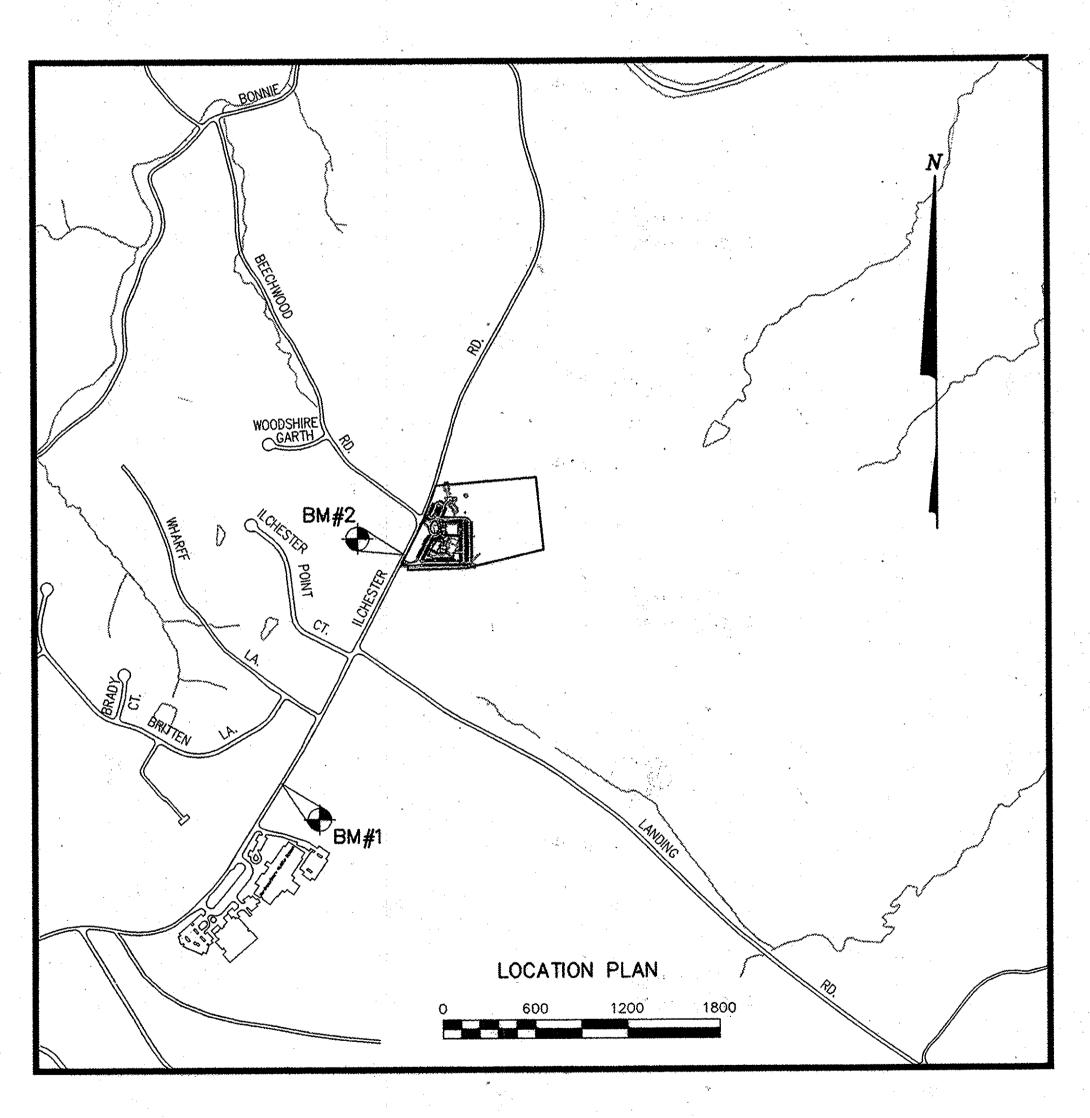

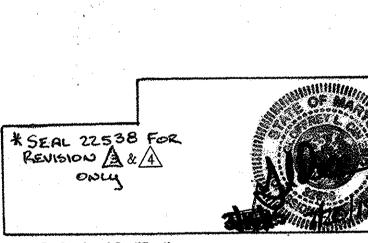


**Professional Certification** I hereby certify that these documents were prepared or approved by me, and that I am a duly the State of Maryland Licence No.: 22538
Expiration Date.: 11-24-15

## BENCHMARKS

31E6 - NAIL & FLASHER IN POWER POLE, 2 TREES & FENCE POST 5' - S.W. OF EDGE OF ROAD & 500' - W. OF WHARF LANE NAD83 N 570852.4 E 1376700.7

31E7 - 9' S.E. OF EDGE OF ROAD AND 250' W OF BEACHWOOD ROAD NAD83 N 572335.3 E 1377503.9

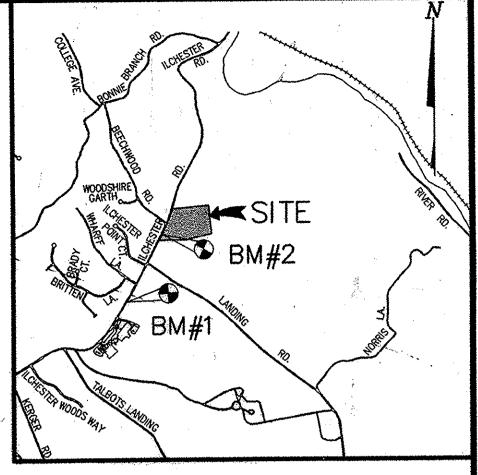

VICINITY MAP SCALE: 1"=2000"

NO. 1 OF 12	COVER SHEET
1 OF 12	COVER SUEET
	COACH SUCCE
2 OF 12	SITE DEVELOPMENT PLAN 1"=50"
3 OF 12	SITE DEVELOPMENT PLAN
4 OF 12	DRAINAGE AREA MAP AND DETAILS
5 OF 12	UTILITY PROFILES, SWM PROFILE AND DETAILS
6 OF 12	SEDIMENT CONTROL PLAN
7 OF 12	SEDIMENT CONTROL NOTES & DETAILS
8 OF 12	SEDIMENT CONTROL NOTES & DETAILS
9 OF 12	SWM AND SEDIMENT CONTROL DETAILS
10 OF 12	DETAIL SHEET
11 OF 12	LANDSCAPE PLAN
12.0F12	OHSITE WATERLINE EXTENSION
	& CHURCH ADDITION 4

SITE ANALYSIS CHART

TOTAL SITE AREA 1.147.806 sf(26.35 Acres)

BUILDING COVERAGE: 0.98 ACRES AND 3.7% OF GROSS AREA AREA PLAN SUBMISSION 4.6 AC. 4.6 AC. DISTURBED AREA R-ED ZONING MULTI-PURPOSE CHURCH USES-SITE-STRUCTURE SCHOOL ACTIVITIES W/ PARKING\* FLOOR SPACE 1st- 12,806SF 2nd- 6,260SF

REQUIRED PARKING = 1 SPACE PER 6 STUDENTS (250/6=42 SPACES) AND 1 SPACE PER 3 SEATS( 750/3 = 250 SPACES) TOTAL SCHOOL AND CHURCH=292

EXISTING PARKING TO BE RESTRIPED= 279 PROPOSED PARKING= 65

TOTAL PARKING SPACES = 344

EXISTING PARISHIONERS TO USE NEW SPACE \*\*(INCLUDES 12 HANDICAP SPACES, RESTRIPING OF EXISTING PARKING AREAS, AND EXISTING PARKING NEAR THE NORTH ENTRANCE)

LOT/PARCEL# 4805 ILCHESTER ROAD (MULTIPURPOS PARCEL NO.260 PARCEL 'A' SUBDIVISION NAME

4795 ILCHESTER ROAD (CHURCH 4803 ILCHESTER ROAD (SCHOOL) PERMIT INFORMATION CHART LOT/PARCEL NO. 26 SECTION/AREA CENSUS TRACT PLAT # OR L/F GRID # ZONING 274/535 10 R-ED TAX MAP NO. ELEC. DIST. 31 SEWER CODE: 1252600 WATER CODE: 6-10

ADDRESS CHART

STREET ADDRESS

CENTURY ENGINEERING, INC. CONSULTING ENGINEERS, PLANNERS, SURVEYORS 32 WEST ROAD

TOWSON, MARYLAND 21204

(410) 823-8070

9/24/03 A REVISED SHEETS 2,3,4,5,6,8 AND 9 REVISED SITE ANALYSIS CHART 3/16/04 A REVISED SHEETS 2 THROUGH 6, 8 AND 10 FOR BALL FIELD STOCKPILE GRADING. ADDED DRAWING AND REVISED DRAWING LIST, REVISED SHEET NUMBER. 3/16/15 REVISED DEALURING LIST & SHEET HUMBERS, ADDED SHEET 12 GLC ADDED ADDRESS FOR CHAPEL TO ADDRESS CHART Revised address chart and added meter address chart BY APP'R. REVISION DATE

The state of the s

PURPOSE NOTE: 4805 ILCHESTER ROAD (MULTIPURPOSE BUILDING)

METER ADDRESS CHART

4801 ILCHESTER ROAD (CHURCH)

4803 ILCHESTER ROAD (SCHOOL)

ARCHDIOCESE OF BALTIMORE

4805 ILCHESTER ROAD

OUR LADY OF PERPETUAL HELP

ELLICOTT CITY, MARYLAND 21043

PREPARED FOR:

THE PURPOSE OF THIS SITE DEVELOPMENT PLAN IS TO SHOW THE ADDITION OF A MULTI-PURPOSE BUILDING TO THE SITE AND PARKING AND ENTRANCE MODIFICATIONS.


COVER SHEET


5TH ELECTION DISTRICT


OUR LADY OF PERPETUAL HELP MULTIPURPOSE BUILDING ELLICOTT CITY, MARYLAND


C.E.I. FILE No. SCALE AS SHOWN R-ED20068.00 SHEET A TAX MAP No. HOWARD COUNTY, MARYLAND


SDP-02-97

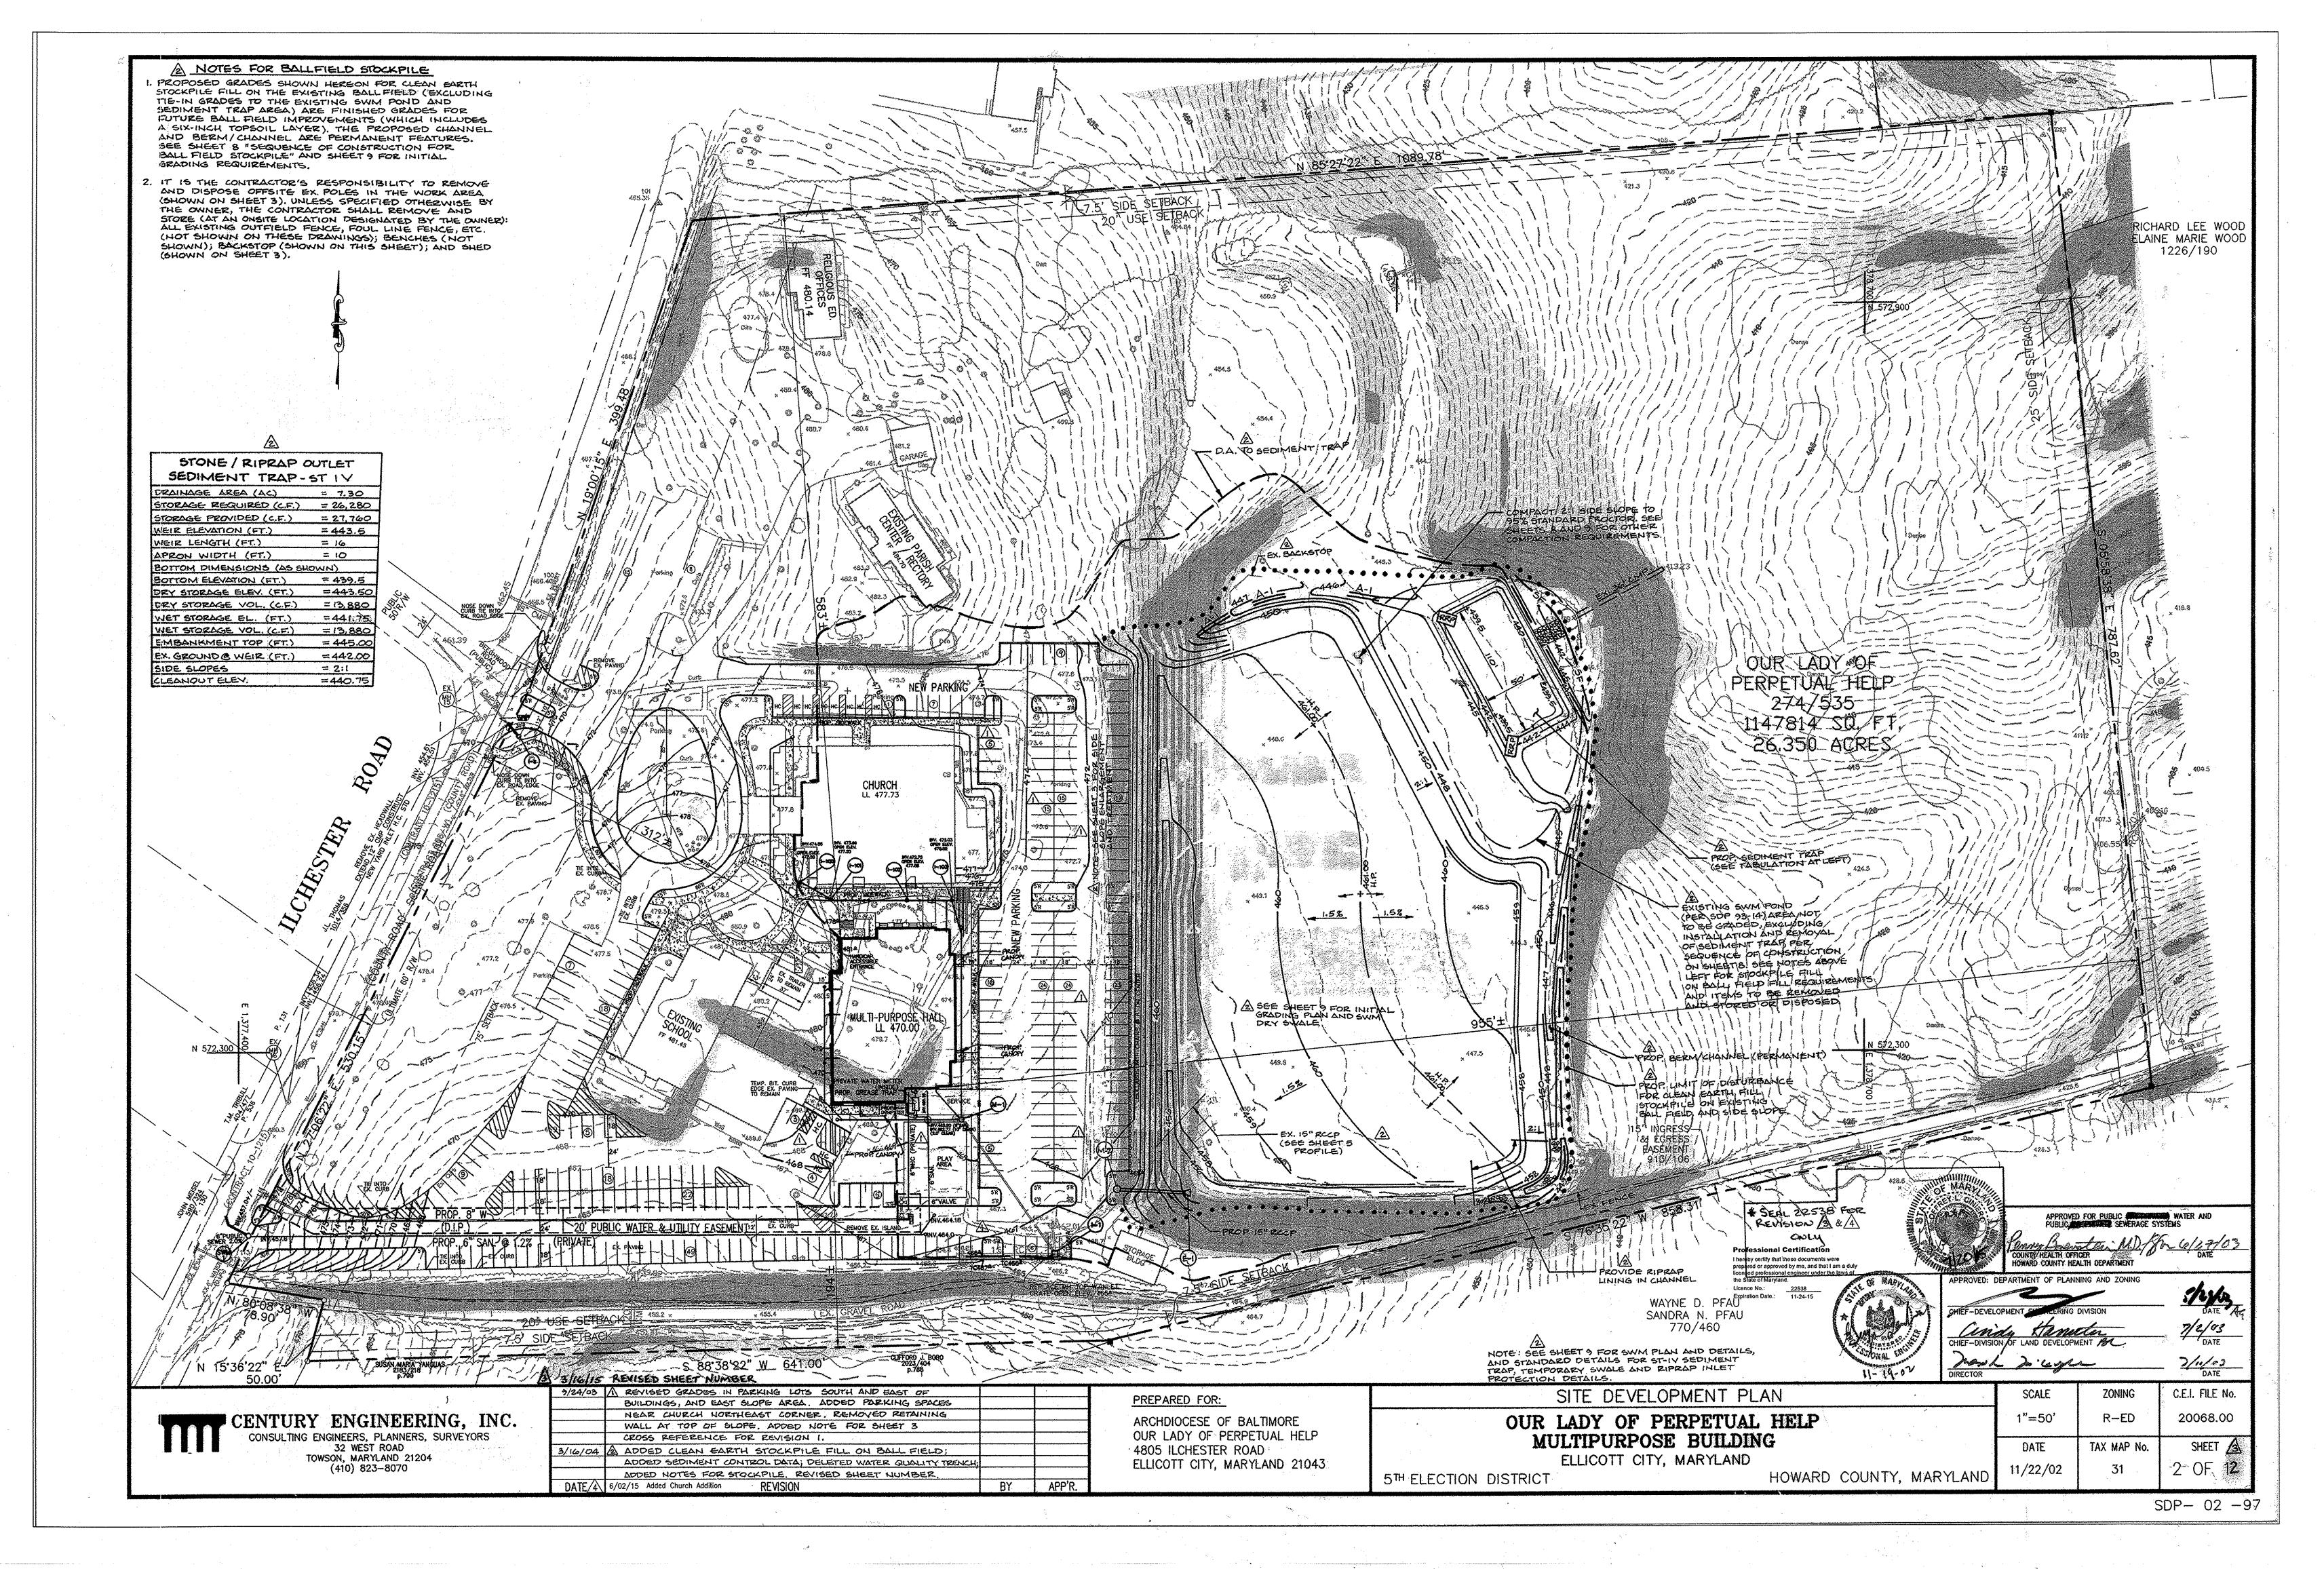


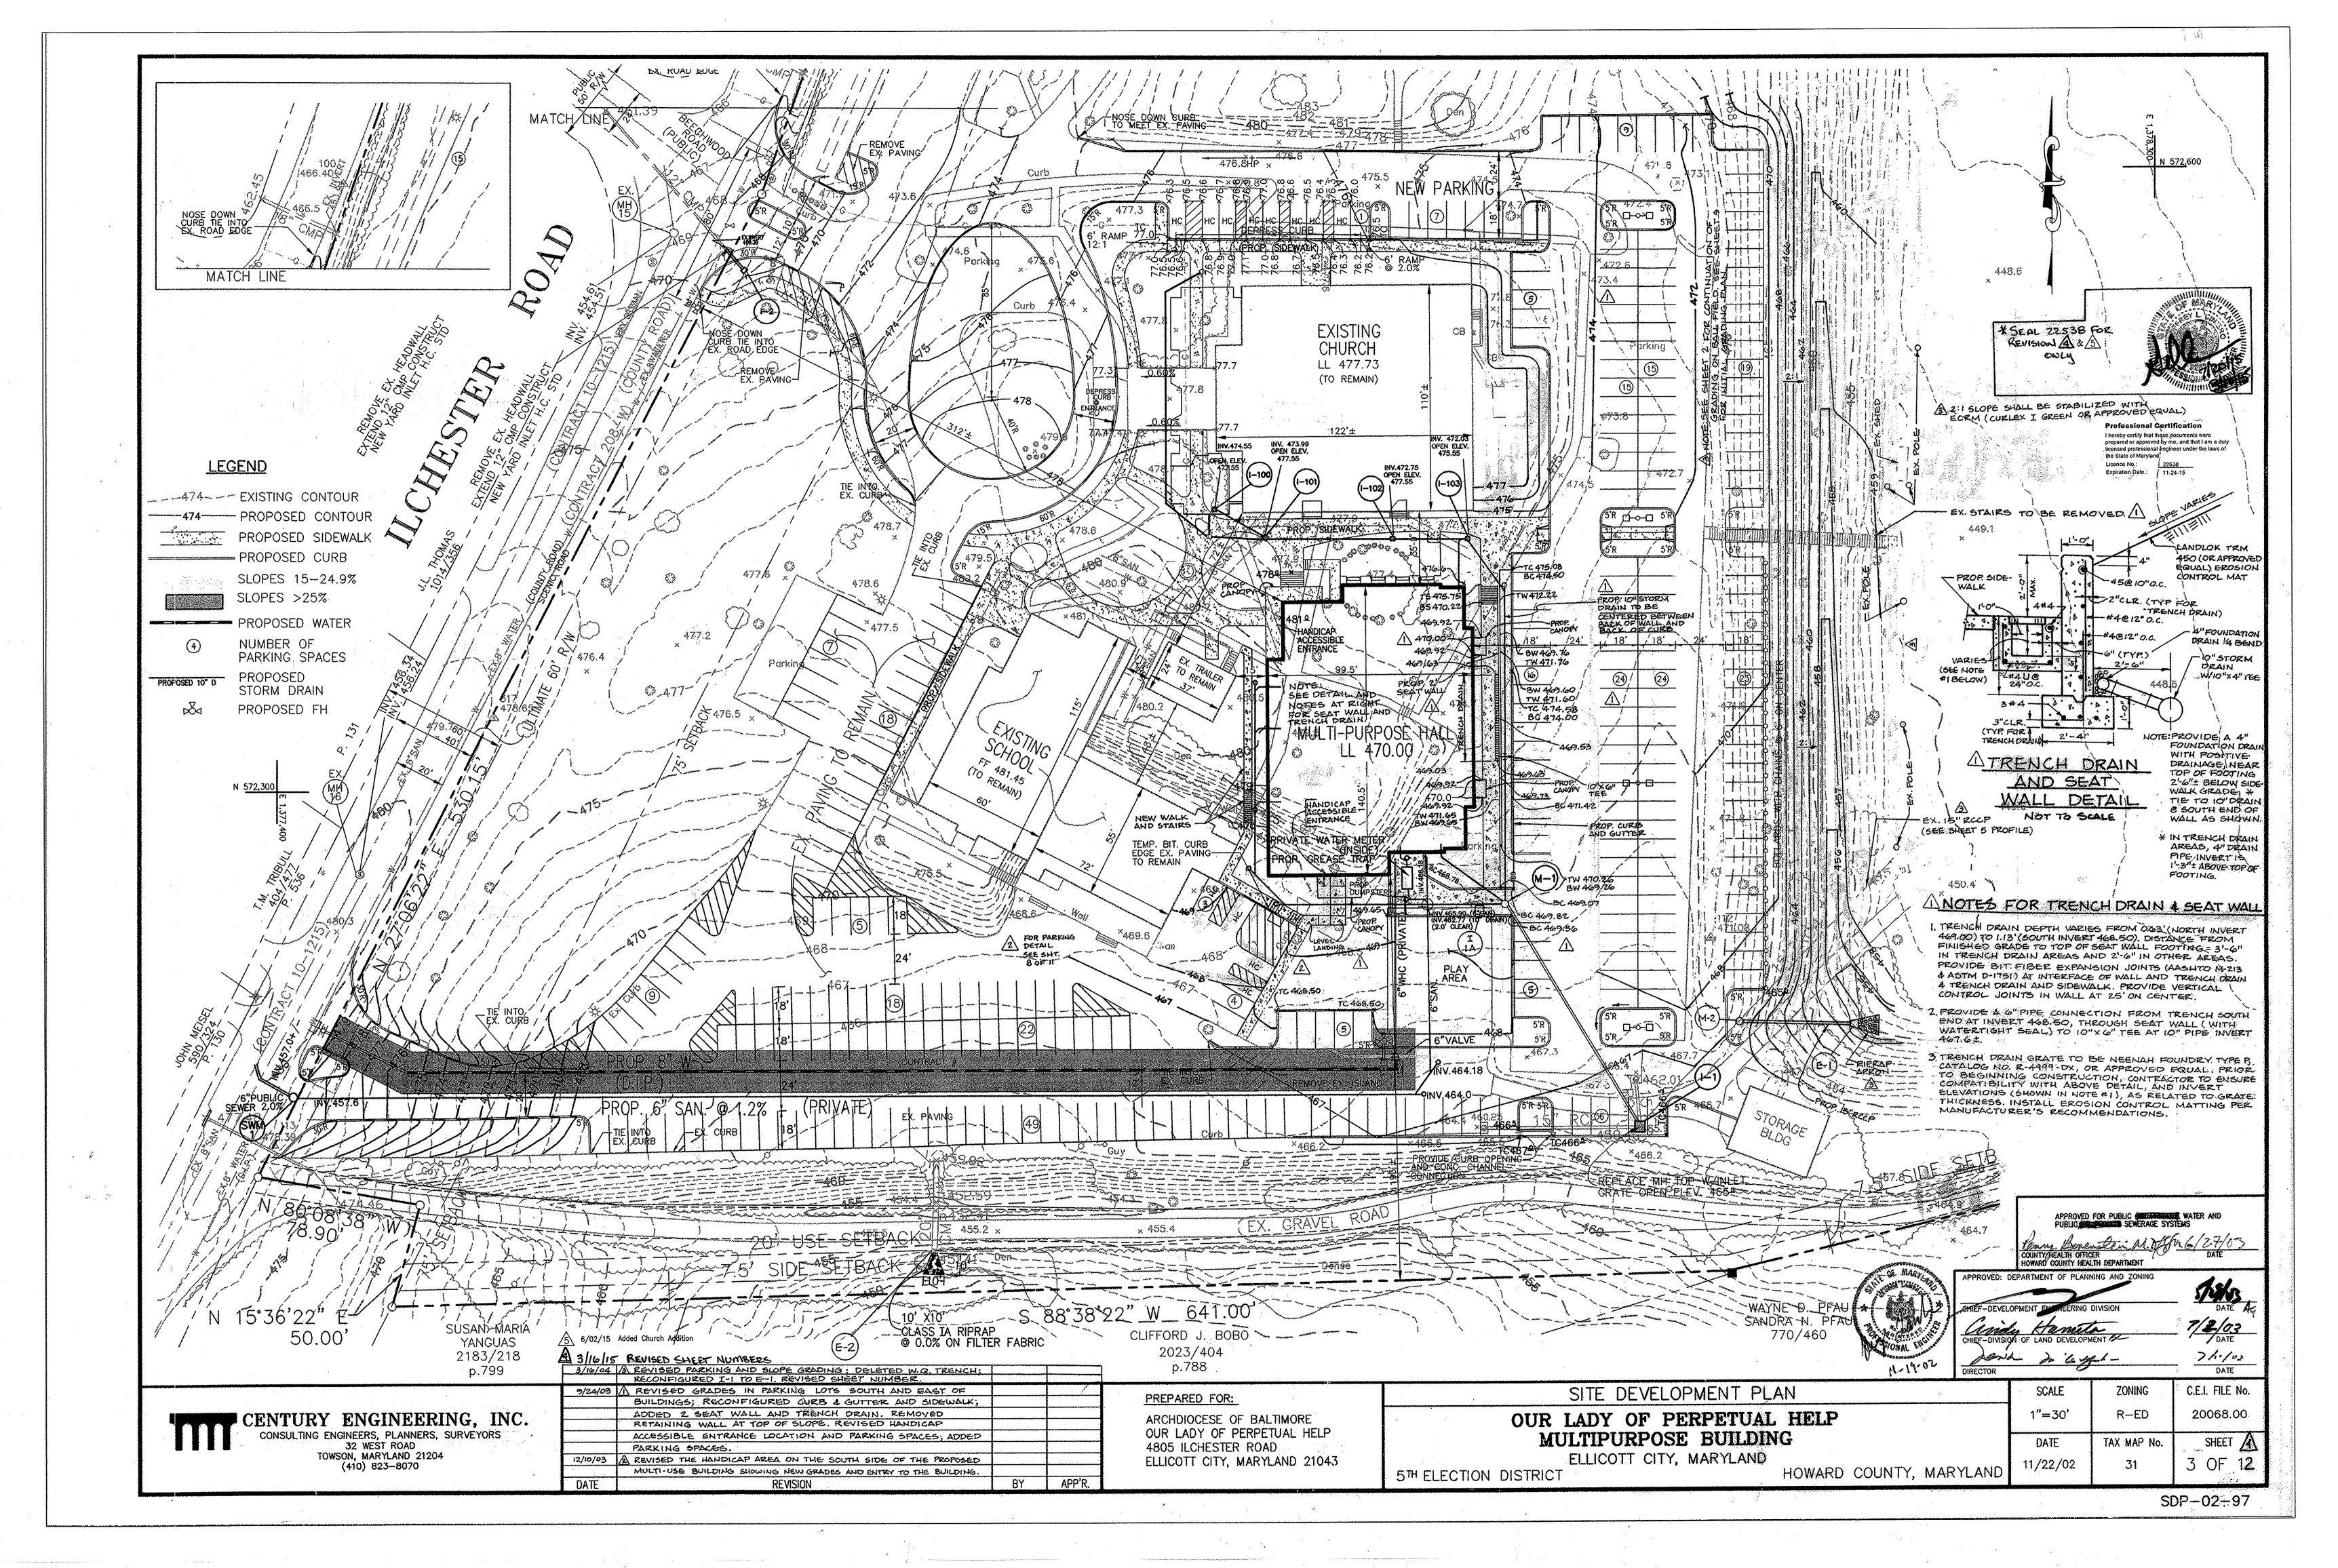

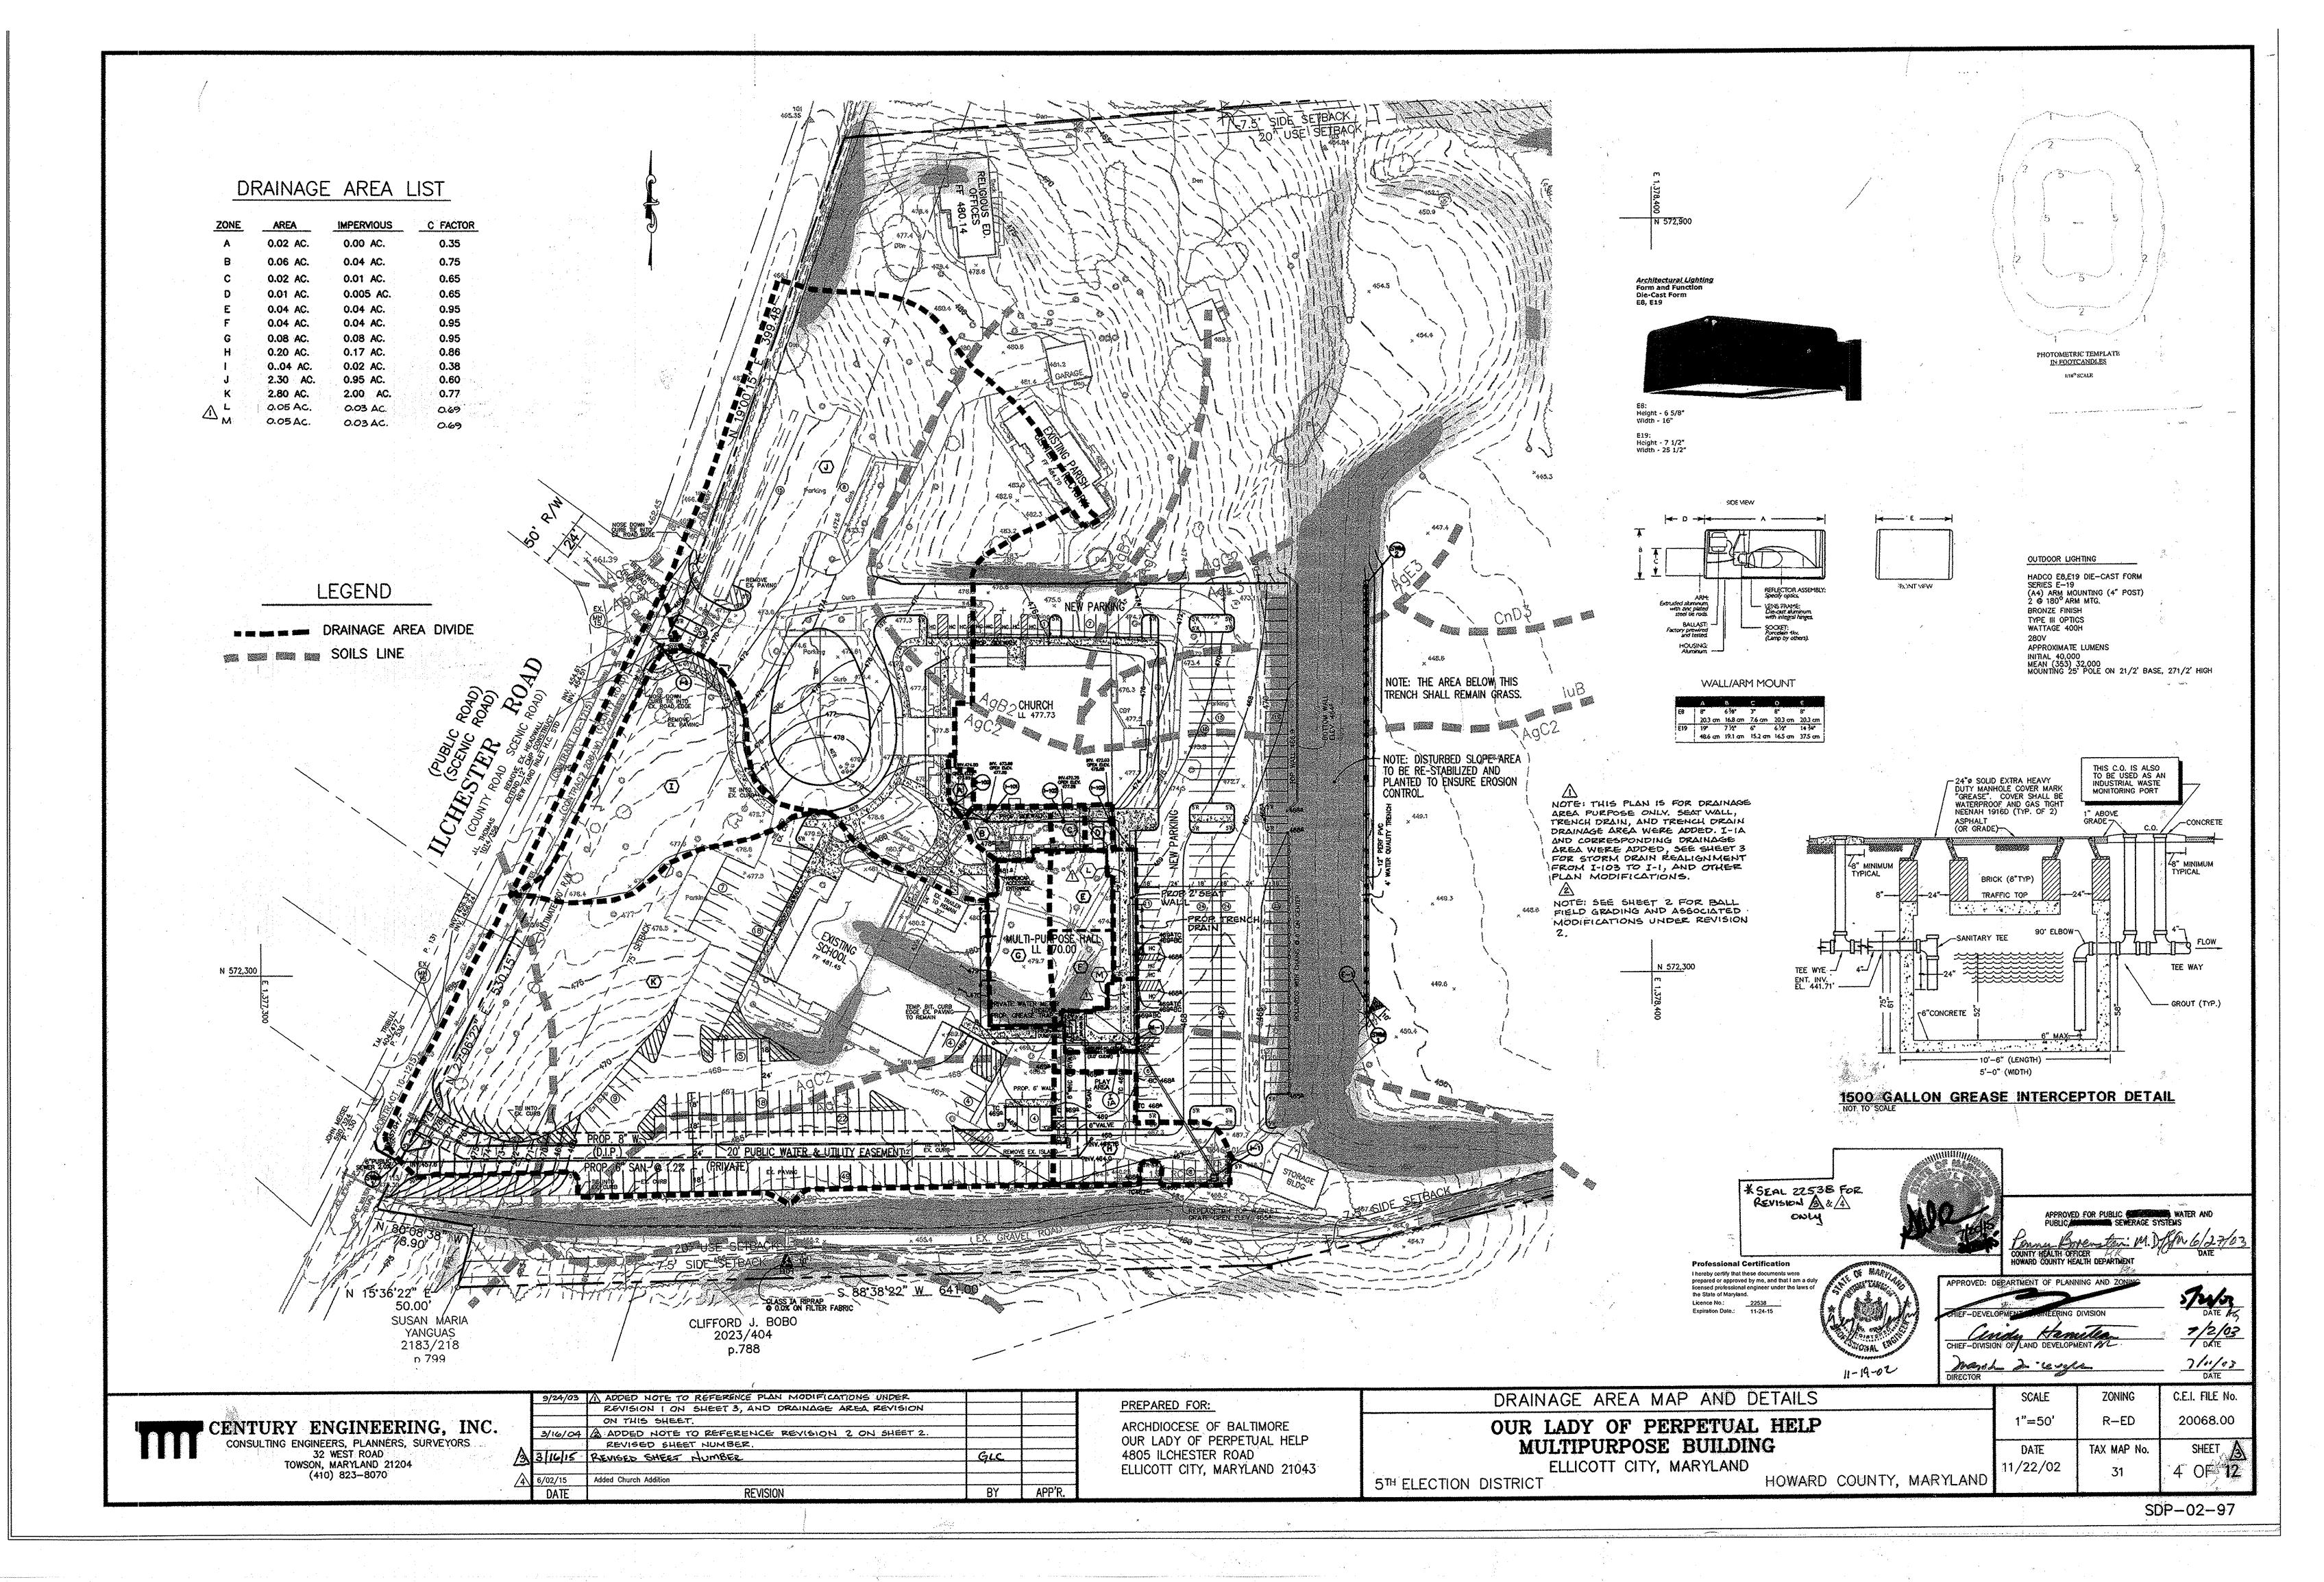

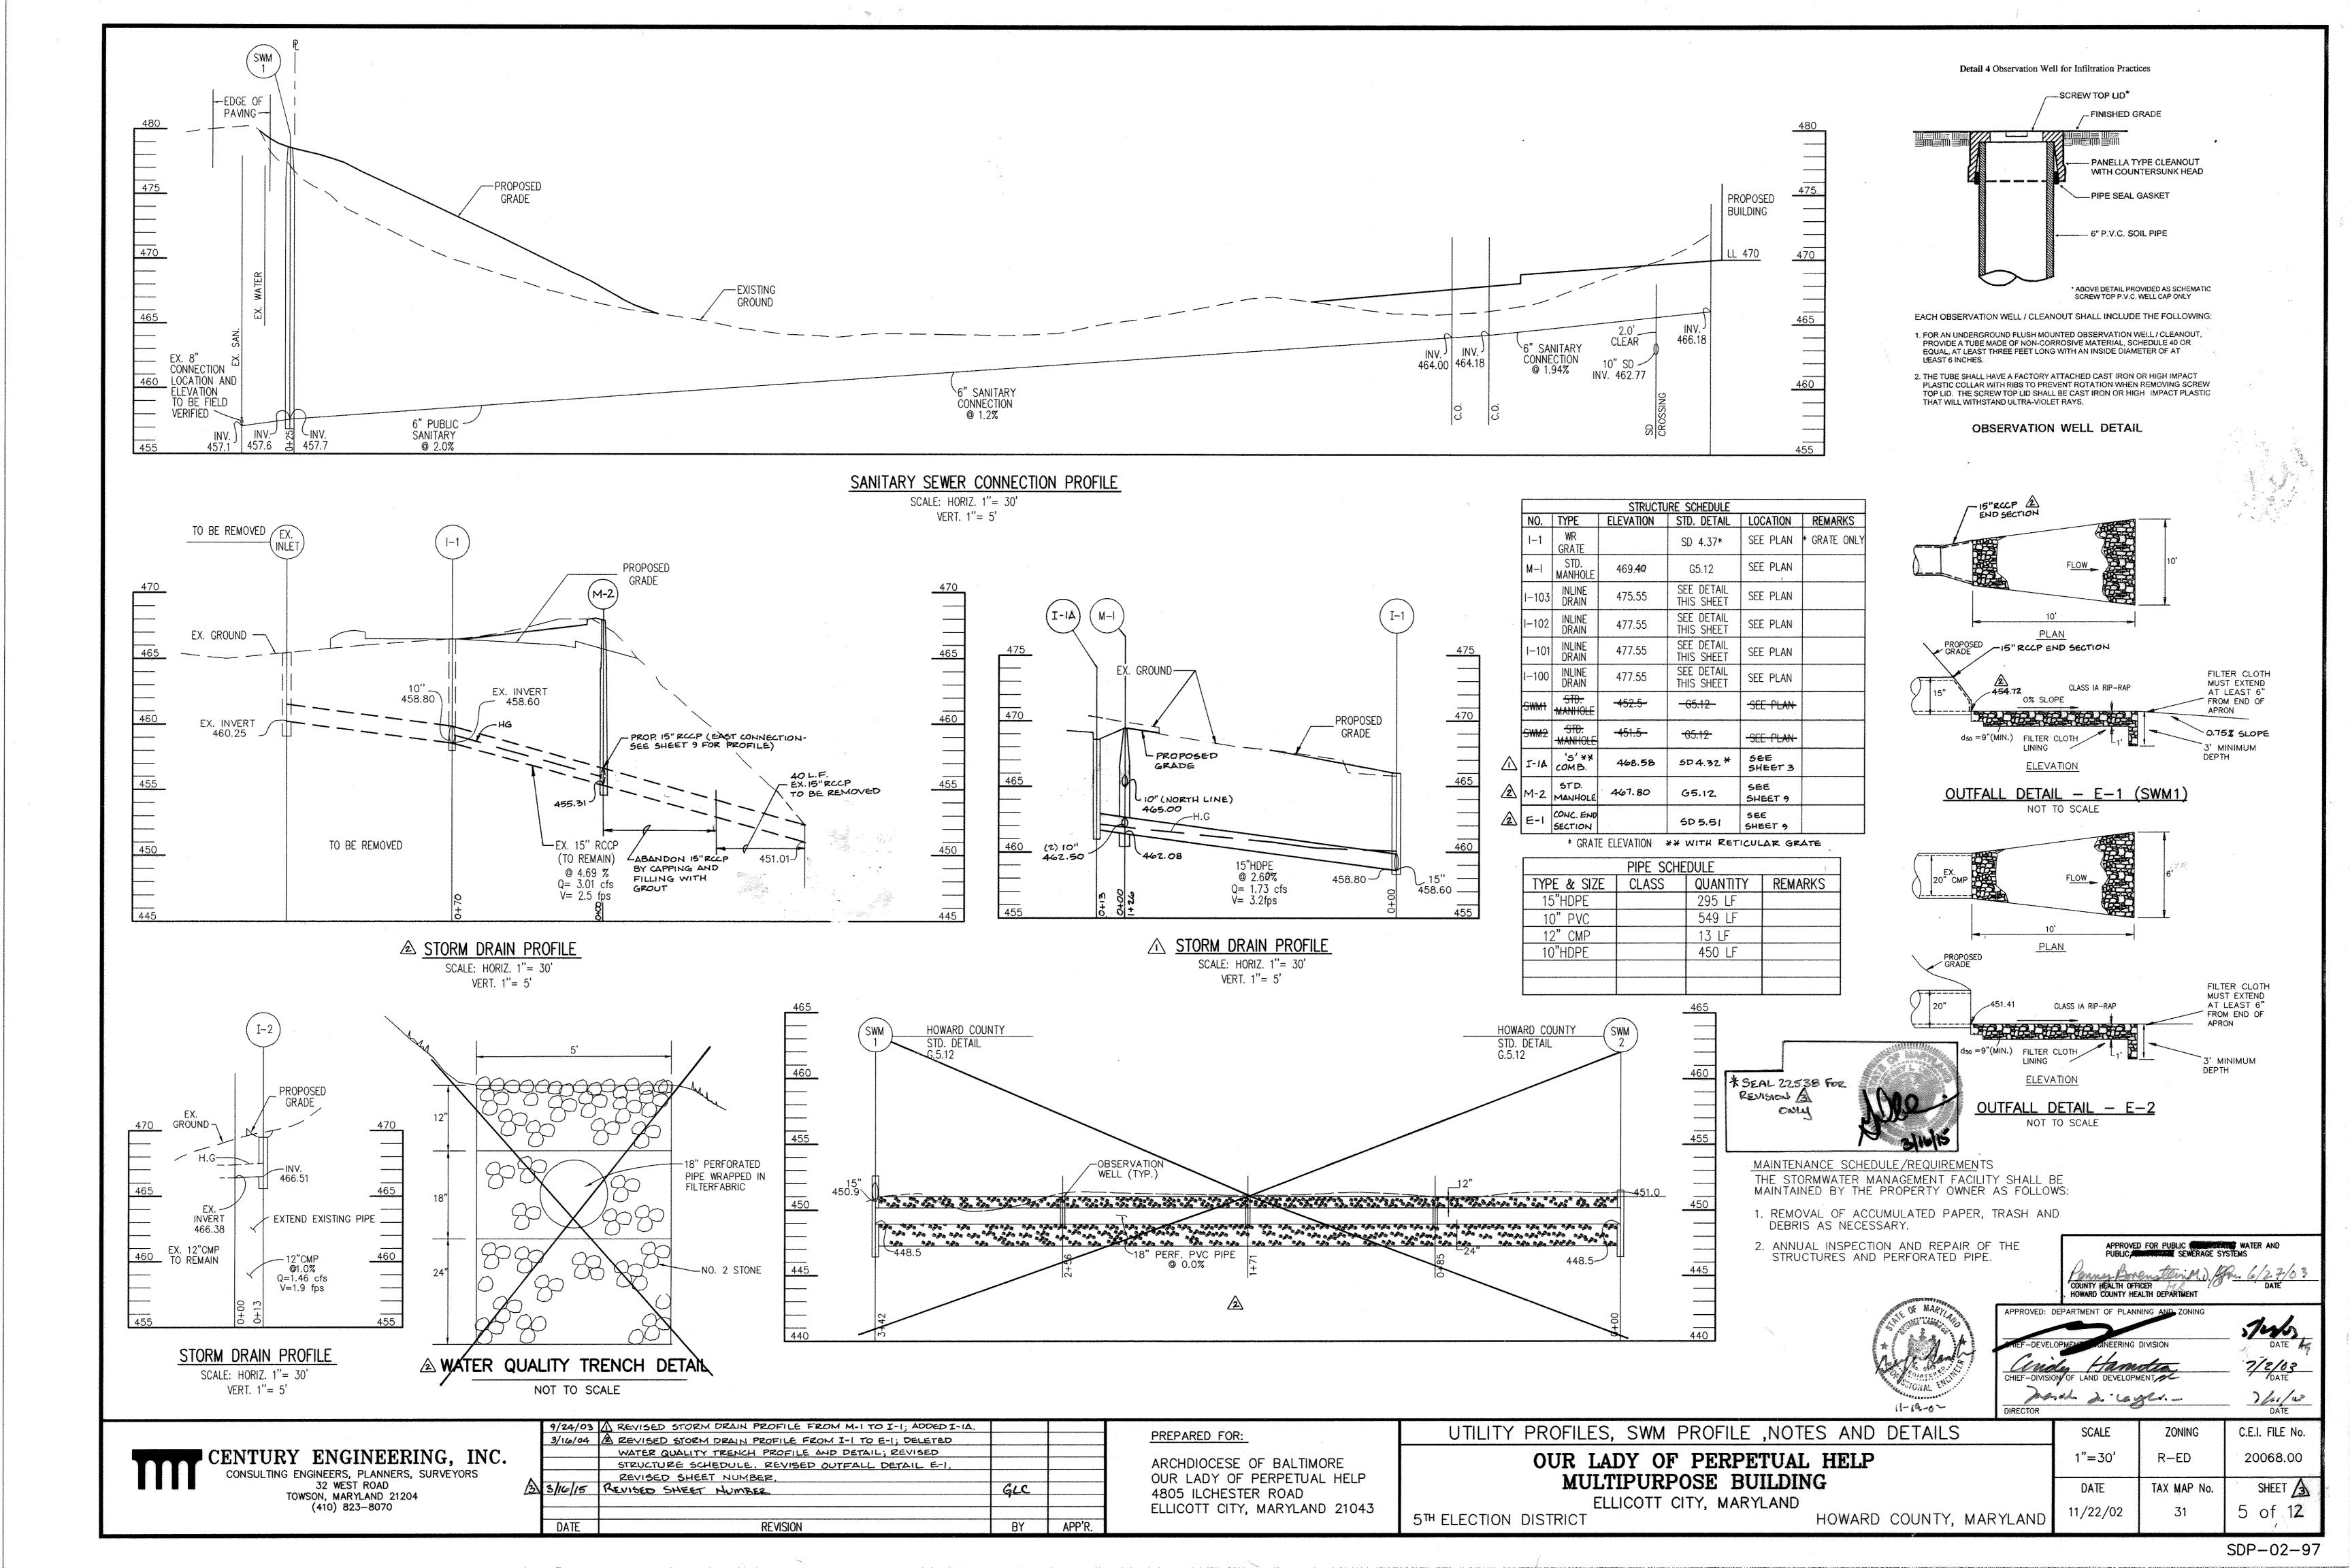

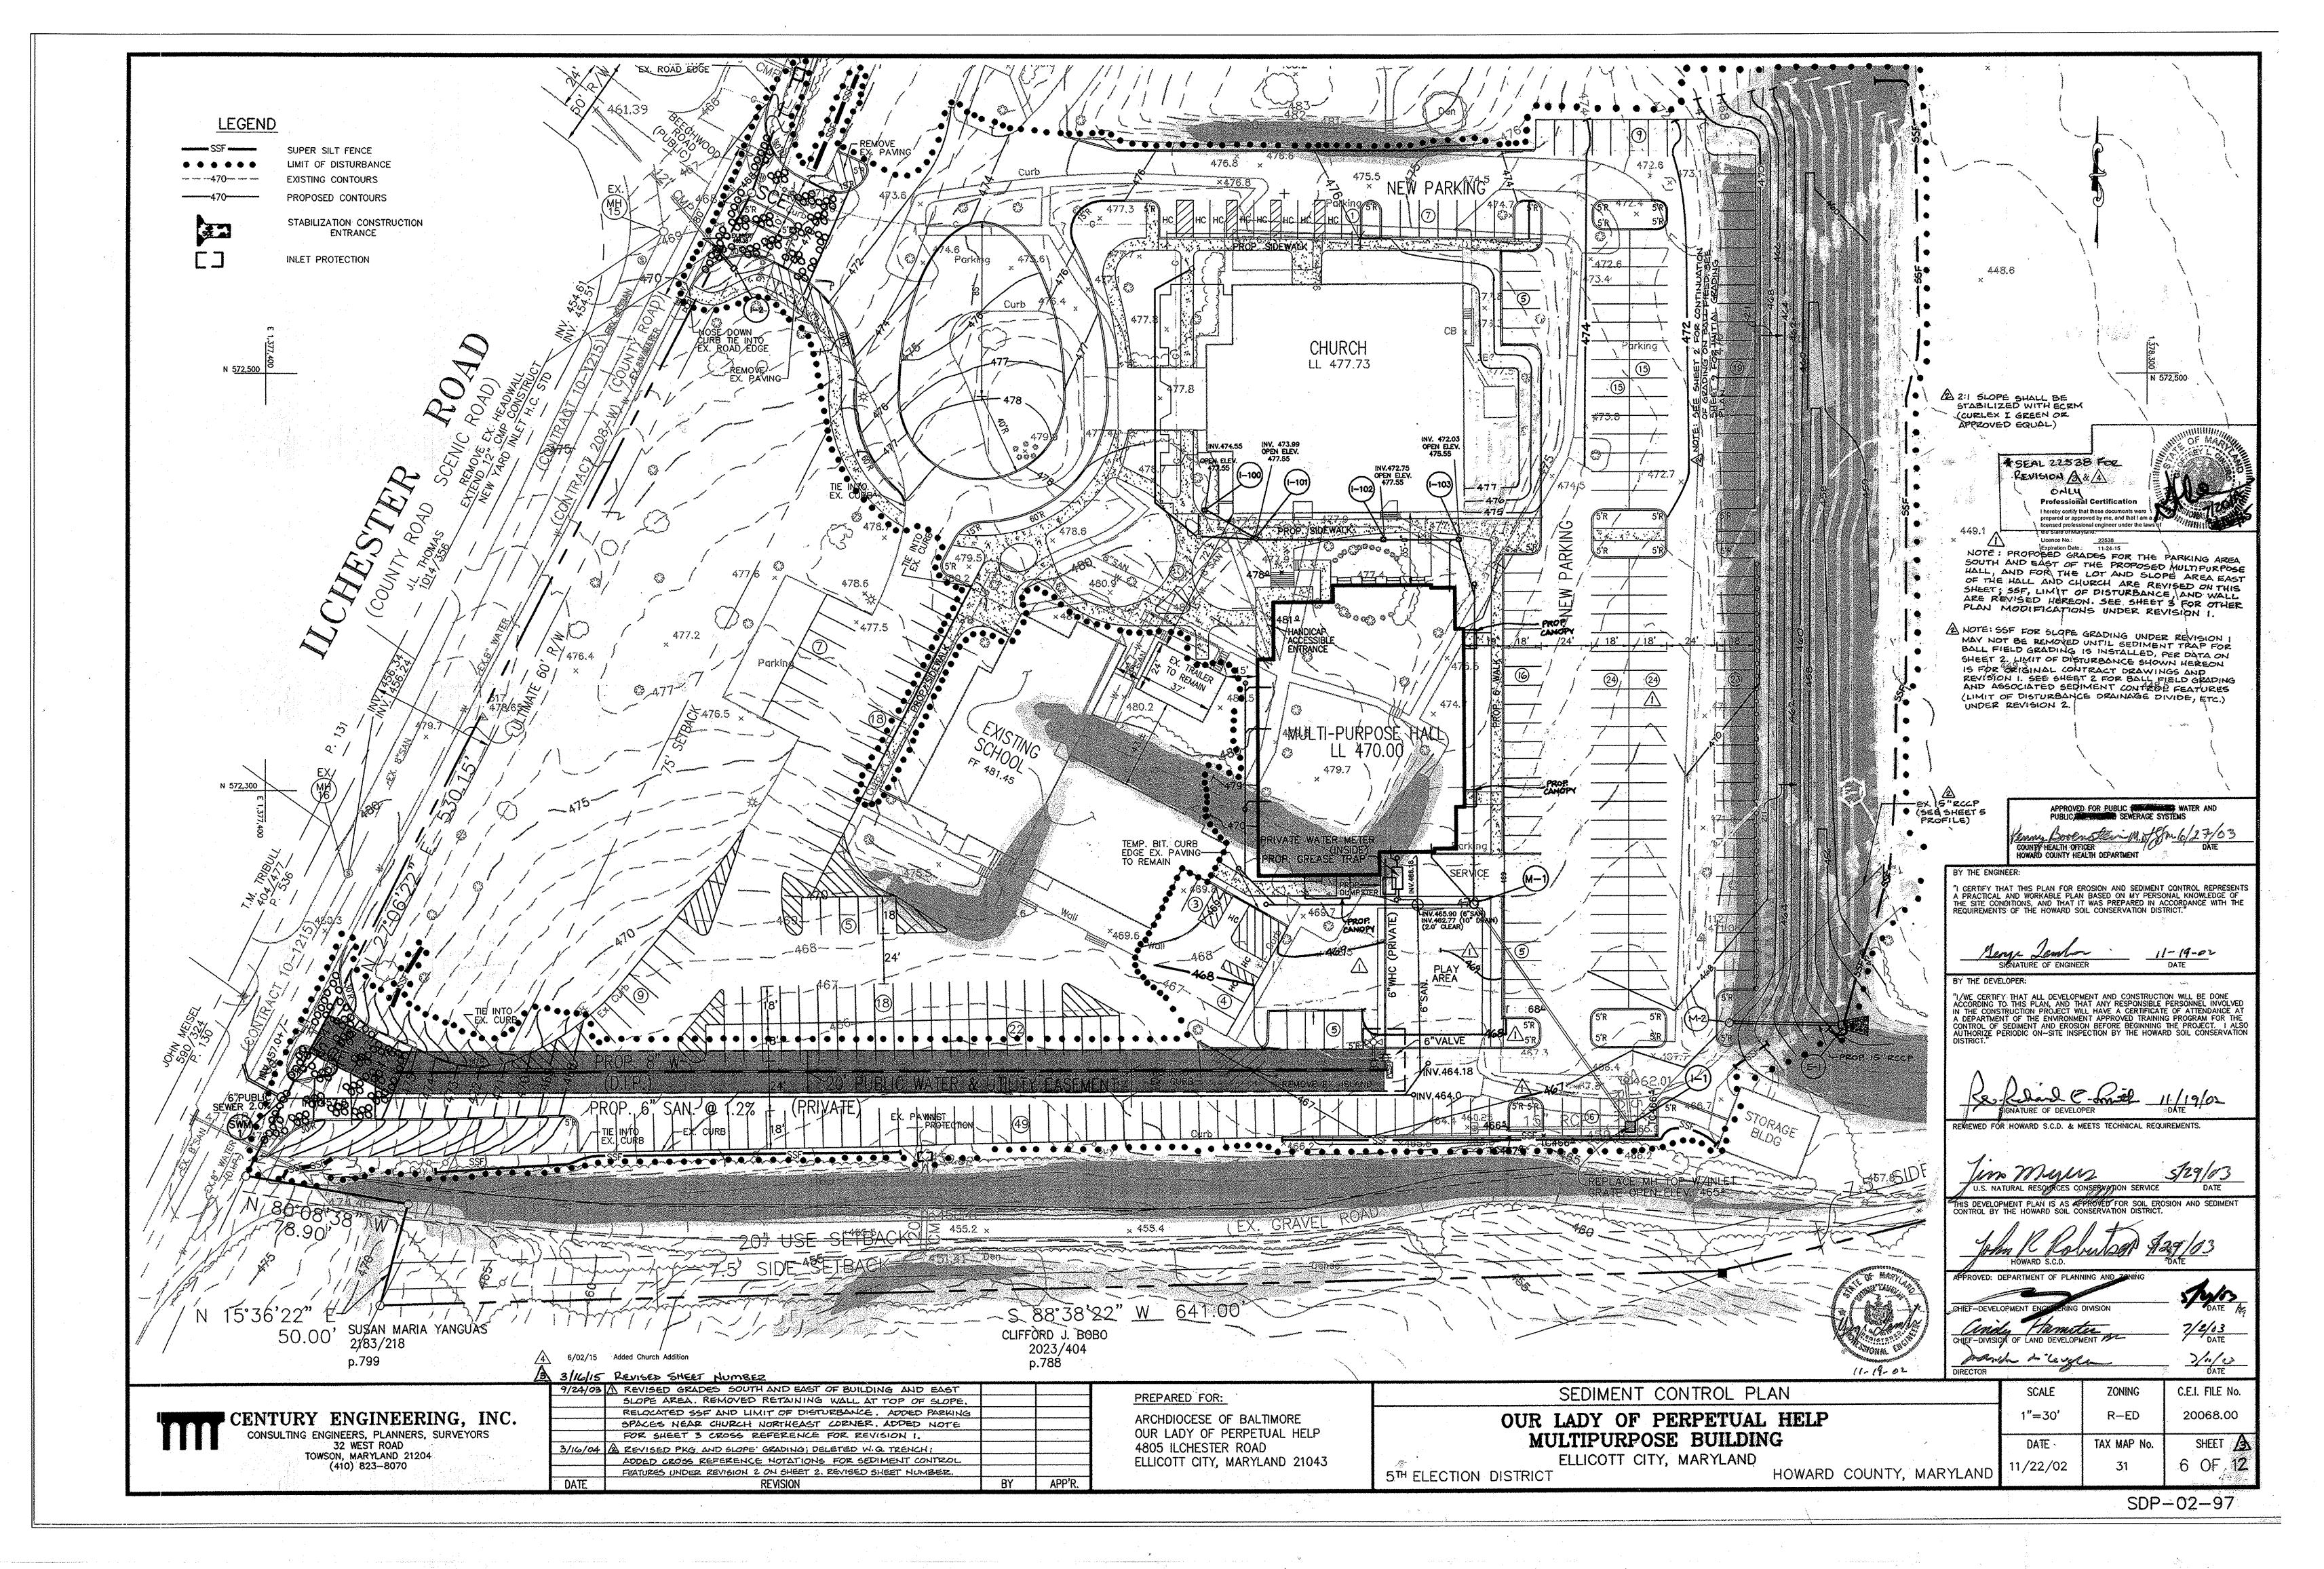

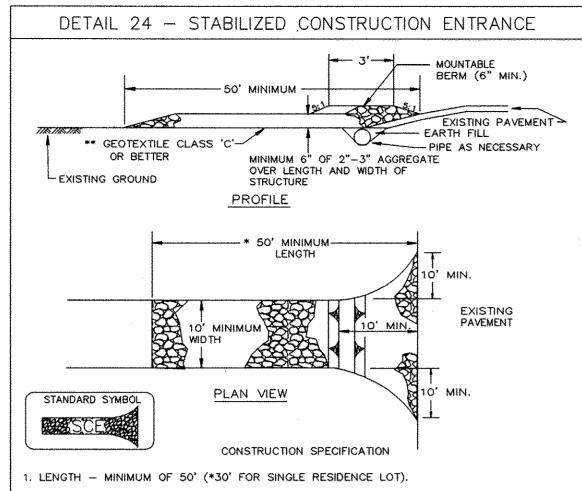

- 2. WIDTH 10' MINIMUM, SHOULD BE FLARED AT THE EXISTING ROAD TO PROVIDE A TURNING
- 3. GEOTEXTILE FABRIC (FILTER CLOTH) SHALL BE PLACED OVER THE EXISTING GROUND PRIOR TO PLACING STONE. \*\*THE PLAN APPROVAL AUTHORITY MAY NOT REQUIRE SINGLE FAMILY RESIDENCES TO USE GEOTEXTILE.
- 4. STONE CRUSHED AGGREGATE (2" TO 3") OR RECLAIMED OR RECYCLED CONCRETE EQUIVALENT SHALL BE PLACED AT LEAST 6" DEEP OVER THE LENGTH AND WIDTH OF THE ENTRANCE.
- 5. SURFACE WATER ALL SURFACE WATER FLOWING TO OR DIVERTED TOWARD CONSTRUCTION ENTRANCES SHALL BE PIPED THROUGH THE ENTRANCE, MAINTAINING POSITIVE DRAINAGE. PIPE INSTALLED THROUGH THE STABILIZED CONSTRUCTION ENTRANCE SHALL BE PROTECTED WITH A MOUNTABLE BERM WITH 5:1 SLOPES AND A MINIMUM OF 6" OF STONE OVER THE PIPE. PIPE HAS TO BE SIZED ACCORDING TO THE DRAINAGE. WHEN THE SCE IS LOCATED AT A HIGH SPOT AND HAS NO DRAINAGE TO CONVEY A PIPE WILL NOT BE NECESSARY. PIPE SHOULD BE SIZED ACCORDING TO THE AMOUNT OF RUNOFF TO BE CONVEYED. A 6" MINIMUM WILL BE REQUIRED.
- 6. LOCATION A STABILIZED CONSTRUCTION ENTRANCE SHALL BE LOCATED AT EVERY POINT WHERE CONSTRUCTION TRAFFIC ENTERS OR LEAVES A CONSTRUCTION SITE. VEHICLES LEAVING THE SITE MUST TRAVEL OVER THE ENTIRE LENGTH OF THE STABILIZED CONSTRUCTION ENTRANCE.
- MARYLAND DEPARTMENT OF ENVIRONMENT U.S. DEPARTMENT OF AGRICULTURE F - 17 - 3 WATER MANAGEMENT ADMINISTRATION SOIL CONSERVATION SERVICE

DETAIL 22 - SILT FENCE
10' MAXIMUM CENTER TO CENTER  10' MAXIMUM CENTER TO CENTER  10' MINIMUM LENGTH FENCE POST, DRIVEN A MINIMUM OF 16" INTO GROUND  16" MINIMUM HEIGHT OF GEOTEXTILE CLASS F  8" MINIMUM DEPTH IN GROUND
PERSPECTIVE VIEW  36" MINIMUM FENCE POST LENGTH  FILTER CLOTH FLOW  FLOW  UNDISTURBED GROUND UNDISTURBED GROUND UNDISTURBED GROUND FENCE POST SECTION MINIMUM 20" ABOVE GROUND UNDISTURBED GROUND FENCE POST DRIVEN A MINIMUM OF 16" INTO THE GROUND  SECTION B  CROSS SECTION  SECTION A  STAPLE  JOINING TWO ADJACENT SILT
FENCE SECTIONS  CONSTRUCTION SPECIFICATIONS

- 1. FENCE POSTS SHALL BE A MINIMUM OF 36" LONG DRIVEN 16" MINIMUM INTO THE GROUND. WOOD POSTS SHALL BE 11/2" X 11/2" SQUARE (MINIMUM) CUT, OR 13/4" DIAMETER (MINIMUM) ROUND AND SHALL BE OF SOUND QUALITY HARDWOOD. STEEL POSTS WILL BE STANDARD T OR U SECTION WEIGHTING NOT LESS THAN 1.00 POND PER LINEAR FOOT.
- 2. GEOTEXTILE SHALL BE FASTENED SECURELY TO EACH FENCE POST WITH WIRE TIES OR STAPLES AT TOP AND MID-SECTION AND SHALL MEET THE FOLLOWING REQUIREMENTS FOR GEOTEXTILE CLASS F:

TEST: MSMT 509 50 LBS/IN (MIN.) TENSILE STRENGTH TENSILE MODULUS 20 LBS/IN (MIN.) TEST: MSMT 509 0.3 GAL FT2/ MINUTE (MAX.) TEST: MSMT 322 FLOW RATE FILTERING EFFICIENCY 75% (MIN.) TEST: MSMT 322

- 3. WHERE ENDS OF GEOTEXTILE FABRIC COME TOGETHER, THEY SHALL BE OVERLAPPED, FOLDED AND STAPLED TO PREVENT SEDIMENT BYPASS.
- 4. SILT FENCE SHALL BE INSPECTED AFTER EACH RAINFALL EVENT AND MAINTAINED WHEN BULGES OCCUR OR WHEN SEDIMENT ACCUMULATION REACHED 50% OF THE FABRIC HEIGHT.
- MARYLAND DEPARTMENT OF ENVIRONMENT U.S. DEPARTMENT OF AGRICULTURE WATER MANAGEMENT ADMINISTRATION SOIL CONSERVATION SERVICE E - 16 - 3

6' MAXIMUM SPACING OF 2" X 4" SPACERS  2" X 4" WEIR  3/4 "-1 1/2 "STONE  FILTER CLOTH  WIRE MESH  2" X 4" WEIR  2" X 4" SPACER  SANDBAG OR ALTERNATE WEIGHT  OF 2" X 4"  WEIGHT  TO STORM DRAIN  TO STORM DRAIN  TO STORM DRAIN
MAX. DRAINAGE AREA = 1/4 ACRE
CONSTRUCTION SPECIFICATIONS
ATTACH A CONTINUOUS PIECE OF WIRE MESH (30" MINIMUM WIDTH BY THROAT LENGTH PLUS     4') TO THE 2" X 4" WEIR (MEASURING THROAT LENGTH PLUS 2') AS SHOWN ON THE STANDARD DRAWING.

DETAIL 23C - CURB INLET PROTECTION (COG OR COS INLETS)


- 2. PLACE A CONTINUOUS PIECE OF GEOTEXTILE CLASS E THE SAME DIMENSIONS AS THE WIRE MESH OVER THE WIRE MESH AND SECURELY ATTACH IT TO THE 2" X 4" WEIR.
- 3. SECURELY NAIL THE 2" X 4" WEIR TO A 9" LONG VERTICAL SPACER TO BE LOCATED BETWEEN THE WEIR AND THE INLET FACE (MAX. 4' APART).
- 4. PLACE THE ASSEMBLY AGAINST THE INLET THROAT AND NAIL (MINIMUM 2' LENGTHS OF 2" X 4" TO THE TOP OF THE WEIR AT SPACER LOCATIONS). THESE 2" X 4" ANCHORS SHALL "XTEND ACROSS THE INLET TOP AND BE HELD IN PLACE BY SANDBAGS OR ALTERNATE WEIGHT.
- 5. THE ASSEMBLY SHALL BE PLACED SO THAT THE END SPACERS ARE A MINIMUM 1' BEYOND
- 6. FORM THE 1/2 " X 1/2" WIRE MESH AND THE GEOTEXTILE FABRIC TO THE CONCRETE GUTTER AND AGAINST THE FACE OF THE CURB ON BOTH SIDES OF THE INLET. PLACE CLEAN 3/4 " X 1 1/2 " STONE OVER THE WIRE MESH AND GEOTEXTILE IN SUCH A MANNER TO PREVENT WATER FROM ENTERING THE INLET UNDER OR AROUND THE GEOTEXTILE.
- 7. THIS TYPE OF PROTECTION MUST BE INSPECTED FREQUENTLY AND THE FILTER CLOTH AND STONE REPLACED WHEN CLOGGED WITH SEDIMENT.


BOTH ENDS OF THE THROAT OPENING.

8. ASSURE THAT STORM FLOW DOES NOT BYPASS THE INLET BY INSTALLING A TEMPORARY EARTH OR ASPHALT DIKE TO DIRECT THE FLOW TO THE INLET.


MARYLAND DEPARTMENT OF ENVIRONMENT .U.S. DEPARTMENT OF AGRICULTURE PAGE WATER MANAGEMENT ADMINISTRATION SOIL CONSERVATION SERVICE

	SILT FENCE DESIGN CR	ITERIA
SLOPE STEEPNESS	(MAXIMUM) SLOPE LENGTH	(MAXIMUM) SILT FENCE LENGTH
FLATTER THAN 50:1	UNLIMITED	UNLIMITED
50:1 TO 10:1	125 FEET	1,000 FEET
10:1 TO 5:1	100 FEET	750 FEET
5:1 TO 3:1	60 FEET	500 FEET
3:1 TO 2:1	40 FEET	250 FEET
2:1 AND STEEPER	20 FEET	125 FEET

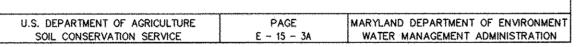

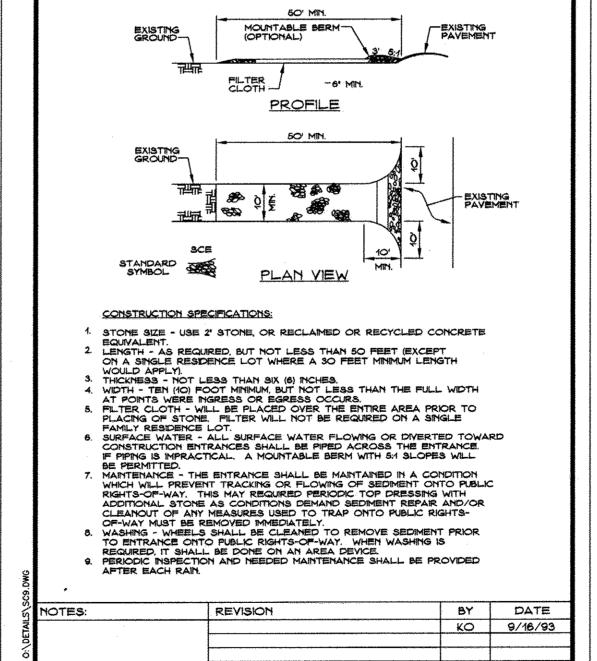

STABILIZED CONSTRUCTION ENTRANCE

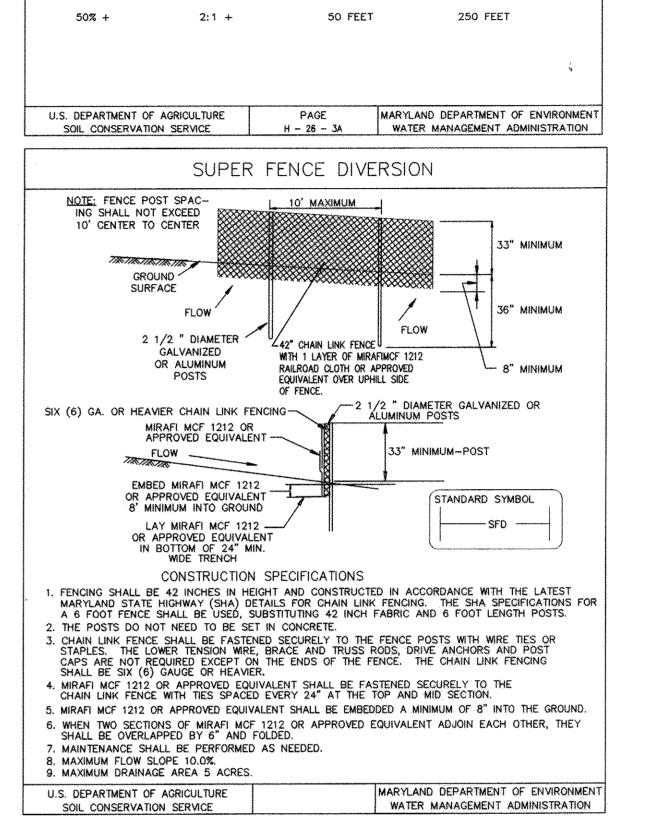

SUPER SILT FENCE

SLOPE LENGTH

(MAXIMUM)

UNLIMITED

200 FEET

100 FEET

100 FEET

SILT FENCE LENGTH

(MAXIMUM)

UNLIMITED

1,500 FEET

1,000 FEET

500 FEET

DESIGN CRITERIA

SLOPE

STEEPNESS

0 - 10:1

10:1 - 5:1

5:1 - 3:1

3:1 - 2:1


SLOPE

0 - 10%

10 - 20%

20 - 33%

33 - 50%

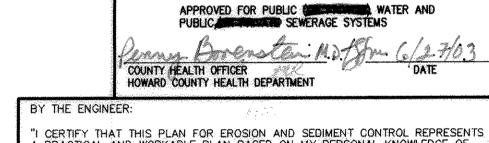

"I CERTIFY THAT THIS PLAN FOR EROSION AND SEDIMENT CONTROL REPRESENTS A PRACTICAL AND WORKABLE PLAN BASED ON MY PERSONAL KNOWLEDGE OF THE SITE CONDITIONS, AND THAT IT WAS PREPARED IN ACCORDANCE WITH THE REQUIREMENTS OF THE HOWARD SOIL CONSERVATION DISTRICT."

BY THE DEVELOPER: "I/WE CERTIFY THAT ALL DEVELOPMENT AND CONSTRUCTION WILL BE DONE ACCORDING TO THIS PLAN, AND THAT ANY RESPONSIBLE PERSONNEL INVOLVED N THE CONSTRUCTION PROJECT WILL HAVE A CERTIFICATE OF ATTENDANCE AT A DEPARTMENT OF THE ENVIRONMENT APPROVED TRAINING PROGRAM FOR TH CONTROL OF SEDIMENT AND EROSION BEFORE BEGINNING THE PROJECT. I ALSO AUTHORIZE PERIODIC ON-SITE INSPECTION BY THE HOWARD SOIL CONSERVATION DISTRICT."

11-19-02

DATE

REVIEWED FOR HOWARD S.C.D. & MEETS TECHNICAL REQUIREMENTS.

U.S. NATURAL RESOURCES CONSERVATION SERVICE THIS DEVELOPMENT PLAN IS AS APPROVED FOR SOIL EROSION AND SEDIMENT CONTROL BY THE HOWARD SOIL CONSERVATION DISTRICT.

APPROVED: DEPARTMENT OF PLANNING AND ZONING

MARKE HIEF-DIVISION OF LAND DEVELOPMENT

7/11/02 DATE

CENTURY ENGINEERING, INC. CONSULTING ENGINEERS, PLANNERS, SURVEYORS 32 WEST ROAD TOWSON, MARYLAND 21204

(410) 823-8070

À	3/16/04	REVISED SHEET NUMBER REVISED SHEET NUMBER	GLC	
	DATE	REVISION	BY	APP'R.

PREPARED FOR:

ARCHDIOCESE OF BALTIMORE OUR LADY OF PERPETUAL HELP 4805 ILCHESTER ROAD ELLICOT CITY, MARYLAND 21043

SEDIMENT CONTROL NOTES AND DETAILS

\*SEAL 22538 FOR

BENISHON B

OUR LADY OF PERPETUAL HELP MULTIPURPOSE BUILDING

ELLICOTT CITY, MARYLAND

5TH ELECTION DISTRICT

HOWARD COUNTY, MARYLAND

C.E.I. FILE No. SCALE 20068.00 AS SHOWN SHEET A TAX MAP No. OF 12 11/22/02

SDP-02-97

#### HOWARD SOIL CONSERVATION DISTRICT

#### STANDARD SEDIMENT CONTROL NOTES

- 1. A minimum of 48 hours notice must be given to the Howard County Department of Inspections, Licenses and Permits, Sediment Control Division prior to the start of any construction (313-1855).
- 2. All vegetative and structural practices are to be installed according to the provisions of this plan and are to be in conformance with the 1994 MARYLAND STANDARDS AND SPECIFICATIONS FOR SOIL EROSION AND SEDIMENT CONTROL and revisions thereto.
- 3. Following initial soil disturbance or re-disturbance, permanent or temporary stabilization shall be completed within: a) 7 calendar days for all perimeter sediment control structures, dikes, perimeter slopes and all slopes steeper than 3:1, b) 14 days as to all other disturbed or graded areas on the project site.
- 4. All sediment traps/basins shown must be fenced and warning signs posted around their perimeter in accordance with Vol. 1. Chapter 7 of the HOWARD COUNTY DESIGN MANUAL, Storm Drainage.
- 5. All disturbed greas must be stabilized within the time period specified above in accordance with the 1994 MARYLAND STANDARDS AND SPECIFICATIONS FOR SOIL EROSION AND SEDIMENT CONTROL for permanent seeding, sod, temporary seeding and mulching (Sec. G). Temporary stabilization with mulch alone shall only be done when recommended seeding dates do not allow for proper germination and establishment of grasses.
- 6. All sediment control structures are in place and are to be maintained in operative condition until permission for their removal has been obtained from the Howard County Sediment Control Inspector.
- 7. Site Analysis:

Total Area of Site 26.375 Acres 8.3 Acres 1 3 Area Disturbed \_\_\_3.6\_Acres Area to be roofed or paved Area to be vegetatively stabilized \_4.7\_Acres 3 Total Cut 4,000 Cu. Yds. Total Fill = 48.000 Cu. Yds. 3 Ofsite waste/borrow area location

- 8. Any sediment control practice which is disturbed by grading activity for placement of utilities must be repaired on the same day of disturbance.
- 9. Additional sediment control must be provided, if deemed necessary, by the Howard County Sediment Control Inspector.
- 10. On all sites with disturbed areas in excess of 2 acres, approval of the inspection agency shall be requested upon completion of installation of perimeter erosion and sediment controls, but before proceeding with any other earth disturbance or grading. Other building or grading inspection approvals may not be authorized until this initial approval by the inspection agency is made.
- 11. Trenches for the construction of utilities is limited to three pipe lengths or that which shall be backfilled and stabilized within one working day, whichever is shorter.

#### HOWARD SOIL CONSERVATION DISTRICT

#### PERMANENT SEEDING NOTES

Apply to graded or cleared areas not subject to immediate further disturbance where a permanent long-lived vegetative cover is needed.

Seedbed Preparation: Loosen upper three inches of soil by raking, disking or other acceptable means before seeding, if not previously loosened.

Soil Amendments: In lieu of soil test recommendations, use one of the following schedules:

- 1. Preferred Apply 2 tons/acre dolomitic limestone (92,000 lbs/1000 sq. ft) and 600 lbs/acre 10-10-10 fertilizer (14 lbs/1000 sq. ft) before seeding. Harrow or disk into upper three inches of soil. At time of seeding, apply 400 lbs/acre 30-0-0 ureaform fertilizer (9 lbs/1000 sq. ft.).
- 2. Acceptable Apply 2 tons/acre dolomitic limestone (92 lbs/1000 sq. ft.) and 1000 lbs/acre 10-10-10 fertilizer (23 lbs/1000 sq. ft.) before seeding. Harrow or disk into upper three inches of soil.

Seeding - For the periods March 1 - April 30 and August 1 - October 15, seed with 60 lbs/acre (1.4 lbs/1000 sq. ft.) of Kentucky 31 Tall Fescue. For the period May - July 31, seed with 60 lbs. Kentucky 31 Tall Fescue per acre and 2 lbs/acre (.05 lbs/1000 sq. ft.) of weeping lovegrass. During the period of October 16 - February 28, protect site by: Option 1 - Two tons per acre of well anchored straw mulch and seed as soon as possible in the spring. Option 2 — Use sod. Option 3 - Seed with 60 lbs/acre Kentucky 30 Tall Fescue and mulch with 2 tons/acre well anchored straw.

Mulching — Apply 1 1/2 to 2 tons per acre (70 to 90 lbs/1000 sq. ft.) of unrotted small grain straw immediately after seeding. Anchor mulch immediately after application using mulch anchoring tool or 218 gallons per acre (5 gal/1000 sq. ft.) of emulsified asphalt on flat areas. On slope 8 feet or higher, use 348 gallons per acre (8 gal/1000 sq. ft.) for anchoring.

Maintenance: Inspect all seeding areas and make needed repairs, replacements and reseedings.

### TEMPORARY SEEDING NOTES

Apply to graded or cleared areas likely to be re-disturbed where a short-term vegetative cover is

Seedbed preparation — Loosen upper three inches of soil by raking, disking or other means before seeding, if not previously loosened.

Soil Amendments - Apply 600 lbs/acre 10-10-10 fertilizer (14 lbs/1000 sq. ft.).

Seeding - For period March 1 - April 30 from August 15 - October 15, seed with 2 1/2 bushel per acre of annual rye (3.2 lbs/1000 sq. ft.). for the period May 1 - August 14, seed with 3 lbs/acre of weeping lovegrass (.07 lbs/1000 sq. ft.). For the period November 16 - February 28, protect site by applying 2 tons/acre of well anchored straw mulch and seed as soon as possible in the spring, or use sod.

Mulching - Apply 1 1/2 tons/acre (70 to 90 lbs/1000 sq. ft.) of unrotted weed-free, small grain straw immediately after seeding. Anchor mulch immediately after application using mulch anchoring tool or 218 ggl. per acre (5 ggl/1000 sg. ft.) of emulsified asphalt on flat areas. On slope 8 ft. or higher, use 348 gal. per acre (8 gal/1000 sq. ft.) for anchorina.

Refer to the 1994 MARYLAND STANDARDS AND SPECIFICATIONS FOR SOIL EROSION AND SEDIMENT CONTROL for additional rates and methods not covered.

SEQUENCE OF CONSTRUCTION	TIMETABLE
1. OBTAIN GRADING PERMIT.	
2. NOTIFY HOWARD COUNTY DEPARTMENTS OF PERMITS & LICENSES, GRADING AND SEDIMENT CONTROL INSPECTIONS @ 313-1855 AT LEAST 48 HOURS PRIOR TO BEGINNING WORK.	1 DAY
3. CLEAR AND GRUB FOR SEDIMENT AND EROSION CONTROL MEASURES.	1 DAY
4. INSTALL ALL SEDIMENT & EROSION CONTROL MEASURES OR DEVICES ONLY.*	3 DAYS
5. NOTIFY HOWARD COUNTY DEPARTMENT OF PERMITS & LICENSES, GRADING AND SEDIMENT CONTROL INSPETIONS @ 414-313-1855 UPON COMPLETION OF SAID INSTALLATION.	1 DAY
7. BEGIN BUILDING CONSTRUCTION AND ASSOCIATED UTILITIES. SEE UTILITY NOTES FOR RESTRICTIONS.	3 MONTH
8. CONSTRUCT ENTRANCES MAINTAINING ACCESS AT ALL TIMES TO CHURCH AND SCHOOL.	2 WEEKS
9. GRADE LOWER PARKING AREA AND CONSRUCT WALL.	3 WEEKS
10. FINE GRADE GARDEN AND GRASS AREAS AND CONSTRUCT SIDEWALKS AND OVERLAY EXISTING PAVED AREAS.	1 WEEK
11. FINAL PAVE NEW PARKING AREAS. INSPECTOR, CLEAR AND GRUB REMAINDER OF THE SITE AS REQUIRED.	1 WEEK
12. STABILIZE ALL REMAINING AREAS.	2 DAYS
13. WITH THE APPROVAL OF THE SEDIMENT CONTROL INSPECTOR REMOVE ALL REMAINING SEDIMENT CONTROLS. SITE AS REQUIRED.	2 DAYS

#### UTILITY NOTES

- 1. CONTRACTOR SHOULD OPEN THAT SECTION OF TRENCH THAT CAN BE BACKFILLED AND STABILIZED EACH DAY. IF TRENCH MUST REMAIN OPEN LONGER THAN ONE DAY, SILT FENCE SHALL BE PLACED BELOW (DOWNSLOPE) THE TRENCH.
- 2. PLACE ALL EXCAVATED MATERIAL ON UPHILL SIDE OF TRENCH.
- 3. ANY SEDIMENT CONTROLS DISTURBED BY UTILITY CONSTUCTION ARE TO BE REPAIRED IMMEDIATELY.

	SEQUENCE OF CONSTRUCTION FOR BALL FIELD STOCKPILE TIMETABLE
i.	NOTIFY HOWARD COUNTY DEPARTMENT OF I DAY PERMITS & LICENCES, GRADING AND SEDIMENT CONTROL INSPECTIONS & (410) 313-1855 AT LEAST 48 HOURS PRIOR TO BEGINNING WORK.
2.	CLEAR AND GRUB FOR SEDIMENT TRAP I DAY
3.	INSTALL SEDIMENT TRAP 3 DAYS
	STRIP AND STOCKPILE ALL TOPSOIL I WEEK WHERE FILL PLACEMENT WILL INITIALLY OCCUR. ALL EARTH MOVING ACTIVITY SHALL TAKE PLACE WITHIN LIMIT OF DISTURBANCE FOR BALL FIELD, IN AN AREA WITH POSITIVE DRAINAGE TO THE TRAP, OR THE CONTRACTOR SHALL PROVIDE TEMPORARY MEASURES AS REQUIRED TO ENSURE POSITIVE DRAINAGE.
5.	PERFORM INITIAL GRADING PER SEQUENCE I MONTH ON SHEET 9.
6.	CONTINUE GRADING OPERATION WITHIN 5 MONTHS THE LIMIT OF DISTURBANCE, STRIPPING AND STOCKPILING TOPSOIL IN EACH AREA OF NEW DISTURBANCE, WITH MAINTENANCE OF POSITIVE DRAINAGE TO THE TRAP, UPON SEDIMENT CONTROL INSPECTOR'S APPROVAL, FILL MAY BE PLACED IN ANY AREA WITHIN THE LIMIT OF DISTURBANCE AT ANY CONFIGURATION (E.G., SURFACE AREA AND HEIGHT) PROVIDED THAT POSITIVE DRAINAGE IS MAINTAINED TO THE TRAP, FILL MATERIAL THAT WILL REMAIN IN PLACE (WITH NOTED EXCLUSIONS) SHALL COMPLY WITH SPECIFICATION BELOW.

VEGETATIVELY STABILIZE ALL AFFECTED \* INSTALL SILT FENCE WHEN REQUIRED PER "INITIAL GRADING SEQUENCE OF CONSTRUCTION"

GRADES PEIOR TO CONSTRUCTION AND

ON SHEET 9

\*7. UPON COMPLETION OF ALL GRADING, .... 3 DAYS

8. WITH THE SEDIMENT CONTROL INSPECTOR'S .... 2 DAYS

WITH THE SEDIMENT CONTROL INSPECTOR'S APPROVAL, STABILIZE ALL AFFECTED AREAS.

APPROVAL, RECLAIM THE SEDIMENT TRAP TO

#### SPECIFICATION FOR FILL TO REMAIN IN PLACE

FILL TO REMAIN IN PLACE (WHICH EXCLUDES ALL BERMS AND CHANNELS; NOTED TEMPORARY AND PERMANENT SIDE SLOPES ON SHEETS 2 AND 9 ) SHALL BE COMPACTED TO A MINIMUM OF 90 % MAXIMUM DRY DENSITY IN ACCORDANCE WITH ASTM D 698 (STANDARD PROCTOR).
SEE SHEET 2 AND 9 FOR COMPACTION REQUIRE-MENTS FOR BERMS, CHANNELS AND SIDE SLOPES.


> APPROVED FOR PUBLIC WATER AND COUNTY HEALTH OFFICER
> HOWARD COUNTY HEALTH DEPARTMENT


"I CERTIFY THAT THIS PLAN FOR EROSION AND SEDIMENT CONTROL REPRESENTS A PRACTICAL AND WORKABLE PLAN BASED ON MY PERSONAL KNOWLEDGE OF THE SITE CONDITIONS, AND THAT IT WAS PREPARED IN ACCORDANCE WITH THE REQUIREMENTS OF THE HOWARD SOIL CONSERVATION DISTRICT."


"I/WE CERTIFY THAT ALL DEVELOPMENT AND CONSTRUCTION WILL BE DONE ACCORDING TO THIS PLAN, AND THAT ANY RESPONSIBLE PERSONNEL INVOLVED IN THE CONSTRUCTION PROJECT WILL HAVE A CERTIFICATE OF ATTENDANCE AT A DEPARTMENT OF THE ENVIRONMENT APPROVED TRAINING PROGRAM FOR THE CONTROL OF SEDIMENT AND EROSION BEFORE BEGINNING THE PROJECT. I ALSO AUTHORIZE PERIODIC ON—SITE INSPECTION BY THE HOWARD SOIL CONSERVATION DISTRICT."

TYPICAL PARKING NOT TO SCALE

5™ ELECTION DISTRICT

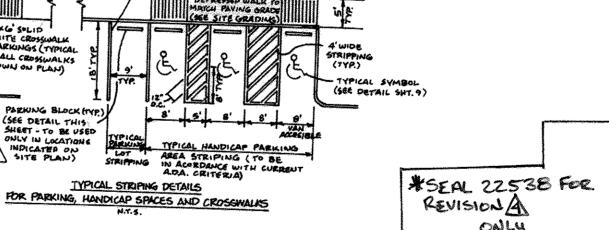


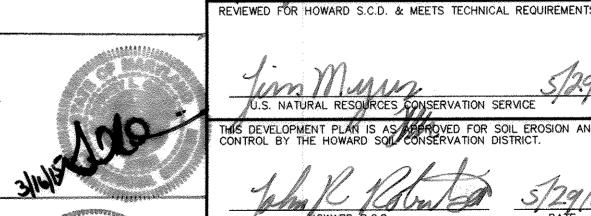

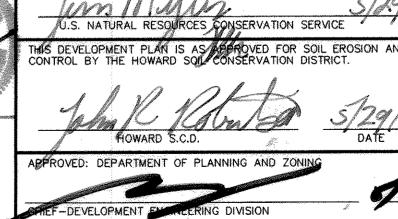

7/11/02 C.E.I. FILE No.

11-19-02

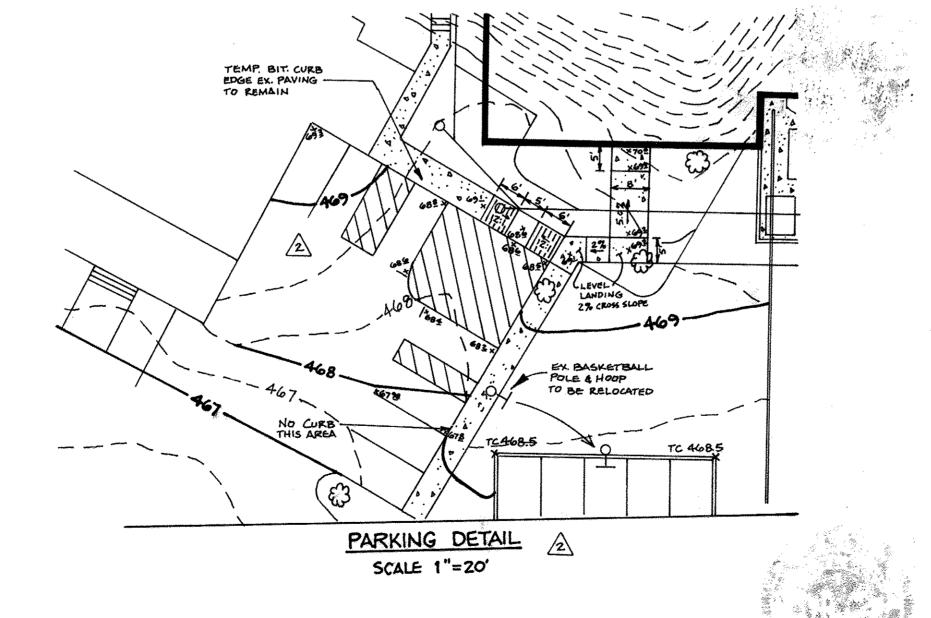

CENTURY ENGINEERING, INC. CONSULTING ENGINEERS, PLANNERS, SURVEYORS 32 WEST ROAD

TOWSON, MARYLAND 21204

(410) 823-8070

REVISED AREA DISTURBED UNDER SITE ANALYSIS ADDED PARKING DETAIL AND TYPICAL PARKING REVISED SITE ANALYSIS; ADDED SEQUENCE OF CONSTRUCTION FOR BALL FIELD STOCKPILE; REVISED SHEET NUMBER GLC 4 3/16/15 REVISED SHEET NUMBER APP'R. BY REVISION

PREPARED FOR:

ARCHDIOCESE OF BALTIMORE OUR LADY OF PERPETUAL HELP 4805 ILCHESTER ROAD ELLICOTT CITY, MARYLAND 21043 SEDIMENT CONTROL NOTES AND DETAILS

OUR LADY OF PERPETUAL HELP MULTIPURPOSE BUILDING

ELLICOTT CITY, MARYLAND

SCALE AS SHOWN R-ED 20068.00 SHEET A TAX MAP No 8 OF 12 11/22/02 HOWARD COUNTY, MARYLAND

